# ALLURE MKE

789 N. JEFFERSON ST. MILWAUKEE, WI 53202

HVAC SYSTEM
PERMIT SET DRAWINGS - JUNE 1, 2021

## WALTERS SHEET METAL CORP

533 SOUTH 94TH STREET
MILWAUKEE, WI 53214
PHONE: 414-443-1980
FAX: 414-443-1985
WWW.WALTERSSHEETMETAL.COM

#### **INDEX**

PAGE	DESCRIPTION
	COVER SHEET
M0.0	INDEX SHEET
M1.0	SITE PLAN
M2.0	ENLARGED FLOOR PLAN LAYOUT
M3.0	ELEVATION LAYOUT
M4.0	HOOD DETAILS
M5.0	HOOD DETAILS
M6.0	EXHAUST FAN DETAILS
M7.0	MAKE-UP AIR UNIT DETAILS
M8.0	TYPICAL NOTES
M9.0	TYPICAL NOTES
M10.0	TYPICAL NOTES

#### WALTERS SHEET METAL CORP

533 SOUTH 94TH STREET MILWAUKEE, WI 53214 PHONE: 414-443-1980 FAX: 414-443-1985 WWW.WALTERSSHEETMETAL.COM

CUSTOMER INFO:

#### **ALLURE MKE**

789 N. JEFFERSON ST. MILWAUKEE, WI 53202

PROJECT NOTES:

REVISIONS

# DATE DESCRIPTION
0 06/01/21 PERMIT SET

CUSTOMER: ALLURE MKE

PROJECT #:

DRAWN BY: J. SUKKERT SCALE: N.T.S.

FILE SAVE AS: ALLURE MKE

PROJECT NAME:

HVAC SYSTEM


SHEET TITLE:

INDEX SHEET

DWG NUMBER:

M0.0

#### **NORTH**

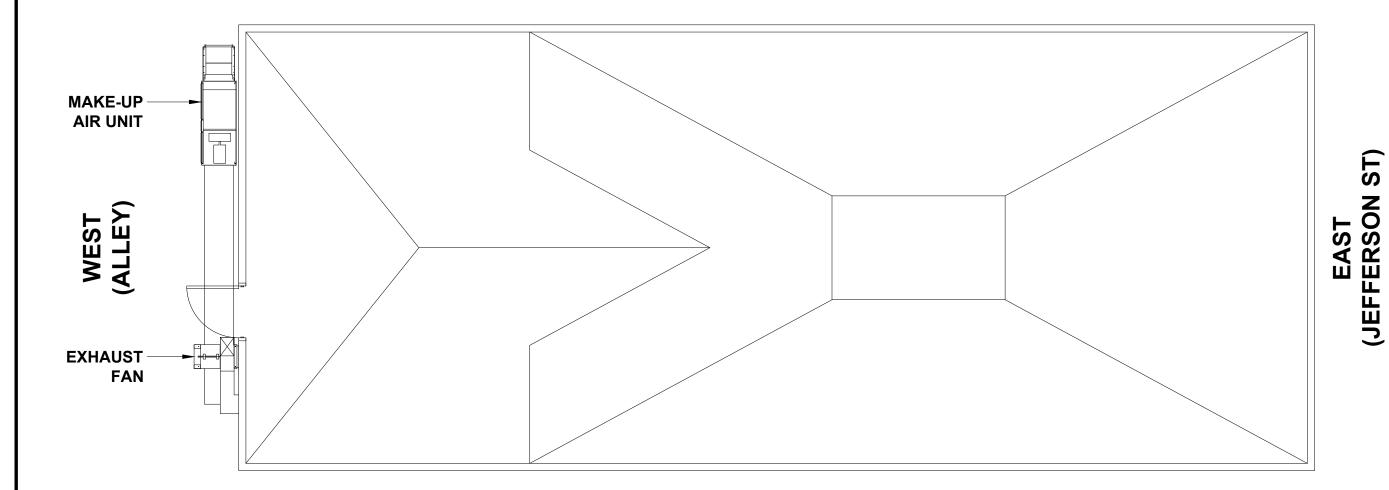

**SOUTH** 



## WALTERS SHEET METAL CORP

533 SOUTH 94TH STREET MILWAUKEE, WI 53214 PHONE: 414-443-1980 FAX: 414-443-1985 WWW.WALTERSSHEETMETAL.COM

CUSTOMER INFO:

#### **ALLURE MKE**

789 N. JEFFERSON ST. MILWAUKEE, WI 53202

PROJECT NOTES:

REVISIONS

# DATE DESCRIPTION
0 06/01/21 PERMIT SET

CUSTOMER: ALLURE MKE

PROJECT #:
DRAWN BY: J. SUKKERT

SCALE: N.T.S.
FILE SAVE AS: ALLURE MKE

PROJECT NAME:

HVAC SYSTEM

SHEET TITLE:

SITE PLAN

DWG NUMBER:

M1.0

### **MAKE-UP AIR UNIT** 20" x 20" **DUCT EXHAUST FAN DUROCK CEMENT BOARD** 0 **ON STEEL STUDS** (BY OTHERS) BACK **RETURN** 72" x 48" -14" x 48" HOOD **PERF BOX**

## WALTERS SHEET METAL CORP

533 SOUTH 94TH STREET MILWAUKEE, WI 53214 PHONE: 414-443-1980 FAX: 414-443-1985 WWW.WALTERSSHEETMETAL.COM

CUSTOMER INFO:

#### **ALLURE MKE**

789 N. JEFFERSON ST. MILWAUKEE, WI 53202

PROJECT NOTES:

CUSTOMER: ALLURE MKE

PROJECT #:
DRAWN BY: J. SUKKERT

SCALE: N.T.S.

FILE SAVE AS: ALLURE MKE

PROJECT NAME:


**HVAC SYSTEM** 

SHEET TITL

ENLARGED FLOOR PLAN LAYOUT

DWG NUMBER:

M2.0

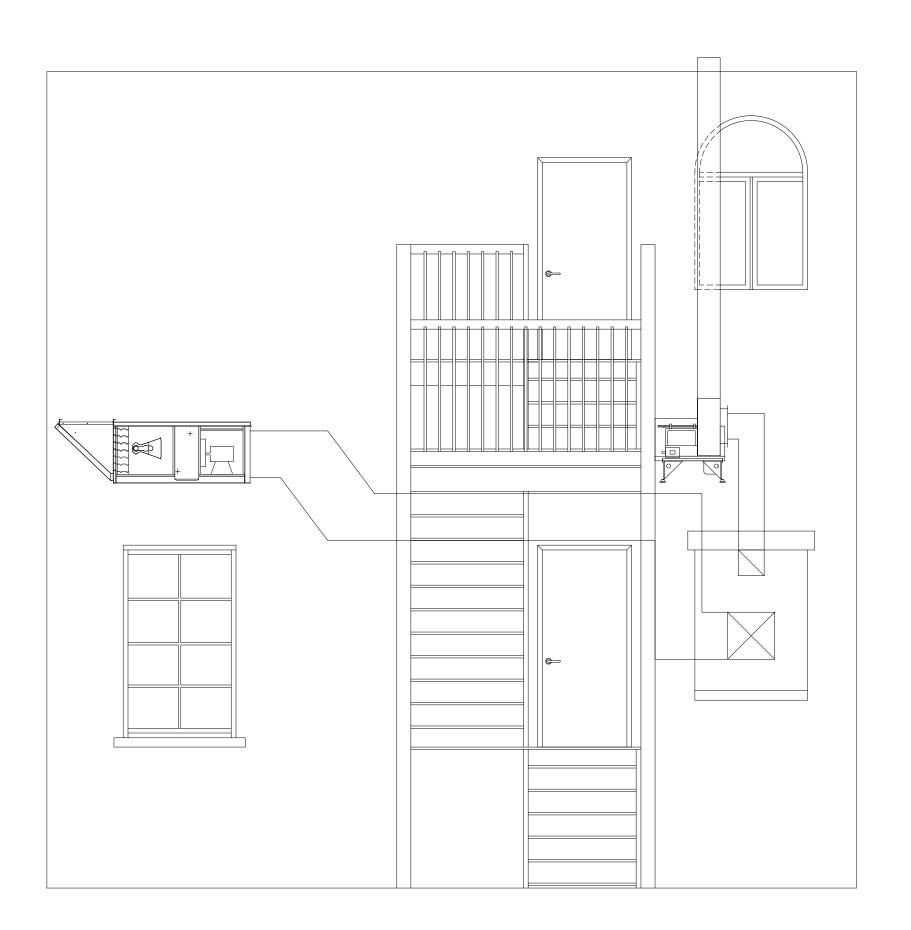

#### WALTERS SHEET METAL CORP

533 SOUTH 94TH STREET MILWAUKEE, WI 53214 PHONE: 414-443-1980 FAX: 414-443-1985 WWW.WALTERSSHEETMETAL.COM

CUSTOMER INFO:

#### **ALLURE MKE**

789 N. JEFFERSON ST. MILWAUKEE, WI 53202

PROJECT NOTES:

RE	VISIONS	
#	DATE	DESCRIPTION
0	06/01/21	PERMIT SET

#### CUSTOMER: ALLURE MKE

PROJECT#:
DRAWN BY: J. SUKKERT

SCALE: N.T.S.

FILE SAVE AS: ALLURE MKE

PROJECT NAME:

HVAC SYSTEM

SHEET TITLE:

**ELEVATION LAYOUT** 

DWG NUMBER:

M3.0

#### **HOOD INFORMATION**


11000			HOOD DIMENSIONS (IN.)			шоор	COOKING			EXH	AUST	SUPPLY		TOTAL	CECTION		
HOOD NO.	MARK	MODEL	LENGTH	WIDTH	HEIGHT	HOOD CONSTR.	LOAD / DUTY	TOTAL		C	OLLAR(S	S)		MUA	AC	WEIGHT	SECTION LOCATION
140.			LENGIA	WIDIR	пеівпі	CONSTR	RATING	CFM	WIDTH	LENGTH	DIA.	CFM	S.P.	CFM	CFM	LBS.	LOCATION
4	HOOD 4	VDEW 72.6	72	40	24	430 SS		4.400	10	13		1400	0.429	4400		240	CINCLE
1	HOOD 1	XBEW-72-S	12	48	24	WHERE	MEDIUM	1400						1400		210	SINGLE

#### **HOOD INFORMATION**

11000		LIGHTING DETAIL	GREASE FILTRAT	GREASE FILTRATION DETAILS				UTILITY CABINET(S)					
HOOD NO.	MARK	FIXTURE TYPE	QTY	FOOT	TYPE / MODEL	QTY	SIZE	(IN.)	LOCATION	FIRE SYSTEM		CC	ONTROLS
140.		BULB / LAMP INFO	QII	CANDLES	MATERIAL	QII	L	Н	LOCATION	TYPE SIZI	SIZE	CONTROLS	INTERFACE
4	HOOD 4	INCANDESCENT (GLOBE)		20.04	BAFFLE	2	16	20					
1	HOOD 1	100W A19 (BULBS NOT INCL.)		39.21	STAINLESS STEEL	2	20	20					

#### **SUPPLY PLENUM INFORMATION**

HOC	D MARK	POS.	TYPE	SI	ZE (I	N.)	INCLU ATER	SULATED DAMPER(S)		HT(S)	TOTAL	COLLARS								
NC	. WARK	PU3.	IIPE	L	W	Н	INSULATEL	DAWIPEK(3)	SUPPLIED	QTY	CFM	TYPE	MOUNTING	QTY	W	L	DIA.	CFM	S.P.	VEL.
1	HOOD 1	FRONT	ASP	72	14	10	NO	NO	NO		1400	MUA	LOOSE	2	10	24		700	0.24	420

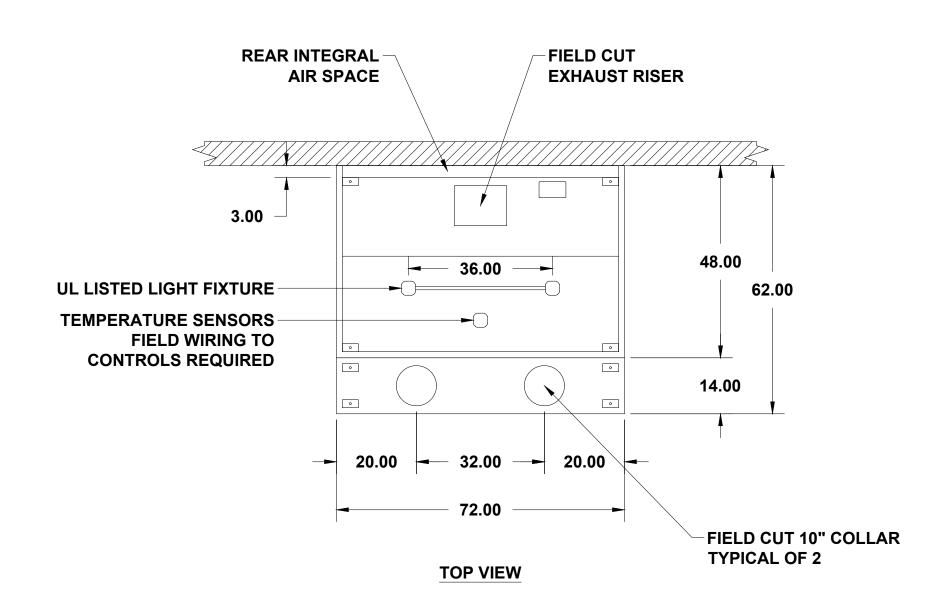

## WALTERS SHEET METAL CORP

533 SOUTH 94TH STREET MILWAUKEE, WI 53214 PHONE: 414-443-1980 FAX: 414-443-1985 WWW.WALTERSSHEETMETAL.COM

CUSTOMER INFO:

#### **ALLURE MKE**

789 N. JEFFERSON ST. MILWAUKEE, WI 53202

PROJECT NOTES:

# DATE DESCRIPTION
0 06/01/21 PERMIT SET

CUSTOMER: ALLURE MKE

PROJECT #: DRAWN BY: J. SUKKERT

SCALE: 1/2" = 1'
FILE SAVE AS: ALLURE MKE

DDO IECT NAME:

**HVAC SYSTEM** 

SHEET TITL


**HOOD #1 DETAILS** 

DWG NUMBER:

M4.0

#### **HOOD OPTIONS**

UL 710 LISTED W/ OUT EXHAUST FIRE DAMPER - UL #R25625
HOOD TOP INSULATED FOR ZERO CLEARANCE TO COMBUSTIBLES
BACK INTEGRAL AIR SPACE - 3 IN WIDE
SHIPPED LOOSE EXHAUST COLLAR(S)
PERFORMANCE ENHANCING LIP (PEL) TECHNOLOGY
STANDING SEAM CONSTRUCTION FOR SUPERIOR STRENGTH

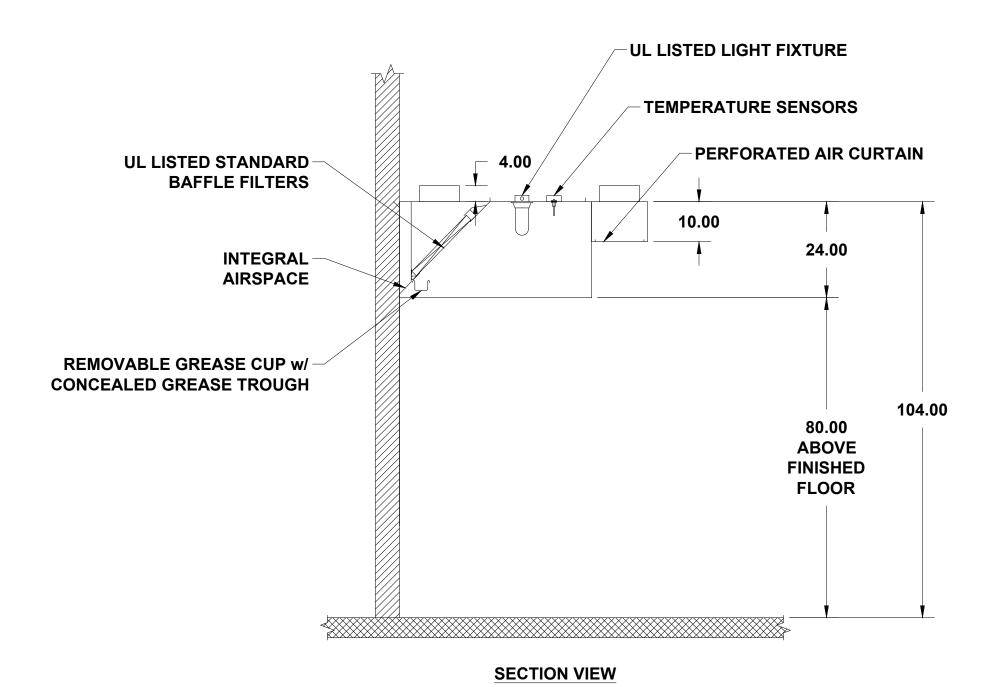

#### WALTERS SHEET METAL CORP

533 SOUTH 94TH STREET MILWAUKEE, WI 53214 PHONE: 414-443-1980 FAX: 414-443-1985 WWW.WALTERSSHEETMETAL.COM

CUSTOMER INFO:

#### **ALLURE MKE**

789 N. JEFFERSON ST. MILWAUKEE, WI 53202

PROJECT NOTES:

REVISIONS

# DATE DESCRIPTION

0 06/01/21 PERMIT SET

CUSTOMER: ALLURE MKE

CUSTOMER: ALLURE MKI PROJECT #:

DRAWN BY: J. SUKKERT

SCALE: 1/2" = 1'

FILE SAVE AS: ALLURE MKE

PROJECT NAME:

HVAC SYSTEM

SHEET TITLE:

**HOOD #1 DETAILS** 

DWG NUMBER:

M5.0

#### UNIVERSAL SINGLE WIDTH FAN

MAF	RK INFORMATION		FA	N INFORMATION					M	OTOR INFORM	ATION		
QTY	MARK	MODEL	VOLUME (CFM)	TOTAL EXTERNAL SP (IN WG)	FAN RPM	OPERATING POWER (HP)	WEIGHT (LB.)	SIZE (HP)	V/C/P	ENCLOSURE	MOTOR RPM	WINDINGS	NEC FLA*
1	EF-1	XUEF-12	1,400	1.1	1,834	0.51	159	0.75	230/60/1	OP	1725	1	6.9

\*NEC FLA - BASED ON TABLE 430.250 OR 430.248 OF NATIONAL ELECTRICAL CODE 2020. ACTUAL MOTOR FLA MAY VARY FOR SIZING THERMAL OVERLOAD, CONSULT FACTORY"

#### **EF-1: SELECTED OPTIONS AND ACCESSORIES**

**FINISH - COATED** 

COATING - PERMATECTOR, CONCRETE GRAY-RAL 7023, FAN AND ATTACHED ACCESSORIES SWITCH - NEMA-3R, TOGGLE, FOR INDOOR OR OUTDOOR USE, MOUNTED AND WIRED DIRECT MOUNT ISOLATORS, ISOLATOR-RUBBER MOUNT, 0.50 INCH, BASE COATING - N/A ROTATION - CW

**BEARINGS - L(10) LIFE OF 80K HOURS** 

**DISCHARGE POSITION - UB** 

**UL/CUL-762 OUTDOOR - POWER VENT. FOR RESTAURANT EXHAUST APPLIANCES** 

**ACCESS DOOR - BOLTED** 

**DRAIN CONNECTION - 1" PIPE THREAD W/PLUG** 


**INLET CONNECTION, PUNCHED** 

**OUTLET CONNECTION, SLIP FIT** 


**WEATHERHOOD - STEEL** 

**SHAFT SEAL - HIGH TEMP** 


**GREASE TRAP, FACTORY MOUNTED WITH BRACKET** 

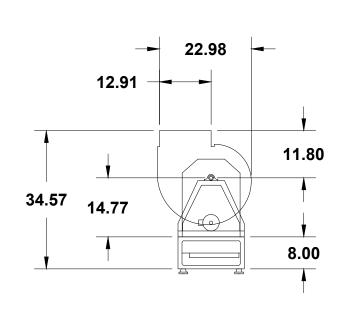



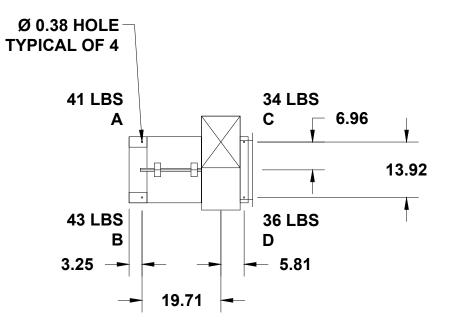

**TOP VIEW** 

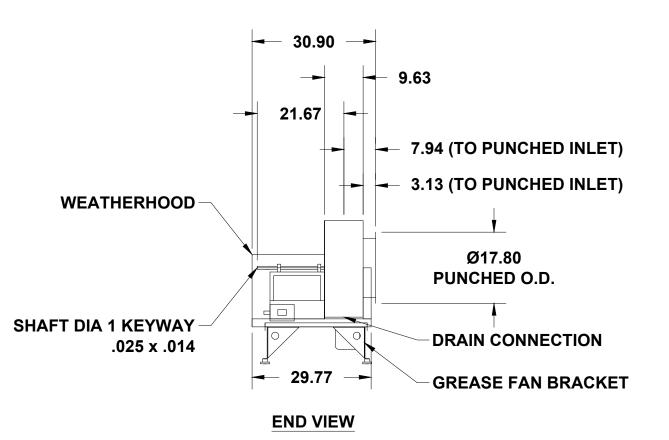

#### WALTERS SHEET METAL CORP

533 SOUTH 94TH STREET MILWAUKEE, WI 53214 PHONE: 414-443-1980 FAX: 414-443-1985 WWW.WALTERSSHEETMETAL.COM

CUSTOMER INFO:

#### **ALLURE MKE**

789 N. JEFFERSON ST. MILWAUKEE, WI 53202

PROJECT NOTES:

EVISIONS

# DATE DESCRIPTION

0 06/01/21 PERMIT SET

CUSTOMER: ALLURE MKE

DRAWN BY: J. SUKKERT

SCALE: 1/2" = 1'
FILE SAVE AS: ALLURE MKE

DJECT NAME:

HVAC SYSTEM


HEET TITLE:


**EXHAUST FAN DETAILS** 

DWG NUMBER:

M6.0

				EQUIP	MENT	SCH	EDU	JLE					
Te	mper	ed Make-	Up Air U	nit							Mark:	MUA-1	
Qty	Accu	rex Model	Volume	Externa	I SP	Total	SP	FRP	м	Operating I	Power	Weight	
1	XDG-P1	115-H05-VG	1,400 CFM	0.4 in.	wg	1.361 i	n. wg	155	0	0.68 հլ	68 hp 4		
	ı		Motor Info	rmation				<u> </u>	I				
	Size	V/C/P	Enclosure	Motor with Shaft	Moto	r RPM	Win	dings	MCA	4	МО	)P	
	1 hp	230/60/1	ODP	Grounding No	17	25		1	10.6	5	15	5	
					Hea	ting							
		0.7	-	Temperature	)			Energy		Connection	Building	Control Access	
	Type	Gas Type	Winter DB	Max Δ	Max LA	T Inp	out	Output	Efficiency		Gas Pressure		
Dii	rect Gas	Natural	-4.0 F	84.0 F	80.0 F	1	8.1 3H	127.0 MBH	92%	3/4"	1/2 PSI	11a	

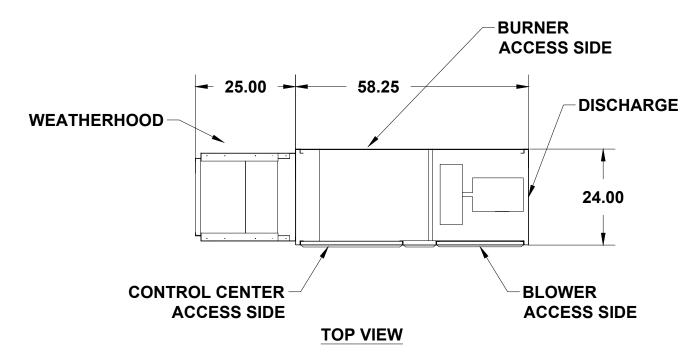

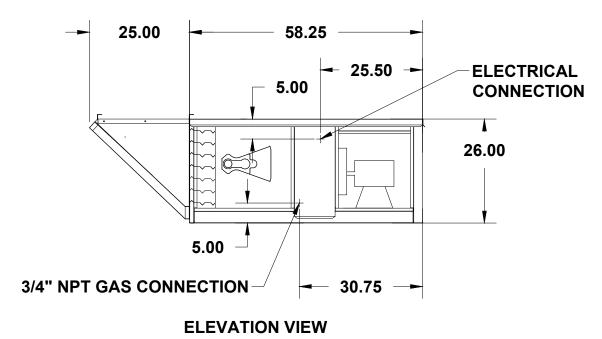

#### NOTE:

THE WEATHERHOOD AND FILTER SECTIONS OF THE MAKE-UP AIR UNIT ARE NOT SUPPORTED BY THE CURB. THIS IS BY DESIGN. IN ORDER TO HELP ALLEVIATE WATER INFILTRATION ISSUES. MUA UNIT SUPPORTS ARE SHIPPED LOOSE WITH UNIT.

#### **OPTIONS AND ACCESSORIES**

AIR FLOW ARRANGEMENT: OUTDOOR AIR ONLY **WEATHERHOOD: ALUMINUM MESH, 16X20X2 - (2)** 

DAMPER: INLET

**OUTDOOR AIR INTAKE POSITION: END** 

**DISCHARGE POSITION: END COATING: GALVANIZED** 

**INSULATION: DOUBLE WALL - HEAT SOURCE ON** 

**SUPPLY FAN CONTROL: VARI-GREEN ECM VARI-GREEN CONTROL: DIAL ON MOTOR** 

**ACCESS SIDE: RIGHT-HAND** 

**CONTROL CENTER** 


**HEAT INLET AIR SENSOR** 

REMOTE PANEL: INDUSTRIAL (SHIPS LOSE) **UNIT ENABLE SWITCH: SUMMER / OFF / WINTER** 

**SWITCHES: PANEL FACE** 

TEMP ADJUSTMENT: PANEL FACE **UNIT CONTROLS: REMOTE PANEL** TEMPERATURE CONTROL: DISCHARGE **DIRECT GAS OPTIONS/ACCESSORIES** 

**APPROVALS: ETL FM COMPLIANT** 

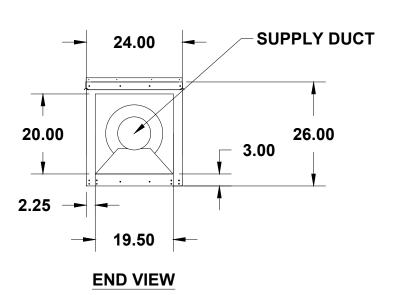

#### **WALTERS** SHEET METAL **CORP**

533 SOUTH 94TH STREET MILWAUKEE, WI 53214 PHONE: 414-443-1980 FAX: 414-443-1985 WWW.WALTERSSHEETMETAL.COM

CUSTOMER INFO:

#### **ALLURE MKE**

789 N. JEFFERSON ST. **MILWAUKEE, WI 53202** 

PROJECT NOTES:

REVISIONS # DATE DESCRIPTION 06/01/21 PERMIT SET CUSTOMER: ALLURE MKE

PROJECT #

DRAWN BY: J. SUKKERT SCALE: 1/2" = 1'

FILE SAVE AS: ALLURE MKE

SHEET TITLE:

**HVAC SYSTEM** 

**MAKE-UP AIR UNIT DETAILS** 

DWG NUMBER:

M7.0

IMC 507.1.1 - SYSTEM IS DESIGNED TO AUTOMATICALLY ACTIVATE THE EXHAUST FAN WHENEVER COOKING OPERATIONS OCCUR. THE ACTIVATION OF THE EXHAUST FAN SHALL OCCUR THROUGH AN INTERLOCK WITH THE COOKING APPLIANCES, BY MEANS OF HEAT SENSORS WITHIN THE KITCHEN HOOD.

IMC 506.3.11.2 - GREASE DUCTS TO BE COMPLETELY COVERED ON ALL SIDES WITH A MATERIAL CLASSIFIED AND LABELED AS GREASE DUCT WRAPS MEETING ASTM E 2336.

IMC/SPS 364.0313 (1) - SYSTEM TO BE BALANCED UPON INSTALLATION. THE PERSON OR AGENCY RESPONSIBLE FOR BALANCING OF THE VENTILATING SYSTEM SHALL DOCUMENT IN WRITING THE AMOUNT OF OUTDOOR AIR BEING PROVIDED AND DISTRIBUTED FOR THE BUILDING OCCUPANTS, EXHAUSTS, AND ANY OTHER SPECIALTY VENTILATION. THE DOCUMENT SHALL BE RETAINED AT THE SITE AND SHALL BE MADE AVAILABLE TO THE DEPARTMENT UPON REQUEST.

IMC 306.5/IFGC 306.5 - PERMANENT ACCESS FOR EQUIPMENT INSTALLED ON ROOFS OR ELEVATED STRUCTURES WITH EQUIPMENT LOCATED AT A HEIGHT EXCEEDING 16FT. PERMANENT LADDERS USED TO PROVIDE REQUIRED ACCESS SHALL MEET THE REQUIREMENTS OF THIS SECTION. ACCESS SHALL NOT REQUIRE CLIMBING OVER OBSTRUCTIONS GREATER THAN 30 INCHES, OR WALKING ON ROOFS HAVING A SLOPE GREATER THAN 4/12.

IBC 904.12 - AUTOMATIC WET CHEMICAL FIRE SUPPRESSION SYSTEM PROVIDED FOR HOODS WITH MANUAL ACTIVATION WITH ACTIVATION DEVICE LOCATED AT OR NEAR A MEANS OF EGRESS FROM THE COOKING AREA A MINIMUM OF 10FT AND A MAXIMUM OF 20FT FROM THE KITCHEN EXHAUST SYSTEM. THE MANUAL ACTIVATION DEVICE SHALL BE LOCATED A MINIMUM OF 42 INCHES AND A MAXIMUM OF 48 INCHES ABOVE THE FLOOR AND IDENTIFY THE HAZARD PROTECTED. THE MAXIMUM ACTIVATION FORCE FOR THE MANUAL ACTIVATION SHALL NOT EXCEED 40lbs, WITH MAXIMUM MOVEMENT OF 14 INCHES TO ACTUATE THE FIRE SUPPRESSION SYSTEM. ALL OF THE ABOVE ITEMS ARE EXEMPTED IF THE SPRINKLER SYSTEM IS AUTOMATIC. THE ACTIVATION OF THE FIRE SUPPRESSION SYSTEM SHALL AUTOMATICALLY SHUT DOWN THE FUEL AND ELECTRICAL POWER SUPPLY TO THE COOKING EQUIPMENT. THE FUEL AND ELECTRICAL SUPPLY RESET SHALL BE MANUAL.

IMC 506.3.2/SPS 364.0506 (2) - PROVIDE TYPE I KITCHEN EXHAUST DUCTS LEADING FROM HOODS WITH WELDED LIQUID TIGHT JOINTS, SEAMS AND PENETRATIONS UNLESS A LISTED EXCEPTION IS MET.

#### WALTERS SHEET METAL CORP

533 SOUTH 94TH STREET MILWAUKEE, WI 53214 PHONE: 414-443-1980 FAX: 414-443-1985 WWW.WALTERSSHEETMETAL.COM

CUSTOMER INFO:

#### **ALLURE MKE**

789 N. JEFFERSON ST. MILWAUKEE. WI 53202

PROJECT NOTES

# DATE DESCRIPTION
0 06/01/21 PERMIT SET

CUSTOMER: ALLURE MKE

PROJECT #:
DRAWN BY: J. SUKKERT
SCALE: N/A

FILE SAVE AS: ALLURE MKE

PROJECT NAM

HVAC SYSTEM

SHEET TITLE:

TYPICAL NOTES

DWG NUMBER:

M8.0

IMC 506.3.7 - PROVIDE TYPE I COMMERCIAL KITCHEN EXHAUST SYSTEMS WITH A MINIMUM SLOPE OF 1/4 UNIT VERTICAL IN 12 UNITS HORIZONTAL TOWARD THE HOOD OR AN APPROVED GREASE RESERVOIR. WHERE HORIZONTAL DUCTS EXCEED 75 FEET IN LENGTH, THE SLOPE MUST A HAVE A MINIMUM SLOPE OF 1 UNIT VERTICAL IN 12 UNITS HORIZONTAL.

IMC 506.3.8 & 9 - DUCT CLEAN-OUT OPENINGS FOR COMMERCIAL KITCHEN GREASE EXHAUST DUCTS OF SIZE AND LOCATIONS AS REQUIRED BY THIS CODE SECTION. ADDITIONALLY, A CLEANOUT SHALL BE PROVIDED FOR BOTH THE INLET SIDE AND OUTLET SIDE OF ANY INLINE FAN. SUCH CLEANOUTS ARE TO BE LOCATED WITHIN 3FT OF THE FAN DUCT CONNECTIONS.

IMC 603.9 - DUCTWORK SHALL BE SEALED AT ALL JOINTS, TRANSVERSE AND LONGITUDINAL SEAMS AND CONNECTIONS IN DUCTWORK USING LISTED PRODUCTS AS REFERENCED IN THE CODE. THE REFERENCED DUCTWORK INCLUDES ALL SUPPLY, EXHAUST AND RETURN DUCTS. THIS IS APPLICABLE TO ALL DUCTWORK OTHER THAN THAT USED AS PART OF THE KITCHEN HOOD EXHAUST DUCT.

IMC 506.3.12 - GREASE DUCT FIRE RESISTIVE ACCESS OPENINGS PROVIDED WITH APPROVED SIGNAGE WITH THE WORDING "ACCESS PANEL. DO NOT OBSTRUCT".

IMC 506.3.13.1 - PROVIDE A TYPE I KITCHEN EXHAUST OUTLET, WHICH TERMINATES ABOVE THE ROOF, WITH A DISCHARGE A MINIMUM OF 40" ABOVE THE ROOF SURFACE.

IMC 506.5.3 - UPBLAST FANS ASSOCIATED WITH TYPE I COMMERCIAL KITCHEN HOODS SHALL BE HINGED AND SUPPLIED WITH A FLEXIBLE WEATHER PROOF ELECTRICAL CABLE TO PERMIT INSPECTION AND CLEANING. THE DUCTWORK SHALL EXTEND A MINIMUM OF 18" ABOVE THE ROOF SURFACES.

IMC 507.4.1 - ALL TYPE I AND II COMMERCIAL KITCHEN HOODS SHALL OVERHANG OR EXTEND A HORIZONTAL DISTANCE OF NOT LESS THEN A 6" BEYOND THE EDGE OF THE COOKING SURFACE ON ALL OPEN SIDES.

IBC 906/IFC 904.12.5 - PROVIDE PORTABLE K-RATED FIRE EXTINGUISHERS WITHIN 30FT TRAVEL DISTANCE OF COMMERCIAL TYPE COOKING EQUIPMENT.

IMC/SPS 364.0313 (3) - ALL OPERATING MANUALS CONCERNING THE HVAC EQUIPMENT AND ITS MAINTENANCE SHALL BE PRESENTED TO THE OWNER AND SHALL BE MADE AVAILABLE TO A DEPARTMENT REPRESENTATIVE UPON REQUEST.

#### WALTERS SHEET METAL CORP

533 SOUTH 94TH STREET MILWAUKEE, WI 53214 PHONE: 414-443-1980 FAX: 414-443-1985 WWW.WALTERSSHEETMETAL.COM

CUSTOMER INFO

#### **ALLURE MKE**

789 N. JEFFERSON ST. MILWAUKEE. WI 53202

PROJECT NOTES

# DATE DESCRIPTION
0 06/01/21 PERMIT SET

USTOMER: ALLURE MKE

PROJECT #:
DRAWN BY: J. SUKKERT
SCALE: N/A

FILE SAVE AS: ALLURE MKE

PROJECT NAM

HVAC SYSTEM

SHEET TIT

TYPICAL NOTES

DWG NUMBER:

M9.0

#### **EXHAUST HOOD NOTES**

EXHAUST RATE IS SIZED IN ACCORDANCE WITH IMC-2015 SEC. 507.1 WHICH ALLOWS SIZING THROUGH THE HOODS' UL-710 LISTING AND LABELING. EACH EXHAUST HOOD IS UNDERWRITERS LABORATORIES (UL) LISTED AND LABELED. EXHAUST RATE IS SIZED TO MEET OR EXCEED THE U.L. TESTING AND LISTING LEVELS.

THE MODEL XBEW-72-S IS UL LISTED FOR AN EXHAUST RATE OF 233 CFM/LINEAR FOOT OF HOOD.

TOTAL HOOD LENGTH = 6' - 0"

6FT x 233 CFM/FT = 1,400 CFM. ACTUAL EXHAUST = 1,400 CFM

100% OF EXHAUSTED AIR IS SUPPLIED BACK INTO KITCHEN AREA THROUGH HOOD MOUNTED PERFORATED PLENUMS AND DIFFUSERS.
DIRECT FIRED MAKE-UP AIR UNIT PROVIDED TO TEMPER AIR TO A MIN. OF 70 DEG. F. SEE SUPPLY UNIT NOTES.

FIRE SYSTEM BY OTHERS.

EVIDENCE OF APPROVAL TO BE AVAILABLE AT JOBSITE.

#### **SUPPLY UNIT NOTES**

MAKE-UP AIR IS PROVIDED THROUGH A CAPTIVE-AIR MODEL XUEF-12 DIRECT FIRED MAKE-UP AIR UNIT.

UNIT IS U.L. LISTED AND LABELED.
UNIT OUTPUT = 1,400 CFM. AND 138.1 MBH.
CALC = 1,400 CFM x 1.08 x 90 DEGREE RISE = 138.1 MBH.
UNIT OUTPUT = 1.400 CFM. AND 138.1 MBH.

FLAME SAFETY, AIR FLOW, HIGH TEMP SAFETY DEVICES INCLUDED.
DISCHARGE DUCTSTAT PROVIDED.

UNIT INTERLOCK WITH EXHAUST FANS BY JOBSITE ELECTRICIAN.

AIR INTAKE IS A MINIMUM OF 10' - 0" FROM ALL EXHAUSTS.

#### **AIR BALANCE**

- EXHAUST FAN = 1,400 CFM
- + MAKE-UP AIR UNIT = 1,400 CFM

= BALANCE = 0 CFM

#### **DUCT SPECS**

EXHAUST TO BE 16GA BLACK IRON WITH ALL SEAMS AND JOINTS LIQUID TIGHT.
ASTM E-2336 2-LAYER UL-LISTED GREASE DUCT INSULATION PROVIDED WHERE WITH 18" OF COMBUSTIBLES.

HIGH TEMP. GASKETED CLEAN-OUTS PROVIDED AT EACH CHANGE IN DUCT DIRECTION PER IMC-2015.
SUPPLY DUCT TO BE GALVANIZED AND FLEX WITH INSULATION PROVIDED IN UNHEATED SPACES.

#### WALTERS SHEET METAL CORP

533 SOUTH 94TH STREET MILWAUKEE, WI 53214 PHONE: 414-443-1980 FAX: 414-443-1985 WWW.WALTERSSHEETMETAL.COM

CUSTOMER INFO:

#### **ALLURE MKE**

789 N. JEFFERSON ST. MILWAUKEE, WI 53202

PROJECT NOTES:

EVISIONS

# DATE DESCRIPTION

0 06/01/21 PERMIT SET

CUSTOMER: ALLURE MKE

PROJECT #:
DRAWN BY: J. SUKKERT
SCALE: N/A

FILE SAVE AS: ALLURE MKE

PROJECT NAME:

HVAC SYSTEM

SHEET TITLE:

TYPICAL NOTES

DWG NUMBER:

M10.0