
MCKINLEY SCHOOL RENOVATION

2001 W. VLIET ST. MILWAUKEE, WI 53208

HPC SUBMITTAL

NOVEMBER 17, 2020 DATE: PROJECT NUMBER: 10031.06.02

LOCATION MAP:

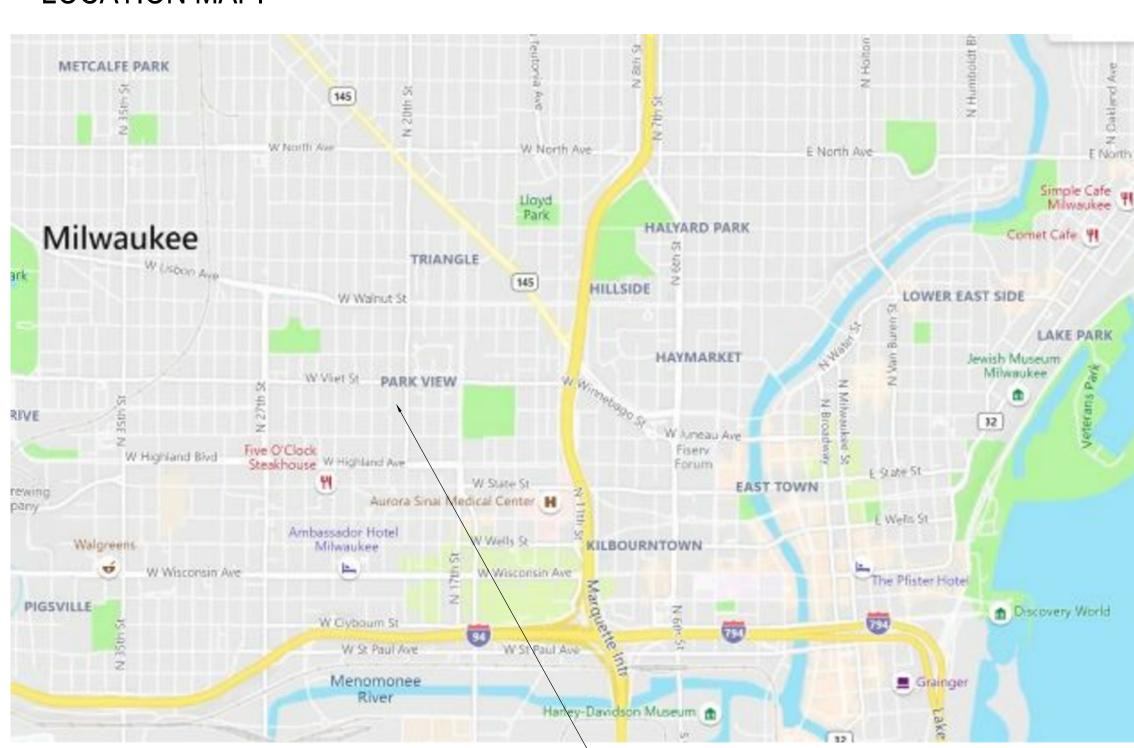

LOCATION

ARCHITECTURAL QUORUM ARCHITECTS, INC.

CONTACT INFORMATION:

3112 West Highland Boulevard Milwaukee, WI 53208 Phone: (414) 265-9265 Fax: (414) 265-9465 Contact: Matthew Edwards Email: Matthew@quorumarchitects.com DRAWING INDEX:

CS COVER SHEET

ARCHITECTURAL L1.1 SITE PLAN

DO.O SITE DEMOLITION PLAN LOWER LEVEL DEMOLITION PLAN FIRST FLOOR DEMOLITION PLAN

SECOND FLOOR DEMOLITION PLAN ROOF DEMOLITION PLAN EXTERIOR DEMOLITION ELEVATIONS

EXTERIOR DEMOLITION ELEVATIONS EXTERIOR DEMOLITION ELEVATIONS D3.4 EXTERIOR DEMOLITION ELEVATIONS

A1.0 LOWER LEVEL FLOOR PLAN FIRST FLOOR PLAN A1.2 SECOND FLOOR PLAN A1.3 ATTIC FLOOR PLAN

A1.4 ROOF PLAN A3.1 EXTERIOR ELEVATIONS A3.2 EXTERIOR ELEVATIONS A3.3 EXTERIOR ELEVATIONS

A3.4 EXTERIOR ELEVATIONS

HISTORIC WINDOW REPLACEMENT HISTORIC WINDOW REPLACEMENT DETAILS HISTORIC WINDOW REPLACEMENT DETAILS HISTORIC WINDOW REPLACEMENT DETAILS

HISTORIC WINDOW REPLACEMENT DETAILS HISTORIC WINDOW REPLACEMENT DETAILS INTERIOR BORROWED LIGHT REFURBISHMENT DETAILS NON-HISTORIC WINDOW REPLACEMENT DETAILS AT NORTH ANNEX


A5.9 ATTIC WINDOW REPLACEMENT DETAILS

A8.0 DOOR SCHEDULE






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MCKINLEY SCHOOL RENOVATION

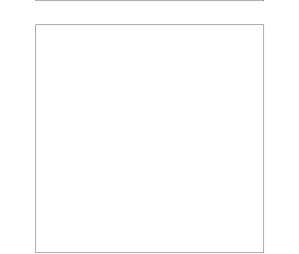HPC SUBMITTAL

Project No.: 10031.06.02 Date: 11/17/2020



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Date: 11/17/2020

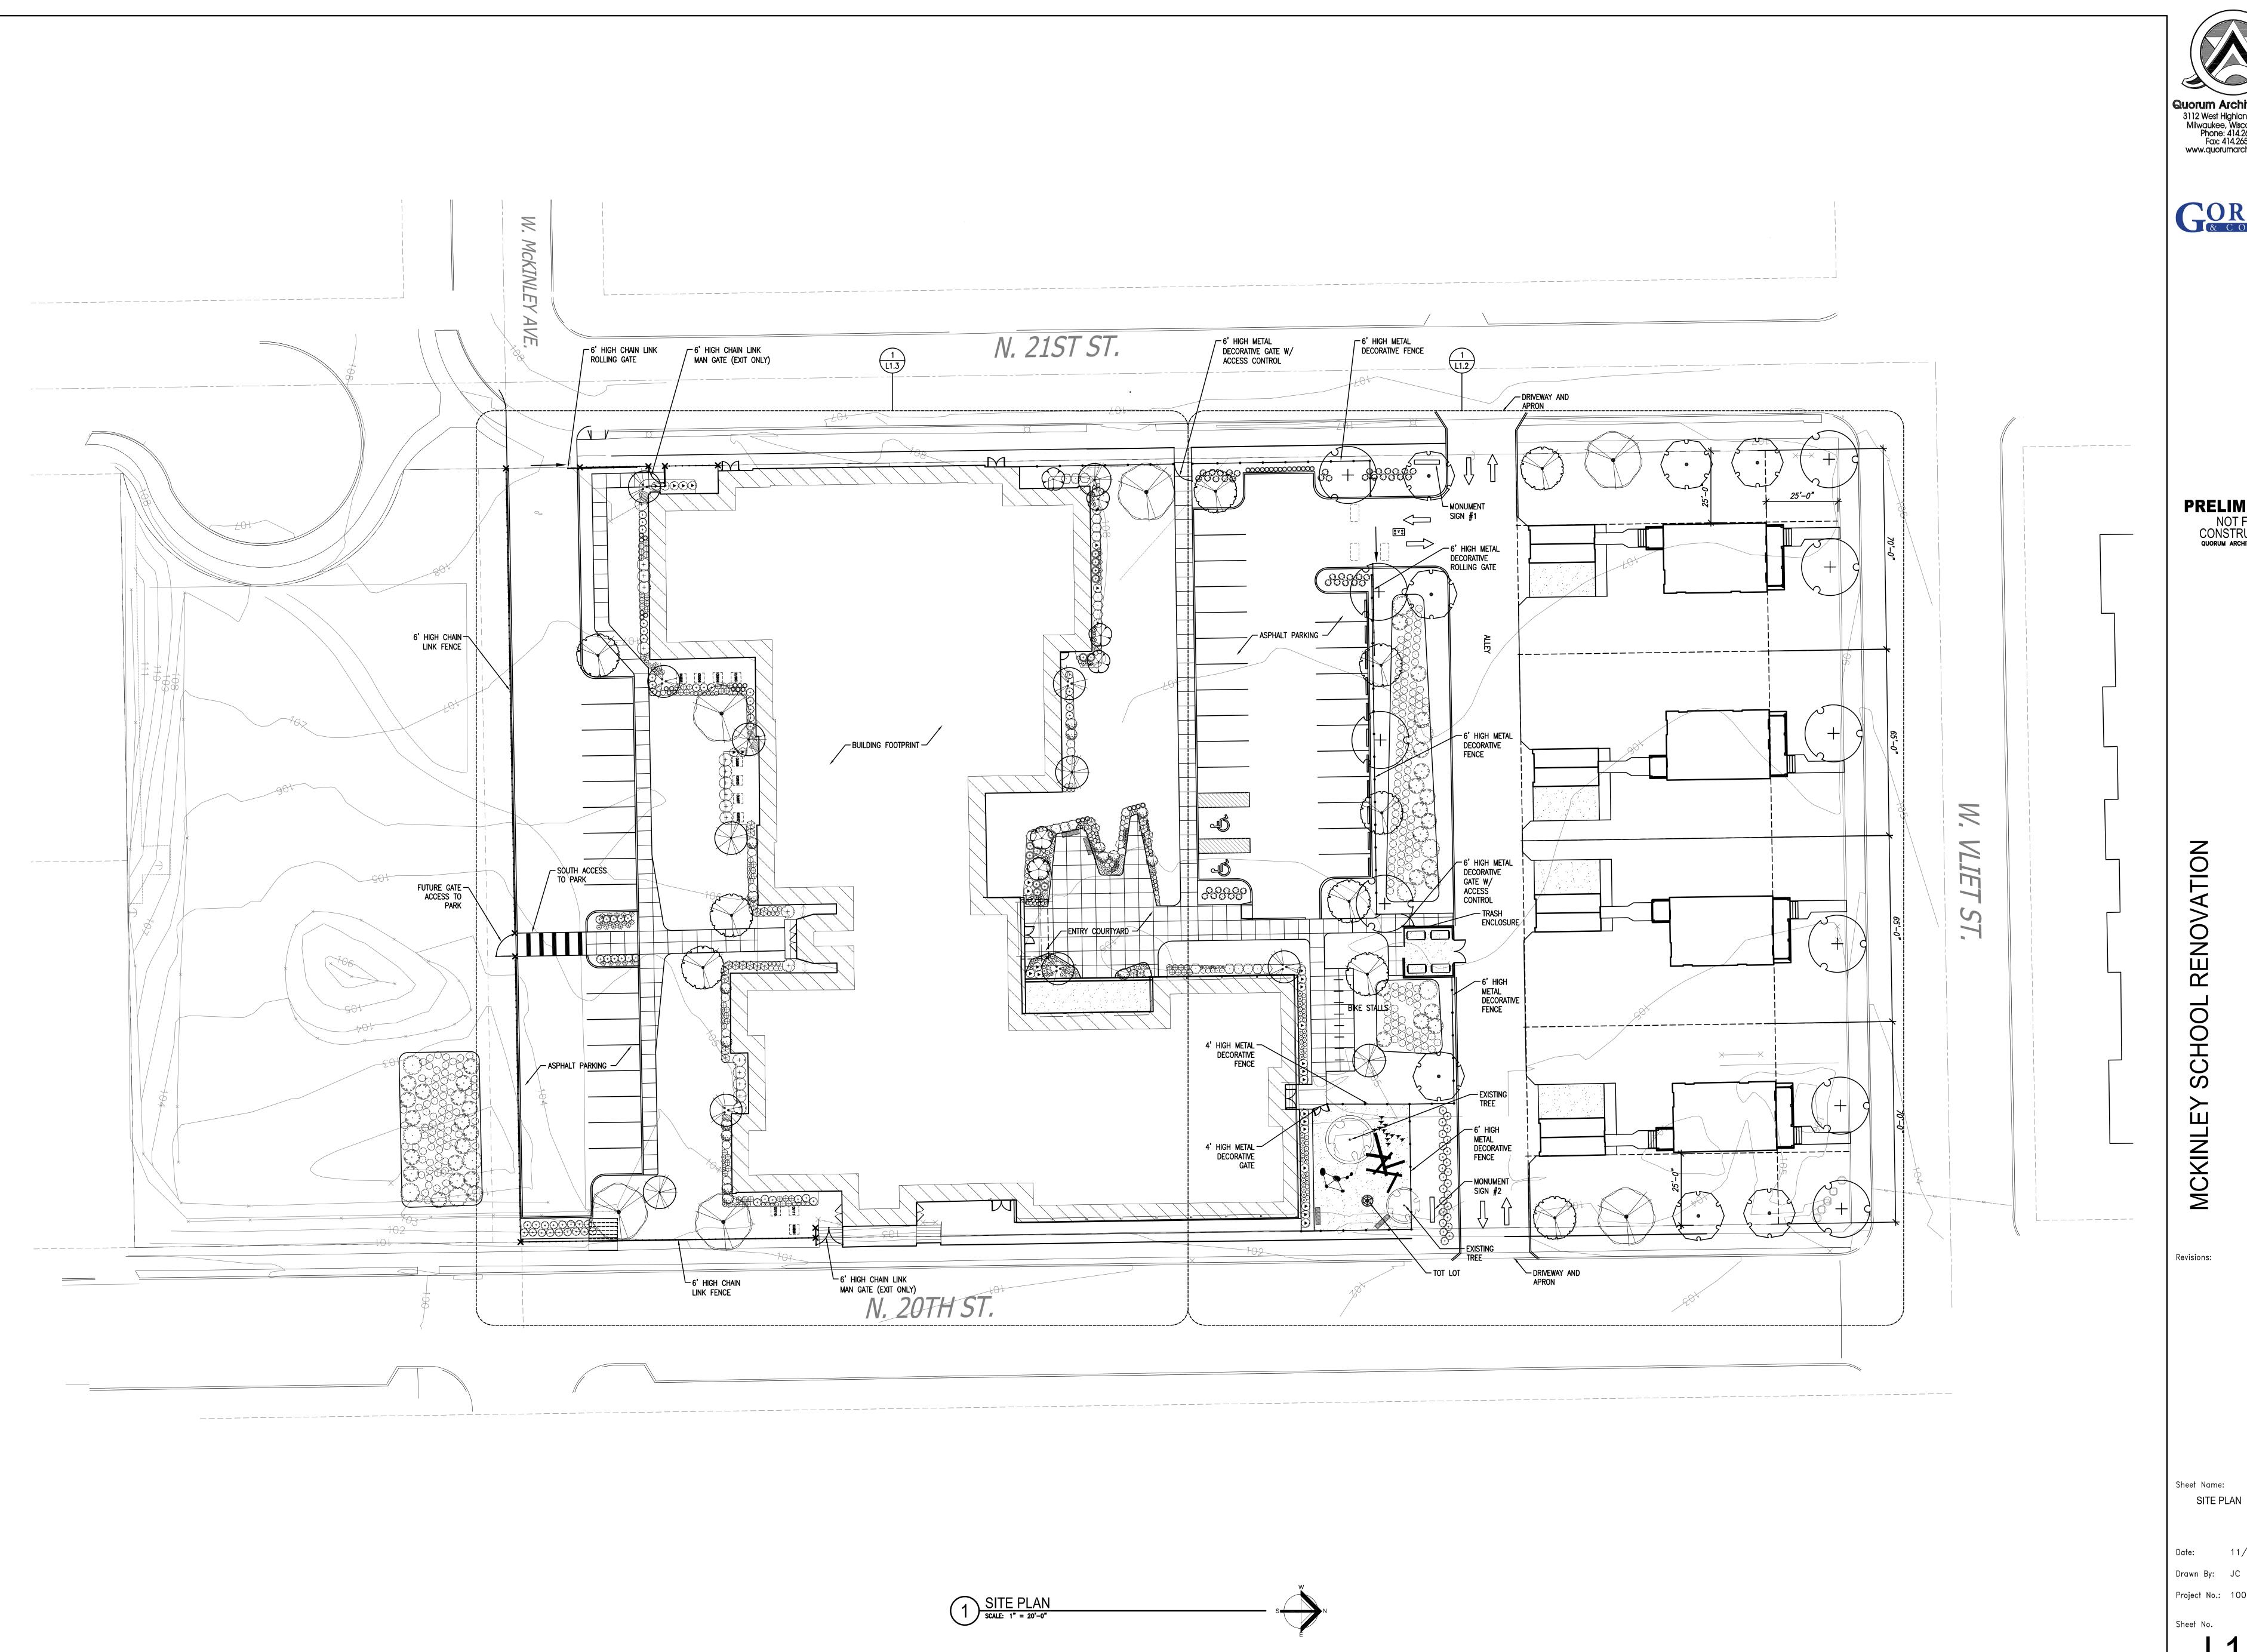Drawn By: JC

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GENERAL DEMOLITION NOTES

- COLLECT AND PALLETIZE AND EXISTING BRICK THAT HAS FALLEN FROM THE BUILDING
- EACH CONTRACTOR SHALL PROVIDE ADEQUATE, NECESSARY AND REQUIRED BARRICADES, FENCES AND SAFETY PRECAUTIONS FOR THE GENERAL PUBLIC'S SAFETY NEAR THE SITE. GENERAL CONTRACTOR SHALL PROVIDE ANY AND ALL TEMPORARY BARRICADES AND DUST BARRIERS AS REQUESTED BY THE OWNER.
- UTILITIES HAVE BEEN LOCATED BY OTHERS, ACTUAL LOCATIONS MAY DIFFER
- 4. REMOVE INVASIVE PLANT MATERIALS GROWING ON EXTERIOR OF BUILDING. DO NOT DAMAGE BRICK.

DEMOLITION NOTES

- REMOVE ALL PLANT MATERIAL WITHIN 5'-0" AT THE PERIMETER OF THE EXISTING BUILDING AND GRUB.
- REMOVE EXISTING TREE AND ALL RELATED PLANT MATERIALS IN LIGHT COURTS. GRIND OUT STUMP AND ROOTS.
- 3 NOT USED
- (4) REMOVE ALL PLAYGROUND EQUIPMENT.
- 5 REMOVE ASPHALT PLAYGROUND AND PARKING LOT.
- 6) REMOVE FLAG POLE AND FOOTING. 7) REMOVE BASKET BALL GOAL AND FOOTING.
- (8) REMOVE FENCE POST AND FOOTING.
- 9 REMOVE PILES OF MIXED DEBRIS OF SHINGLES AND GENERAL TRASH.
- 10) REMOVE LANDSCAPE TIMBERS

LEGEND

- INDICATES FOUND 1" IRON PIPE
 INDICATES SET 1" IRON PIPE
 + INDICATES FOUND CHISELED CROSS
 SANITARY MANHOLE
 ♦ SANITARY CLEANOUT OR VENT
 ♦ SEPTIC TANK ACCESS COVER M.I.S. MANHOLEUNKNOWN MANHOLE STORM MANHOLE
- INLET (ROUND)
 INLET (SQUARE)
 □ CURB INLET
 STORM SEWER END SECTION
- GAS VALVE
 GAS METER
 WATER VALVE
- ∀ HYDRANT₩ WATER MANHOLE♥ WATER SERVICE CURB STOP WELL HEAD

 STAND PIPE

 WALL INDICATOR VALVE
- FOST INDICATOR VALVE □ LIGHT POLE

 SPOT/YARD LIGHT

 UTILITY POLE

 GUY POLE


 GUY WIRE
- ELECTRIC MANHOLE
 ELECTRIC PEDESTAL
 ELECTRIC METER
 - TELEPHONE PEDESTAL CABLE PEDESTAL CONTROL BOX
 FIBER OPTIC SIGN
 TRAFFIC LIGHT
 COMMUNICATION MANHOLE

TELEPHONE MANHOLE

- □ BOLLARD→ SOIL BORING/MONITORING WELL
 - ▼ WATER SURFACE◆ WETLANDS FLAG MARSH
 FLAGPOLE

PARKING METER

SIGN 🖶 MAILBOX * RAILROAD CROSSING SIGNAL ♣ HANDICAP SPACE★ CONIFEROUS TREE☼ DECIDUOUS TREE

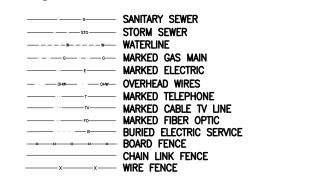



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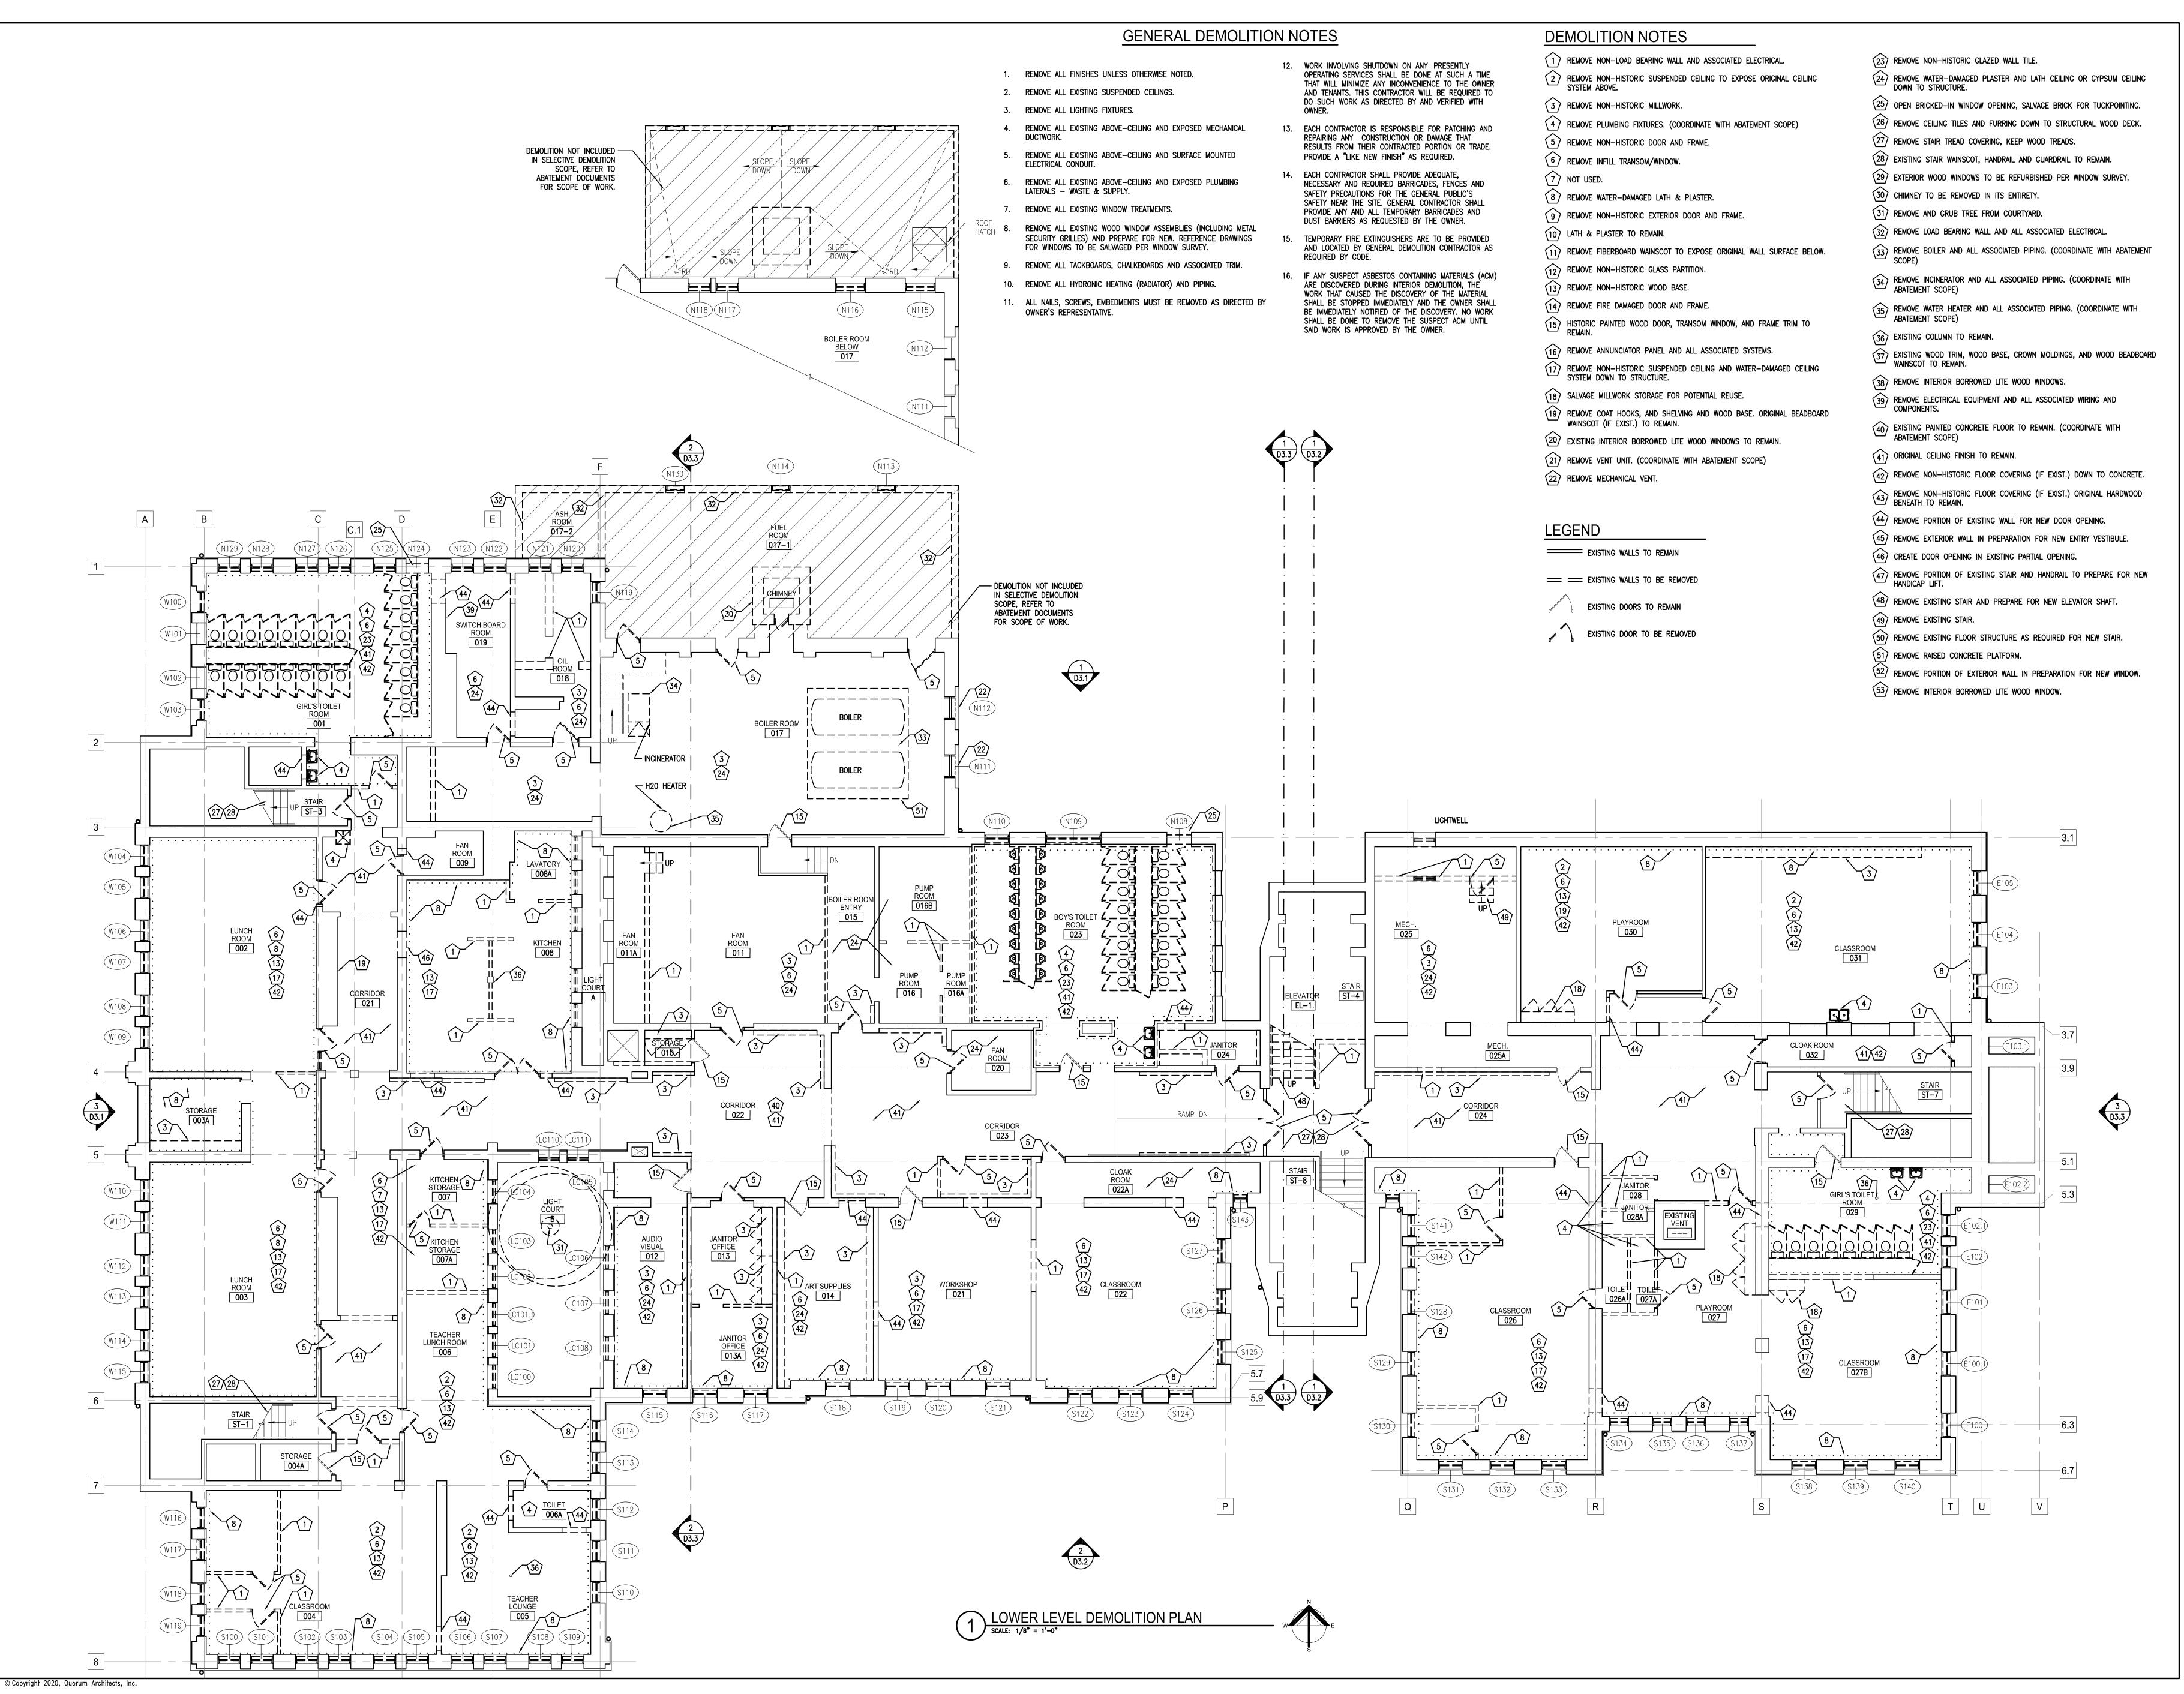
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Sheet Name: SITE DEMOLITION

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LOWER LEVEL

DEMOLITION PLAN


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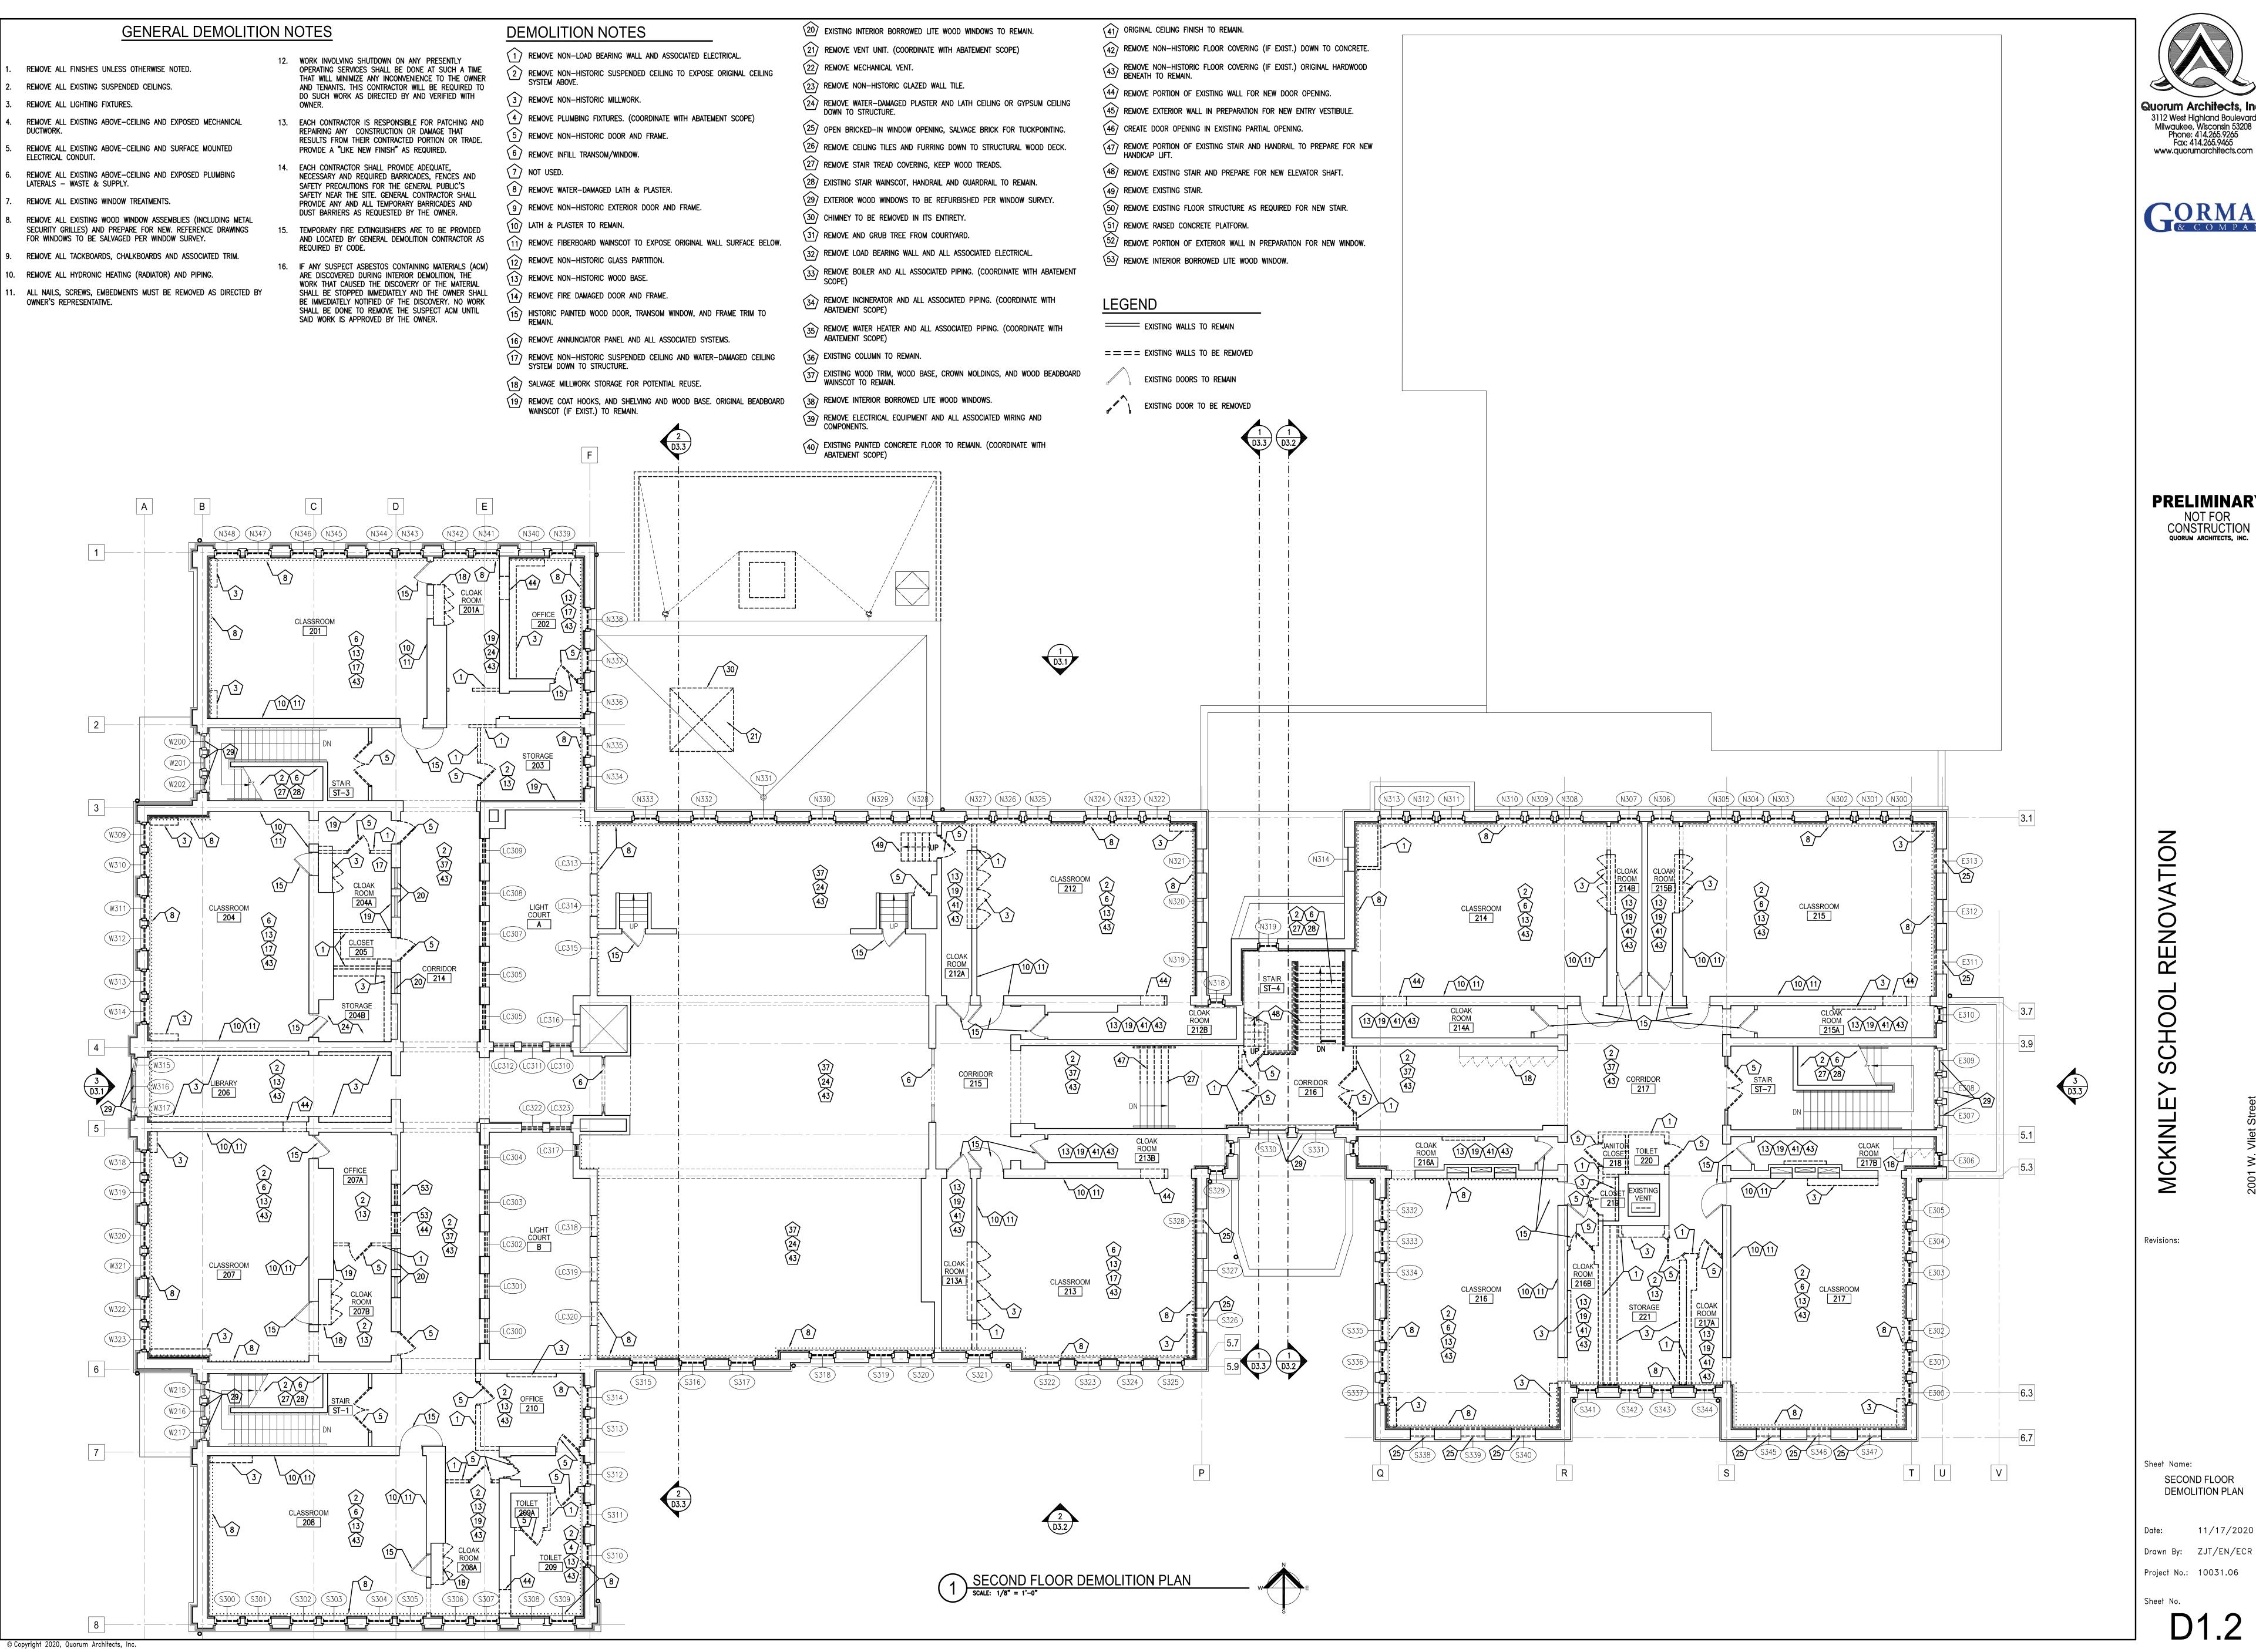


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FIRST FLOOR **DEMOLITION PLAN**

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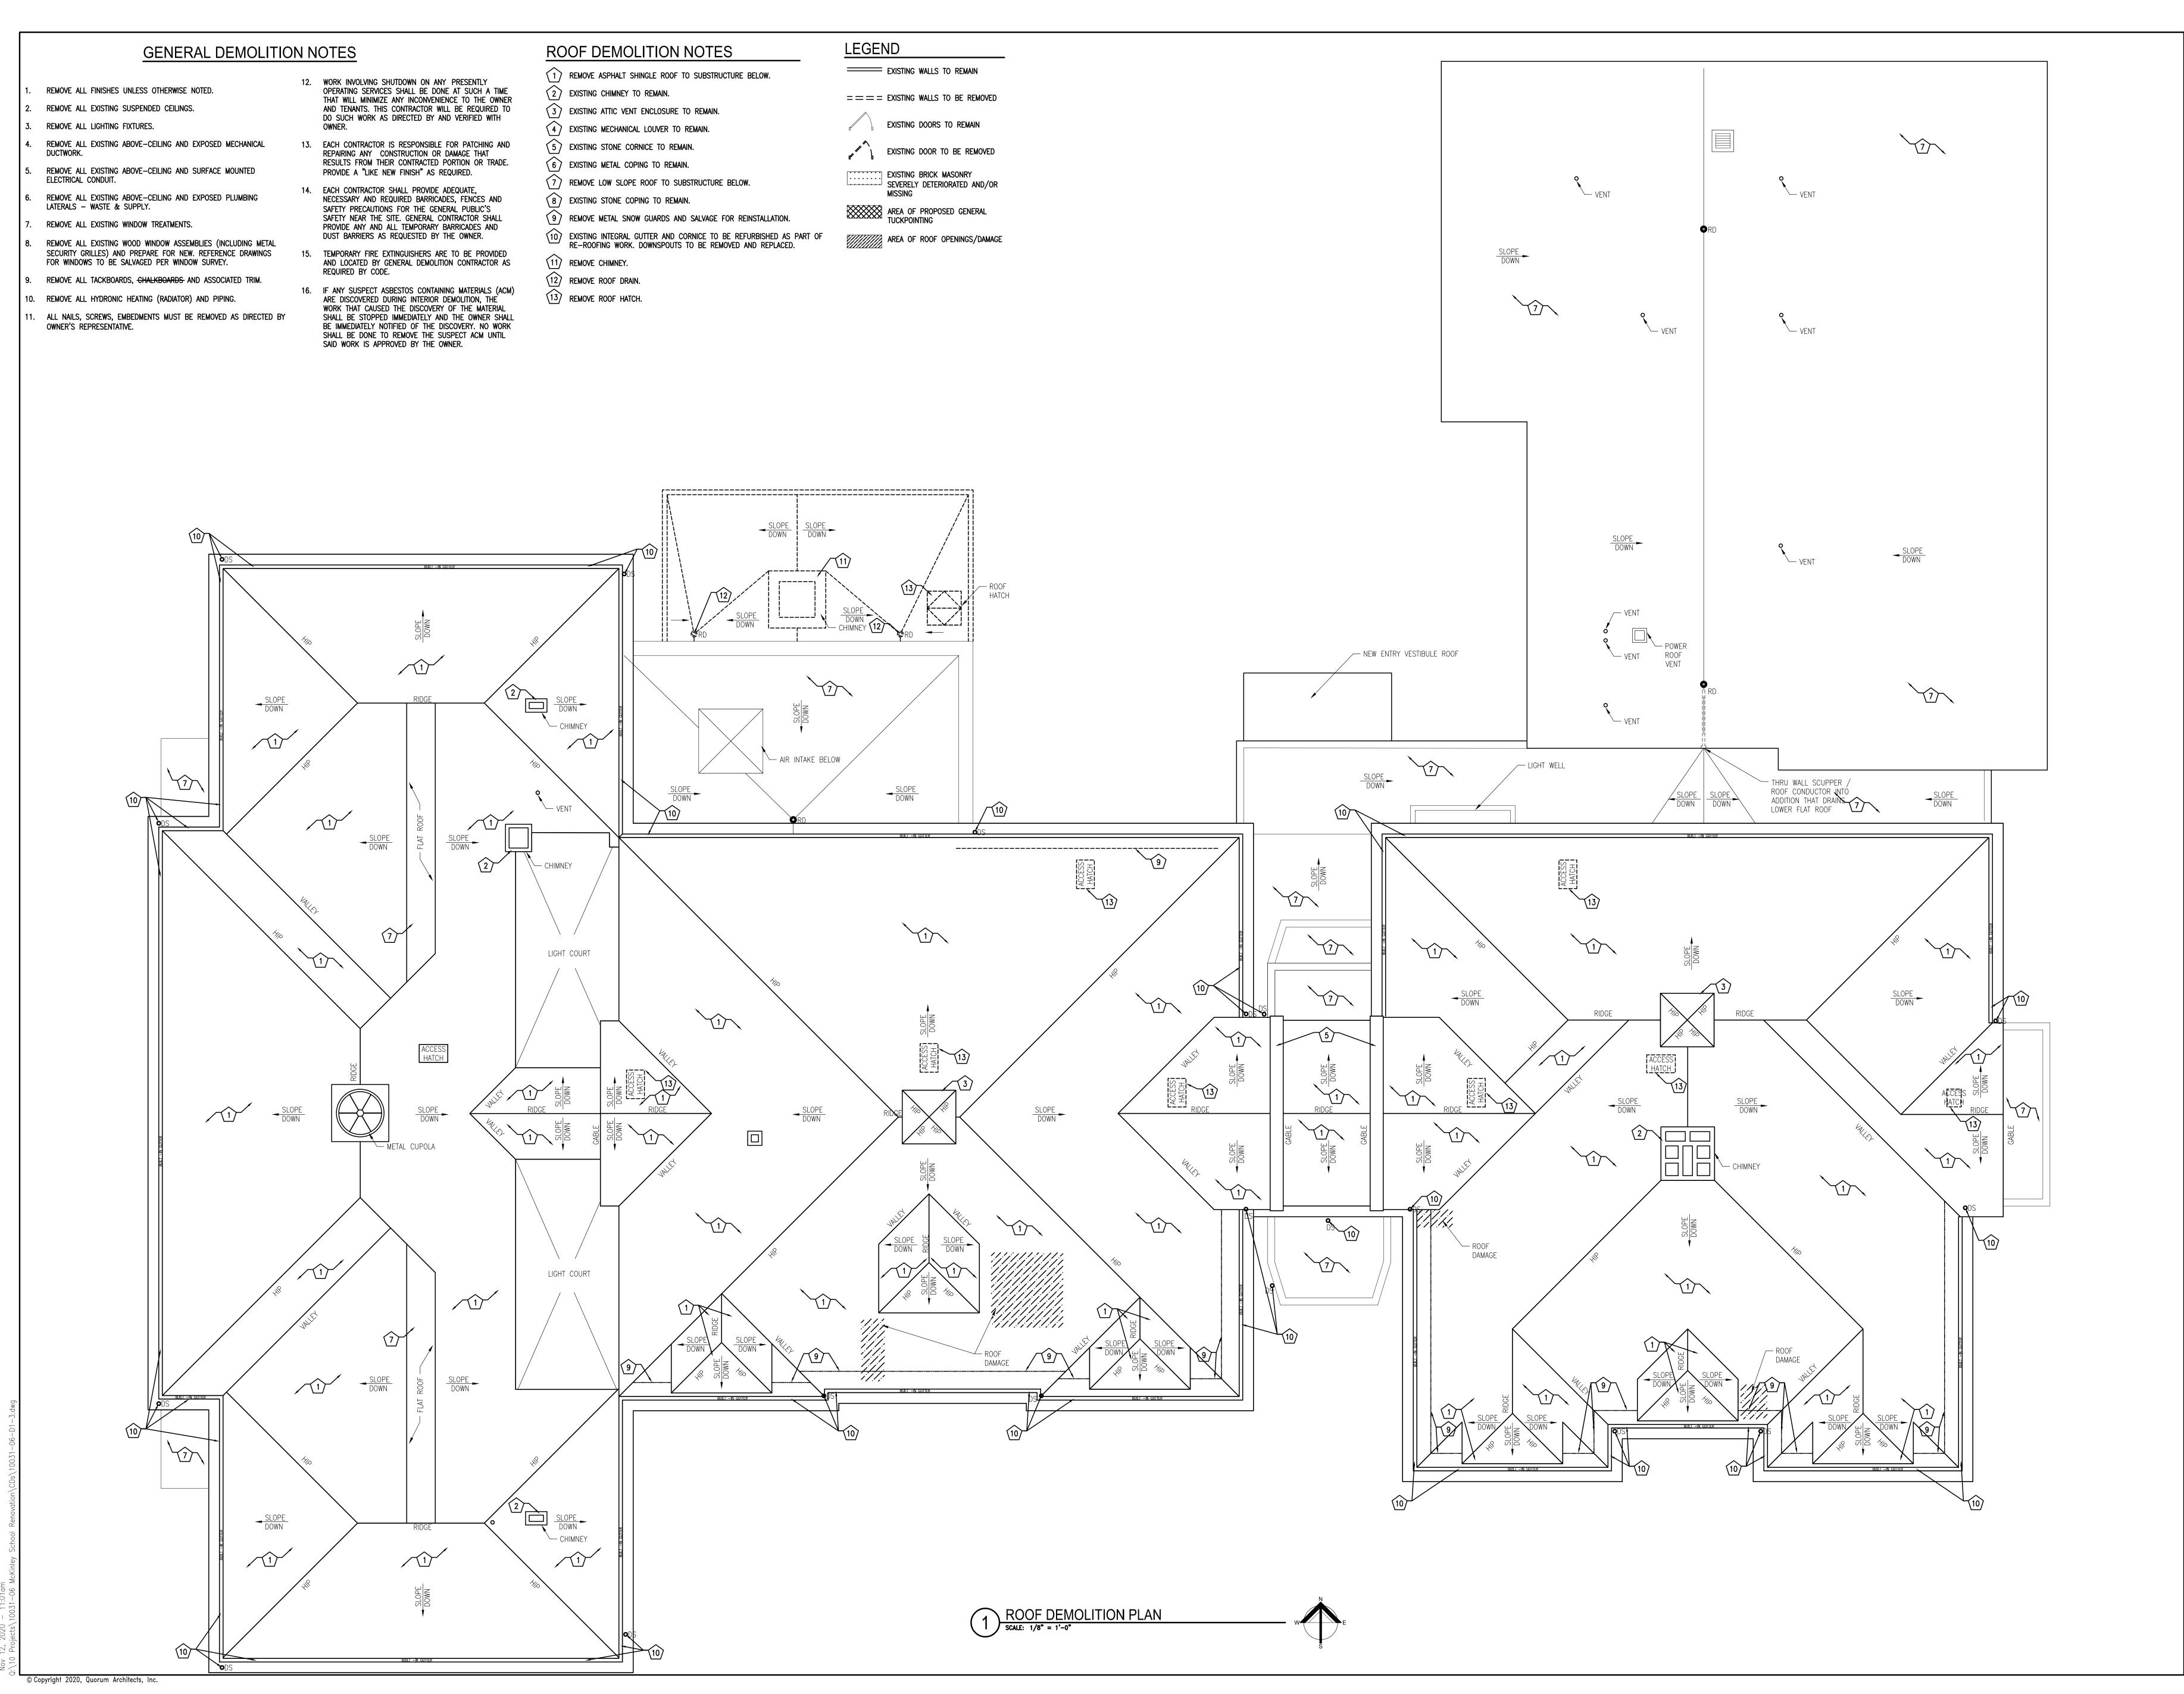
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Sheet Name: SECOND FLOOR **DEMOLITION PLAN**

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D1.2

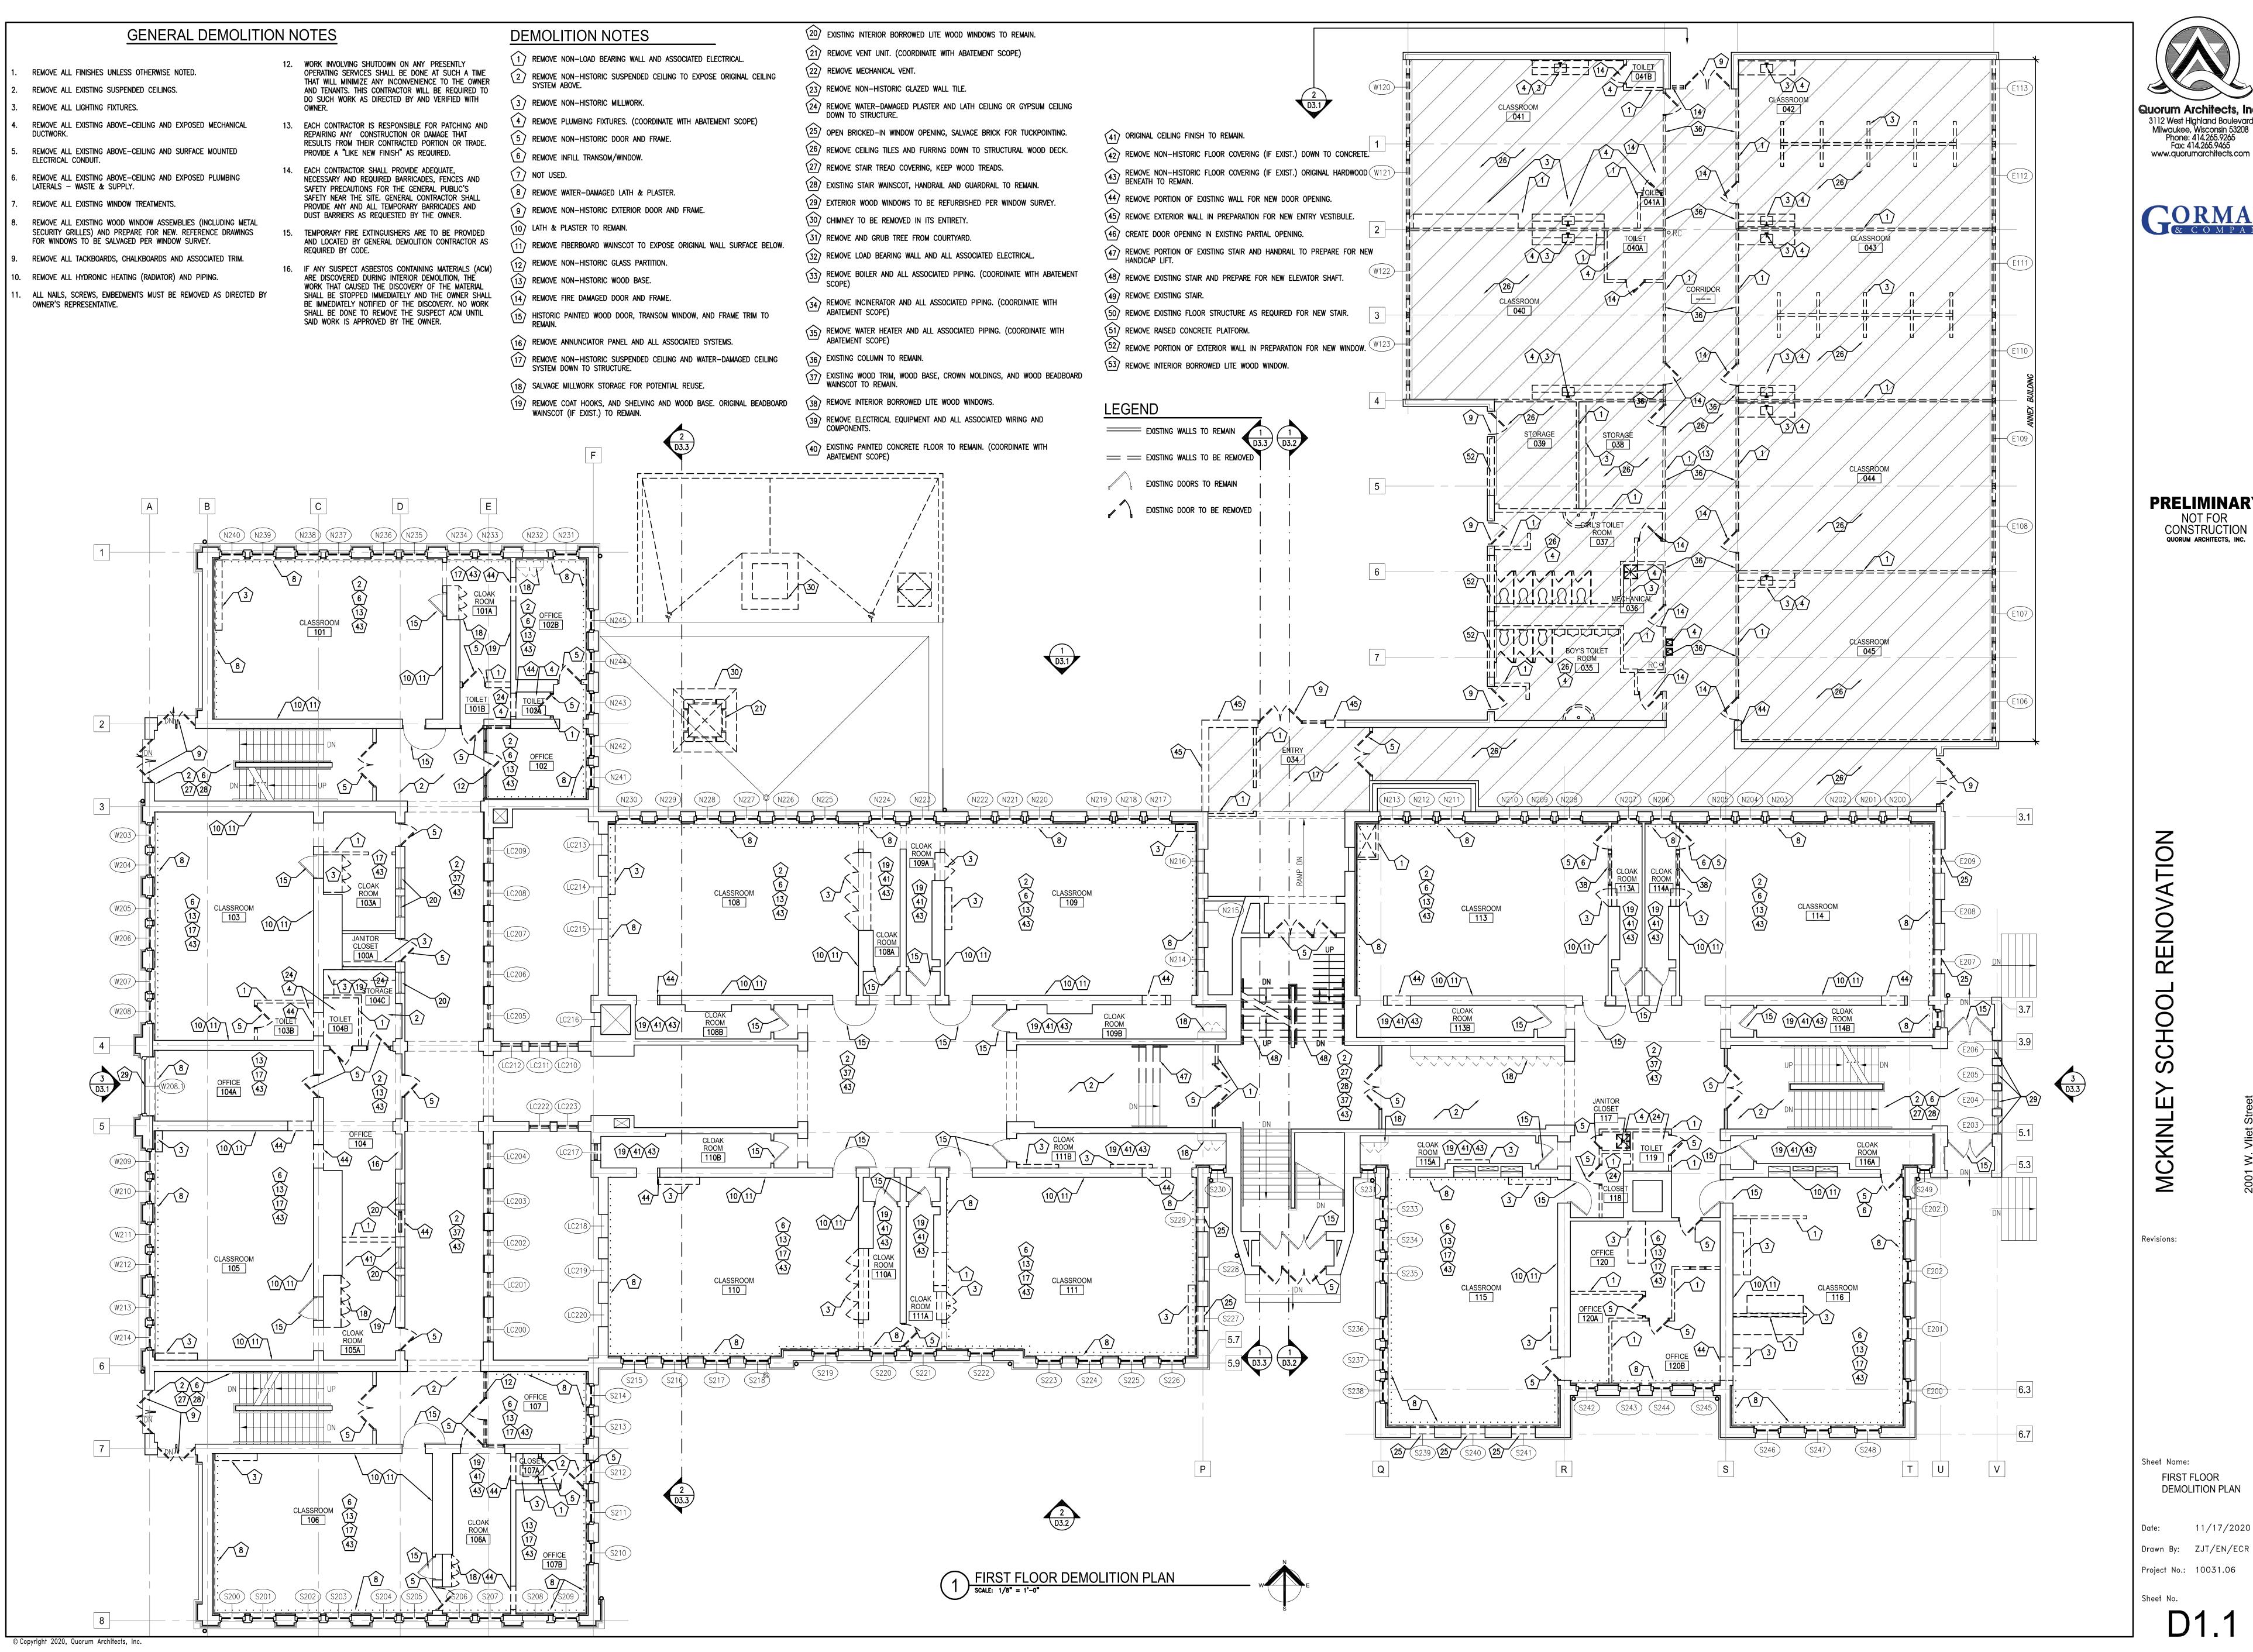

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าร:

Sheet Name:
ROOF
DEMOLITION PLAN


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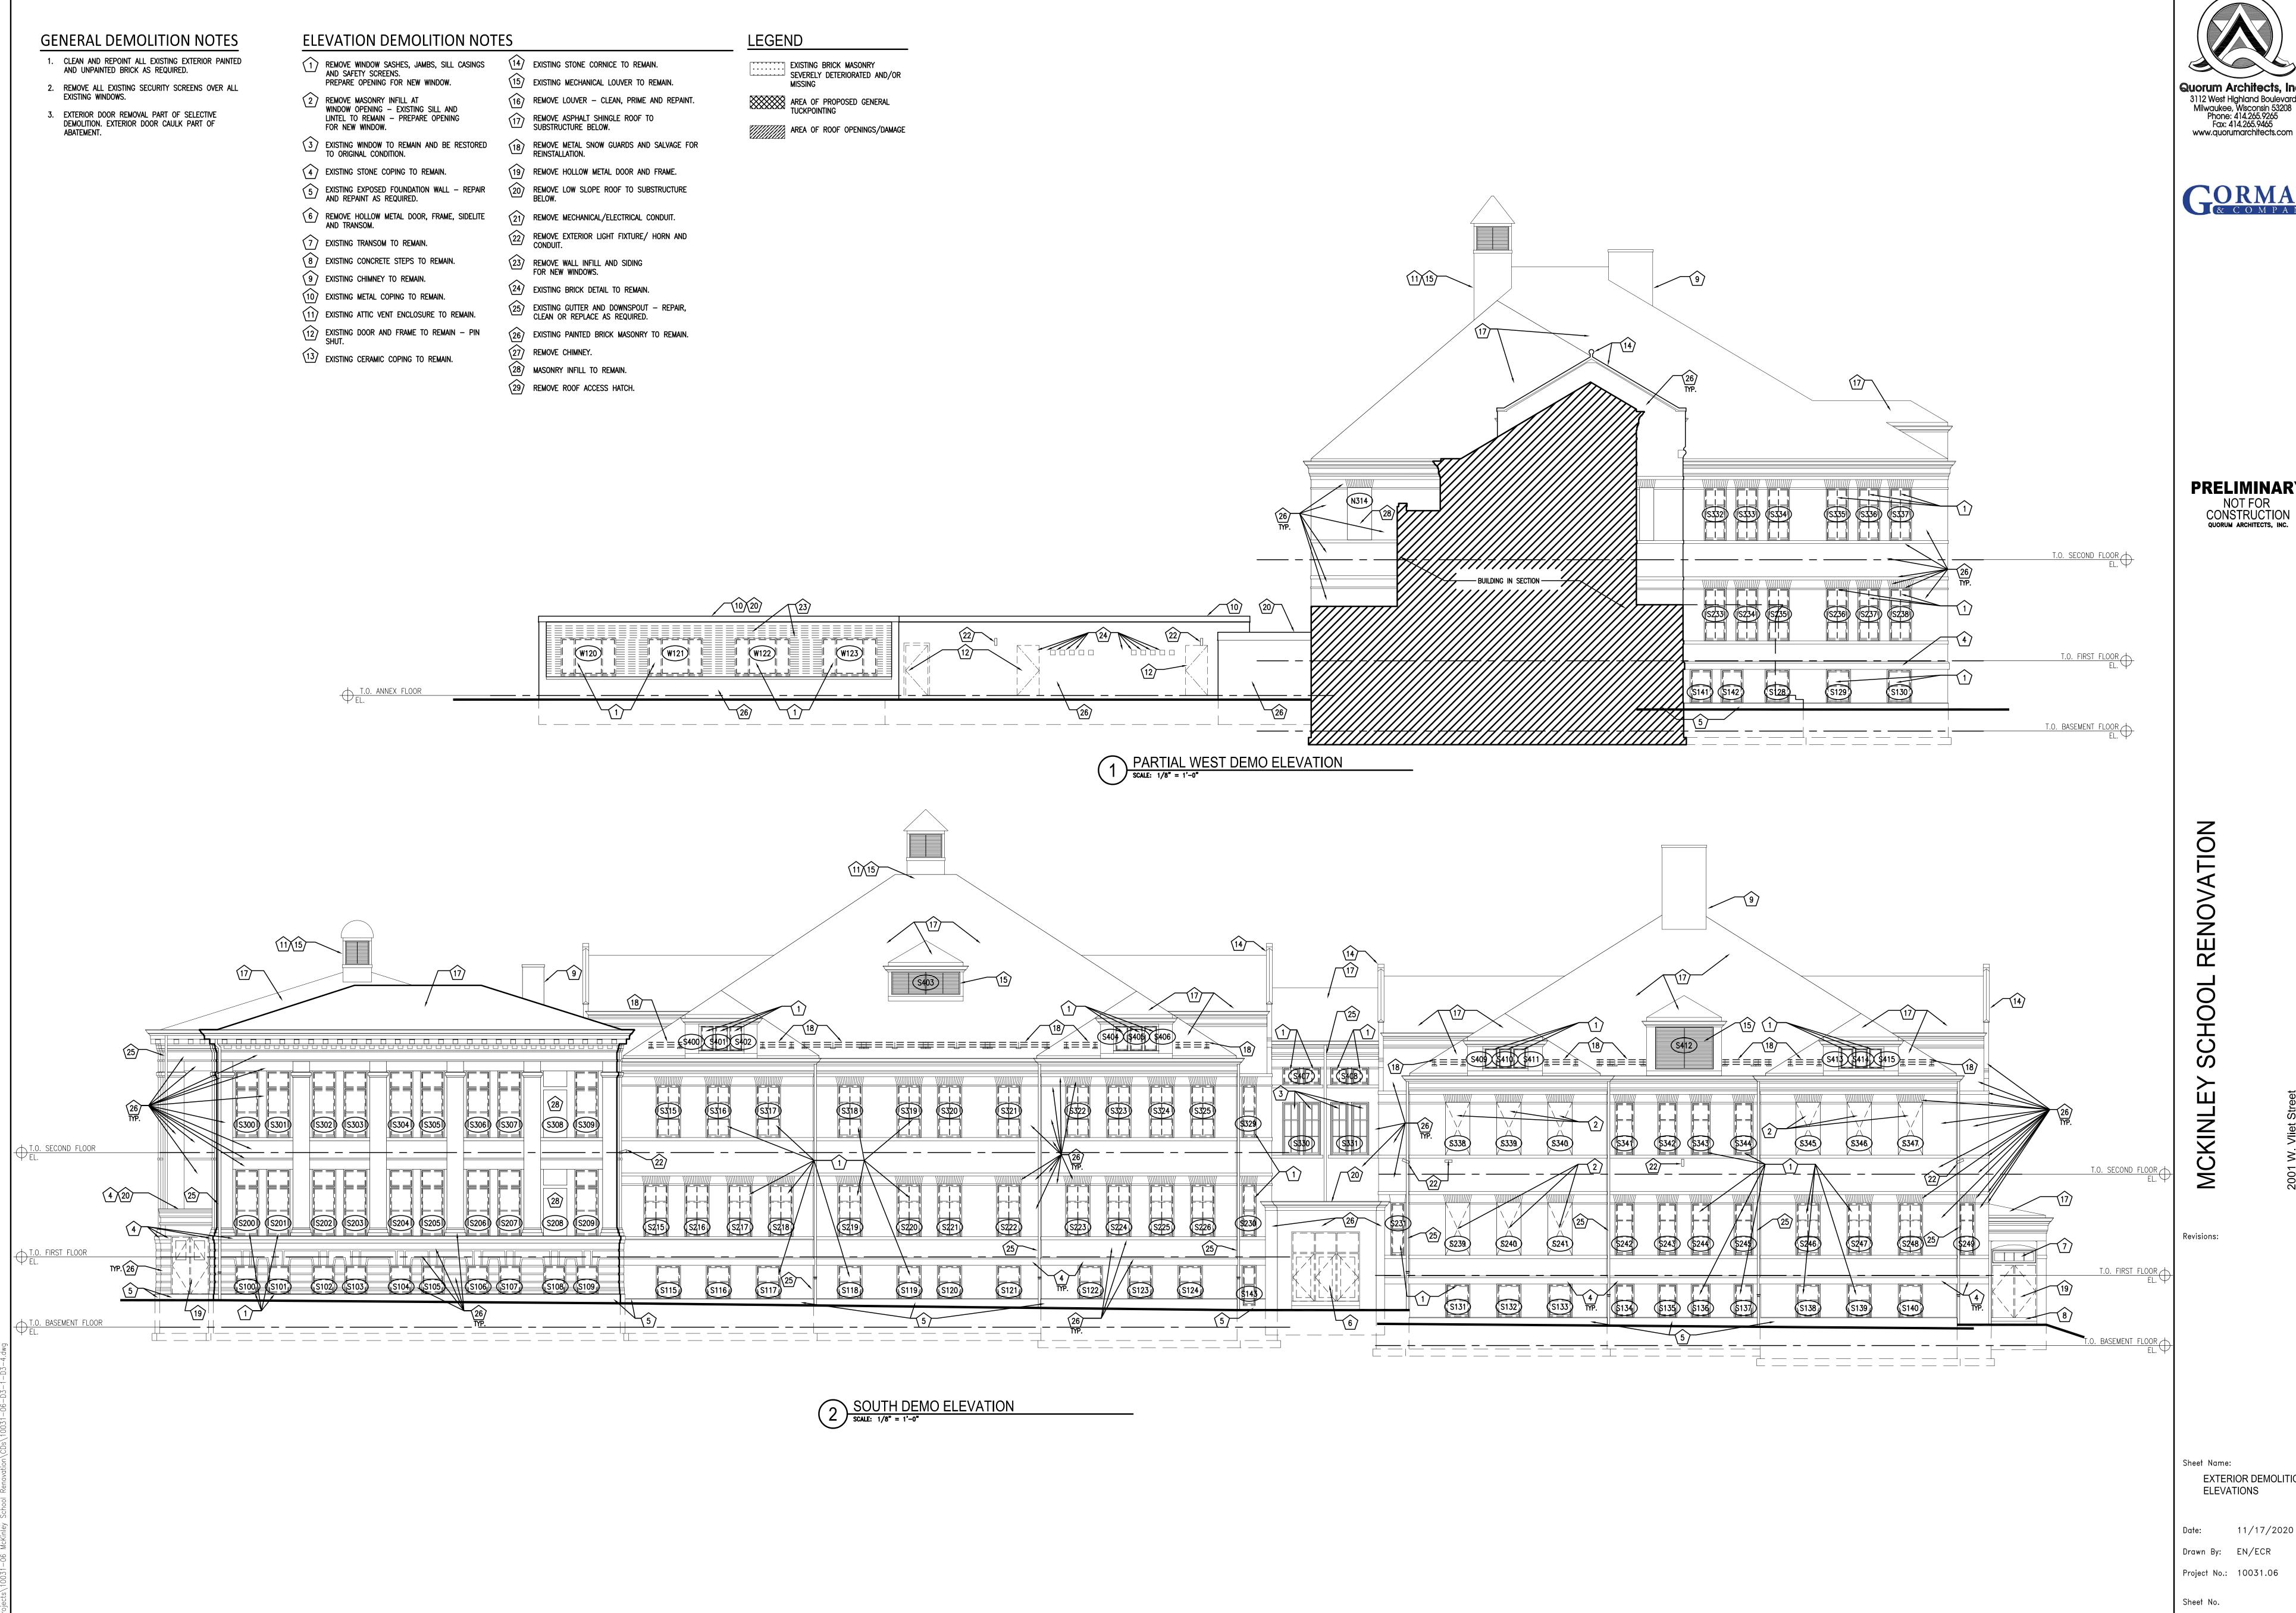
CONSTRUCTION

QUORUM ARCHITECTS, INC.

EXTERIOR DEMOLITION

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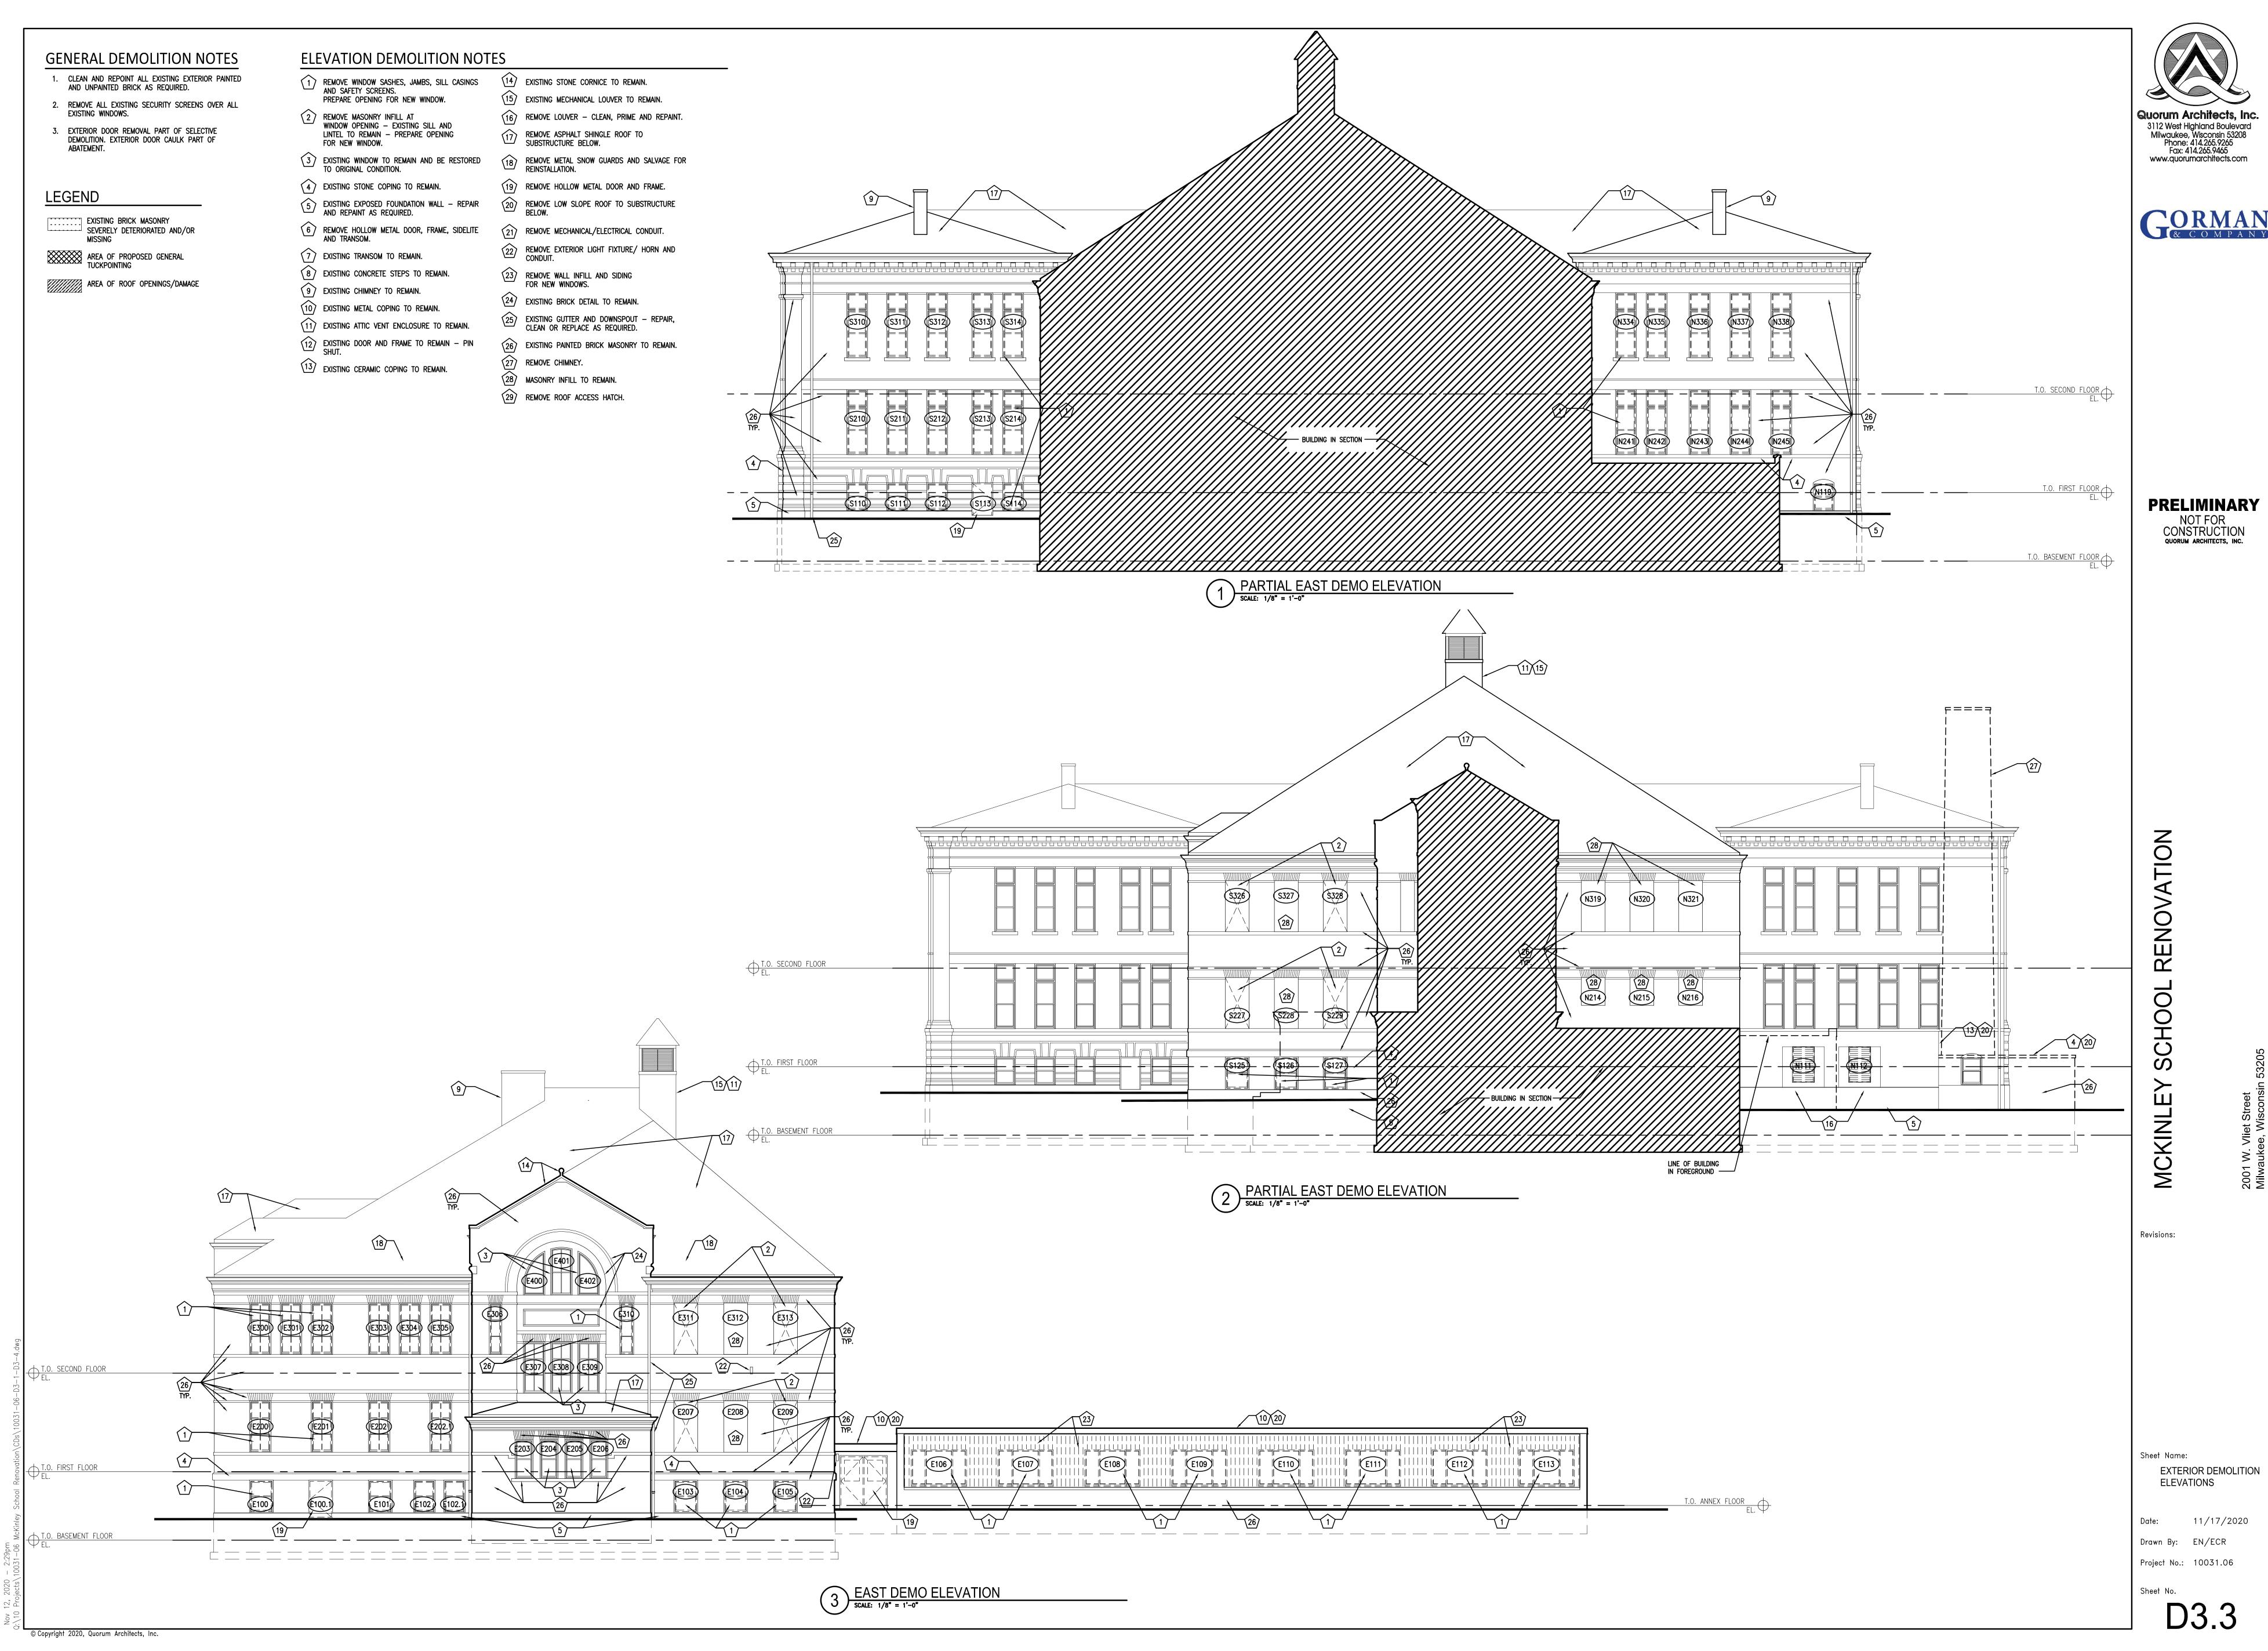
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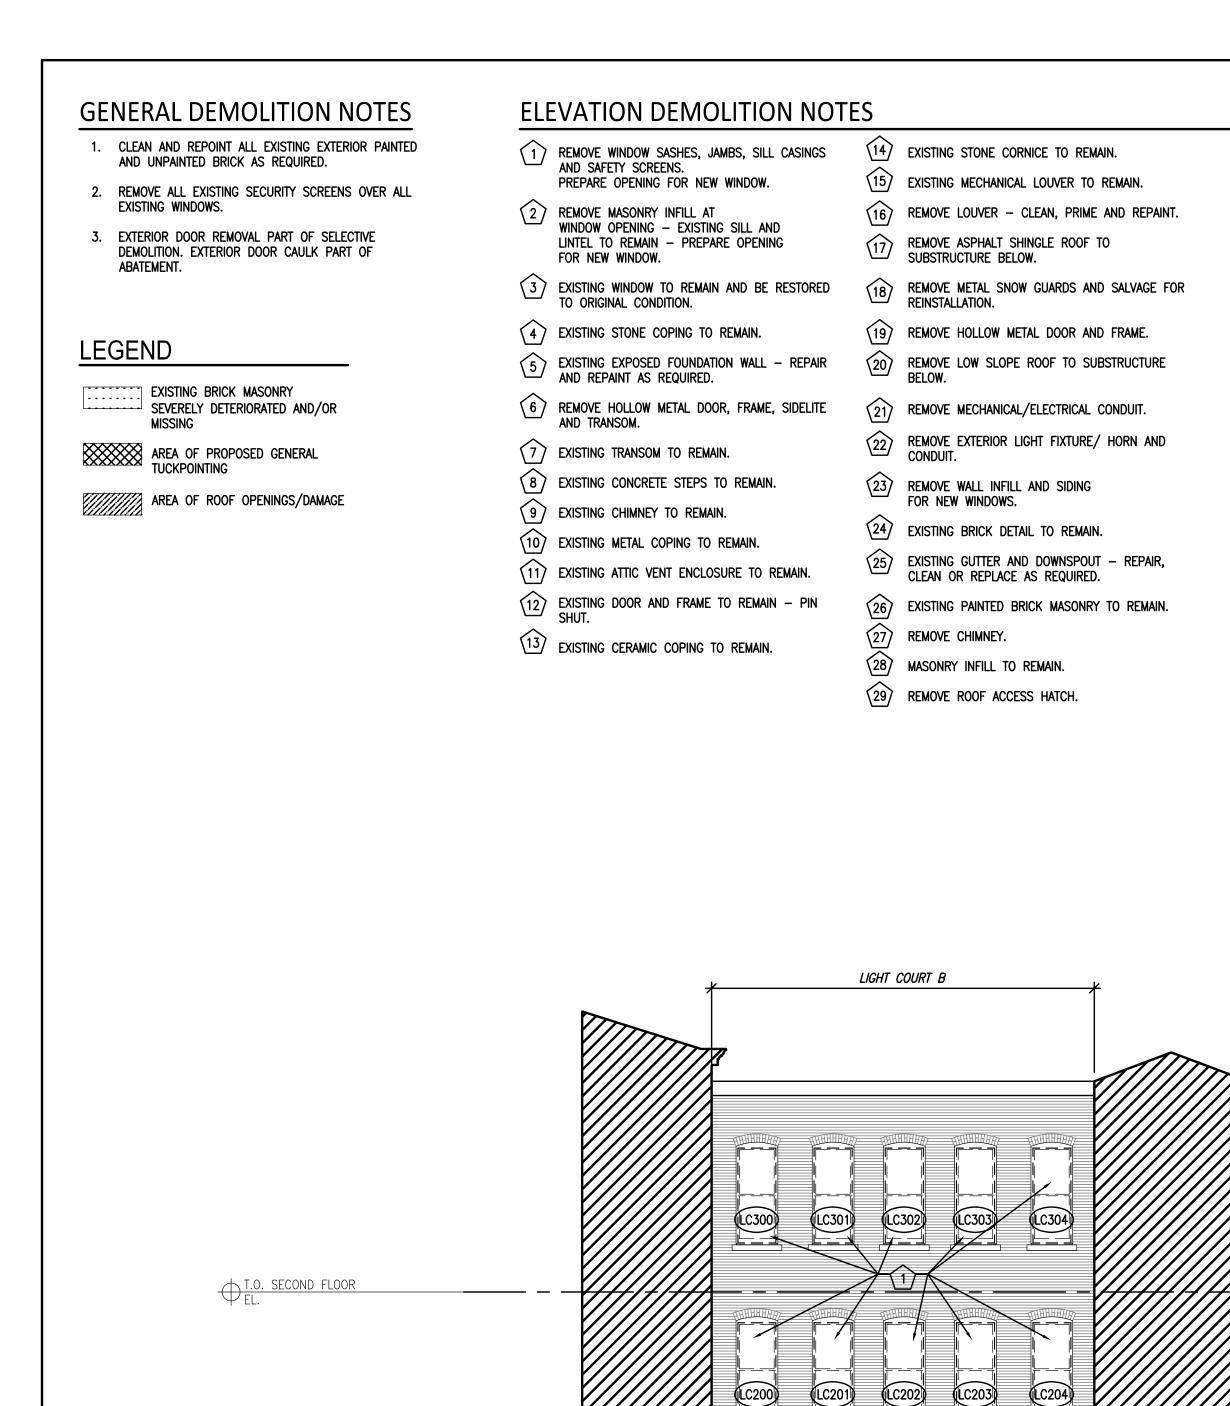
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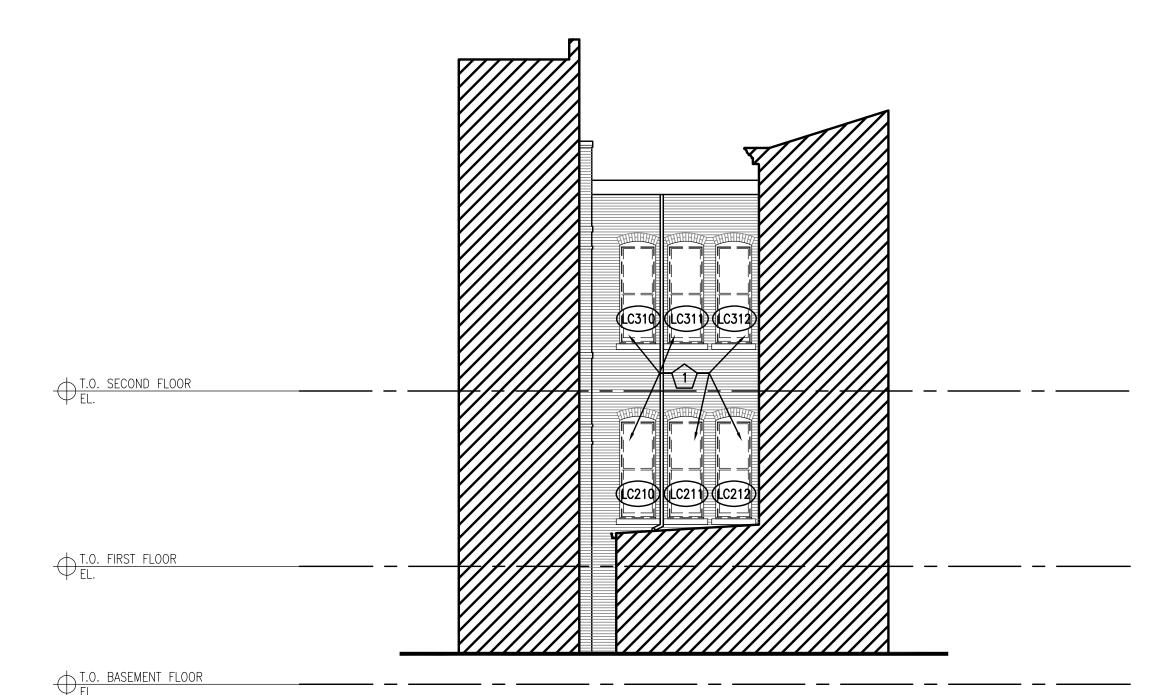
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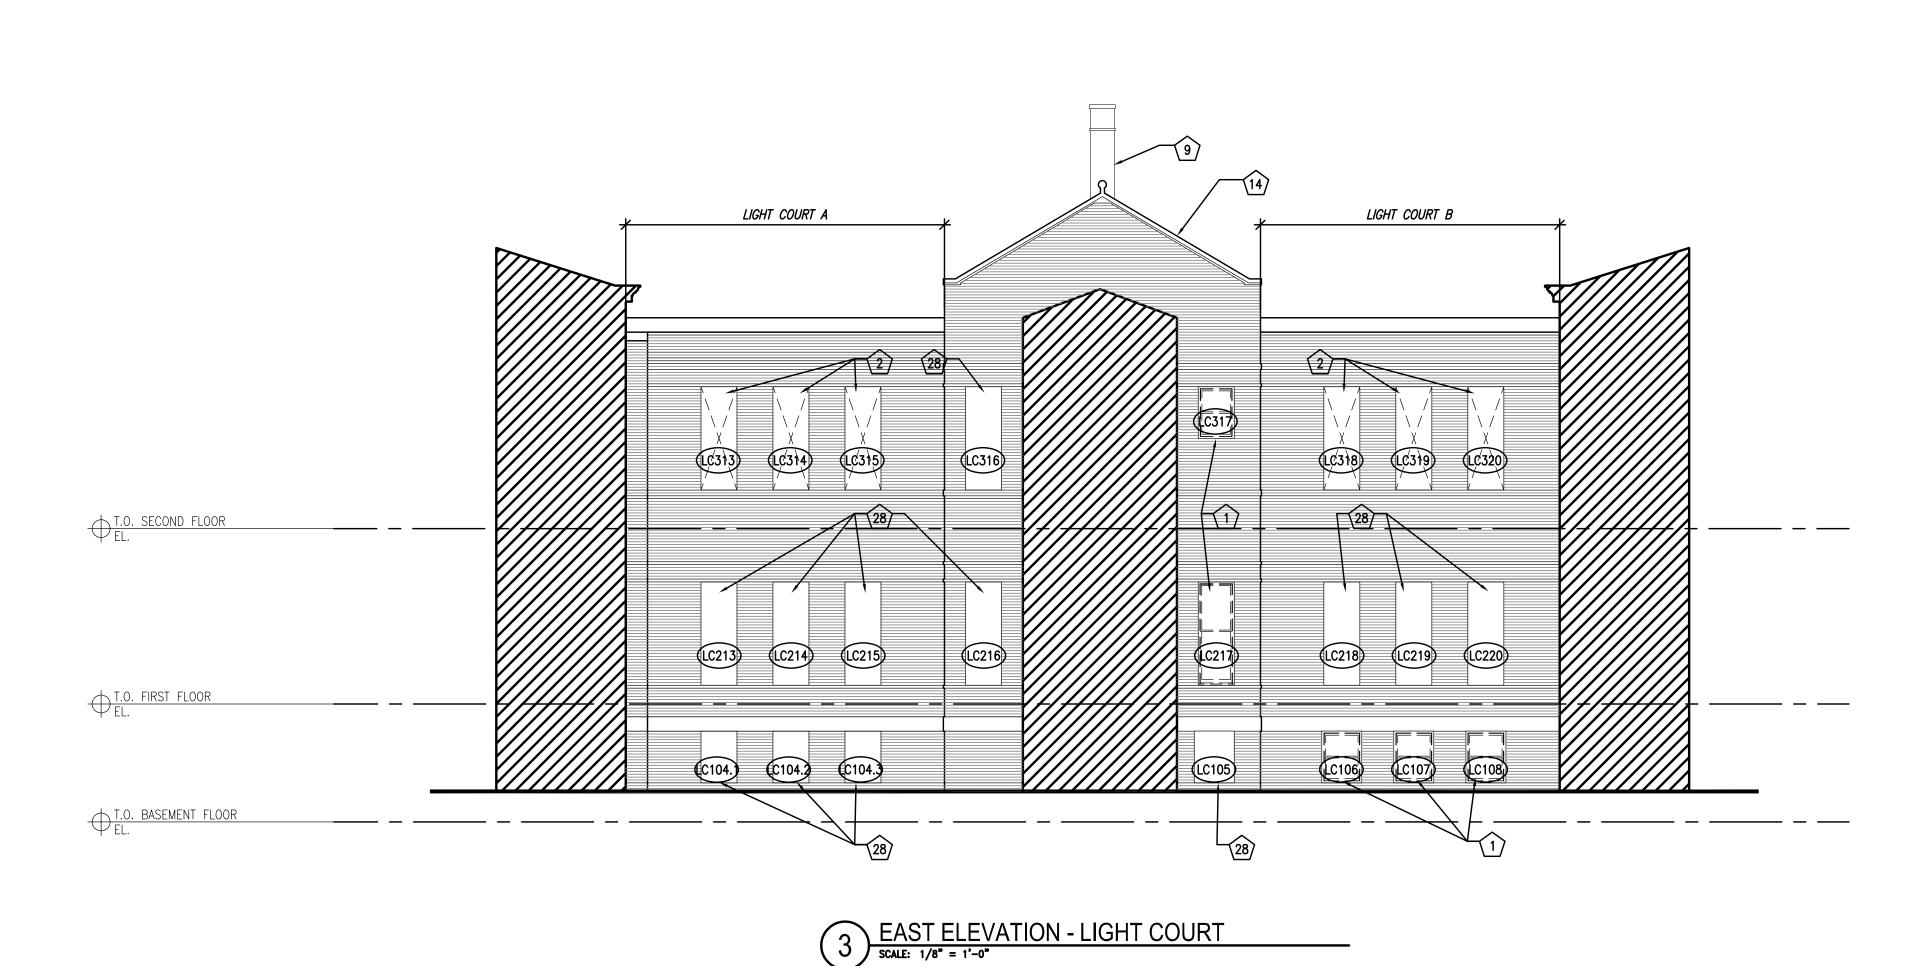


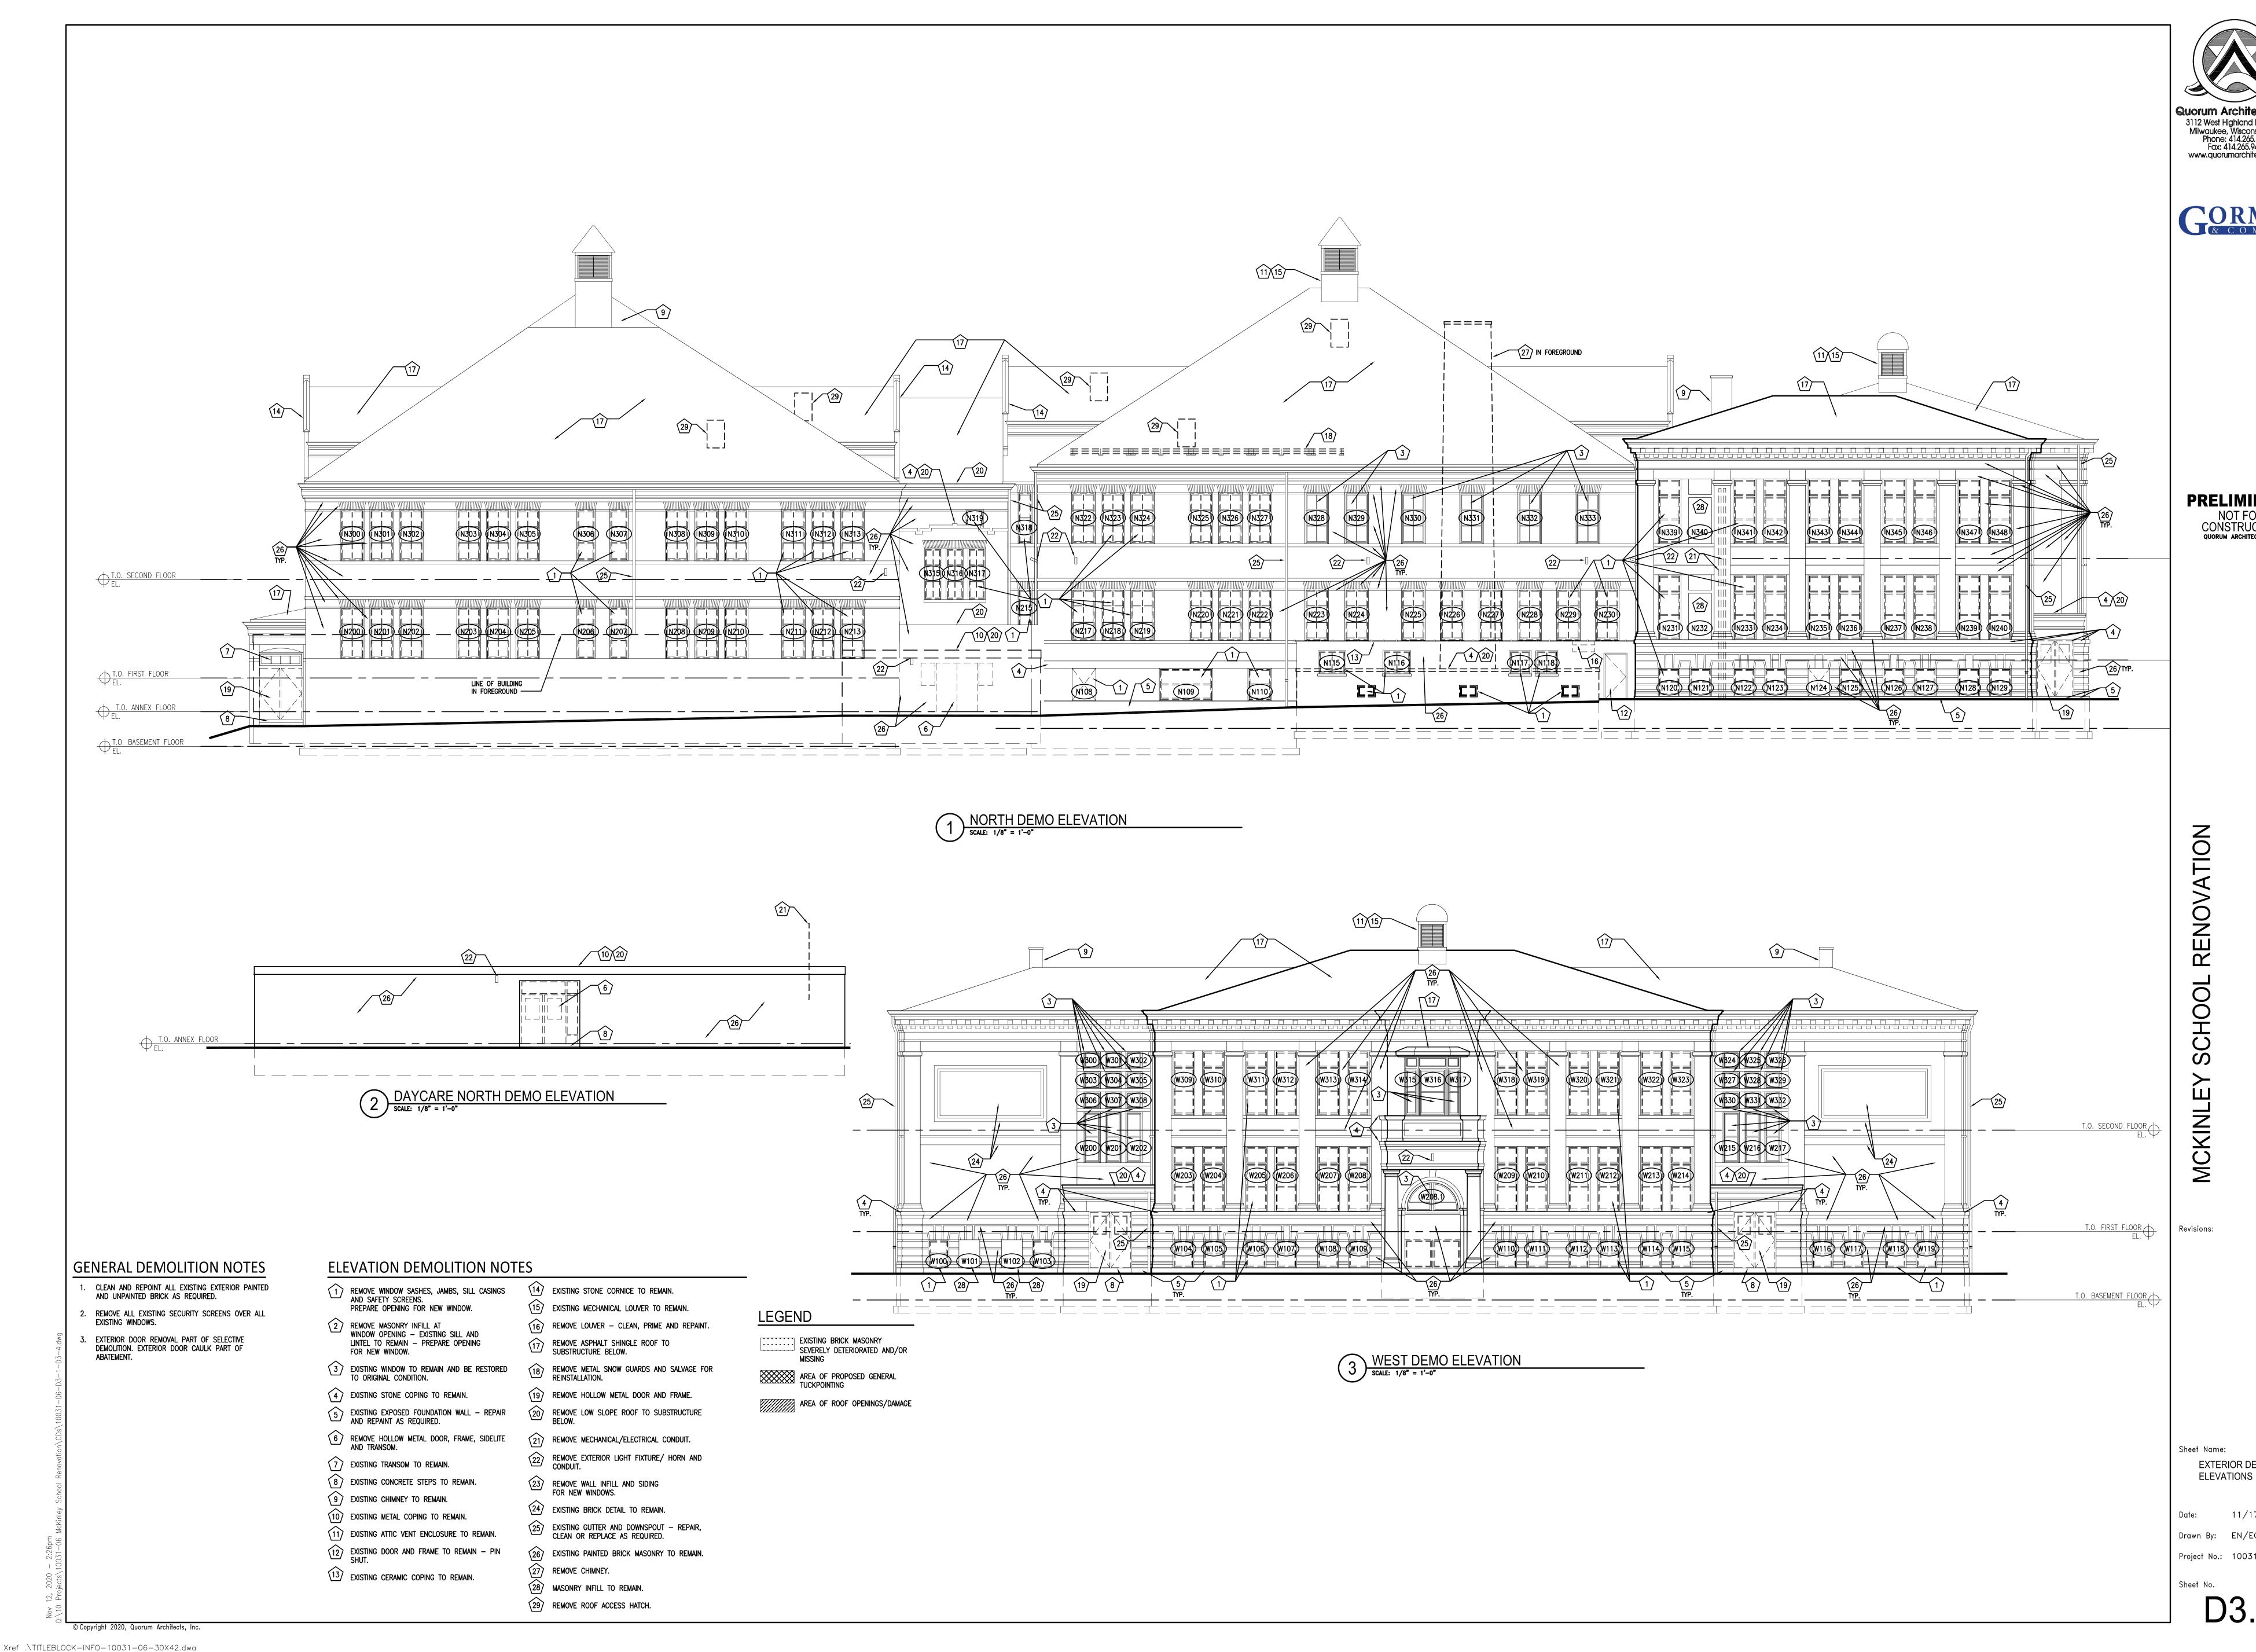

T.O. BASEMENT FLOOR EL.


SOUTH ELEVATION - LIGHT COURT

SCALE: 1/8" = 1'-0"



1 WEST ELEVATION - LIGHT COURT
SCALE: 1/8" = 1'-0"

LIGHT COURT A

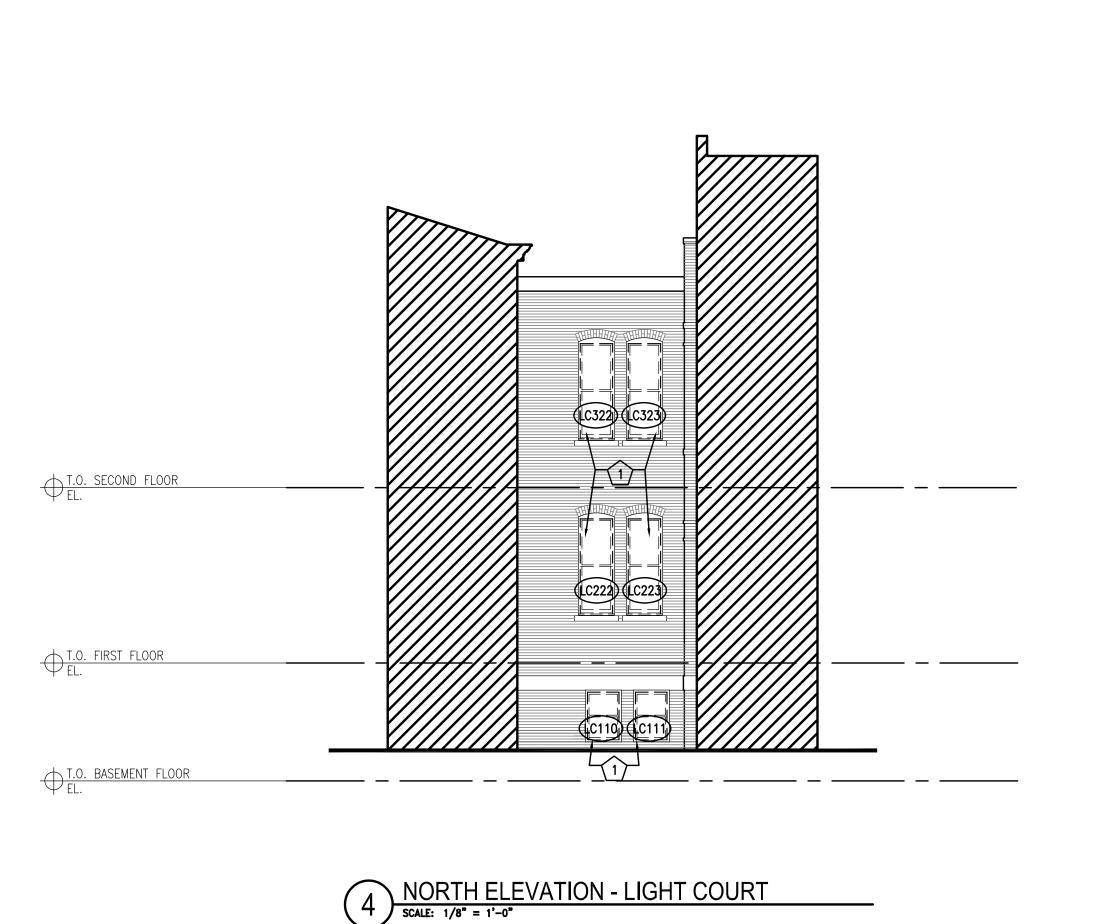

Sheet Name: EXTERIOR DEMOLITION **ELEVATIONS**

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T.O. FIRST FLOOR EL.

T.O. BASEMENT FLOOR

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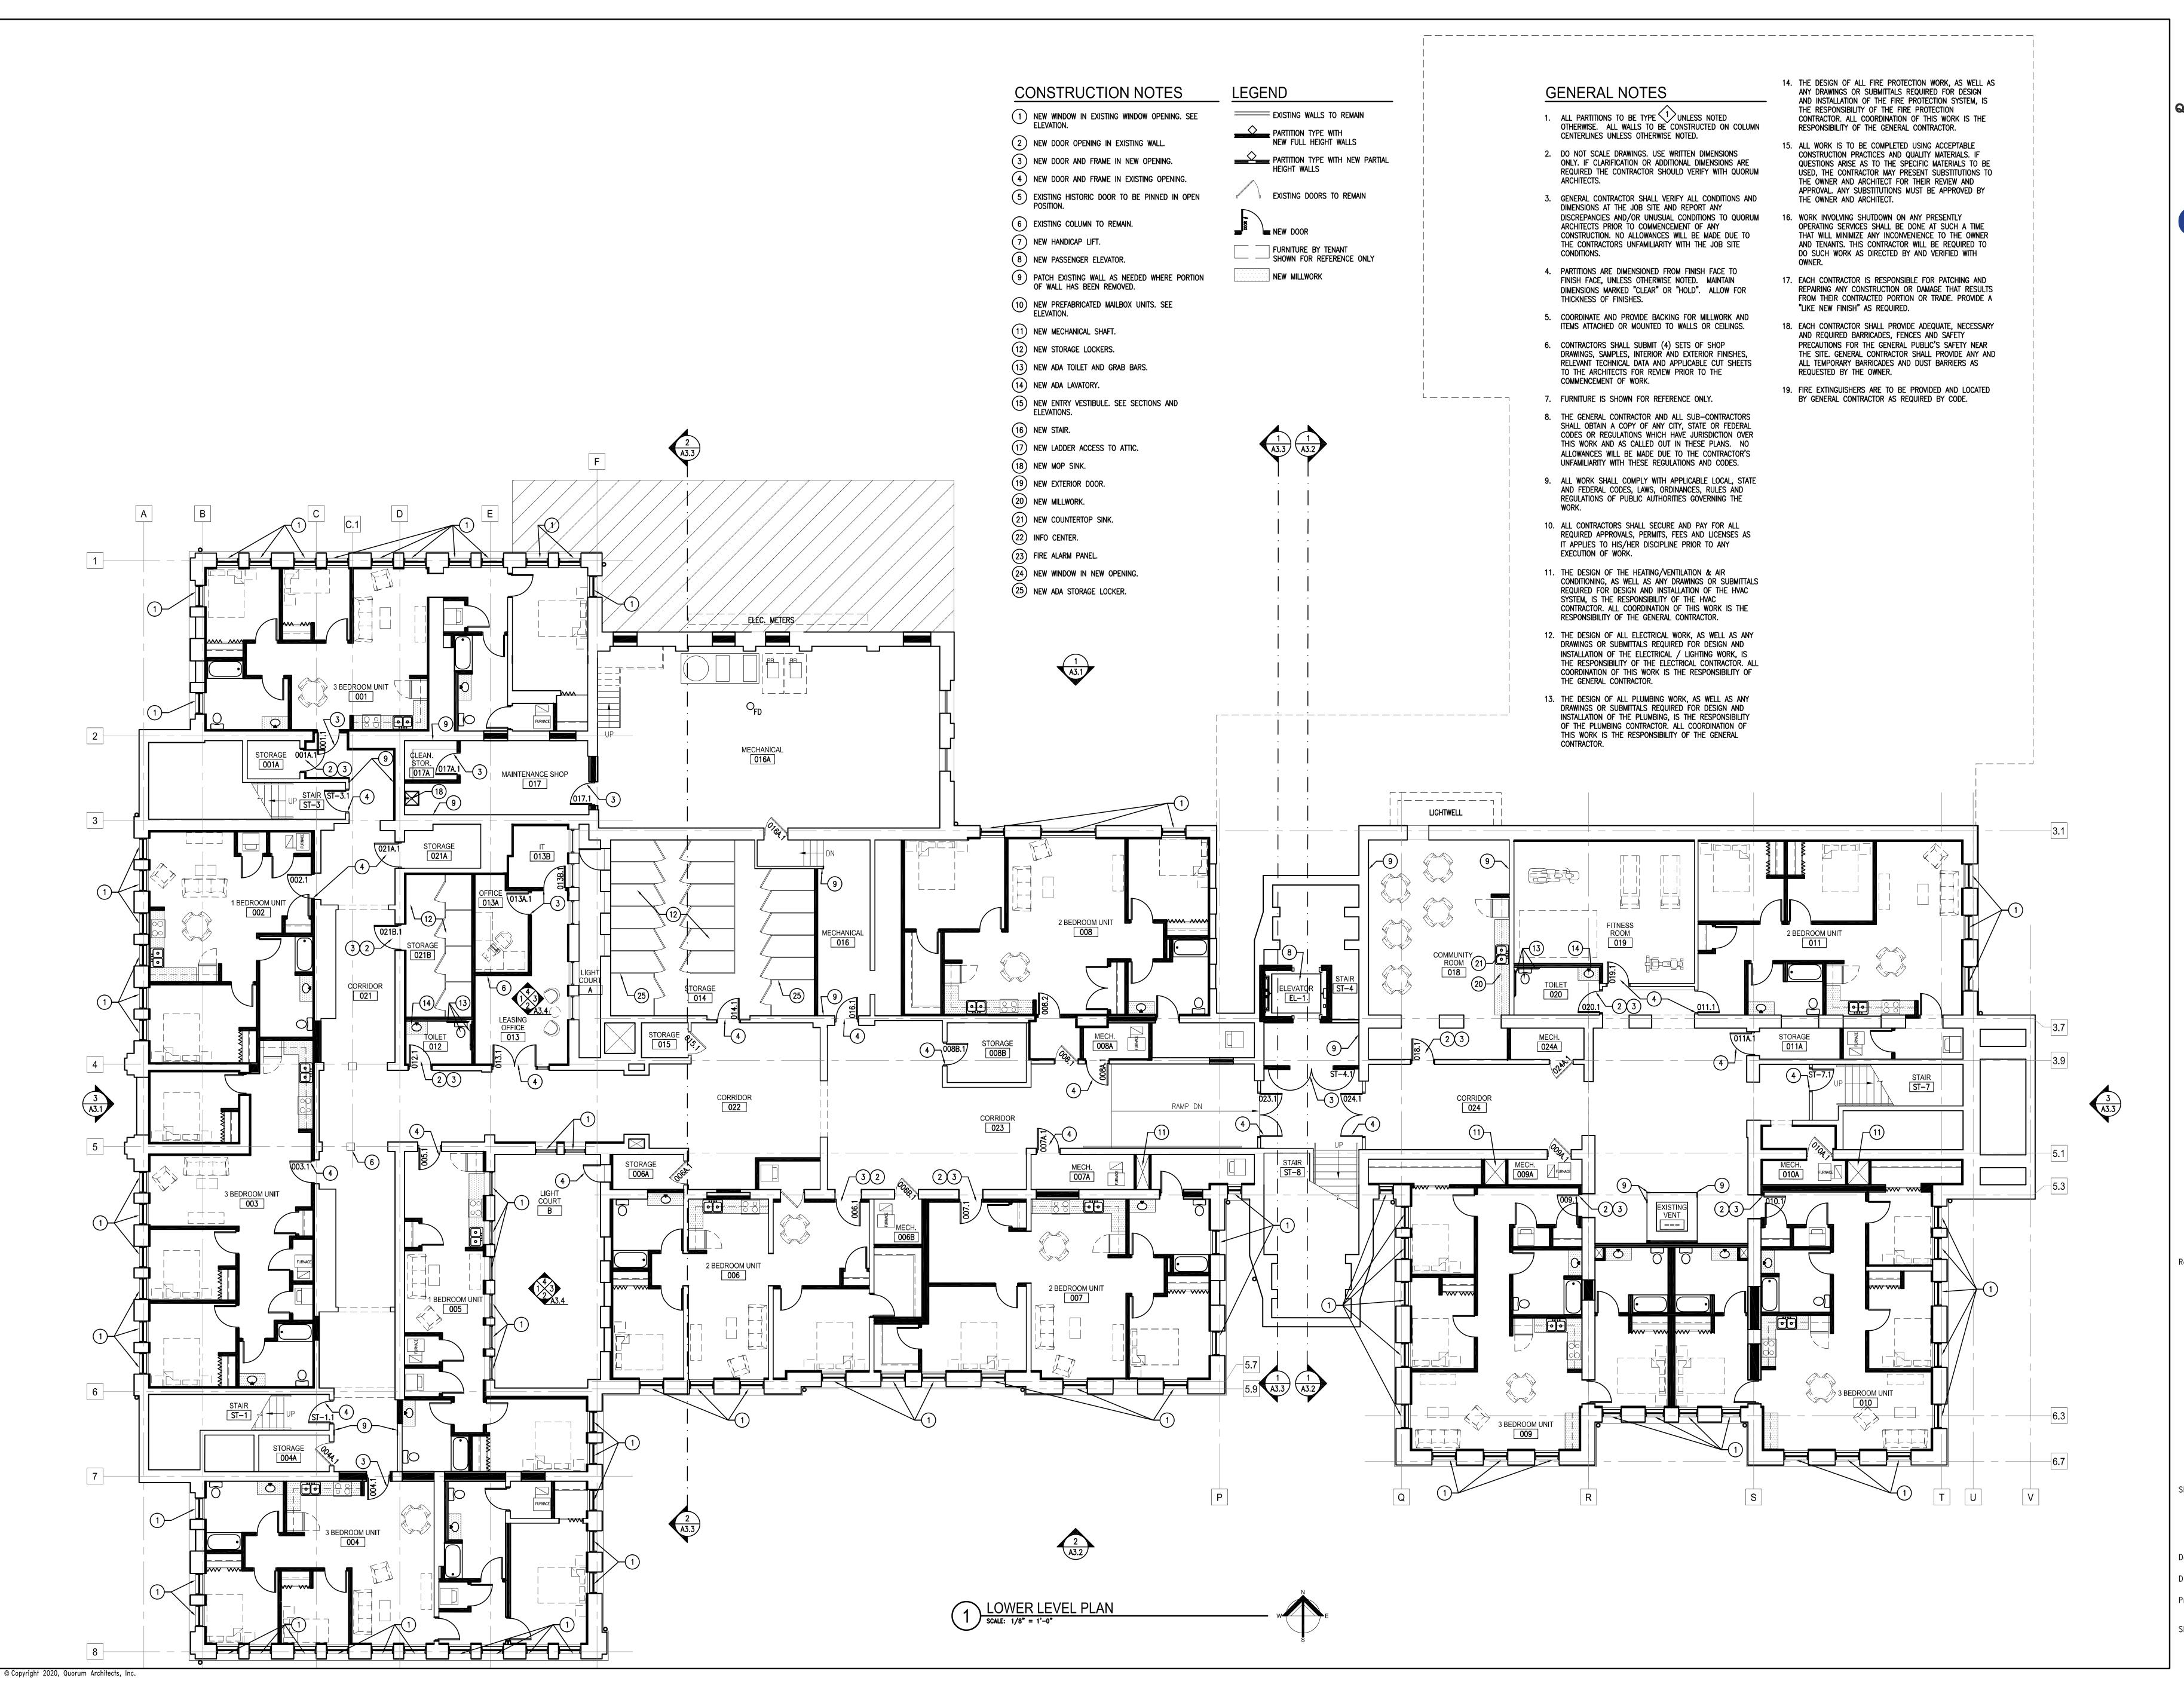
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Sheet Name:

LOWER LEVEL


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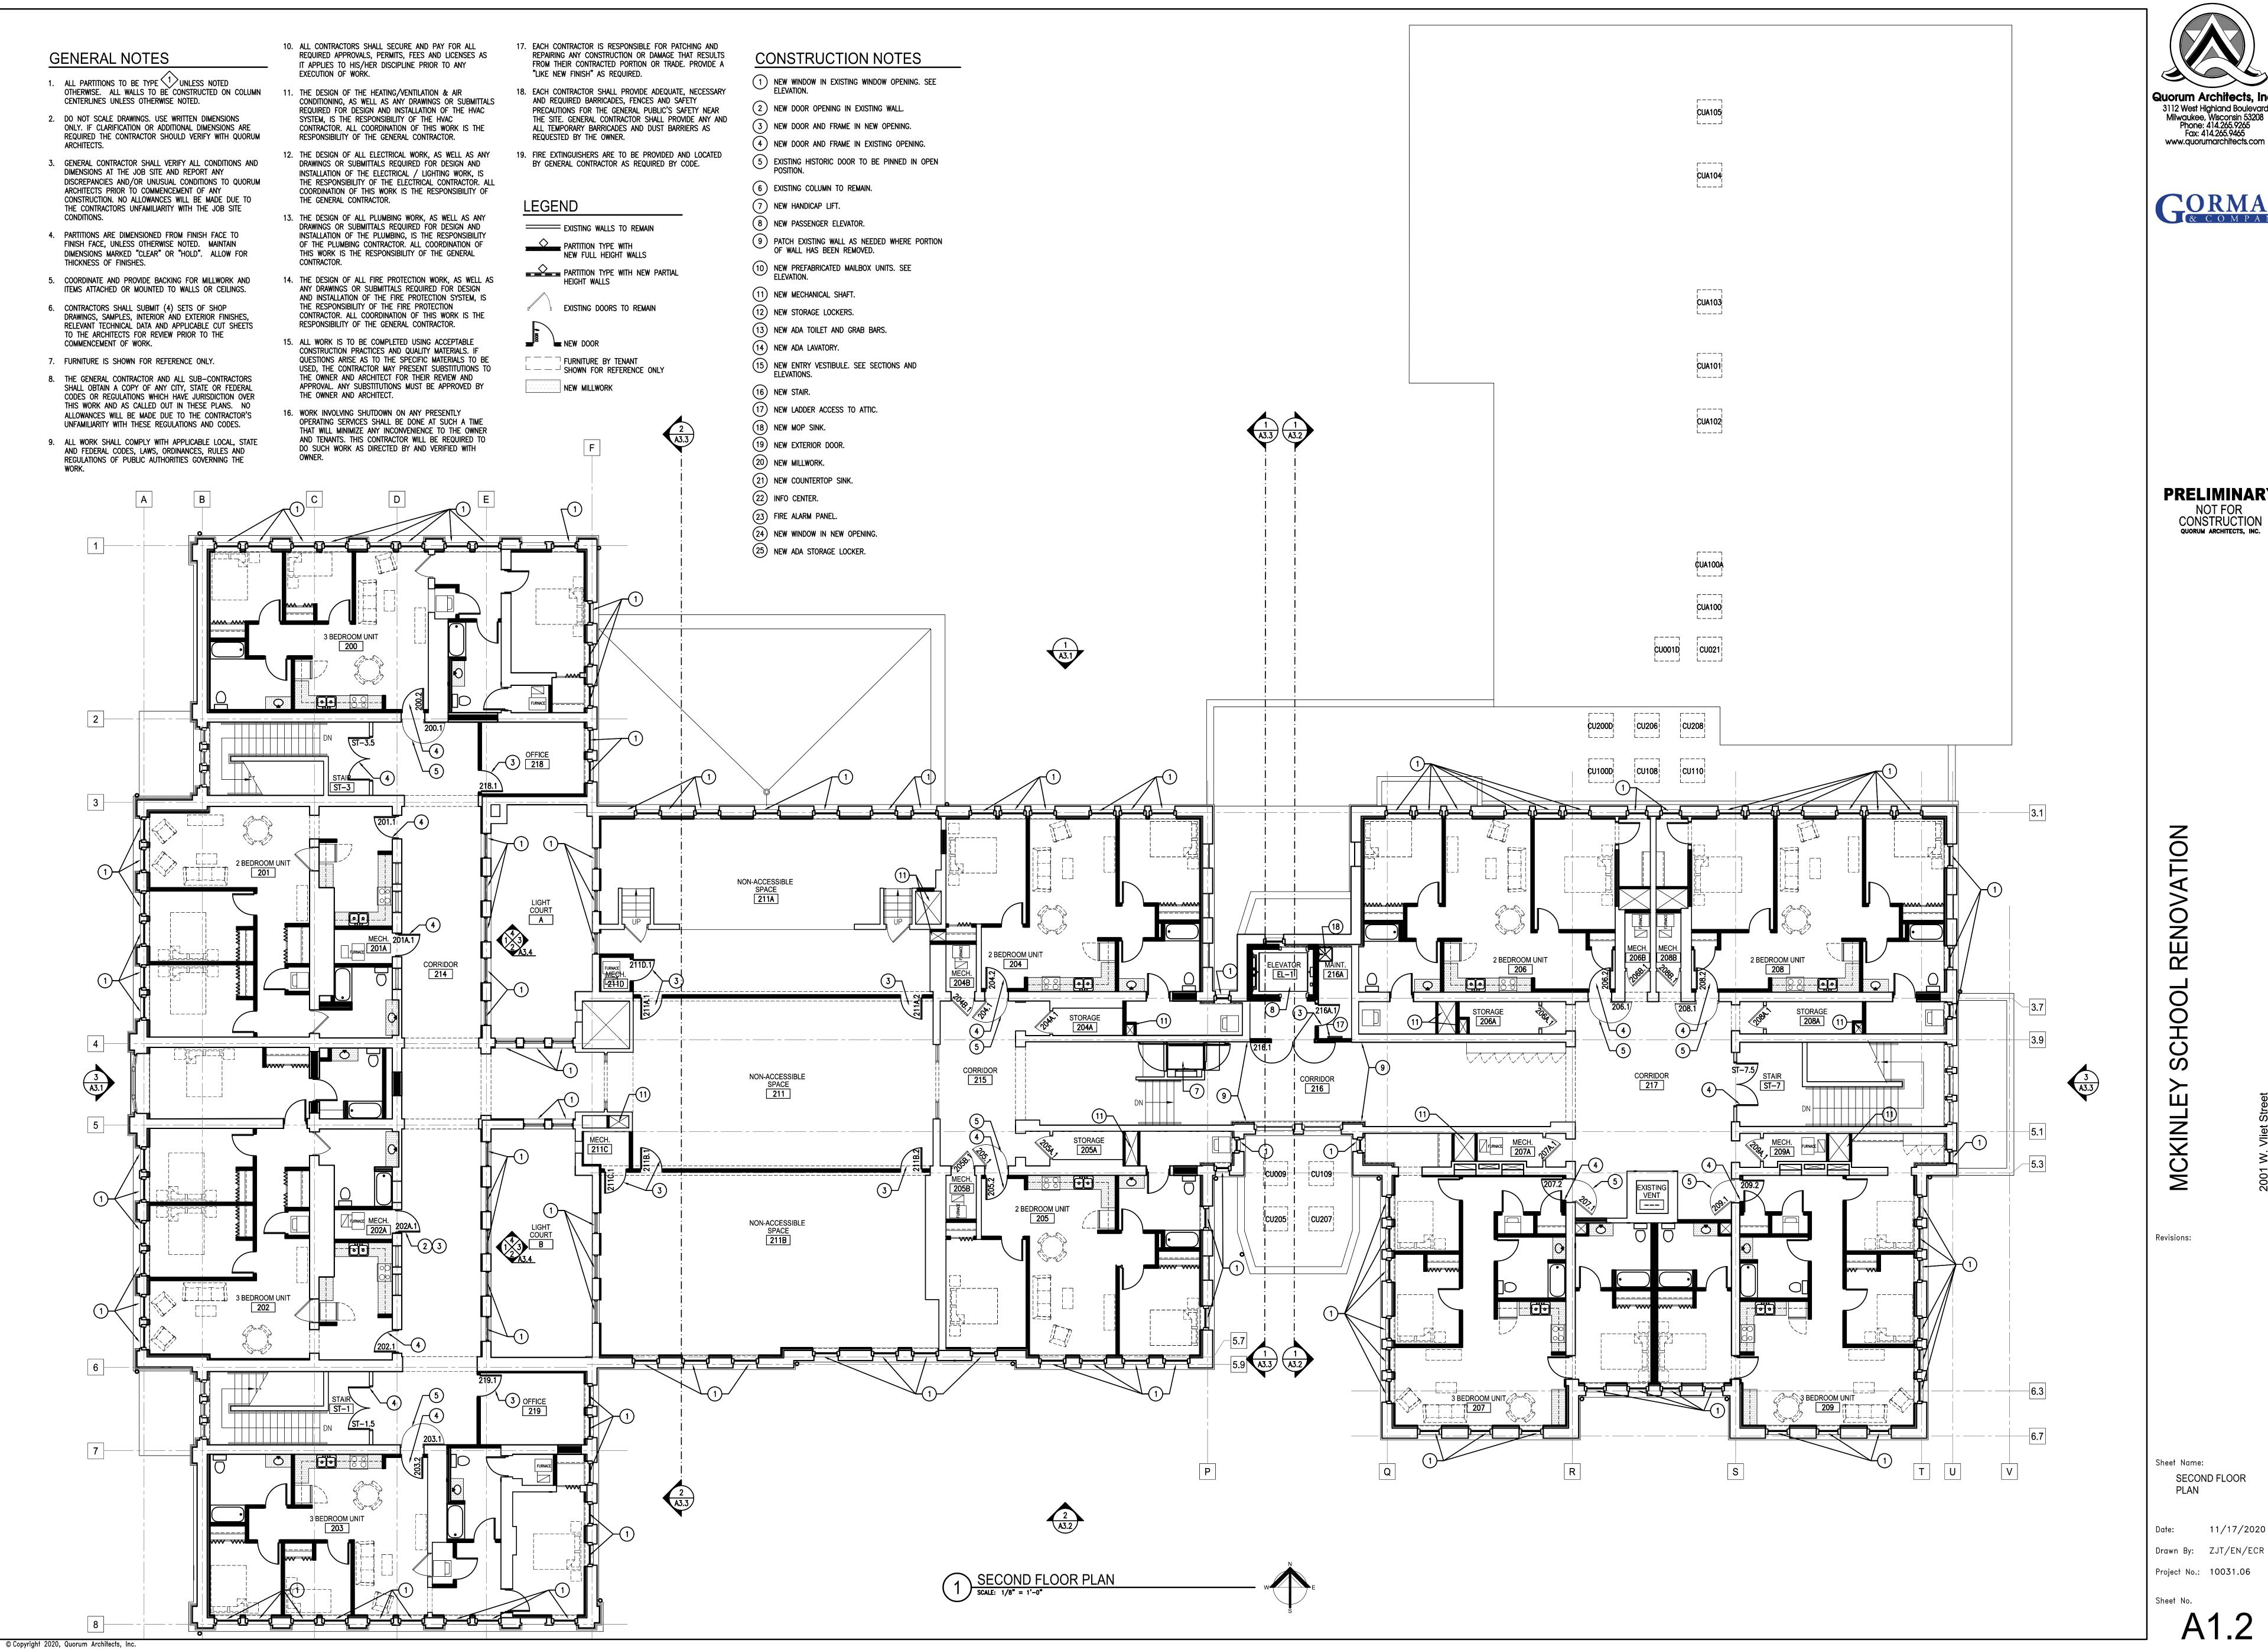


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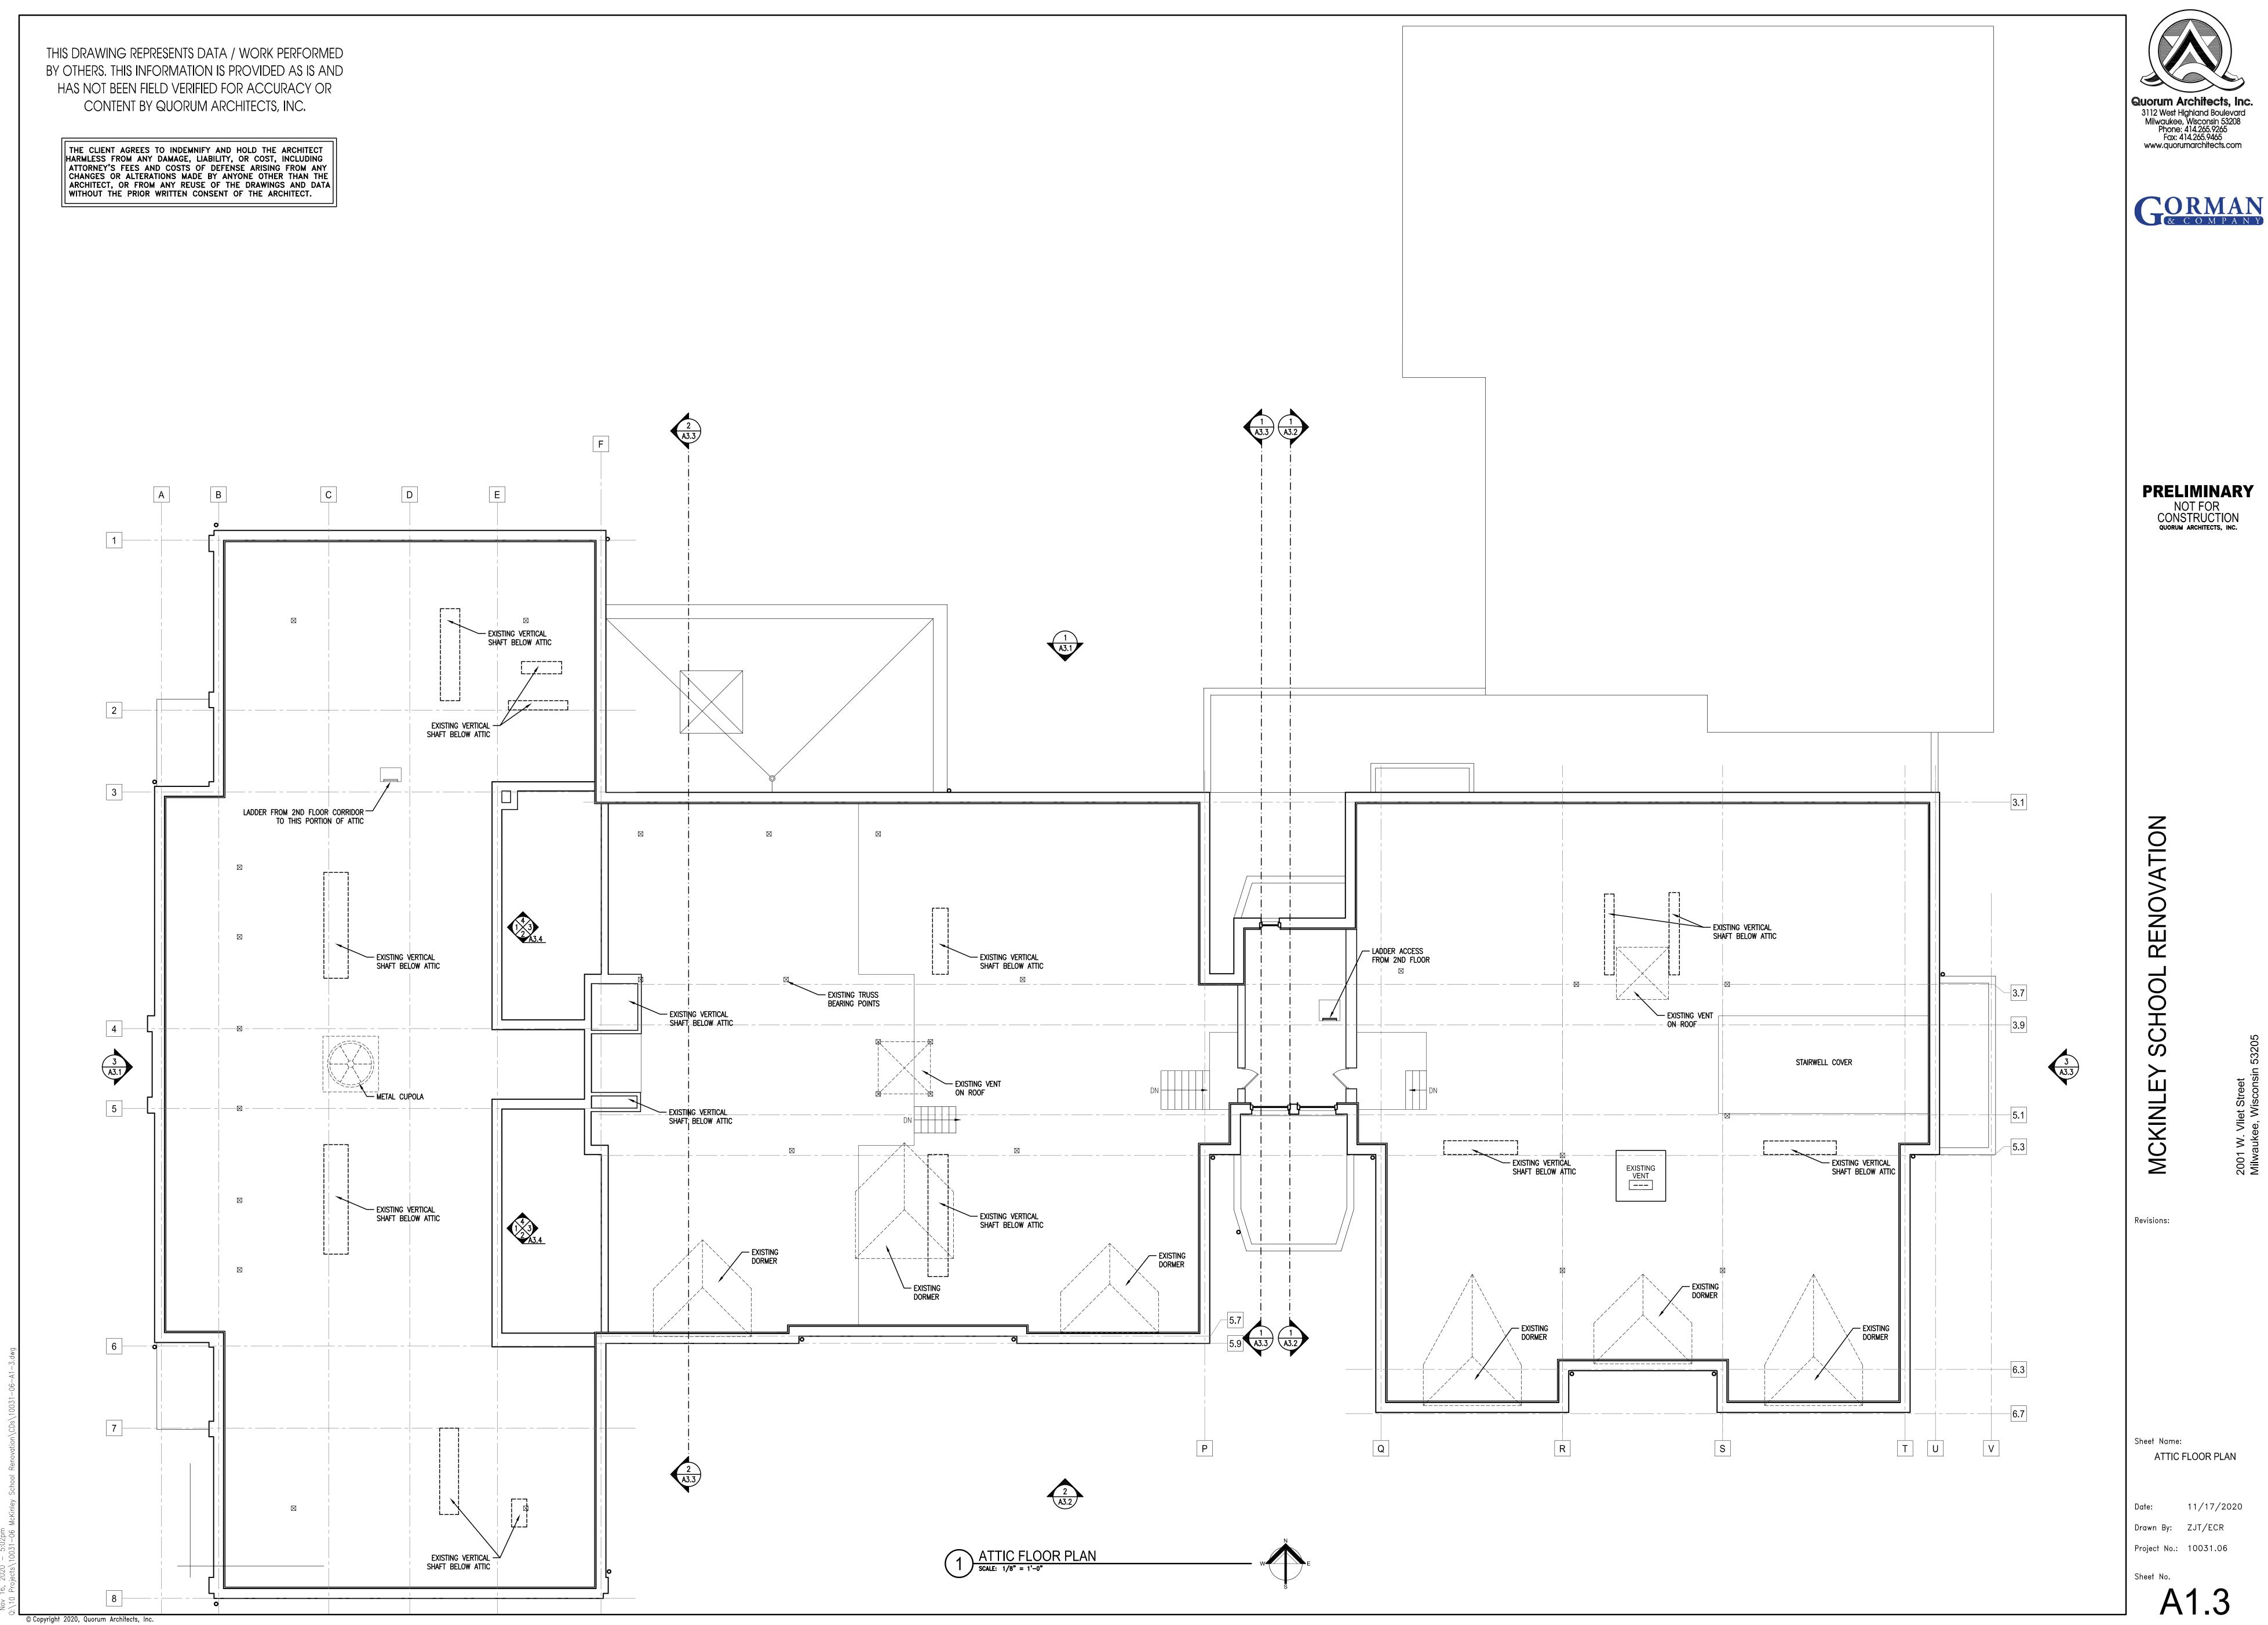





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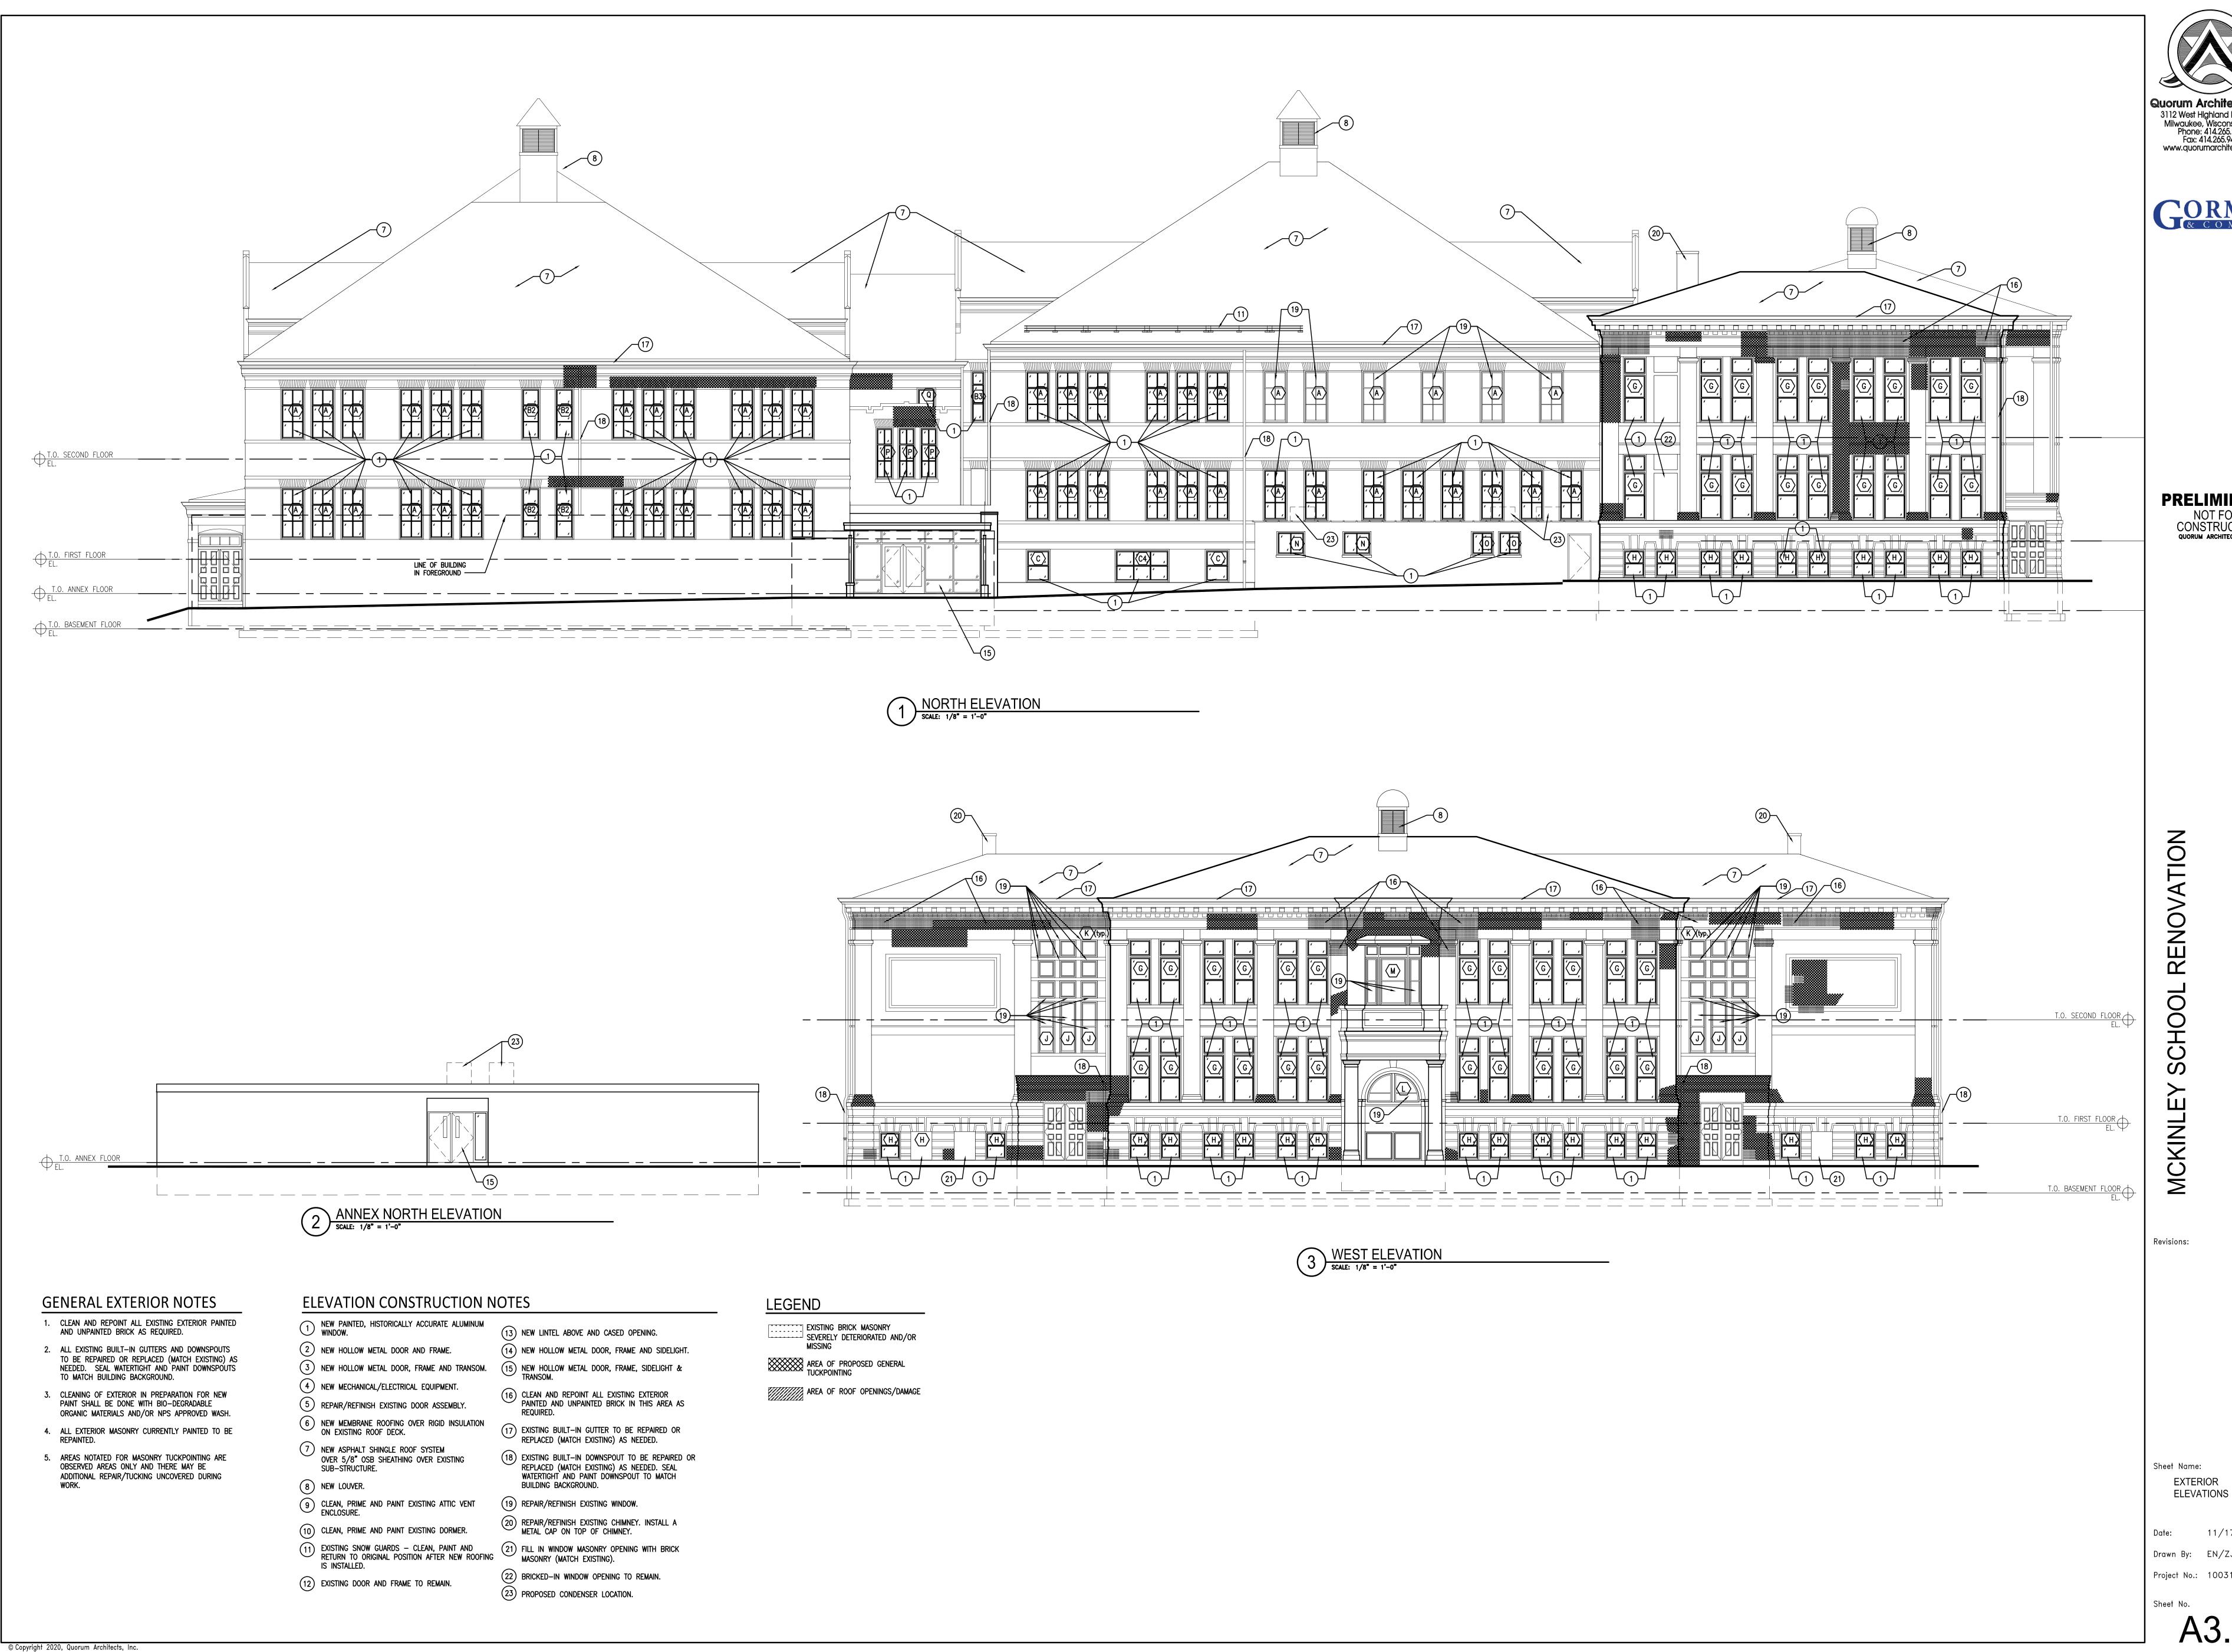


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CLEAN AND REPOINT ALL EXISTING EXTERIOR PAINTED AND UNPAINTED BRICK AS REQUIRED.

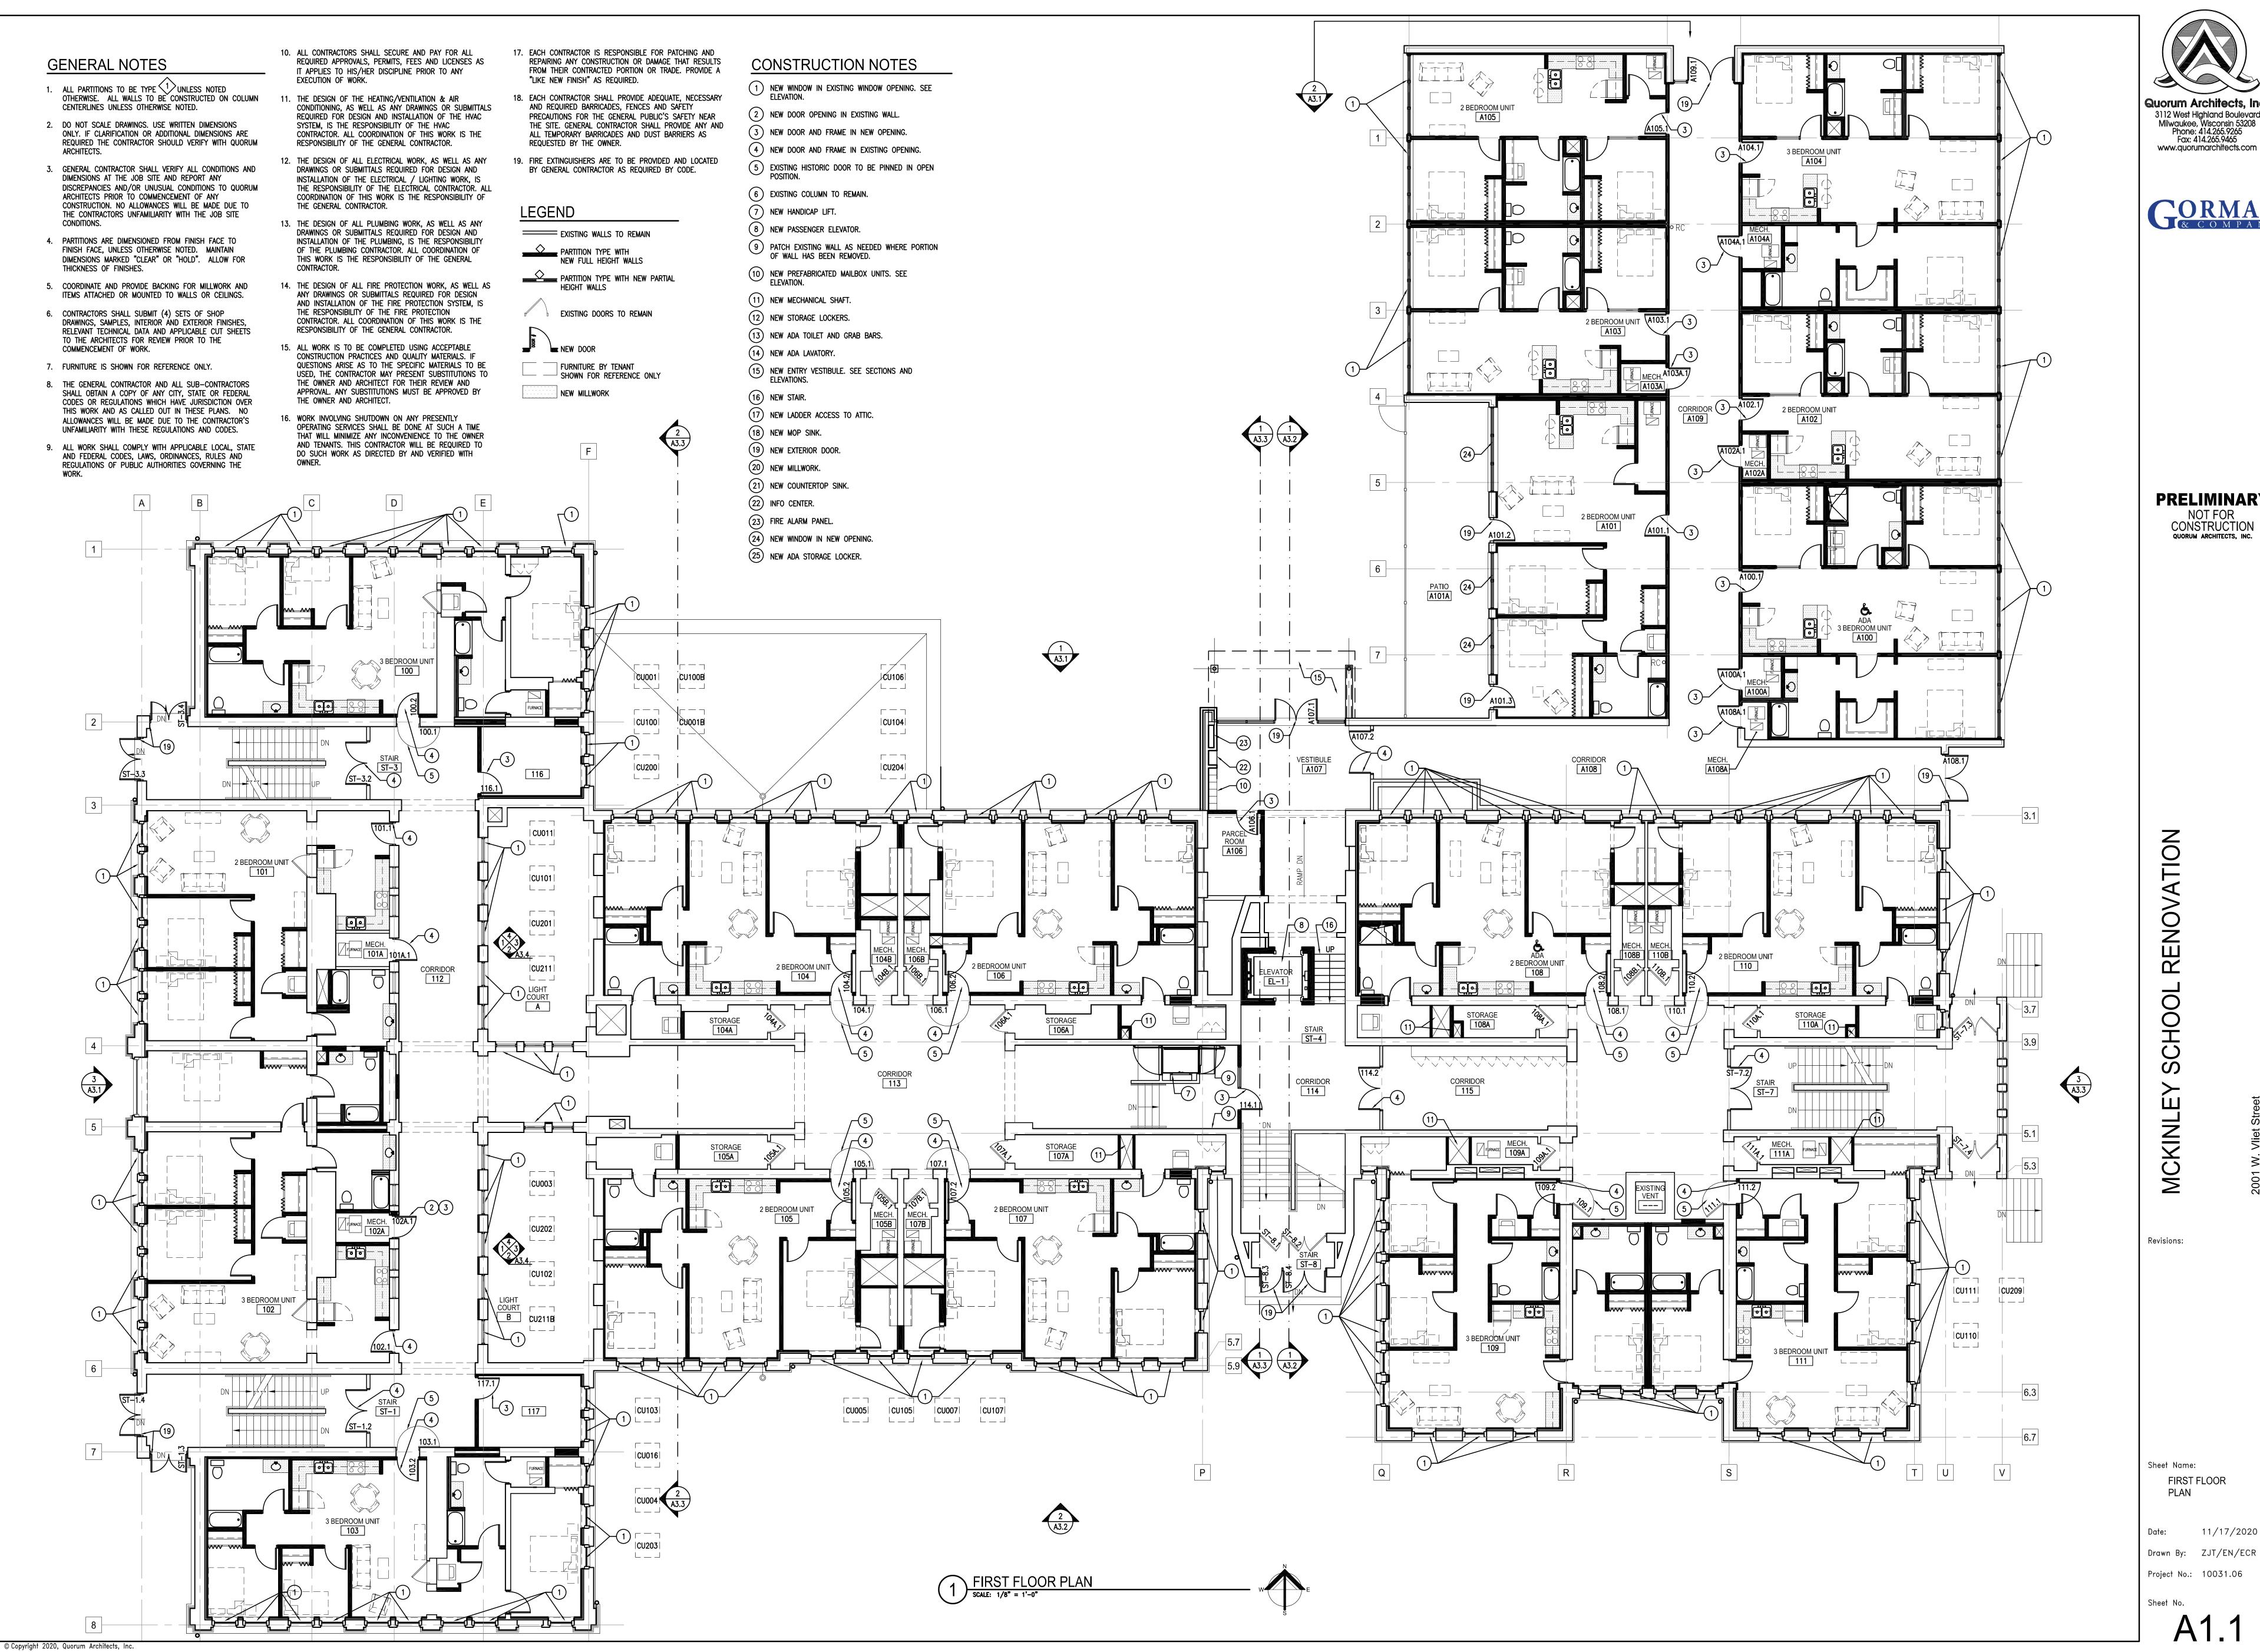ALL EXISTING BUILT-IN GUTTERS AND DOWNSPOUTS TO BE REPAIRED OR REPLACED (MATCH EXISTING) AS NEEDED. SEAL WATERTIGHT AND PAINT DOWNSPOUTS TO MATCH BUILDING BACKGROUND.

- 3. CLEANING OF EXTERIOR IN PREPARATION FOR NEW PAINT SHALL BE DONE WITH BIO-DEGRADABLE ORGANIC MATERIALS AND/OR NPS APPROVED WASH.
- 4. ALL EXTERIOR MASONRY CURRENTLY PAINTED TO BE
- 5. AREAS NOTATED FOR MASONRY TUCKPOINTING ARE OBSERVED AREAS ONLY AND THERE MAY BE ADDITIONAL REPAIR/TUCKING UNCOVERED DURING

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- NEW PAINTED, HISTORICALLY ACCURATE ALUMINUM WINDOW.
- (2) NEW HOLLOW METAL DOOR AND FRAME.
- (3) NEW HOLLOW METAL DOOR, FRAME AND TRANSOM.
- 4 NEW MECHANICAL/ELECTRICAL EQUIPMENT.
- 5 REPAIR/REFINISH EXISTING DOOR ASSEMBLY.
- 6 NEW MEMBRANE ROOFING OVER RIGID INSULATION ON EXISTING ROOF DECK.
- 7 NEW ASPHALT SHINGLE ROOF SYSTEM OVER 5/8" OSB SHEATHING OVER EXISTING SUB-STRUCTURE.
- 8 NEW LOUVER.
- CLEAN, PRIME AND PAINT EXISTING ATTIC VENT ENCLOSURE.
- (10) CLEAN, PRIME AND PAINT EXISTING DORMER.
- IS INSTALLED. (12) EXISTING DOOR AND FRAME TO REMAIN.

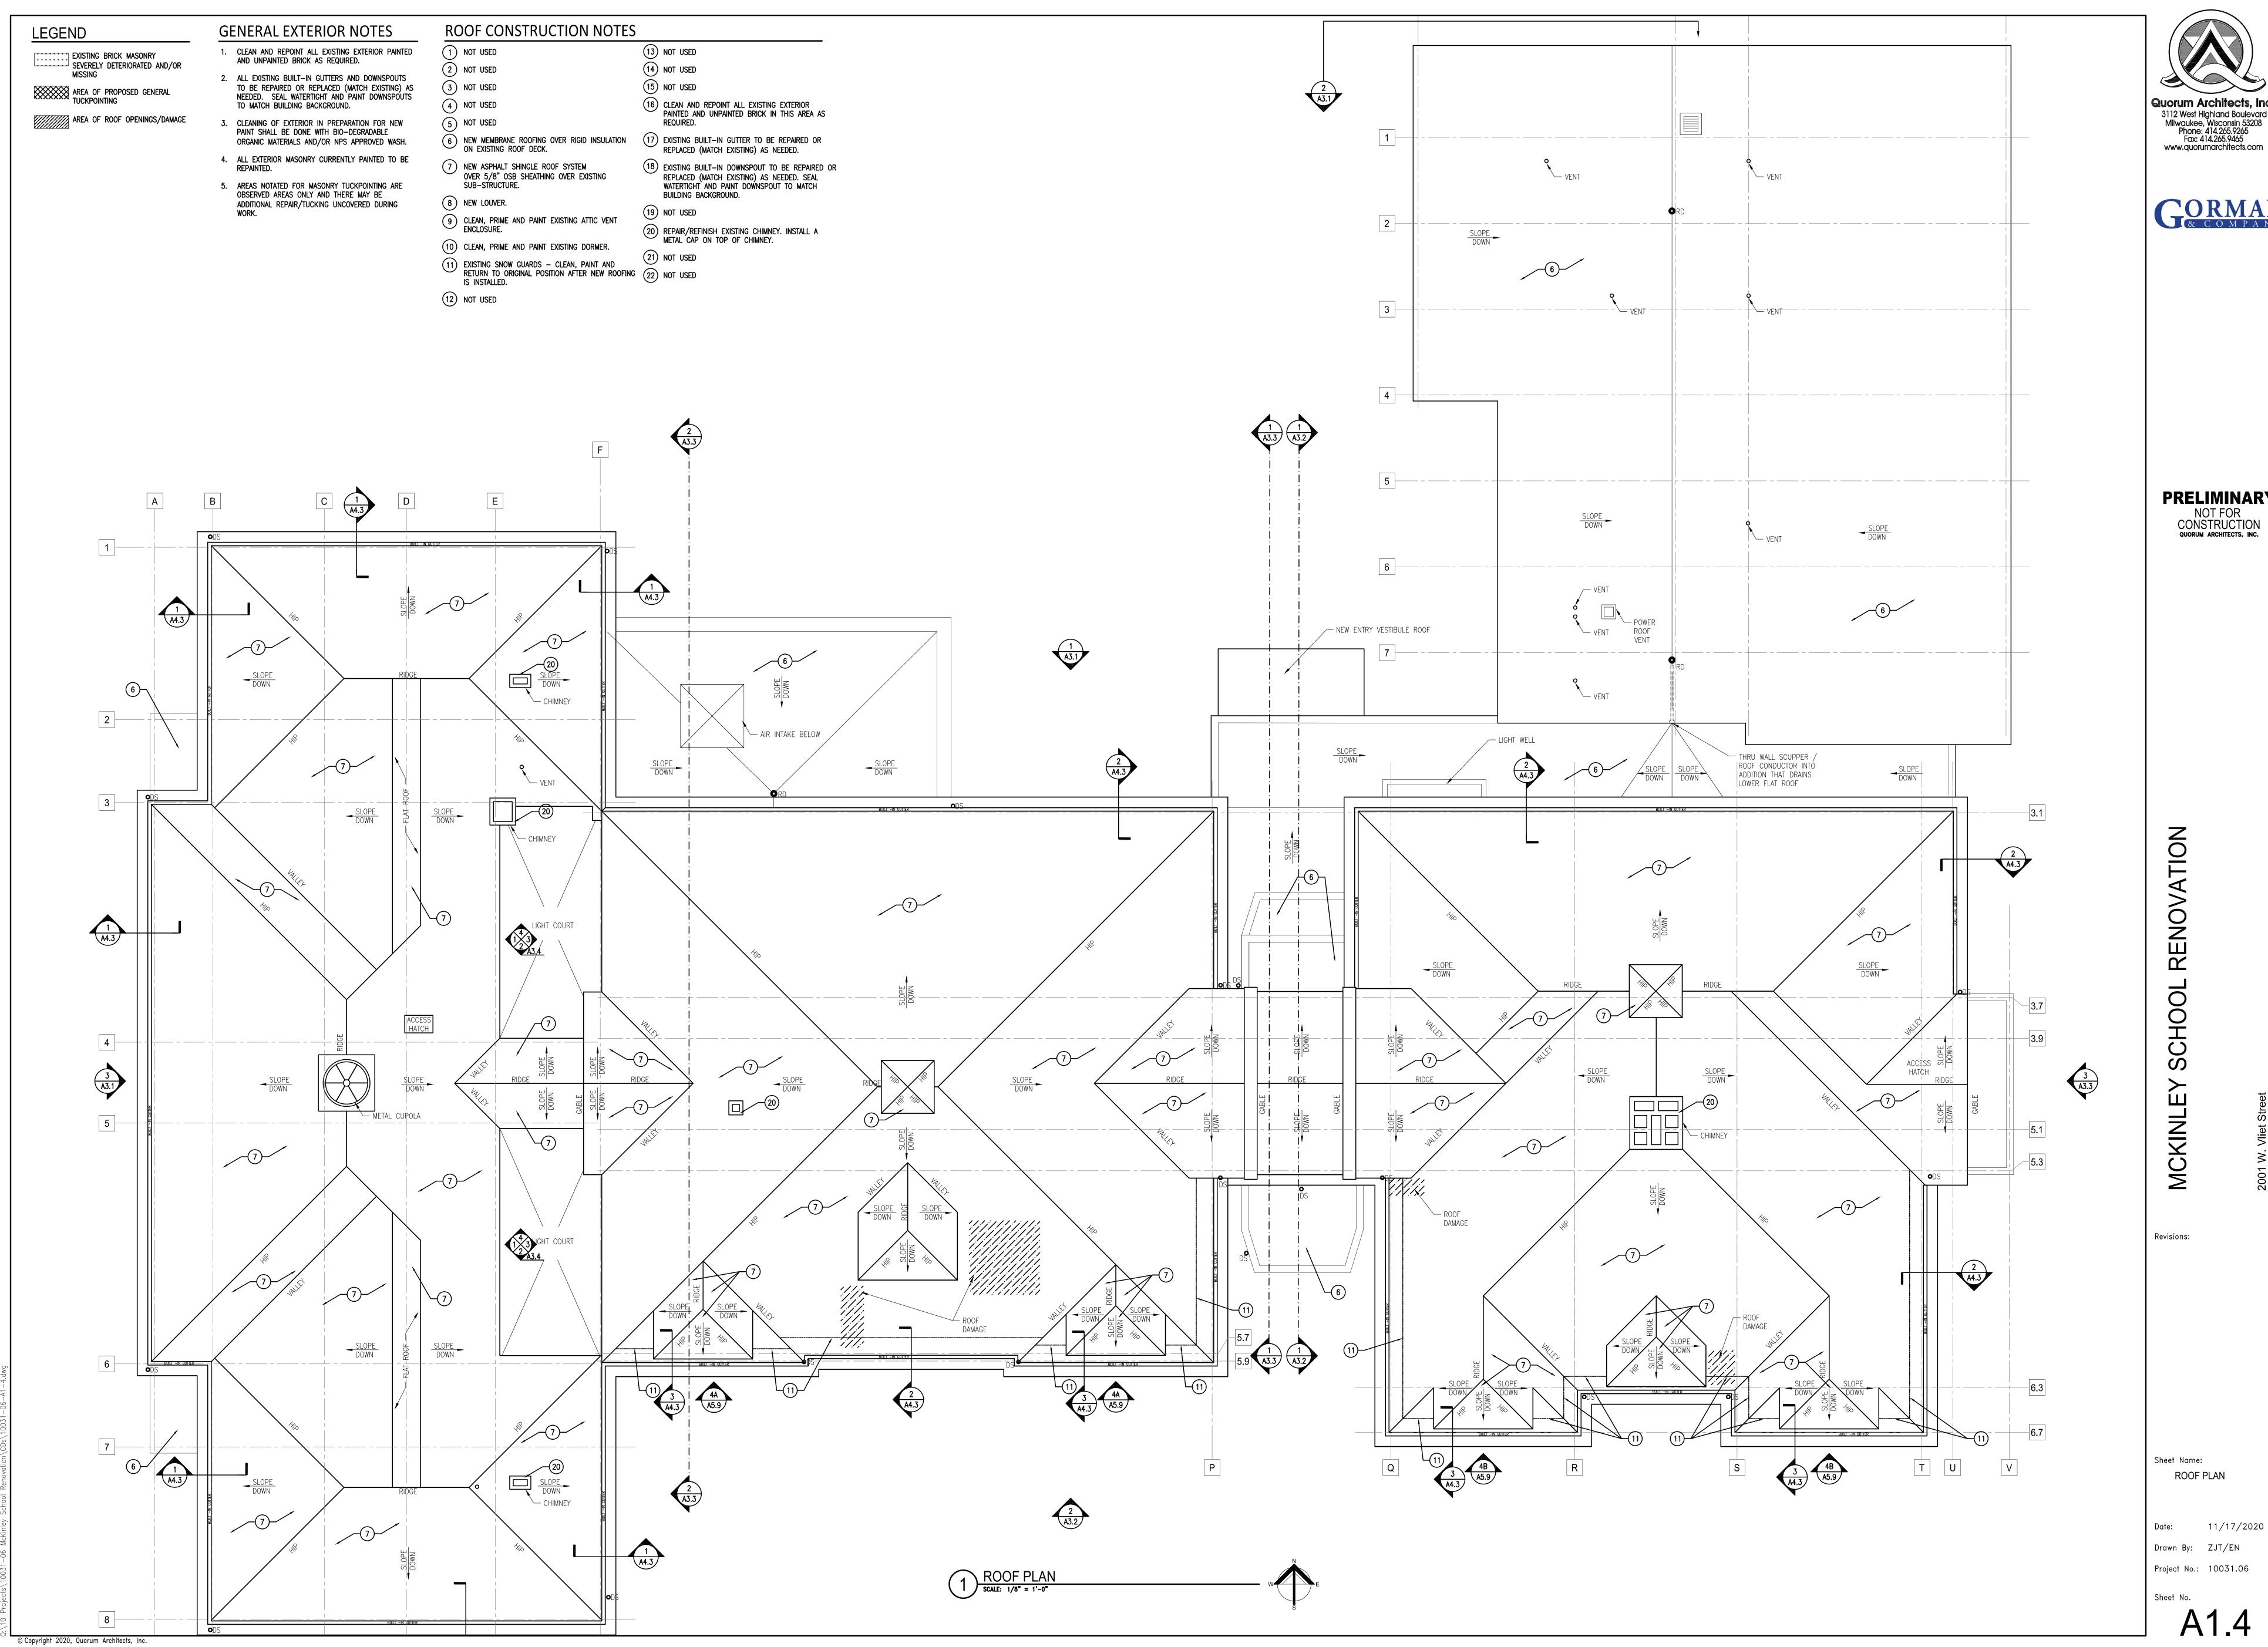- (13) NEW LINTEL ABOVE AND CASED OPENING.
 - (14) NEW HOLLOW METAL DOOR, FRAME AND SIDELIGHT.
 - (15) NEW HOLLOW METAL DOOR, FRAME, SIDELIGHT &
 - (16) CLEAN AND REPOINT ALL EXISTING EXTERIOR PAINTED AND UNPAINTED BRICK IN THIS AREA AS
 - (17) EXISTING BUILT-IN GUTTER TO BE REPAIRED OR REPLACED (MATCH EXISTING) AS NEEDED.
 - (18) EXISTING BUILT-IN DOWNSPOUT TO BE REPAIRED OR REPLACED (MATCH EXISTING) AS NEEDED. SEAL WATERTIGHT AND PAINT DOWNSPOUT TO MATCH BUILDING BACKGROUND.
 - (19) REPAIR/REFINISH EXISTING WINDOW.
 - 20) REPAIR/REFINISH EXISTING CHIMNEY. INSTALL A METAL CAP ON TOP OF CHIMNEY.
- EXISTING SNOW GUARDS CLEAN, PAINT AND RETURN TO ORIGINAL POSITION AFTER NEW ROOFING

 (21) FILL IN WINDOW MASONRY OPENING WITH BRICK MASONRY (MATCH EXISTING).
- (22) BRICKED-IN WINDOW OPENING TO REMAIN. 23) PROPOSED CONDENSER LOCATION.

EXISTING BRICK MASONRY -- SEVERELY DETERIORATED AND/OR


AREA OF PROPOSED GENERAL TUCKPOINTING

AREA OF ROOF OPENINGS/DAMAGE

Sheet Name: **EXTERIOR ELEVATIONS**

Date: 11/17/2020 Drawn By: EN/ZJT Project No.: 10031.06

Sheet No.

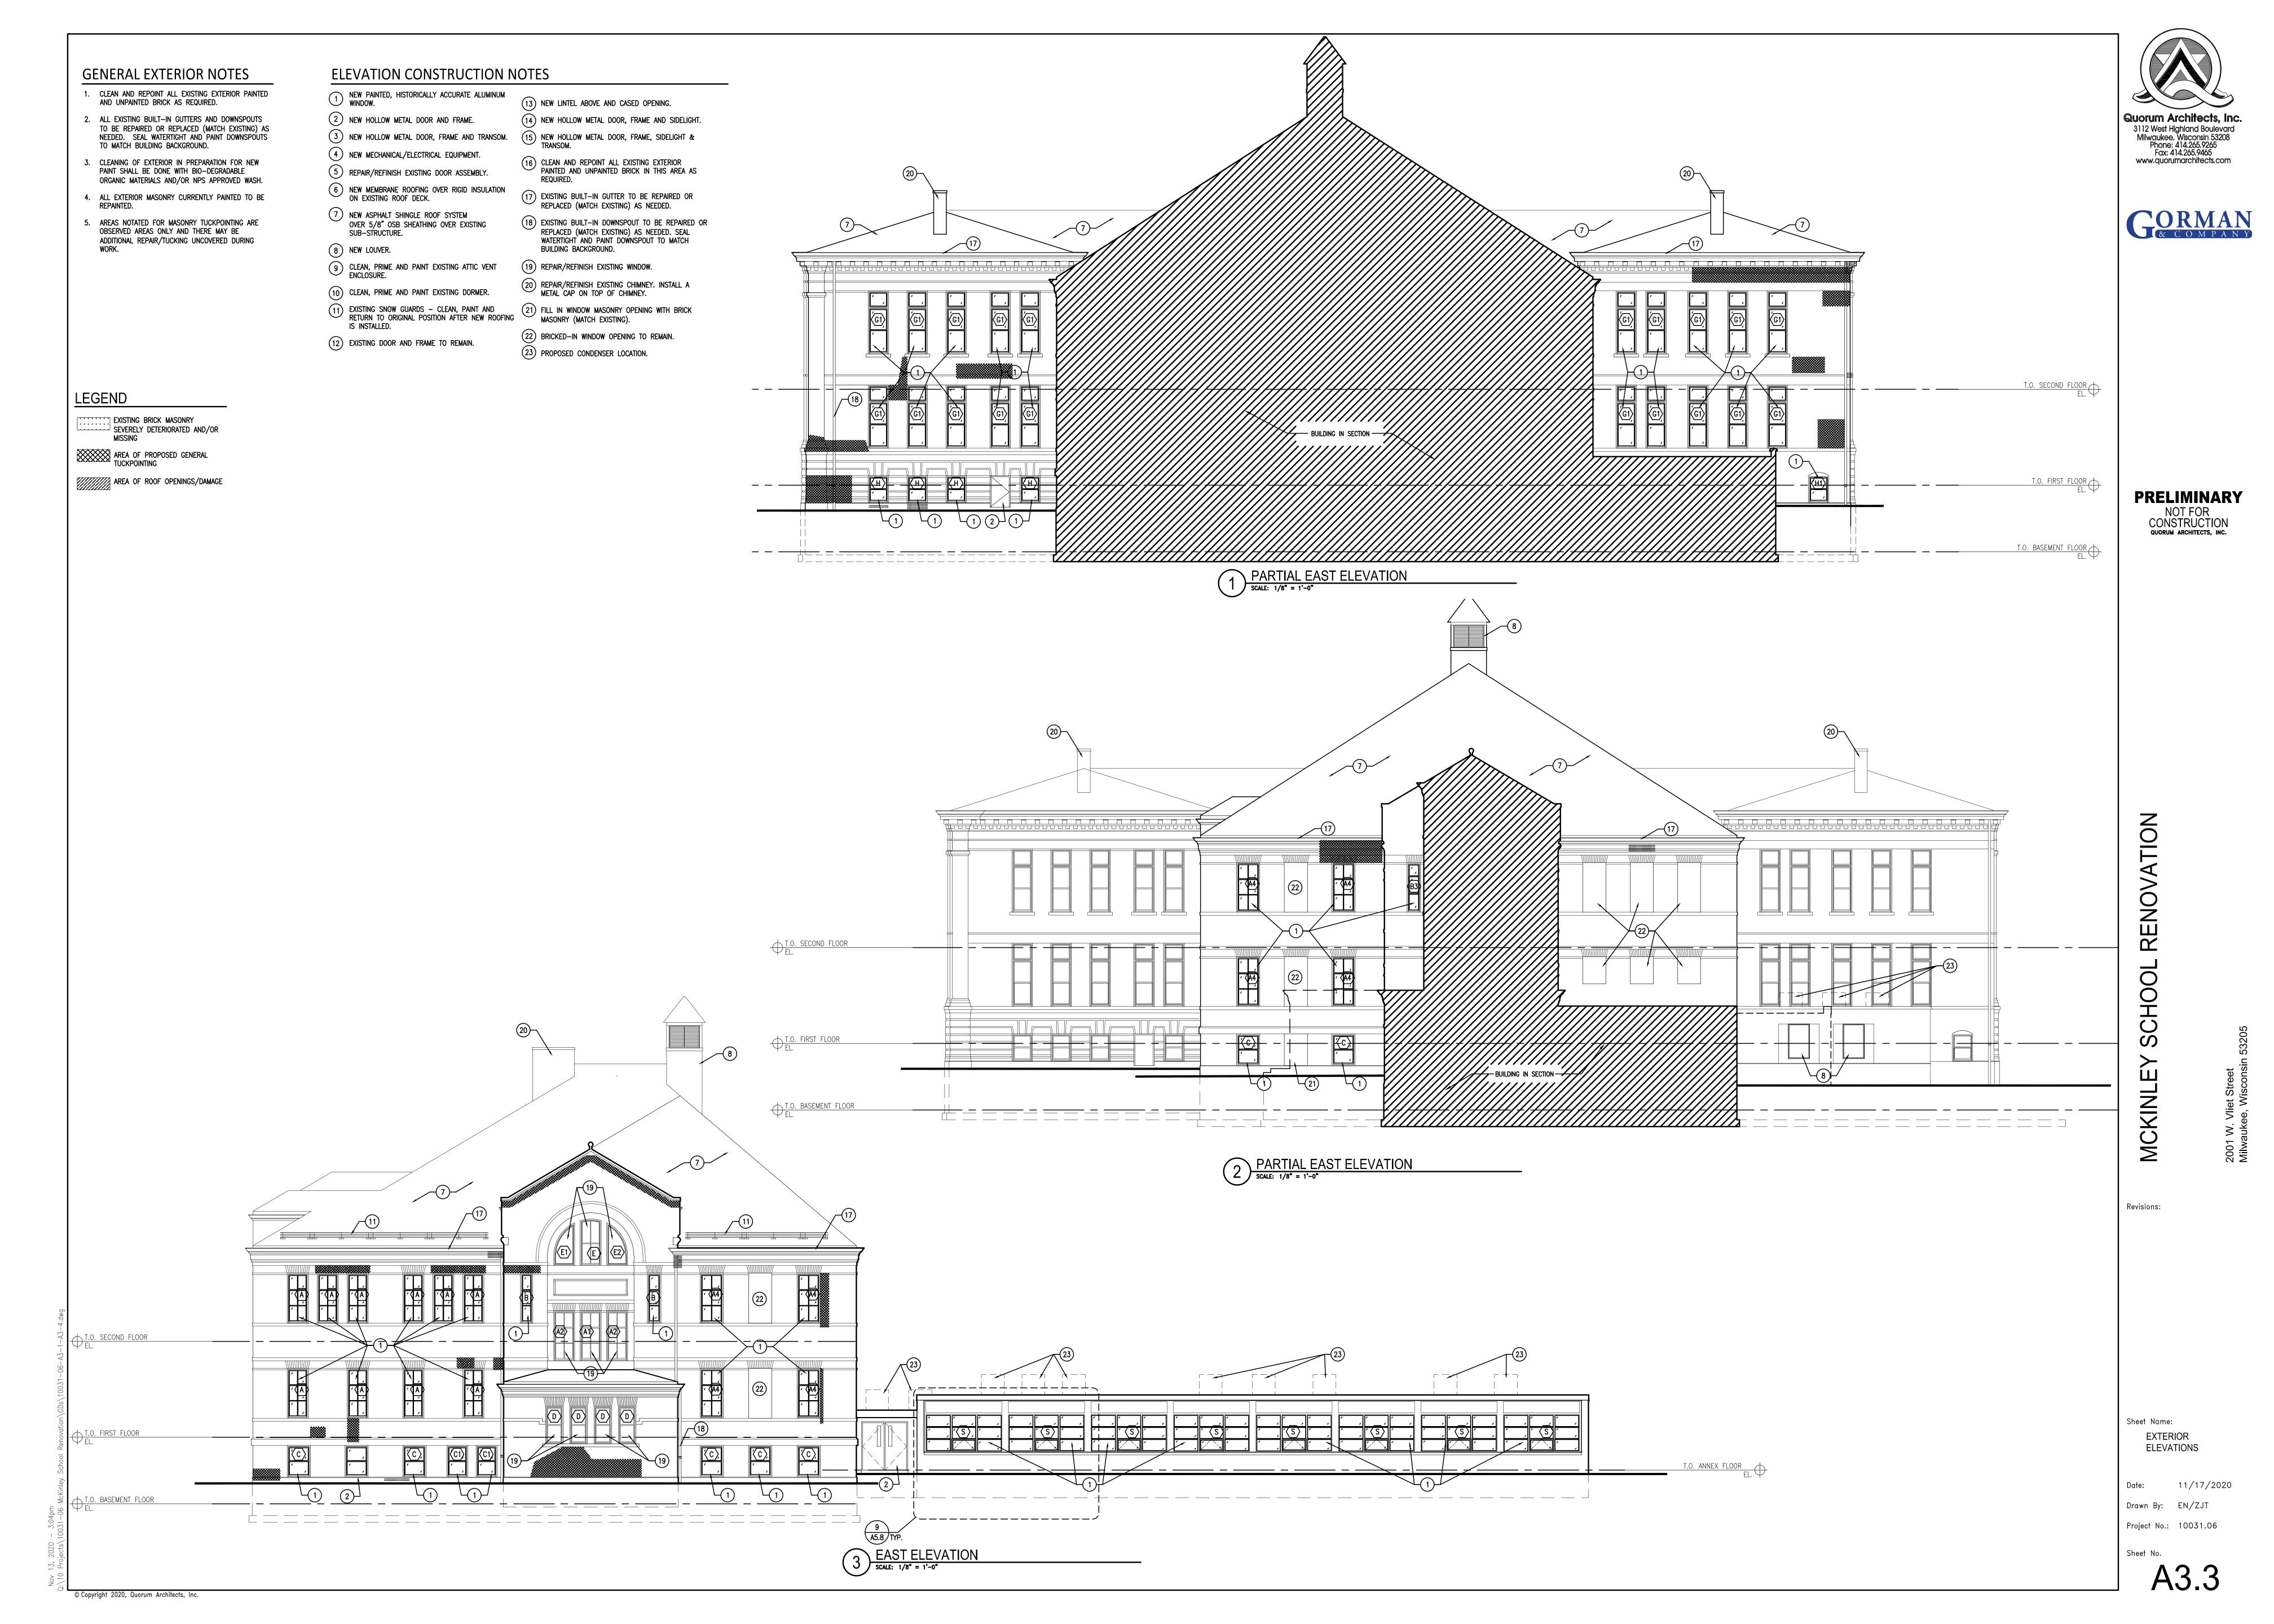

IS INSTALLED.

2. ALL EXISTING BUILT-IN GUTTERS AND DOWNSPOUTS TO BE REPAIRED OR REPLACED (MATCH EXISTING) AS NEEDED. SEAL WATERTIGHT AND PAINT DOWNSPOUTS TO MATCH BUILDING BACKGROUND.

3. CLEANING OF EXTERIOR IN PREPARATION FOR NEW PAINT SHALL BE DONE WITH BIO-DEGRADABLE ORGANIC MATERIALS AND/OR NPS APPROVED WASH.

4. ALL EXTERIOR MASONRY CURRENTLY PAINTED TO BE

5. AREAS NOTATED FOR MASONRY TUCKPOINTING ARE OBSERVED AREAS ONLY AND THERE MAY BE ADDITIONAL REPAIR/TUCKING UNCOVERED DURING

7 NEW ASPHALT SHINGLE ROOF SYSTEM OVER 5/8" OSB SHEATHING OVER EXISTING SUB-STRUCTURE. 8 NEW LOUVER.

(12) EXISTING DOOR AND FRAME TO REMAIN.

 CLEAN, PRIME AND PAINT EXISTING ATTIC VENT ENCLOSURE. (10) CLEAN, PRIME AND PAINT EXISTING DORMER.

6 NEW MEMBRANE ROOFING OVER RIGID INSULATION ON EXISTING ROOF DECK.

ELEVATION CONSTRUCTION NOTES

NEW PAINTED, HISTORICALLY ACCURATE ALUMINUM WINDOW.

BUILDING BACKGROUND.

(19) REPAIR/REFINISH EXISTING WINDOW.

LIGHT COURT B

LIGHT COURT A

20) REPAIR/REFINISH EXISTING CHIMNEY. INSTALL A METAL CAP ON TOP OF CHIMNEY.

(13) NEW LINTEL ABOVE AND CASED OPENING.

(14) NEW HOLLOW METAL DOOR, FRAME AND SIDELIGHT.

(15) NEW HOLLOW METAL DOOR, FRAME, SIDELIGHT &

CLEAN AND REPOINT ALL EXISTING EXTERIOR PAINTED AND UNPAINTED BRICK IN THIS AREA AS

EXISTING BUILT-IN GUTTER TO BE REPAIRED OR REPLACED (MATCH EXISTING) AS NEEDED.

(18) EXISTING BUILT-IN DOWNSPOUT TO BE REPAIRED OR

REPLACED (MATCH EXISTING) AS NEEDED. SEAL WATERTIGHT AND PAINT DOWNSPOUT TO MATCH

EXISTING SNOW GUARDS — CLEAN, PAINT AND RETURN TO ORIGINAL POSITION AFTER NEW ROOFING (MASONRY (MATCH EXISTING)).

22) BRICKED-IN WINDOW OPENING TO REMAIN. (23) PROPOSED CONDENSER LOCATION.

1 WEST ELEVATION - LIGHT COURT
SCALE: 1/8" = 1'-0"

3 EAST ELEVATION - LIGHT COURT

SCALE: 1/8" = 1'-0"

LEGEND

AREA OF ROOF OPENINGS/DAMAGE

AREA OF PROPOSED GENERAL TUCKPOINTING

SEVERELY DETERIORATED AND/OR

EXISTING BRICK MASONRY

LIGHT COURT A

LIGHT COURT B

T.O. BASEMENT FLOOR

SOUTH ELEVATION - LIGHT COURT

SCALE: 1/8" = 1'-0"

4 NORTH ELEVATION - LIGHT COURT

SCALE: 1/8" = 1'-0"

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Sheet Name: **EXTERIOR**

ELEVATIONS


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> Sheet No. A3.4

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T.O. FIRST FLOOR EL.

T.O. BASEMENT FLOOR EL.



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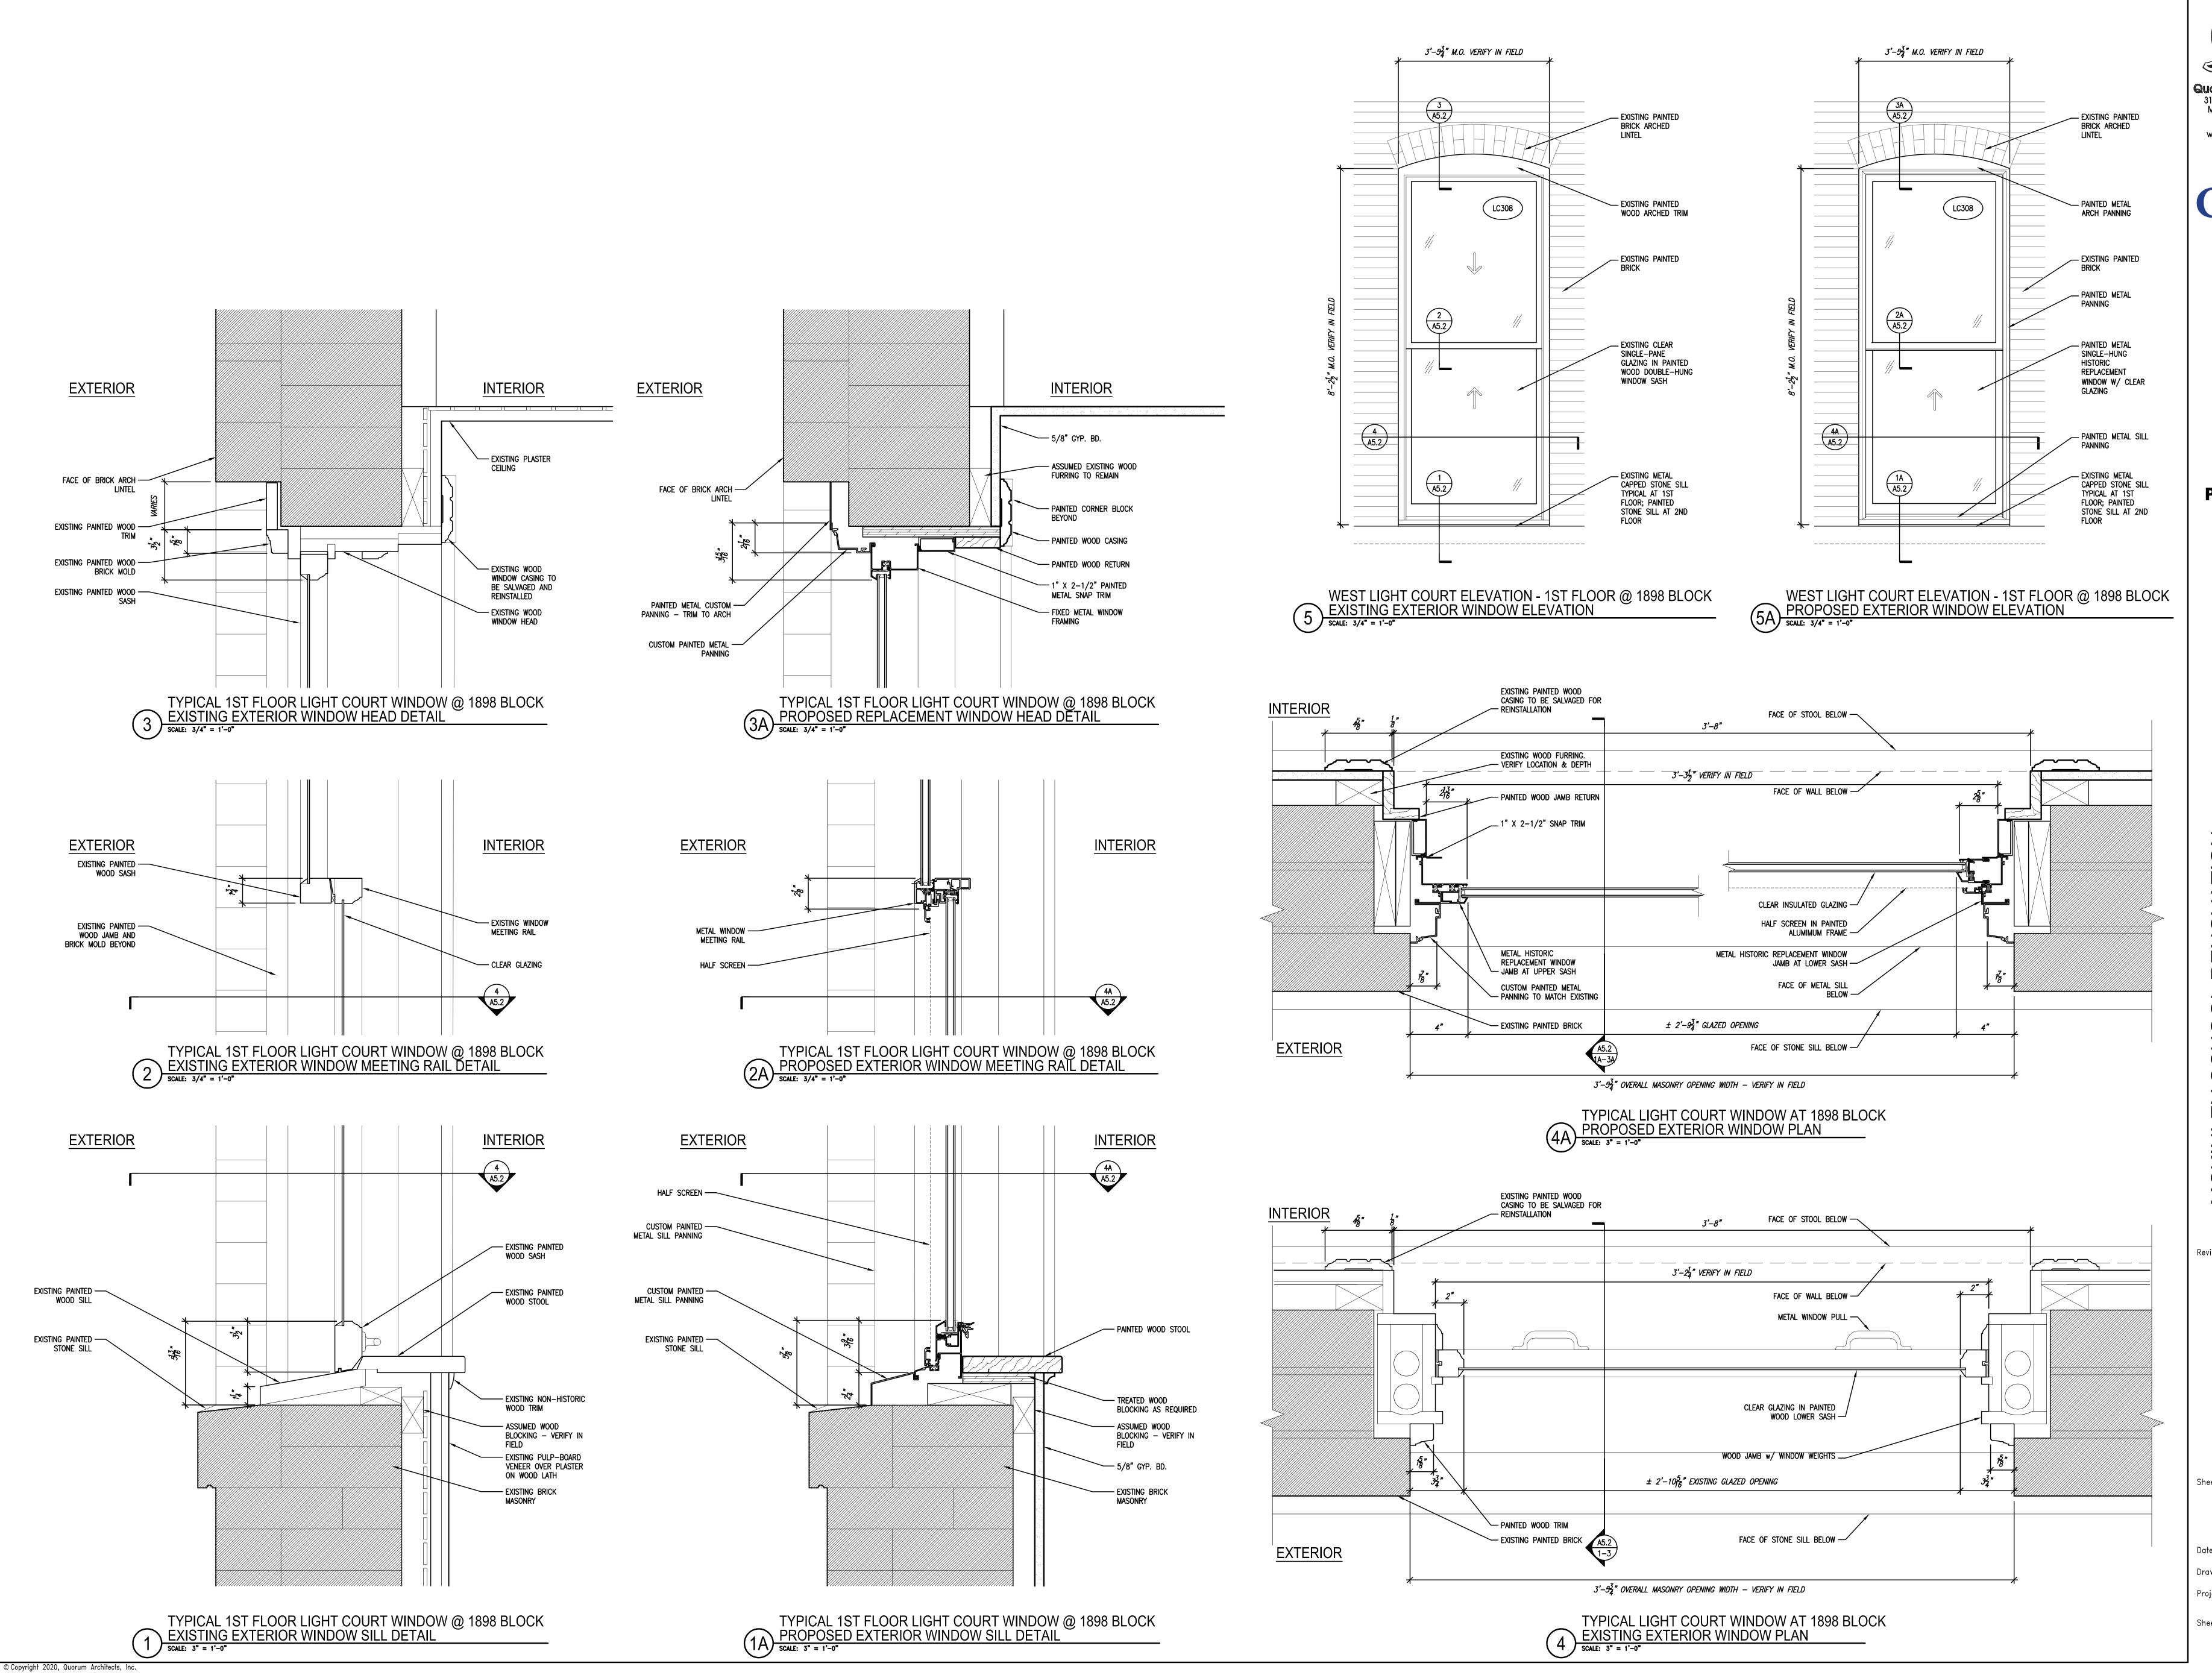
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11/17/2020 Drawn By: MWK/ECR Project No.: 10031.06

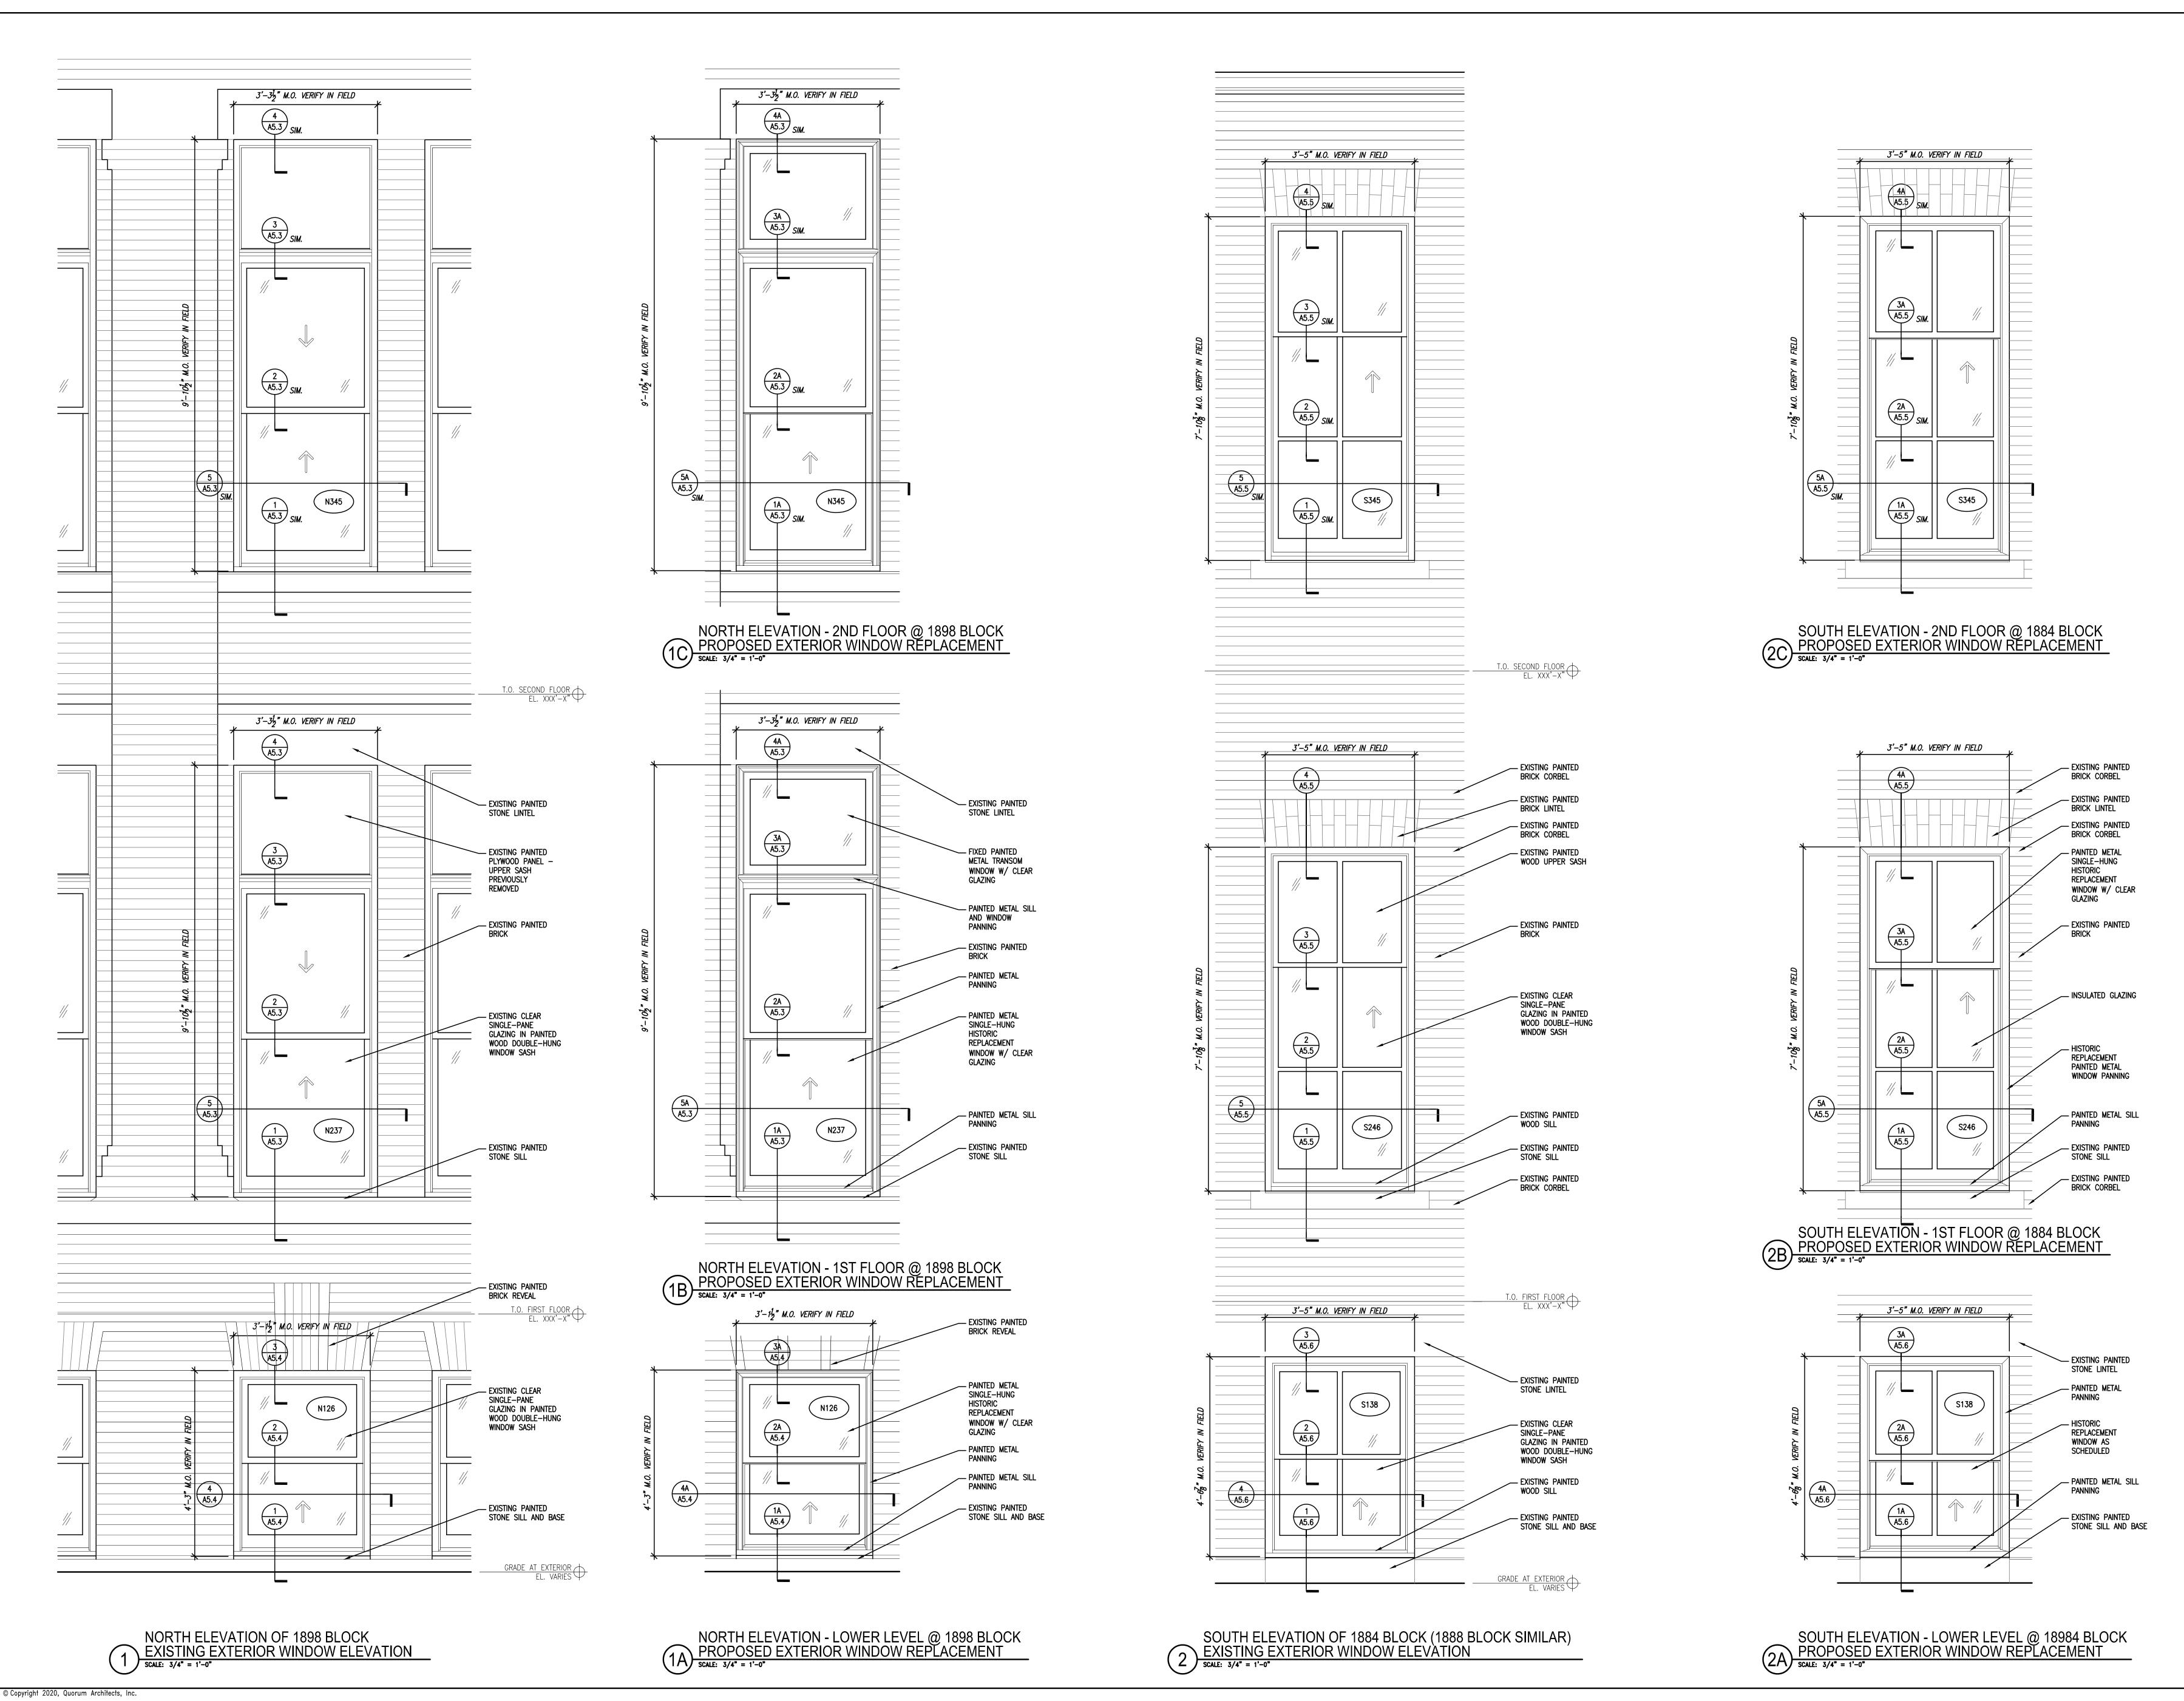Sheet No. A5.1

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Revisions:

1.041310113.

Sheet Name:
HISTORIC WINDOW
REPLACEMENT DETAILS

Date: 11/17/2020

Drawn By: MWK/ECR

Project No.: 10031.06

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MCKINLEY SCHOOL RENOVATION

Revisions:

Sheet Name:
HISTORIC WINDOW
REPLACEMENT DETAILS

Date: 11/17/2020

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Project No.: 10031.06


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Sheet Name: HISTORIC WINDOW

REPLACEMENT DETAILS 11/17/2020

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MCKINLEY SCHOOL RENOVATION

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Sheet Name:
HISTORIC WINDOW
REPLACEMENT DETAILS

Date: 11/17/2020

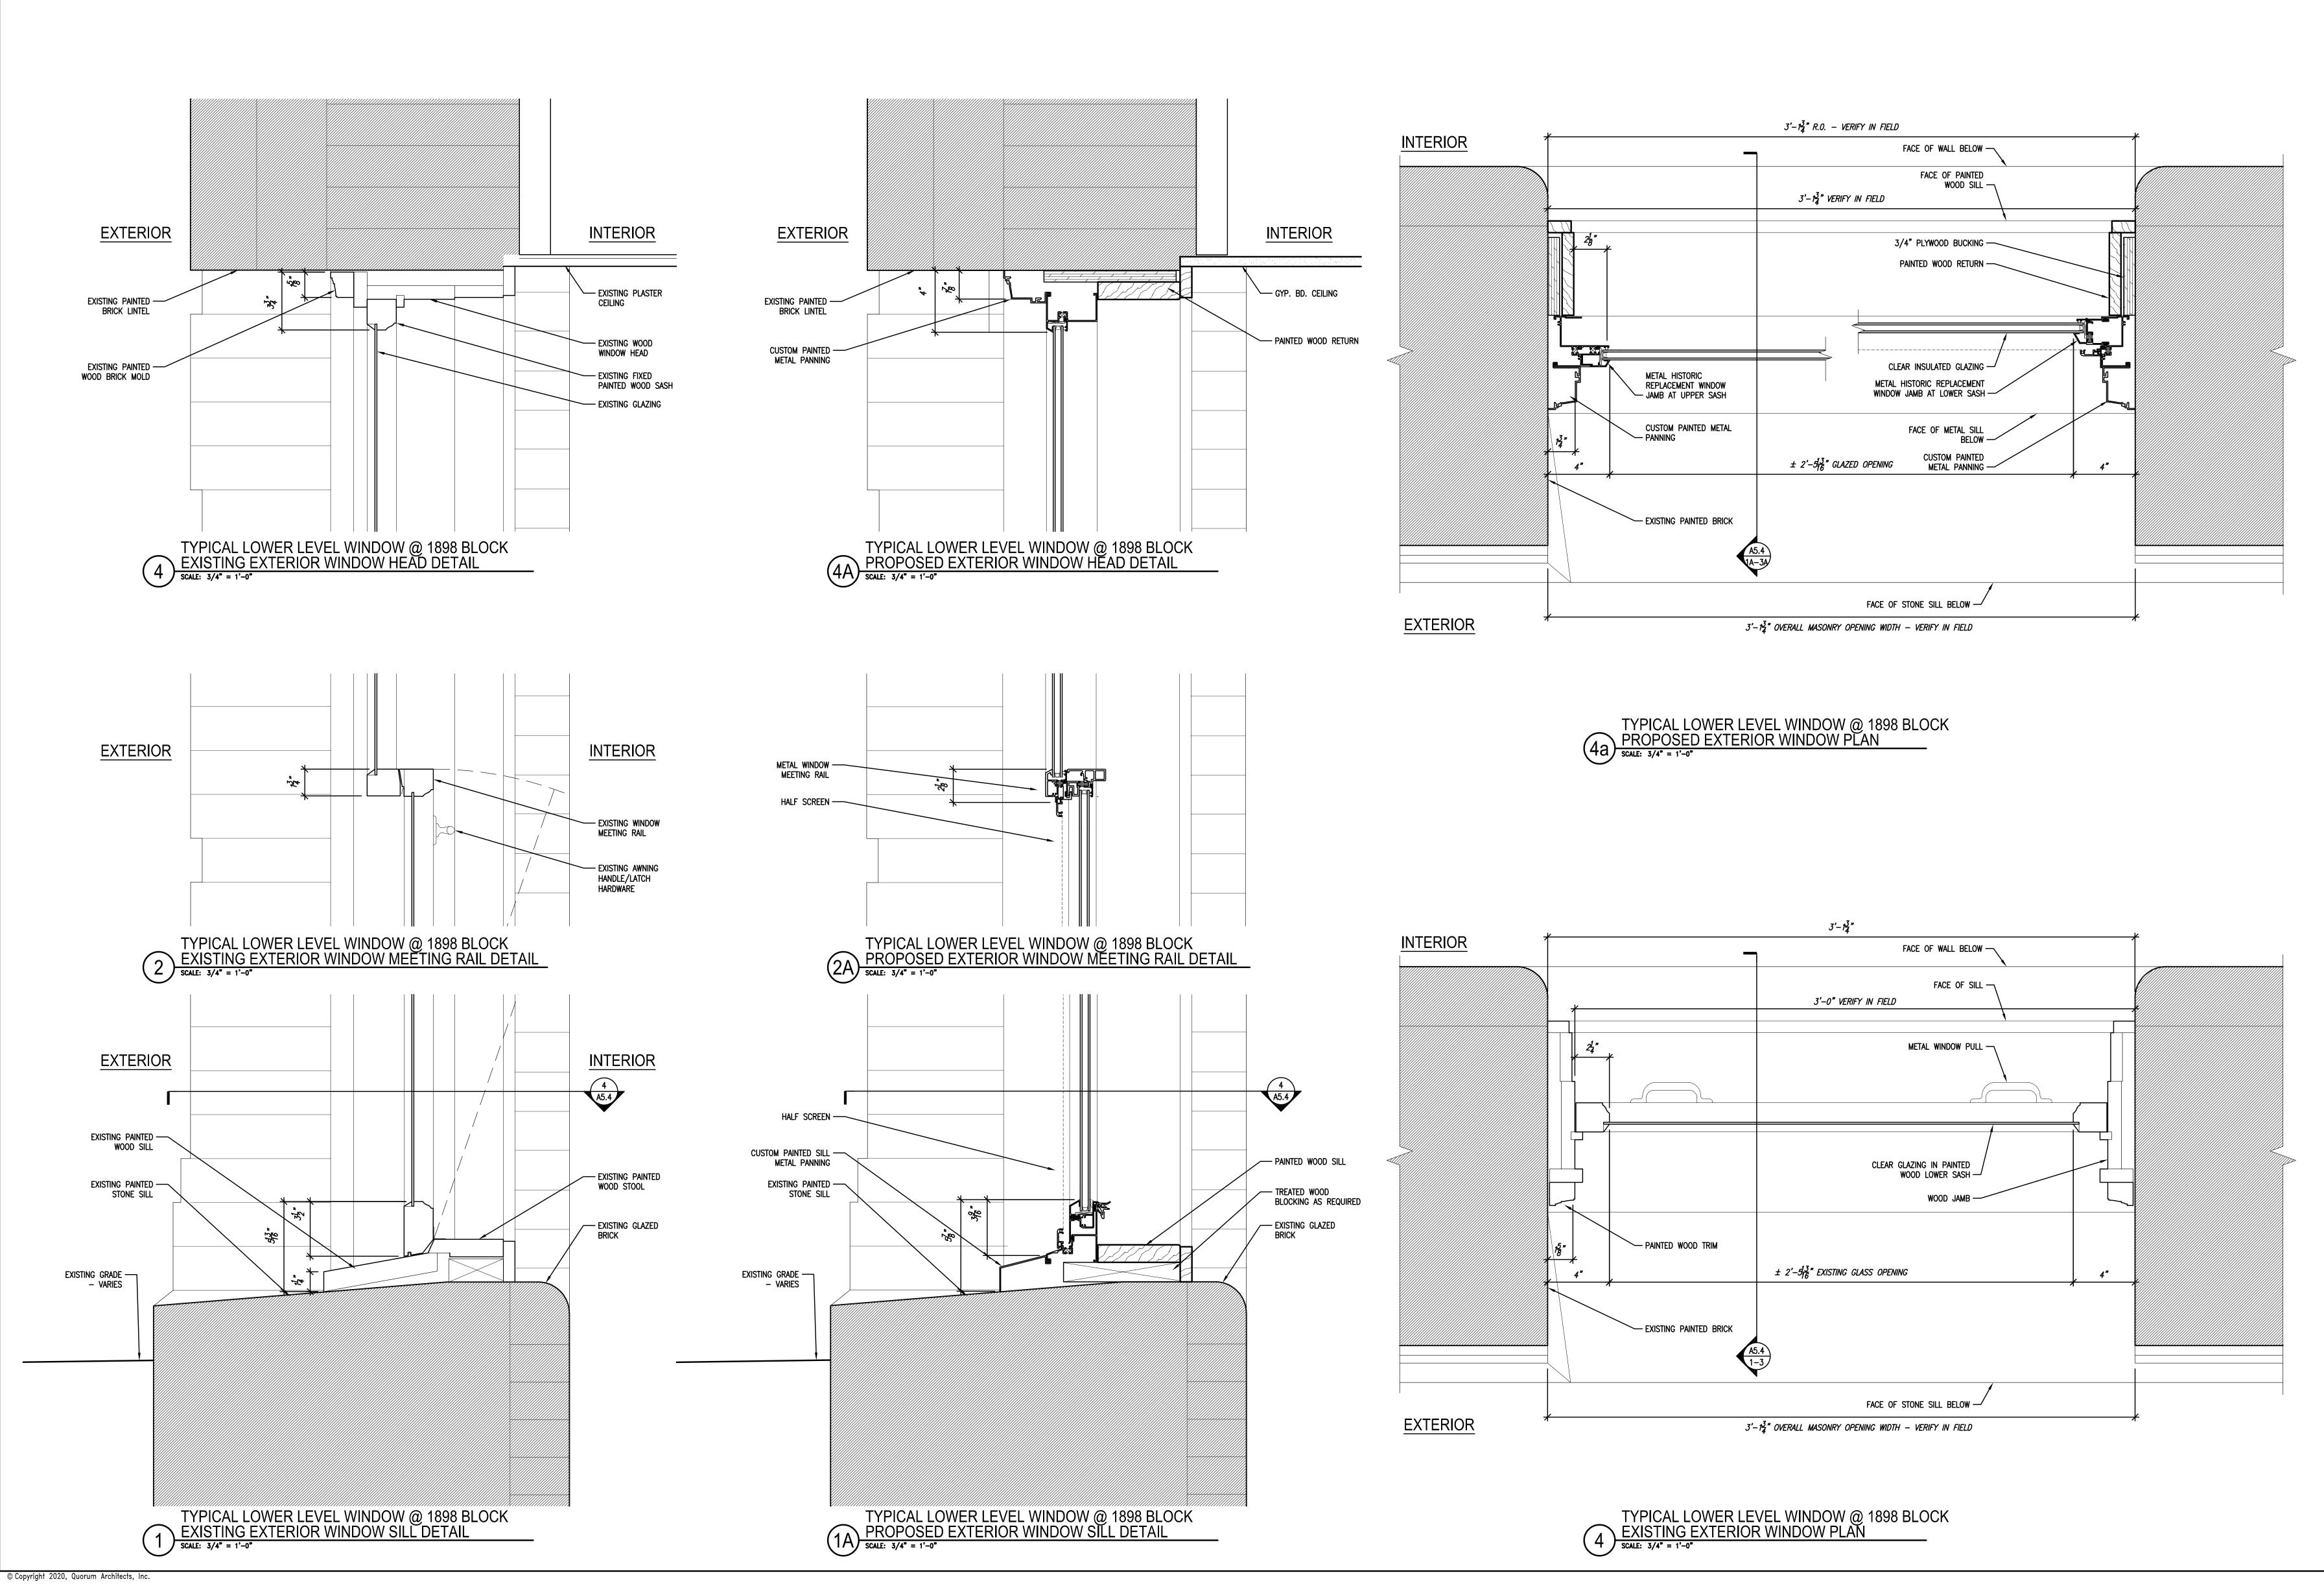Drawn By: MWK/ECR

Project No.: 10031.06


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INTERIOR

INTERIOR

MASONRY

4A A5.6

TYPICAL LOWER LEVEL WINDOW @ 1884 BLOCK
PROPOSED EXTERIOR WINDOW MEETING RAIL DETAIL

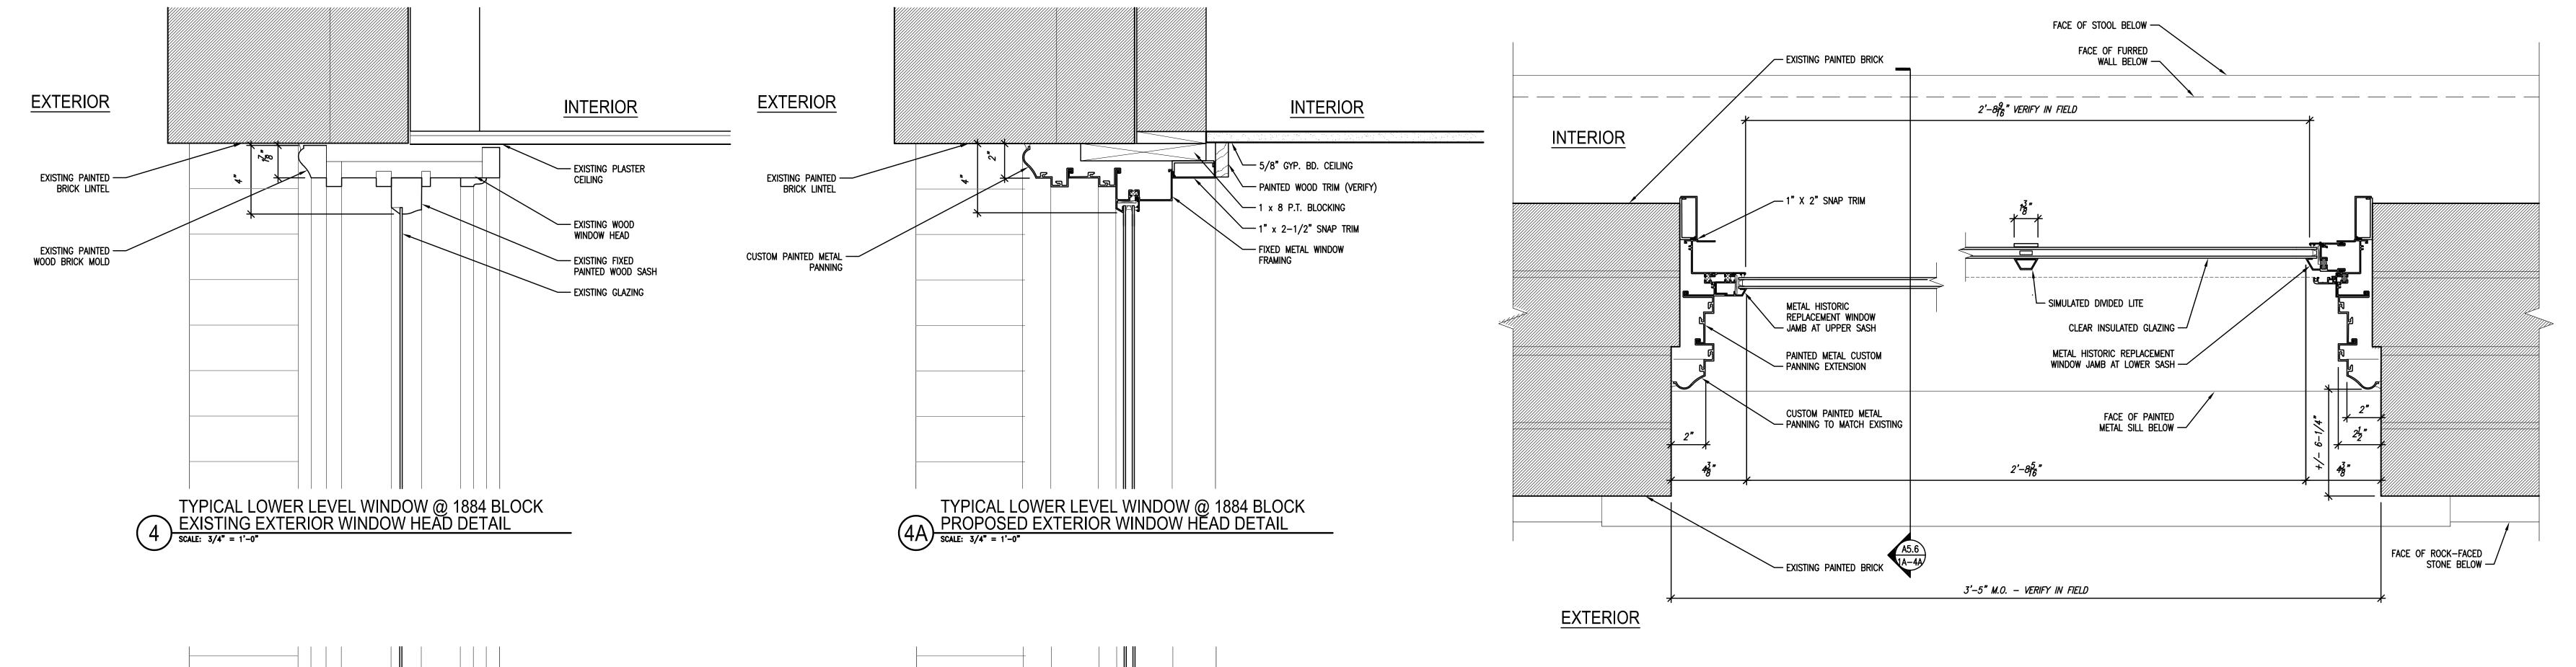SCALE: 3/4" = 1'-0"

TYPICAL LOWER LEVEL WINDOW @ 1884 BLOCK
PROPOSED EXTERIOR WINDOW SILL DETAIL

SCALE: 3/4" = 1'-0"

EXTERIOR

METAL WINDOW — MEETING RAIL

HALF SCREEN -

EXTERIOR

HALF SCREEN -

CUSTOM PAINTED —— METAL SILL PANNING

EXISTING PAINTED — STONE SILL

INTERIOR

— EXISTING WINDOW MEETING RAIL


INTERIOR

EXISTING PAINTED WOOD STOOL

___ EXISTING FURRED

TYPICAL LOWER LEVEL WINDOW @ 1884 BLOCK PROPOSED EXTERIOR WINDOW PLAN

SCALE: 3/4" = 1'-0"

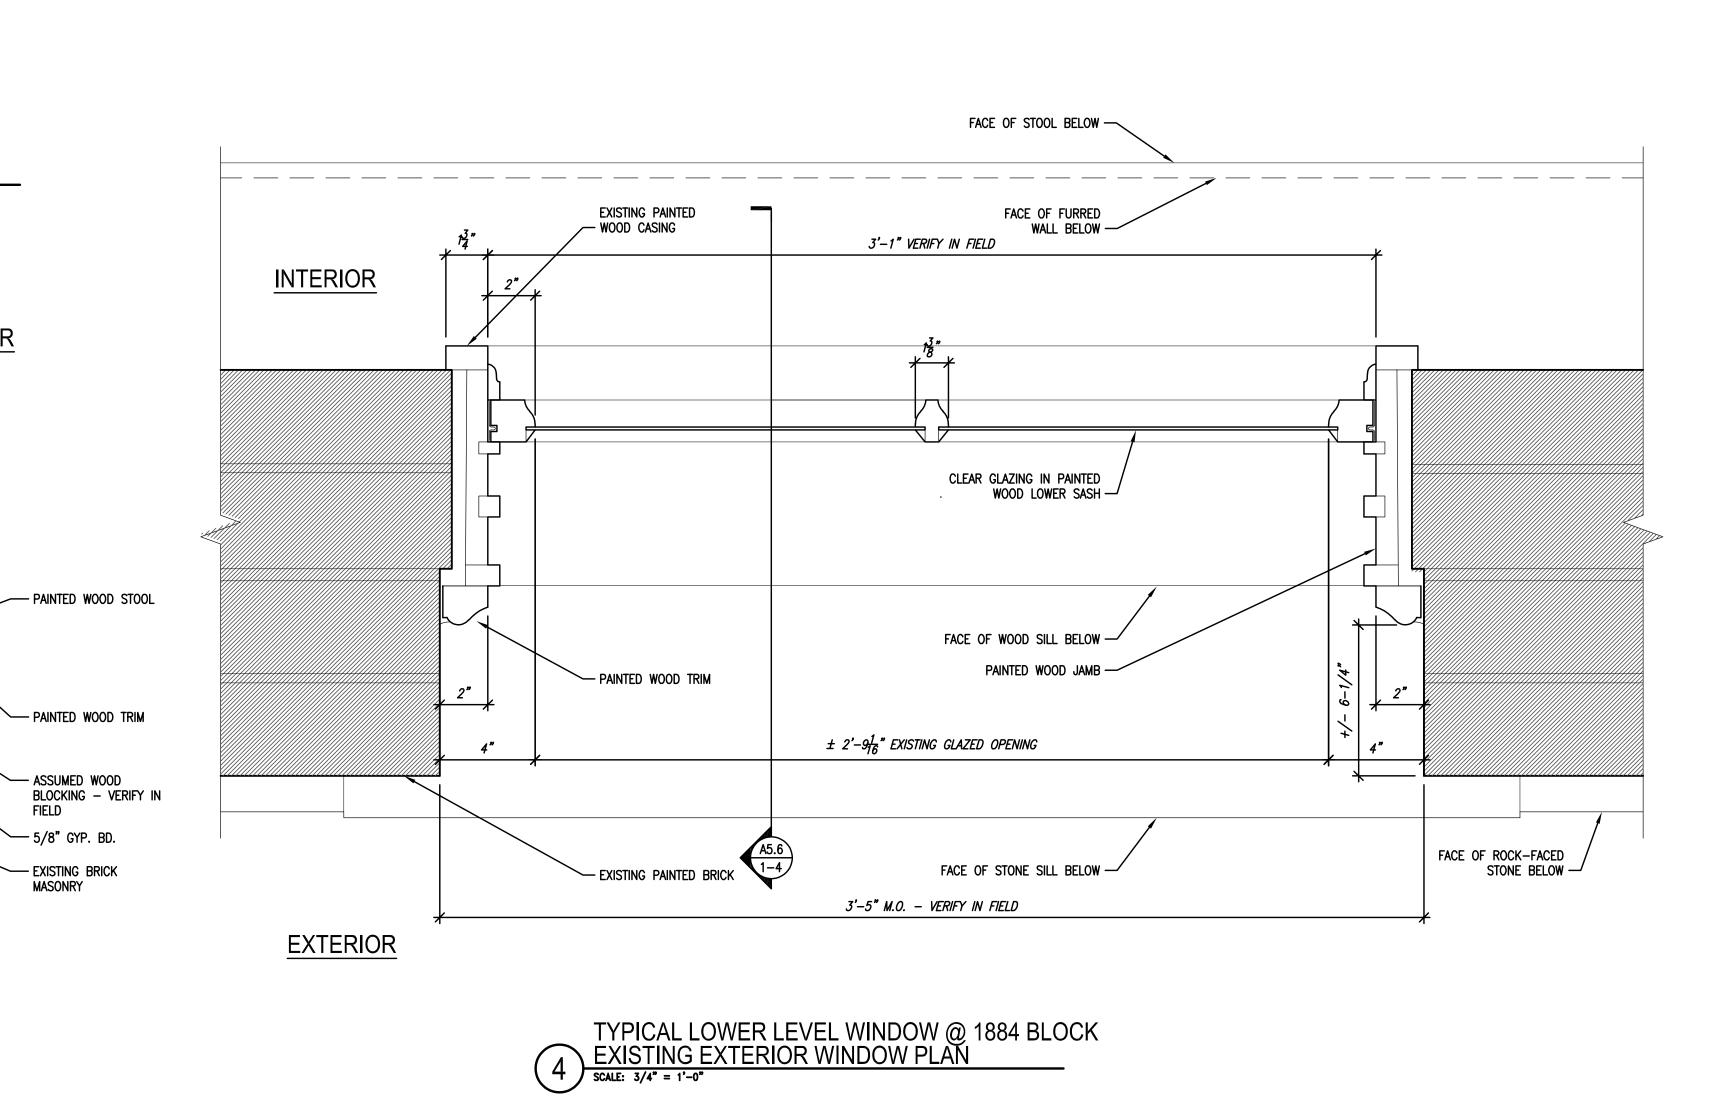

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Sheet Name: HISTORIC WINDOW REPLACEMENT DETAILS

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A5.6

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EXTERIOR

EXTERIOR

EXISTING PAINTED — WOOD SILL

EXISTING PAINTED — STONE SILL

EXISTING GRADE — - VARIES

TYPICAL LOWER LEVEL WINDOW @ 1884 BLOCK

EXISTING EXTERIOR WINDOW MEETING RAIL DETAIL

SCALE: 3/4" = 1'-0"

TYPICAL LOWER LEVEL WINDOW @ 1884 BLOCK

EXISTING EXTERIOR WINDOW SILL DETAIL


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Date: 11/17/2020 Drawn By: MWK/ECR

DETAILS

Project No.: 10031.06


Sheet No.

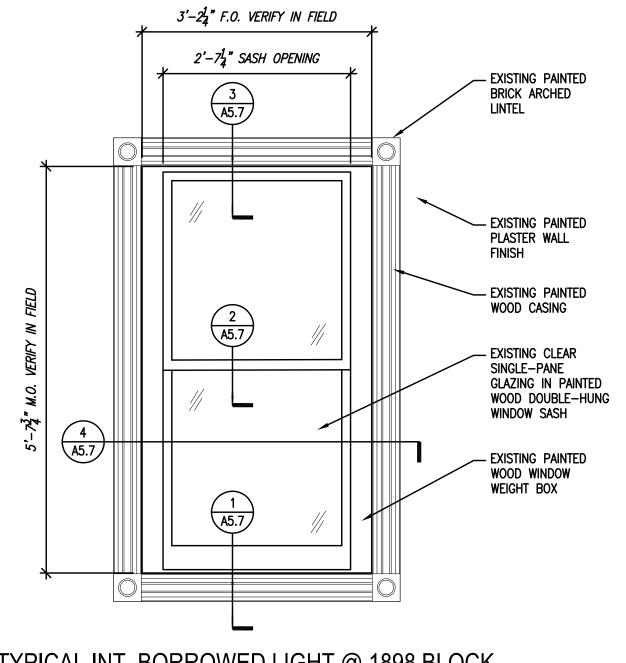

TYPICAL INT. BORROWED LIGHT @ 1898 BLOCK

5 EXISTING INTERIOR WINDOW ELEVATION AT CORRIDOR


SCALE: 3/4" = 1'-0"

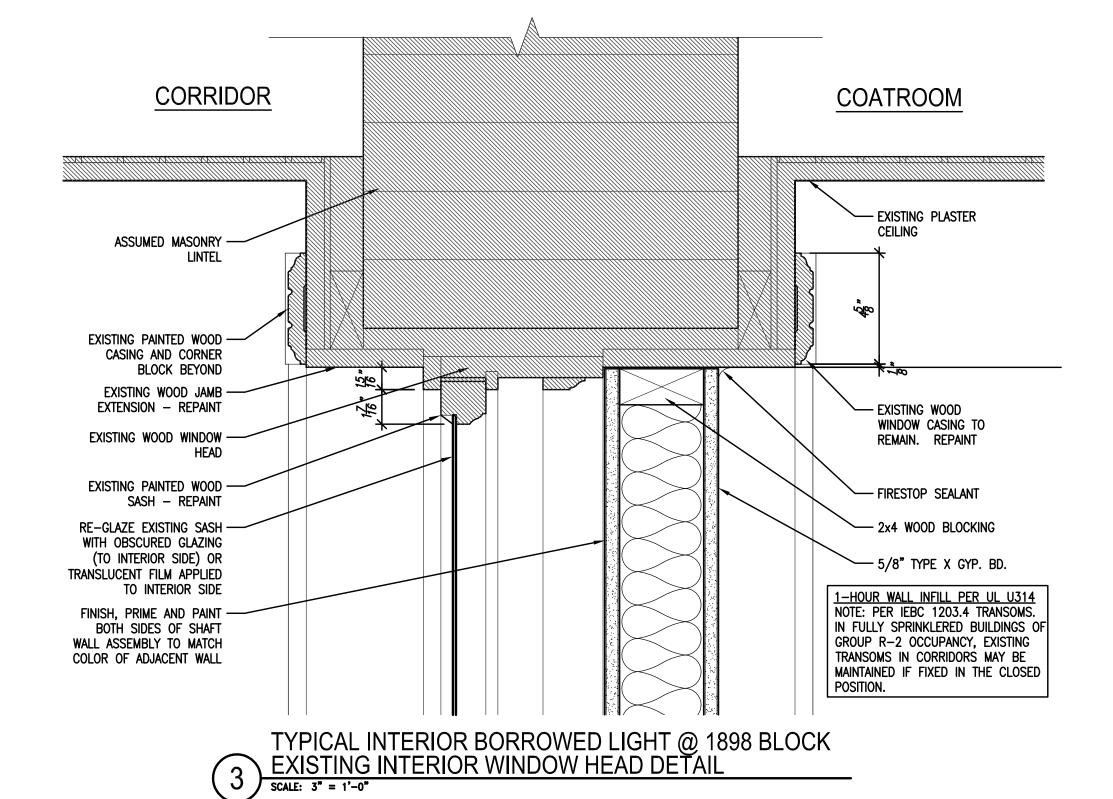

CORRIDOR COATROOM EXISTING PAINTED -WOOD SASH -REPAINT — EXISTING WINDOW MEETING RAIL — REPAINT EXISTING PAINTED — WOOD JAMB BEYOND - REPAINT (TYPICAL) - RE-GLAZE EXISTING SASH WITH OBSCURED GLAZING (TO INTERIOR SIDE) OR TRANSLUCENT FILM APPLIED TO INTERIOR SIDE

TYPICAL INTERIOR BORROWED LIGHT @ 1898 BLOCK EXISTING INTERIOR WINDOW MEETING RAIL DETAIL


SCALE: 3" = 1'-0"

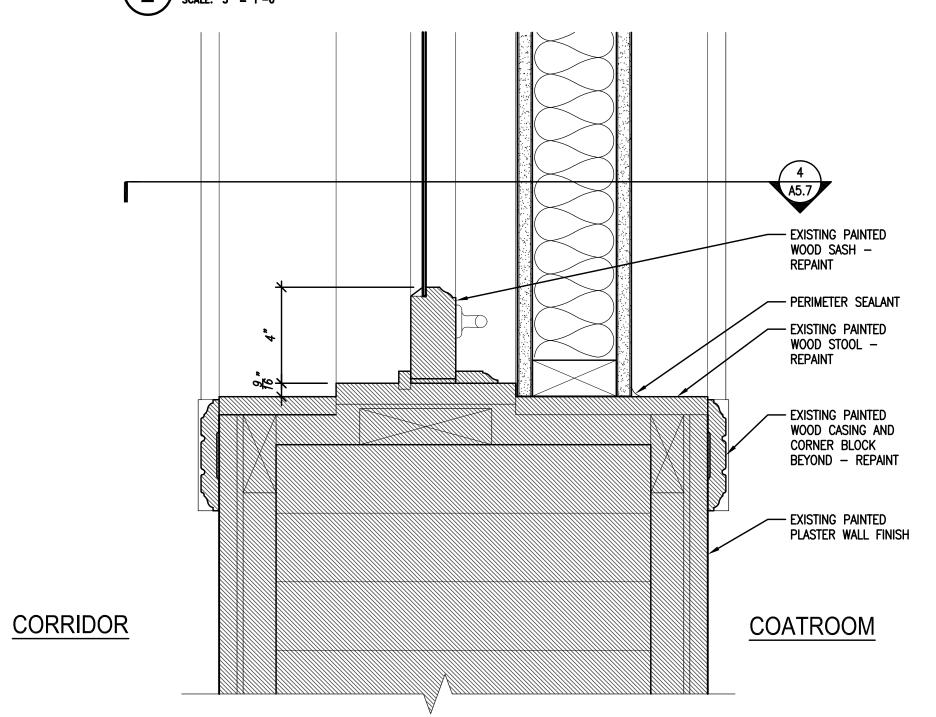

TYPICAL INTERIOR BORROWED LIGHT @ 1898 BLOCK

EXISTING INTERIOR WINDOW SILL DETAIL

SCALE: 3" = 1'-0"

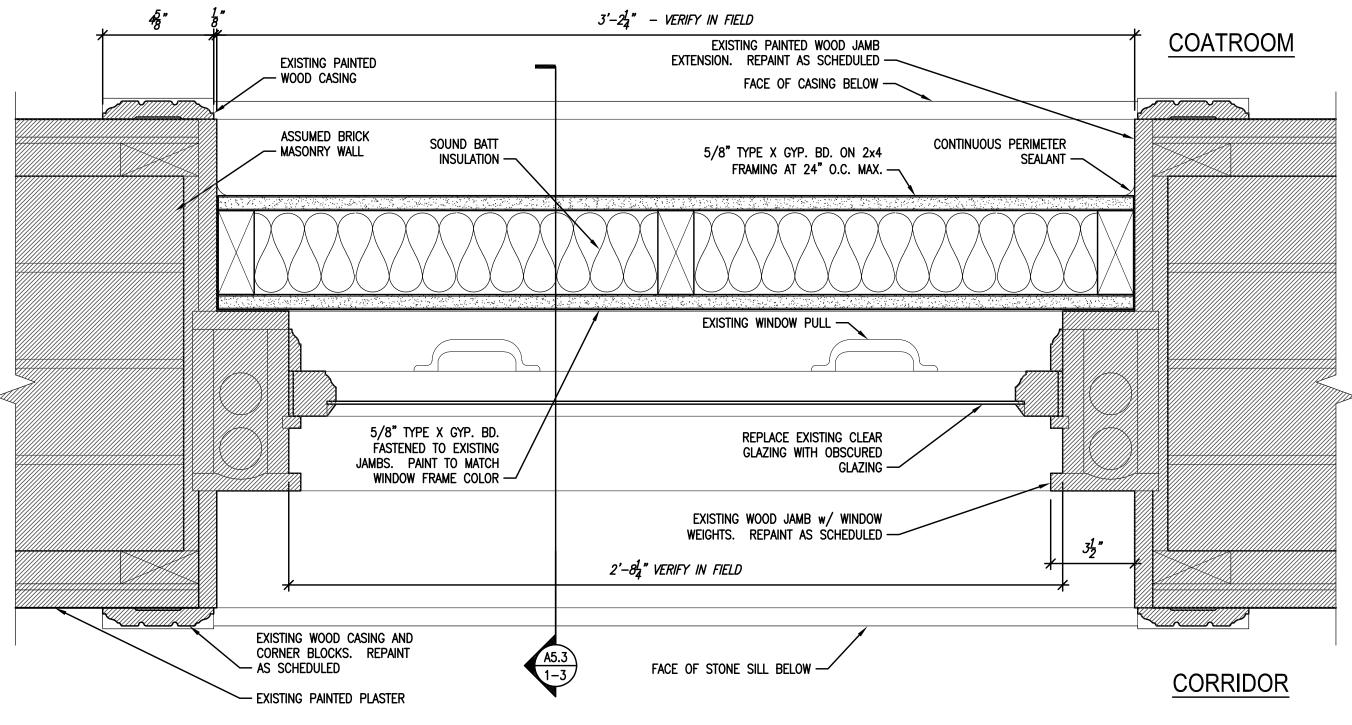


TYPICAL INT. BORROWED LIGHT @ 1898 BLOCK

EXISTING INTERIOR WINDOW PLAN

SCALE: 3/4" = 1'-0"

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PRELIMINARY NOT FOR CONSTRUCTION

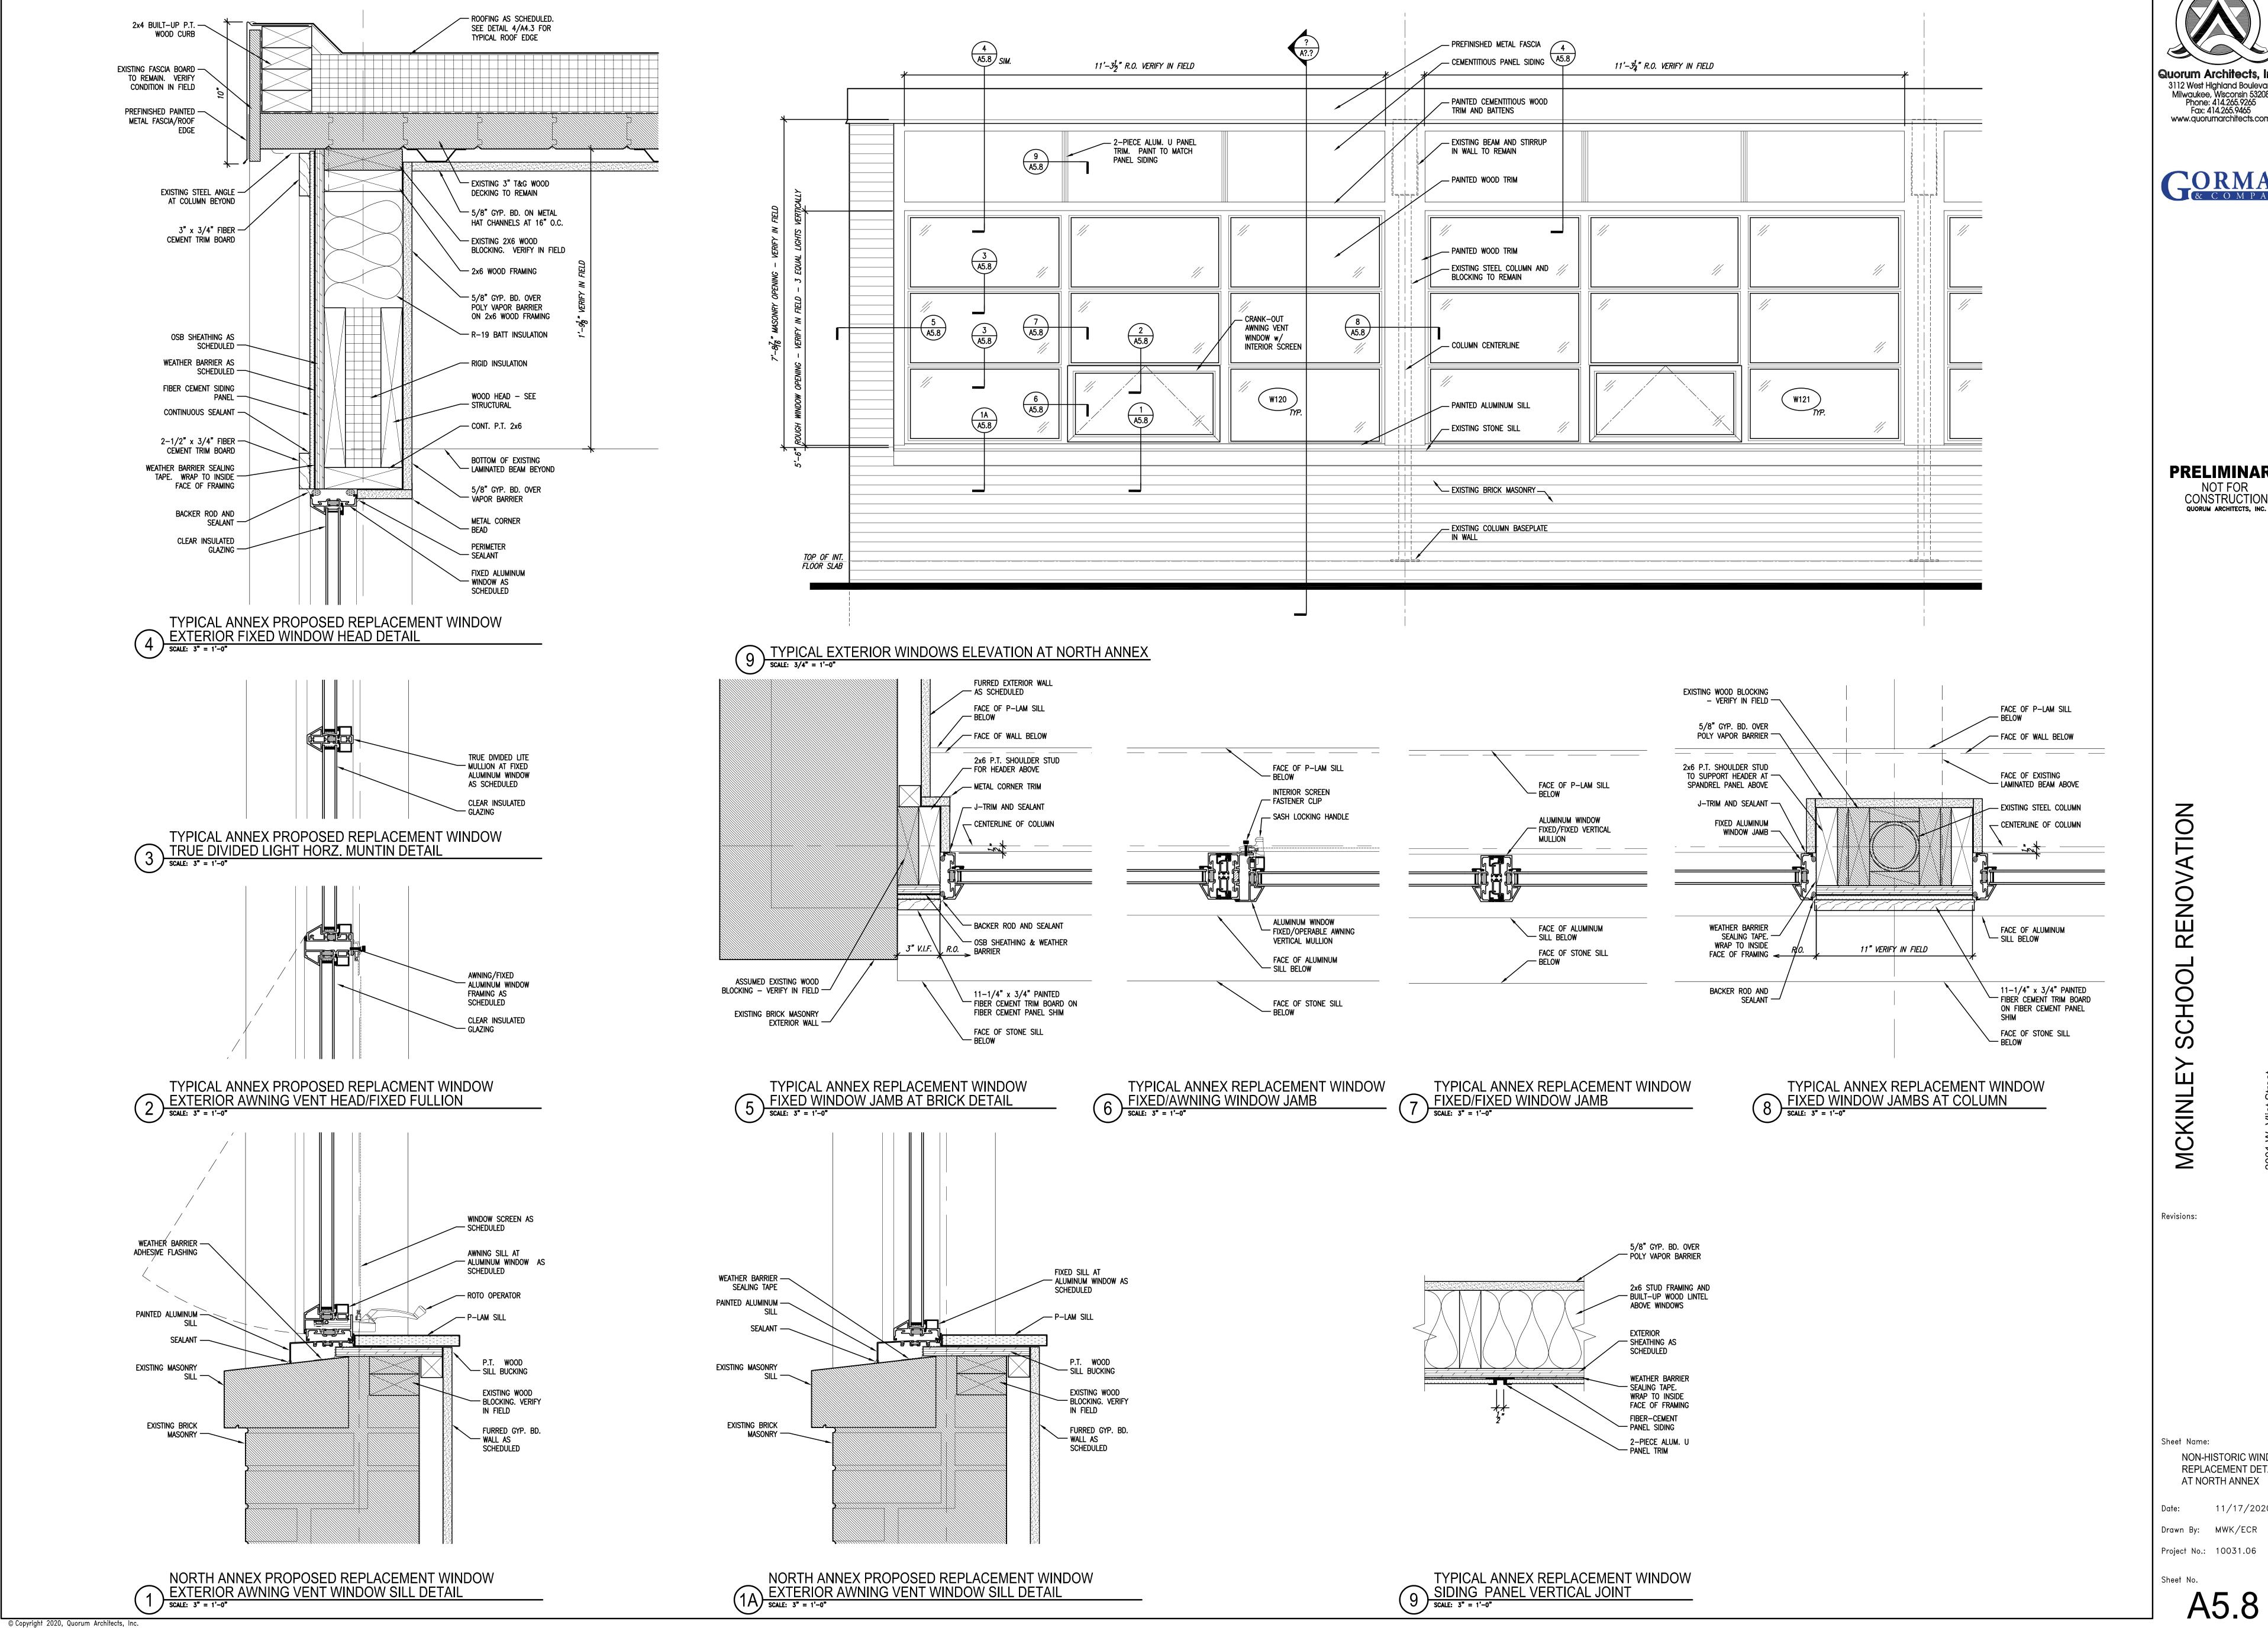Sheet Name: NON-HISTORIC WINDOW REPLACEMENT DETAILS AT NORTH ANNEX

11/17/2020 Drawn By: MWK/ECR Project No.: 10031.06

Sheet No.

— ASPHALT SHINGLE ROOF AT DORMER

FLASHING - REPAINT

- PAINTED METAL HISTORIC

REPLACEMENT CASEMENT

WINDOW W/ CLEAR GLAZING

__ EXISTING METAL

— PAINTED WOOD

- SHINGLE SIDING

- PAINTED WOOD TRIM TO MATCH EXISTING

- PAINTED METAL SILL

— EXISTING PAINTED

— EXISTING METAL

EPDM MEMBRANE

GUTTER LINED WITH

STONE SILL

CORNICE

1'-9" R.O. VERIFY IN FIELD

S415

S409 S413

\$410 3 \$414 A5.9

TYPICAL ATTIC DORMER WINDOWS AT 1884 BLOCK PROPOSED REPLACEMENT WINDOW ELEVATION

SCALE: 3/4" = 1'-0"



PRELIMINARY NOT FOR CONSTRUCTION QUORUM ARCHITECTS, INC.

RENOVATION S MCKINLE

Revisions:

EXISTING PAINTED

PAINTED CASEMENTWINDOW W/ CLEAR

GLAZING

REPLACEMENT

PAINTED METAL

PAINTED METAL SILL

- Existing painted Stone sill

— EXISTING PAINTED BRICK CORBEL

Sheet Name: ATTIC WINDOW


REPLACEMENT DETAILS


11/17/2020 Drawn By: MWK/ECR


Project No.: 10031.06

Sheet No.

A5.9

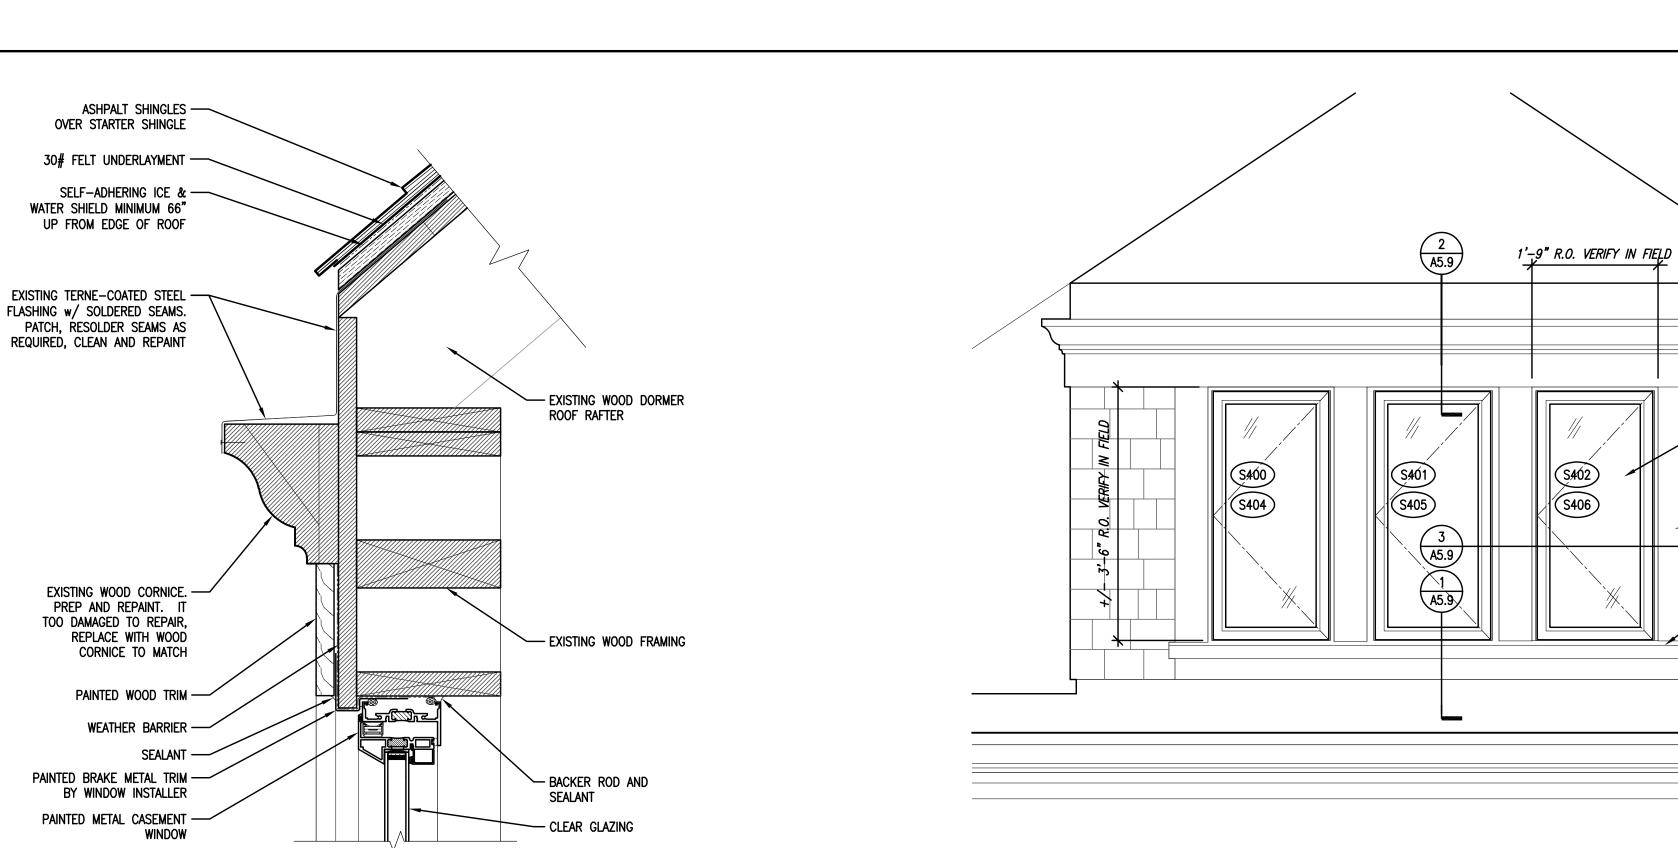

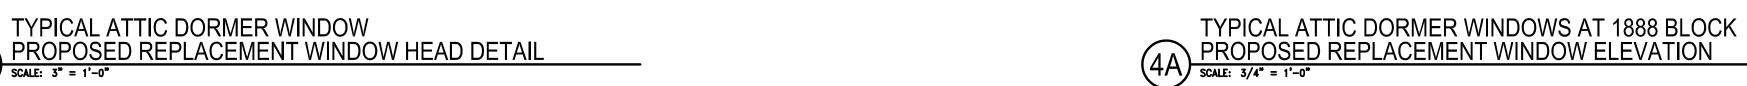

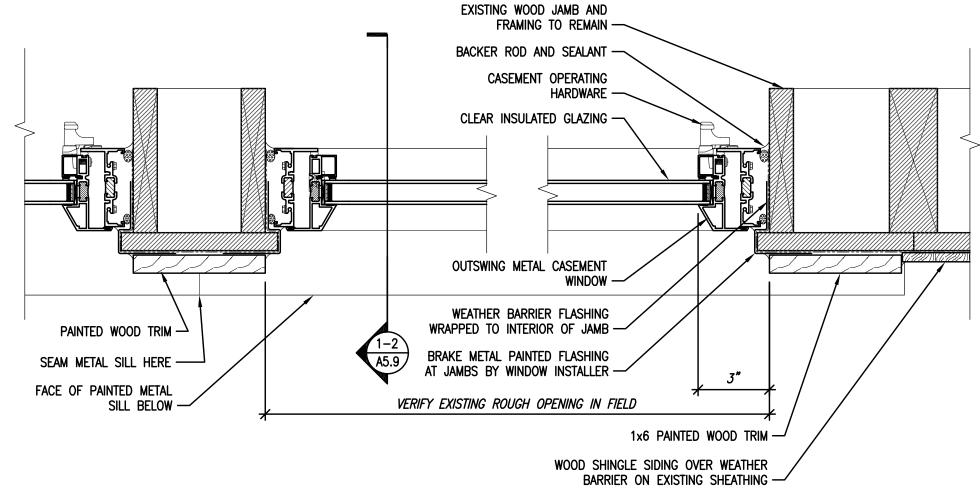

– ASPHALT SHINGLE ROOF AT DORMER

FLASHING - REPAINT

– EXISTING METAL

- PAINTED WOOD

– PAINTED METAL

HISTORIC REPLACEMENT

CASEMENT WINDOW

W/ CLEAR GLAZING

- PAINTED WOOD TRIM TO MATCH EXISTING

- PAINTED METAL SILL

- EXISTING PAINTED

- EXISTING METAL

GUTTER LINED WITH


EPDM MEMBRANE

STONE SILL

- SHINGLE SIDING

CORNICE




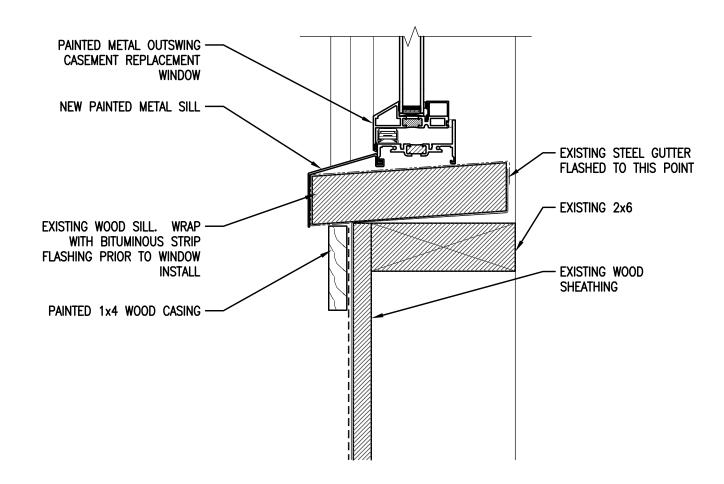

TYPICAL ATTIC DORMER WINDOW


PROPOSED REPLACEMENT WINDOW SILL DETAIL


SCALE: 3" = 1'-0"

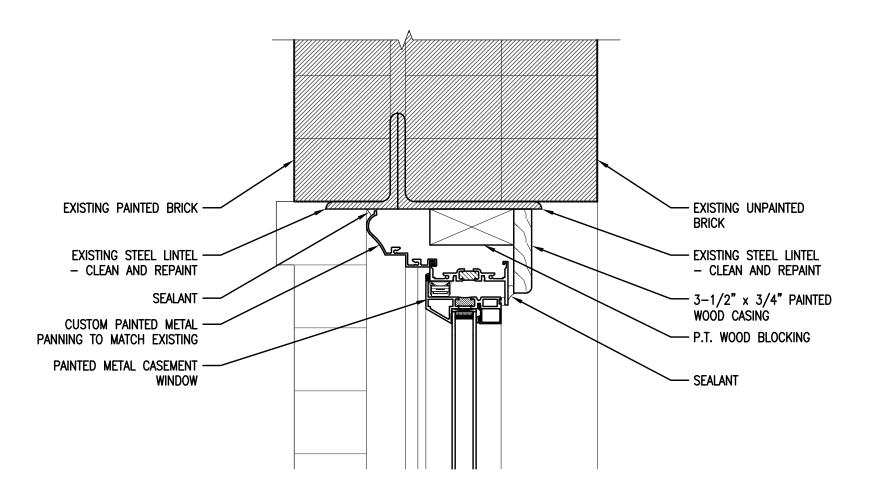

TYPICAL ATTIC WINDOW @1926 CONNECTOR
PROPOSED REPLACEMENT WINDOW SILL DETAIL

SCALE: 3" = 1'-0"

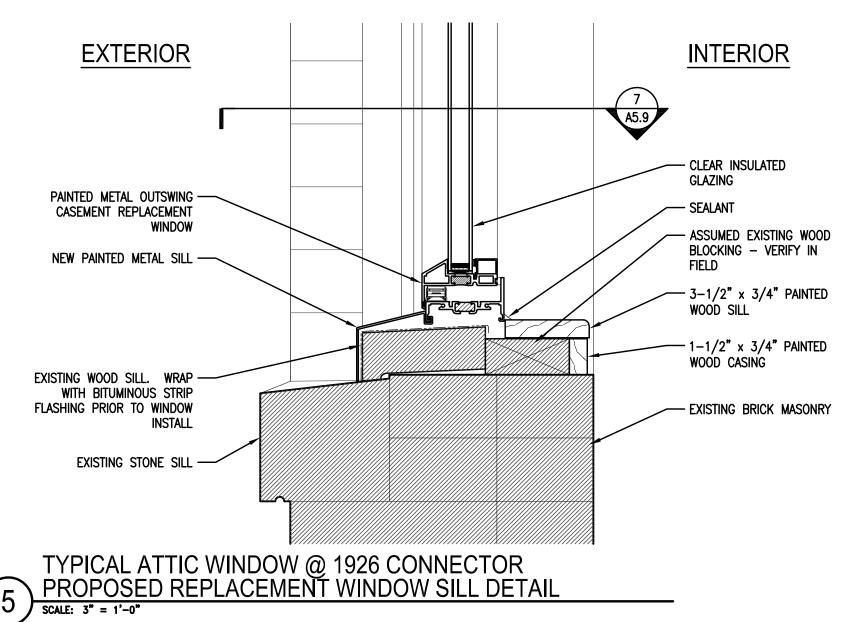

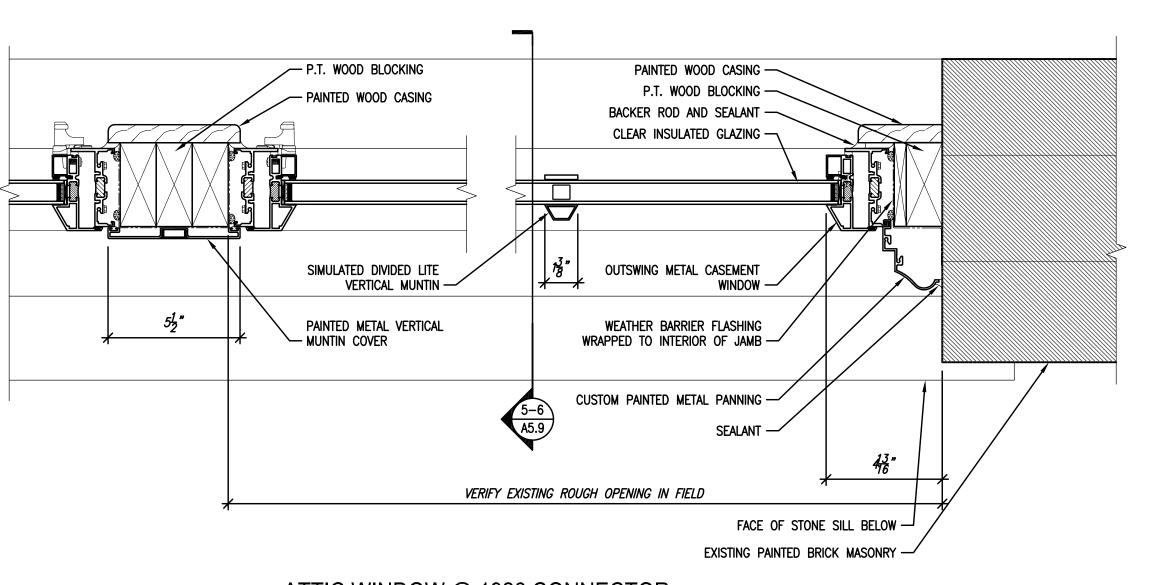

ATTIC WINDOW @ 1926 CONNECTOR
PROPOSED REPLACEMENT WINDOW JAMB DETAILS

SCALE: 3" = 1'-0"

SOUTH ATTIC WINDOWS AT 1926 CONNECTOR PROPOSED REPLACEMENT WINDOW ELEVATION

SCALE: 3/4" = 1'-0"

6407-B

6407-A

- PAINTED METAL

A5.9

6408-B

DOWNSPOUT

5 A5.9

— PAINTED METAL MULLION COVER

6408-A

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	DOOR FRAME											HDWE	REQUIRED	
DOOR No.		SIZE		TYPE	FINISH	GLASS/	TYPE	WIDTH	FINISH	DE	TAIL	SET	ASSEMBLY	DOOR SCHEDULE NOTES
	WIDTH	HEIGHT	THICKNESS	l ''' <u>-</u>	1 1111011	LOUVER	· · · · <u>-</u>	WIBIII	I IIVIOI I	HEAD	JAMB		RATING	
100.1	EXISTING	EXISTING	EXISTING	D-9		YES	EXISTING	EXISTING					1	1, 3
100.2	3'-0"	7'-0"	1-3/4"	D-1			F-1						20 MIN.	
101.1	3'-0"	7'-0"	1-3/4"	D-1			F-1				ļ		20 MIN.	
101A.1	3'-0"	7'-0"	1-3/4"	D-1			F-1						20 MIN.	
102.1	3'-0"	7'-0"	1-3/4"	D-1			F-1						20 MIN.	
102A.1	3'-0"	7'-0"	1-3/4"	D-1			F-1						20 MIN.	
103.1	EXISTING	EXISTING	EXISTING	D-9		YES	EXISTING	EXISTING						1, 3
103.2	3'-0"	7'-0"	1-3/4"	D-1			F-1						20 MIN.	
104.1	EXISTING	EXISTING	EXISTING	D-9		YES	EXISTING	EXISTING						1, 3
104A.1	EXISTING	EXISTING	EXISTING	D-10		YES	EXISTING	EXISTING						2
104B.1	EXISTING	EXISTING	EXISTING	D-10		YES	EXISTING	EXISTING				+		2
104.2	3'-0"	7'-0"	1-3/4"	D-1			F-1	-					20 MIN.	
105.1	EXISTING	EXISTING	EXISTING	D-9		YES	EXISTING	EXISTING				 		1, 3
105A.1	EXISTING	EXISTING	EXISTING	D-10	1	YES	EXISTING	EXISTING				1		2
105B.1	EXISTING	EXISTING	EXISTING	D-10		YES	EXISTING	EXISTING						2
105.2	3'-0"	7'-0"	1-3/4"	D-1			F-1				ļ		20 MIN.	
106.1	EXISTING	EXISTING	EXISTING	D-9		YES	EXISTING	EXISTING						1, 3
106A.1	EXISTING	EXISTING	EXISTING	D-10		YES	EXISTING	EXISTING					20 MIN.	2
106B.1	EXISTING	EXISTING	EXISTING	D-10		YES	EXISTING	EXISTING					20 MIN.	2
106.2	3'-0"	7'-0"	1-3/4"	D-1			F-1						20 MIN.	
107.1	EXISTING	EXISTING	EXISTING	D-9		YES	EXISTING	EXISTING						1, 3
107A.1	EXISTING	EXISTING	EXISTING	D-10		YES	EXISTING	EXISTING					 	2
107B.1	EXISTING	EXISTING	EXISTING	D-10		YES	EXISTING	EXISTING					+	2
107.2	3'-0"	7'-0"	1-3/4"	D-1			F-1						20 MIN.	
108.1	EXISTING	EXISTING	EXISTING	D-9		YES	EXISTING	EXISTING					 	1, 3
108A.1	EXISTING	EXISTING	EXISTING	D-10		YES	EXISTING	EXISTING						2
108B.1	EXISTING	EXISTING	EXISTING 1-3/4"	D-10 D-1	1	YES	EXISTING F-1	EXISTING				1	20 MIN. 20 MIN.	2
108.2	3'-0" EXISTING	7'-0" EXISTING	EXISTING	D-1 D-9		YES	EXISTING	EXISTING						1, 3
109.1	EXISTING	EXISTING	EXISTING	D-9 D-10		YES	EXISTING	EXISTING				+	 	2
109.2	3'-0"	7'-0"	1-3/4"	D-10			F-1	LAISTING					20 MIN.	2
				 	<u> </u>	-	-				 			
110.1	3'-0"	7'-0"	1-3/4"	D-1			F-1						20 MIN.	
110A.1	EXISTING	EXISTING	EXISTING	D-10		YES	EXISTING	EXISTING						2
110B.1	EXISTING	EXISTING	EXISTING	D-10		YES	EXISTING	EXISTING					20 MIN.	2
111.1	EXISTING	EXISTING	EXISTING	D-9		YES	EXISTING	EXISTING						1, 3
111A.1	EXISTING	EXISTING	EXISTING	D-10		YES	EXISTING	EXISTING					20 MIN.	2
111.2	3'-0"	7'-0"	1-3/4"	D-1			F-1						20 MIN.	
114.1	3'-0"	7'-0"	1-3/4"	D-2		YES	F-5							
114.2	(2) 3'-0"	7'-0"	1-3/4"	D-3		YES	F-3							
116.1	3'-0"	7'-0"	1-3/4"	D-1			F-1						20 MIN.	
117.1	3'-0"	7'-0"	1-3/4"	D-1			F-1						20 MIN.	
A100.1	3'-0"	7'-0"	1-3/4"	D-1			F-1						20 MIN.	
A100A.1	3'-0"	7'-0"	1-3/4"	D-1			F-1						20 MIN.	
A101.1	3'-0"	7'-0"	1-3/4"	D-1			F-1						20 MIN.	
A101.2	3'-0"	7'-0"	1-3/4"	D-7		YES	F-8						20 MIN.	
A101.3	3'-0"	7'-0"	1-3/4"	D-7		YES	F-8						20 MIN.	
A102.1	3'-0"	7'-0"	1-3/4"	D-1			F-1						20 MIN.	
A102A.1	3'-0"	7'-0"	1-3/4"	D-1			F-1						20 MIN.	
A103.1	3'-0"	7'-0"	1-3/4"	D-1			F-1						20 MIN.	
A103A.1	3'-0"	7'-0"	1-3/4"	D-1			F-1						20 MIN.	
A104.1	3'-0"	7'-0"	1-3/4"	D-1			F-1						20 MIN.	
A104A.1	3'-0"	7'-0"	1-3/4"	D-1			F-1						20 MIN.	
	i	i	1	•	1	i	i	1	. 		i	1	1	

	1		1					1	1		
A105.1	3'-0"	7'-0"	1-3/4"	D-1		F-1				20 MIN.	
A106.1	3'-0"	7'-0"	1-3/4"	D-1		F-1					
A107.1	(2) 3'-0"	7'-0"	1-3/4"	D-8	YES	F-9					
A107.2	(2) 3'-0"	7'-0"	1-3/4"	D-3	YES	F-3					
A108.1	(2) 3'-0"	7'-0"	1-3/4"	D-6	YES	F-6					
108A.1	3'-0"	7'-0"	1-3/4"	D-1		F-1				20 MIN.	
A109.1	(2) 3'-0"	7'-0"	1-3/4"	D-6	YES	F-7					

DOOR			DOOR						FR	AME		HDWE	REQUIRED	
DOOR No.		SIZE		TVDE	FINISH	GLASS/	TYPE	MIDTH	FINISH	DE.	TAIL	HDWE SET	ASSEMBLY	
	WIDTH	HEIGHT	THICKNESS		FINISH	LOUVER			FINISH	HEAD	JAMB	1	RATING	
ST-1.1	3'-0"	7'-0"	1-3/4"	D-3		YES	F-2							
ST-1.2	(2) 3'-0"	7'-0"	1-3/4"	D-3		YES	F-3							
ST-1.3	(2) V.I.F.	7'-0"	1-3/4"	D-5		YES	F-6							
ST-1.4	(2) V.I.F.	7'-0"	1-3/4"	D-5		YES	F-6							
ST-1.5	(2) 3'-0"	7'-0"	1-3/4"	D-3		YES	F-3							
ST-3.1	3'-0"	7'-0"	1-3/4"	D-3		YES	F-2							
ST-3.2	(2) 3'-0"	7'-0"	1-3/4"	D-3		YES	F-3							
ST-3.3	(2) V.I.F.	7'-0"	1-3/4"	D-5		YES	F-6							
ST-3.4	(2) V.I.F.	7'-0"	1-3/4"	D-5		YES	F-6							
ST-3.5	(2) 3'-0"	7'-0"	1-3/4"	D-3		YES	F-3							
ST-4.1	(2) 3'-0"	7'-0"	1-3/4"	D-3		YES	F-3							
ST-7.1	3'-0"	7'-0"	1-3/4"	D-3		YES	F-3							
ST-7.2	(2) 3'-0"	7'-0"	1-3/4"	D-3		YES	F-3							
ST-7.3	EXISTING	EXISTING	EXISTING	EXISTING	EXISTING		EXISTING	EXISTING	EXISTING					
ST-7.4	EXISTING	EXISTING	EXISTING	EXISTING	EXISTING		EXISTING	EXISTING	EXISTING					
ST-7.5	(2) 3'-0"	7'-0"	1-3/4"	D-3		YES	F-3							
ST-8.1	EXISTING	EXISTING	EXISTING	EXISTING	EXISTING		EXISTING	EXISTING	EXISTING					
ST-8.2	EXISTING	EXISTING	EXISTING	EXISTING	EXISTING		EXISTING	EXISTING	EXISTING					
ST-8.3	V.I.F.	7'-0"	1-3/4"	D-5		YES	F-10							
ST-8.4	(2) V.I.F.	7'-0"	1-3/4"	D-5		YES	F-6							

DOOD			DOOR						FR	AME			REQUIRED	
DOOR No.		SIZE			FINISH	GLASS/	TVDE	MIDTH	EINIIGH	DE	ΓAIL	HDWE SET	ASSEMBLY	DOOR SCHEDULE NOTES
	WIDTH	HEIGHT	THICKNESS	TIYPE	LINIOU	LOUVER	TYPE	חוטואן	FINISH	HEAD	JAMB	""	RATING	
200.1	EXISTING	EXISTING	EXISTING	D-9		YES	EXISTING	EXISTING						1, 3
200.2	3'-0"	7'-0"	1-3/4"	D-1			F-1						20 MIN.	
201.1	3'-0"	7'-0"	1-3/4"	D-1			F-1						20 MIN.	
201A.1	3'-0"	7'-0"	1-3/4"	D-1			F-1						20 MIN.	
202.1	3'-0"	7'-0"	1-3/4"	D-1			F-1						20 MIN.	
202A.1	3'-0"	7'-0"	1-3/4"	D-1			F-1						20 MIN.	
203.1	EXISTING	EXISTING	EXISTING	D-9		YES	EXISTING	EXISTING						1, 3
203.2	3'-0"	7'-0"	1-3/4"	D-1			F-1						20 MIN.	
204.1	EXISTING	EXISTING	EXISTING	D-9		YES	EXISTING	EXISTING						1, 3
204A.1	EXISTING	EXISTING	EXISTING	D-10		YES	EXISTING	EXISTING					20 MIN.	2
204B.1	EXISTING	EXISTING	EXISTING	D-10		YES	EXISTING	EXISTING					20 MIN.	2
204.2	3'-0"	7'-0"	1-3/4"	D-1			F-1		 				20 MIN.	
205.1	EXISTING	EXISTING	EXISTING	D-9		YES	EXISTING	EXISTING						1, 3
205A.1	EXISTING	EXISTING	EXISTING	D-10		YES	EXISTING	EXISTING					20 MIN.	2
205B.1	EXISTING	EXISTING	EXISTING	D-10		YES	EXISTING	EXISTING					20 MIN.	2
205.2	3'-0"	7'-0"	1-3/4"	D-1			F-1						20 MIN.	
206.1	EXISTING	EXISTING	EXISTING	D-9		YES	EXISTING	EXISTING						1, 3
206A.1	EXISTING	EXISTING	EXISTING	D-10		YES	EXISTING	EXISTING					20 MIN.	2
206B.1	EXISTING	EXISTING	EXISTING	D-10		YES	EXISTING							2
206.2	3'-0"	7'-0"	1-3/4"	D-1			F-1						20 MIN.	
207.1	EXISTING	EXISTING	EXISTING	D-9		YES	EXISTING	EXISTING						1, 3
207A.1	EXISTING	EXISTING	EXISTING	D-10		YES	EXISTING	EXISTING					20 MIN.	2
207.2	3'-0"	7'-0"	1-3/4"	D-1			F-1						20 MIN.	
208.1	EXISTING	EXISTING	EXISTING	D-9		YES	EXISTING	EXISTING						1, 3
208A.1	EXISTING	EXISTING	EXISTING	D-10		YES	EXISTING	EXISTING					20 MIN.	2
208B.1	EXISTING	EXISTING	EXISTING	D-10		YES	EXISTING	EXISTING					20 MIN.	2
208.2	3'-0"	7'-0"	1-3/4"	D-1			F-1						20 MIN.	
209.1	EXISTING	EXISTING	EXISTING	D-9		YES	EXISTING	EXISTING						1, 3
209A.1	EXISTING	EXISTING	EXISTING	D-10		YES	EXISTING	EXISTING	<u> </u>				20 MIN.	2
209.2	3'-0"	7'-0"	1-3/4"	D-1			F-1						20 MIN.	
211A.1	3'-0"	7'-0"	1-3/4"	D-1			F-1						20 MIN.	
211A.2	3'-0"	7'-0"	1-3/4"	D-1			F-1						20 MIN.	
211B.1	3'-0"	7'-0"	1-3/4"	D-1			F-1						20 MIN.	
211B.2	3'-0"	7'-0"	1-3/4"	D-1			F-1						20 MIN.	
211C.1	3'-0"	7'-0"	1-3/4"	D-1			F-2							
	3'-0"		1-3/4"											
211D.1		7'-0"	•	D-1			F-2							
216.1	(2) 3'-0"	7'-0"	1-3/4"	D-4		YES	F-3							
216A.1	3'-0"	7'-0"	1-3/4"	D-2			F-2							
218.1	3'-0"	7'-0"	1-3/4"	D-1			F-1						20 MIN.	
219.1	3'-0"	7'-0"	1-3/4"	D-1			F-1			-			20 MIN.	

Date: 11/17/2020 Drawn By: ECR

Project No.: 10031.06

Sheet No.





DOOR HARDWARE

HARDWARE SET #1 (DOUBLE DOOR ENTRY) ENTRANCE / OFFICE LOCKSET BUTTS (3) PAIR DUMMY TRIM (INACTIVE LEAF) FLUSH BOLTS (1) PAIR CLOSER (ACTIVÈ LEAF ONLY) WALL STOPS (2) ASTRAGAL

HARDWARE SET #2 (INTERIOR LOCKED DOOR) ENTRANCE / OFFICE LOCKSET BUTTS 1-1/2 PAIR WALL STOP

<u>HARDWARE SET #3</u> (DOUBLE DOOR CLOSETS)
DUMMY TRIM ROLLER CATCHES (2)

HARDWARE SET #4 (RESTROOM)
PRIVACY LOCK BUTTS 1-1/2 PAIR

WALL STOP

WALL STOP

<u>HARDWARE SET #5</u> (PASSAGE SET) PASSAGE SET BUTTS 1-1/2 PAIR

<u>HARDWARE SET #6</u> (CORRIDOR) STOREROOM LOCKSET BUTTS 1-1/2 PAIR CLOSER WALL STOP

DOOR SCHEDULE NOTES

- 1. HISTORIC DOOR TO BE PINNED OPEN SEE DETAIL
- 2. REPLACE GLAZING IN EXISTING DOOR WITH SOLID PANEL 3. REPLACE GLAZING IN EXISTING DOOR WITH NEW GLAZING
 - ALL DOOR HARDWARE TO BE <INSERT> FINISH.

UNLESS NOTED OTHERWISE.

- ALL CLOSERS TO BE LCN OR EQUAL (SILVER COLOR) - ALL HINGES AT DOORS WITH CLOSERS TO BE HAGER BB1279 4-1/2 X 4-1/2 AT INTERIOR. ALL OTHER


GENERAL DOOR NOTES

- HINGES TO BE HAGER 1279 OR EQUAL. - ALL DOOR INSTALLATIONS AND DOOR HARDWARE MUST
- CONFORM WITH AMERICAN NATIONAL STANDARD ICC/ANSI A117.1-2003.
- AT DOUBLE ENTRY DOORS, LEFT HAND REVERSE LEAF TO RECEIVE FLUSH BOLTS.
- CONTRACTOR SHALL SUPPLY LOCK CYLINDERS TO LANDLORD FOR KEYING TO MASTER SYSTEM. CONTRACTOR SHALL SUPPLY CYLINDERS.


MANUFACTURER:

BUTTS: HAGER OR EQUAL - ALL CYLINDRICAL DOOR HARDWARE TO BE <INSERT MANUF> LOCK SETS: SCHLAGE D-SERIES <INSERT>-SERIES, <INSERT> LEVERSET, FINISH <INSERT>. WALL STOPS: IVES OR EQUAL FLUSH BOLTS: IVES OR EQUAL ACOUSTIC SEAL: PEMKO AUTOMATIC ACOUSTIC DOOR BOTTOM: PEMKO CLOSER: LCN

DOOR TYPES

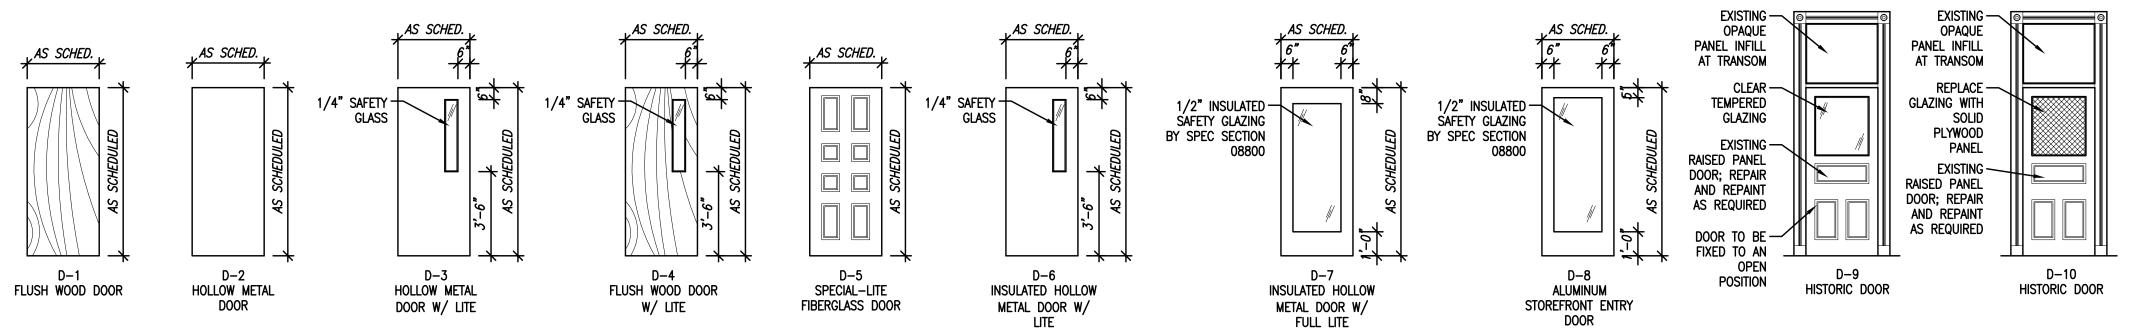

FRAME TYPES

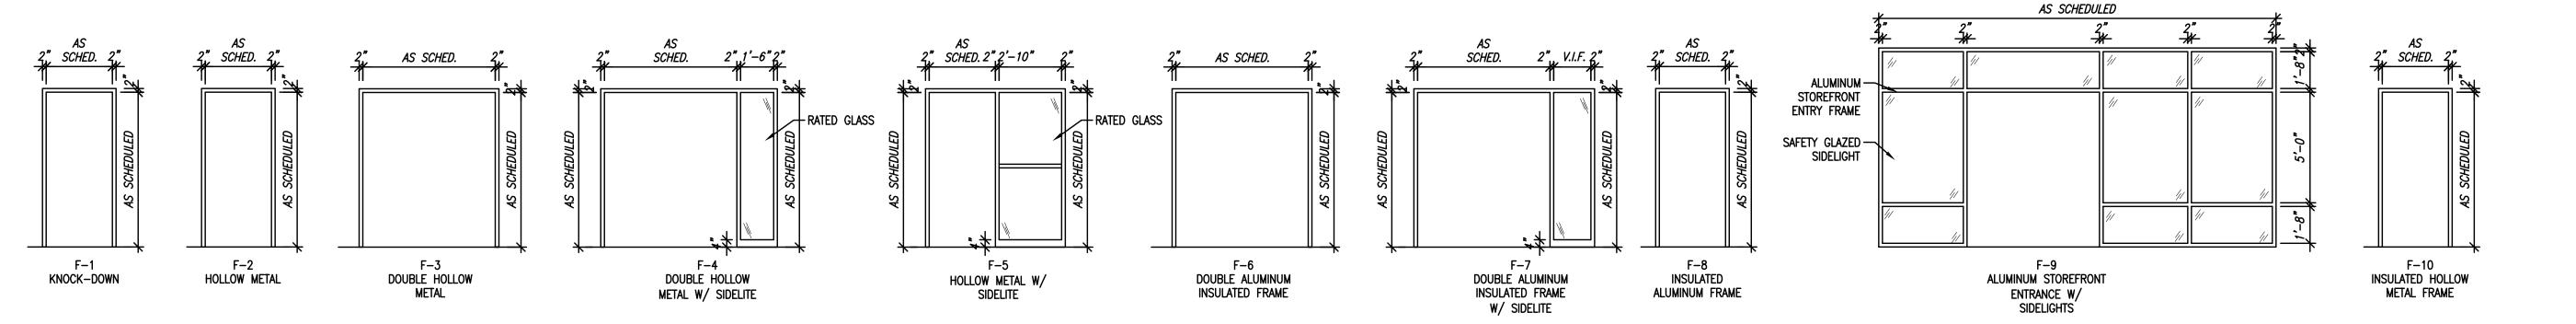

PRELIMINARY NOT FOR CONSTRUCTION QUORUM ARCHITECTS, INC.

RENOVATION SCHOOL MCKINLEY

Revisions:

Sheet Name: DOOR SCHEDULE

Date: 11/17/2020 Drawn By: ECR Project No.: 10031.06

Sheet No.

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