PATTEE GROUP - TENANT IMPROVEMENT729 W. HISTORIC MITCHELL STREETMILWAUKEE, WISCONSIN 5320416 JULY, 2020

PERMIT DOCUMENTS

SHEET INDEX

ARCHITECTURAL DRAWINGS

G000 TITLE SHEET WITH CODE + LIFE SAFETY PLANS

A100 FIRST + SECOND FLOOR DEMO + FLOOR PLANS

A200 ENLARGED STOREFRONT PLAN AND ELEVATIONA300 ENLARGED STAIR PLAN, SECTIONS AND ELEVATIONS

A400 INTERIOR ELEVATIONS + DOORS + SCHEDULES

STRUCTURAL DRAWINGS

S100 STRUCTURAL FRAMING PLANS

S500 STRUCTURAL FRAMING DETAILS


GENERAL NOTES

- A. CONTRACTORS DO NOT SCALE DRAWINGS.
 B. ALL WORK SHALL BE IN ACCORDANCE WITH APPLICABLE BUILDING CODES AND COMPLY WITH ALL ORDINANCES AND REGULATION OF THE CITY, COUNTY, STATE AND FEDERAL JURISDICTION.
- C. IMMEDIATELY REPORT TO ARCHITECT ANY DISCREPANCIES BETWEEN EXISTING CONDITIONS AND THOSE INDICATED ON THE PERMIT DOCUMENTS.D. DIMENSIONS ON FLOOR PLAN ARE BASED ON FACE OF FINISHED WALL TO FACE
- OF FINISHED WALL (NOMINAL).
 E. VERIFY ALL DIMENSIONS AND CONDITIONS AT JOB SITE. PORTIONS OF EXISTING CONSTRUCTION MAY HAVE BEEN REMOVED BY OWNER.
 F. VERIFY ALL ROUGH-IN DIMENSIONS FOR BUILT IN EQUIPMENT PRIOR TO
- PERFORMING WORK.
 G. CONTRACTOR IS RESPONSIBLE FOR ALL NECESSARY CUTTING, FITTING OR PATCHING NECESSARY.
- H. CONSTRUCT A DUST PROOF PARTITION TO SEPARATE AREAS OF CONSTRUCTION FROM ADJACENT OCCUPIED AREAS OUTSIDE SCOPE OF CONSTRUCTION.
- H. MAINTAIN CONTINUOUS UTILITY SERVICE TO ALL SPACES IN THE BUILDING NOT AFFECTED BY THIS WORK. COORDINATE WITH OWNER ANY DISRUPTION IN SERVICES REQUIRED TO PERFORM WORK OR TO MODIFY EXISTING PIPING, DUCTWORK OR ANY ASSOCIATED EQUIPMENT.

SITE LOCATION MAP





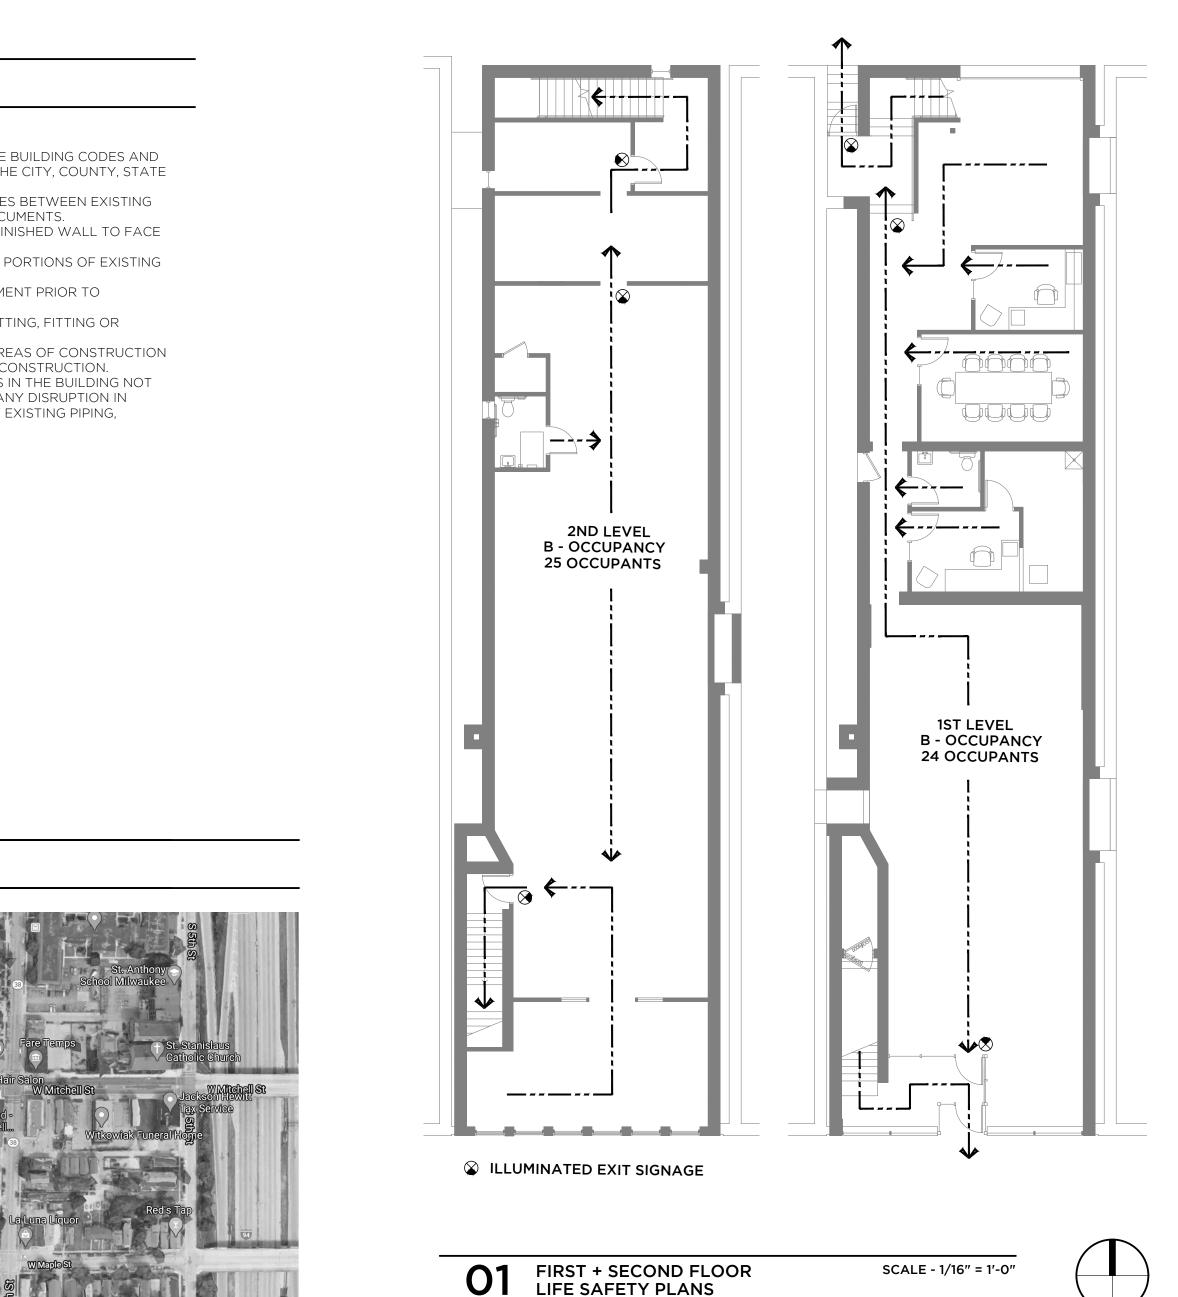



219 N. MILWAUKEE STREET SUITE 630 MILWAUKEE, WISCONSIN 53202 T (414) 539-3336



305 N PLANKINGTON AVENUE SUITE 101 MILWAUKEE, WI 53202 T (414) 278-9200



219 N MILWAUKEE ST SUITE 630 MILWAUKEE WISCONSIN 53202

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BUILDING CODE INFORMATION

APPLICABLE CODES WISCONSIN COMMERCIAL BUILDING CODE/IBC 2015

INTERNATIONAL EXISTING BUILDING CODE CHAPTER 4 - CLASSIFICATION OF WORK

CHAPTER 3 - USE AND OCCUPANCY CLASSIFICATION WISCONSIN COMMERCIAL BUILDING CODE OCCUPANCY CLASSIFICATION: NAME AND GROUP

CHAPTER 5 - GENERAL BUILDING HEIGHTS AND AREAS BUILDING HEIGHT FIRST FLOOR AREA SECOND FLOOR AREA

CHAPTER 6 - TYPES OF CONSTRUCTION CONSTRUCTION CLASSIFICATION:

AREA OF REMODEL:

FIRE RESISTANCE RATING FOR BUILDING ELEMENTS (TABLE 601) STRUCTURAL FRAME: EXTERIOR BEARING WALLS: INTERIOR BEARING WALLS: FLOOR CONSTRUCTION: ROOF CONSTRUCTION:

CHAPTER 9 - FIRE PROTECTION SYSTEMS SPRINKLER TYPE: CHAPTER 10 - MEANS OF EGRESS

DESIGN OCCUPANT LOAD (TABLE 1004.1.1): FIRST FLOOR: SECOND FLOOR: TOTAL OCCUPANT LOAD:

MINIMUM STAIR REQUIRED EGRESS WIDTH (SECTION1005.1) 13 OCCUPANTS X .03 INCHES = .39 INCHES

EXIT ACCESS TRAVEL DISTANCE	(SECTION 1017.2):
BUSINESS:	MAXIMUM: 200 FEET
COMMON PATH OF EGRESS TRAVEL	(SECTION 1006.2.1):
BUSINESS:	MAXIMUM: 75 FEET

DEAD END CORRIDOR LIMIT: (SECTION 1020.4):

CORRIDOR FIRE-RESISTANCE RATING: (SECTION 1020.1):

CHAPTER 29 - PLUMBING SYSTEMS NUMBER OF REQUIRED PLUMBING FIXTURES (TABLE 2902.1):

F١	RST	FL	00F

WATERCLOSETS (MALE)	REQUIRED: 1
WATERCLOSETS (FEMALE)	REQUIRED: 1
LAVATORIES	REQUIRED: 1
SERVICE SINKS	REQUIRED: 1
SECOND FLOOR:	
WATERCLOSETS (MALE)	REQUIRED: 1
WATERCLOSETS (FEMALE)	REQUIRED: 1
LAVATORIES	REQUIRED: 1

EXISTING USE BUSINESS GROUP "B"

LEVEL 2 ALTERATION

2 STORIES 2,868 SF 2,654 SF 1,862 SQ FT

TYPE VB 0 HOURS 0 HOURS 0 HOURS 0 HOURS 0 HOURS

NON-SPRINKLED

24 OCCUPANTS 25 OCCUPANTS 49 OCCUPANTS

PROVIDED: 48 INCHES

PROVIDED: 140 FEET

PROVIDED: 30 FEET

20 FEET 1 HOUR

PROVIDED: 1 PROVIDED: 1 PROVIDED: 1

PROVIDED: 1

PROVIDED: 1 PROVIDED: 1 PROVIDED: 1

PROJECT NAME 729 W. MITCHELL ST PATTEE GROUP

729 W HISTORIC MITCHELL ST MILWAUKEE, WI 53204

DRAWING ISSUE HISTORY CD 07-16-2020 PERMITSET

SET TYPE CONTRUCTION SCOPE DOCUMENTS

aa project number 20010

рате 07-16-2020

SHEET TITLE DEMOLITION + FLOOR PLANS





DEMOLITION PLAN GENERAL NOTES

- A. VERIFY ALL DIMENSIONS AND CONDITIONS AT JOB SITE. PORTIONS OF EXISTING CONSTRUCTION MAY HAVE BEEN REMOVED BY OWNER.
- B. COORDINATE DEMOLITION OF LOAD BEARING WALLS, FLOORS AND COLUMNS WITH THE STRUCTURAL PLANS.
- C. VERIFY EXACT COMPOSITION OF EXISTING WALLS TO BE REMOVED.
- D. REMOVE FLOOR FINISHES, INCLUDING SETTING BED IN CERAMIC TILE AREAS, WHERE NEW FLOORING IS INDICATED IN ROOM FINISH SCHEDULE.
- E. REMOVE SUSPENDED CEILINGS AND RELATED HANGERS, OR GYPSUM BOARD/PLASTER CEILINGS WHERE NEW CEILINGS ARE INDICATED ON REFLECTED CEILING PLAN OR ROOM FINISH SCHEDULE.
- F. REMOVE ALL COLUMN FINISHES, INCLUDING GYPSUM BOARD AND FURRINGS, FROM EXISTING STRUCTURAL COLUMNS. G. REMOVE ALL INTERIOR AND WALL MOUNTED ITEMS IN AREAS TO BE REMODELED
- (REFER TO ROOM FINISH SCHEDULE) INCLUDING BUT NOT LIMITED TO, CABINETRY, EQUIPMENT, LOCKERS, TOILET PARTITIONS, SHELVING, HOOKSTRIPS, HANDRAILS, CLOSET POLES, CHALK AND TACK BOARDS, MIRRORS, WALL AND CEILING TRIM, AND BASE.
- H. REFER TO PLUMBING, HVAC AND ELECTRICAL PLANS FOR ADDITIONAL DEMOLITION ITEMS AND NOTES. COORDINATE WORK WITH PLUMBING, HVAC AND ELECTRICAL REQUIREMENTS.
- I. MAINTAIN CONTINUOUS UTILITY SERVICE TO ALL SPACES IN THE BUILDING NOT AFFECTED BY THIS WORK. COORDINATE WITH OWNER ANY DISRUPTION IN SERVICES REQUIRED TO PERFORM WORK OR TO MODIFY EXISTING PIPING. DUCTWORK OR ANY ASSOCIATED EQUIPMENT.
- J. CONSTRUCT A DUST-PROOF PARTITION TO SEPARATE AREAS OF CONSTRUCTION FROM ADJACENT OCCUPIED AREAS OUTSIDE SCOPE OF CONSTRUCTION.

DEMOLITION PLAN KEYED NOTES

- 1. REMOVE EXISTING COLUMN. REFER TO STRUCTURAL DRAWINGS 2. REMOVE EXISTING PORTION OF FLOOR FOR NEW STAIR. REFER OT STRUCTURAL
- DRAWINGS. 3. REMOVE EXISTING PORTION OF STOREFRONT.

FLOOR PLAN GENERAL NOTES

- A. DIMENSIONS ON FLOOR PLAN ARE BASED ON FACE OF FINISHED WALL TO FACE
- OF FINISHED WALL (NOMINAL). B. VERIFY ALL DIMENSIONS AND CONDITIONS AT JOB SITE. PORTIONS OF EXISTING CONSTRUCTION MAY HAVE BEEN REMOVED BY OWNER.
- C. REFER TO SHEET XXX FOR DOOR SCHEDULES, DOOR TYPES, AND NOTES.

FLOOR PLAN **KEYED NOTES**

1. NEW STOREFRONT AT ENTRY 2. NEW MOP / SERVICE SINK

INTERIOR PARTITION TYPE SCHEDULE **GENERAL NOTES**

- A. ALL MASONRY PARTITON SHALL BE 8" CONCRETE BLOCK UNLESS OTHERWISE NOTED ON FLOOR PLANS.
- B. DIMENSIONS OF PARTITIONS ON FLOOR PLAN ARE BASED ON FACE OF FINISHED
- PARTITION TO FACE OF FINISHED PARTITION (NOMINAL). C. PROVIDE TYPE "X" FIRE RATED GYPSUM BOARD AT ALL FIRE RATED GYPSUM
- BOARD PARTITIONS.
- D. PROVIDE UL FIRE RATED CONCRETE BLOCK AT ALL FIRE RATED CONCRETE BLOCK PARTITIONS.
- E. SEAL ALL WALL PENETRATIONS AT PERIMETER AND FIRESTOP ALL FIRE RATED
- PARTITIONS. F. EXTEND ALL GYPSUM BOARD PARTITIONS FULL HEIGHT TO UNDERSIDE OF STEEL DECK ABOVE. AT METAL DECK CONSTRUCTION ABOVE PROVIDE SLIP JOINT BETWEEN TOP OF PARTITION AND UNDERSIDE OF METAL DECK OR STRUCTURAL STEEL MEMBER ABOVE.
- F. EXTEND CONCRETE BLOCK PARTITIONS FULL HEIGHT TO UNDERSIDE OF STEEL DECK ABOVE. PROVIDE HORIZONTAL MASONRY JOINT REINFORCEMENT AT 16" OC VERTICALLY. REFER TO STRUCTURAL DRAWINGS FOR VERTICAL REINFORCEMENT REQUIREMENTS.

ACOUSTICAL WOOD STUD PARTITION

INTERIOR PARTITION TYPE SCHEDULE

 $\langle PRT-1 \rangle$


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CONTRUCTION SCOPE

AA PROJECT NUMBER

PRT-1

- (1) LAYER 5/8" TYPE "X" GYPSUM BOARD • 2x4 OR 2x6 WOOD STUDS AT 16" OC WITH SOUND ATTENUATING BATT INSULATION
- (1) LAYER 5/8" TYPE "X" GYPSUM BOARD



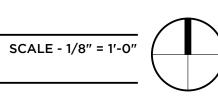

SET TYPE

20010

DATE

07-16-2020

SHEET TITLE

DEMOLITION +

FLOOR PLANS

DOCUMENTS

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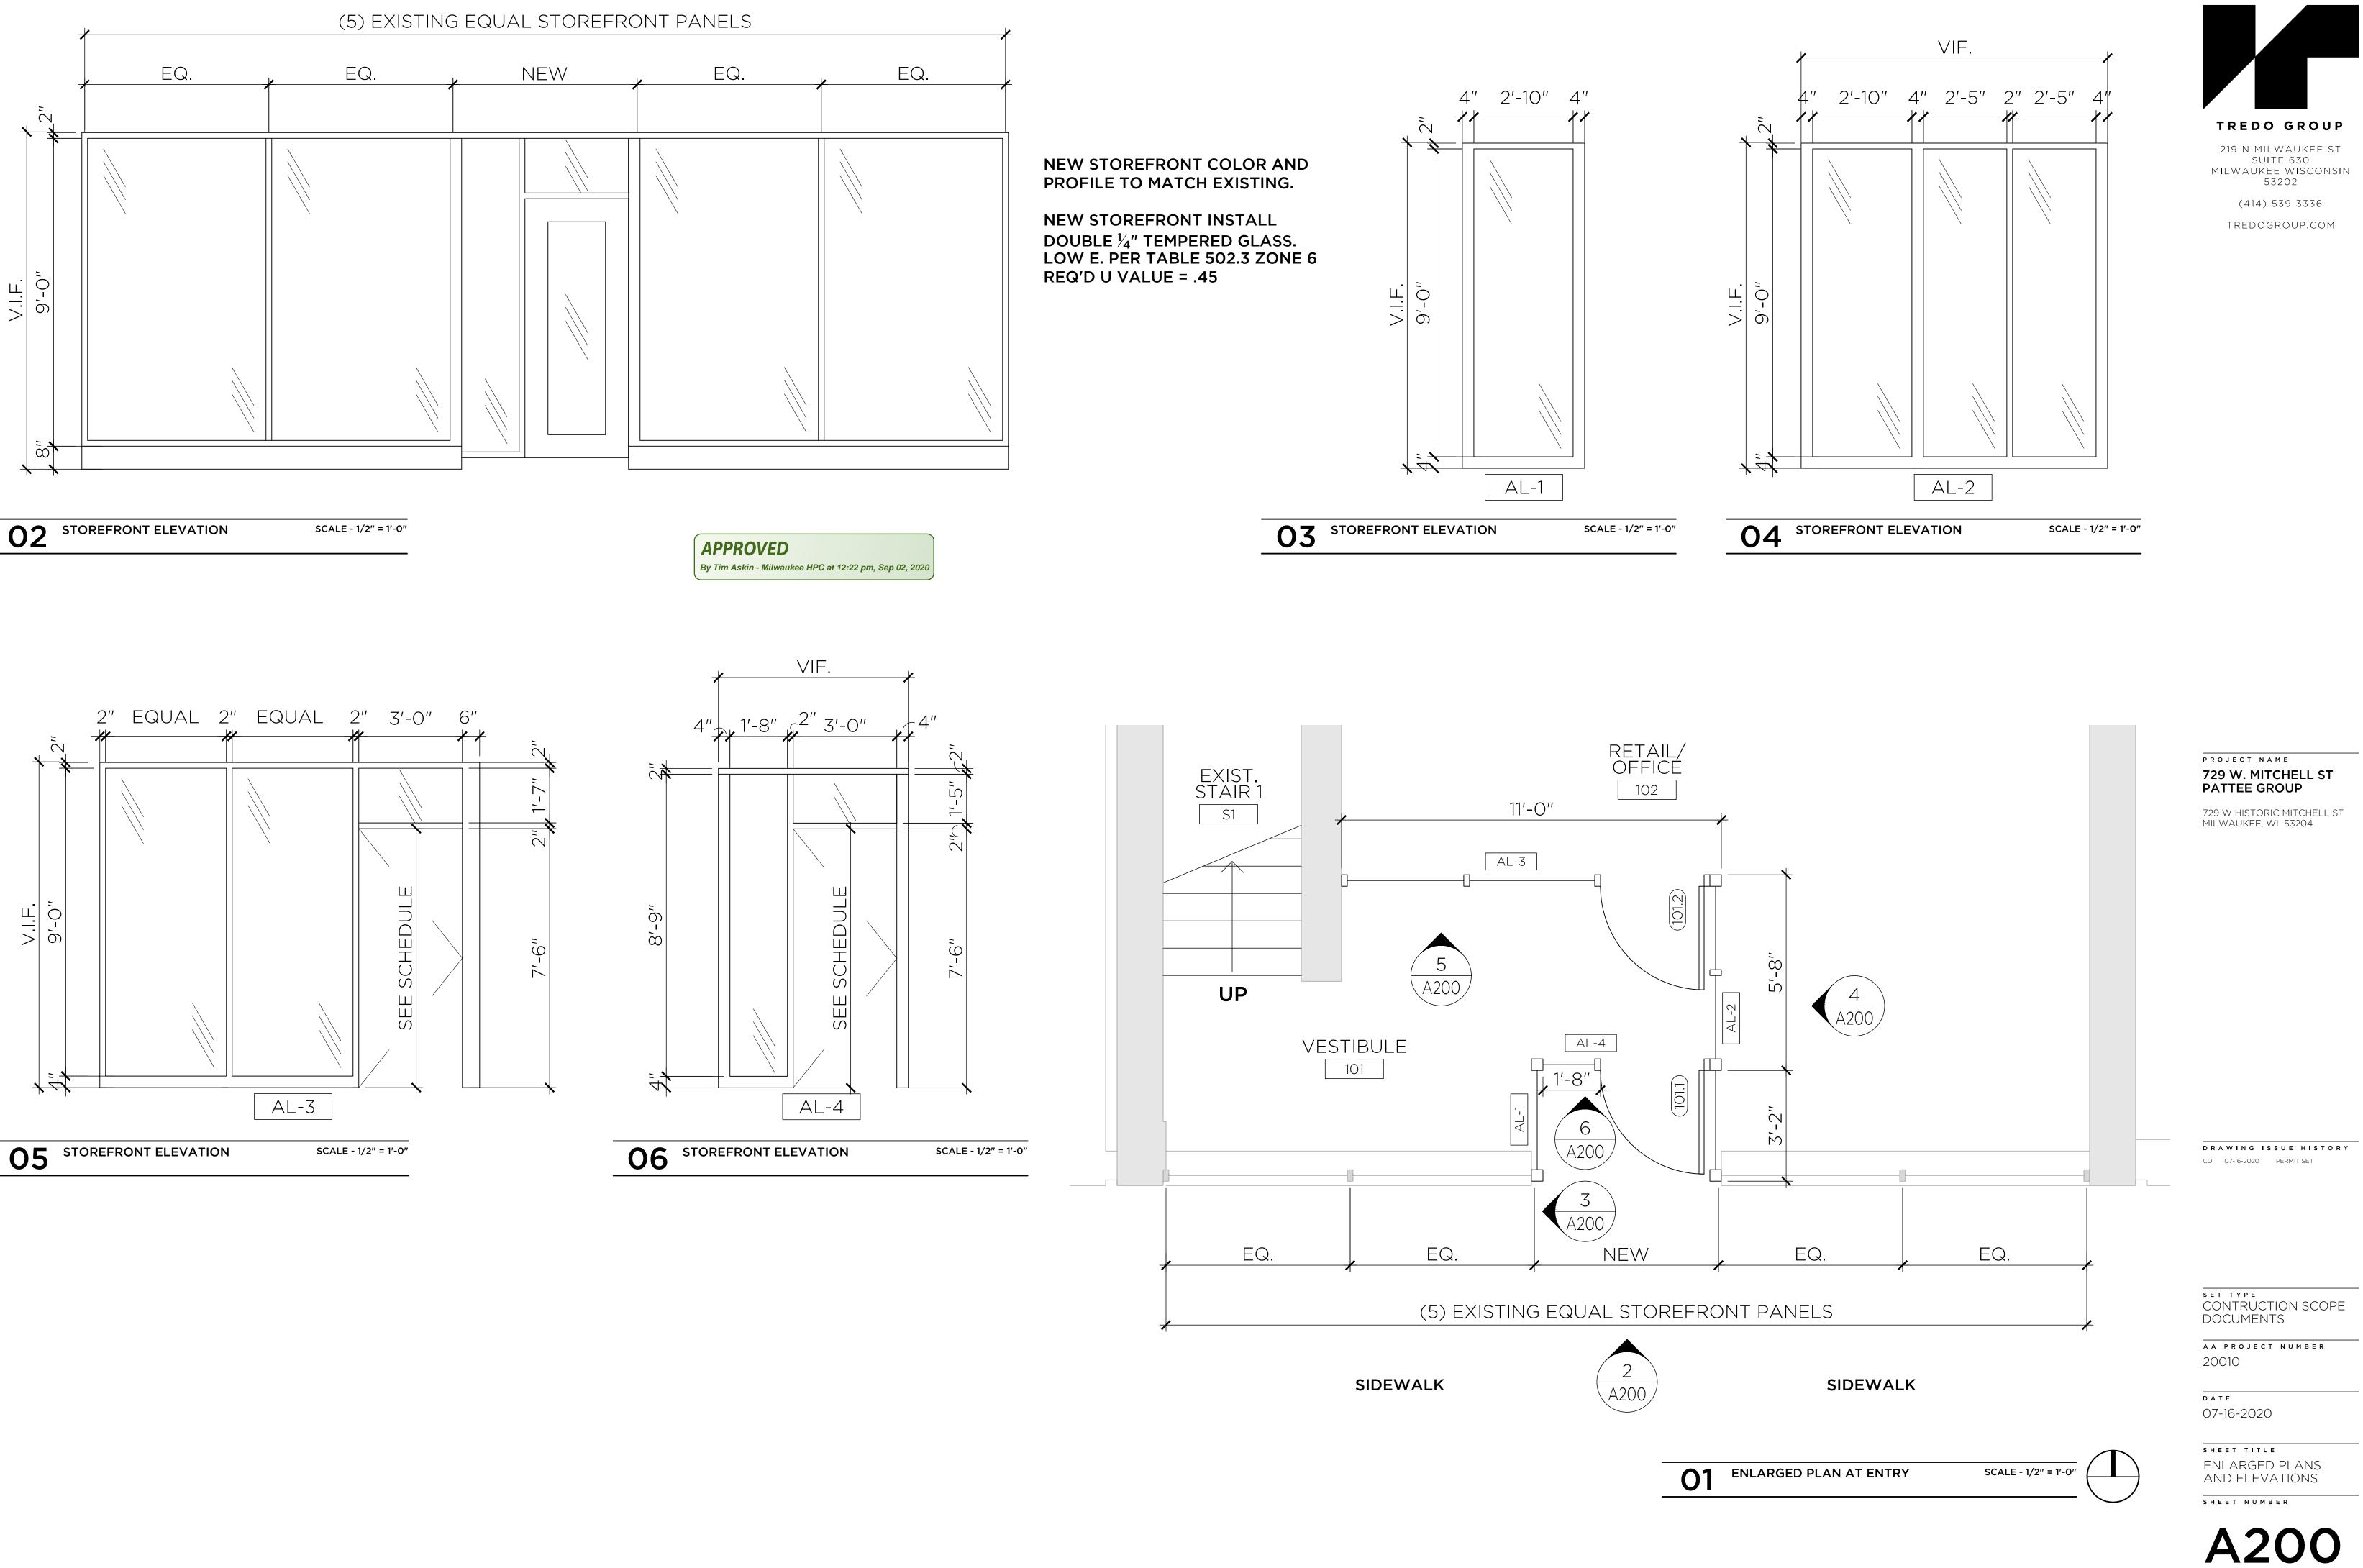
(X)


 $\langle X \rangle$


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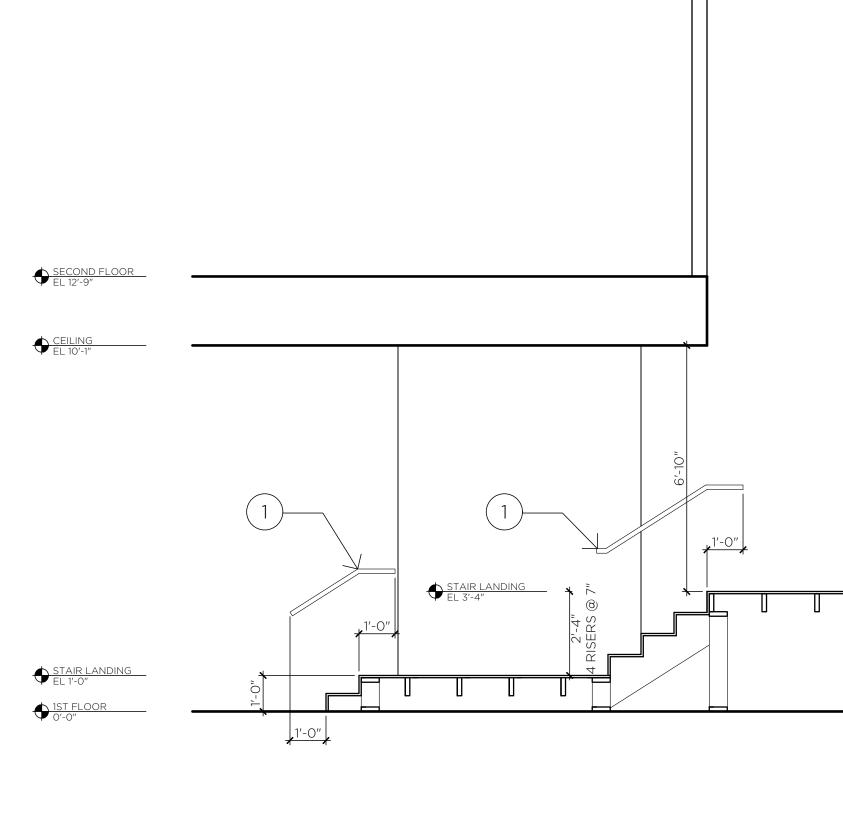
PATTEE GROUP


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03 SECTION AT STAIR

SCALE - 3/8" = 1'-0"

STAIR GENERAL NOTES

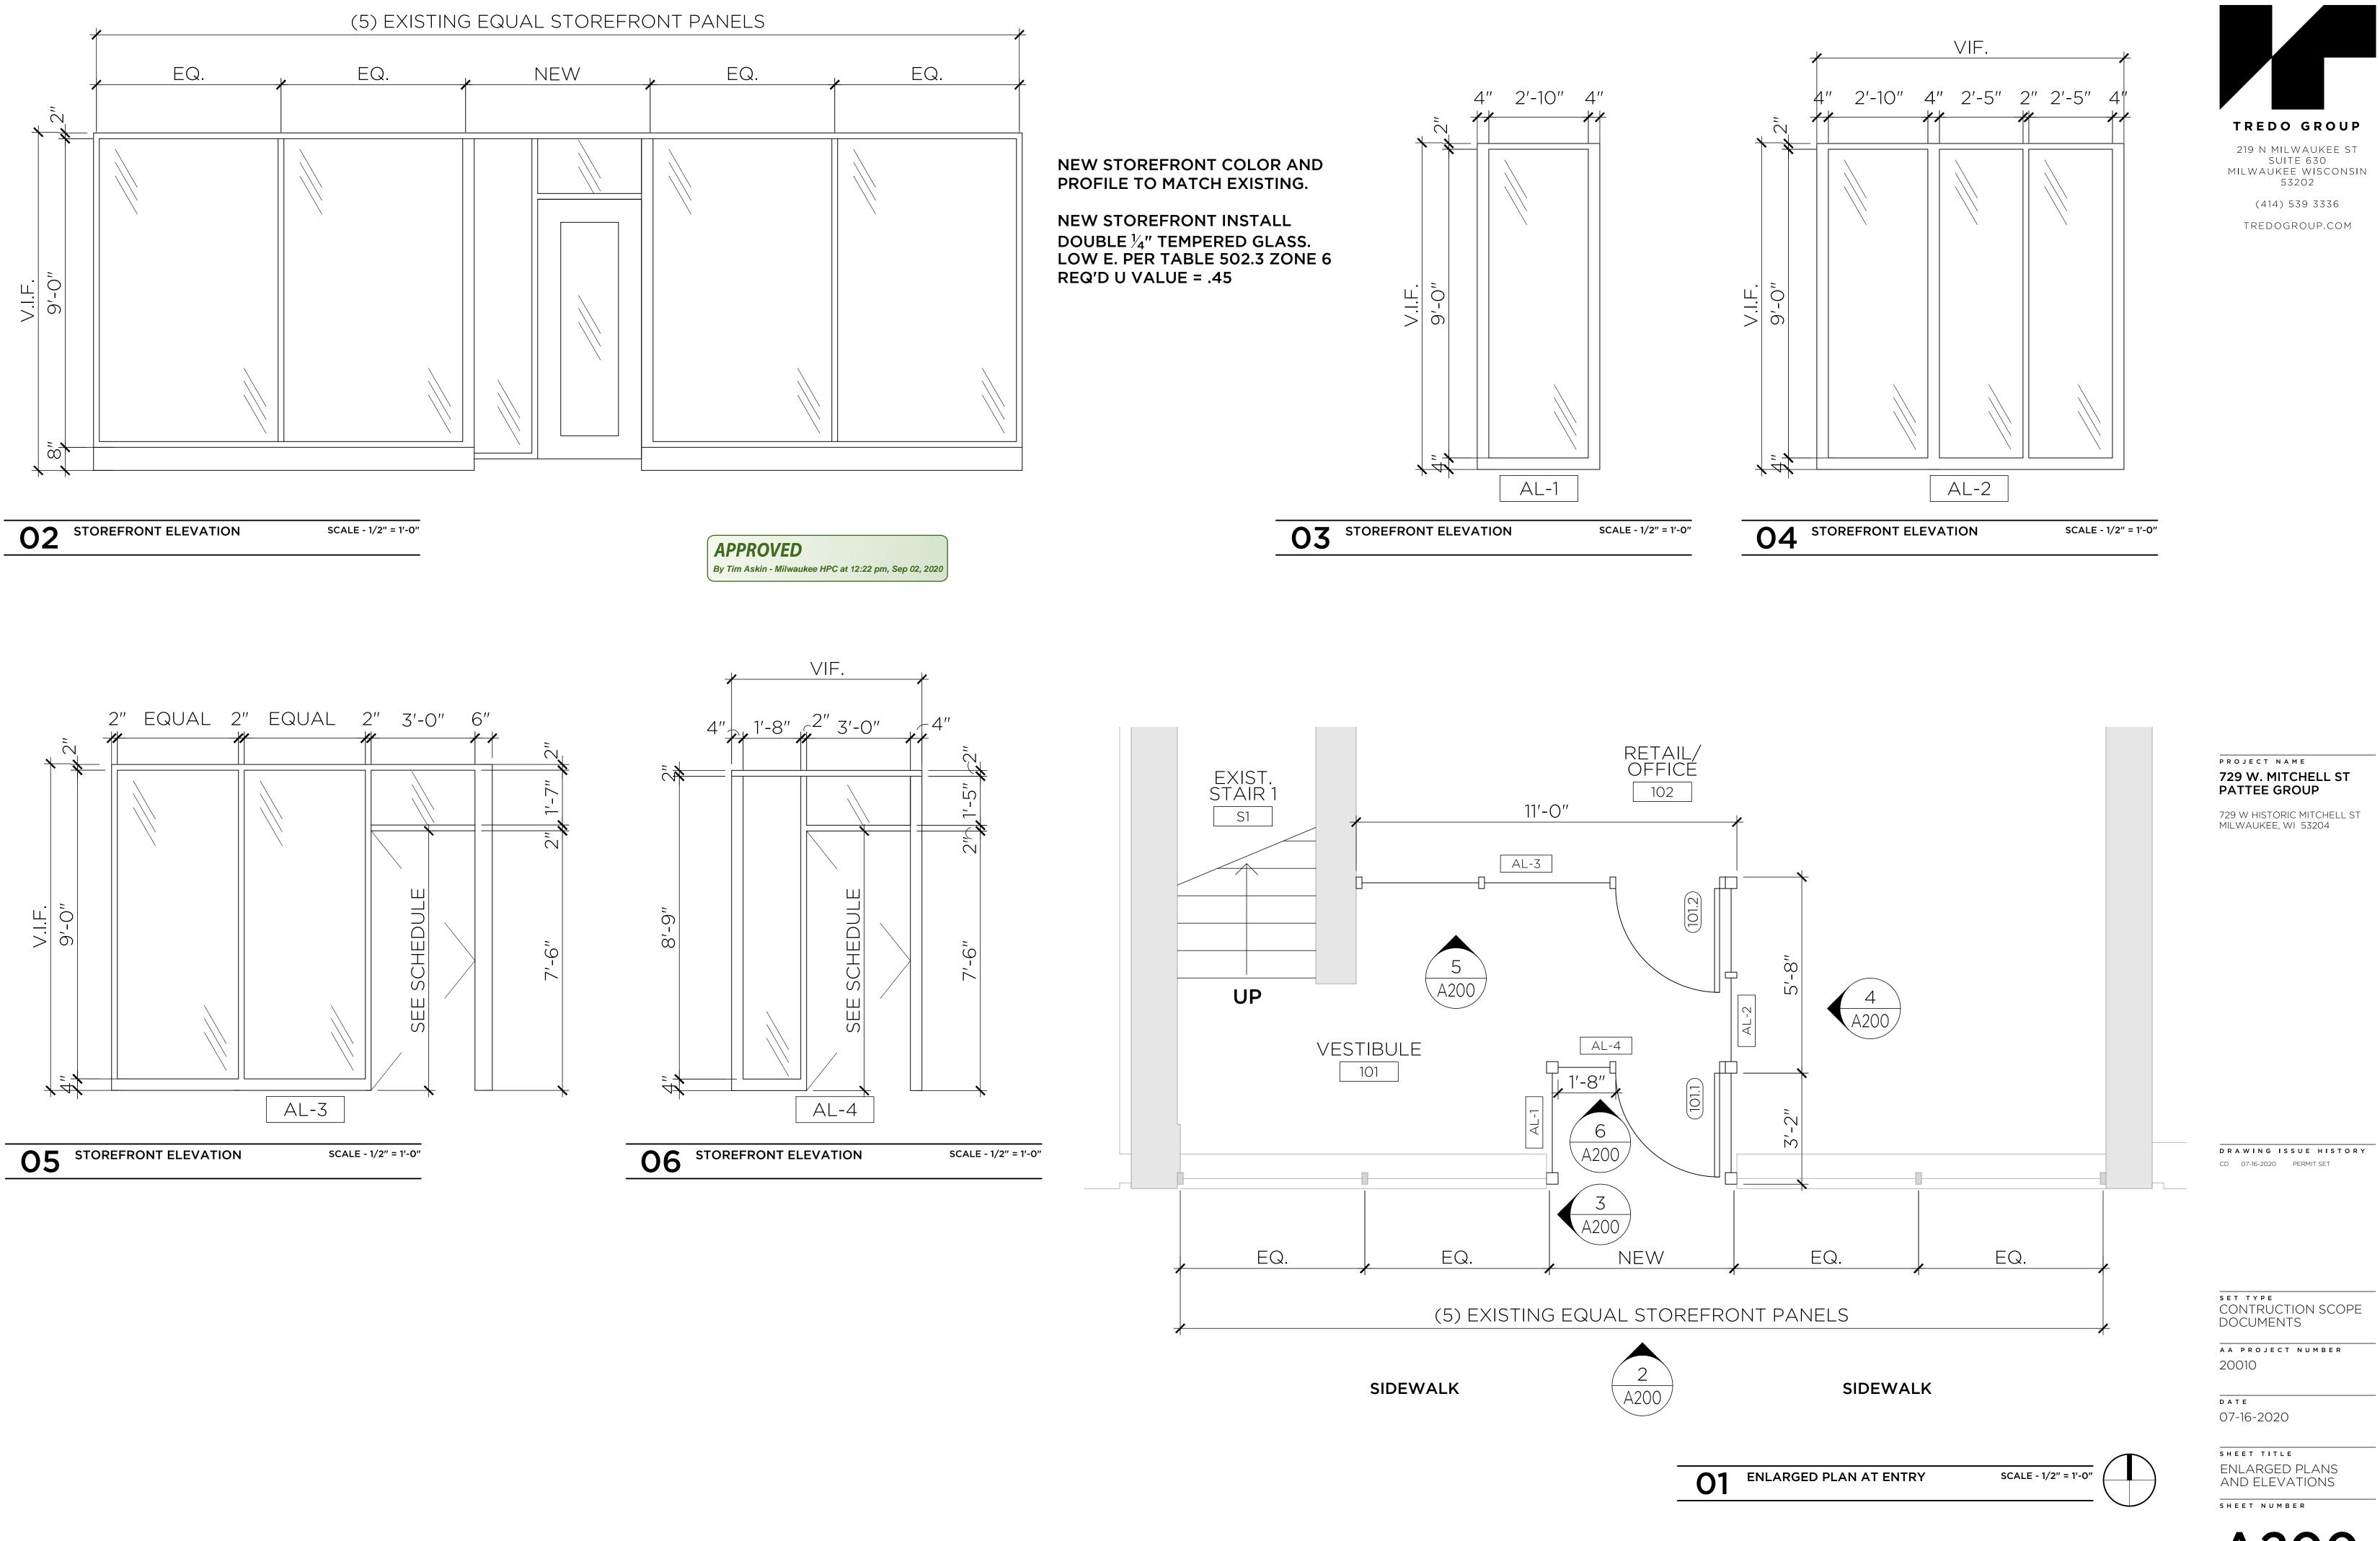A. INSTALL CONTINUOUS BLOCKING ON BOTH SIDES OF THE STAIR ADEQUATE TO ACCOMMODATE HANDRAIL BRACKET LOADS. LOCATE BLOCKING BEHIND AND CENTERED ON HANDRAIL LOCATIONS. B. END OF HANDRAIL MUST RETURN TO WITHIN $\frac{1}{8}$ INCH OF WALL.

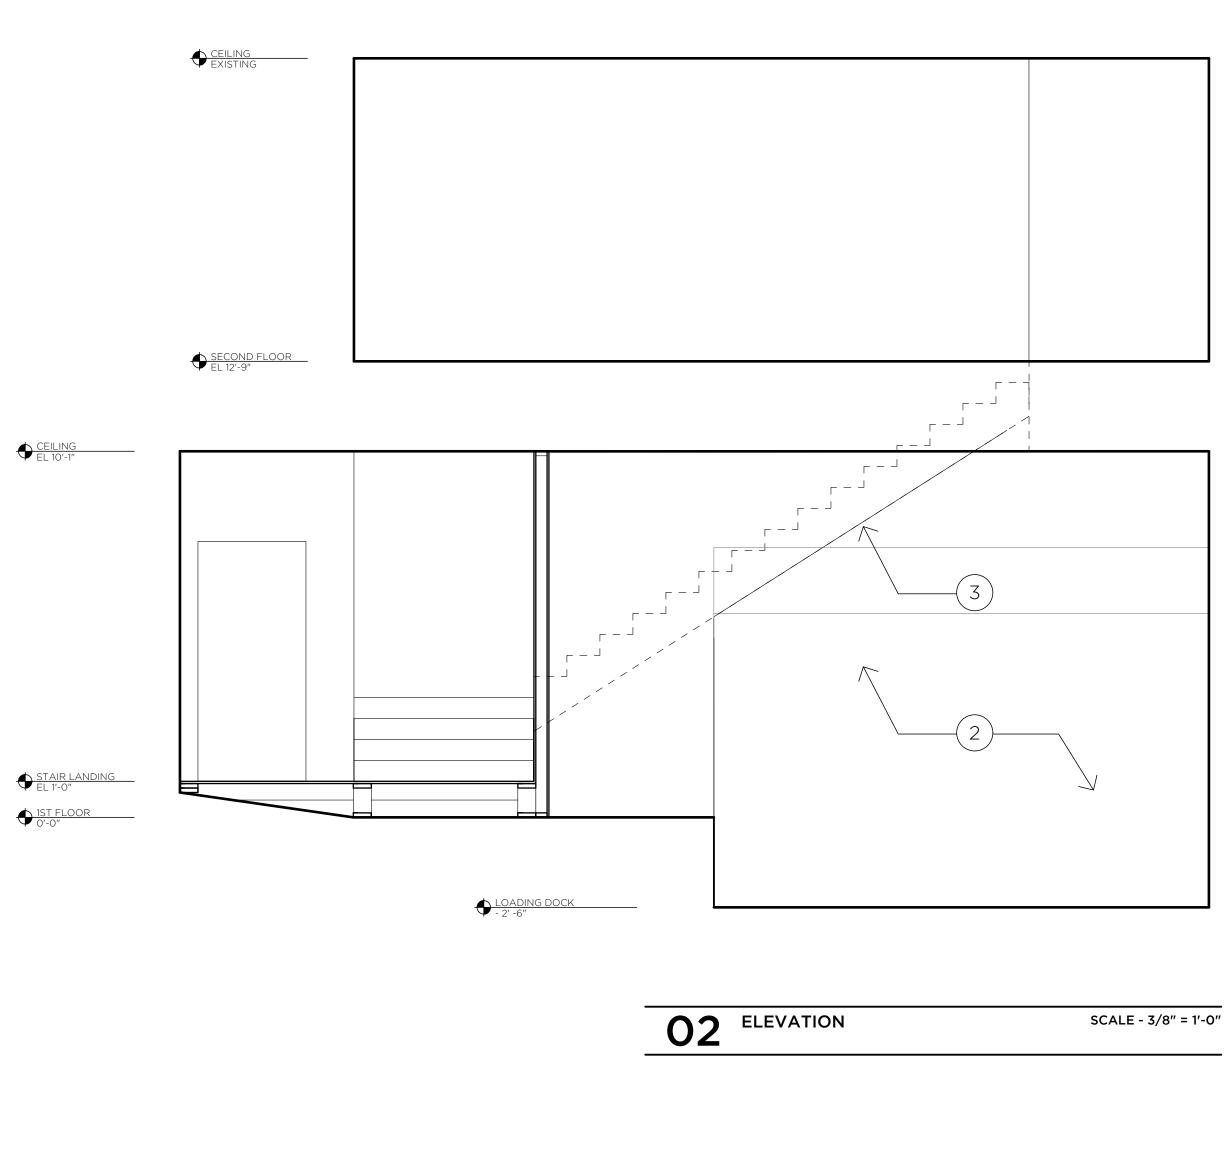KEYNOTES

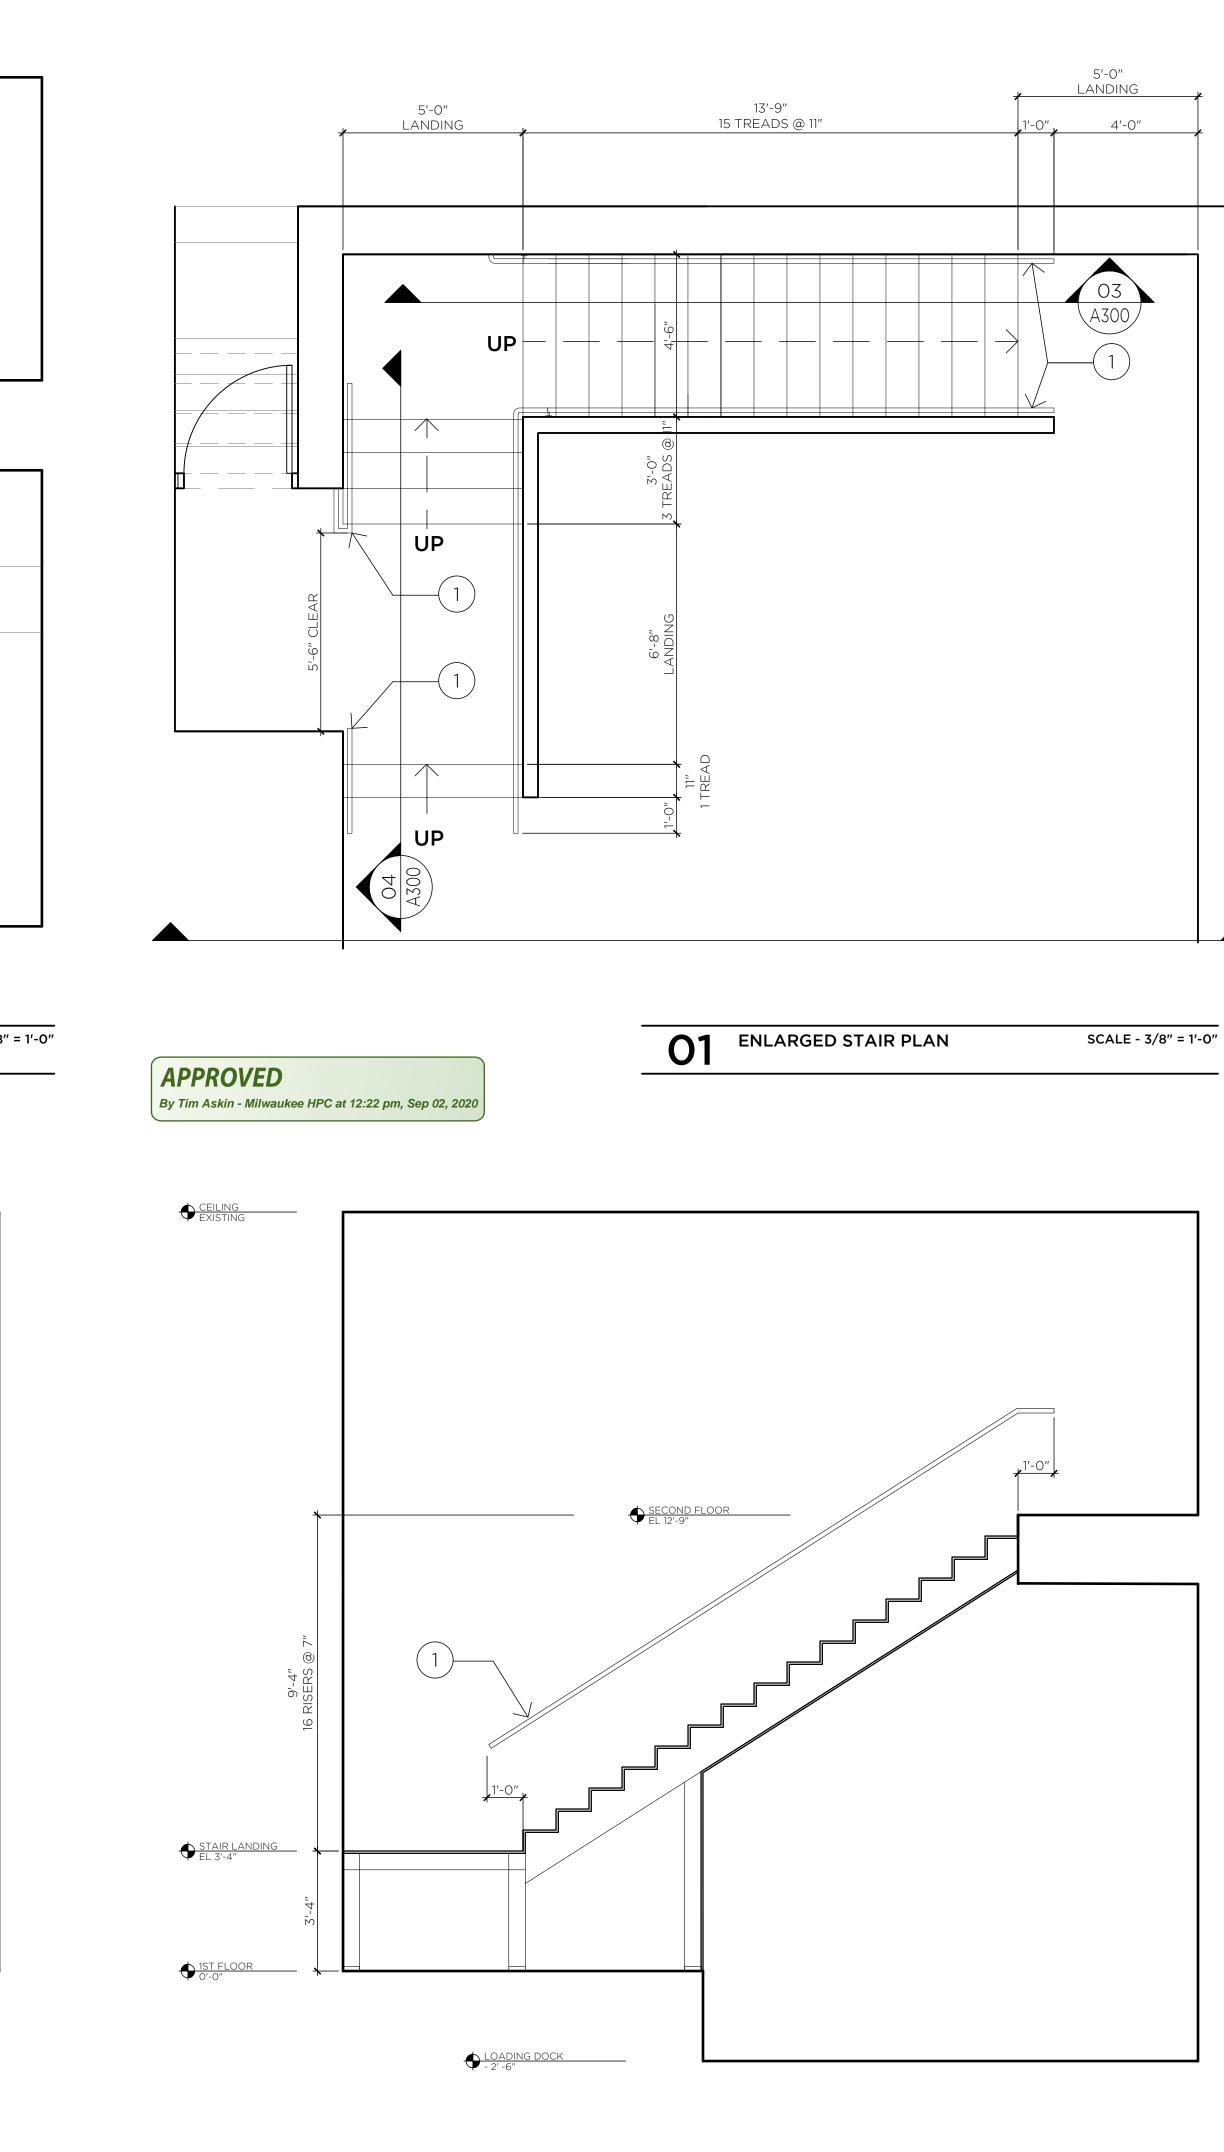- 1. PROVIDE 1 $\frac{1}{4}$ " STEEL PIPE HANDRAIL BOTH SIDES OF STAIR. TYP. PAINT. MOUNT AT 34" AFF.
- 2. EXISTING OVERHEAD DOOR TO BE REMOVED AND OR REPLACED WITH SMALLER OVERHEAD DOOR
- 3. DRYWALL UNDERSIDE OF NEW STAIR.



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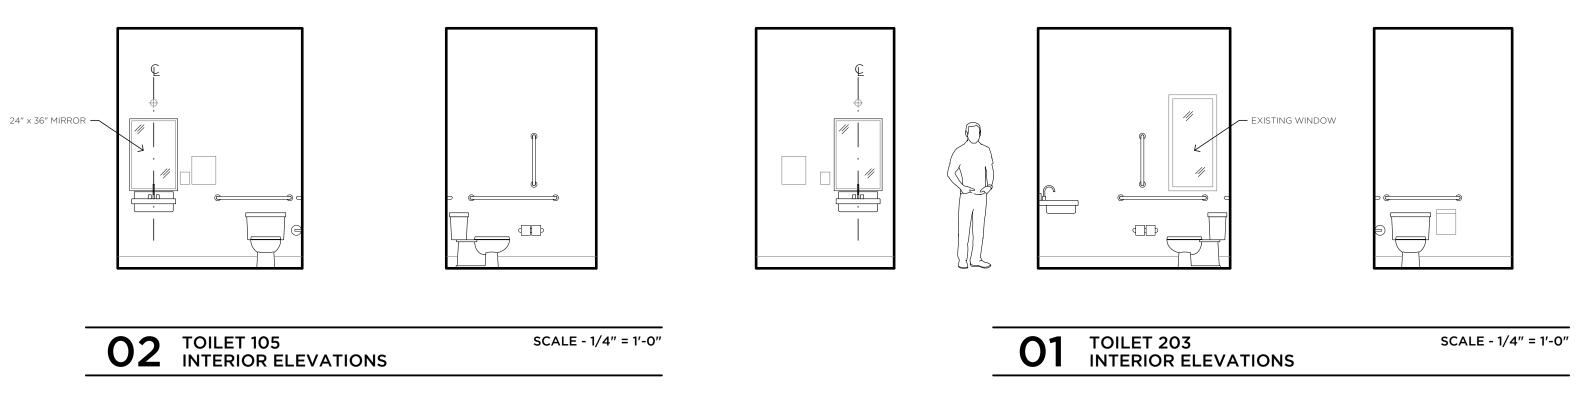
SET TYPE CONTRUCTION SCOPE DOCUMENTS


AA PROJECT NUMBER 20010

DATE 07-16-2020


SHEET TITLE ENLARGED STAIR PLAN SECTIONS AND ELEVATIONS SHEET NUMBER






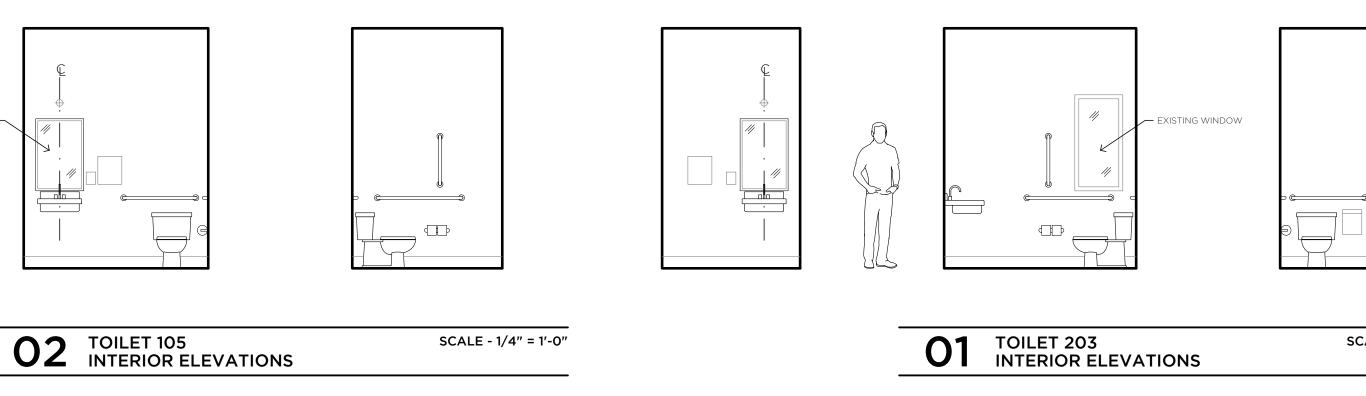

TYPICAL MOUNTING HEIGHTS

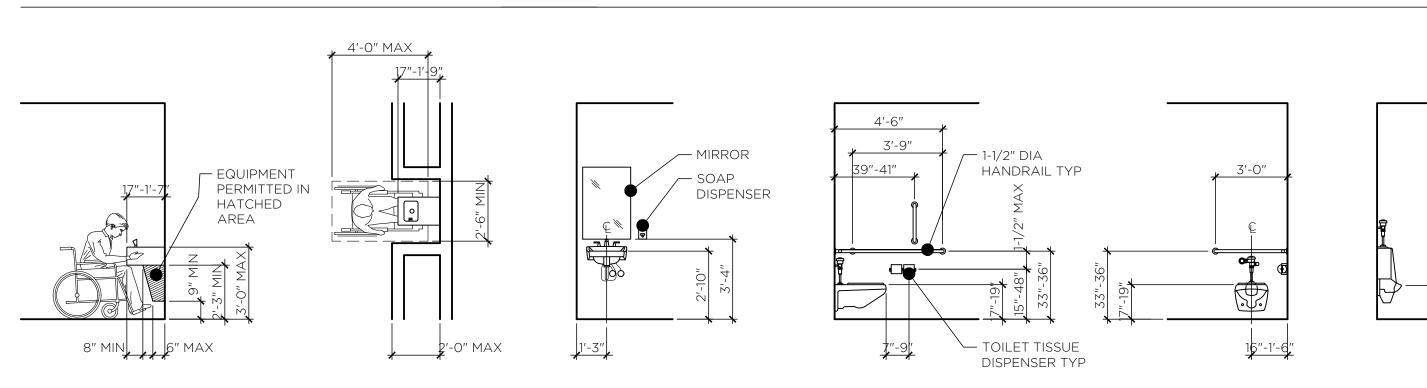

DOOR AND FRAME TYPES

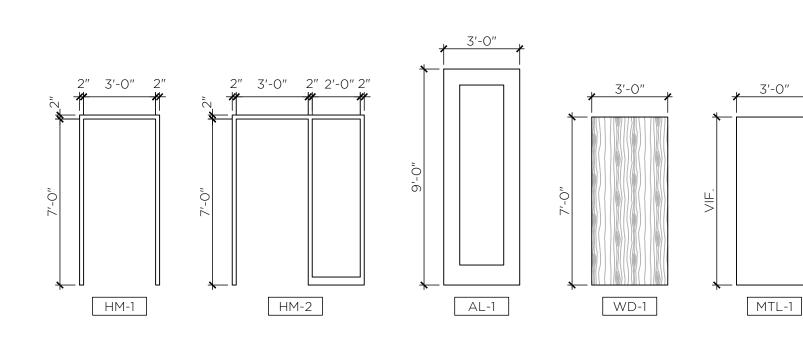

APPROVED By Tim Askin - Milwaukee HPC at 12:22 pm, Sep 02, 2020

INTERIOR ELEVATIONS **GENERAL NOTES**

- A. INTERIOR ELEVATION DIMENSIONS ARE BASED ON FACE OF FINISHED WALL TO FACE OF FINISHED WALL.
- B. REFER TO ELEVATION A400 FOR TYPICAL MOUNTING HEIGHT ELEVATIONS.

ARCHITECTURAL WOODWORK AND CASEWORK **GENERAL NOTES**

- A. REFER TO ROOM FINISH AND MATERIAL SCHEDULE OF PLASTIC LAMINATE SELECTIONS.
- B. PROVIDE BASE, AS LISTED IN ROOF FINISH SCHEDULE AT ALL CASEWORK. C. PROVIDE GROMMETS IN CASEWORK COUNTERTOPS WHEREVER ELECTRICAL OR COMMUNICATIONS OUTLETS ARE INDICATED IN KNEE SPACE BELOW. VERIFY LOCATIONS IN FIELD.
- D. ROUND ALL OUTSIDE CORNERS OF COUNTERTOPS WITH MINIMUM 1-1/2" RADIUS UNLESS NOTED OTHERWISE.
- E. PROVIDE 1-1/2" (MINIMUM) FILLERS AT PERPENDICULAR JUNCTION OF ALL CABINETS AND AT PERPENDICULAR JUNCTURE WITH ADJACENT WALLS, UNLESS NOTED OTHERWISE. SCRIBE ALL EDGES AND APPLY SEALANT TO JOINTS. F. PROVIDE SEALANT BETWEEN BACKSPLASH / SIDESPLASH OR COUNTERTOP AND
- WALL. G. ALL SHELVING IN CASEWORK TO BE ADJUSTABLE UNLESS NOTED OTHERWISE.



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 B. ALL WOOD FRAMES TO RECEIVE PAIC. ALL WOOD DOORS TO RECEIVE PAIND. ALL HARDWARE FINISH: TBD	ALL KEYING, LOCKING/ELECTRIFIED ACCESS COORDINATED BY GENERAL CONTRACTOR WITH OWNER. (HM) - HOLLOW METAL (AL) - ALUMINUM (WD) - WOOD		
DOOR 101.1 TYPE: AL-1 FRAME: AL-4 HARDWARE	DOOR 107 TYPE: WD-1 FRAME: HM-2 HARDWARE		
DOOR 101.2 TYPE: AL-1 FRAME: AL-3 HARDWARE	DOOR 108 TYPE: MTL-1 FRAME: HM-1 HARDWARE: - PANIC HARDWARE		
DOOR 103 TYPE: WD-1 FRAME: HM-2 HARDWARE	DOOR 201 TYPE: WD-1 FRAME: HM-1 HARDWARE		
DOOR 104 TYPE: WD-1 FRAME: HM-1 HARDWARE	DOOR 202 TYPE: WD-1 FRAME: HM-1 HARDWARE: - PANIC HARDWARE		

DOOR, FRAME AND HARDWARE

NOTES

DOOR 105 TYPE: WD-1 FRAME: HM-1 HARDWARE ------

DOOR 106 TYPE: WD-1 FRAME: HM-2 HARDWARE

DOOR 203 TYPE: WD-1 FRAME: HM-1 HARDWARE ---

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729 W HISTORIC MITCHELL ST MILWAUKEE, WI 53204

DRAWING ISSUE HISTORY CD 07-16-2020 PERMIT SET

SET TYPE CONTRUCTION SCOPE DOCUMENTS

AA PROJECT NUMBER 20010

DATE 07-16-2020

SHEET TITLE INTERIOR ELEVATIONS DOOR SCHEDULE SHEET NUMBER

