

### ABBREVIATIONS

AFF	Above Finished Floor	FC	Fire Code	MFR	Manufacturer	SECT	Section	MIN	Window
ALUM	Aluminum	FD	Floor Drain	MIN	Minimum	SHT	Sheet	WO	Without
ARCH	Architect	FDN	Foundation	MISC	Miscellaneous	SHTG	Sheeting	WP	Weatherproof
		FG	Fiberglass	NIC	Not in Contract	SIM	Similar	WWF	Welded Wire Fo
BLDG	Building	FIN	Finished	NO	Number	SPEC	Specified		
BLKG	Blocking	FLR	Floor	NONCOM	Noncombustible	STD	Standard	\$	And
BRG	Bearing	FT	Foot or Feet	NTS	Not to Scale	STOR	Storage	0	At
		FTG	Footing	0/	On, Over	SYP	Southern Yellow Pine	Ł	Center Line
CLG	Ceiling	GYP	Gypsum	00	On Center			DIA	Diameter
CONC	Concrete			OPNG	Opening	Т	Tread		
CONSTR	Construction	HT	Height	OPP	Opposite	T & G	Tongue & Groove		
CONT	Continuous	HC	Handicap	OH	Overhead	TEMP	Temporary		
CONTR	Contract(or)	HDR	Header			THK	Thick		
CTR	Center	HR	Hour	PLY	Plywood	TOF	Top of Footing		
		HVAC	Heating, Ventilating \$	PROP	Property	TRTD	Treated		
DP	Deep		Air Conditioning	PT	Point	TV	Television		
DBL	Double	INCL	Including	PVMT	Pavement	TYP	Typical		
DET	Detail	INSUL	Insulation	PWR	Power				
DIA	Diameter	INT	Interior	PSF	Pounds per Square Foot	UL DES	Underwriters		
DIM	Dimension	КT	Joist	PSL	Parallam Structure Lumber		Laboratory		
DN	Down	JST KD	Kiln Dried	PLF	Per linear foot	1110	Designation		
DR	Door	RD.	Rin Dried			UNO	Unless Noted		
DS	Downspout	LAV	Lavatory	R	Riser		Otherwise		
DWG	Drawing	LT	Light	RAD	Radius	VВ	Vapor Barrier		
		LVL	Laminated Veneer Lumber	REF	Refrigerator	VCT	Vinyl Composite Tile		
<del>~</del> .	- ·			REINF	Reinforcing	VEN	Veneer		
EA	Each		Maria dana an	REQD	Required				
ELEC	Electrical	MAX	Maximum	REV	Revision	М	Wide		
ELEV	Elevation	MC MECH	Moisture Content Mechanical	RM	Room	Ψ/	With		
EP	Electrical Panel			RO	Rough Opening	WD	Wood		
EXT	Exterior	MET	Metal						

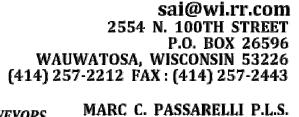

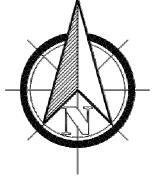



### **BENCHMARK FOR ELEVATIONS:**

Concrete Monument with Brass Cap Marking the Northeast Corner of the Northeast 1/4 of Section 15–7–22 Elevation: 665.95' NGVD 1929 Datum Converted to 85.35' Milwaukee Datum

WISCONSIN REGISTERED LAND SURVEYOR


NOTE : THIS IS NOT AN ORIGINAL SURVEY UNLESS THIS SEAL IS RED.

#### Surveyed for: **PATERA, LLC**

"I have surveyed the above described property and the above map is a true representation thereof and shows the size and location of the property, its exterior boundaries, the location and dimensions of all structures thereon, fences, apparent easements and roadways and visible encroachments, if any.

"This survey is made for the exclusive use of the present owners of the property, and also those who purchase, mortgage, or guarantee the title thereto within one (1) year from date hereof; and as to them I warrant the accuracy of said survey map.

07/22/2019	MWW	08/09/2019	МСР	35558
FIELD WORK DATE	FIELD WORK BY	DATE DRAFTED	DRAFTED BY	JOB NUMBER

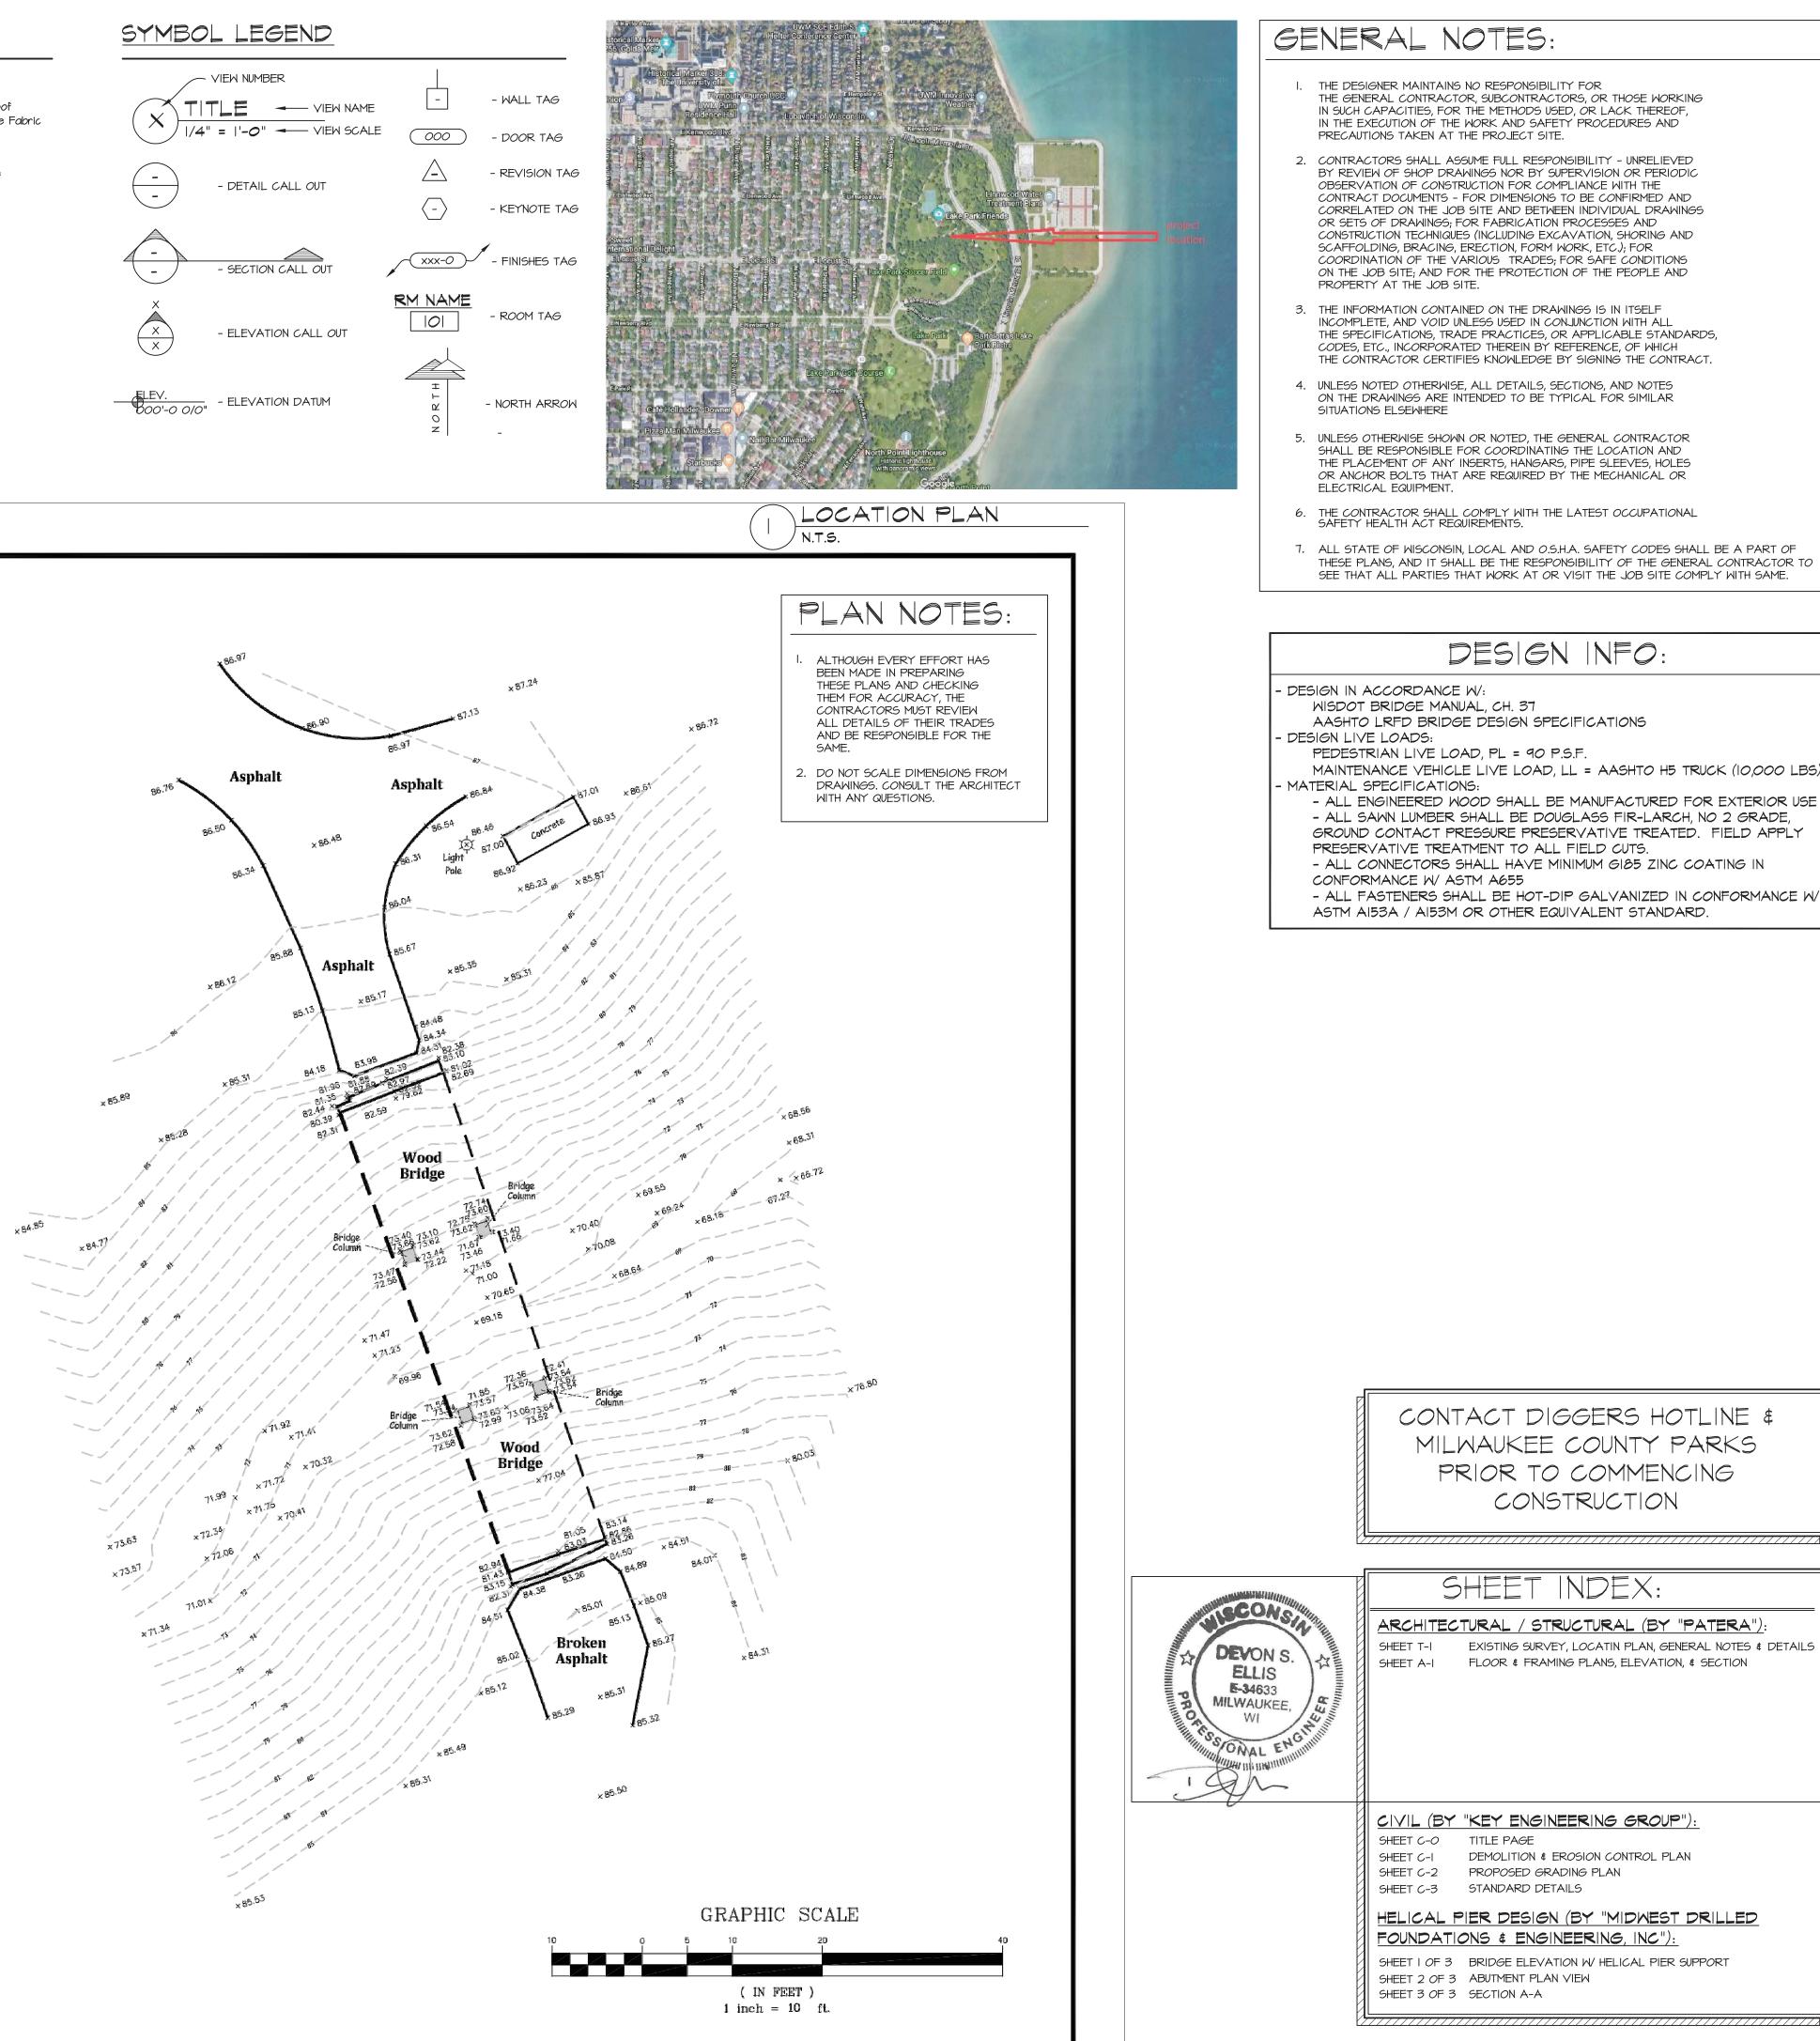

- 7. ALL STATE OF WISCONSIN, LOCAL AND O.S.H.A. SAFETY CODES SHALL BE A PART OF THESE PLANS, AND IT SHALL BE THE RESPONSIBILITY OF THE GENERAL CONTRACTOR TO SEE THAT ALL PARTIES THAT WORK AT OR VISIT THE JOB SITE COMPLY WITH SAME.

- MAINTENANCE VEHICLE LIVE LOAD, LL = AASHTO H5 TRUCK (10,000 LBS)
- ALL ENGINEERED WOOD SHALL BE MANUFACTURED FOR EXTERIOR USE - ALL SAWN LUMBER SHALL BE DOUGLASS FIR-LARCH, NO 2 GRADE, GROUND CONTACT PRESSURE PRESERVATIVE TREATED. FIELD APPLY

- ALL FASTENERS SHALL BE HOT-DIP GALVANIZED IN CONFORMANCE W/





## **REVISIONS:**

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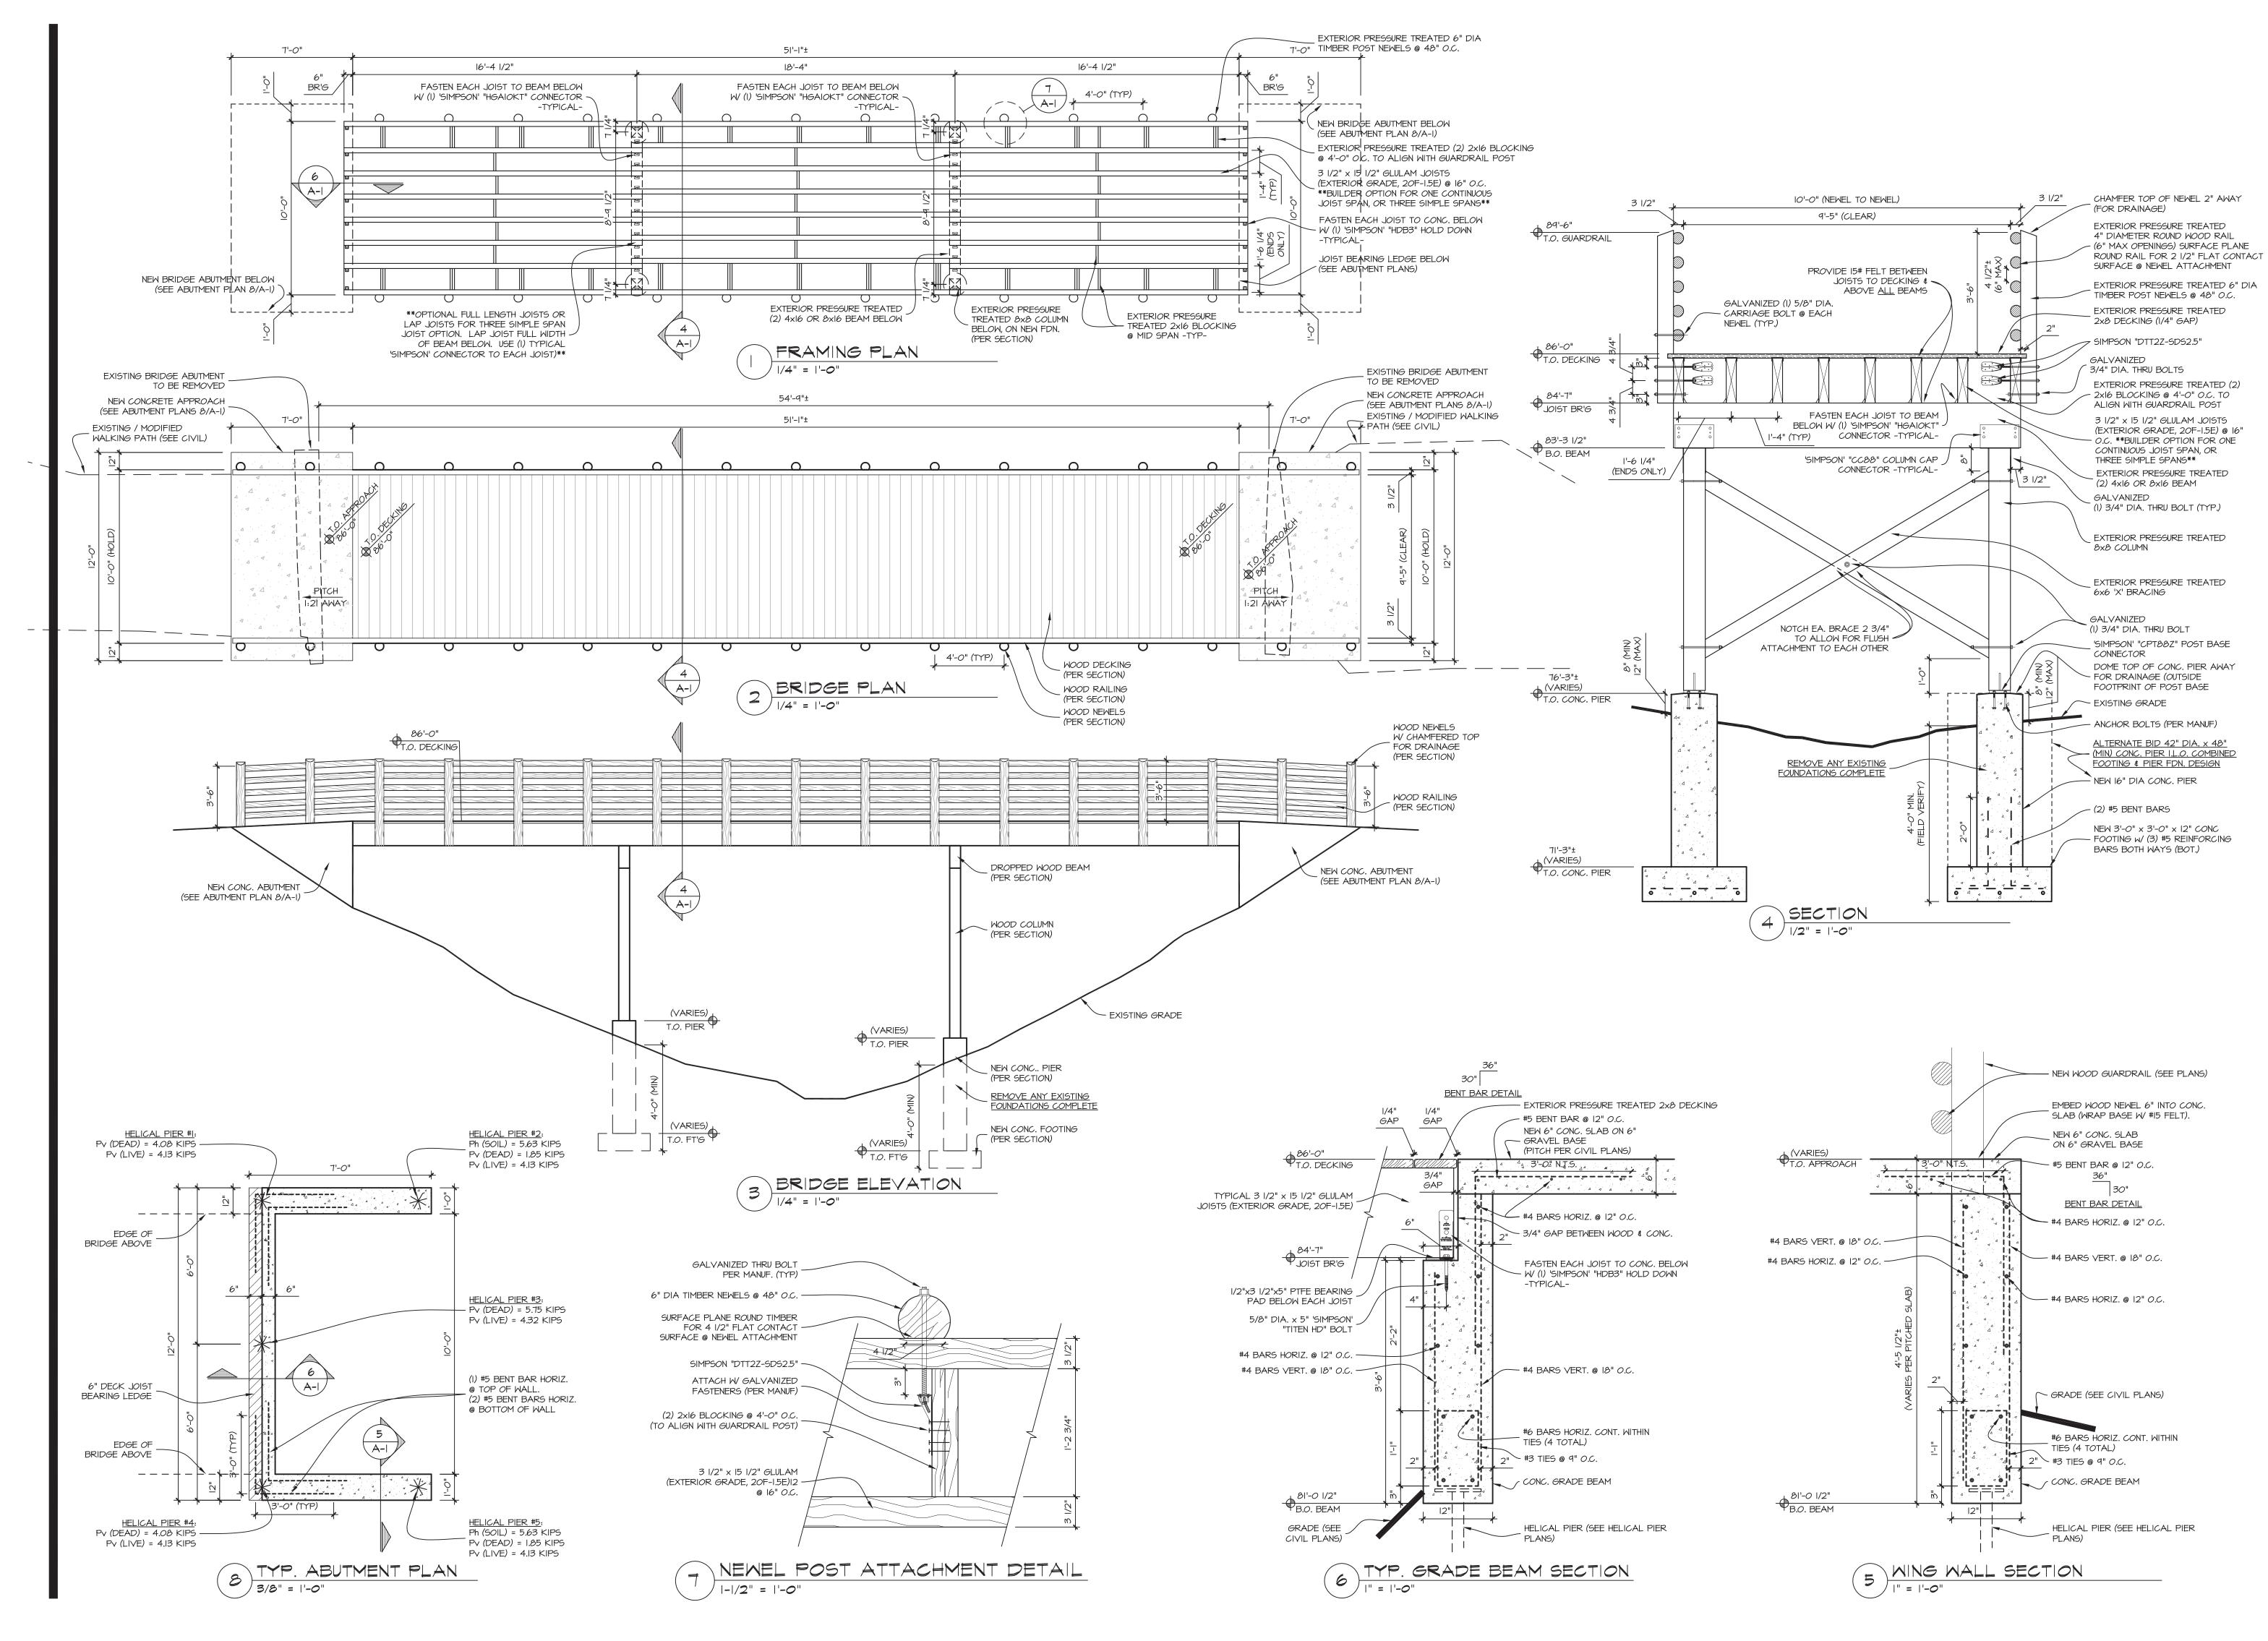
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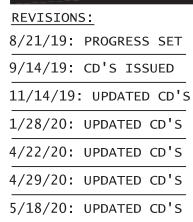
8/21/19: PROGRESS SET 9/14/19: CD'S ISSUED 11/14/19: UPDATED CD'S 1/28/20: UPDATED CD'S 4/22/20: UPDATED CD'S 4/29/20: UPDATED CD'S 5/18/20: UPDATED CD'S

PROJECT NUMBER: 19-261

DATE: AUG. 9, 2019









**U ľ e** I 53151 -703  $\leq$ 786 J θ +---262 • — \_ **U 1** × 76 -67 62-786- $\sim$ 

PROJECT NUMBER: 19-261

DATE: AUG. 9, 2019



• - SET IRON STAKE	B-4 - BORING
- FOUND IRON PIPE	$\otimes$ - CLEAN OUT
P/L - PROPERTY LINE	C - TRANSFORMER
x 100.00 - EXISTING SPOT ELEVATION	
S - SEWER MANHOLE	BOLLARD
© - COMMUNICATION MANHOLE	
E) - ELECTRIC MANHOLE	— E — E — E — E — - UNDERGROUND ELECTRIC
D - CATCH BASIN	- T $-$ T $-$ T $-$ T $-$ T $-$ UNDERGROUND TELECOMMUNICATIONS
T) - TRAFFIC MANHOLE	
EM - ELECTRIC METER	
GM- GAS METER	SAN SAN SANITARY SEWER
	ststst STORM SEWER
	sf sf sf SILT FENCE
A - TRAFFIC SIGNAL	
▼ - FLOOD LIGHT	
	-xxxxxxxxxxxxxxxxxxxxxxxxxxxxxxxx SAW CUT
	· TREE LINE

REVISION	DESCRIPTION	DATE	BY	DESIGNED BY	ISSUANCE TYPE	
NO.				RJN		
				DRAWN BY		
				RJN	PERMIT	
				APPROVED BY		
				DAT		
				DATE 05.15.2020		
				05.15.2020		

# LAKE PARK PEDESTRIAN BRIDGE LAKE PARK **CITY OF MILWAUKEE MILWAUKEE COUNTY** WISCONSIN

SITE LOCATION AERIAL MAP

## **CONTACT LIST**

OGDEN CONSTRUCTION GROUP, LLC

JOEL COOK - joelcook@ogdenre.com - 414-342-4203

PATERA, LLC - ARCHITECTS

NATHAN REMITZ - nathan@paterallc.com - 262-786-6776

**KEY ENGINEERING** 

DEB TARNOW, P.E. - dtarnow@keyengineering.com - 414-224-8300 ext. 209 ROB NEWELL - rnewell@keyengineering.com - 414-224-8300 ext. 205

**PROPOSED PLAN SET OGDEN CONSTRUCTION GROUP, LLC** LAKE PARK PEDESTRIAN BRIDGE MILWAUKEE, WISCONSIN

## PAGE INDEX


TITLE PAGE C-0 C-1 **DEMOLITION & EROSION CONTROL PLAN** PROPOSED GRADING PLAN **C-2** C-3 STANDARD DETAILS

> "THE INFORMATION SHOWN ON THIS DRAWING CONCERNING TYPE AND LOCATION OF UNDERGROUND UTILITIES IS NOT GUARANTEED TO BE ACCURATE OR ALL INCLUSIVE. THE CONTRACTOR IS RESPONSIBLE FOR MAKING HIS OWN DETERMINATIONS AS TO THE TYPE AND LOCATION OF UNDERGROUND UTILITIES AS MAY BE NECESSARY TO AVOID DAMAGE THERETO."





KEY PROJECT NUMBER 2002-0285-0001 PROJECT SCALE SHEET NUMBER **C-0** 

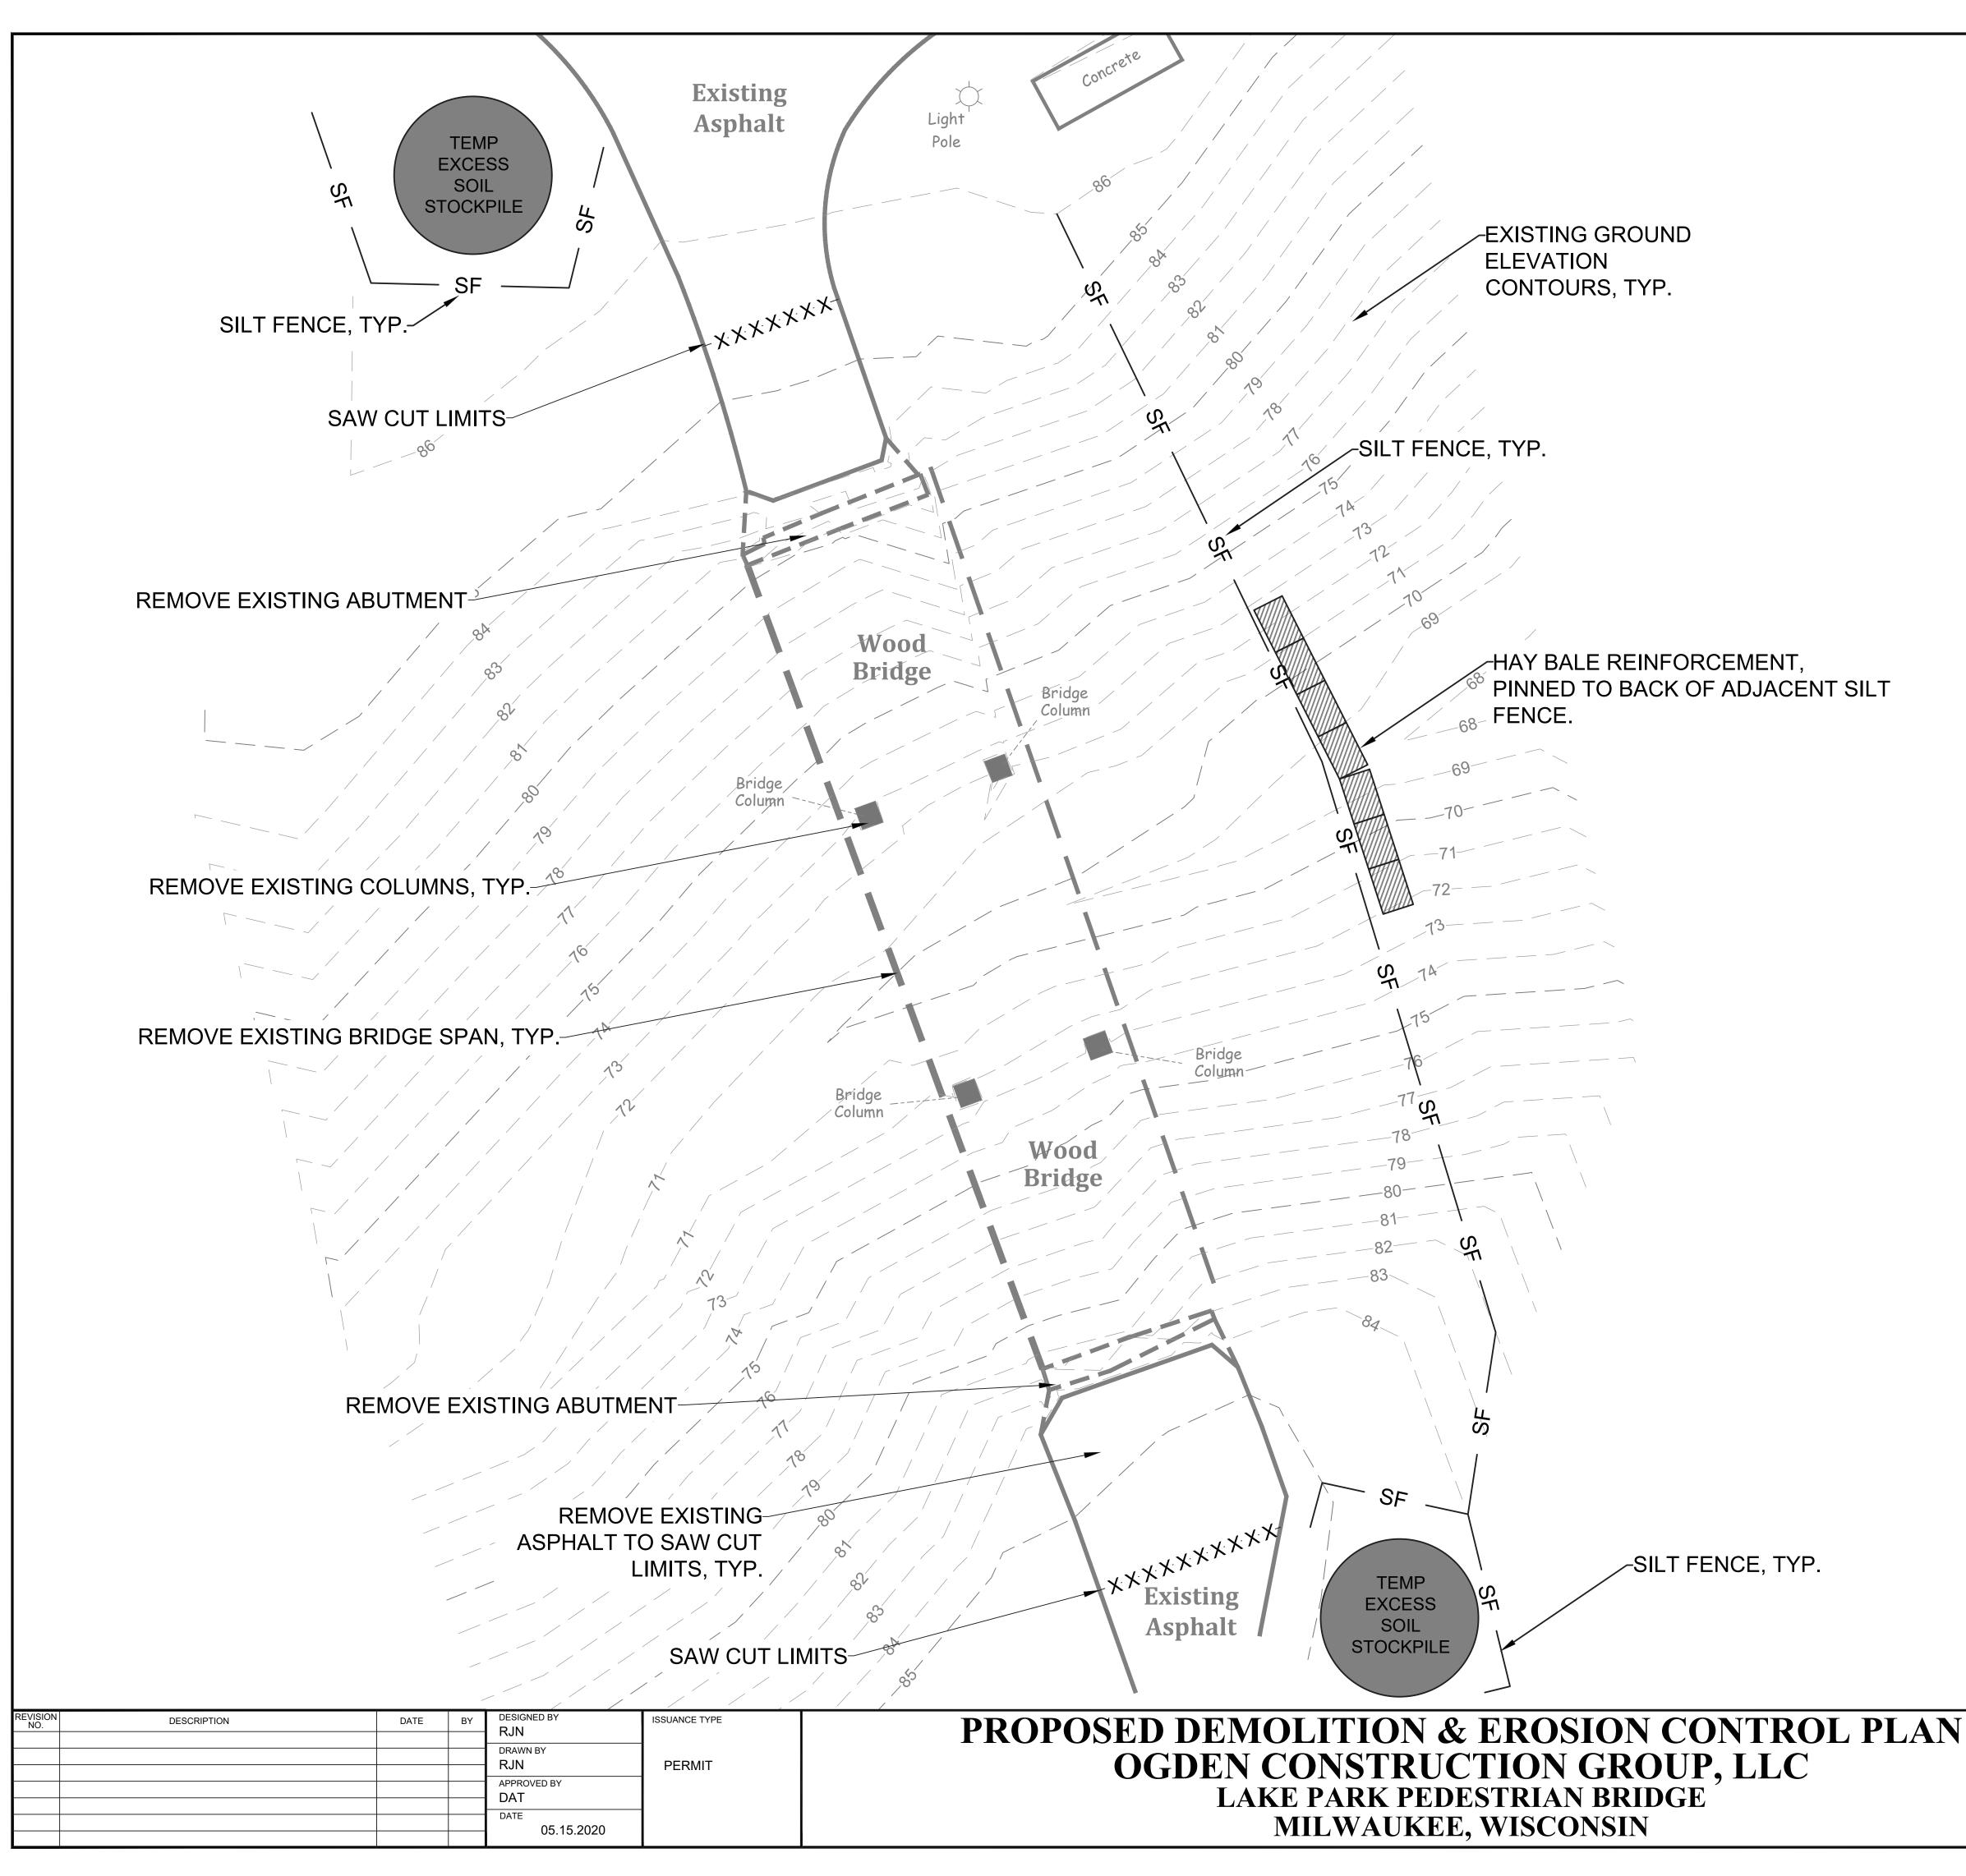

### MAINTENANCE PLAN

- 1. ALL EROSION AND SEDIMENT CONTROL PRACTICES WILL BE INSPECTED FOR FUNCTIONAL EFFECTIVENESS FOLLOWING EVERY 1/2-INCH RAIN EVENT AND IN NO CASE LESS THAN ONCE PER WEEK. ANY NEEDED REPAIRS WILL BE MADE IMMEDIATELY TO ENSURE THE DEVICE FUNCTIONS AS DESIGNED.
- 2. ALL SEEDED AREAS WILL BE WATERED, FERTILIZED, MULCHED AND RESEEDED AS NECESSARY TO MAINTAIN A VIGOROUS, DENSE VEGETATIVE COVER.
- 3. ANY SEDIMENT REACHING A PUBLIC OR PRIVATE STREET SHALL BE REMOVED BY STREET CLEANING BEFORE THE END OF EACH DAY OR AS NECESSARY TO PREVENT DEBRIS FROM ENTERING A STORM SEWER, DITCH, OR WATERWAY.
- 4. IN THE EVENT CONSTRUCTION ACTIVITIES RESULT IN SEVERE DUST CONDITIONS, SEE WDNR TECHNICAL STANDARD 1068.
- 5. IN THE EVENT OF DEWATERING ACTIVITIES, FOLLOW WDNR TECHNICAL STANDARD 1061. ALL WATER DISCHARGED FROM THE DEWATERING EQUIPMENT MUST BE FILTERED BY A TYPE II GEOTEXTILE BAG SIZED FOR THE PUMP DISCHARGE FLOW RATE.
- ANIONIC POLYACRYLAMIDE SHALL BE APPLIED TO ALL DISTURBED AREAS WHERE STABILIZATION OR EROSION IS PROBLEMATIC DURING INCLIMATIC WEATHER WHEN SEEDING IS NOT LIKELY TO GERMINATE. APPLICATION OF POLYACRYLAMIDE SHALL BE PERFORMED IN ACCORDANCE WITH WDNR CONSERVATION PRACTICE STANDARD 1050 (EROSION CONTROL, LAND APPLICATION OF ANIONIC POLYACRYLAMIDE.)

#### NOTES:

- 1. ALL PROPOSED ELEVATIONS ARE SHOWN AS FINISHED SURFACE GRADES, LOCATED AT GEOMETRY POINTS AND SPOT ELEVATIONS.
- 2. THE EROSION CONTROL PLAN MUST COMPLY WITH CITY OF MILWAUKEE AND DNR TECHNICAL STANDARDS.
- 3. STREETS SHALL BE KEPT CLEAN WITH STREET SWEEPING DURING CONSTRUCTION.
- 4. ALL EXPOSED SOIL AREAS NOT DISTURBED FOR UP TO SEVEN DAYS MUST BE IMMEDIATELY RESTORED WITH SEED AND MULCH.
- 5. EXCESS TOPSOIL SHALL BE HAULED OFFSITE. NO SALES OF TOPSOIL FROM SITE IS PERMITTED BY THE CITY OF MILWAUKEE.

#### CONSTRUCTION SCHEDULE

- 1. OBTAIN PLAN APPROVAL AND APPLICABLE PERMITS
- 2. INSTALL PERIMETER EROSION CONTROL
- 3. COMPLETE DEMOLITION ACTIVITIES.
- 4. STRIP AND REMOVE TOPSOIL WITHIN DISTURBANCE LIMITS FROM PROJECT SITE.
- 5. TEMPORARY STOCKPILES SHALL BE PROTECTED WITH STRAW BALES, SILT FENCE, OR OTHER PERIMETER CONTROL MEASURES.
- 6. ROUGH GRADE FOR PROPOSED IMPROVEMENTS.
- 7. INSTALL CONCRETE ABUTMENTS AND CONCRETE PIERS & FOUNDATION.
- 8. CONSTRUCT BRIDGE AND DECKING.
- 9. INSTALL PAVEMENT.
- 10. FINAL GRADE, INSTALL PERMANENT EROSION MATTING, TOPSOIL, INSTALL PLANT MATERIAL, SEED AND STABILIZE ALL DISTURBED AREAS.
- 11. REMOVE ALL TEMPORARY EROSION CONTROL MEASURES AFTER 70% GROWTH OF HEALTHY VEGETATION.
- 12. ESTIMATED TIME TO FINAL STABILIZATION 3 MONTHS FROM THE START OF CONSTRUCTION ACTIVITIES.

# LEGEND


- SET IRON STAKE
- FOUND IRON PIPE P/L - PROPERTY LINE
- x 100.00 EXISTING SPOT ELEVATION
- S SEWER MANHOLE
- © COMMUNICATION MANHOLE E - ELECTRIC MANHOLE
- 🛍 🛈 CATCH BASIN
- ① TRAFFIC MANHOLE
- EM ELECTRIC METER
- GM- GAS METER
- WATER VALVE
- 🕅 GAS VALVE
- 💢 HYDRANT
- 🛆 TRAFFIC SIGNAL
- I UTILITY BOX ന്വം- UTILITY POLE
- ♥ FLOOD LIGHT
- 🌣 LIGHT POLE
- 🛛 WELL


#### B-4 - BORING ⊗ - CLEAN OUT - TRANSFORMER AG - AIR CONDITIONER • BOLLARD water water water water - UNDERGROUND WATER — E — E — E — - UNDERGROUND ELECTRIC - T - T - T - UNDERGROUND TELECOMMUNICATIONS - OVERHEAD ELECTRIC — • — • — • — • UNDERGROUND GAS \_\_\_\_\_ SAN \_\_\_\_\_ SAN \_\_\_\_\_ - SANITARY SEWER \_\_\_\_\_\_st \_\_\_\_\_\_st \_\_\_\_\_ - STORM SEWER - SF - SF - SF - SILT FENCE ------ × ------ - HAND RAIL - FP - FP - FP - FLOOD PLAIN -PEC -PEC - PRIMARY ENVIRONMENTAL CORRIDOR -xxxxxxxxxxxxxxxxxxxxxxxx - - SAW CUT

SCALE IN FEET





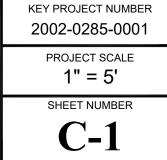

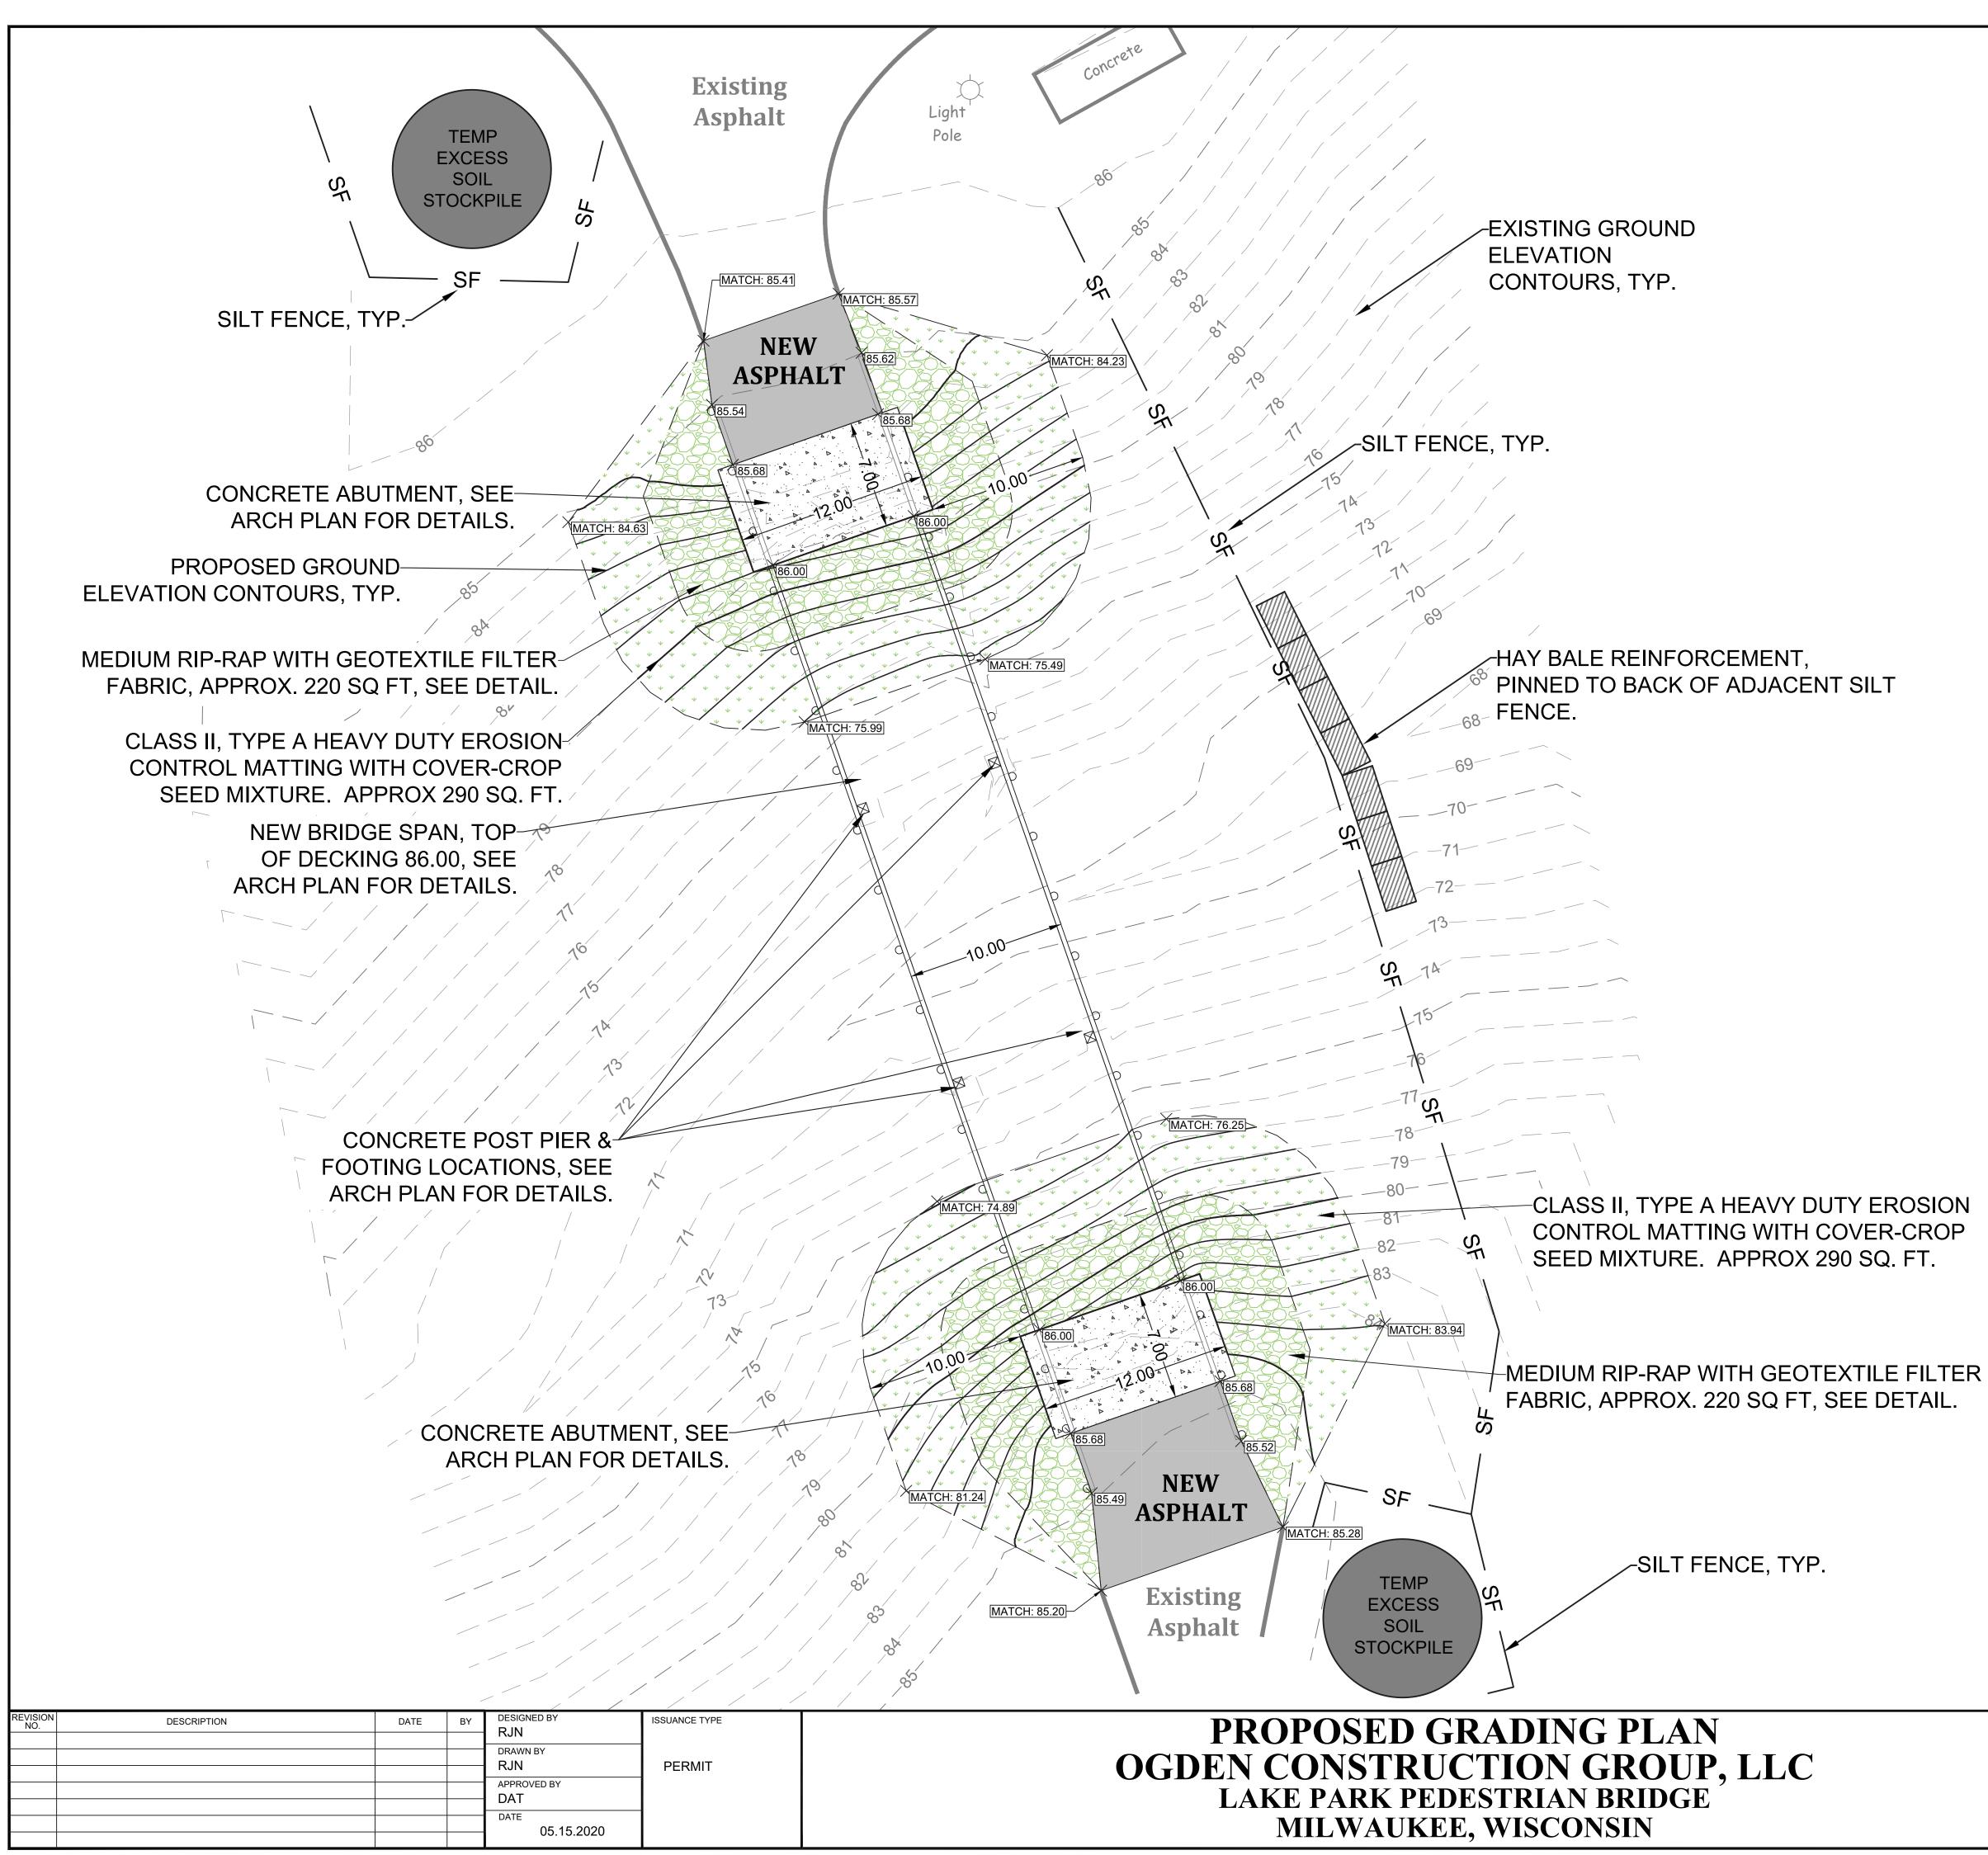

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### SEEDING NOTES:

- 1. AGRECOL CUSTOM SEED MIX ORDER NUMBER 0050726, OR EQUAL, IN ALL DISTURBED AREAS NOT COVERED BY FILTER FABRIC AND RIP-RAP, PER STANDARD SPECIFICATIONS.
- 2. MINIMIZE DISTURBED AREAS TO THOSE NEEDED FOR CONSTRUCTION ONLY.

CUSTOM SEED MIX HYSTRIX PATULA CAREX BREVIOR ELYMUS VIRGINICUS GLYCERIA STRIATA CAREX SPRENGELII AQUILEGIA CANADENSIS CAMPANULA AMERICANA EUPATORIUM PURPUREUM SOLIDAGO FLEXICAULIS

# LEGEND

- TRANSFORMER A AIR CONDITIONER • BOLLARD — Е — Е — Е — - UNDERGROUND ELECTRIC - T - T T - T - UNDERGROUND TELECOMMUNICATIONS ----- • - UNDERGROUND GAS — SAN — SAN — - SANITARY SEWER — - STORM SEWER -O----- - CHAIN LINK FENCE ------ × ------ - HAND RAIL - FP - FP - FP - FLOOD PLAIN - PP - PP - PP - - PERMANENT POOL -xxxxxxxxxxxxxxxxxxxxxxx - - SAW CUT 

SCALE IN FEET

KEY PROJECT NUMBER

2002-0285-0001

PROJECT SCALE


1" = 5'

SHEET NUMBER

**C-2** 

B-4 - BORING

⊗ - CLEAN OUT

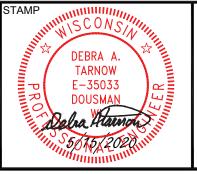

• SET IRON STAKE

P/L - PROPERTY LINE

S - SEWER MANHOLE

🛍 🛈 - CATCH BASIN

E - ELECTRIC MANHOLE

(T) - TRAFFIC MANHOLE

EM - ELECTRIC METER

GM- GAS METER

- WATER VALVE

△ - TRAFFIC SIGNAL

I - UTILITY BOX

ന്വം- UTILITY POLE

♥ - FLOOD LIGHT

🌣 - LIGHT POLE

🞯 - WELL

GAS VALVE

💢 - HYDRANT

- FOUND IRON PIPE

x 100.00 - EXISTING SPOT ELEVATION


© - COMMUNICATION MANHOLE




#### SILT FENCE GENERAL NOTES:

- DETAIL OF CONSTRUCTION NOT SHOWN ON THIS DRAWING SHALL CONFORM TO THE PERTINENT REQUIREMENTS OF THE STANDARD SPECIFICATIONS AND APPLICABLE SPECIAL PROVISIONS.
- WHEN POSSIBLE THE SILT FENCE SHOULD BE CONSTRUCTED IN AN ARC OR HORSESHOE SHAPE, WITH THE ENDS POINTING UPSLOPE TO MAXIMIZE BOTH STRENGTH AND EFFECTIVENESS.
- ① CROSS BRACE WITH 2" x 4" WOODEN FRAME OR EQUIVALENT AT TOP OF POSTS AS DIRECTED BY THE ENGINEER.
- ② MINIMUM 14 GAGE WIRE REQUIRED, FOLD FABRIC 3" OVER THE WIRE AND STAPLE OR PLACE WIRE RINGS ON 12" C-C.
- ③ EXCAVATE A TRENCH A MINIMUM OF 4" WIDE AND 6" DEEP TO BURY AND ANCHOR THE GEOTEXTILE FABRIC, FOLD MATERIAL TO FIT TRENCH AND BACKFILL AND COMPACT TRENCH WITH EXCAVATED SOIL.
- ④ WIRE SUPPORT FENCE SHALL BE 14 GAGE MINIMUM WOVEN WIRE WITH A MAXIMUM MESH SPACING OF 6". SECURE TOP OF GEOTEXTILE FABRIC TO TOP OF FENCE WITH STAPLES OR WIRE RINGS AT 12" C-C.
- 5 GEOTEXTILE FABRIC SHALL BE REINFORCED WITH AN INDUSTRIAL POLY-PROPYLENE NETTING WITH A MAXIMUM MESH SPACING OF 3/4" OR EQUAL. A HEAVY DUTY NYLON TOP SUPPORT CORD OR EQUIVALENT IS REQUIRED.
- ⑥ STEEL POSTS SHALL BE STUDDED "TEE" OR "U TYPE" WITH A MINIMUM WEIGHT OF 1.28 lbs/lin. ft. (WITHOUT ANCHOR). FIN ANCHORS SUFFICIENT TO RESIST POST MOVEMENT ARE REQUIRED. WOOD POSTS SHALL BE A MINIMUM SIZE OF 4" DIA. OR 1-1/2" x 3-1/2" EXCEPT WOOD POSTS FOR GEOTEXTILE FABRIC REINFORCED WITH NETTING SHALL BE A MINIMUM SIZE OF  $1-1/8" \times 1-1/8"$  OAK OR HICKORY.

ALTERNATIVES A AND B ARE EQUAL AND EITHER MAY BE USED.

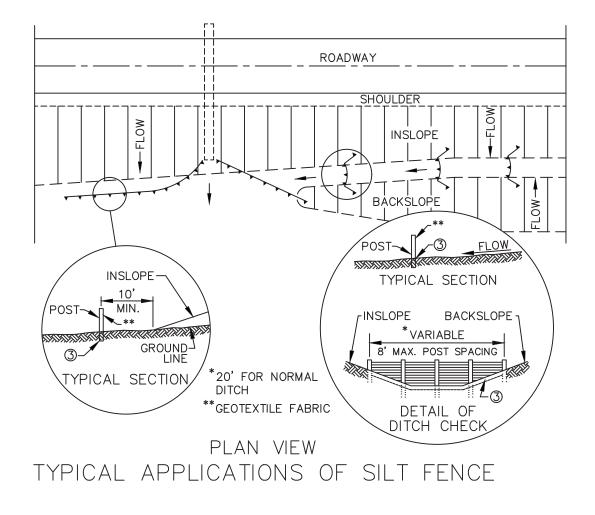

REVISION NO.	DESCRIPTION	DATE	BY	DESIGNED BY	ISSUANCE TYPE	
						1
				RJN	PERMIT	1
				APPROVED BY DAT		
						1
				DATE 05.15.2020		
				00.10.2020		1

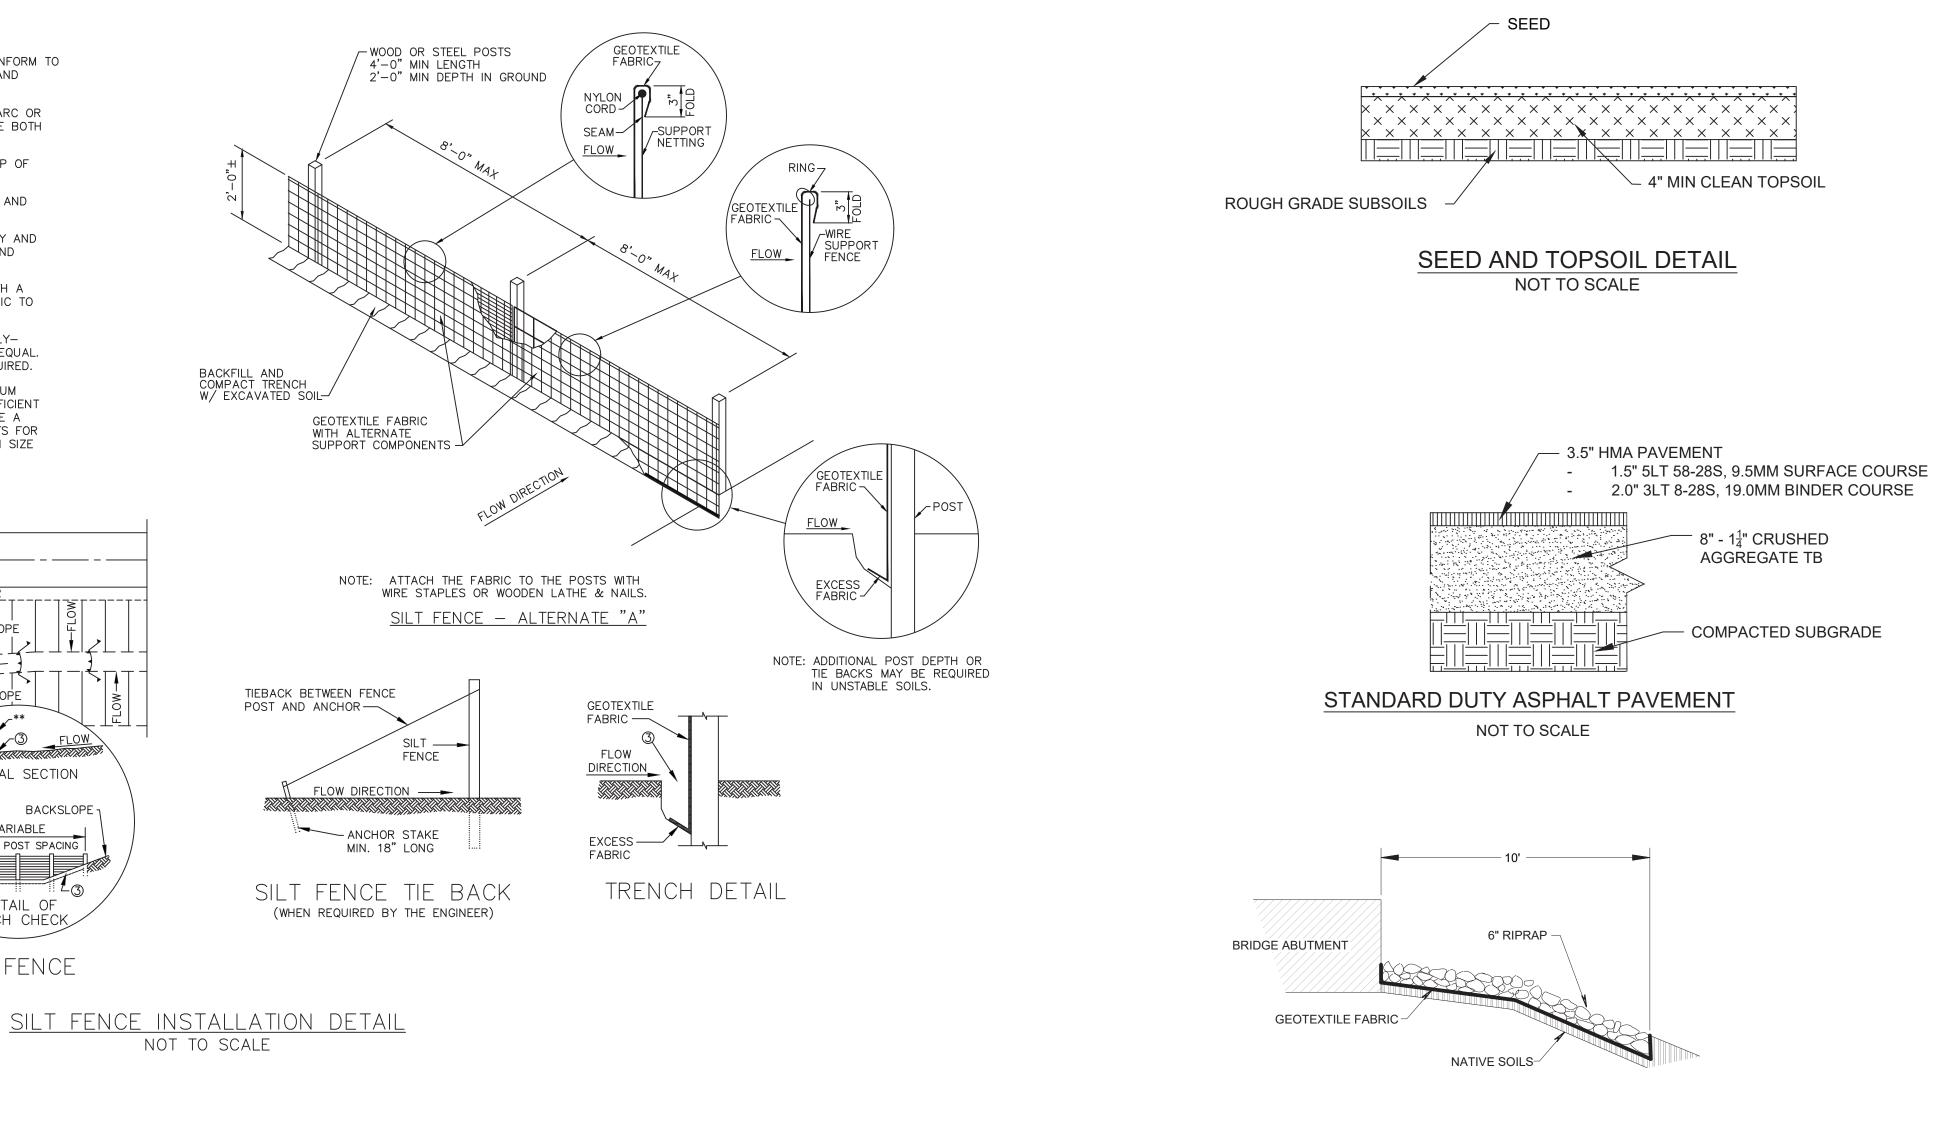

## **STANDARD DETAILS OGDEN CONSTRUCTION GROUP, LLC** LAKE PARK PEDESTRIAN BRIDGE MILWAUKEE, WISCONSIN


## RIPRAP AND GEOTEXTILE FABRIC

AT ABUTMENTS DETAIL NTS






2002-0285-0001
PROJECT SCALE NTS
SHEET NUMBER
<b>C-3</b>

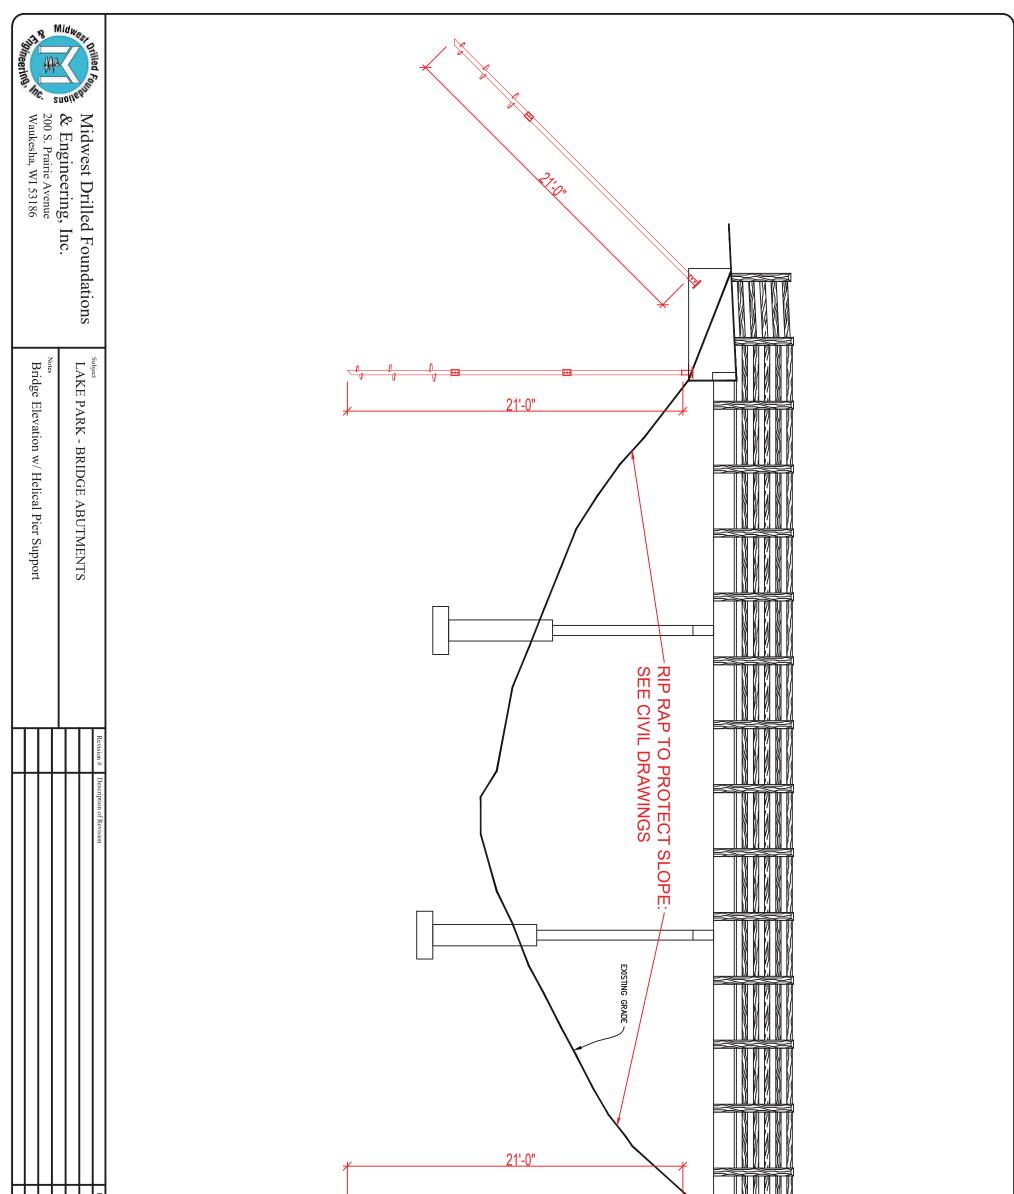

By Date Job No. 20-XXX Contractor MDF&E	
Date 5/1/2020 Scale N.T.S.	
Drawn By R.F.P. Sheet 1 of 3	

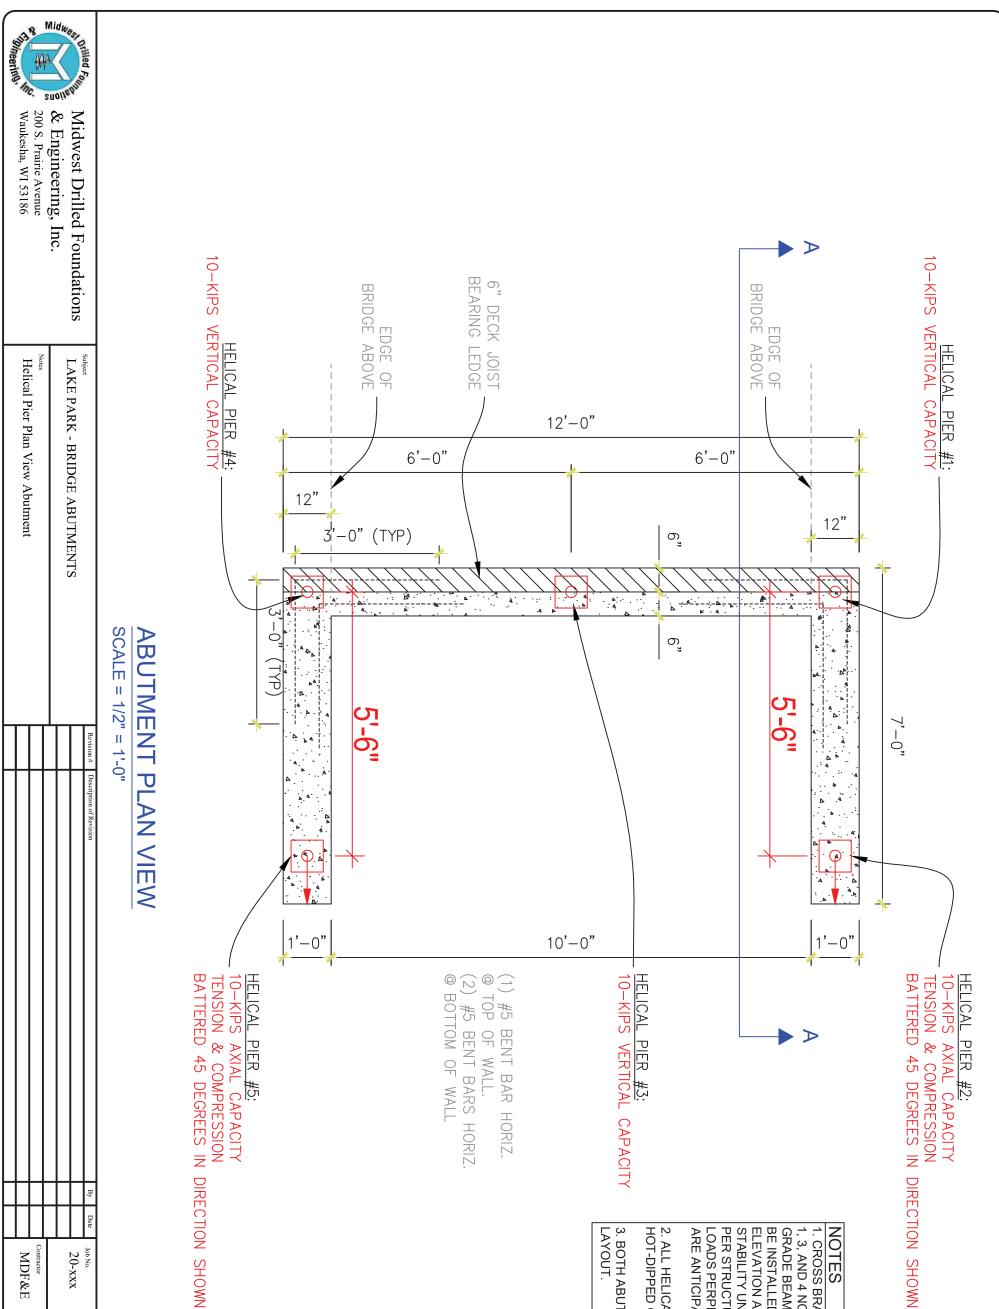


					Ву	
					Date	
	MDF&E	Contractor		20-xxx	Job No.	
	1/2" = 1'-0"	Scale		5/1/2020	Date	
	2 of 3	Sheet		R.F.P.	Drawn By	

DIRECTION SHOWN

# BE INSTALLED FROM B/GRADE BEAM ELEVATION AND SOIL WILL PROVIDE LATERAL STABILITY UNTIL CONCRETE PLACEMENT. 1. CROSS BRACING BETWEEN HELICAL PIERS 1, 3, AND 4 NOT REQUIRED FOR CONCRETE GRADE BEAM OPTION. HELICAL PIERS WILL NOTES PER STRUCTURAL ENGINEER, NO LATERAL LOADS PERPENDICULAR TO BRIDGE TRAFFIC ARE ANTICIPATED.

2. ALL HELICAL PIER MATERIAL TO BE HOT-DIPPED GALVANIZED.

**3. BOTH ABUTMENTS TO HAVE IDENTICAL** LAYOUT

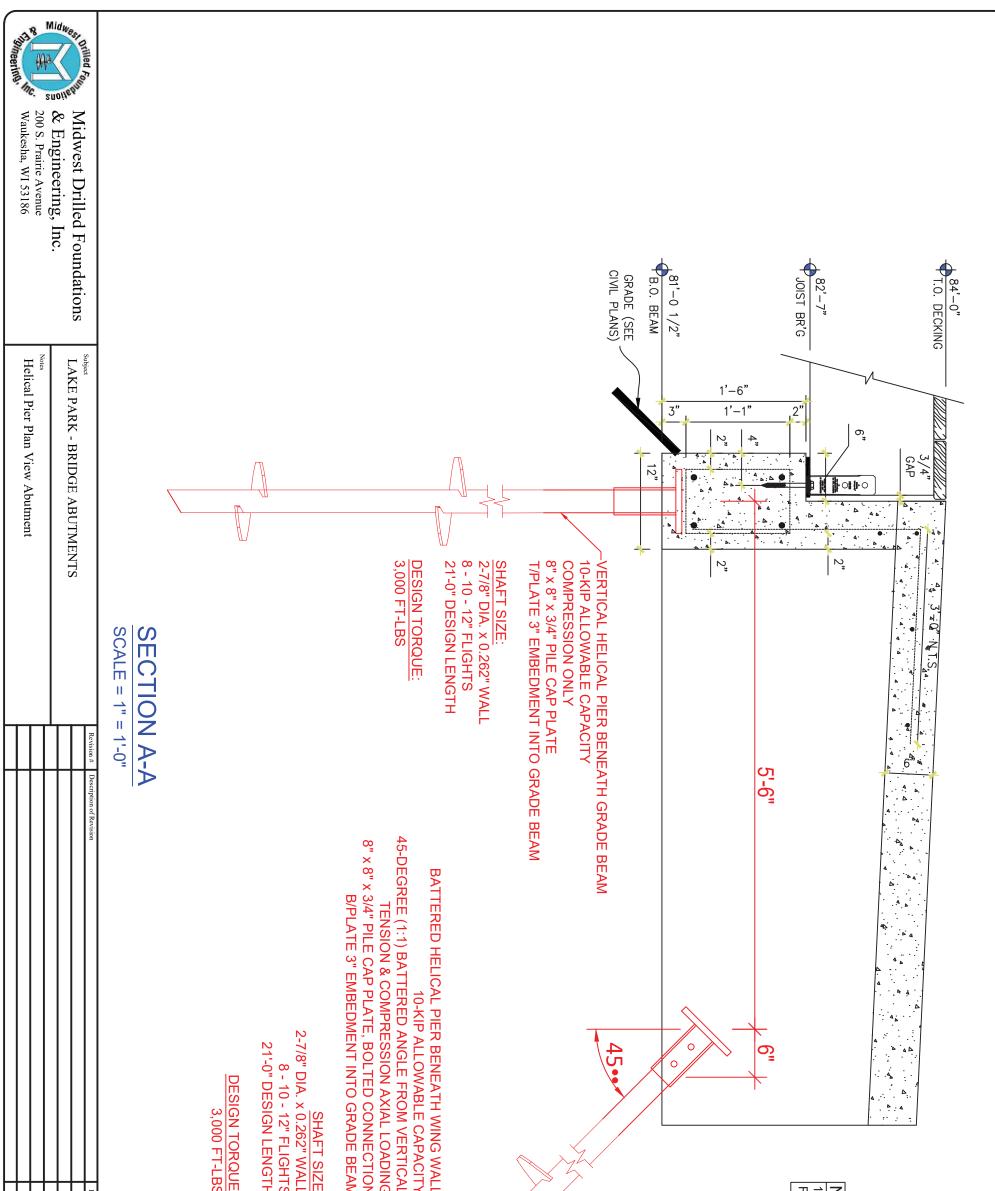

L Com	By Date Job	ALASE AND ELE	NOTES 1. WING WA FOR CLARIT
Contractor MDF&E	<sup>Job No.</sup> 20-XXX		NOTES 1. WING WALL REINFORCEMENT OMITTED FOR CLARITY
Scale 1" = 1'-0"	Date 5/1/2020		TOMITTED
sheet 3 of 3	Drawn By R.F.P.		