

flush and the sill shortened and reused and shortened to match the replacement window width..

2. Windows will be all wood both inside and out. No vinyl, vinyl-clad, aluminum, aluminum-clad or fiberglass windows are permitted. Simulated divided lights must have wood grids on both sides of glass and a spacer bar.

3. Standard masonry conditions

New mortar must match the original mortar in terms of color, texture, grain size, joint width, and joint finish/profile. The compressive strength of the repointing mortar shall be equal or less than the compressive strength of the original mortar and surrounding brick or stone. The replacement mortar shall contain approximately the same ingredient proportions of the original mortar. Mortar that is too hard is subject to premature failure and could damage the masonry. See the city's books As Good As New or Good for Business, Masonry Chapters, for more information. In most cases, this means a lime mortar with natural hydraulic cement rather than Portland cement. No joint of a width less than 3/8" may be cleaned of damaged/decomposed mortar with power disc grinders. No over-cutting of the joints is permitted. Remove decomposed mortar back into the wall 2.5 times the height of the joint before repointing.

New brick must match as closely as possible the color texture, size, and finish of the original brick.


A sample panel of brick and mortar must be reviewed and approved by HPC staff prior to general installation of the material. UNDER NO CIRCUMSTANCES SHALL UNPAINTED MASONRY BE PAINTED, BE GIVEN A WATERPROOFING TREATMENT, OR CLEANED BY ABRASIVE MEANS.

All work must be done in a craftsman-like manner, and must be completed within one year of the date this certificate was issued. Staff must approve any changes or additions to this certificate before work begins. Work that is not completed in accordance with this certificate may be subject to correction orders or citations. If you require technical assistance, please contact Dean Doerrfeld of the Historic Preservation staff as follows: Phone: (414) 286-5712 E-mail: Dean.Doerrfeld@milwaukee.gov.


If permits are required, you are responsible for obtaining them from the Milwaukee Development Center. If you have questions about permit requirements, please consult the Development Center's web site, <u>www.milwaukee.gov/build</u>, or call (414) 286-8210.

City of Milwaukee Historic Preservation Staff

Copies to: Development Center, Ald. Nik Kovac, Contractor, Inspector Paul Wolfgramm (286-2590)

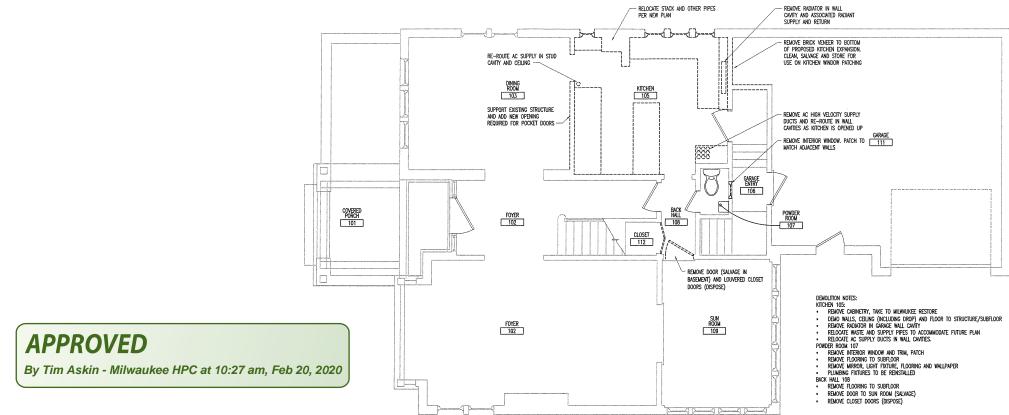

EXISTING/DEMOLITION FIRST FLOOR PLAN SOLVE 1/4-=1'-0"

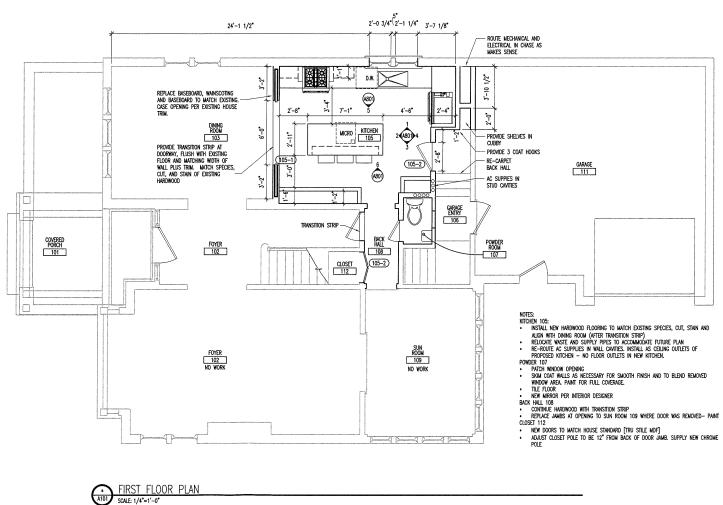

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JOHN VAN ROOY ARCHITECTURE

JOHN VAN ROOY ARCHITECTURE, LLC 2843 N. Prospect Avenue Milwaukee, WI 53211 t. 414.801.0173 e: john@johnvanrooy.com www.johnvanrooy.com


2518 N. Terrace Ave. Milwaukee, WI 53211




12/09/19 Date

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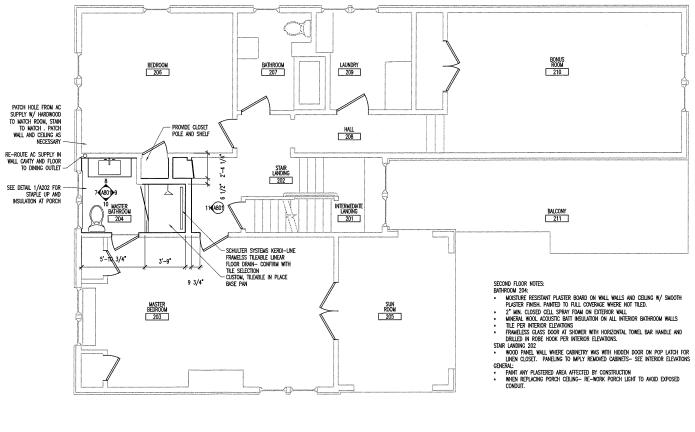
SHEET TITLE Existing/Demo First Floor Plan, First Floor Plan

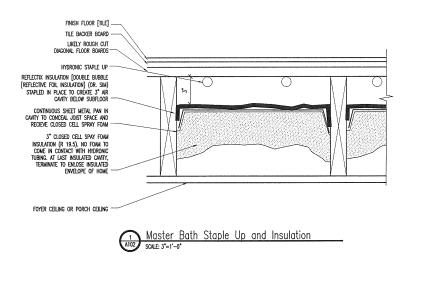

APPROVED By Tim Askin - Milwaukee HPC at 10:27 am, Feb 20, 2020

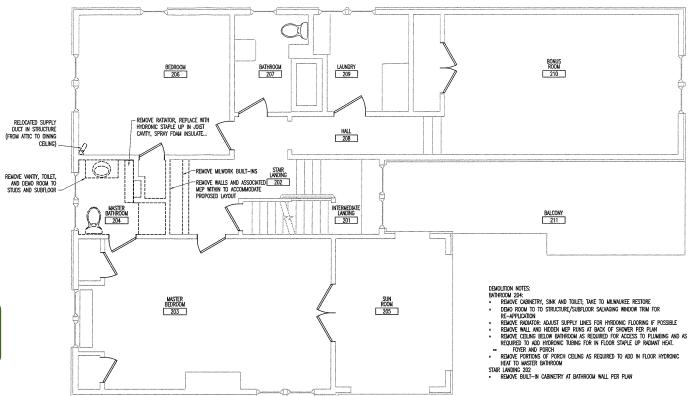

2 EXISTING/DEMOLITION SECOND FLOOR PLAN SCALE: 1/4=1'-0"




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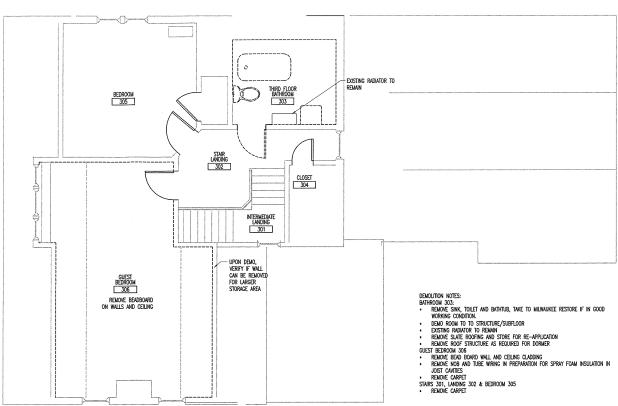
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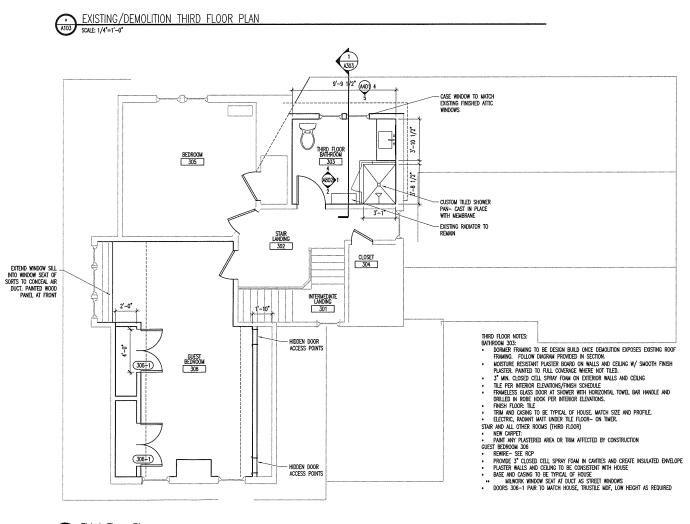
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SHEET TITLE Existing/Demo Second Floor Plan, Second Floor Plan, Details







A103 SCALE: 1/4"=1'-0"
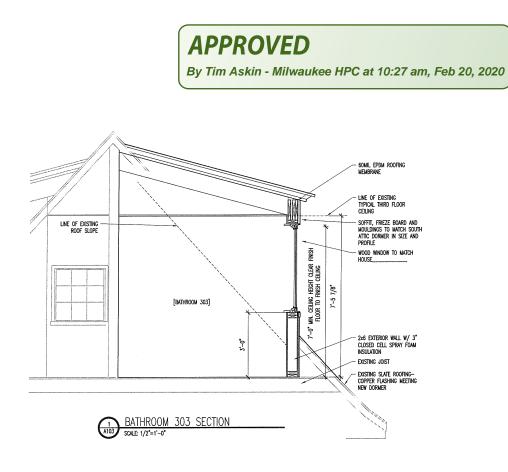
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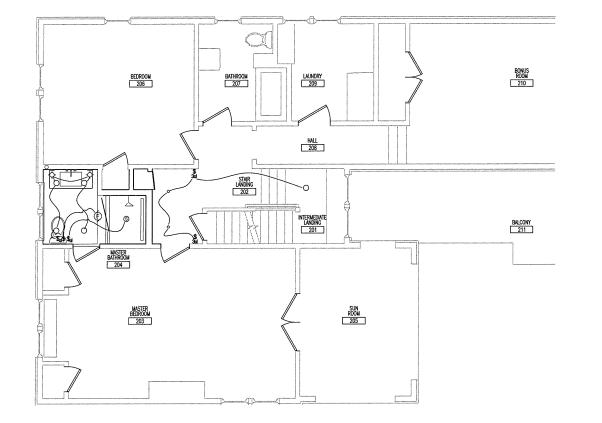
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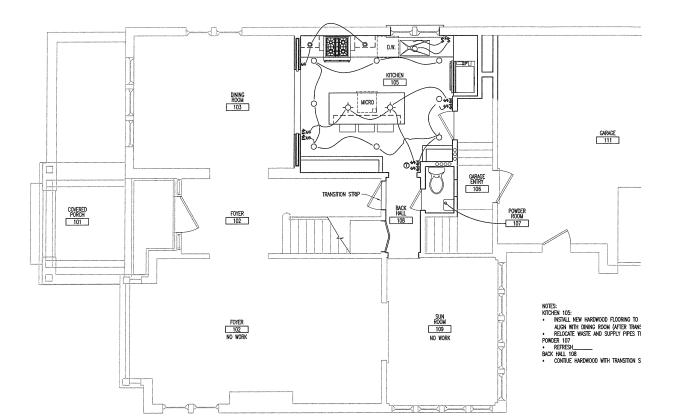


SHEET TITLE Existing/Demo Second Floor Plan, Second Floor Plan, Details


SECOND FLOOR REFLECTED CEILING PLAN








	APPR By Tim As		ED Ailwaukee HF	
LIGHT	ING AND RECEPTACLE SYMBOLS			
-¢-	DECORATIVE LIGHT FIXTURE	\$	SINGLE POLE WALL SWITC	
0	RECESSED PIN HOLE LED (MR16 SIZE)	\$ ₄	DIMMER SWITCH	
0	RECESSED, DIMABLE 4" CAN LIGHT, 3000K	\$3	3-WAY SWITCH	
	(SHALLOW HOUSING AS REQUIRED)	\$ S	3-WAY DIMMER SWITCH	
S	4" RECESSED SHOWER LIGHT W/ GLASS COVER (2700 tto 3000 K)	36 \$4	4-WAY SWITCH	
	LINEAR TRIMLESS, RECESSED. DIMMABLE 2" LED,			
•	RECESSED ADJUSTABLE LED - MR16 SIZE/ EQUIVALENT	\$4 4	4-WAY DIMMER SWITCH	
ю	DECORATIVE SCONCE	\$ _{5d} ©-	5-WAY DIMMER SWITCH	
	LED TAPE LIGHT FOR WALL WASHING/COVES.	-	MOTION DETECTOR SWITC	
	DIMMABLE	\$ ₁	TIMER SWITCH	
¢	EXHAUST FAN, CEILING MOUNTED		TELEVISION JACK, VERIFY LOCATION WITH OWNER. TELEPHONE	
0	UNDER CABINET LED LIGHT		DATA	
$\setminus \rho$		Ø	THERMOSTAT	
\sim	CEILING FAN	0	RECESSED JUNCTION BO	
%		KP	GARAGE DOOR KEYPAD	
(SP)	RECESSED CEILING SPEAKER- BY OWNER	6	RECESSED DOOR BELL C	
đ	WALL MOUNTED SPEAKER- BY OWNER	OB	DOOR BELL	
SP	RECESSED CEILING SPEAKER- BY OWNER	GDG	GARAGE DOOR OPENER	
	LINEAR LED LIGHT, WALL MOUNTED			
			CEILING ELEVATIONS	
Ľ	STEP LIGHT- ON ATOMIC CLOCK TIMER	8-0	8-6 1/2 (10-10 1/2	
	SURFACE MOUNTED LINEAR LED	10-0		
03	ELECTRICAL OUTLET - FLOOR MOUNTED DUPLEX	NOTES:		
0) 49	ELECTRICAL OUTLET - STANDARD DUPLEX ELECTRICAL OUTLET - BOTTOM HALF SWITCHED DUPLEX	1 EIVTI	RES TO BE SELECTED BY	
₩, ₩,	ELECTRICAL OUTLET - BOTTOM HALF SWITCHED DUPLEX -	2. ALL	AND RECEPTACLE PLAN P	
Ø.,	WATERPROOF ELECTRICAL OUTLET - WATERPROOF	COMPLIAN	ICE TO BE THE RESPONSIE	
	DEDICATED EQUIPMENT OUTLET - VERIFY W/ MANUF.	AND INSTALLER 3. ALL FLOOR OUTLET & WALL SCO DETERMINED ON SITE BY ARCHITECT 4. ALL BOXES & PENETRATIONS OF		
#	ELECTRICAL OUTLET - FOUR GANG			
¢ _{GF1}	ELECTRICAL OUTLET - GROUND FAULT CIRCUIT	FULLY W	ATERPROOF	
	ELECTRICAL DUTLET - FLOOR MOUNTED DUPLEX			

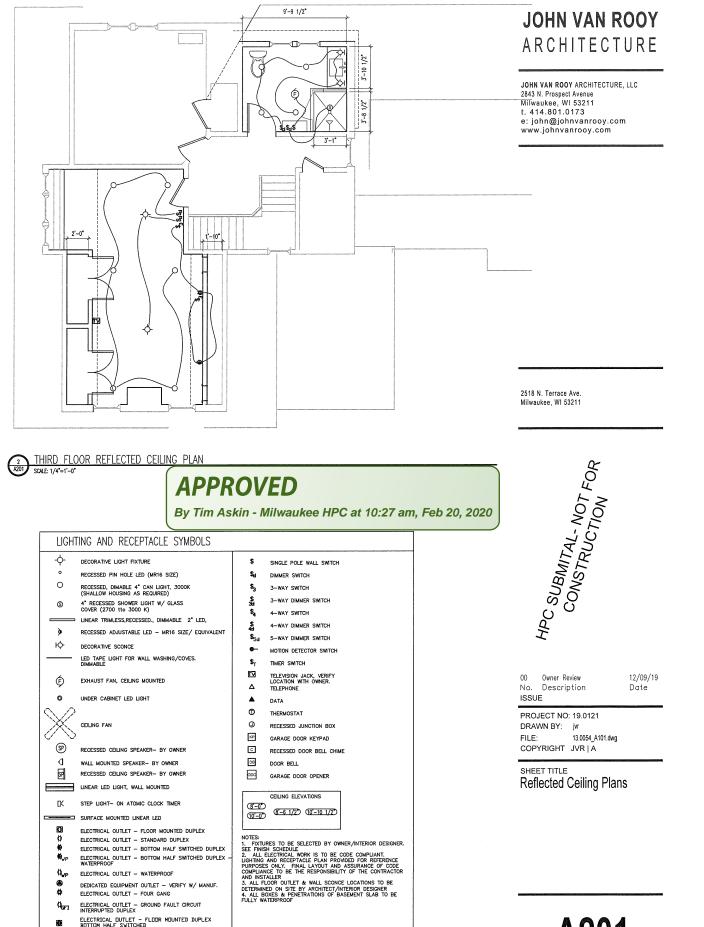

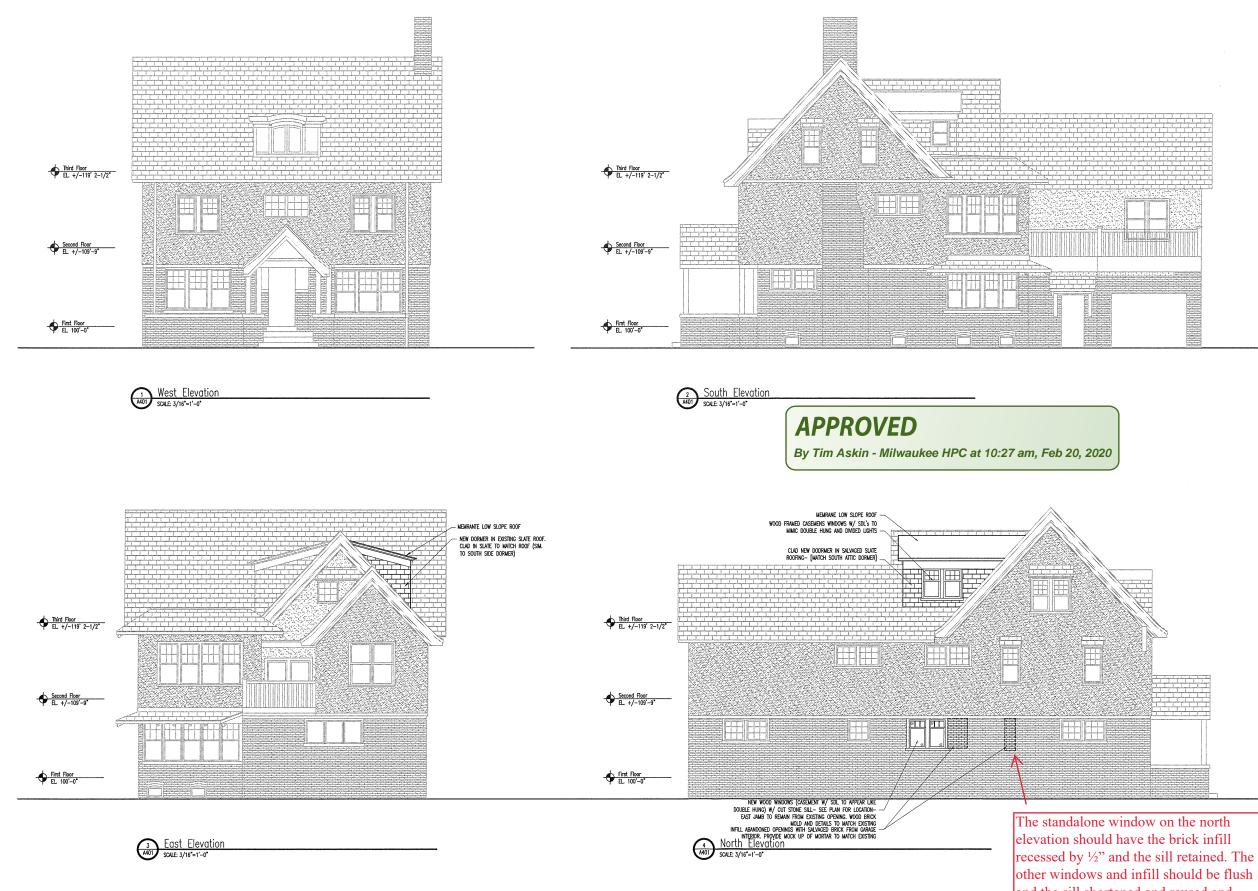

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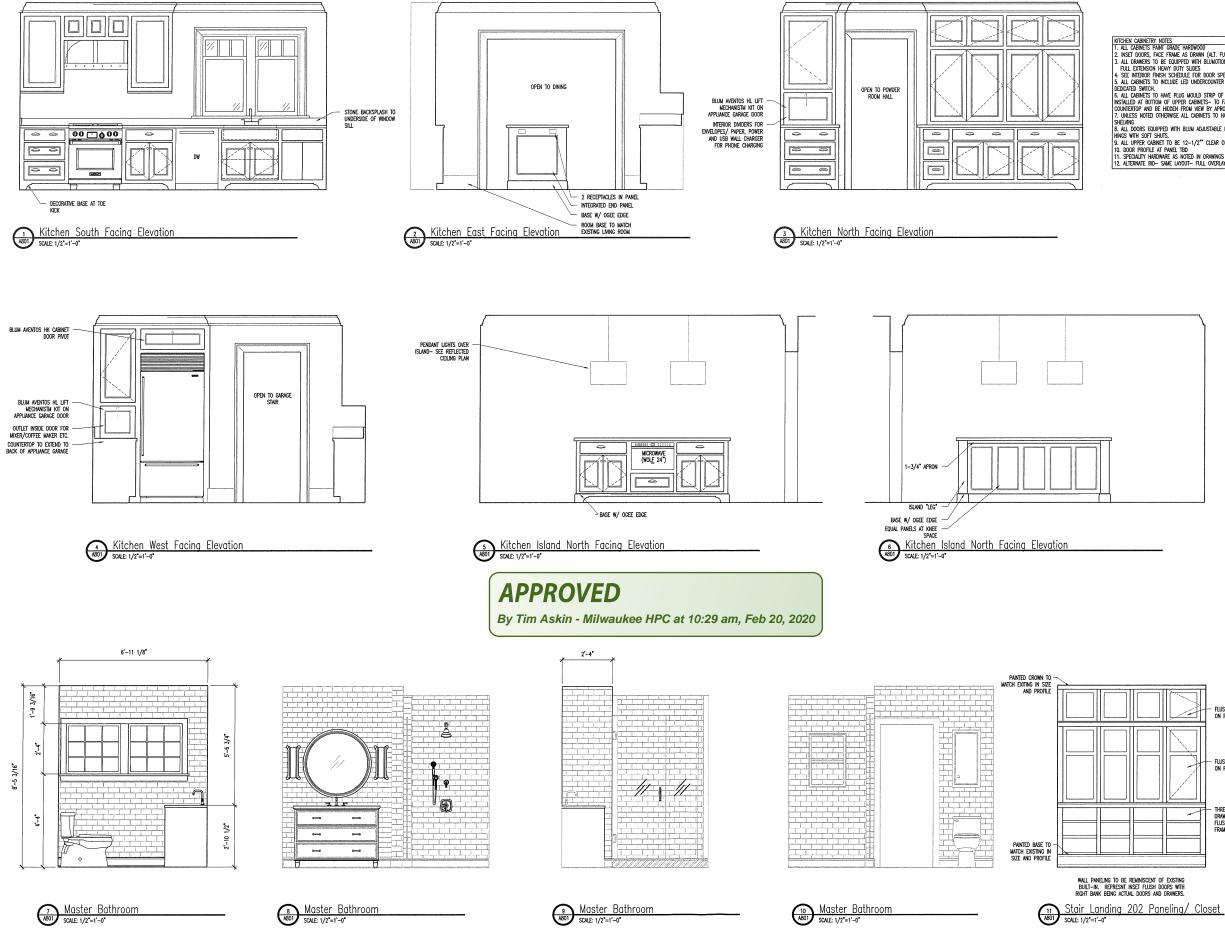
and the sill shortened and reused and shortened to match the replacement

window width..



	Owner Review Description	12/09/19 Date			
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	JECT NO: 19.0121 WN BY: jvr				
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SHEET TITLE Exterior Elevations



KITCHEN CASINETRY NOTES 1. ALL CASINETS PAINT GRADE HARDWOOD 2. INSET DOORS, FACE FRAME AS DRAWN (ALT. FULL OVERLAY) 3. ALL DRAWNEST DO BE COLIPPOED WITH BLUWDION SOFT SAUT, FULL DYTENSION HEAVY DUTY SLOES 4. SEE INTERIOR FINISH SCHEDULE FOR DOOR SPECIES & FINISH 5. ALL CASINETS TO INCLUE LED LINDERCOUNTER LISHTING ON DEDICATED WITCH. 6. ALL CASINETS TO THAVE PLUG MOULD STRIP OF OUTLETS INSTALLED AT BOTTOW OF UPPER CASINETS- TO FACE COUNTERTOF AND BE HIDDEN FROM VIEW BY APRON. 7. UNLESS MOTOS 9. ALL UPPER CASINET. 1. SPECALTY HARDWARE AS NOTED IN DRAWINGS 12. ALTERNATE BID- SAWE LATOUT- FULL OVERLAY CASINETS

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SHEET TITLE Interior Elevations

FLUSH DOOR ON POP LATCH Flush door on pop latch - THREE STACKED DRAWERS--FLUSH-- INSET FRAME

WALL PANELING TO BE REMINISCENT OF EXISTING BUILT-IN. REPRESINT INSET FLUSH DOORS WITH RIGHT BANK BEING ACTUAL DOORS AND DRAWERS.