

LIVING WITH HISTORY

Property Description of work

Certificate of Appropriateness

Milwaukee Historic Preservation Commission/200 E. Wells Street/Milwaukee, WI 53202/phone 414-286-5712/fax 414-286-3004

1139 E. KNAPP ST.First Ward Triangle HD

Description of work At the rear of the North elevation on the West facade of the building, the clapboard and aluminum-framed glazed windows that form the enclosed porch at the first and second stories will be removed. Also, the secondary chimney will be removed (not visible from the North or East stree elevations) and the terracotta and brick from its deconstruction will be utilized for infill throughout the project. At the North/West facades, voids in the masonry left by door removal will be infilled with salvaged brick to match existing conditions. Extant brick will be cleaned of paint and new stone banding will reproduce the surrounding conditions. The IBC compliant exit stair will be removed in the demolition phase. The existing wood fence will be extended to enclose garbage and HVAC condensers. The chimney stack will be removed as it is not visible from the North elevation street level. Newly exposed brick as a result of the removal of this addition will be cleaned of paint and tuckpointed where needed. Matching salvaged brick will be utilized to infill openings in the masonry wall to accommodate the installation of newly replicated windows. Masonry repairs and cleaning within the area behind the demolished section are EXCLUDED from this approval because of the necessity of a separate permitting process. Hand scraping of paint for initial removal with low pressure water (<200psi at nozzle) is allowed under this approval.

Additionally, the West dormer metal gable finials and crockets will be restored/replicated appropriately. Newly cut stone lintels/belt courses and stone masonry will match historic conditions.

Date issued

2/20/2020

PTS ID 114898 COA north and west elevation restoration

In accordance with the provisions of Section 320-21 (11) and (12) of the Milwaukee Code of Ordinances, the Milwaukee Historic Preservation Commission has issued a certificate of appropriateness for the work listed above. The work was found to be consistent with preservation guidelines. The following conditions apply to this certificate of appropriateness:

1. Paint removal from masonry requires a separate building permit and separate COA for any method other than gentle hand-scraping. Staff is prepared to handle such an approval without a return to the Commission. Expectations are below for reference

2. Masonry cleaning conditions

Abrasive cleaning methods are prohibited on historic buildings by Wisconsin state law. Exceptions can only be granted in writing by the Wisconsin Historical Society. Chemical and power-washing are acceptable methods of cleaning that the city can approve.

3. Standard masonry conditions.

New mortar must match the original mortar in terms of color, texture, grain size, joint width, and joint finish/profile. The compressive strength of the repointing mortar shall be equal or less than the compressive strength of the original mortar and surrounding brick or stone. The replacement mortar shall contain approximately the same ingredient proportions of the original mortar. Mortar that is too hard is subject to premature failure and could damage the masonry. See the city's books As Good As New or Good for Business, Masonry Chapters, for more information. In most cases, this means a lime mortar with natural hydraulic cement rather than Portland cement. No joint of a width less than 3/8" may be cleaned of damaged/decomposed mortar with power disc grinders. No over-cutting of the joints is permitted. Remove decomposed mortar back into the wall 2.5 times the height of the joint before repointing.

New brick must match as closely as possible the color texture, size, and finish of the original brick.


A sample panel of brick and mortar must be reviewed and approved by HPC staff prior to general installation of the material. UNDER NO CIRCUMSTANCES SHALL UNPAINTED MASONRY BE PAINTED, BE GIVEN A WATERPROOFING TREATMENT, OR CLEANED BY ABRASIVE MEANS; THIS STATEMENT SUPERSEDES ANY OTHER WORDING IN THIS DOCUMENT INDICATING THE CONTRARY.

All work must be done in a craftsman-like manner, and must be completed within one year of the date this certificate was issued. Staff must approve any changes or additions to this certificate before work begins. Work that is not completed in accordance with this certificate may be subject to correction orders or citations. If you require technical assistance, please contact Historic Preservation staff as follows: Phone: (414) 286-5712 E-mail: hpc@milwaukee.gov.


If permits are required, you are responsible for obtaining them from the Milwaukee Development Center. If you have questions about permit requirements, please consult the Development Center's web site, <u>www.milwaukee.gov/build</u>, or call (414) 286-8210.

m ans


City of Milwaukee Historic Preservation Staff Copies to: Development Center, Ald. Robert Bauman, Contractor, Inspector John Cunningham (286-2538)

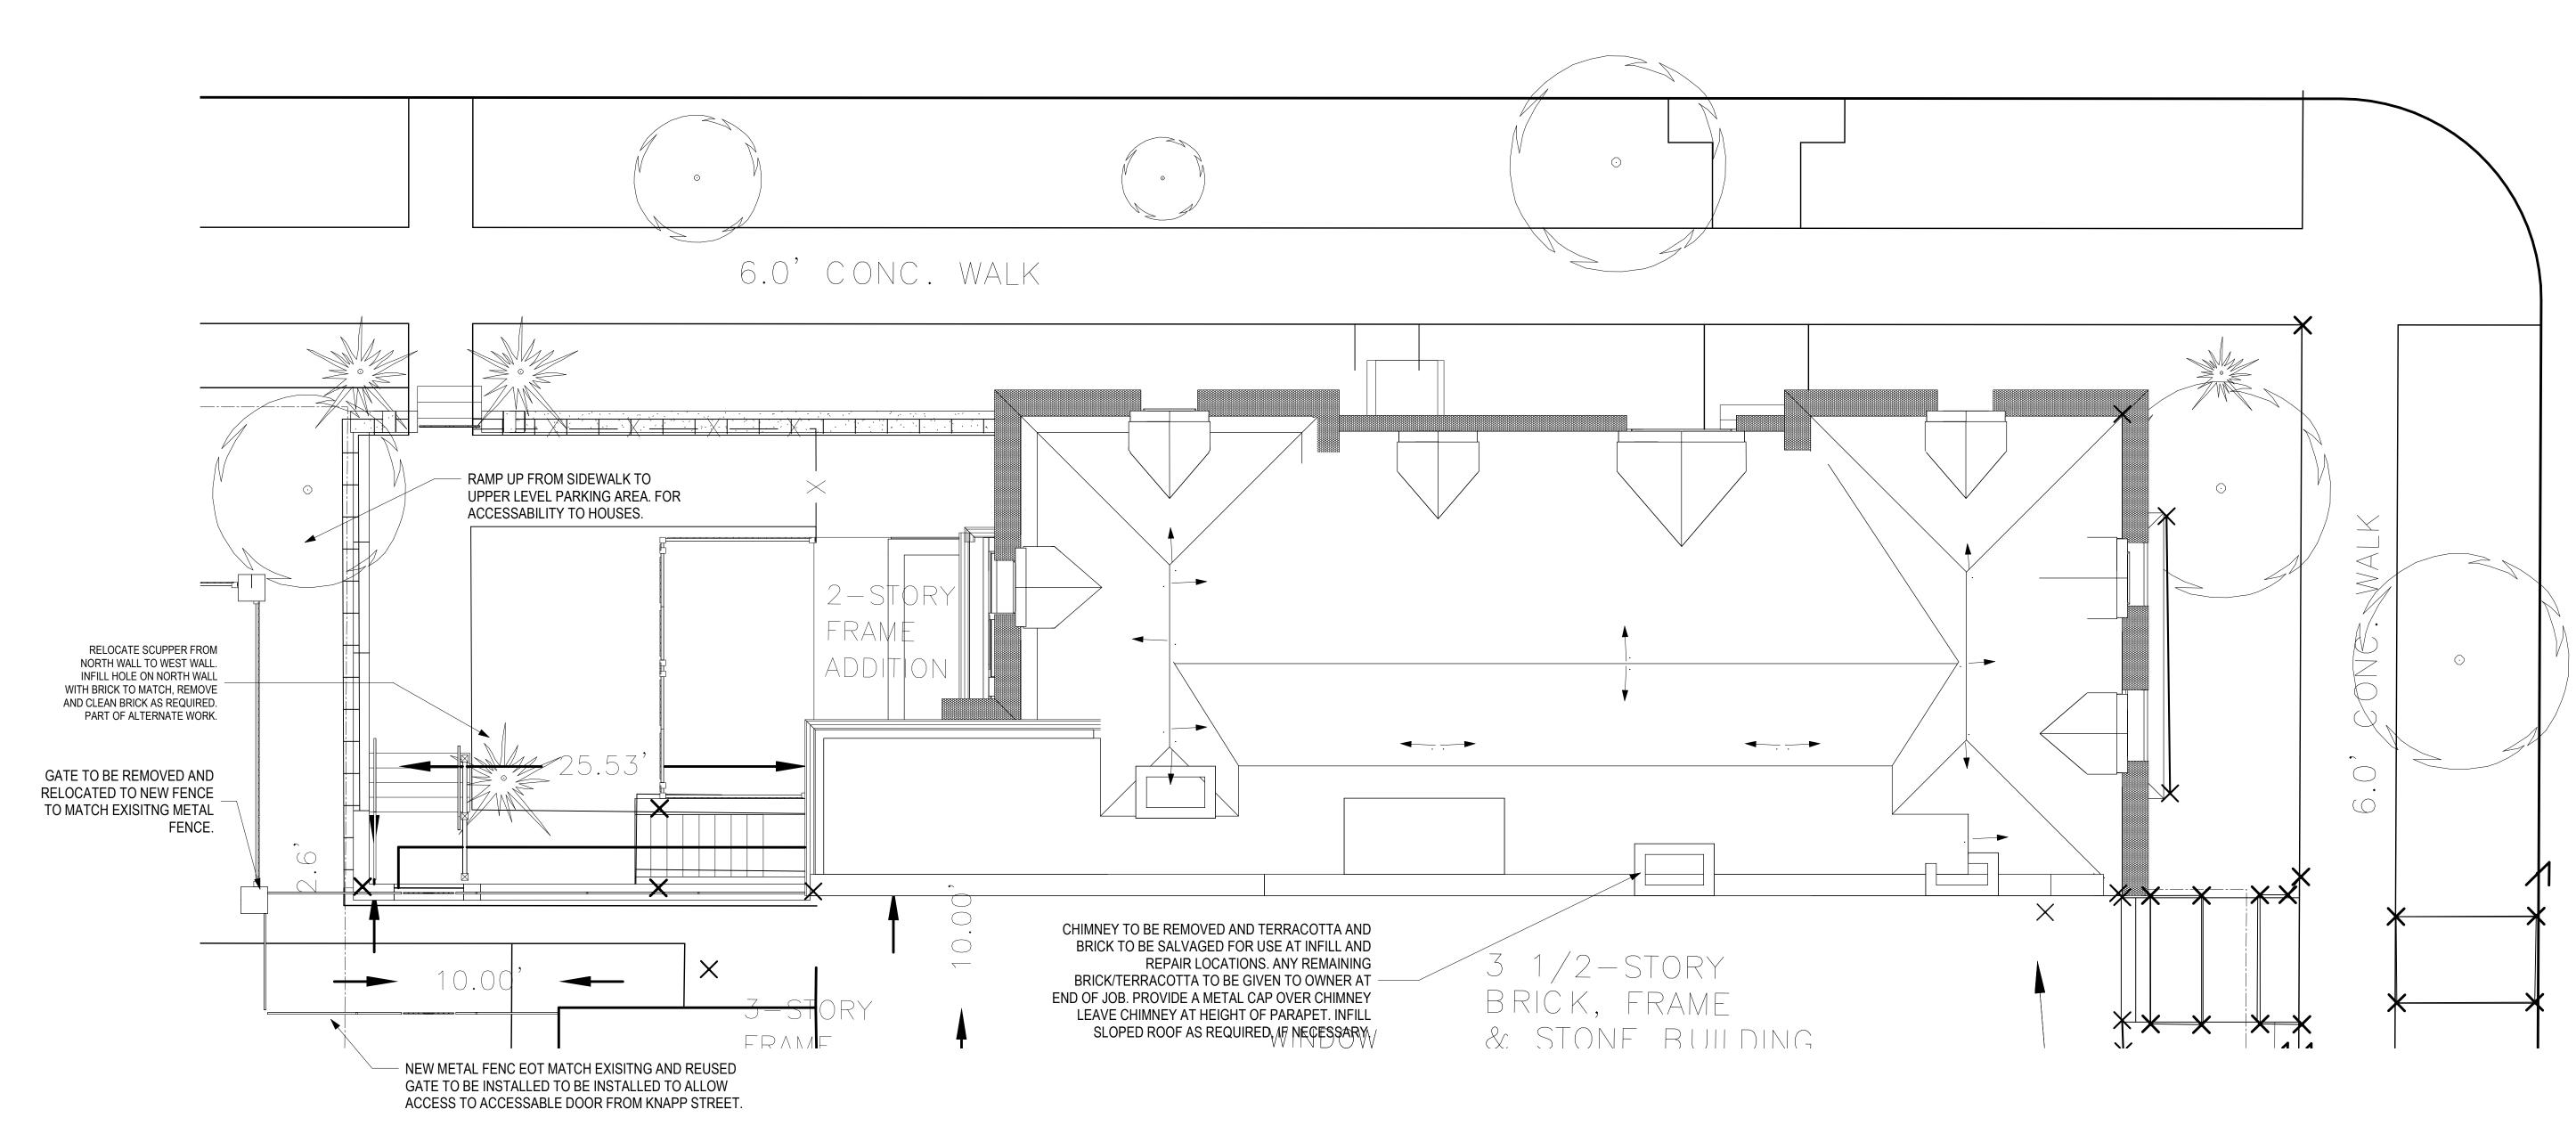


8 PHASE 1 - ROOF PLAN AND SITE PLAN 3/16" = 1'-0"

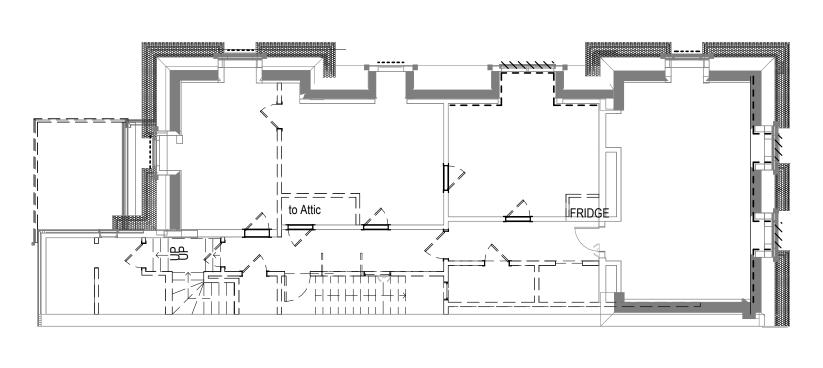

14 PHASE 1 - THIRD LEVEL 3/32" = 1'-0"

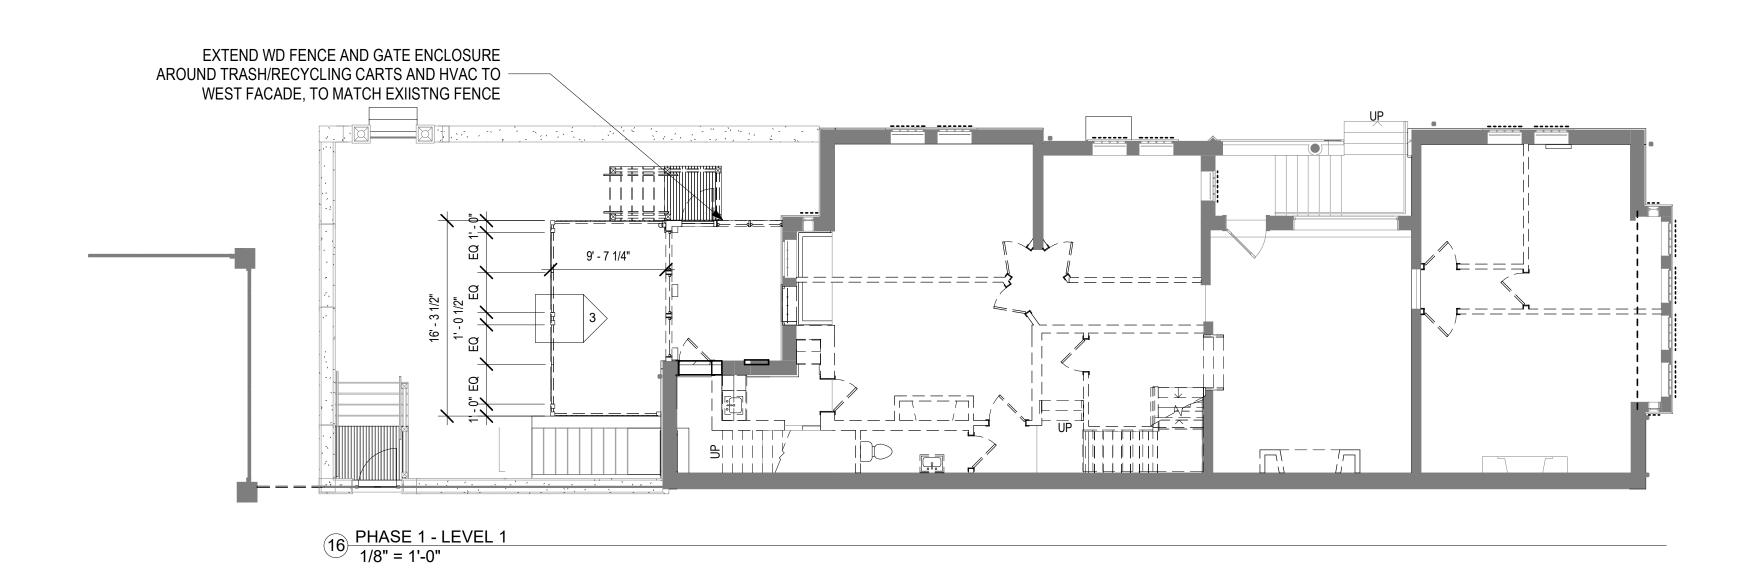

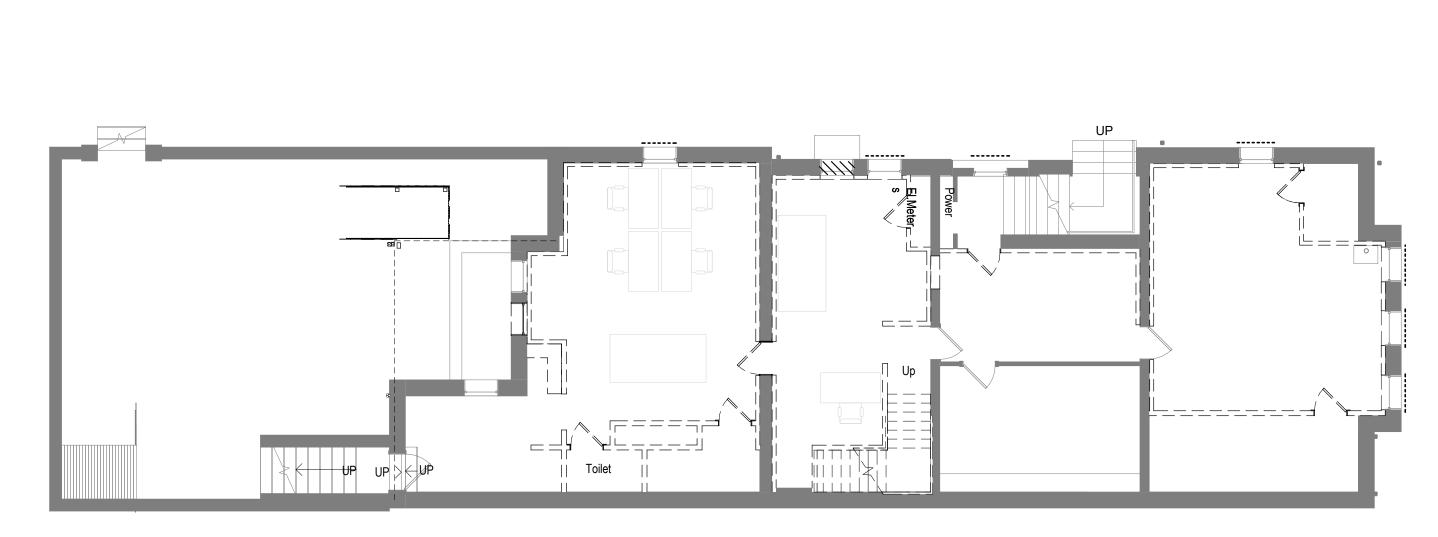

1 PHASE 1 - GARDEN LEVEL 1/8" = 1'-0"

3

DESIGN BUILD PLUMBING, HVAC AND **ELECTRICAL SYSTEM GENERAL NOTES:**


1. PROVIDE A DESIGN BUILD FIRE ALARM SYSTEM THROUGH-OUT THE BUILDING, MANUFACTURER - NOTIFIER. DESIGNED BY FIRE DETECTION GROUP. ALL CONDUIT RUNS TO BE CONCEALED, IF ANY CONDUIT IS EXPOSED IT NEEDS TO BE EVALUATED WITH THE ARCHITECT IN THE FIELD BEFORE INSTALLATION. COORDINATE LOCATIONS WITH ARCHITECT FOR ALL DEVICES ON SITE.

2. PROVIDE A DESIGN BUILD PLUMBING, ELECTRICAL AND HVAC SYSTEM


DEMOLITION GENERAL NOTES:

- ---- REMOVE PLASTER & INSTALL 5/8" GYP BD, SHIM AS REQUIRED. REPAINT ENTIRE ROOM & CEILING
- REMOVE WINDOW SASH, FRAME, AND CASING. SAVE CASING FOR REINSTALLATION IF POSSIBLE.
- REPLACE SASH ONLY TO MATCH EXISTING PROFILES. USE 1/2" INSULATED GLASS.

APPROVED By Tim Askin - Milwaukee HPC at 9:41 am, Feb 20, 2020

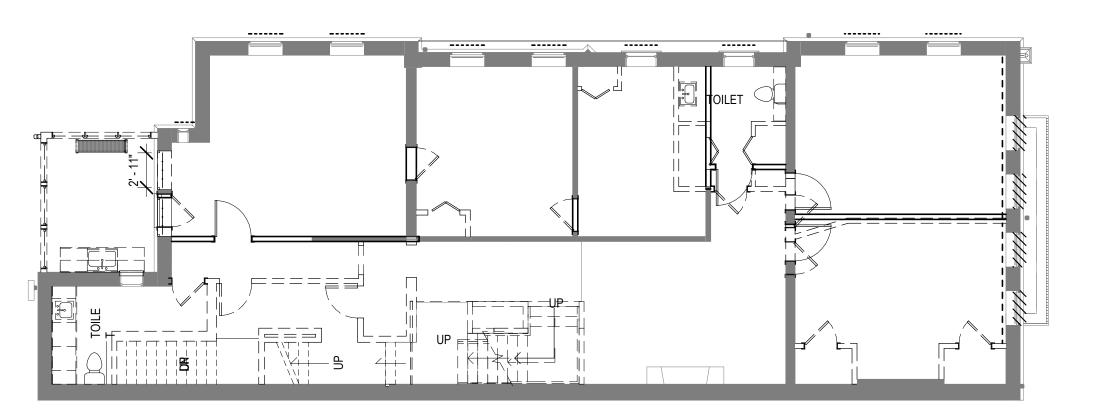

2 PHASE 1 - SECOND LEVEL 1/8" = 1'-0"

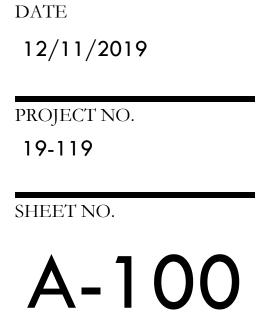





© UIHLEIN/WILSON - RAMLOW/STEIN ARCHITECTS, INC. ALL RIGHTS RESERVED OWNERSHIP OF DOCUMENTS This document, and the ideas and designs incorporated herein, as an instrument of professional service, is the sole property of Uihlein/Wilson - Ramlow/Stein Architects, Inc., and is not to be used in whole or in part for any other project or purpose without the expressed written authorization of Uihlein/Wilson - Ramlow/Stein Architects, Inc. REVISIONS No. Date: Description:

UIHLEIN | WILSON RAMLOW STEIN ARCHITECTURE I DESIGN I PLANNING 322 East Michigan Street Milwaukee, WI 53202 414.271.8899 office@uihlein-wilson.com

www.uihlein-wilson.com



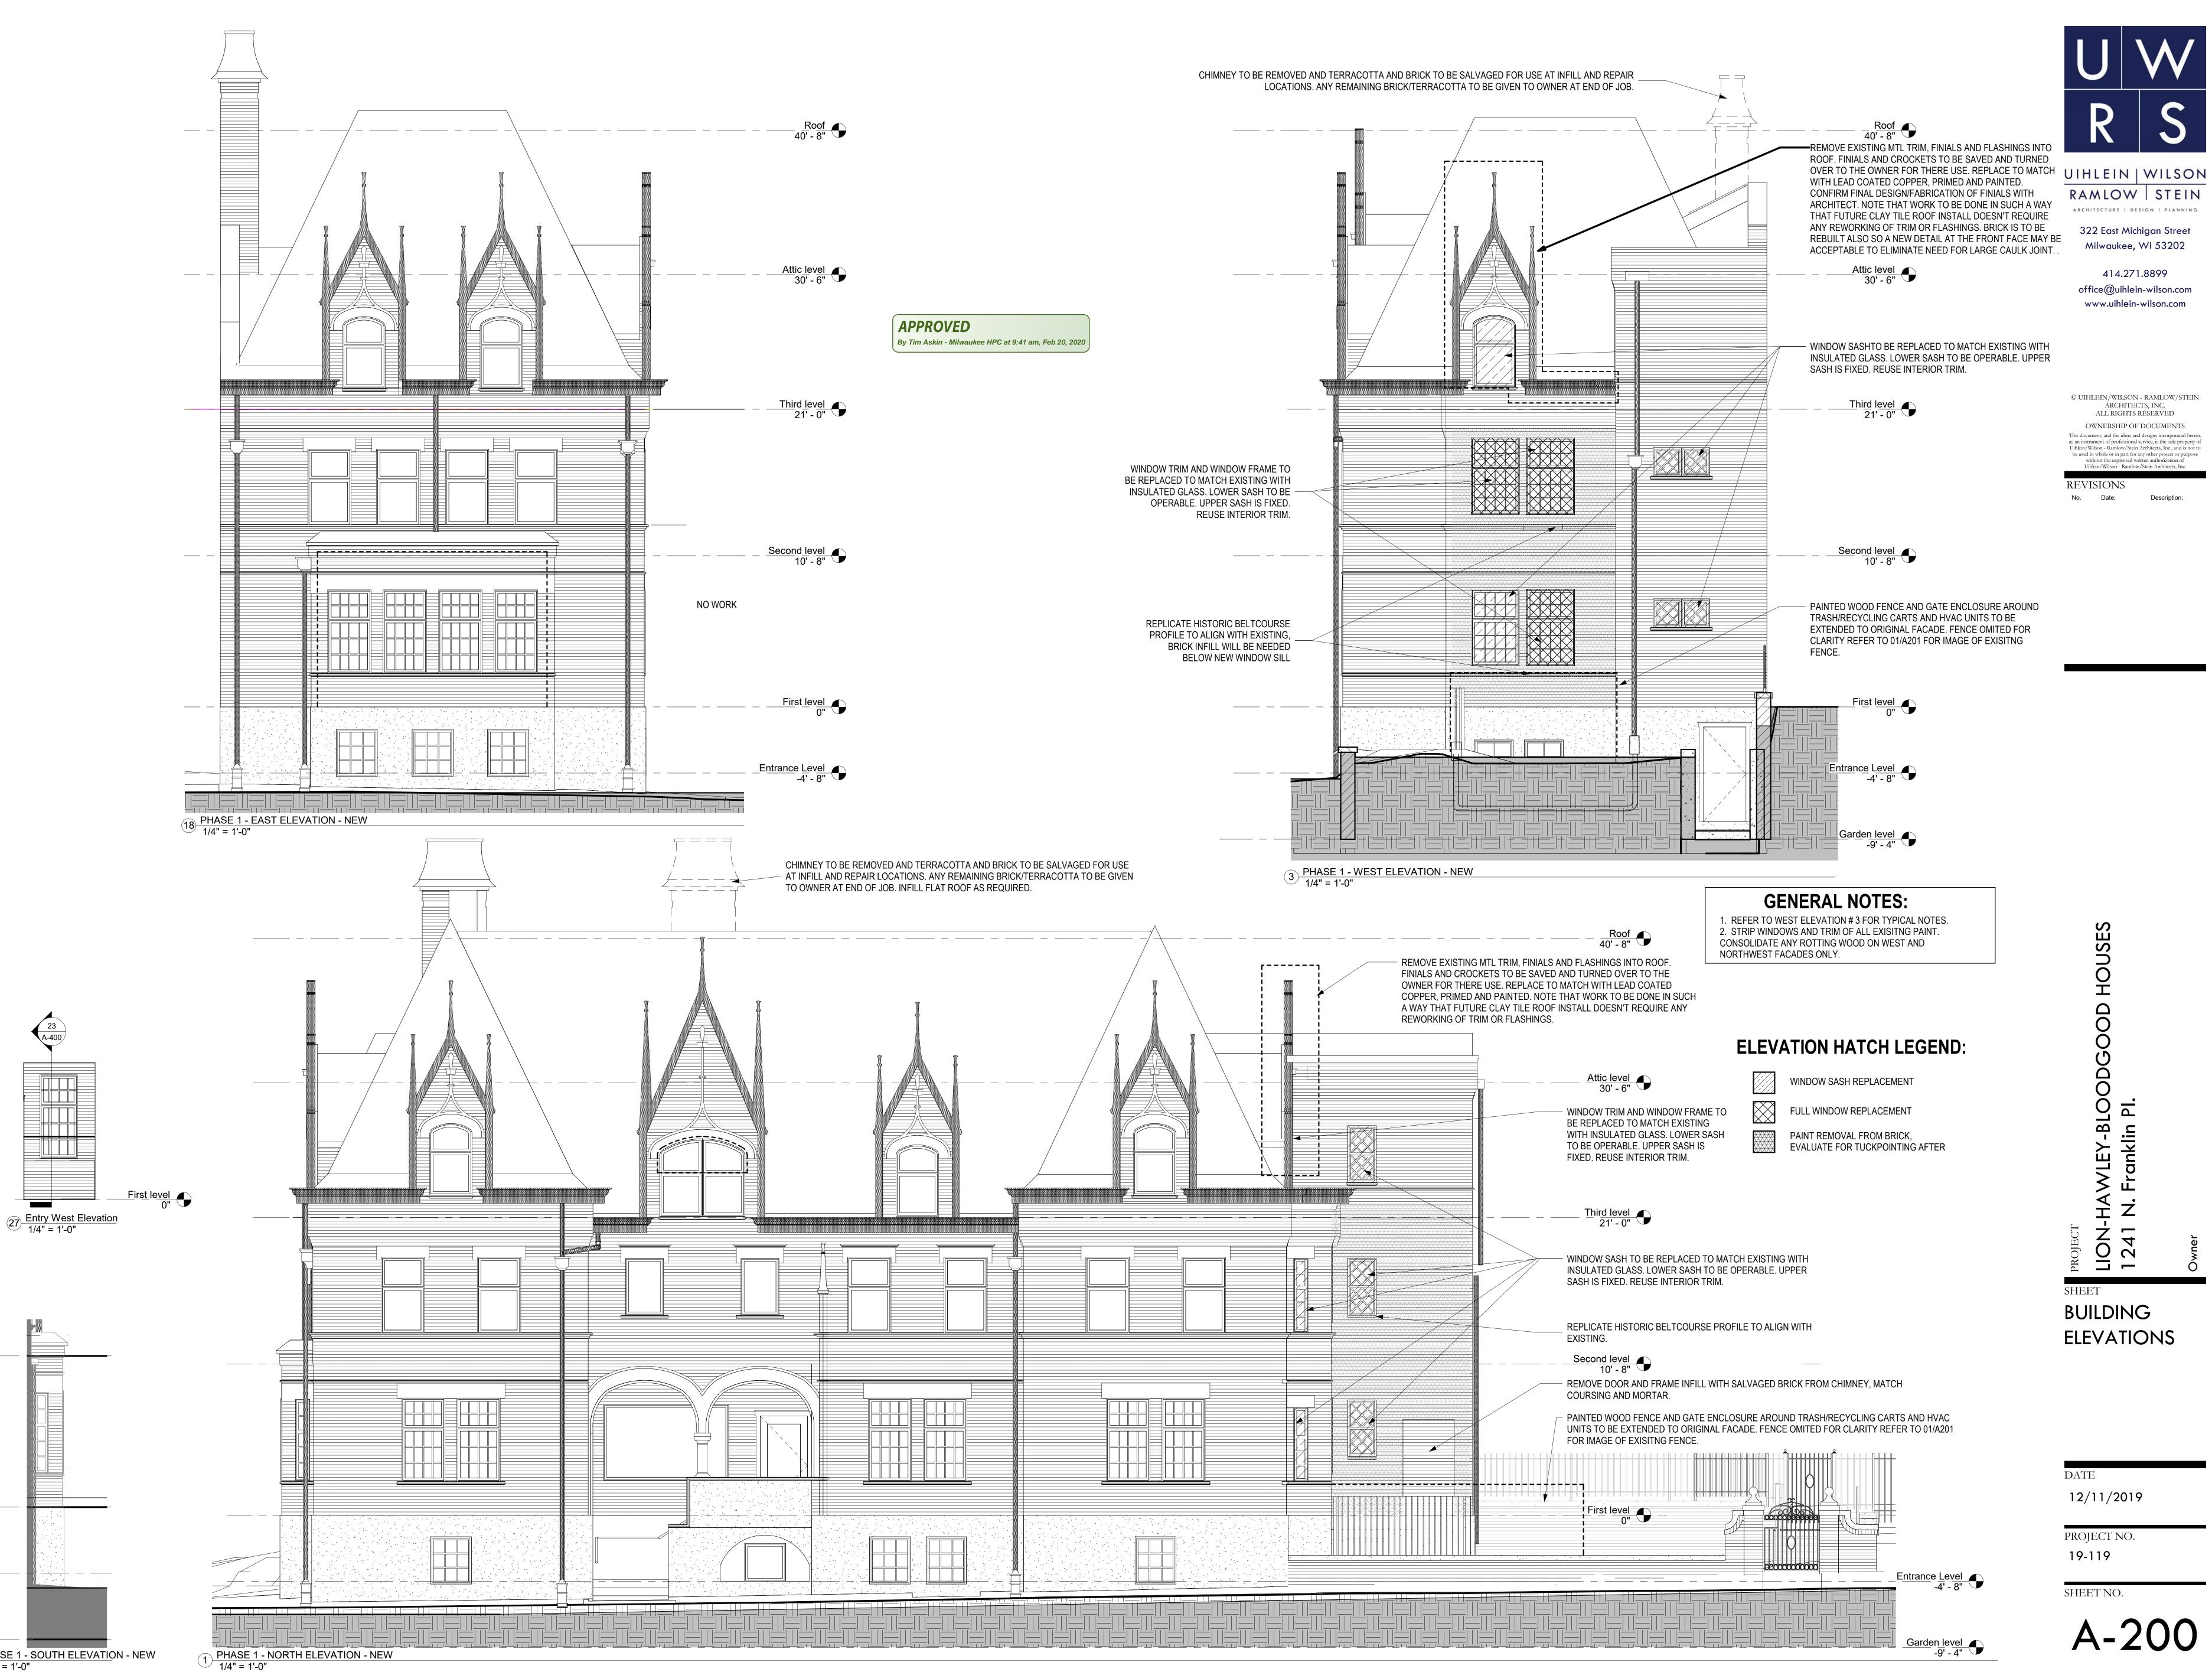

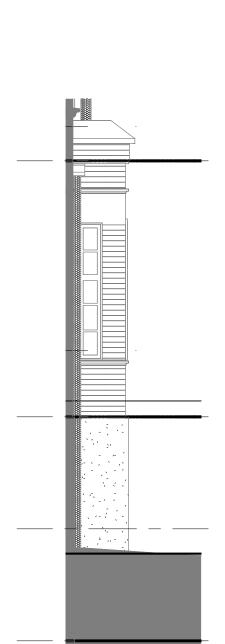

A-400

26 PHASE 1 - SOUTH ELEVATION - NEW 1/4" = 1'-0"



414.271.8899 office@uihlein-wilson.com www.uihlein-wilson.com

© UIHLEIN/WILSON - RAMLOW/STEIN ARCHITECTS, INC. ALL RIGHTS RESERVED OWNERSHIP OF DOCUMENTS This document, and the ideas and designs incorporated herein, as an instrument of professional service, is the sole property of Uihlein/Wilson - Ramlow/Stein Architects, Inc., and is not to be used in whole or in part for any other project or purpose without the expressed written authorization of Uihlein/Wilson - Ramlow/Stein Architects, Inc REVISIONS

No. Date:

Description:

USES BLO ٦ ۲-B| klin LION 1241 SHEET BUILDING ELEVATIONS

DATE 12/11/2019 PROJECT NO. 19-119 SHEET NO. A-200

-REPLACE ROTTEN STORM WINDOWS TO MATCH EXISTING WOOD AND GLASS STORMS.




HAWLEY HOUSE 18 EAST ELEVATION - EXISTING 1/4" = 1'-0"

APPROVED By Tim Askin - Milwaukee HPC at 9:41 am, Feb 20, 2020


ALL PAINT TO BE STRIPPED FROM MASONRY, EVALUATE NEED FOR TUCKPOINTING AFTER REMOVAL IS COMPLETE, TYPICAL OF 1ST AND 2ND FLOOR, SEE ELEVATIONS

REPLICATE HISTORIC WINDOW AFTER THE REMOVE DOOR AND FRAME, INSTALL A NEW CUSTOM WINDOW TO MATCH EXISTING FRAME PROFILES AND SASH WINDOW TO BE OPERATIONAL DOUBLE HUNG. WOOD PSECIES TO MATCH WOOD SPECIES OF ADJACENT WINDOW (MAHOGONY).

REPLICATE HISTORIC BELTCOURSE PROFILE TO ALIGN WITH EXISTING, BRICK INFILL WILL BE NEEDED BELOW NEW WINDOW SILL

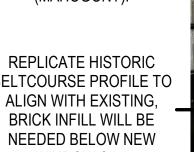

SOUTHWEST ELEVATION

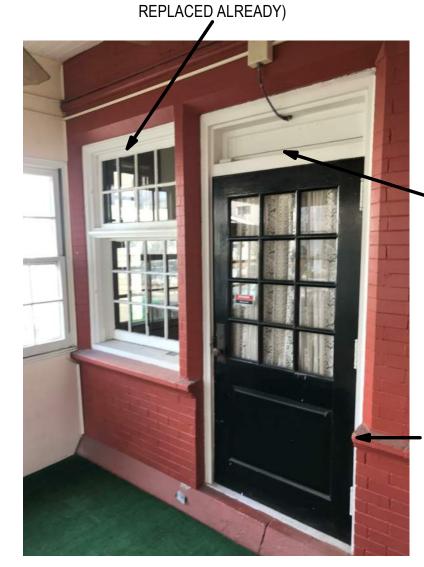

WINDOW TO REMAIN. REPLACEMNT SASH WITH 1/2"

INSULATED GLASS TO BE INSTALLED, REPAIR WOOD

FRAME AS REQUIRED. (THIS WILL MATCH THE REST OF

THE WINDOWS SASH IN THE HOUSE THAT WERE

WEST ELEVATION INTERIOR ELEVATIONS - WEST AND SOUTH WALLS OF PORCH - FIRST 16 FLOOR 1/16" = 1'-0"

BLOODGOOD HOUSE

3 NORTH ELEVATION - EXISTING 1/4" = 1'-0"

Masonry cleaning must be approved separately because of environmental permitting process. Only hand scraping is permitted under this approval.

> WINDOWS TO REMAIN. REPLACEMNT SASH WITH 1/2" INSULATED GLASS TO BE INSTALLED, REPAIR WOOD FRAME AS REQUIRED. (THIS WILL MATCH THEN THE REST OF THE WINDOWS SASH IN THE HOUSE REPLACED ALREADY)

APPROPRIATLY DISCONNECT DATA AND POWER, REMOVE WIRING AND PATCH HOLES WITH APPROVED MASONRY PATCHING COMPOUND, TYP.

FLOORING AND CEILING TO BE REMOVED, TYP.

REMOVE DOOR AND FRAME AND INFILL WITH BRICK TO MATCH EXISITNG BRICK (REUSE BRICK SALVAGED FROM CHIMNEY REMOVAL), MATCH COURSING AND MORTAR



SOUTH ELEVATION

NORTH ELEVATION



NORTH AND WEST ELEVATION -1 <u>EXISTING PORCH</u> 1/4" = 1'-0"



DORMER ORNAMENTAL METAL WORK TO BE REPLACED TO MATCH EXISITNG WITH MISSING THIS WORK WILL MATCH THE PREVIOUS ORNAMENTAL METAL WORK REPLACED ON REST OF FACADES. WINDOW IN DORME TO HAVE REPLACEMENT SASH WITH 1/2" INSULATED GLASS INSTALLED.

2 STORY WOOD CLAPPBOARD SIDED PORCH ADDITION ENCLOSED WITH WINDOWS TO BE REMOVED TO EXPOSE ORIGINAL EXTERIOR OF HOUSE.

DORMER ORNAMENTAL METAL WORK TO BE REPLACED TO MATCH EXISITNG WITH MISSING THIS WORK WILL MATCH THE PREVIOUS ORNAMENTAL METAL WORK REPLACED ON REST OF FACADES. WINDOW IN DORME TO HAVE REPLACEMENT SASH WITH 1/2" INSULATED GLASS INSTALLED.

2 STORY WOOD CLAPPBOARD SIDED PORCH ADDITION ENCLOSED WITH WINDOWS TO BE REMOVED TO EXPOSE ORIGINAL EXTERIOR OF HOUSE.

WINDOWS TO REMAIN. REPLACEMNT SASH WITH 1/2" INSULATED GLASS TO BE INSTALLED, REPAIR WOOD FRAME AS REQUIRED. (THIS WILL MATCH THEN THE REST OF THE WINDOWS SASH IN THE HOUSE REPLACED ALREADY)

FENCE TO BE EXTENDED BACK TO TEHE ORIGINAL HOUSE FACADE TO ENCLOSE TRASH COLLECTION AND HVAC CONDENSING UNITS.





PROJECT NO.

19-119

SHEET NO.

A-201

Milwaukee, WI 53202 414.271.8899 office@uihlein-wilson.com www.uihlein-wilson.com

© UIHLEIN/WILSON - RAMLOW/STEIN

ARCHITECTS, INC.

ALL RIGHT'S RESERVED

OWNERSHIP OF DOCUMENTS This document, and the ideas and designs incorporated herein as an instrument of professional service, is the sole property of Uihlein/Wilson - Ramlow/Stein Architects, Inc., and is not to be used in whole or in part for any other project or purpose without the expressed written authorization of Uihlein/Wilson - Ramlow/Stein Architects, Inc.

Description:

REVISIONS

No. Date:

322 East Michigan Street

UIHLEIN | WILSON RAMLOW | STEIN ARCHITECTURE I DESIGN I PLANNING



17 HISTORIC PHOTOGRAPH - FINIALS 1/2" = 1'-0"



BLOODGOOD HOUSE WITH CLAY TILE ROOF. 3 HISTORIC PHOTOGRAPH - CLAY TILE 1/2" = 1'-0"



HISTORIC PHOTOGRAPH - EXISTING CONDITIONS 1/2" = 1'-0"



12/11/2019

PROJECT NO.

19-119

Y-BLO Iklin Pl. Р. 24 SHEET HISTORIC PHOTO OF EAST AND NORTH ELEVATIONS DATE

USES

Т

© UIHLEIN/WILSON - RAMLOW/STEIN ARCHITECTS, INC. ALL RIGHTS RESERVED OWNERSHIP OF DOCUMENTS This document, and the ideas and designs incorporated herein, as an instrument of professional service, is the sole property of Uihlein/Wilson - Ramlow/Stein Architects, Inc., and is not to be used in whole or in part for any other project or purpose without the expressed written authorization of Uihlein/Wilson - Ramlow/Stein Architects, Inc. REVISIONS No. Date: Description:

322 East Michigan Street Milwaukee, WI 53202 414.271.8899 office@uihlein-wilson.com www.uihlein-wilson.com

