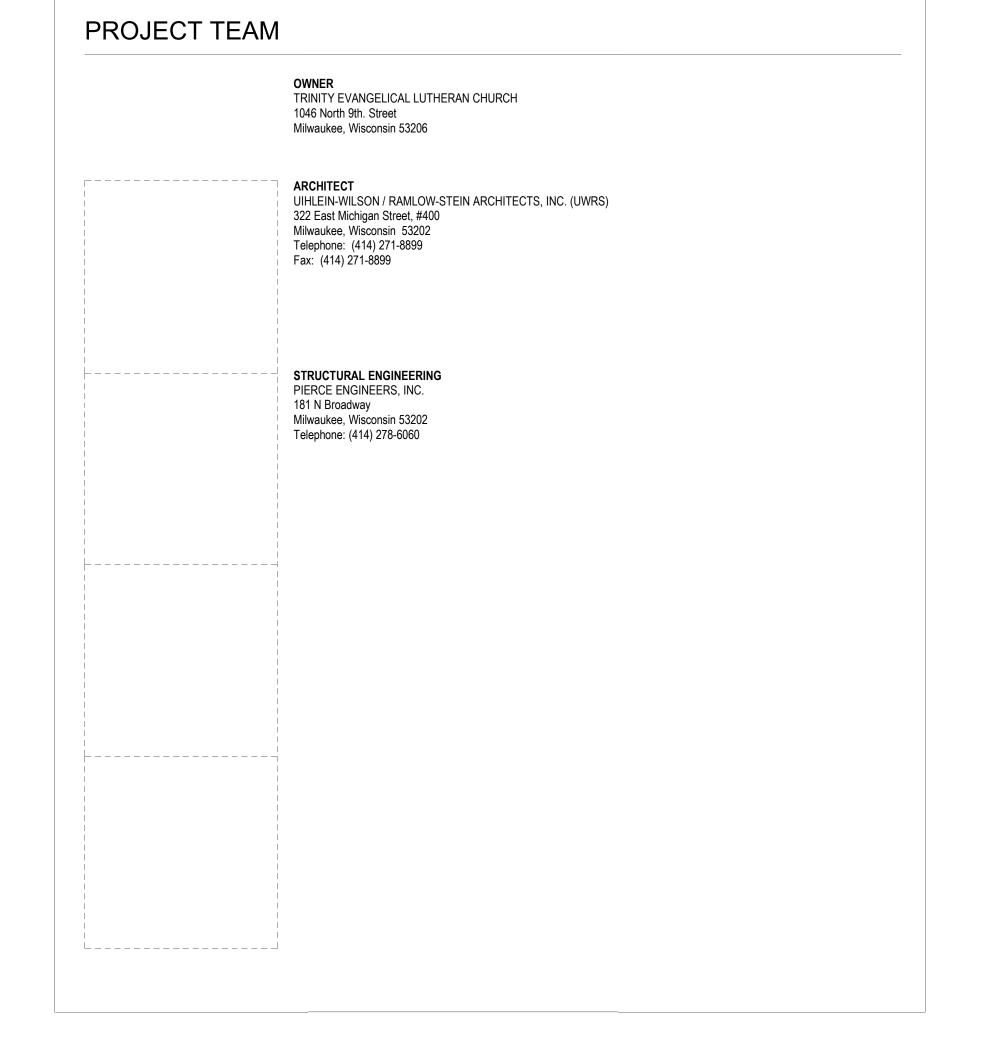


TRINITY EVANGELICAL LUTHERAN CHURCH RESTORATION

09/21/2018

1046 N 9TH ST, MILWAUKEE WI 53206

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TITLE SHEET

18-122

09/21/2018

PROJECT NO. 18-122

ANGLE

ACP

ACT

ANOD

APPROX

ARCH

ASB

B-B

BLDG

BLKG

BOS

BRG

BSMT

BUR

CBP

C/C

CFOI

CG-S CG-W

CJ

CLG

CLR CM

CMU

COL

CONC

CONST

CONT

CORR

CSMT

CTR CTSK CU

ELECT

EQUIP

ETR

FOC

FURN

GAL GALV

GWB

HVACC

CPT

CONTR

BLK

PERCENT

ANCHOR BOLT

ACOUSTICAL

AREA DRAIN

ADJUSTABLE

ALTERNATE

ALUMINUM

ANODIZED

ASBESTOS

ASPHALT

APPROXIMATE(LY)

ARCHITECT(URAL)

BACK TO BACK

BULLETIN BOARD

BOARD/BEAD

BOTH FACES

BITUMINOUS

BUILDING

BLOCKING

BEARING

BRICK

BENCH MARK

BACK SPLASH

BUILT UP ROOF

BOTH WAYS

CHANNEL

CABINET

CERAMIC

BASEMENT

BOTTOM

BOTTOM OF STEEL

BRITISH THERMAL UNIT

CATCH BASIN/CORNER BEAD

CORNER GUARD STAINLESS STEEL

CHAIR RAIL/COAT RACK/COLD ROLLED

CORNER GUARD WOOD LOOK

CONCRETE MASONRY UNIT

CONTRACTOR FURNISHED, OWNER INSTALLED

CHALK BOARD PAINT

CENTER TO CENTER

CORK FLOORING

CORNER GUARD

CONTROL JOINT

CENTER LINE

CENTIMETER

COLUMN

CONCRETE

CONSTRUCTION

CONTINUOUS

CONTRACTOR

CORRUGATED

CASEMENT

COUNTERSUNK

DRINKING FOUNTAIN

DITTO/DOOR OPENING

ELEVATION/ELEVATOR

EXISTING TO REMAIN

ELECTRIC WATER COOLER

FIRE ALARM/FORCED AIR/FRESH AIR

ETHYLENE PROPYLENE DIENE MONOMER

DOUBLE HUNG

DIAMETER

DIAGONAL

DIMENSION

DISPENSER

DOWNSPOUT DETAIL

DRAWING

EXISTING

ELECTRIC(AL)

EPOXY PAINT

EQUIPMENT

EACH WAY

EXHAUST

EXISTING EXPANSION

EXTERIOR

FLOOR DRAIN

FOUNDATION

FACE TO FACE

FINISHED

FIXTURE

FLOW LINE FLOOR

FLUORESCENT

FACE OF WALL

FULL SIZE

FOOTING

GAGE

GALLON

FURNITURE

FIELD VERIFY

GALVANIZED GRAB BAR

GENERAL CONTRACTOR

GRADE/GROUND/GROUT/GRANITE

HEATING, VENTILATION AND AIR CONDITIONING

GLASS PARTITION

GLASS SURFACE

GYPSUM

HOSE BIB HOLLOW CORE

HARDWARE HOUSEKEEPING

HOLLOW METAL

HVAC CONTRACTOR

INSIDE DIAMETER
INVERT ELEVATION

INCH(ES)

INCLUDE INFORMATION

INSULATED

INSULATED

JUNCTION BOX

JANITOR'S CLOSET

INTERIOR

LAMINATED

POUND

POUNDS

LEFT HAND LINEAR LINOLEUM

LIMESTONE

LONG LEG VERTICAL

HORIZONTAL

HOUR

HIGH

GYPSUM WALL BOARD

FOOT/FEET FLOOR TO FLOOR

FACE OF COLUMN FACE OF MASONRY FACE OF STUD

FINISHED FLOOR FLAT HEAD (SCREW)

FIRE HOSE CABINET

FIRE EXTINGUISHER

FIRE EXTINGUISHER CABINET

FIBERGLASS REINFORCED PANEL

EACH

DOWN

DOOR

COUNTER

CUBIC

DEPTH

DOUBLE

CEILING

CLEAR

BLOCK

BORROWED LITE

AIR CONDITIONING

ACOUSTICAL CEILING PANELS

ACCESS PANEL/ACRYLIC PANEL

ACOUSTICAL CEILING TILES

ABOVE FINISHED FLOOR

ACOUSTICAL WALL PANEL

BALLED AND BURLAPPED

MACH

MAS

MATL

MAX

MB

MC MDF

MECH

MED

MEZZ

MFR

MIR

MISC

MRBL

MTL

MULL

MULTI

N/A

NOM

NRC

NTE

NTS

OFCI

OFOI

OPP

PCF

PLAM

PLBG

PREFAB

PREFIN

PRELIM

PSF

PTB

PTM

PVC

RBR

RCP

REBAR

REINF

REQD

RES

REV

SCONC

STB

STC

STW

SUSP

SWB

SYM

TOB

TOC

TRZO

UNO

VEST

VTR

VCP

WDP

UNFIN

TRZOB

STO/STOR

PWB PWD/PLYWD

PLAS/PLAST

OPG/OPNG

MACHINE

MASONRY

MATERIAL

MAXIMUM

MARKERBOARD

MECHANICAL

MEZZANINE

MAN HOLE

MINIMUM

MIRROR

MARBLE

MULLION

MULTIPLE

NORTH

NUMBER

NOMINAL

NO SCALE

NOT TO EXCEED

NOT TO SCALE

ON CENTER

OPENING

OPPOSITE

OUNCE(S)

PARTITION

PLUMBING

PAINT

OUTSIDE AIR/OVERALL

OUTSIDE DIAMETER

OPPOSITE HAND/OVERHEAD

POUNDS PER CUBIC FOOT

PLATE/PROPERTY LINE

PLASTIC LAMINATE

PLASTER/PLASTIC

PREFABRICATED

POLE AND SHELF

PORCELAIN TILE

PROJECTION SCREEN
POUNDS PER SQUARE FOOT

PORCELAIN TILE BASE

PORCELAIN WALL TILE

POLYVINYL CHLORIDE

PAINTED WOOD BASE

QUARTZ SURFACE

QUARRY TILE BASE

QUARRY WALL TILE

RADIUS/(STAIR) RISER

QUARRY TILE

RETURN AIR

ROOF DRAIN

REINFORCING

REQUIRED

RESILIENT REVISION

ROOFING RIGHT HAND

ROOM

RUBBER BASE

RUBBER FLOORING

REINFORCING BAR

ROUGH OPENING

RIGHT OF WAY

ROLLER SHADE RUBBER STAIRS

SINK/SOUTH

SOIL BORING

SOLID CORE

SCHEDULE(D)

SECTION

SHEATHING

SIMILAR

SEALED CONCRETE SOAP DISPENSER

SHELF/SINGLE HUNG

SHORT LEG VERTICAL

SPECIALTY PAINT

SHOWER ROD

STONE BASE

STANDARD

STORAGE

STRUCTURAL

SUSPENDED

SYMMETRICAL

STONE WAINSCOT

STAIN AND VARNISH

STAINED WOOD BASE

TOP AND BOTTOM

TELEPHONE

THICK(NESS)

TOP OF BEAM

TOP OF CURB

TOP OF FOOTING TOP OF JOIST

TOP OF STEEL

TOP OF WALL
TOILET PARTITIONS

TERRAZZO

TYPICAL

UNFINISHED

VALANCE & PANEL

VAPOR BARRIER

VERIFY IN FIELD

VERTICAL

VESTIBULE

WITH WOOD BASE

WINDOW WIDE FLANGE

WITHOUT

YARD

WALL HUNG

VINYL ASBESTOS TILE

VENT THROUGH ROOF

WEST/WIDE/WIDTH

WOOD MILLWORK WOOD WALL PANELING

WATER RESISTANT

WELDED WIRE FABRIC

VINYL COATED CEILING PANEL

WATER CLOSET/WALLCOVERING

WATERPROOF/WORKING POINT

WEIGHT/WINDOW TREATMENT

WOOD/WOOD FLOORING

URINAL

TERRAZZO BASE

TRANSITION STRIP

UNDERWRITERS' LABORATORY

UNLESS NOTED OTHERWISE

TACKBOARD/TOWEL BAR

TONGUE AND GROOVE

TOILET PAPER HOLDER

TEMPERATURE/TEMPERED/TEMPORARY

SANITARY NAPKIN DISPENSER

SOUND TRANSMISSION CLASS

SANITARY NAPKIN RECEPTACLE

SERVICE SINK/STAINLESS STEEL/SOLID SURFACE

SANITARY

PLYWOOD

POUNDS PER SQUARE INCH

PATCH TO MATCH/PORCELAIN TILE MOSAIC

REINFORCED CONCRETE PIPE/REFLECTED CEILING PLAN

PREFINISHED

PRELIMINARY

METAL

MANUFACTURER

MISCELLANEOUS

NOT APPLICABLE

NOT IN CONTRACT

NOISE REDUCTION COEFFICIENT

OWNER FURNISHED, CONTRACTOR INSTALLED

OWNER FURNISHED, OWNER INSTALLED

MARBLE BASE


MASONRY OPENING

MEDIUM


MECHANICAL CONTRACTOR

MEDIUM DENSITY FIBERBOARD

DRAWING SYMBOLS

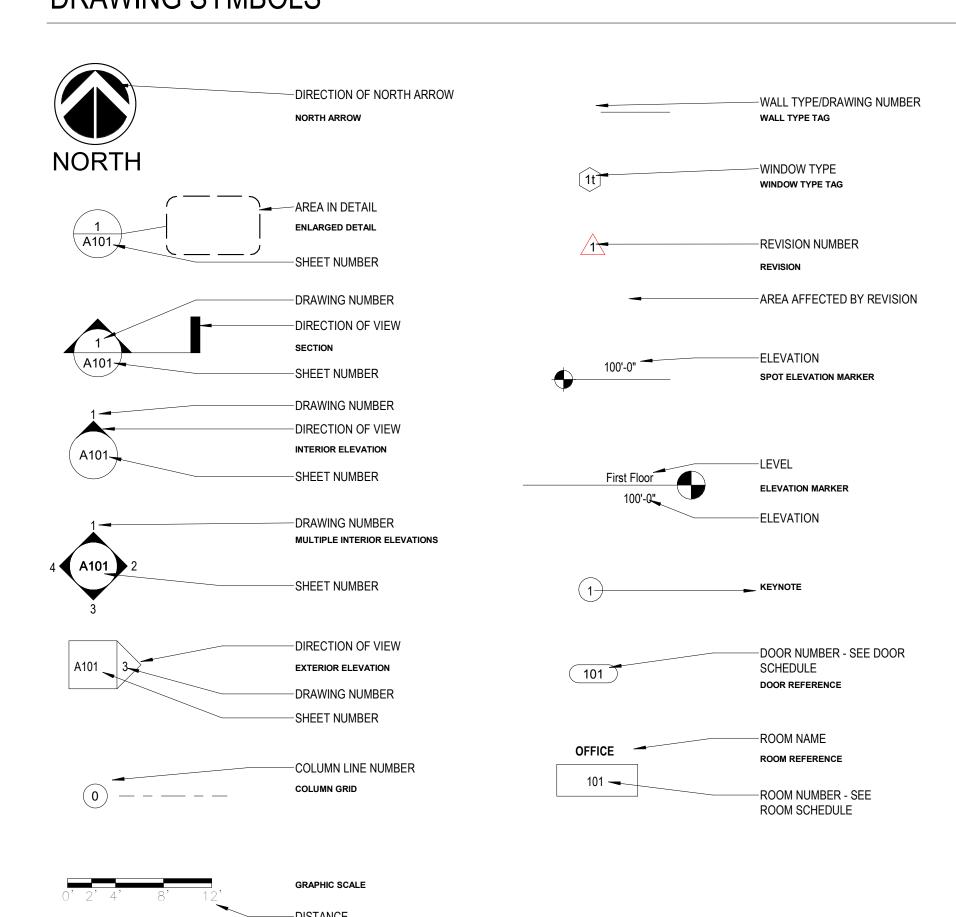

MATERIAL SYMBOLS

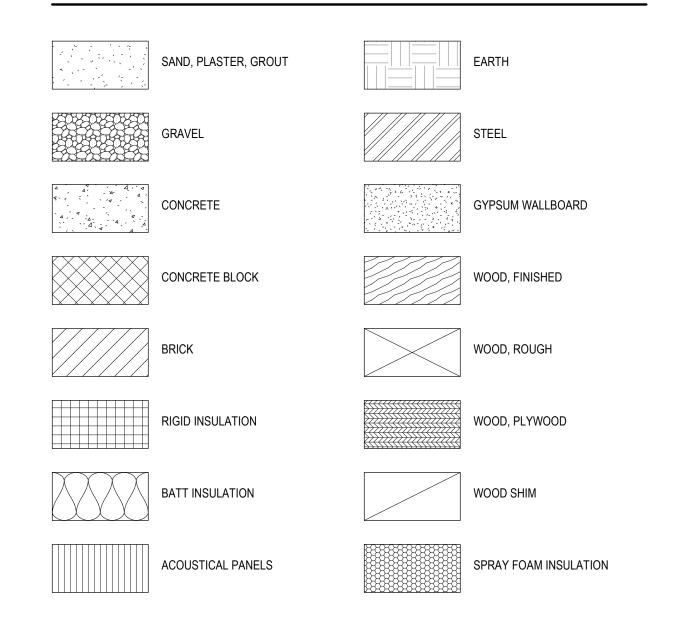

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TRINITY EVANGELICAL LUTHERAN CHURCI RESTORATION

CODE
INFORMATION,
ABBREVIATIONS
& SYMBOLS

DATE

09/21/2018

PROJECT NO. **18-122**

SHEET NO.

G001

1 FIRST FLOOR - EXISTING
A101 SCALE: 1/8" = 1'-0"



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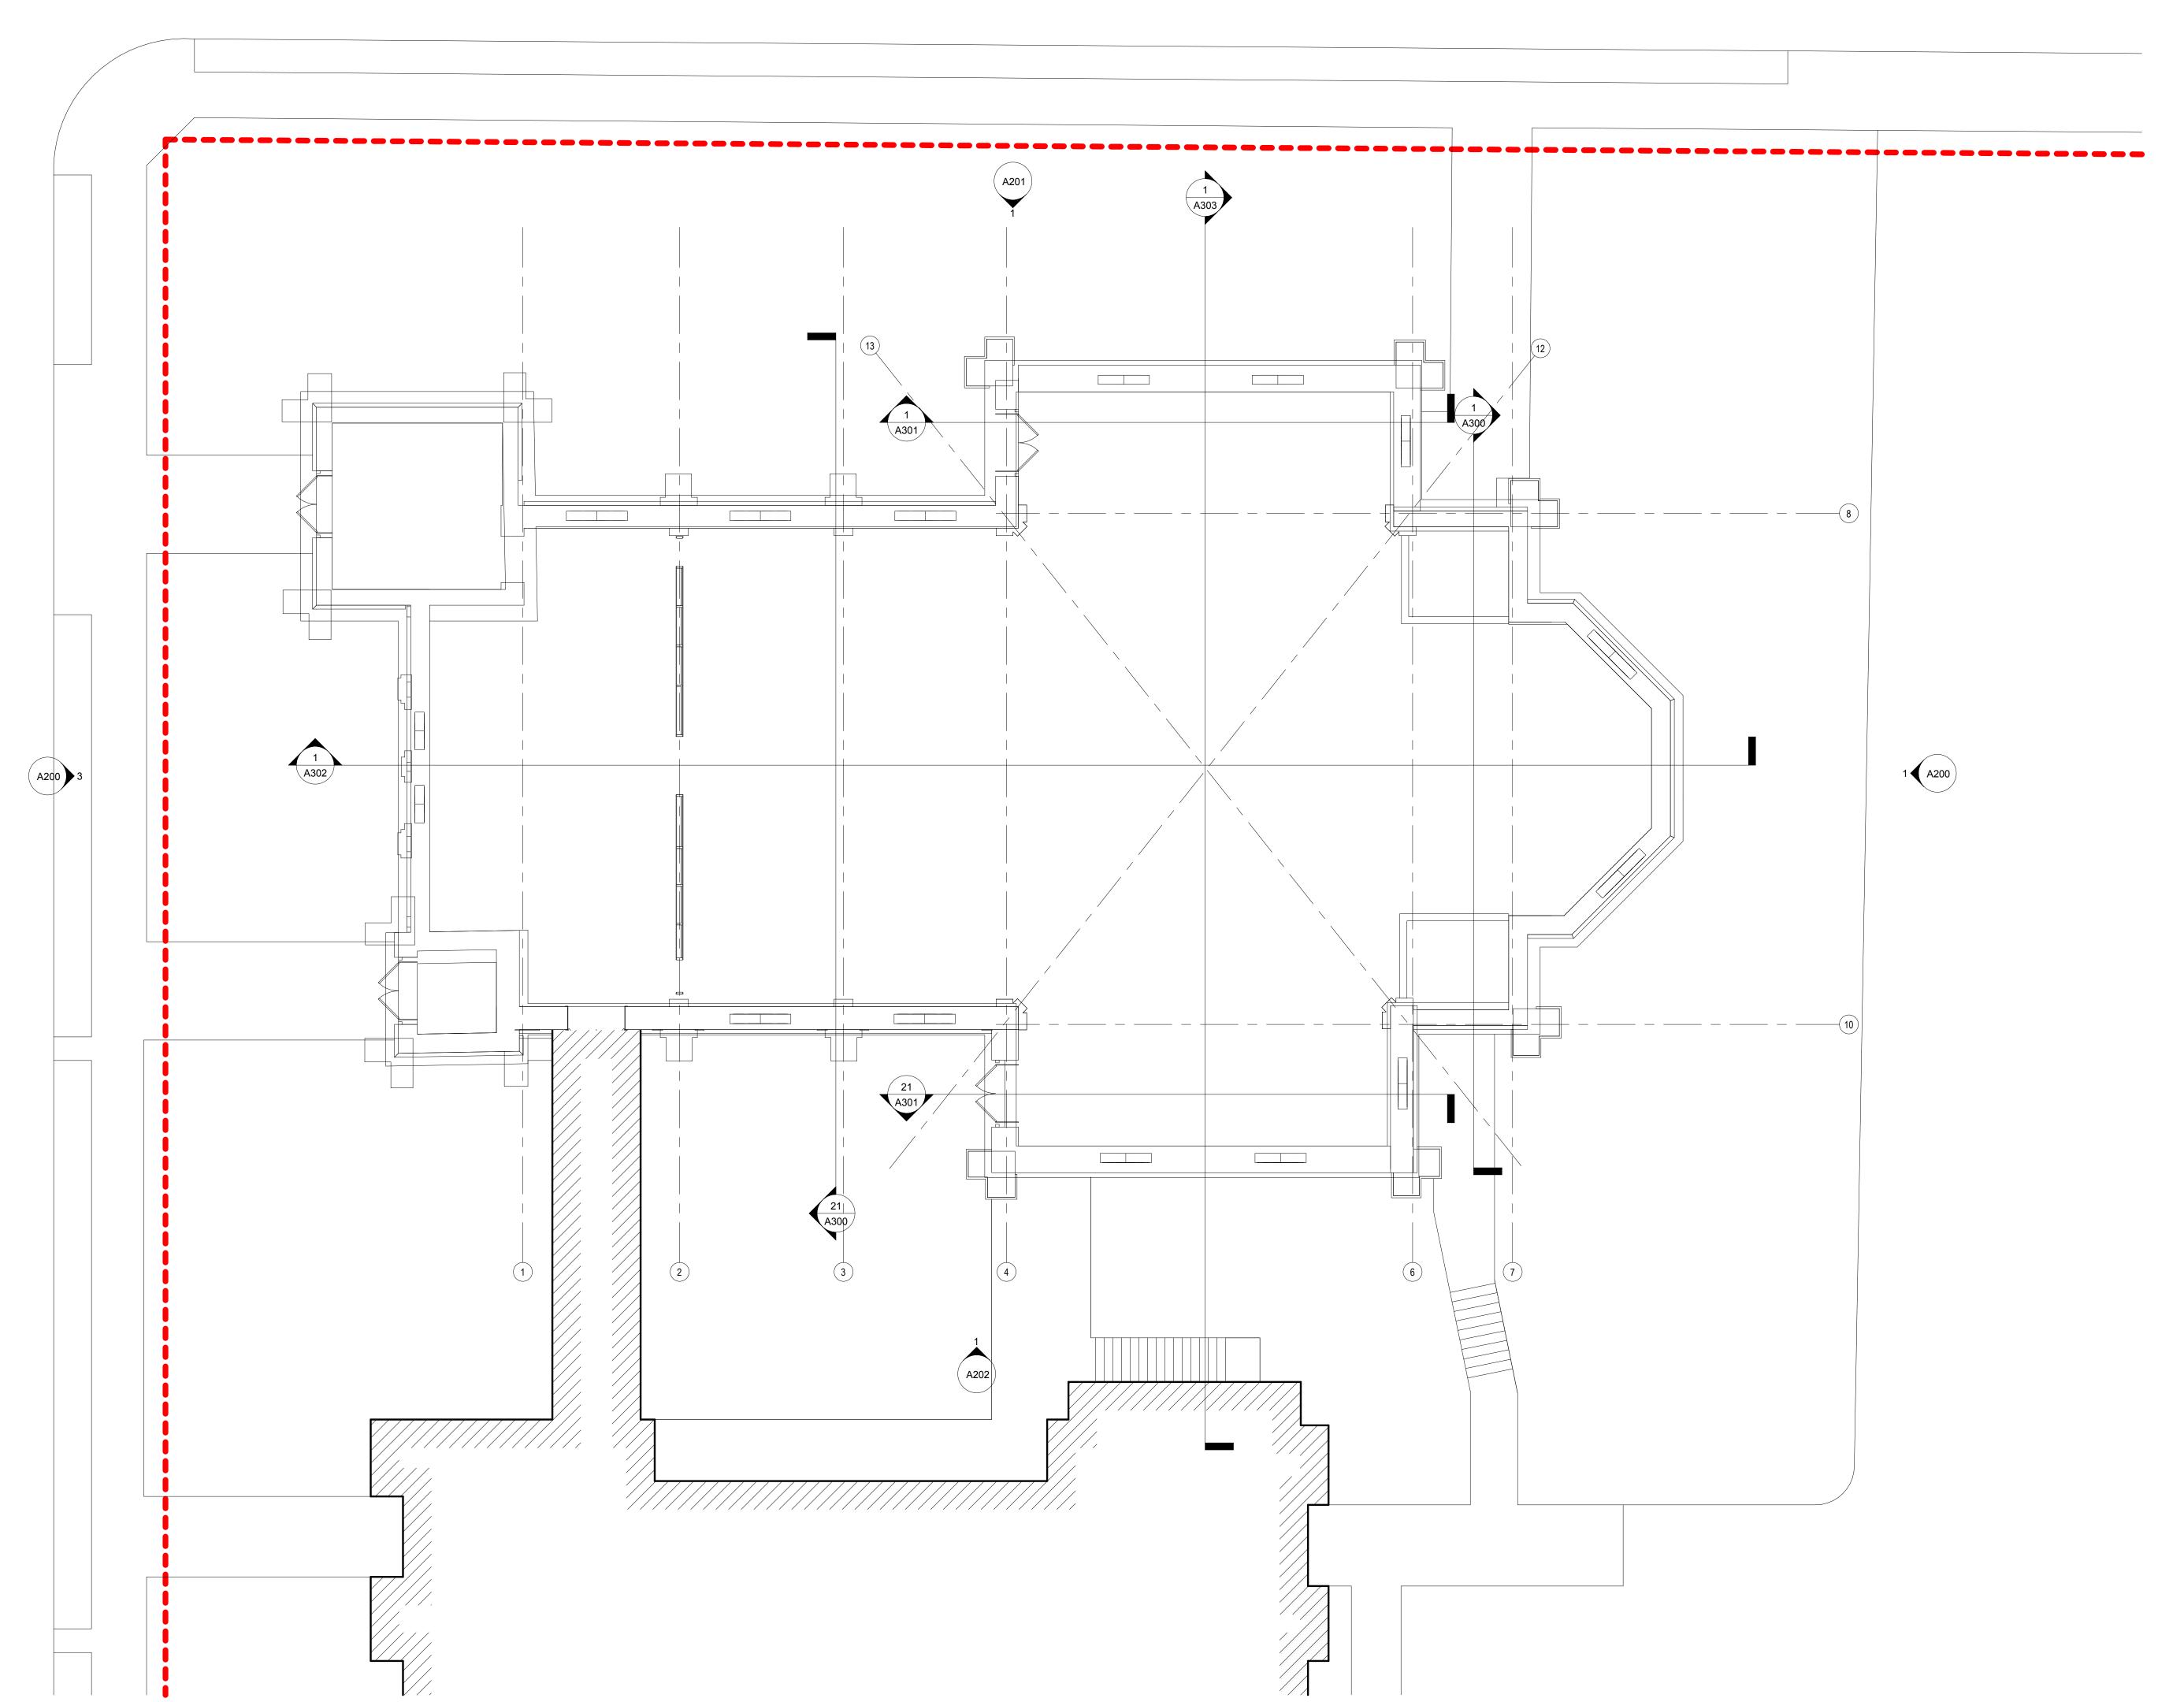
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SHEET'
FIRST FLOOR PLAN

09/21/2018

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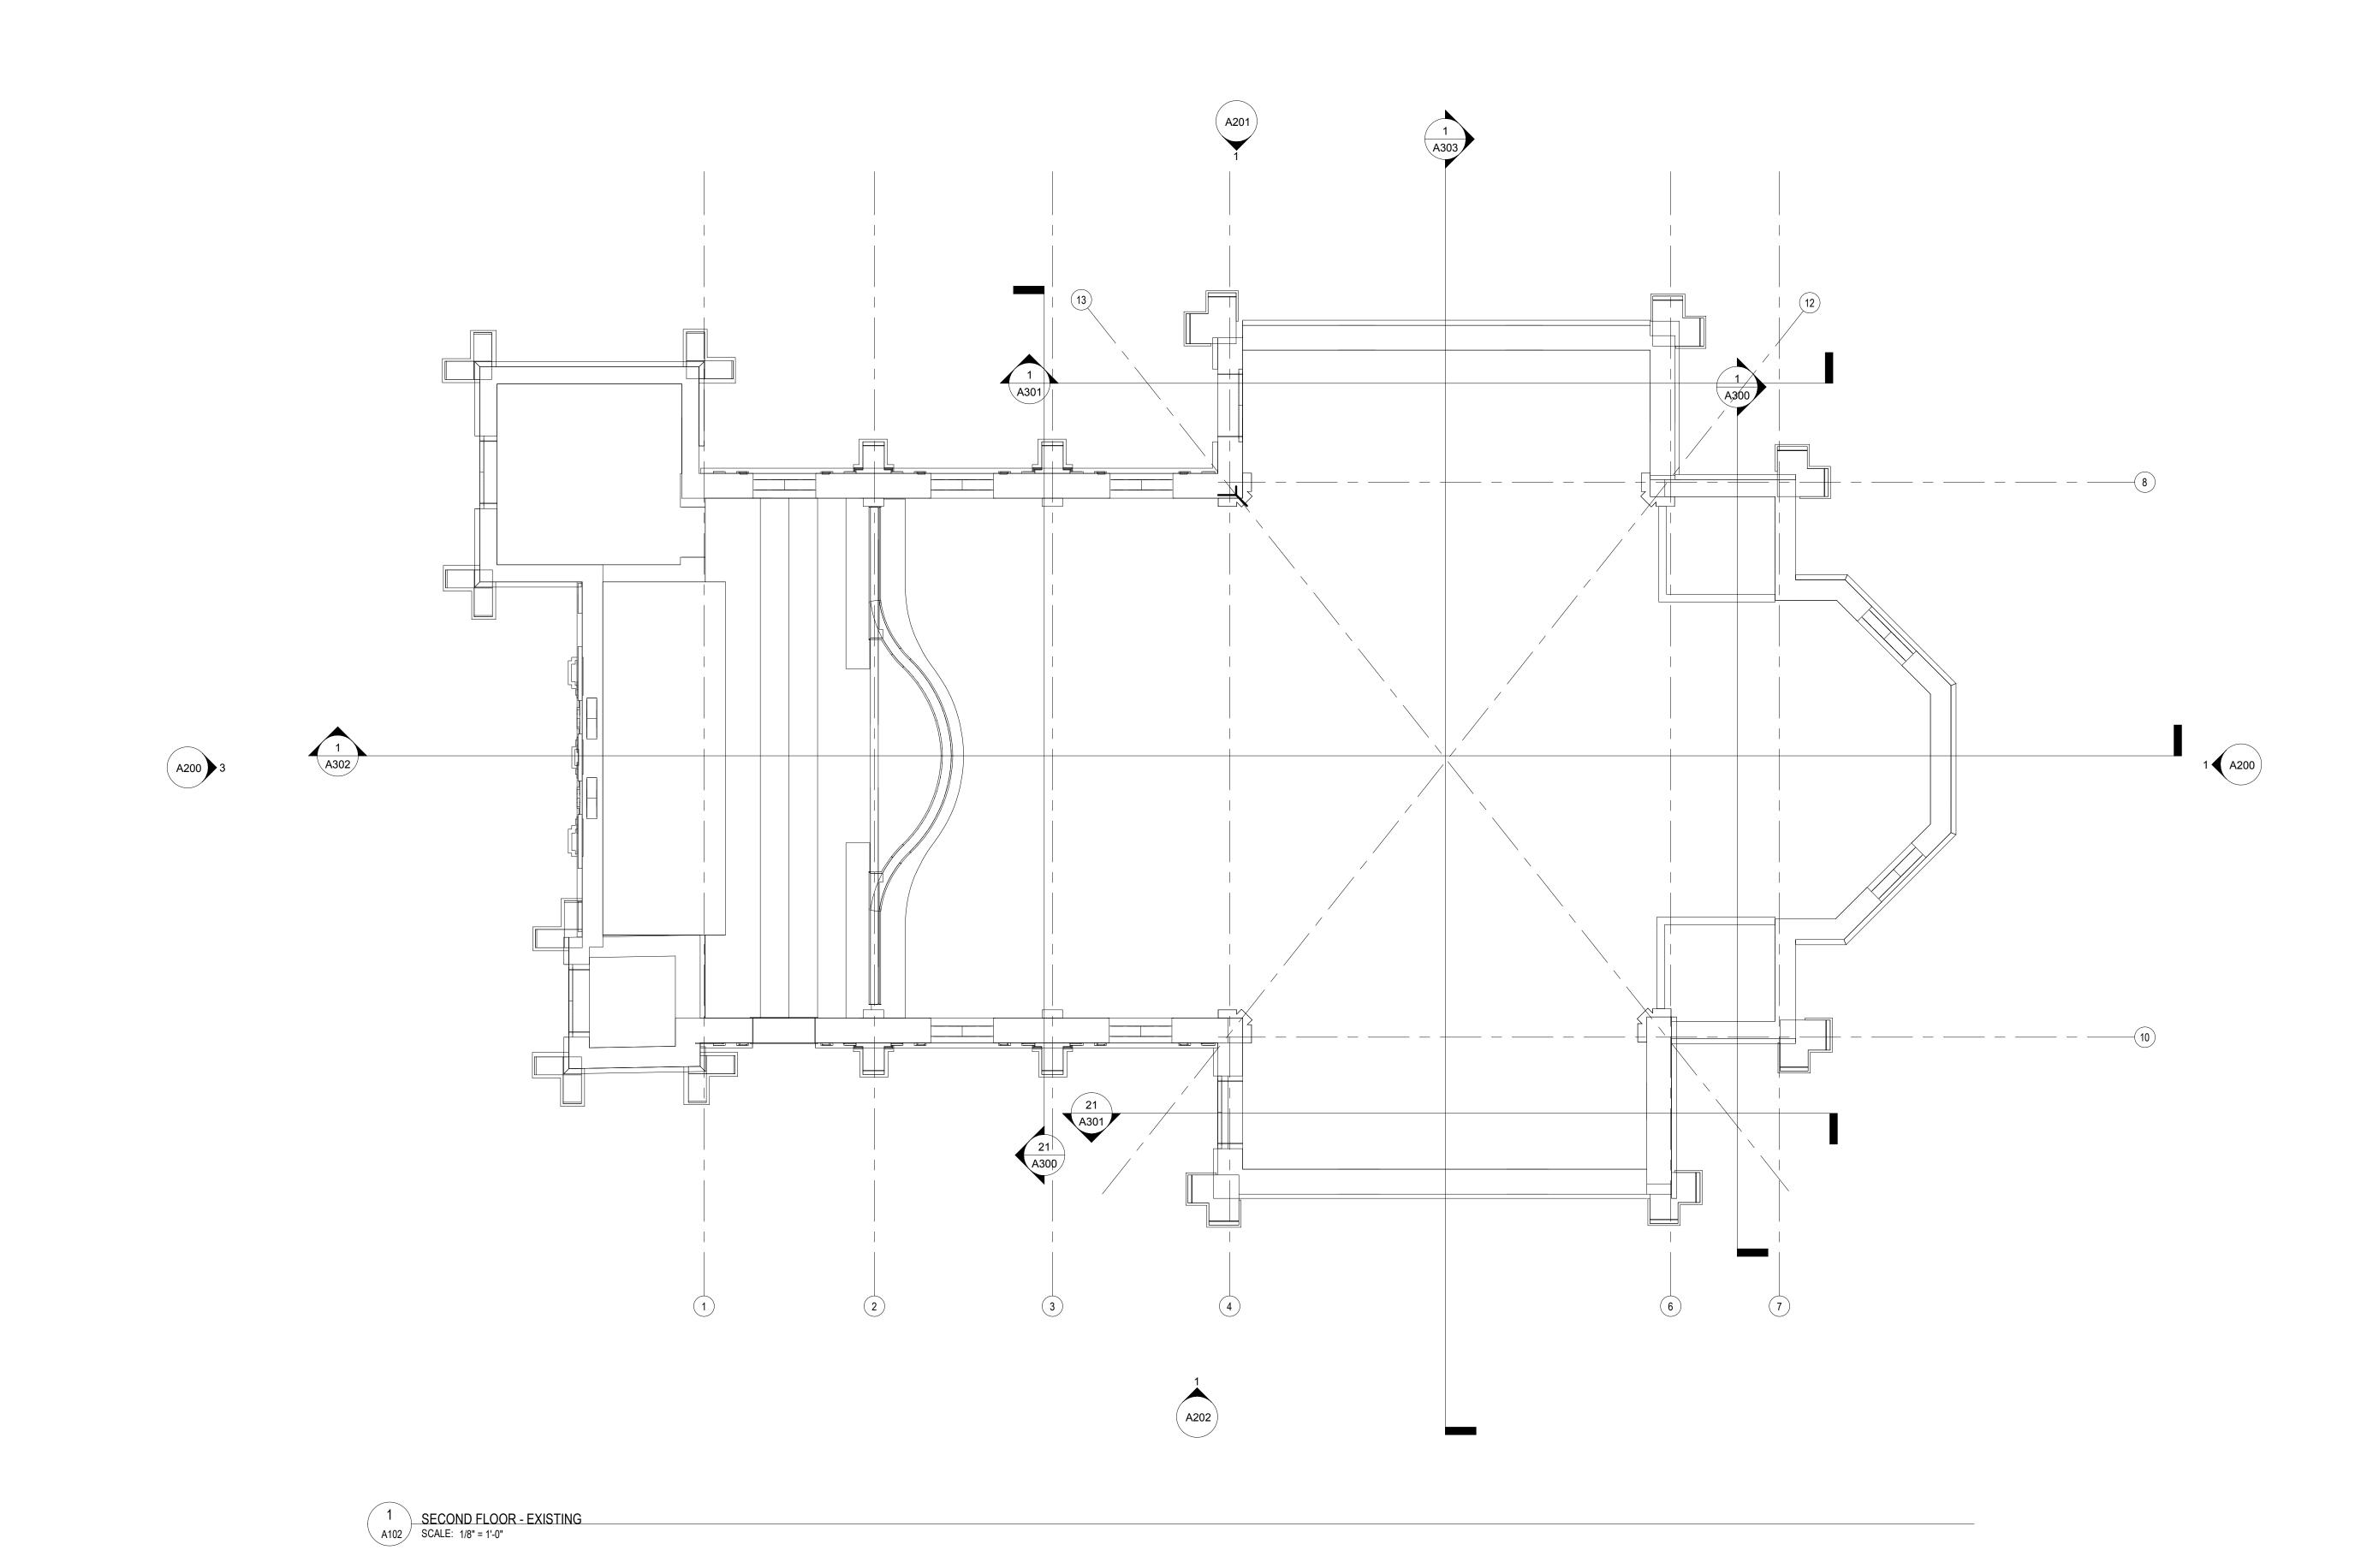
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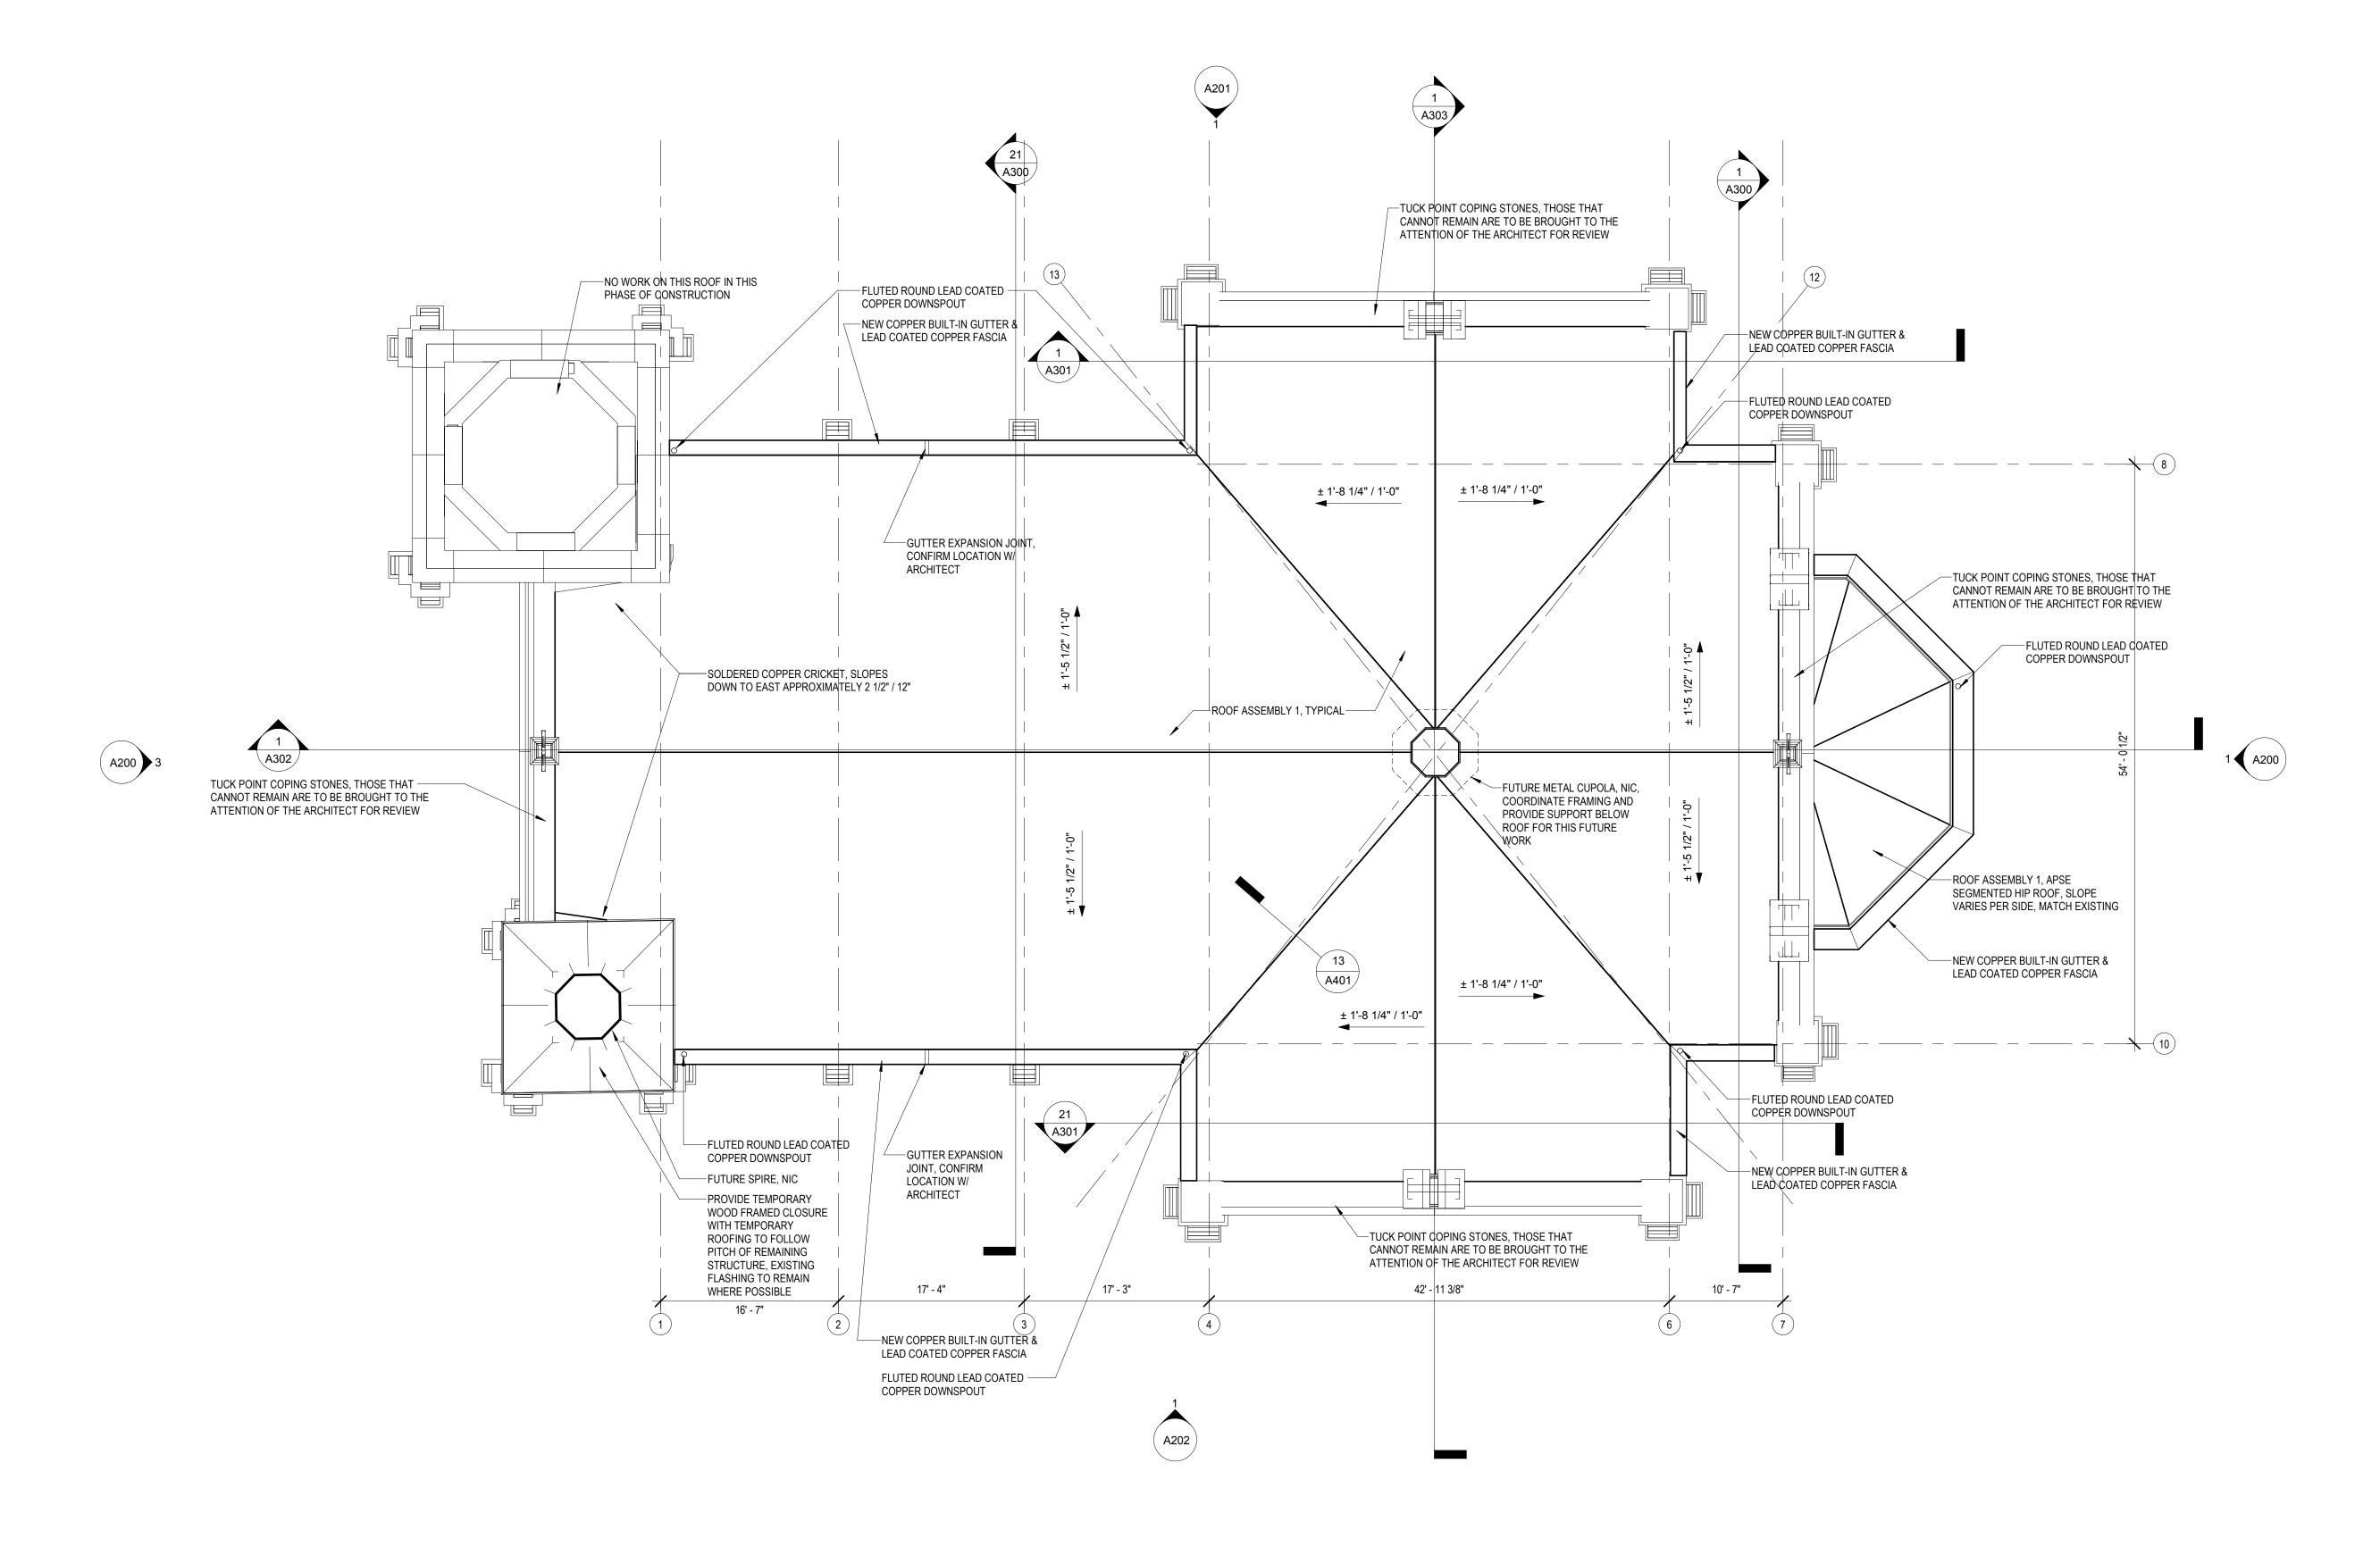
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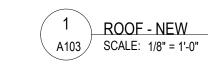
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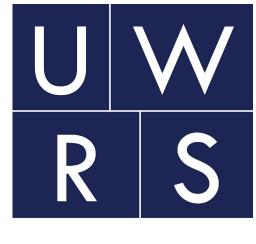


FROM EXTERIOR TO INTERIOR:

- A1. SLATE AS PRIMARY BID: MACHINE CUT, 10" X 20" X 1/4" TO 3/8", SPANISH UNFADING BLACK SLATE
- A2. SYNTHETIC SHINGLE AS ALTERNATE BID: 10" X 20" X 1/4" TO 3/8", GAF SLATELINE ANTIQUE SLATE
- APPROVED SHINGLES UNDERLAYMENT MEMBRANE, SHARKSKIN ULTRA OR
- APPROVED EQUAL C. 5/8" APA RATED EXTERIOR GRADE PLYWOOD, 1/2 STAGGER JOINTS WITH INSULATION LAYER BELOW
- (2) LAYERS OF 2 1/2" POLYISOCYANURATE ROOF INSULATION WITH 1/2 STAGGER JOINTS VAPOR BARRIER, FIRESTONE V-FORCE OR APPROVED
- **EQUAL** 1/2" GYPSUM BOARD SUBSTRATE G. 3" METAL DECK







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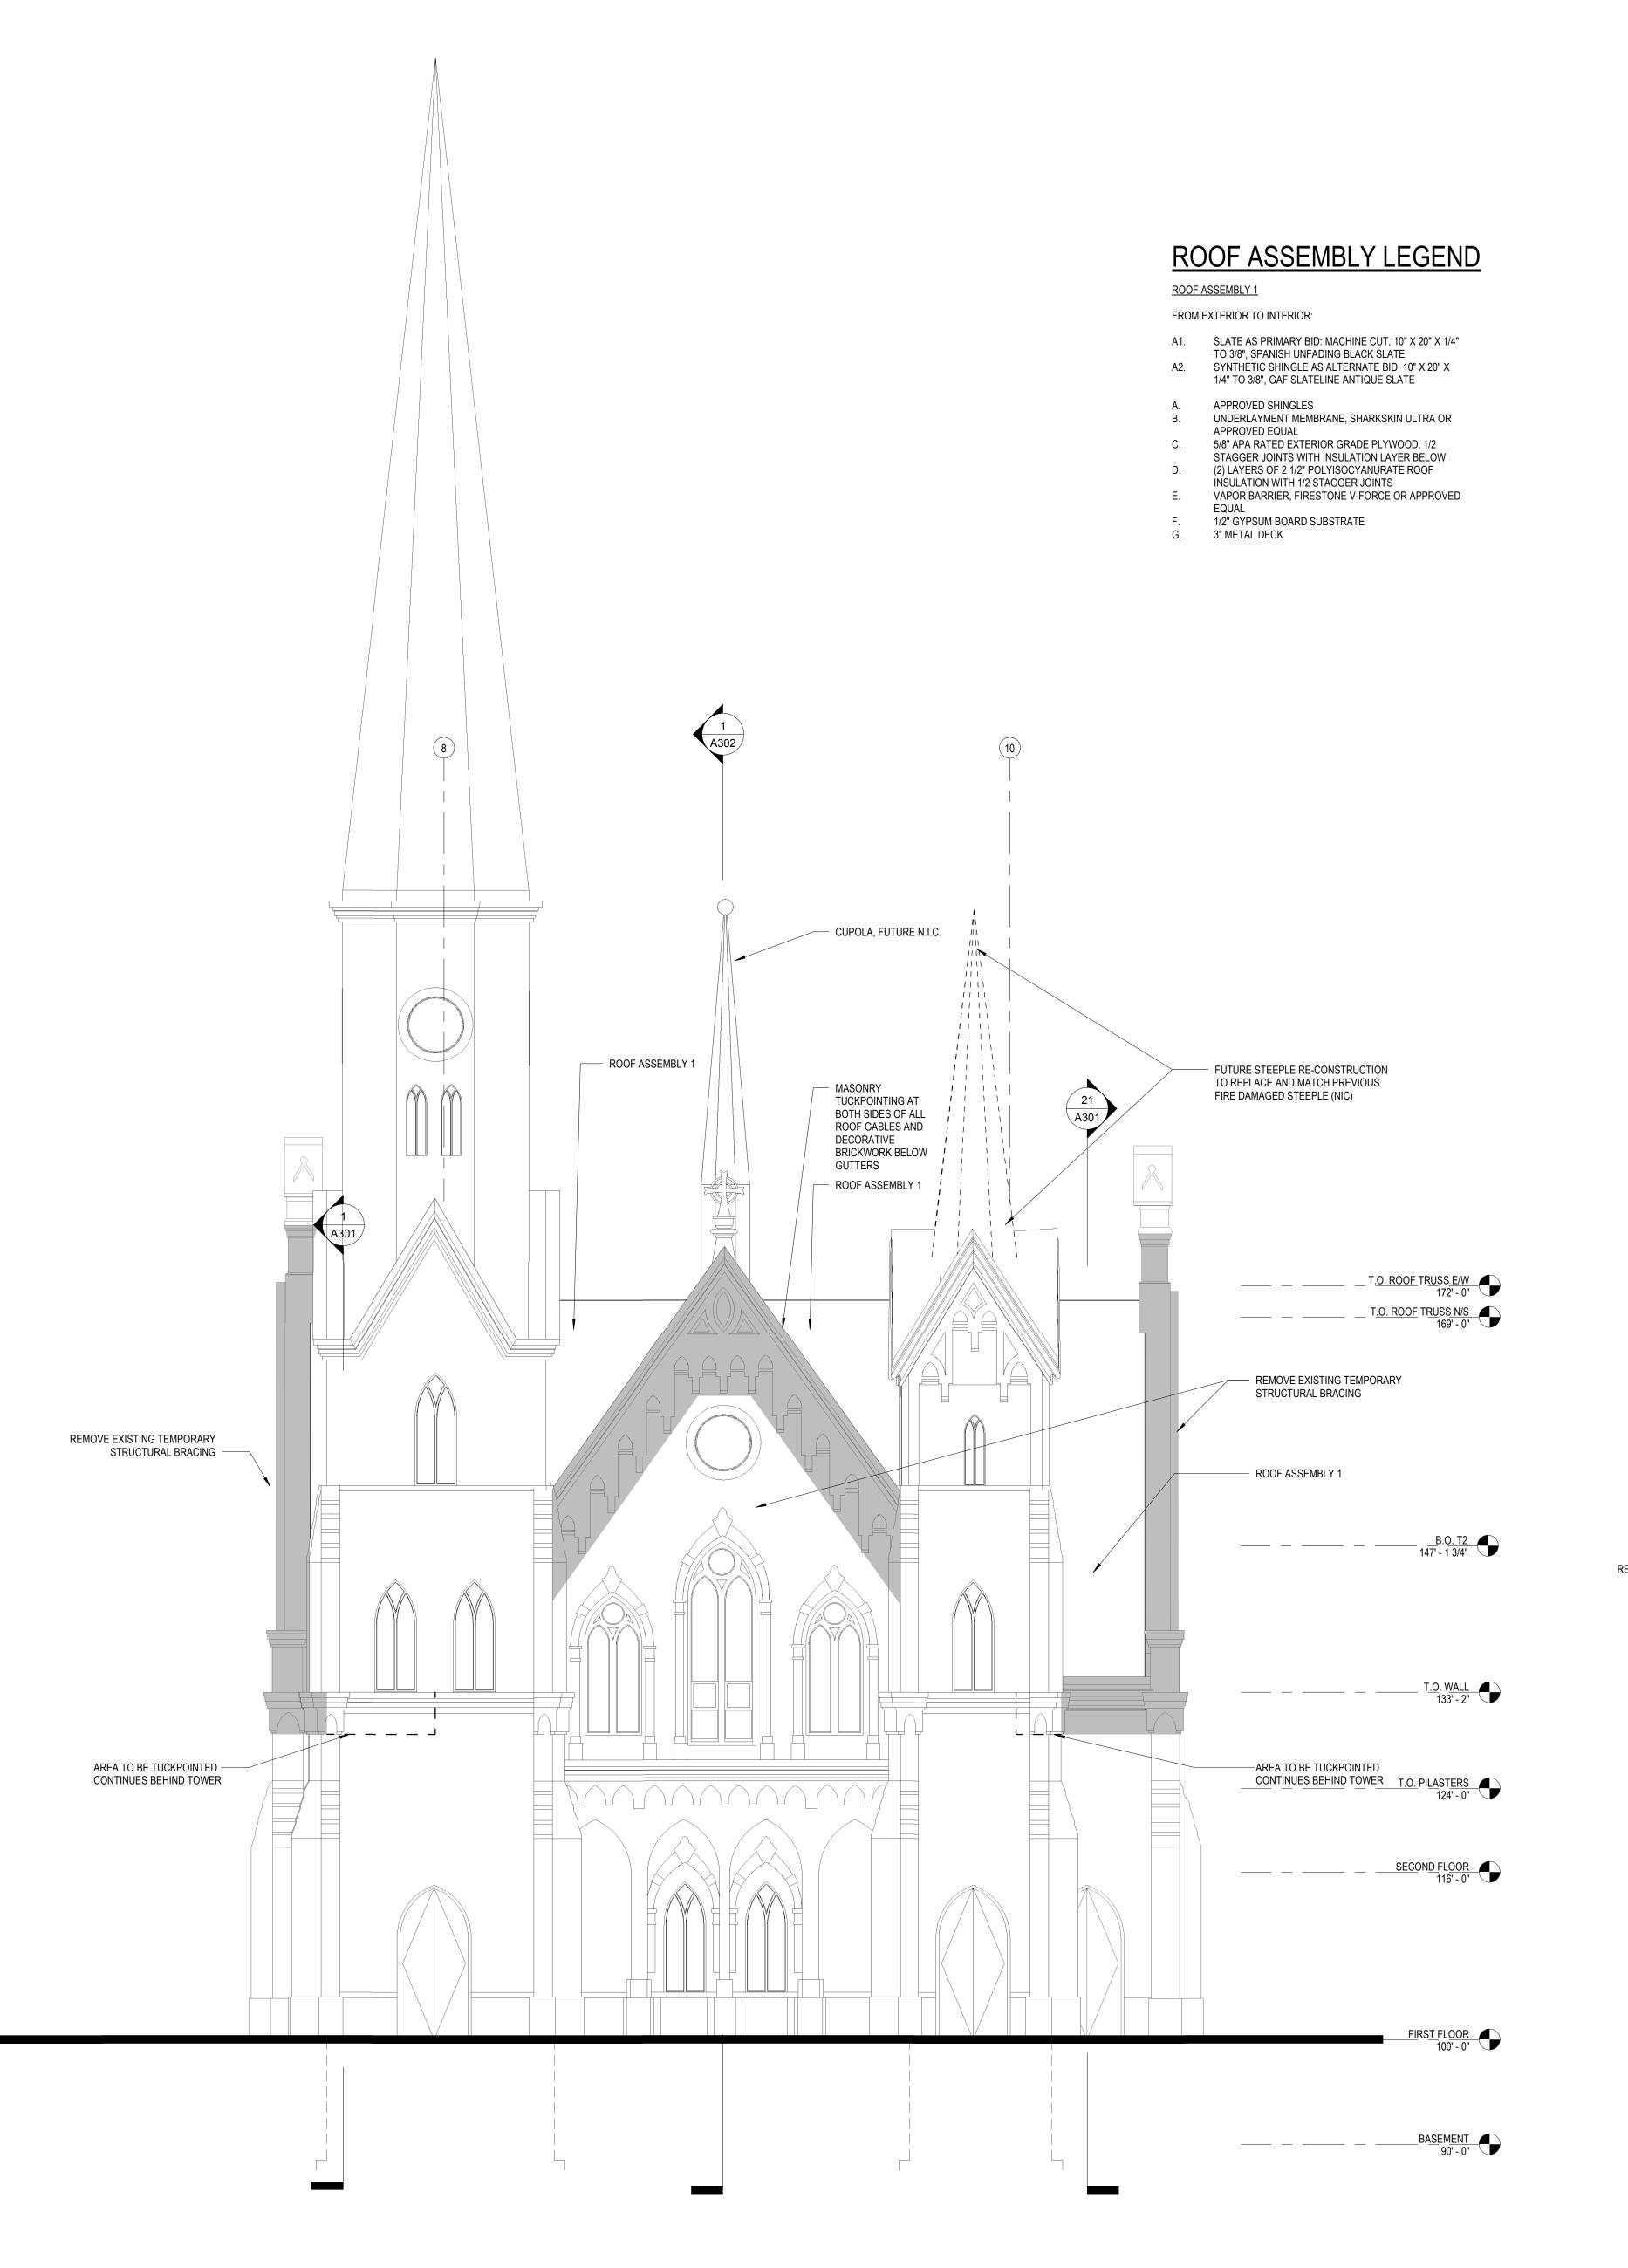
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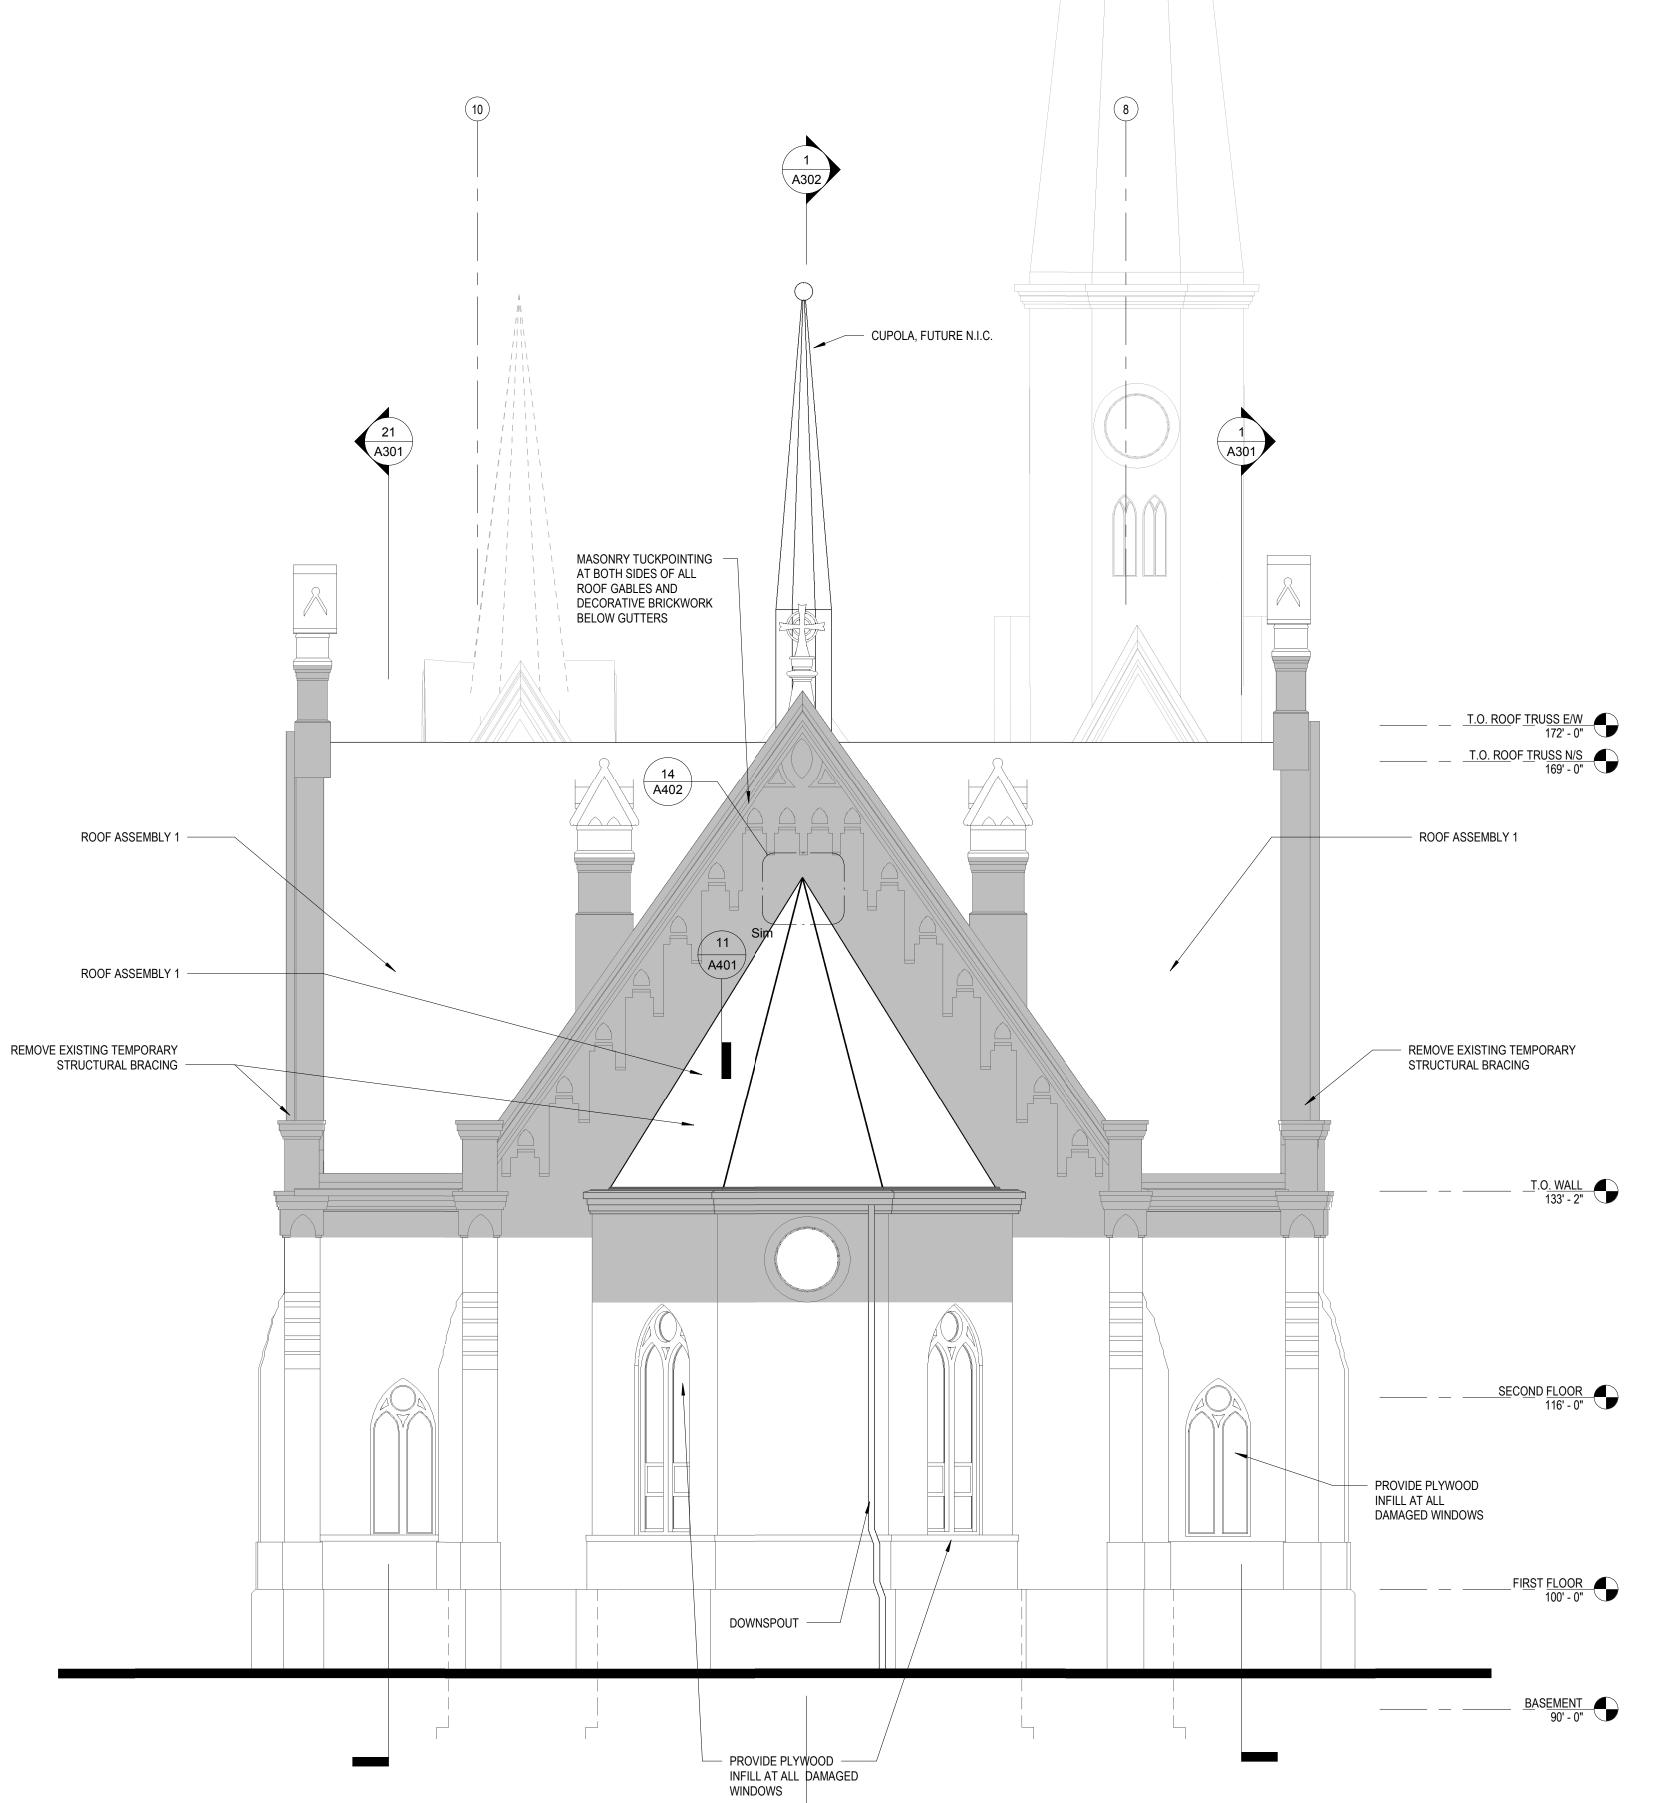
ROOF PLAN

09/21/2018

PROJECT NO. 18-122



3
A200 ELEVATION - EXISTING - WEST
SCALE: 1/8" = 1'-0"



1 ELEVATION - EXISTING - EAST SCALE: 1/8" = 1'-0"

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Y EVANGELICAL LUTHERAN CHURCH RATION


SHEET
BUILDING
ELEVATIONS

DATE **09/21/2018**

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> TRINITY EVANGELICAL LUTHERAN CHURCH RESTORATION


BUILDING ELEVATIONS

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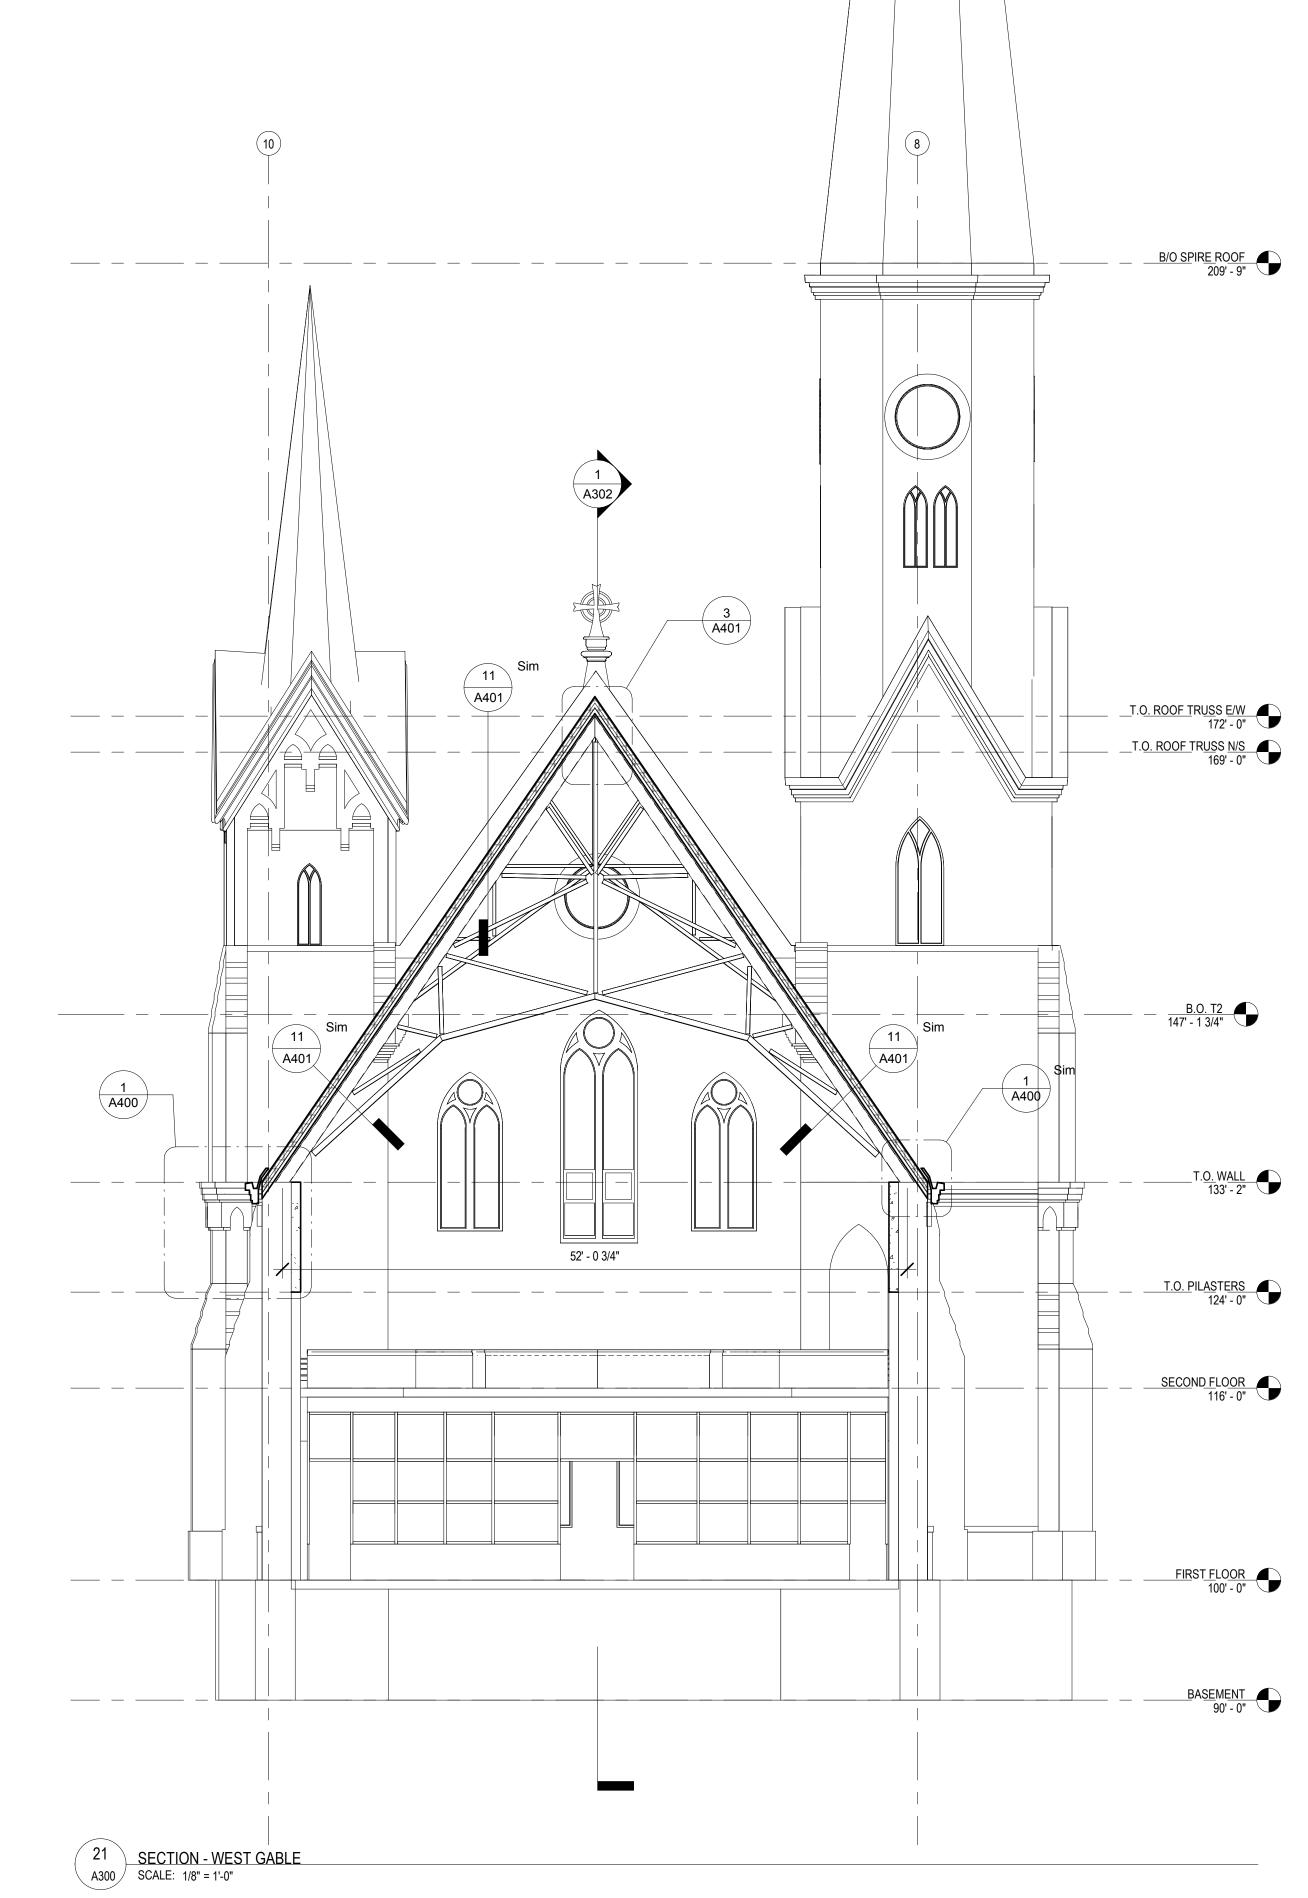
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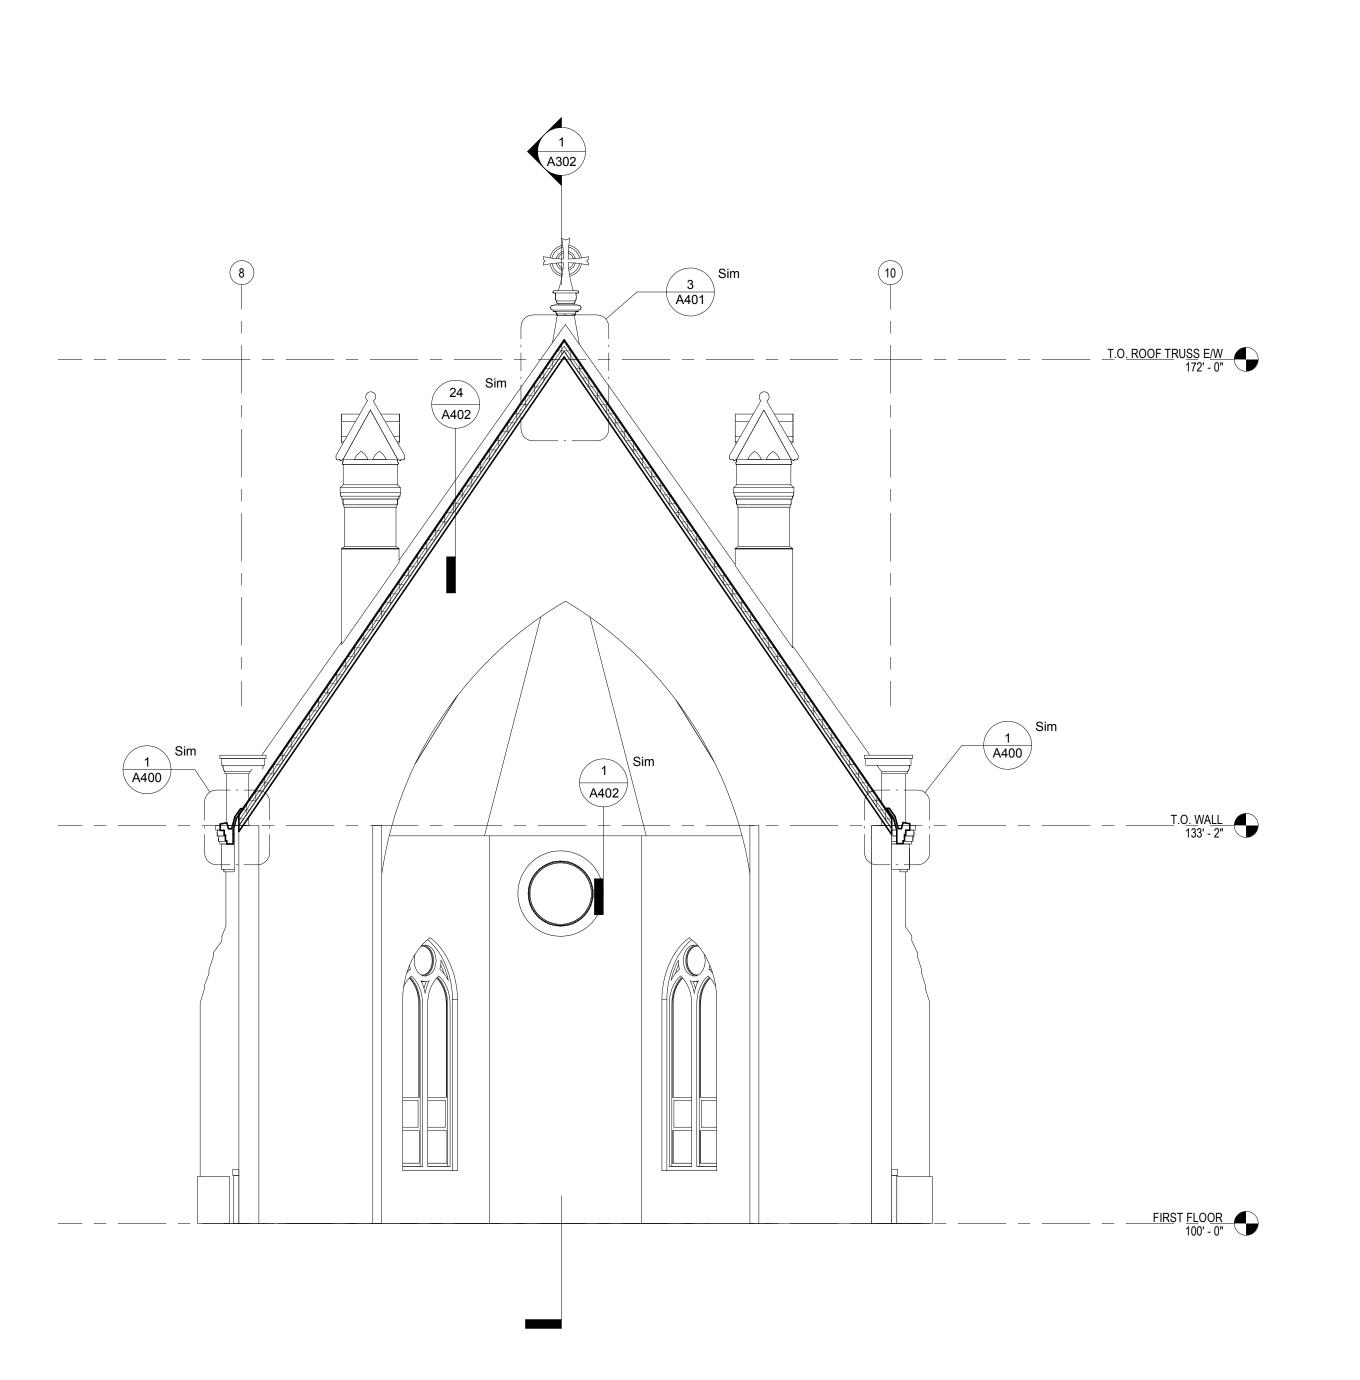
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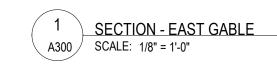
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RESTORATION

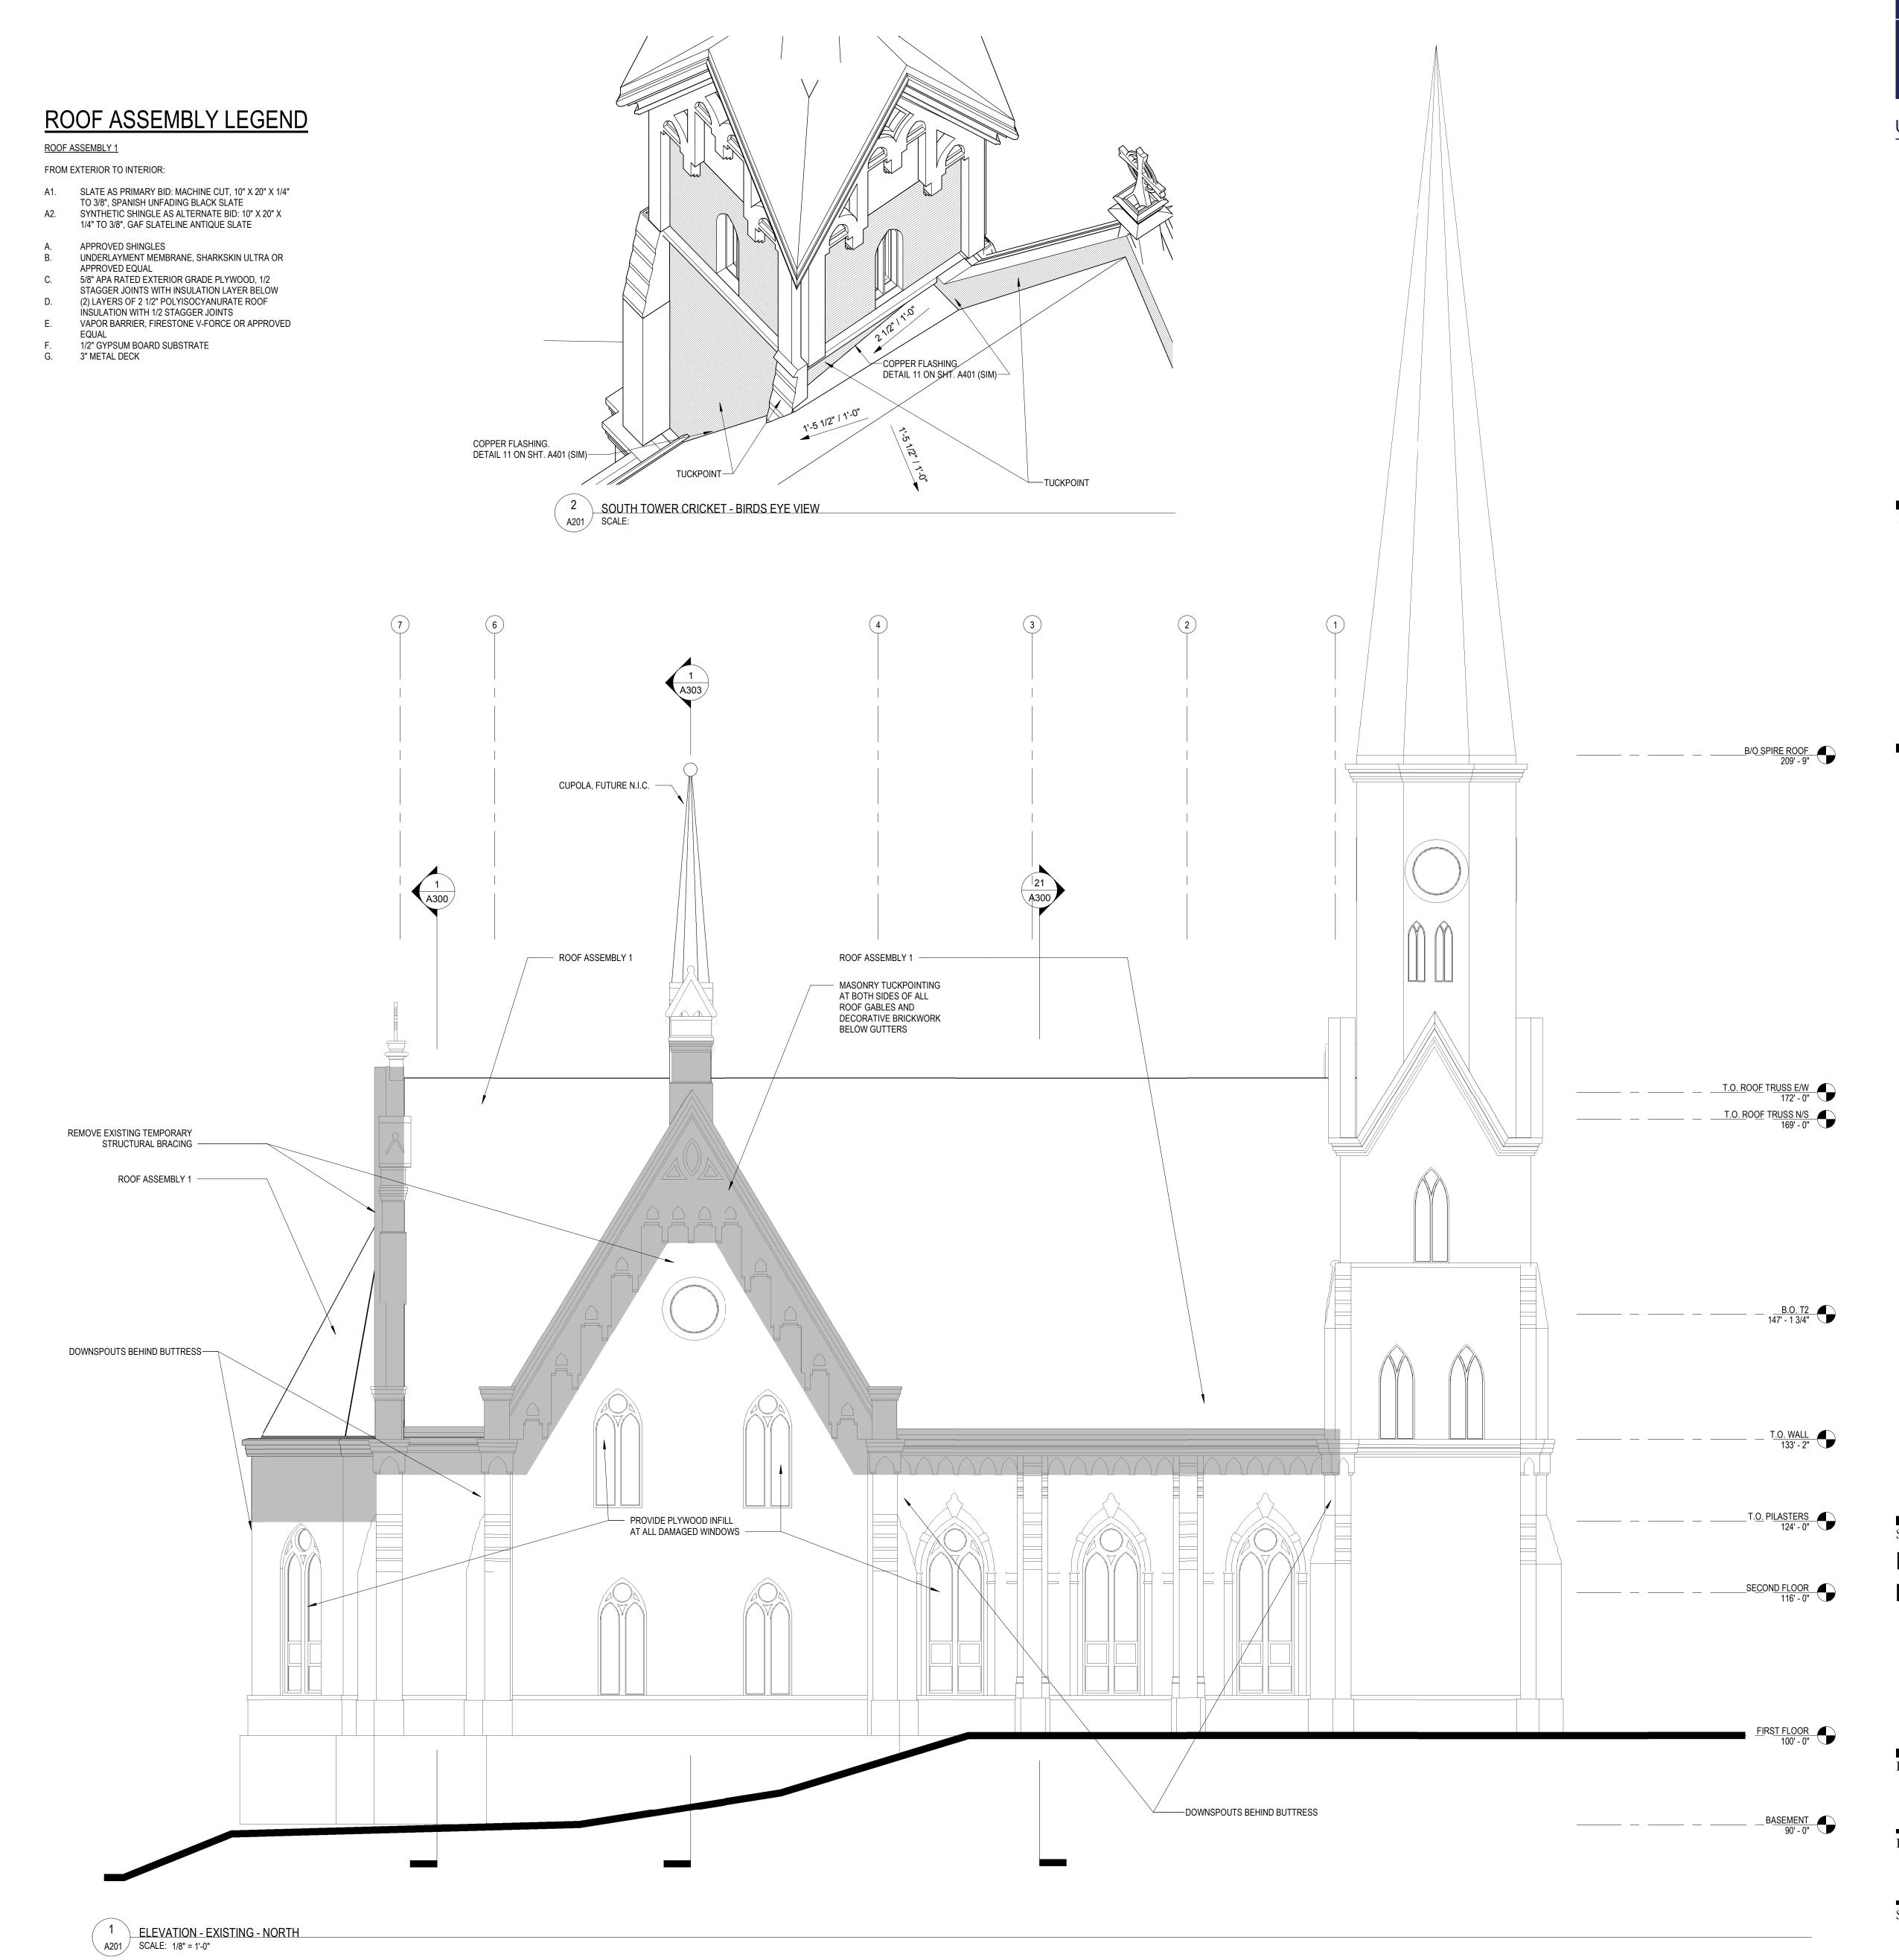
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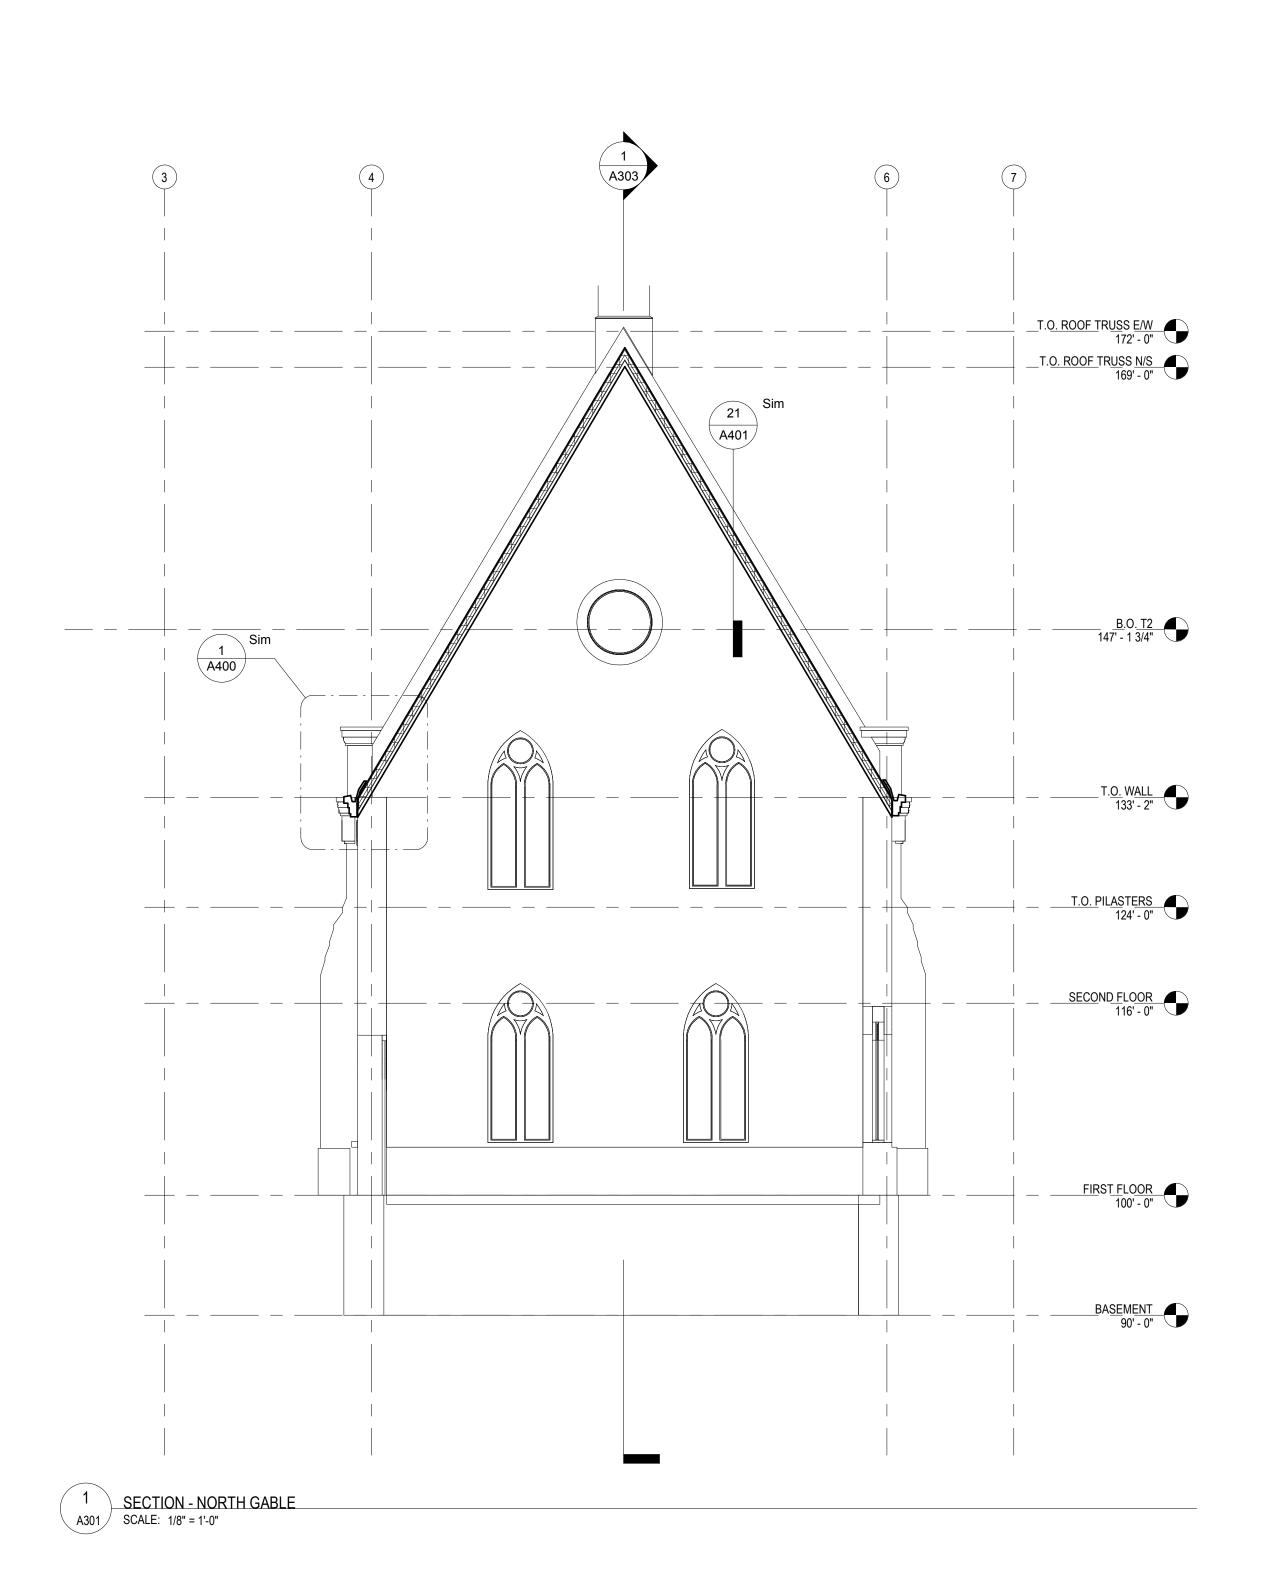
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RINITY EVANGELICAL LUTHERAN CHURCH ESTORATION


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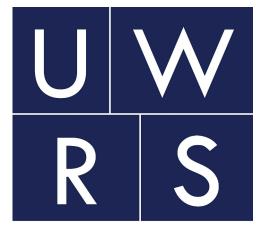
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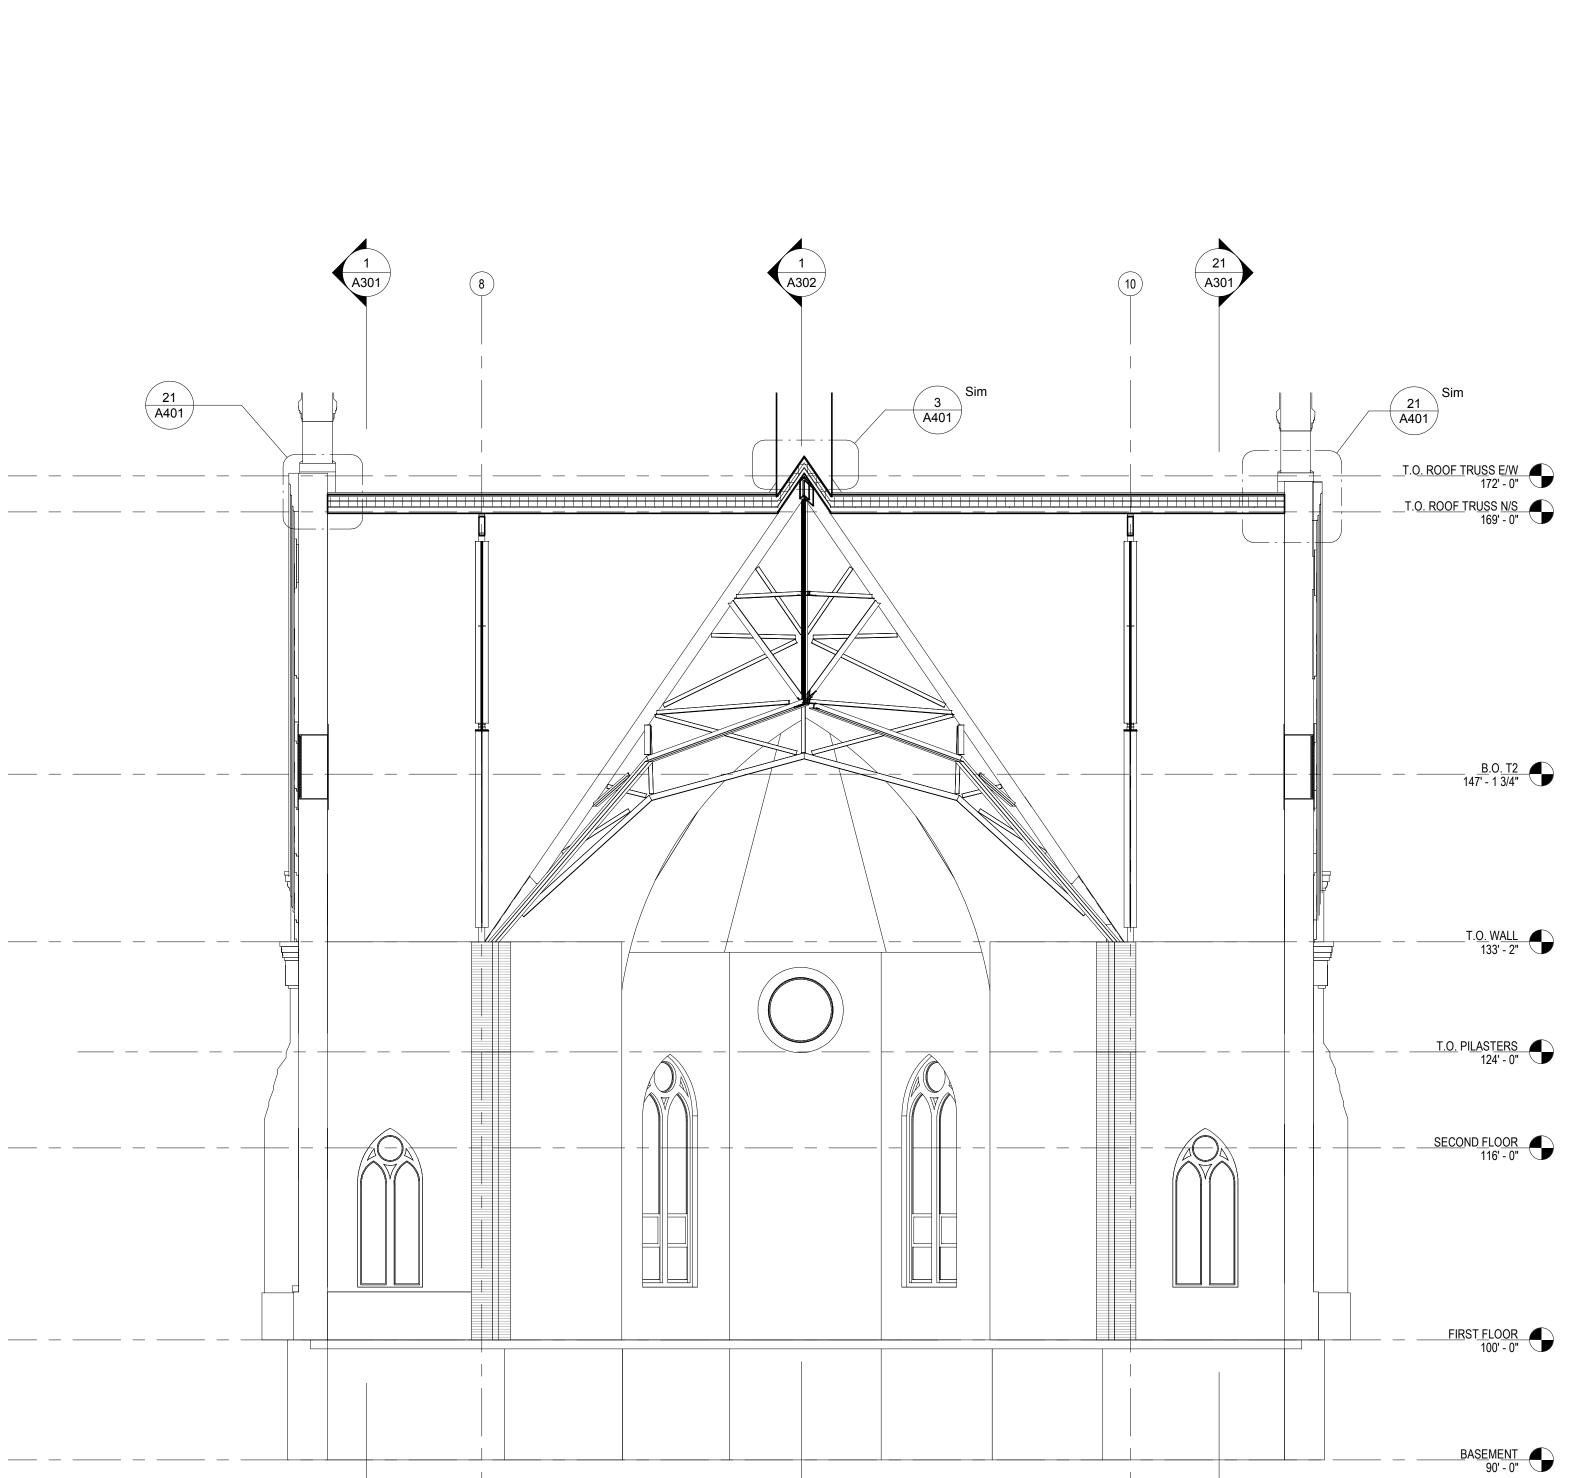
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PROJECT NO. 18-122

SHEET NO.

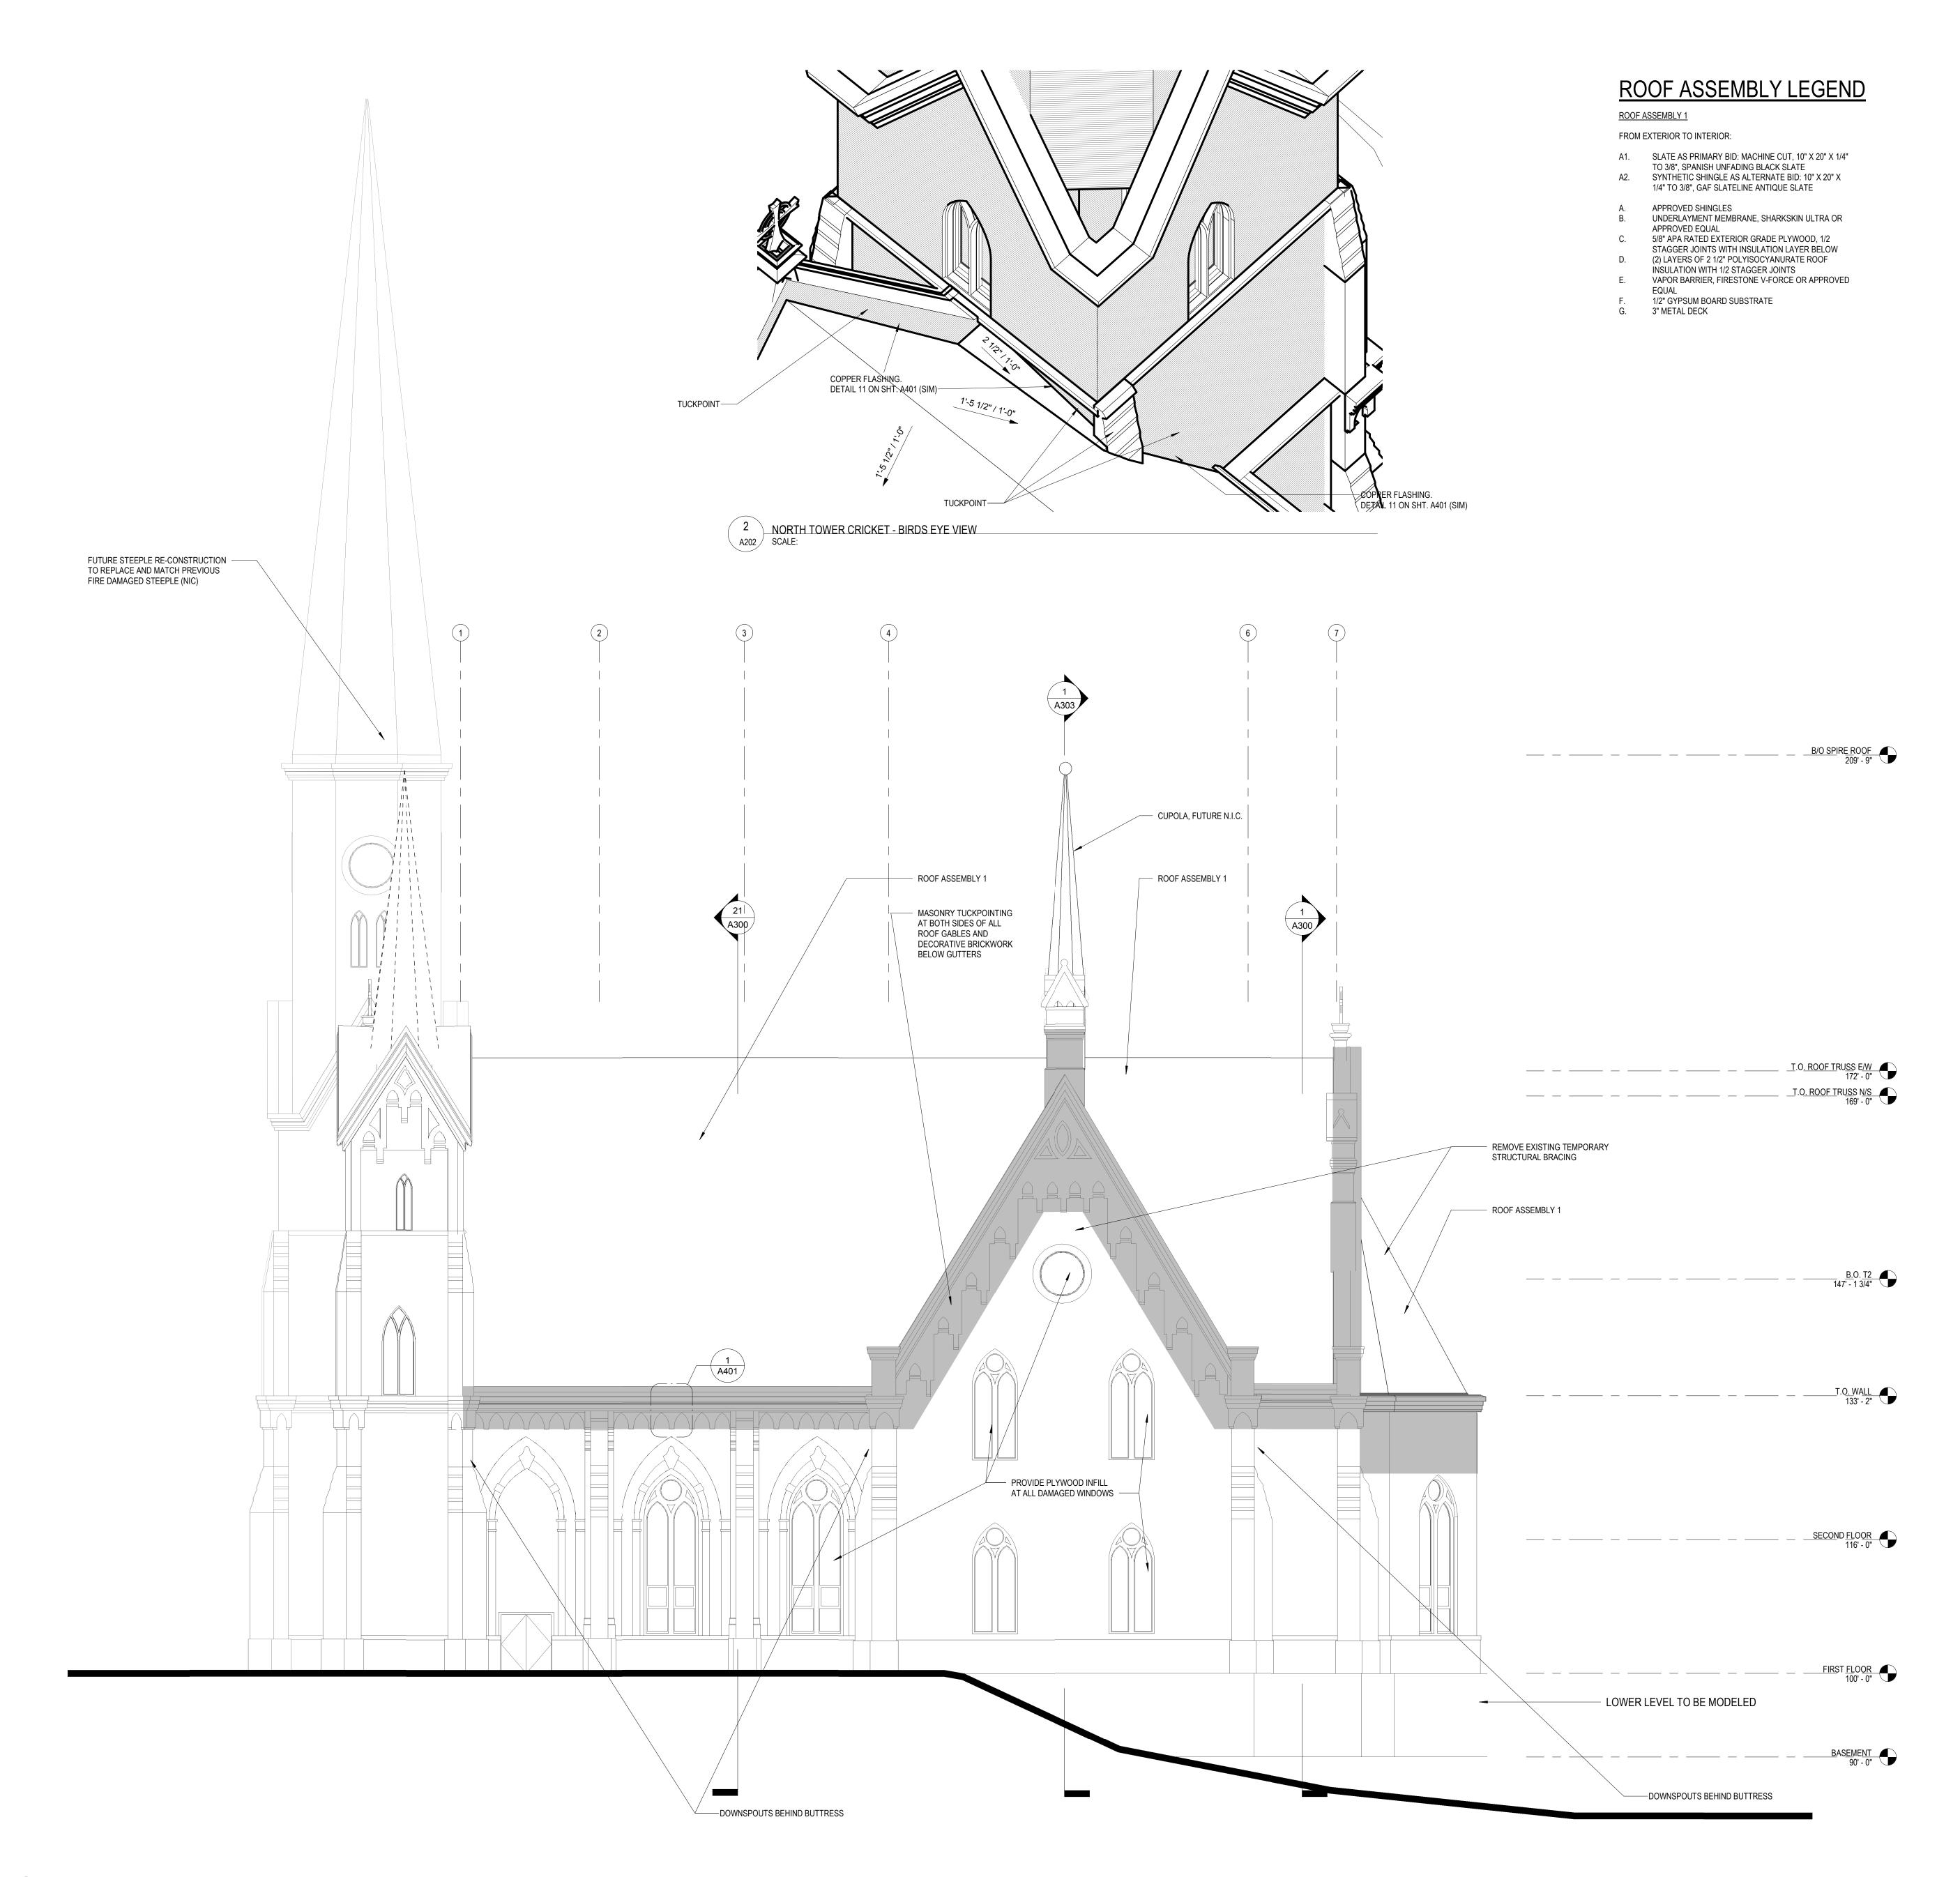

1 BUILDING SECTION - EAST
SCALE: 1/8" = 1'-0"

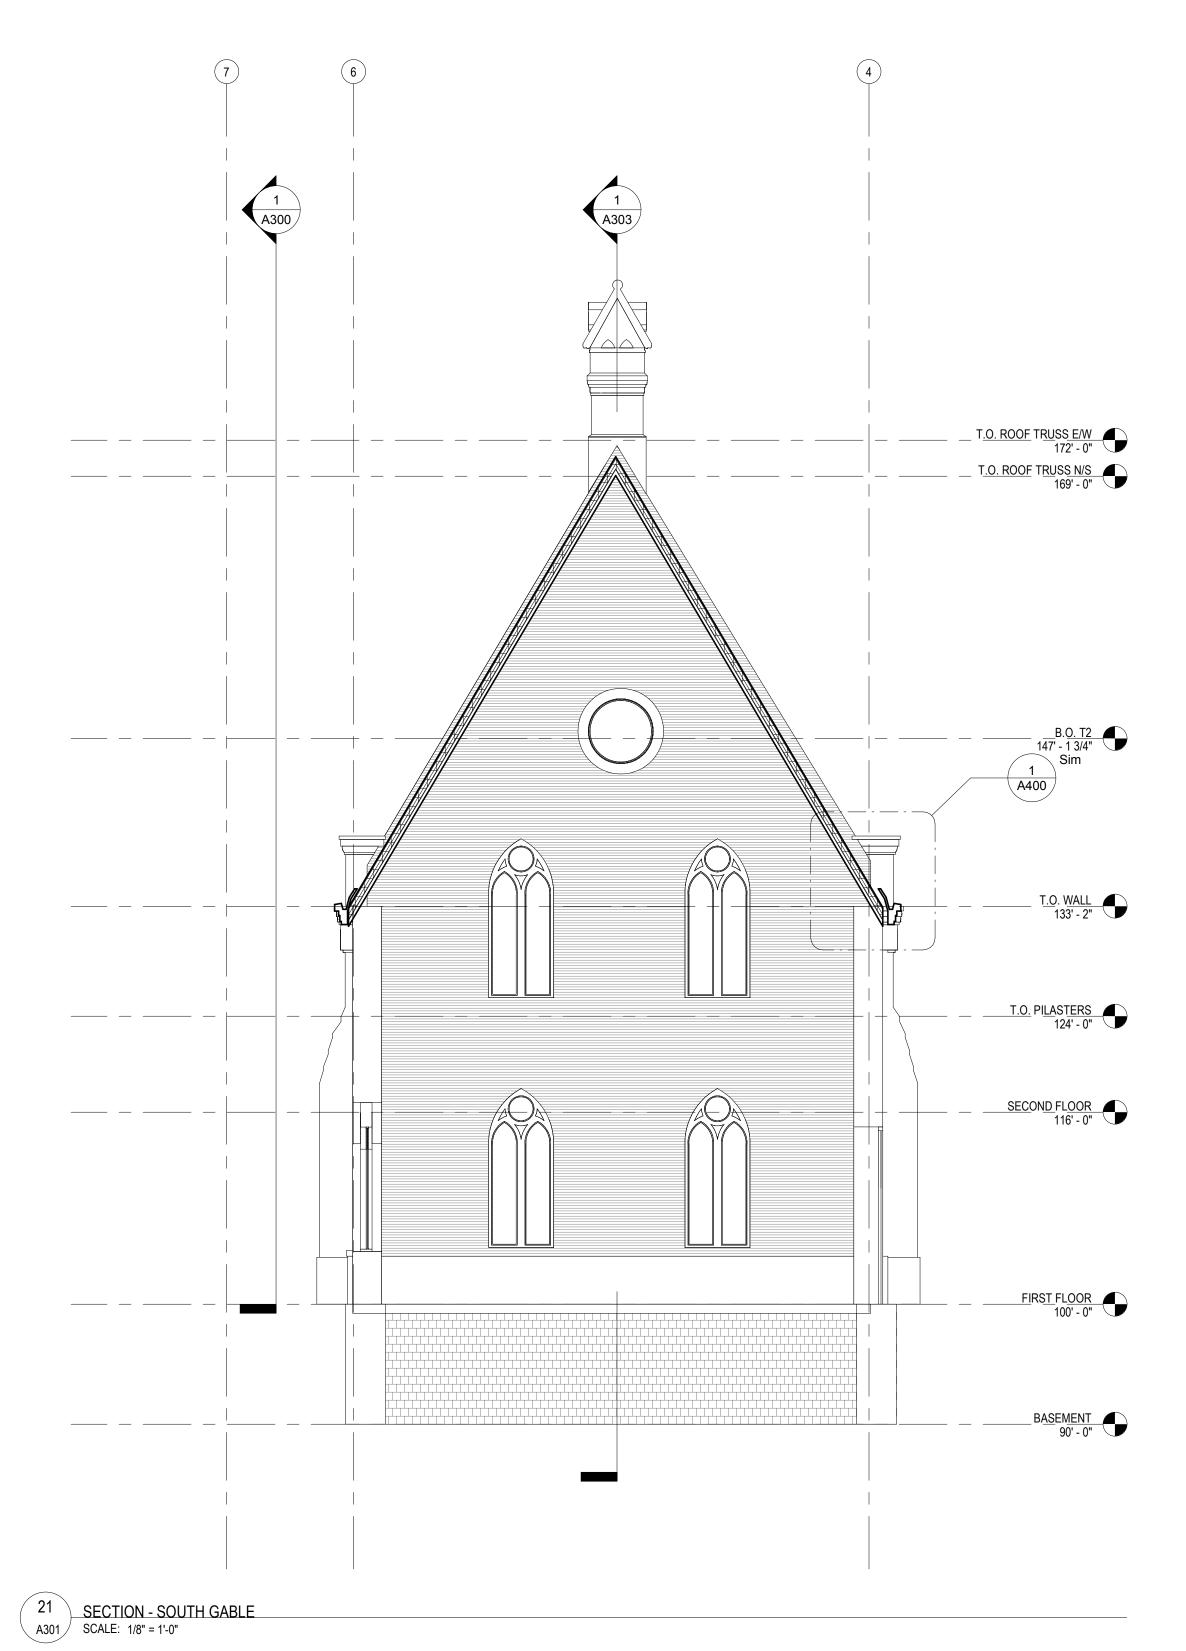1 DETAIL - T/O WALL AND GUTTER - WEST SCALE: 3" = 1'-0"

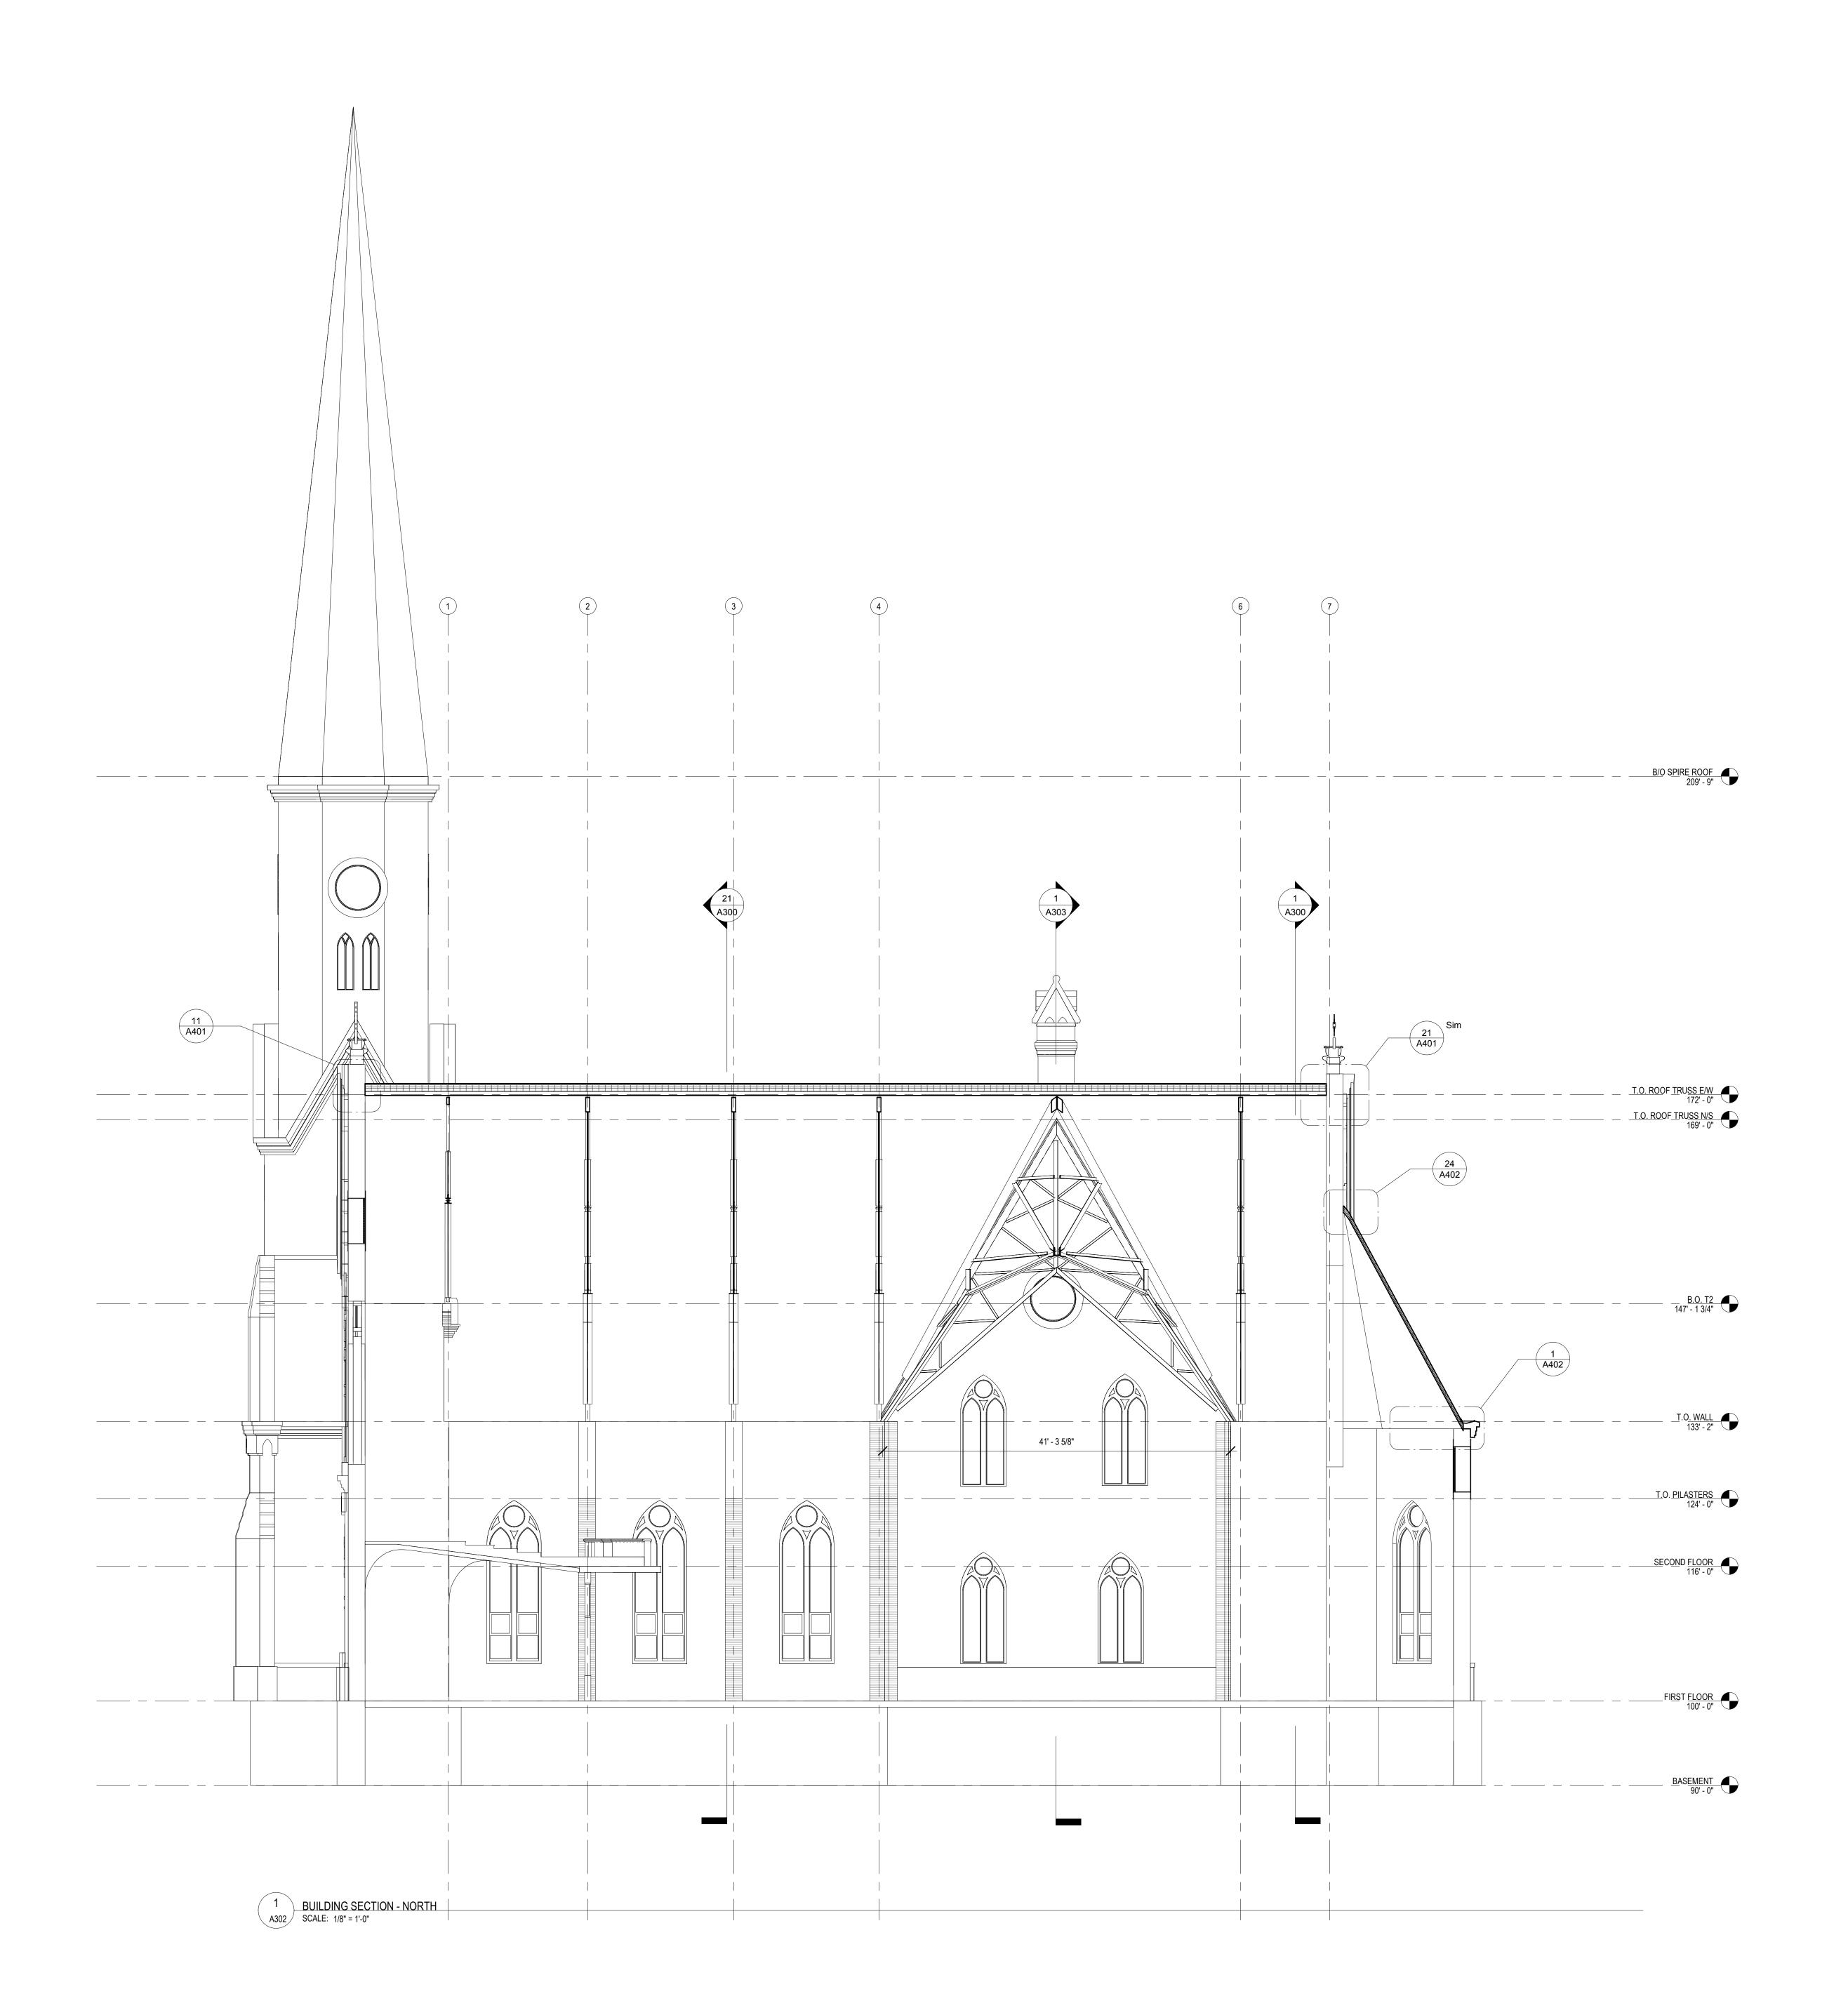A400

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- COPPER RIDGE COVER PROFILE TBD

STANLESS STEEL BRACKET

GAP FOR VENTING

ROOF ASSEMBLY 1

STEEL TRUSS, SEE STRUCTURAL

STAINLESS STEEL SPRINGS 6" WIDE AT 4' O.C. MIN.

PROVIDE CLEARANCE FOR FUTURE SLATE SHINGLES AND 1"

TIGHT SEAL REQUIRED AT MITERED JOINTS, USE SPRAY FOAM INSULATION OR MANUFACTURER'S STANDARD METHOD FOR CLOSING ANY GAPS IN THE JOINT

20 GAUGE METAL TRANSITION PER STRUCTURAL

OWNERSHIP OF DOCUMENTS

This document, and the ideas and designs incorporated herein,

TRINITY RESTOR

DETAILS


SHEET

09/21/2018


PROJECT NO.

18-122


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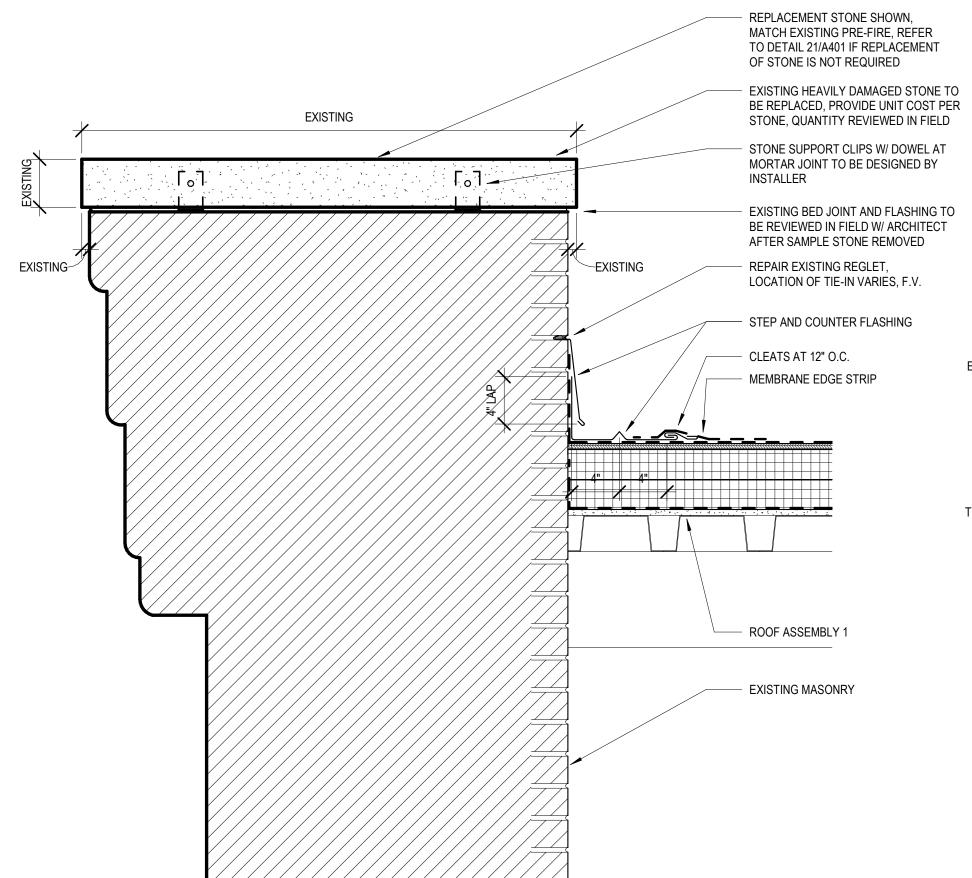


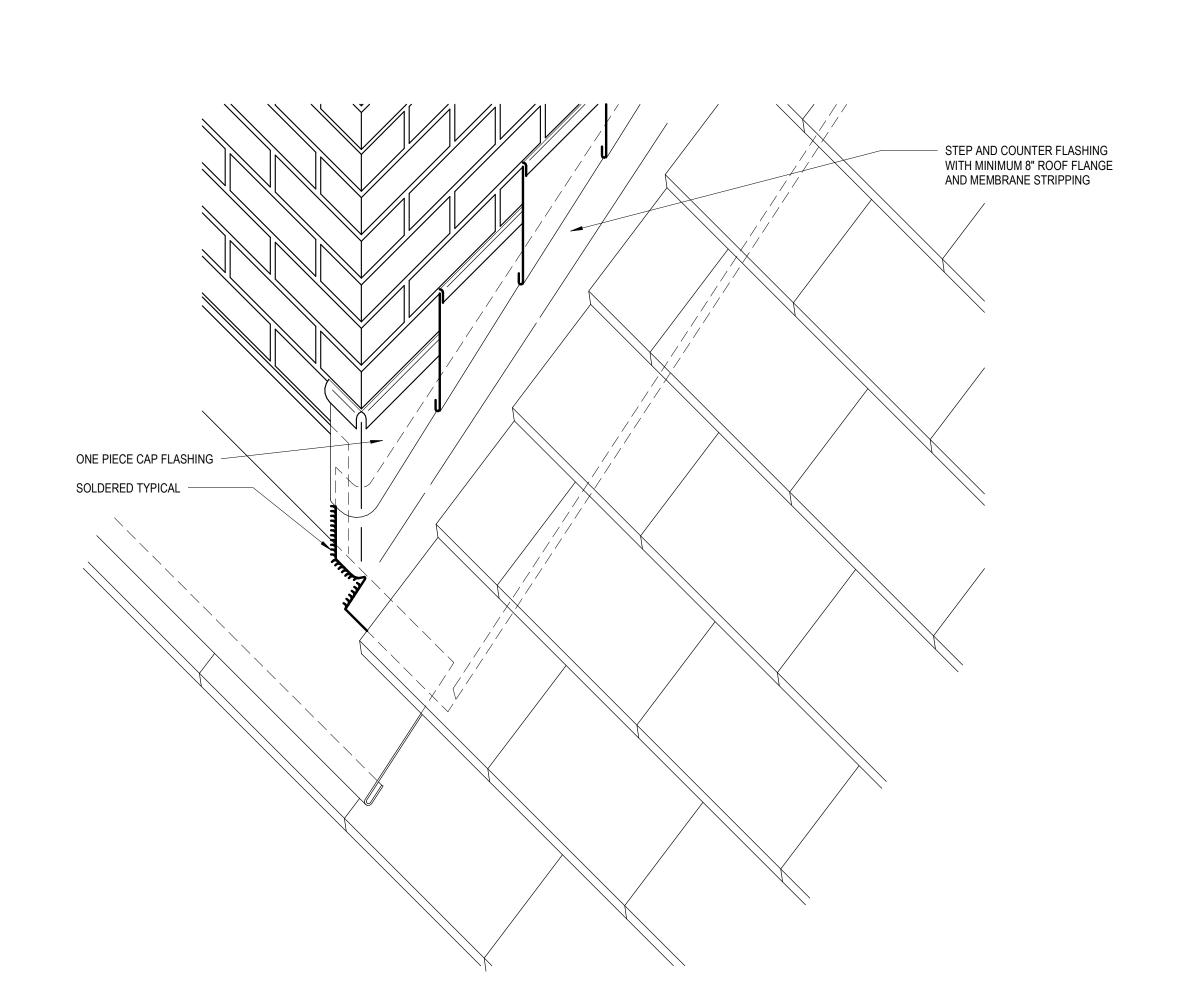
2
A401
DETAIL - FLASHING ALONG TOWER
SCALE: 1 1/2" = 1'-0"



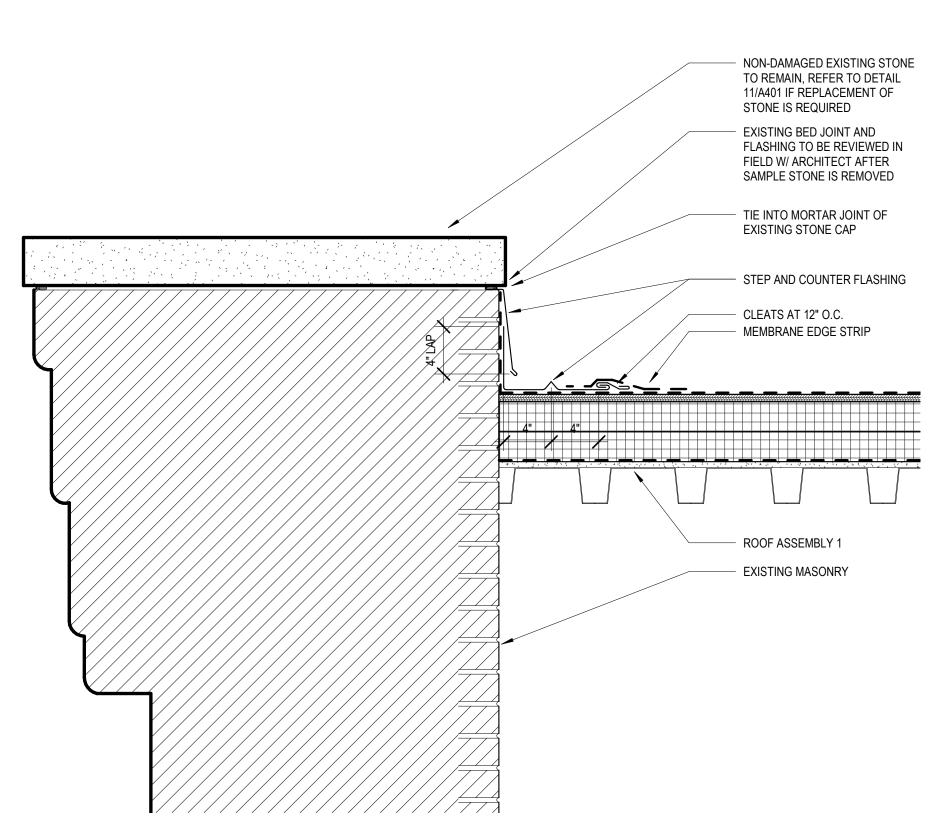



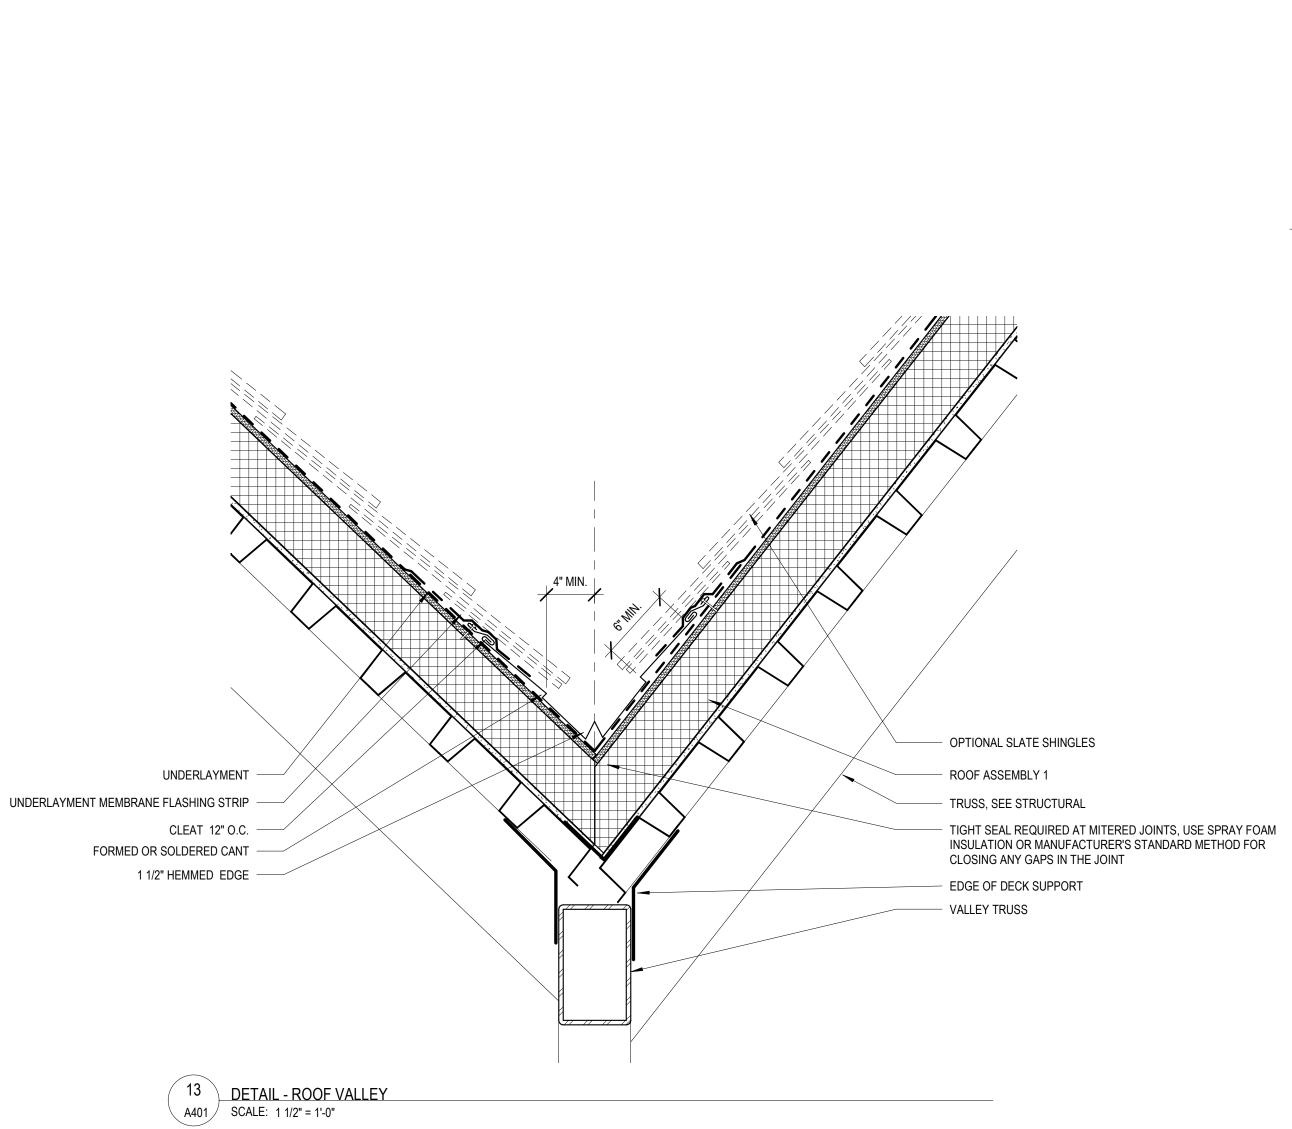

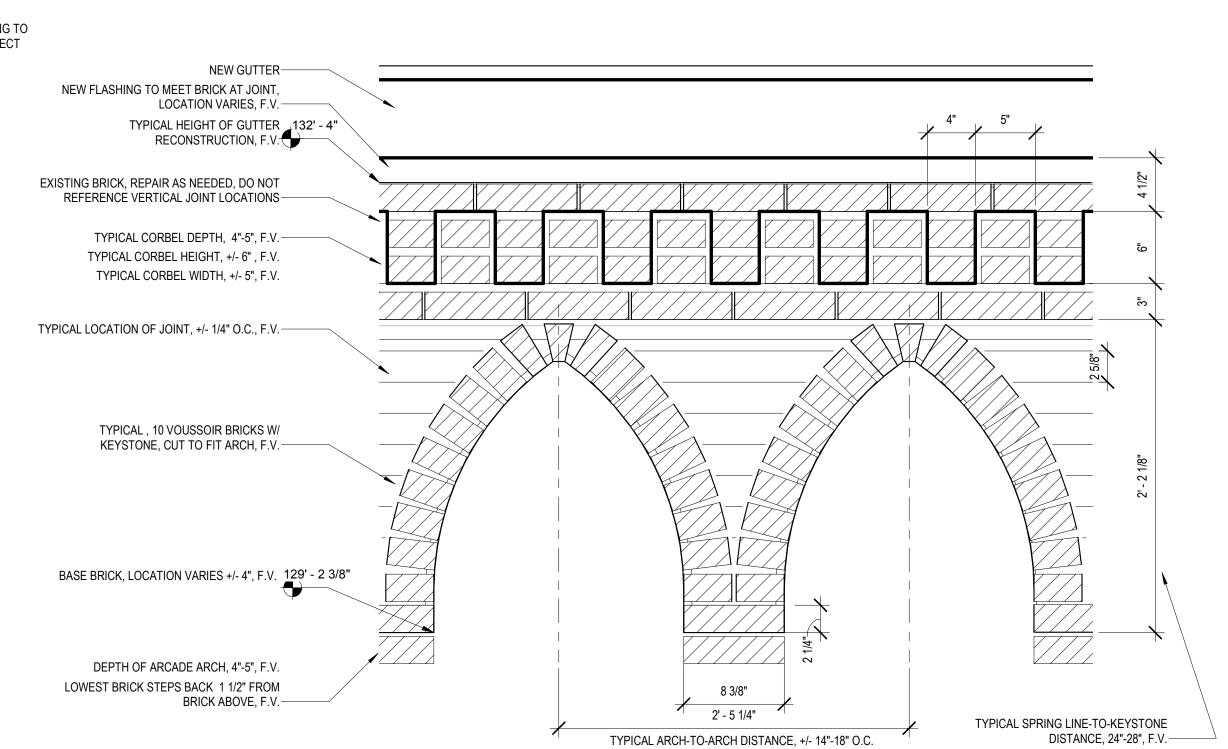



DETAIL - GABLE STONE CAP TYP AND ROOF CONNECTION TO WEST GABLE

SCALE: 1 1/2" = 1'-0"


ROOF ASSEMBLY 1

1 DETAIL - ARCADE GOTHIC CORNICE
SCALE: 1 1/2" = 1'-0"

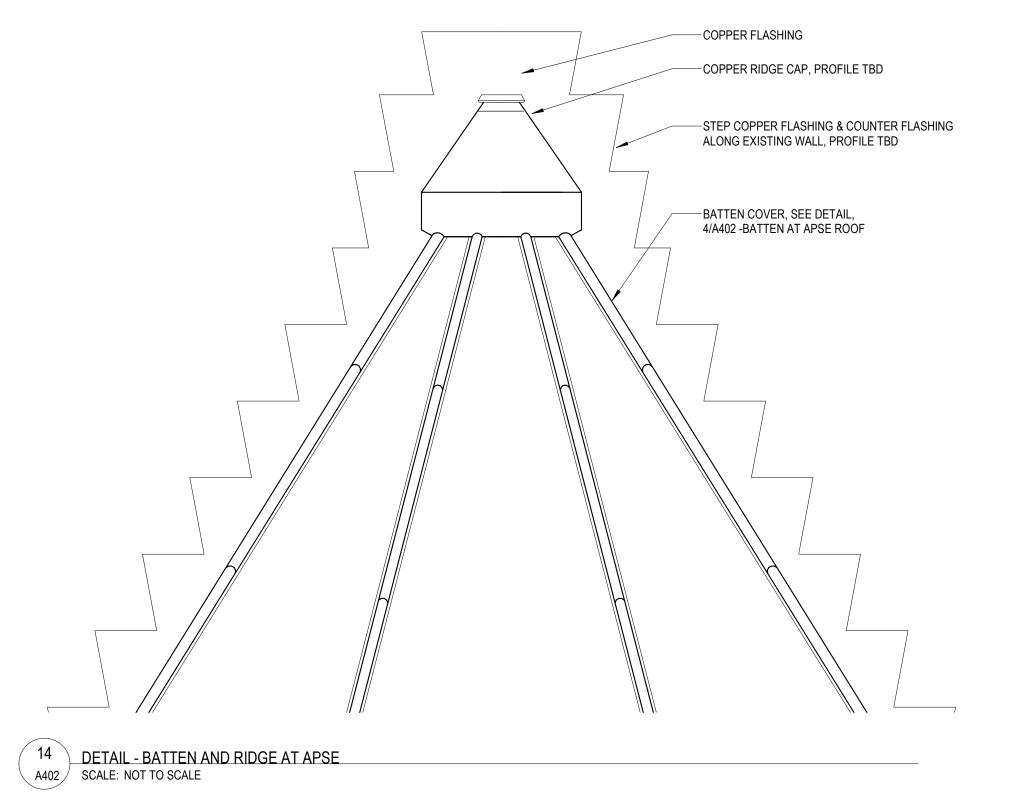

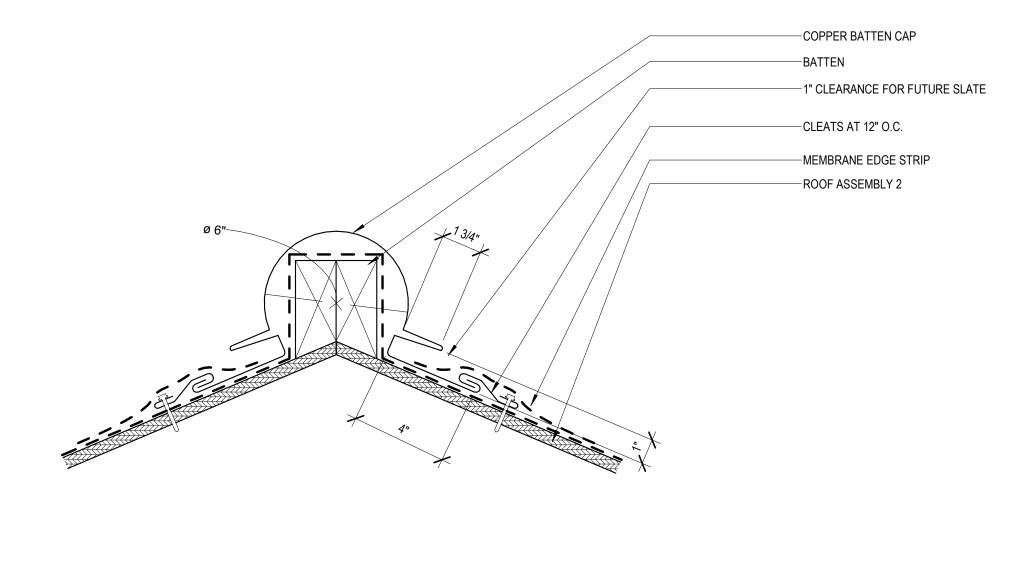

4 DETAIL - RIDGE BATTEN CAP AT APSE ROOF
SCALE: 3" = 1'-0"

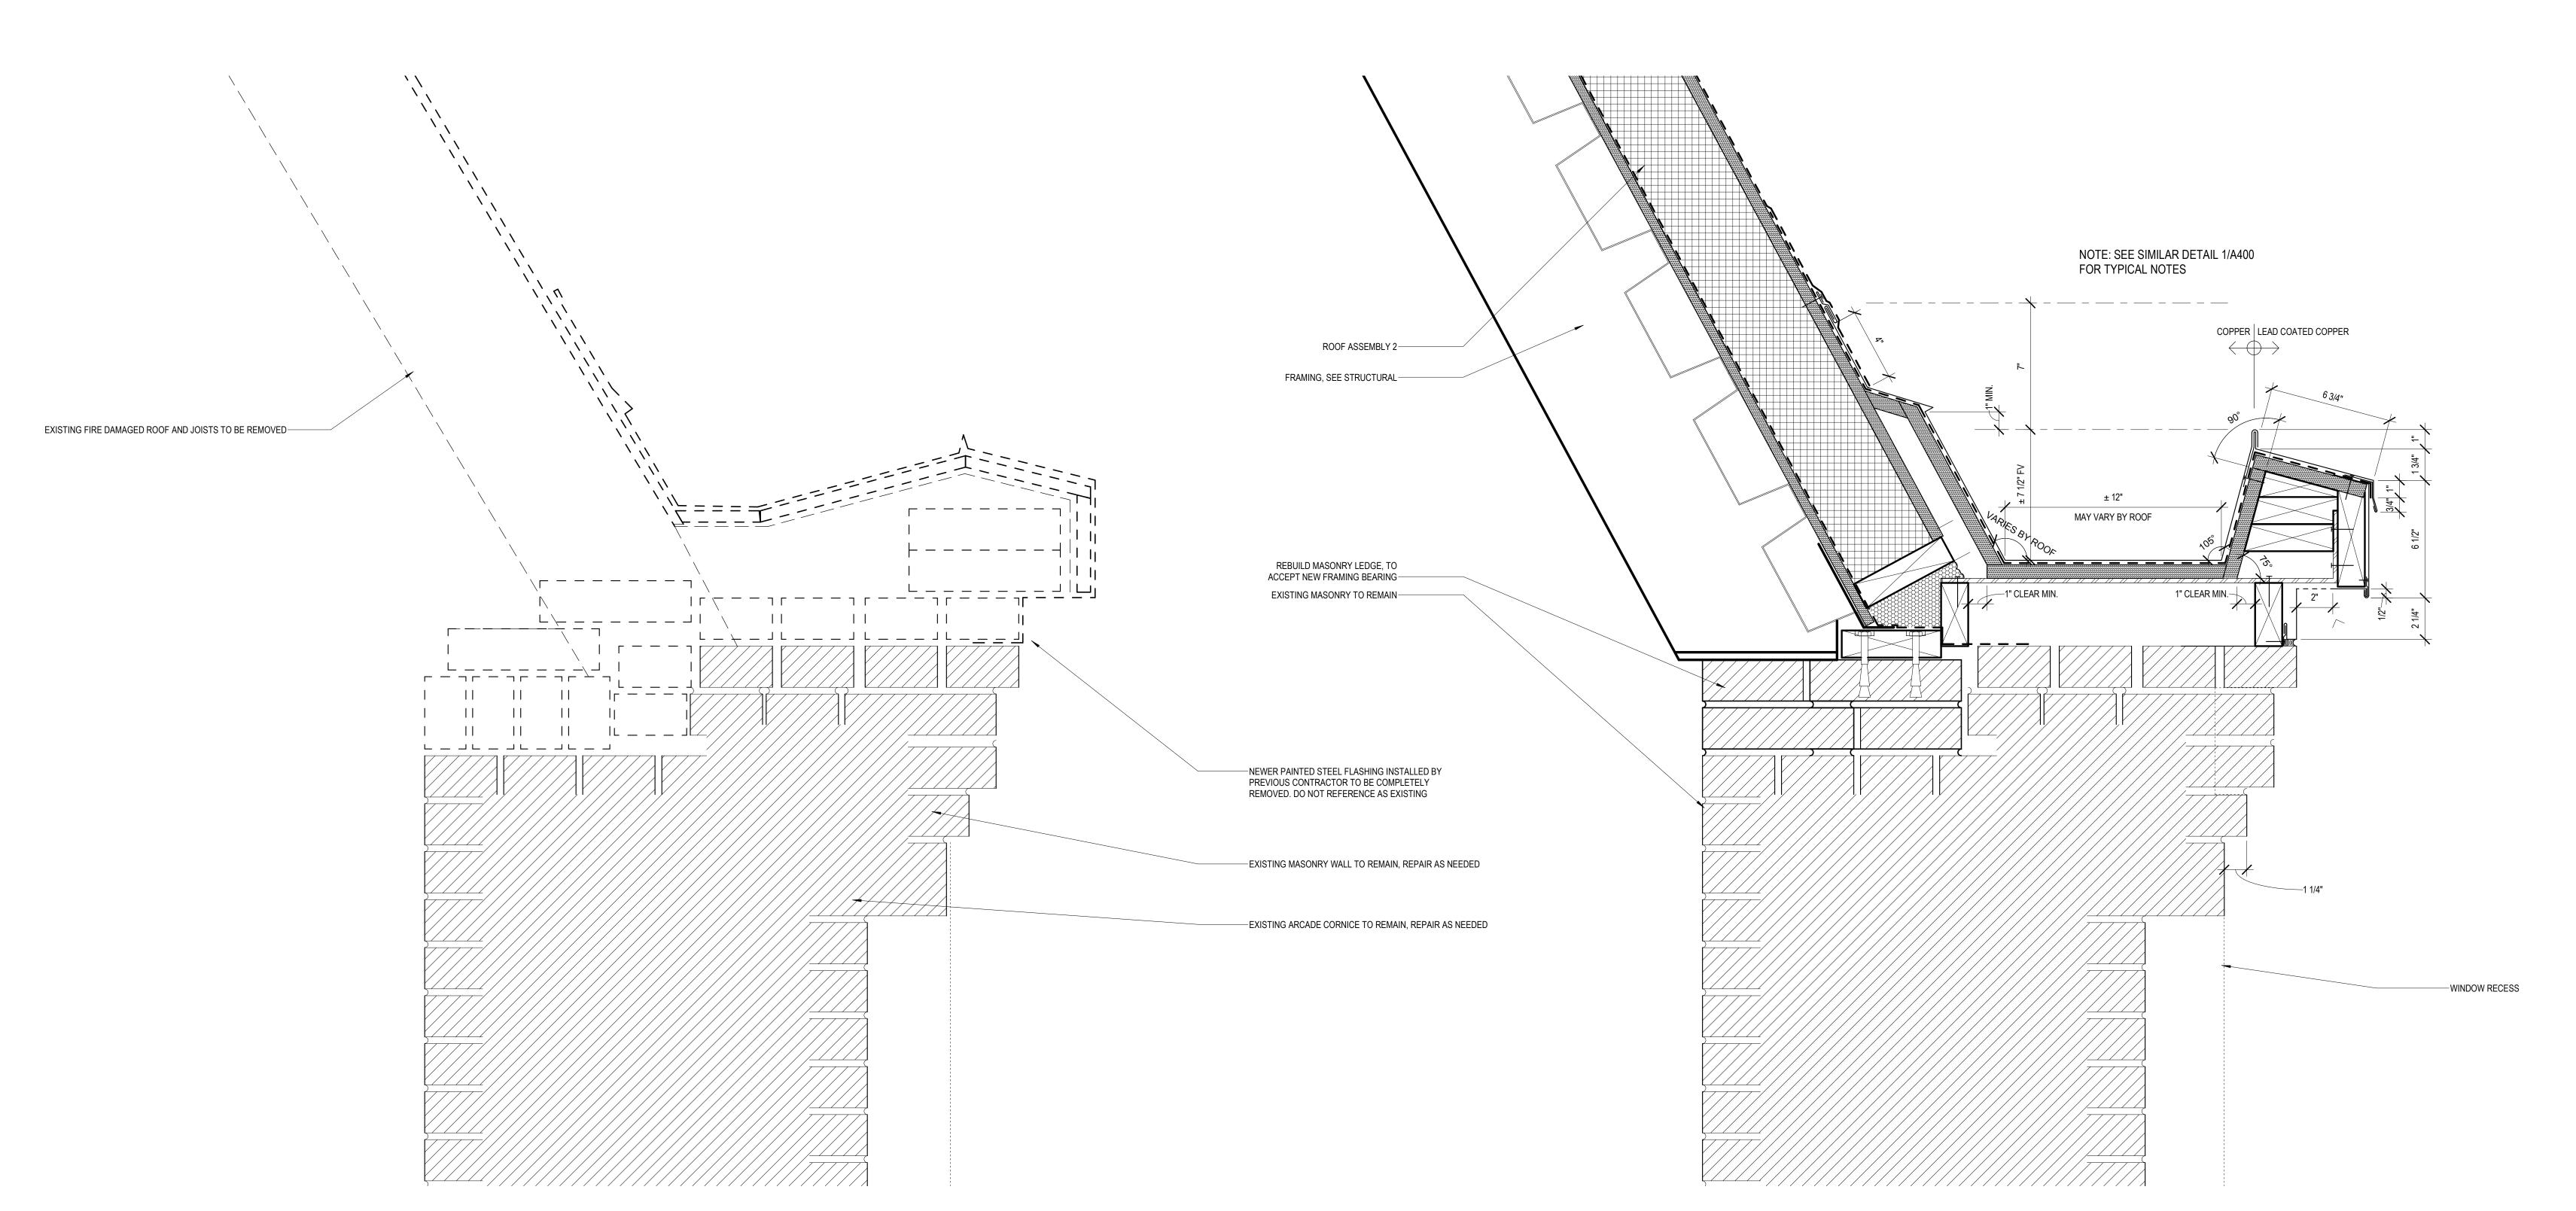

TRINITY EVANGELICAL LUTHERAN CHURCH
RESTORATION

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No. Date:

1 10/11/2018 Addendum 1 2 10/30/2018 Addendum 2

SHEET **DETAILS**

09/21/2018

PROJECT NO. **18-122**

SHEET NO.

- 2. THE GENERAL CONTRACTOR AND SUBCONTRACTORS SHALL BE FAMILIAR WITH THE ENTIRE SET OF CONSTRUCTION DOCUMENTS (ARCHITECTURAL, CIVIL, ELECTRICAL, PLUMBING, STRUCTURAL, ETC.) IN ORDER TO PROVIDE ALL CONSTRUCTION AND MATERIALS FOR THIS PROJECT.
- 3. THE CONTRACTOR SHALL REFER TO OTHER DRAWINGS CONTAINED IN THE CONSTRUCTION DOCUMENTS FOR ADDITIONAL SPECIFIED MEMBERS, DIMENSIONS, ELEVATIONS, DETAILS, OPENINGS, INSERTS, SLEEVES, DEPRESSIONS, ETC. NOT SHOWN ON THE STRUCTURAL DRAWINGS, REQUIRED TO CONSTRUCT THIS PROJECT.
- 4. DETAILS SHOWN ON STRUCTURAL DRAWINGS SHALL BE APPLICABLE TO ALL PORTIONS OF THE CONTRACT DOCUMENTS UNLESS NOTED OTHERWISE.
- 5. NOTES AND DETAILS ON DRAWINGS SHALL TAKE PRECEDENCE OVER GENERAL STRUCTURAL NOTES AND TYPICAL DETAILS.
- 6. ALL LOADS AND REACTIONS SHOWN ON THE PLANS ARE SERVICE LOADS, UNLESS NOTED OTHERWISE.
- 7. DO NOT SCALE PLANS.
- 8. IN NO CASE SHALL STRUCTURAL ALTERATIONS OR WORK AFFECTING A STRUCTURAL MEMBER BE MADE UNLESS APPROVED BY THE STRUCTURAL ENGINEER.
- IT IS SOLELY THE CONTRACTOR'S RESPONSIBILITY TO DETERMINE ERECTION PROCEDURE AND CONSTRUCTION SEQUENCE IN ORDER TO ENSURE
 THE SAFETY OF THE BUILDING AND WORKMEN DURING CONSTRUCTION (MEANS AND METHODS OF CONSTRUCTION). THIS INCLUDES, BUT IS NOT
 LIMITED TO: SHORING, UNDERPINNING, TEMPORARY BRACING, ETC.
- 10. CONSTRUCTION DOCUMENTS SHOW DIMENSIONS AND ELEVATIONS TO SIGNIFICANT WORKING POINTS (COLUMN CENTERLINES, OUTSIDE FACE OF WALLS, TOP OF FRAMING MEMBERS, ETC.) MATERIAL SUPPLIERS AND DESIGNERS ARE RESPONSIBLE FOR ALL OTHER INFORMATION IN ORDER TO DETAIL/FABRICATE THEIR WORK. CONTACT THE ARCHITECT WITH ANY DISCREPANCIES.
- 11. IN THE EVENT OF ANY DISCREPANCIES BETWEEN THE STRUCTURAL DRAWINGS AND ANY OTHER PLANS CONTAINED IN THIS SET OF CONSTRUCTION DOCUMENTS, THE CONTRACTOR SHALL BRING THE DISCREPANCY TO THE ARCHITECTS ATTENTION IMMEDIATELY, IN WRITING.
- 12. NO PROVISIONS HAVE BEEN MADE IN THE DESIGN OF THIS STRUCTURE FOR FUTURE EXPANSION, UNLESS SPECIFICALLY NOTED ON PLAN.

ALL EXISTING FRAMING SHOWN ON THESE DRAWINGS IS BASED ON AVAILABLE DOCUMENTATION AND FIELD OBSERVATION TO DATE. CONTRACTOR SHALL FIELD VERIFY ALL SIZES, DIMENSIONS, ELEVATIONS, AND CONFIGURATIONS OF EXISTING STRUCTURAL ELEMENTS (COLUMNS, BEAMS, WALLS, ETC.) AS NECESSARY TO PROPERLY INSTALL ALL NEW STRUCTURAL ELEMENTS AS SHOWN. COORDINATE DIFFERENCES BETWEEN FIELD CONDITIONS

- AND STRUCTURAL DRAWINGS WITH STRUCTURAL ENGINEER PRIOR TO PROCEEDING WITH WORK, AND PROCUREMENT/FABRICATION OF MATERIALS.

 2. CONTRACTOR SHALL FIELD VERIFY EXISTING CONDITIONS AND NOTIFY ARCHITECT AND STRUCTURAL ENGINEER OF ANY CONFLICTS WITH CONSTRUCTION DOCUMENTS.
- 3. REMOVE AND REPLACE AND/OR MODIFY ALL EXISTING CONSTRUCTION (ARCHITECTURAL, STRUCTURAL, ELECTRICAL, AND MECHANICAL) AS REQUIRED IN ORDER TO PLACE NEW STRUCTURAL WORK SHOWN ON THE CONSTRUCTION DOCUMENTS. DO NOT MODIFY STRUCTURAL COMPONENTS UNLESS DETAILED ON THE CONSTRUCTION DOCUMENTS.
- 4. IT IS SOLELY THE CONTRACTOR'S RESPONSIBILITY TO DETERMINE ERECTION PROCEDURE AND CONSTRUCTION SEQUENCE IN ORDER TO ENSURE THE SAFETY OF THE BUILDING AND WORKMEN DURING CONSTRUCTION (MEANS AND METHODS OF CONSTRUCTION). THIS INCLUDES, BUT IS NOT LIMITED TO: SHORING, UNDERPINNING, TEMPORARY BRACING, ETC. CONTRACTOR SHALL DESIGN AND PROVIDE ALL SHORING REQUIRED TO SUPPORT EXISTING CONSTRUCTION AND NEW CONSTRUCTION AS REQUIRED TO BUILD THIS PROJECT.

STRUCTURAL STEEL:
DESIGN, FABRICATION, AND ERECTION SHALL CONFORM TO AISC (AMERICAN INSTITUTE OF STEEL CONSTRUCTION) "STEEL CONSTRUCTION MANUAL".
EDITION AS SPECIFIED BY CODE.

- 2. STEEL DETAILING AND CONNECTIONS SHALL CONFORM TO THE REQUIREMENTS OF AISC 360 "SPECIFICATIONS FOR STRUCTURAL STEEL BUILDINGS". EDITION AS SPECIFIED BY CODE, ALLOWABLE STRESS DESIGN.
- 3. BEAM AND GIRDER CONNECTIONS SHALL BE DETAILED AS NOTED ON PLANS AND DETAILS.
- 4. STEEL FABRICATOR SHALL DESIGN CONNECTIONS NOT SPECIFICALLY DETAILED ON PLANS AS FOLLOWS:
 A. MEMBER SHEAR CONNECTIONS: UNLESS A LARGER VERTICAL END REACTION IS SHOWN ON THE DRAWINGS (i.e. R = 85k), MINIMUM DESIGN SHEAR FORCES SHALL BE A NON-COMPOSITE SUPPORT REACTION "R" EQUAL TO ONE HALF THE TOTAL UNIFORM LOAD CAPACITY FROM THE TABLE OF UNIFORM LOAD CONSTANTS IN THE AISC MANUAL PART 2 FOR THE GIVEN SHAPE, SPAN, AND GRADE OF STEEL.
- B. MEMBERS REQUIRING END MOMENT CONNECTIONS SHALL MEET THE REQUIREMENTS OF TYPE 1 "RIGID FRAME" CONSTRUCTION INCLUDING FRICTION BOLTS IF UTILIZED. ALL OTHER MEMBERS SHALL FOLLOW THE REQUIREMENTS OF TYPE 2 "SIMPLE" CONSTRUCTION.
- 5. ALTERNATE CONNECTIONS FROM WHAT IS SPECIFIED ON THE CONSTRUCTION DOCUMENTS WILL NOT BE ACCEPTED WITHOUT WRITTEN APPROVAL FROM THE STRUCTURAL ENGINEER.
- 6. WELDING SHALL BE PERFORMED BY CERTIFIED WELDERS HOLDING CURRENT AWS CERTIFICATES IN THE TYPES OF WELDING SPECIFIED ON THE CONSTRUCTION DOCUMENTS.
- 7. ALL STEEL BEAMS SHALL BE FABRICATED WITH THE NATURAL CAMBER (WITHIN MILL TOLERANCE) IN THE UPWARD VERTICAL DIRECTION.
- 8. PROVIDE 3/16" CAP PLATE AT THE ENDS OF ALL EXPOSED TUBE AND PIPE MEMBERS, UNLESS NOTED OTHERWISE.

UNLESS NOTED OTHERWISE, FRAME THE LARGEST BEAM OVER COLUMNS AT BEAM TO BEAM INTERSECTIONS.

- 9. PROVIDE STIFFENER PLATES ON BOTH SIDES OF BEAM WEBS AT ALL CONCENTRATED LOADS ABOVE AND BELOW A BEAM. UNLESS NOTED OTHERWISE, FRAME THE LARGEST BEAM OVER COLUMNS AT BEAM TO BEAM INTERSECTIONS.
- 10. SPLICES SHALL BE ALLOWED ONLY AT LOCATIONS INDICATED ON THE STRUCTURAL DRAWINGS, UNLESS APPROVED BY THE STRUCTURAL ENGINEER.
- 11. CONTRACTOR SHALL ELECTRONICALLY SUBMIT STEEL SHOP DRAWINGS FOR APPROVAL PRIOR TO FABRICATION. CONTRACTOR SHALL REVIEW AND STAMP ALL SHOP DRAWINGS BEFORE SUBMITTING TO THE ARCHITECT.
- 12. STAIRS, HANDRAILS, AND GUARDRAILS SHALL BE DELEGATED DESIGN BY THE STEEL SUPPLIER. CONNECTIONS INTO SURROUNDING STRUCTURE SHALL BE APPROVED BY STRUCTURAL ENGINEER. CALCULATIONS OF ALL STAIR COMPONENTS MUST BE SUPPLIED WITH STAIR SHOP DRAWINGS AND STAMPED BY THE PROFESSIONAL ENGINEER IN RESPONSIBLE CHARGE, IN THE STATE IN WHICH THE PROJECT IS LOCATED.
- 13. CONTRACTOR SHALL DETERMINE, FURNISH AND INSTALL ANY TEMPORARY BRACING OR GUYS REQUIRED TO ERECT STEEL MEMBERS. TEMPORARY BRACING SHALL BE LEFT IN PLACE UNTIL THE PERMANENT STRUCTURE IS IN PLACE AND SECURE. REFER TO PLAN NOTES FOR DESCRIPTION OF LATERAL SYSTEM.
- 14. STRUCTURAL STEEL FRAMING SHALL BE TRUE AND PLUMB BEFORE CONNECTIONS ARE FINALLY BOLTED OR WELDED.
- 15. ANY HOLES, CUTS, OR COPING FIELD CUT INTO STEEL MUST BE VERIFIED WITH THE STRUCTURAL ENGINEER PRIOR TO WORK. CONTRACTOR SHALL COORDINATE ALL HOLES REQUIRED BY OTHERS WITH THE STRUCTURAL ENGINEER.
- 16. THE STEEL SUPPLIER SHALL COORDINATE HIS WORK WITH OTHER DELEGATED DESIGN COMPONENTS (i.e. STEEL JOISTS, PRECAST CONCRETE, ETC.).
- 1. DECK, ACCESSORIES, AND ATTACHMENTS SHALL CONFORM WITH THE CURRENT EDITION OF "STEEL DECK INSTITUTE SPECIFICATIONS".
- 2. PROVIDE SUPPORT AT COLUMNS AS REQUIRED FOR DECK SUPPORT. PROVIDE L2x2x3/16 MINIMUM.
- 3. AT OPENINGS IN DECK LESS THAN 12"x12", PROVIDE A 16 GAUGE COVER PLATE FASTENED TO DECK WITH #12 TEK SCREWS.
- 4. AT CHANGE IN DECK DIRECTION, PROVIDE A 20 GAUGE x 9" WIDE CONTINUOUS PLATE. PROVIDE SAME PLATE AT ALL RIDGES, VALLEYS, AND HIPS BENT TO MATCH PROFILE OF ROOF.

BUILDING DESIGN LOADS/CRITERIA	TRUSS MEMBER SCHEDULE			
ROOF SNOW LOADS & DESIGN DATA:		MARK STRUCTURAL STEEL:		
DESIGN ROOF SNOW LOAD	20 psf (BALANCED SNOW LOAD)	ROLLED WIDE FLANGE SHAPES, ASTM A992 GRADE 50	Fy = 50,000 PSI	
FLAT ROOF SNOW LOAD (Pf) = (0.7*Ce*Ct*ls*Pg)	5.5 psf	CHANNELS, ANGLES, AND S SHAPES, ASTM A36	Fy = 36,000 PSI	
SNOW EXPOSURE FACTOR (Ce)	1.0	PLATE AND BAR, ASTM A36	Fy = 36,000 PSI	
SNOW LOAD IMPORTANCE FACTOR (Is)	1.0	TUBE SHAPES, ASTM A500 GRADE B	Fy = 46,000 PSI	
ROOF THERMAL FACTOR (Ct)	1.0	PIPE ASTM A53, TYPE E or S, GRADE B	Fy = 35,000 PSI	
GROUND SNOW (Pg)	30 psf	ALL OTHER ROLLED SHAPES, ASTM A36	Fy = 36,000 PSI	
RAIN ON SNOW SURCHARGE	0		•	
SLOPED ROOF FACTOR (Cs)	0.25	STRUCTURAL BOLTS:		
		HIGH STRENGTH BOLTS, NUTS, & WASHERS	ASTM A325	
WIND DESIGN DATA:		ZINC-COATED HIGH STRENGTH BOLTS, NUTS, &	ASTM A325	
WIND IMPORTANCE FACTOR (Iw)	1.0 MPH	WASHERS		
NOMINAL WIND SPEED	90 MPH	STAINLESS STEEL BOLTS, NUTS, & WASHERS	ASTM F593	
WIND DIRECTIONALITY FACTOR (Kd)	0.85	SHEAR CONNECTORS (GRADES 1015 THRU 1020)	ASTM A108	
MEAN ROOF HEIGHT	53 FT	THREADED RODS	ASTM A36	
WIND EXPOSURE CATEGORY	В	CLEVIS & TURNBUCKLES (GRADE 1035)	ASTM A108	
WIND EXPOSURE CLASSIFICATION	ENCLOSED	EYE BOLTS & NUTS (GRADE 1030)	ASTM A108	
INTERNAL PRESSURE COEFFICIENT	+/-0.18	ANCHOR BOLTS (GRADE 36)	ASTM F1554	
BUILDING LENGTH (L)	155 FT			
LEAST WIDTH (B)	57 FT	WELDED CONNECTIONS:		
VELOCITY PRESSURE EXPOSURE COEFFICIENT Kh (CASE 1)	0.89	WELDING ELECTRODES	E70XX	
VELOCITY PRESSURE EXPOSURE COEFFICIENT Kh (CASE 2)	0.89			
TOPOGRAPHIC FACTOR (Kzt)	1.0	MASONRY:	fm = 2,000 PSI	
EDGE STRIP (a)	6 FT			
END ZONE (2a)	12 FT	MASONRY MORTAR:		
DESIGN PROCEDURE	METHOD 1 (SIMPLIFIED PROCEDURE)	TYPE "M" MORTAR BELOW GRADE		
		TYPE "M" or "S" ABOVE GRADE		

GROUT BELOW BASE PLATES & BEARING PLATES:NONMETALLIC, SHRINKAGE-RESISTANT

ASTM C1107

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TRINITY EVANGELICAL LUTHERAN CHURCH RESTORATION

SHEET

GENERAL

NOTES &

DESIGN

CRITERIA


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SHEET NO.

S001



w/ 5/8" SPACER AT 2'-6" o/c, TYP.

TRUSS BOTTOM

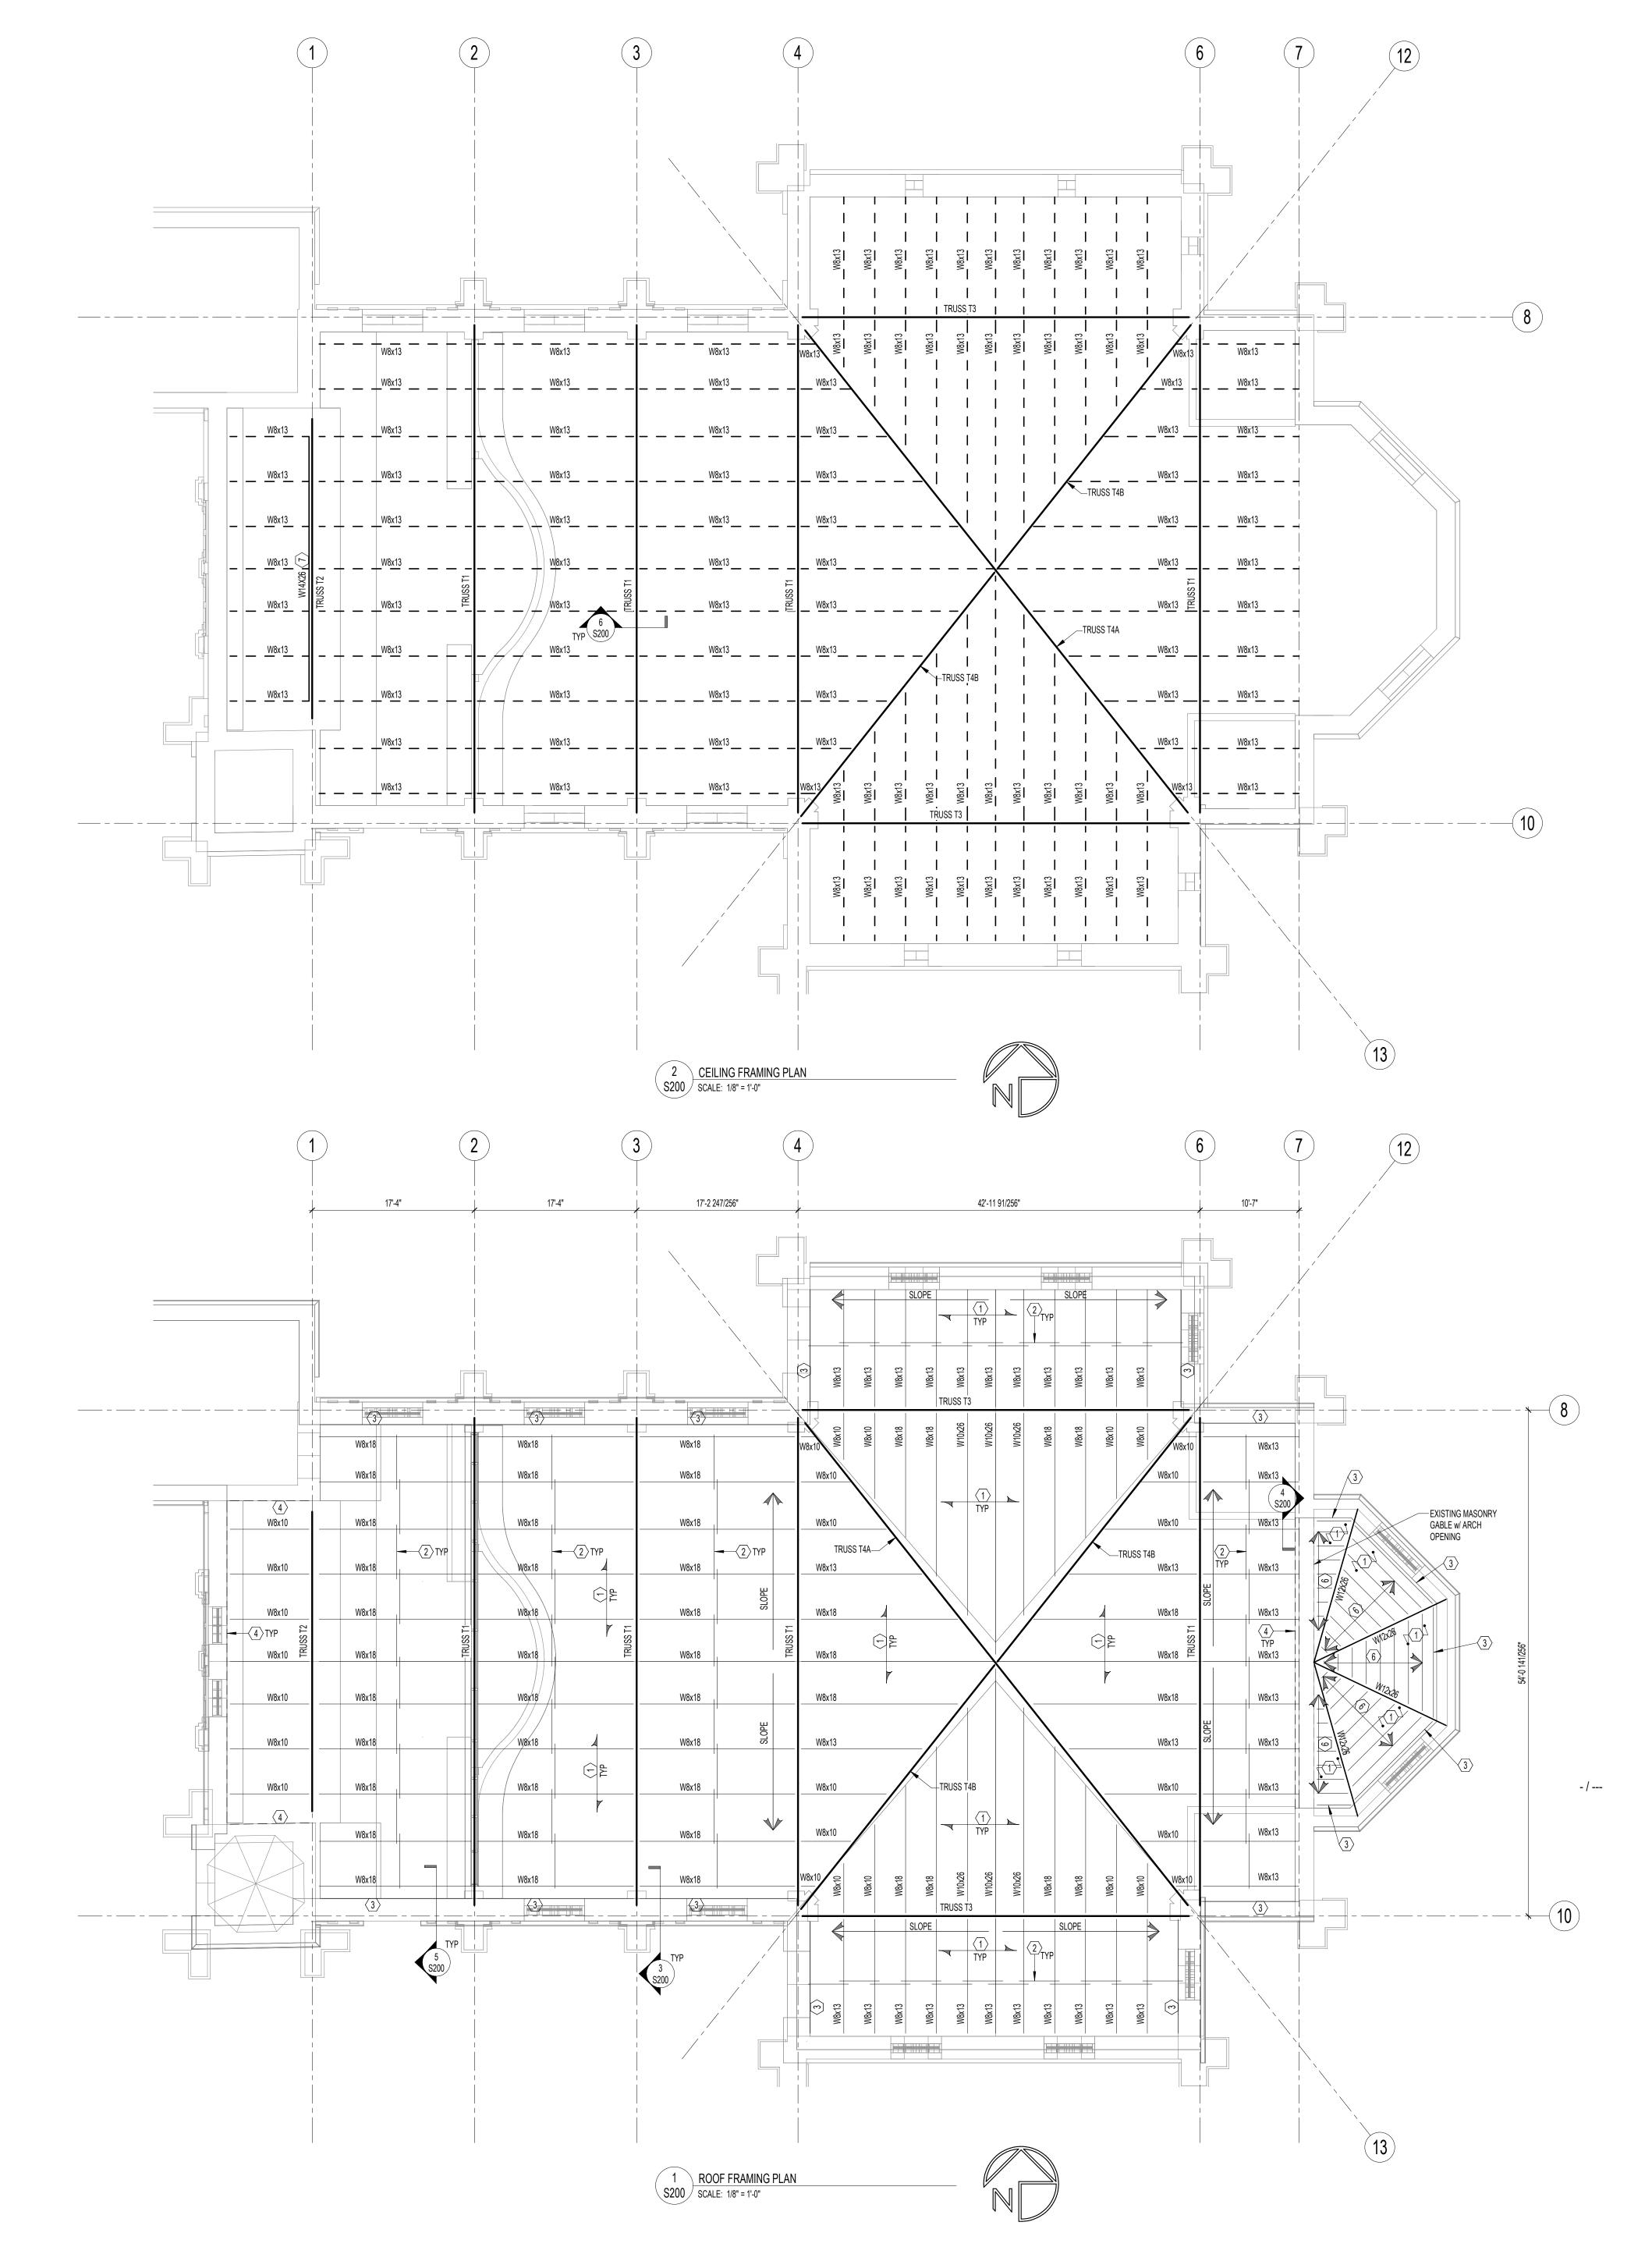-4x4x5/16 CONT. BENT PLATE w/ 1/2" DIA. WEDGE BOLT AT 1'-4" oc. 4" EMBED, TYP

(2) 3/4" DIA. A325 – T BOLTS, TYP.

EXISTING WALL-

5 S200 DECK BEARING DETAIL

4 S200 PURLIN END CONNECTION DETAIL

NEW MASONRY BUILD-UP-TO MATCH EXISTING.

EXISTING STONE -

COPING TO REMAIN.

EXISTING MASONRY-

EXISTING MASONRY-BUTTRESS TO REMAIN.

3 S200 TRUSS BASE CONNECTION DETAIL

WALL TO REMAIN.

—1/2" DIA. WEDGE BOLTS, 8" oc.

NEW STEEL TRUSS-

SEE TRUSS DETAILS-

—(6) 3/4" DIA. ADHESIVE

- NEW CONCRETE CAP

- NEW CONCRETE PIER TIED TO EXISTING WALL. PROVIDE (2) #5 VERTICAL

REINFORING w/ 90 DEG HOOK

-- (2) #5 DOWELS w/ EPOXY GROUT AT 1'-4" OC VERTICALLY. 6" EMBED, TYP.

1'-0" TYP, U.N.O.

6 S200 CEILING BEAM/JOIST BEARING DETAIL

STEEL FRAMING PLAN NOTES:

PLAN NOTES APPLY TO ALL STEEL ROOF FRAMING PLANS. ALL NOTES DO NOT NECESSARILY APPLY TO ALL SHEETS. . SEE ARCHITECTURAL DRAWINGS FOR NEW ROOFING COMPOSITION & DETAILS.

2. REFER TO SHEETS S400, S401, S402 & S403 FOR TRUSS PROFILES, MEMBER SIZES & CONNECTION DETAILS.

3. AFTER INSTALLATION OF NEW STEEL TRUSSES AND ROOF DECKING, EXISTING TEMPORARY STEEL WALL BRACING CAN BE SAFELY REMOVED.

4. PLUG ALL ANCHOR HOLES AFTER REMOVAL OF TEMPORARY WALL BRACING WITH

STEEL FRAMING PLAN KEYED NOTES:

KEYED NOTES APPLY TO ALL STEEL ROOF FRAMING PLANS. ALL NOTES DO NOT NECESSARILY APPEAR ON ALL SHEETS.

3N x 22 GA. GALV. METAL DECK, 3 SPAN (MIN.) CONDITION. USE 5/8" PUDDLE WELD IN 24/4 PATTERN AND (3)#10 TEK SCREWS SIDELAP FASTENERS PER SPAN.

2 3/4" DIA. SAG ROD AT MID-SPAN.

COMPATIBLE EPOXY.

3 CONT. DOWNTURNED DECK BEARING BENT PLATE (4x4x5/16) WITH 1/2" DIA. WEDGE BOLT AT 1'-4" OC, 4" EMBED, TYP.

4 1'-0" LONG DOWNTURNED DECK BEARING L4x4x5/16 WITH (2)1/2" DIA. WEDGE BOLTS, 4" EMBED, TYP.

5 ROOF SHEATHING SHALL BE 5/8" APA RATED WOOD ROOF SHEATHING (PLYWOOD OR OSB). ATTACH SHEATHING TO ROOF PURLINS w/ SIMPSON STRONG DRIVE TB 1460S AT 1'-0" o/c. PROVIDE WOOD SHEATHING CLIPS WHERE SHEATHING EDGES ABUT BETWEEN ROOF PURLINS. STAGGER ALL ROOF SHEATHING JOINTS.

(6) W8X10 PURLINS.

7 WIDE FLANGE BEAM TO SPAN HORIZONTALLY BETWEEN TRUSS T2 BOTTOM CHORDS. BOTTOM OF STEEL ELEVATION TO MATCH CEILING APEX OF TRUSS T1.

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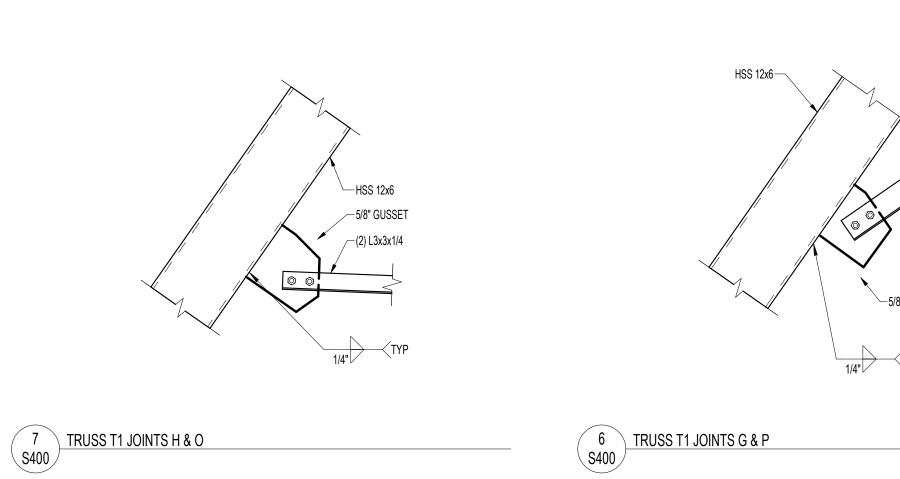



ROOF FRAMING PLAN

DATE

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PROJECT NO. 18-122



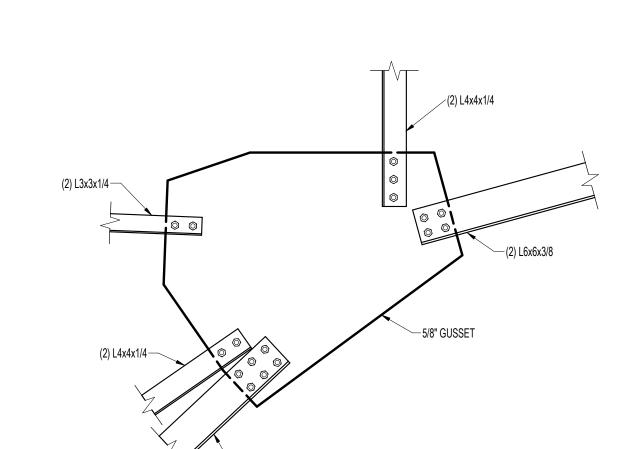


TRUSS T1 JOINTS D & F

9 S400 TRUSS T1 JOINTS J & M


HSS 12x6


10 S400 TRUSS T1 JOINTS K & L

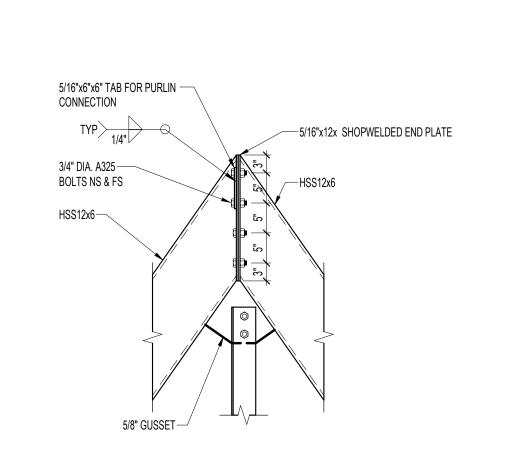

8 S400 TRUSS T1 JOINTS I & N

3 S400 TRUSS T1 JOINT B

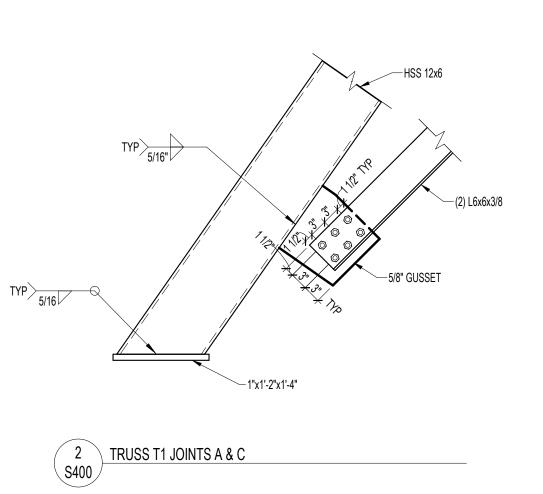

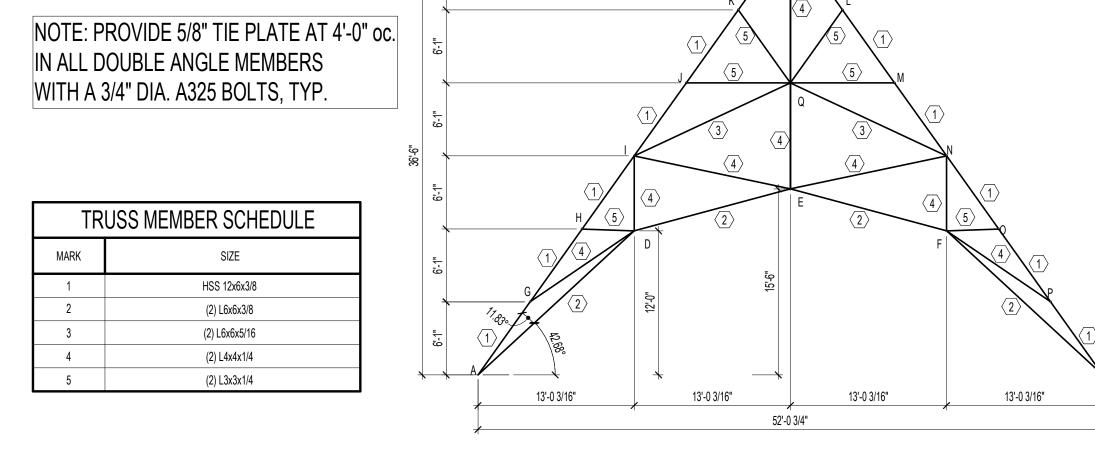

1 TRUSS T1

DATE 09/21/2018 PROJECT NO. 18-122

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PE PROJECT: 18363

Description:

ADDENDUM 1

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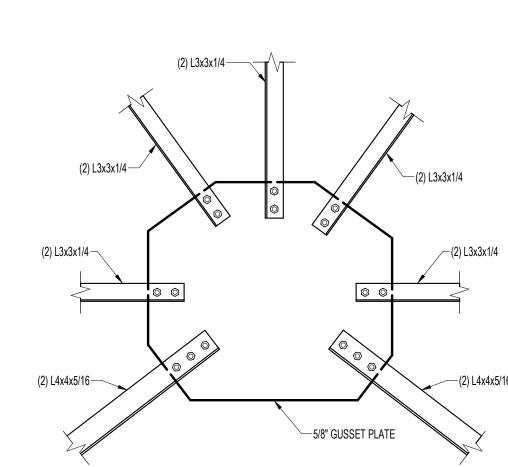
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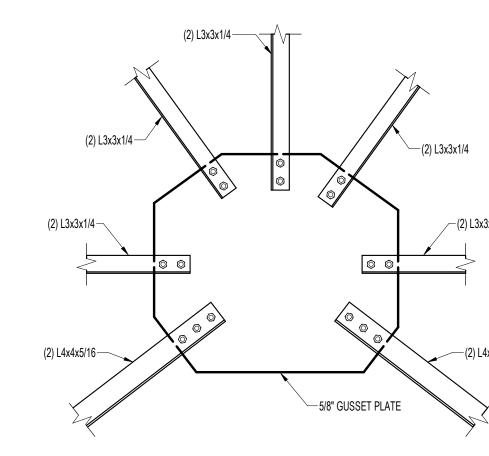
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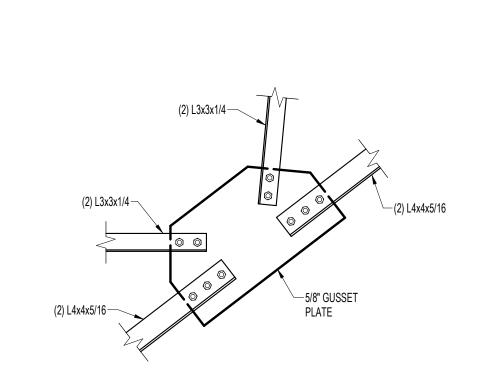















5 S401 TRUSS T2 JOINTS D & F

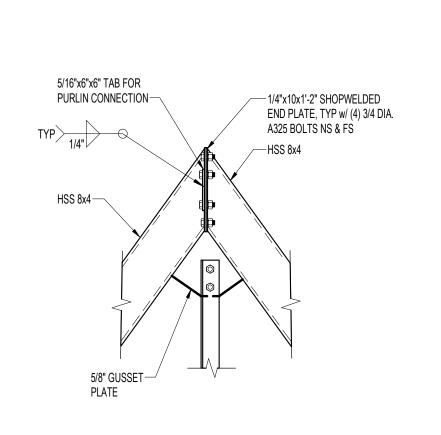

TRUSS T2 JOINT B

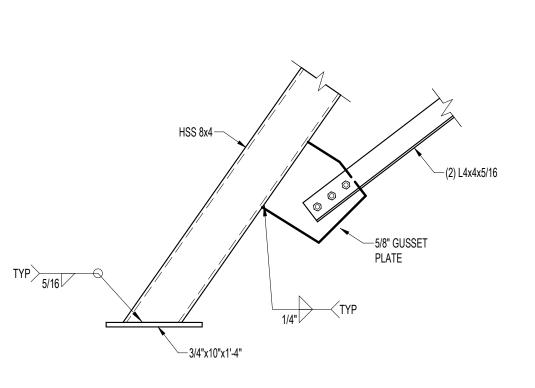


TRUSS T2 JOINTS A & C

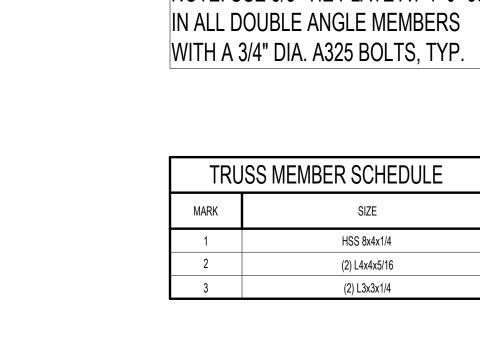

1 TRUSS T2

NOTE: USE 5/8" TIE PLATE AT 4'-0" oc.

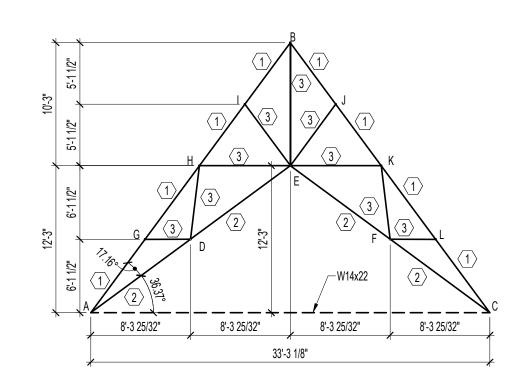

DATE	
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ADDENDUM 1









STRUCTURAL **DETAILS**


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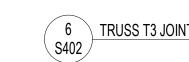
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SHEET NO.






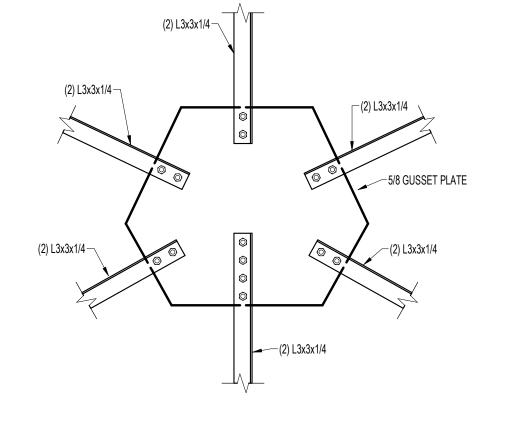


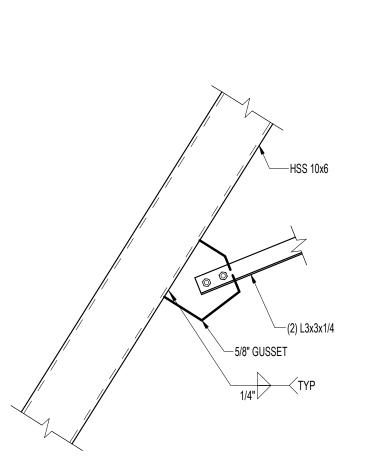

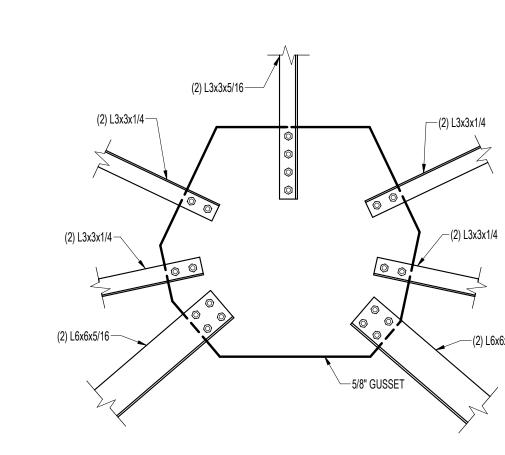
12 S402 TRUSS T3 JOINT S

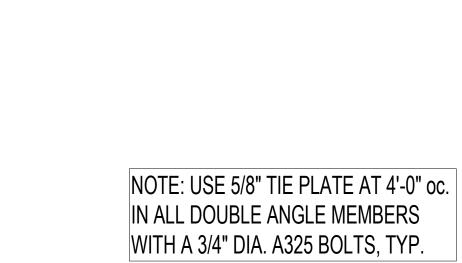

		33'-6"	1-2		K 4	(4)	2	P 1	
TRUSS	S MEMBER SCHEDULE]	1.2-5	J	4 2		"0-61	2 4	
MARK	SIZE		27	4	D	13'-0"			R R
1	HSS 10x6x5/16	1		12,8>	1-0				
2	(2) L6x6x5/16		2-7"	1 2 5.	1				2
3	(2) L3x3x5/16		A						
4	(2) L3x3x1/4			6'-10 155/256"	6'-10 155/256"	6'-10 155/256"	6'-10 155/256"	6'-10 155/256"	6'-10 155/256"
		_	7	,	7	41	'-3 5/8"	1	1
			7						

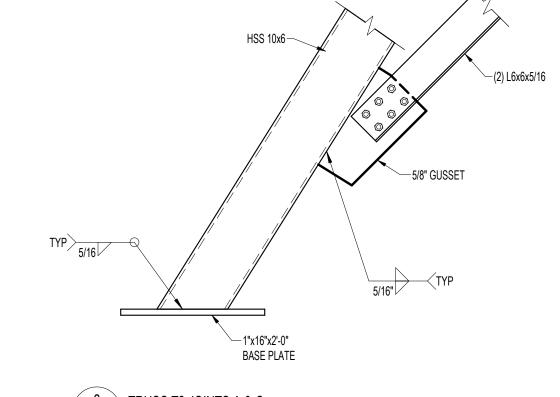

____(2) L3x3x1/4

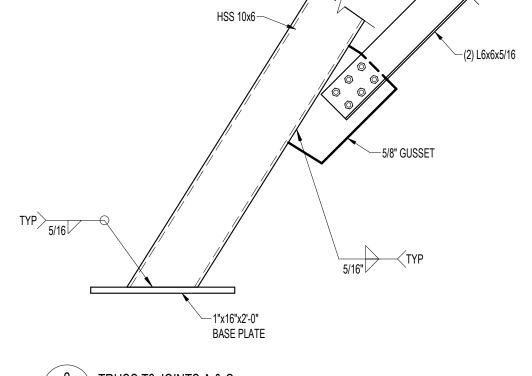

3/4" DIA. A325 BOLT, TYP.


TRUSS T3 JOINTS A & C

4 S402 TRUSS T3 JOINTS D & H

5/8" GUSSET PLATE


(2) L3x3x1/4


5 S402 TRUSS T3 JOINTS E & G

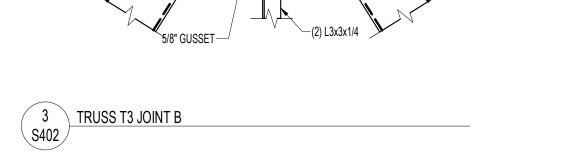



5/16"x6"x6" TAB FOR PURLIN— CONNECTION

5/16"x12"x2"-0" SHOP WELD END PLATE w/ (4) 3/4" DIA. A325 BOLTS NS & FS, TYP

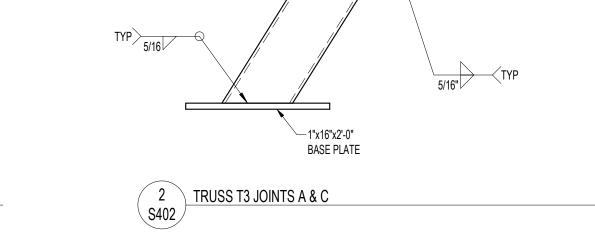

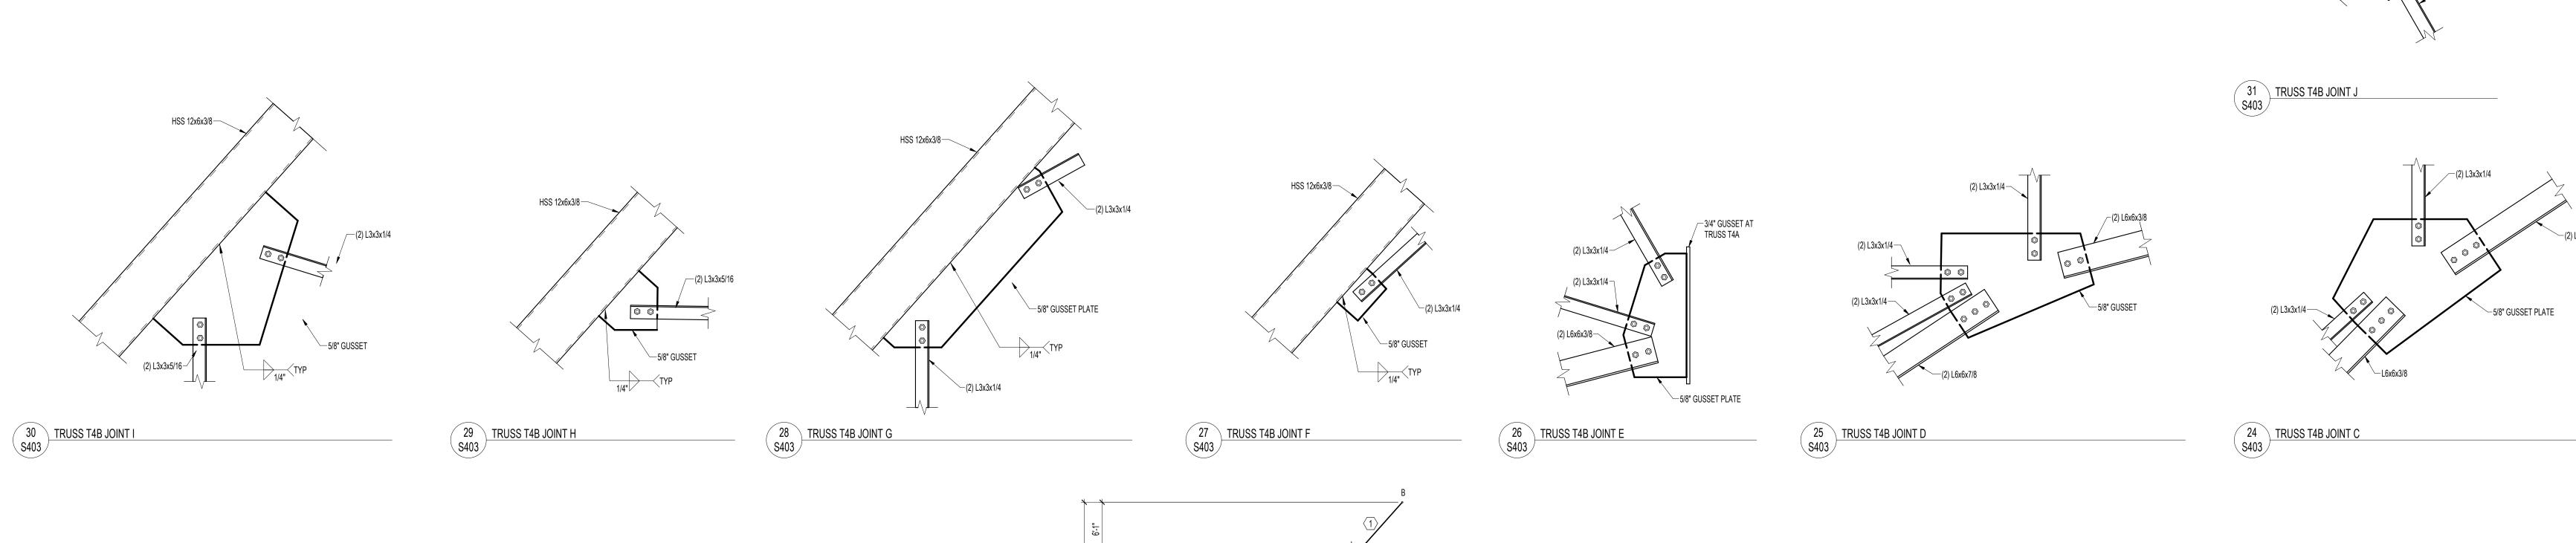

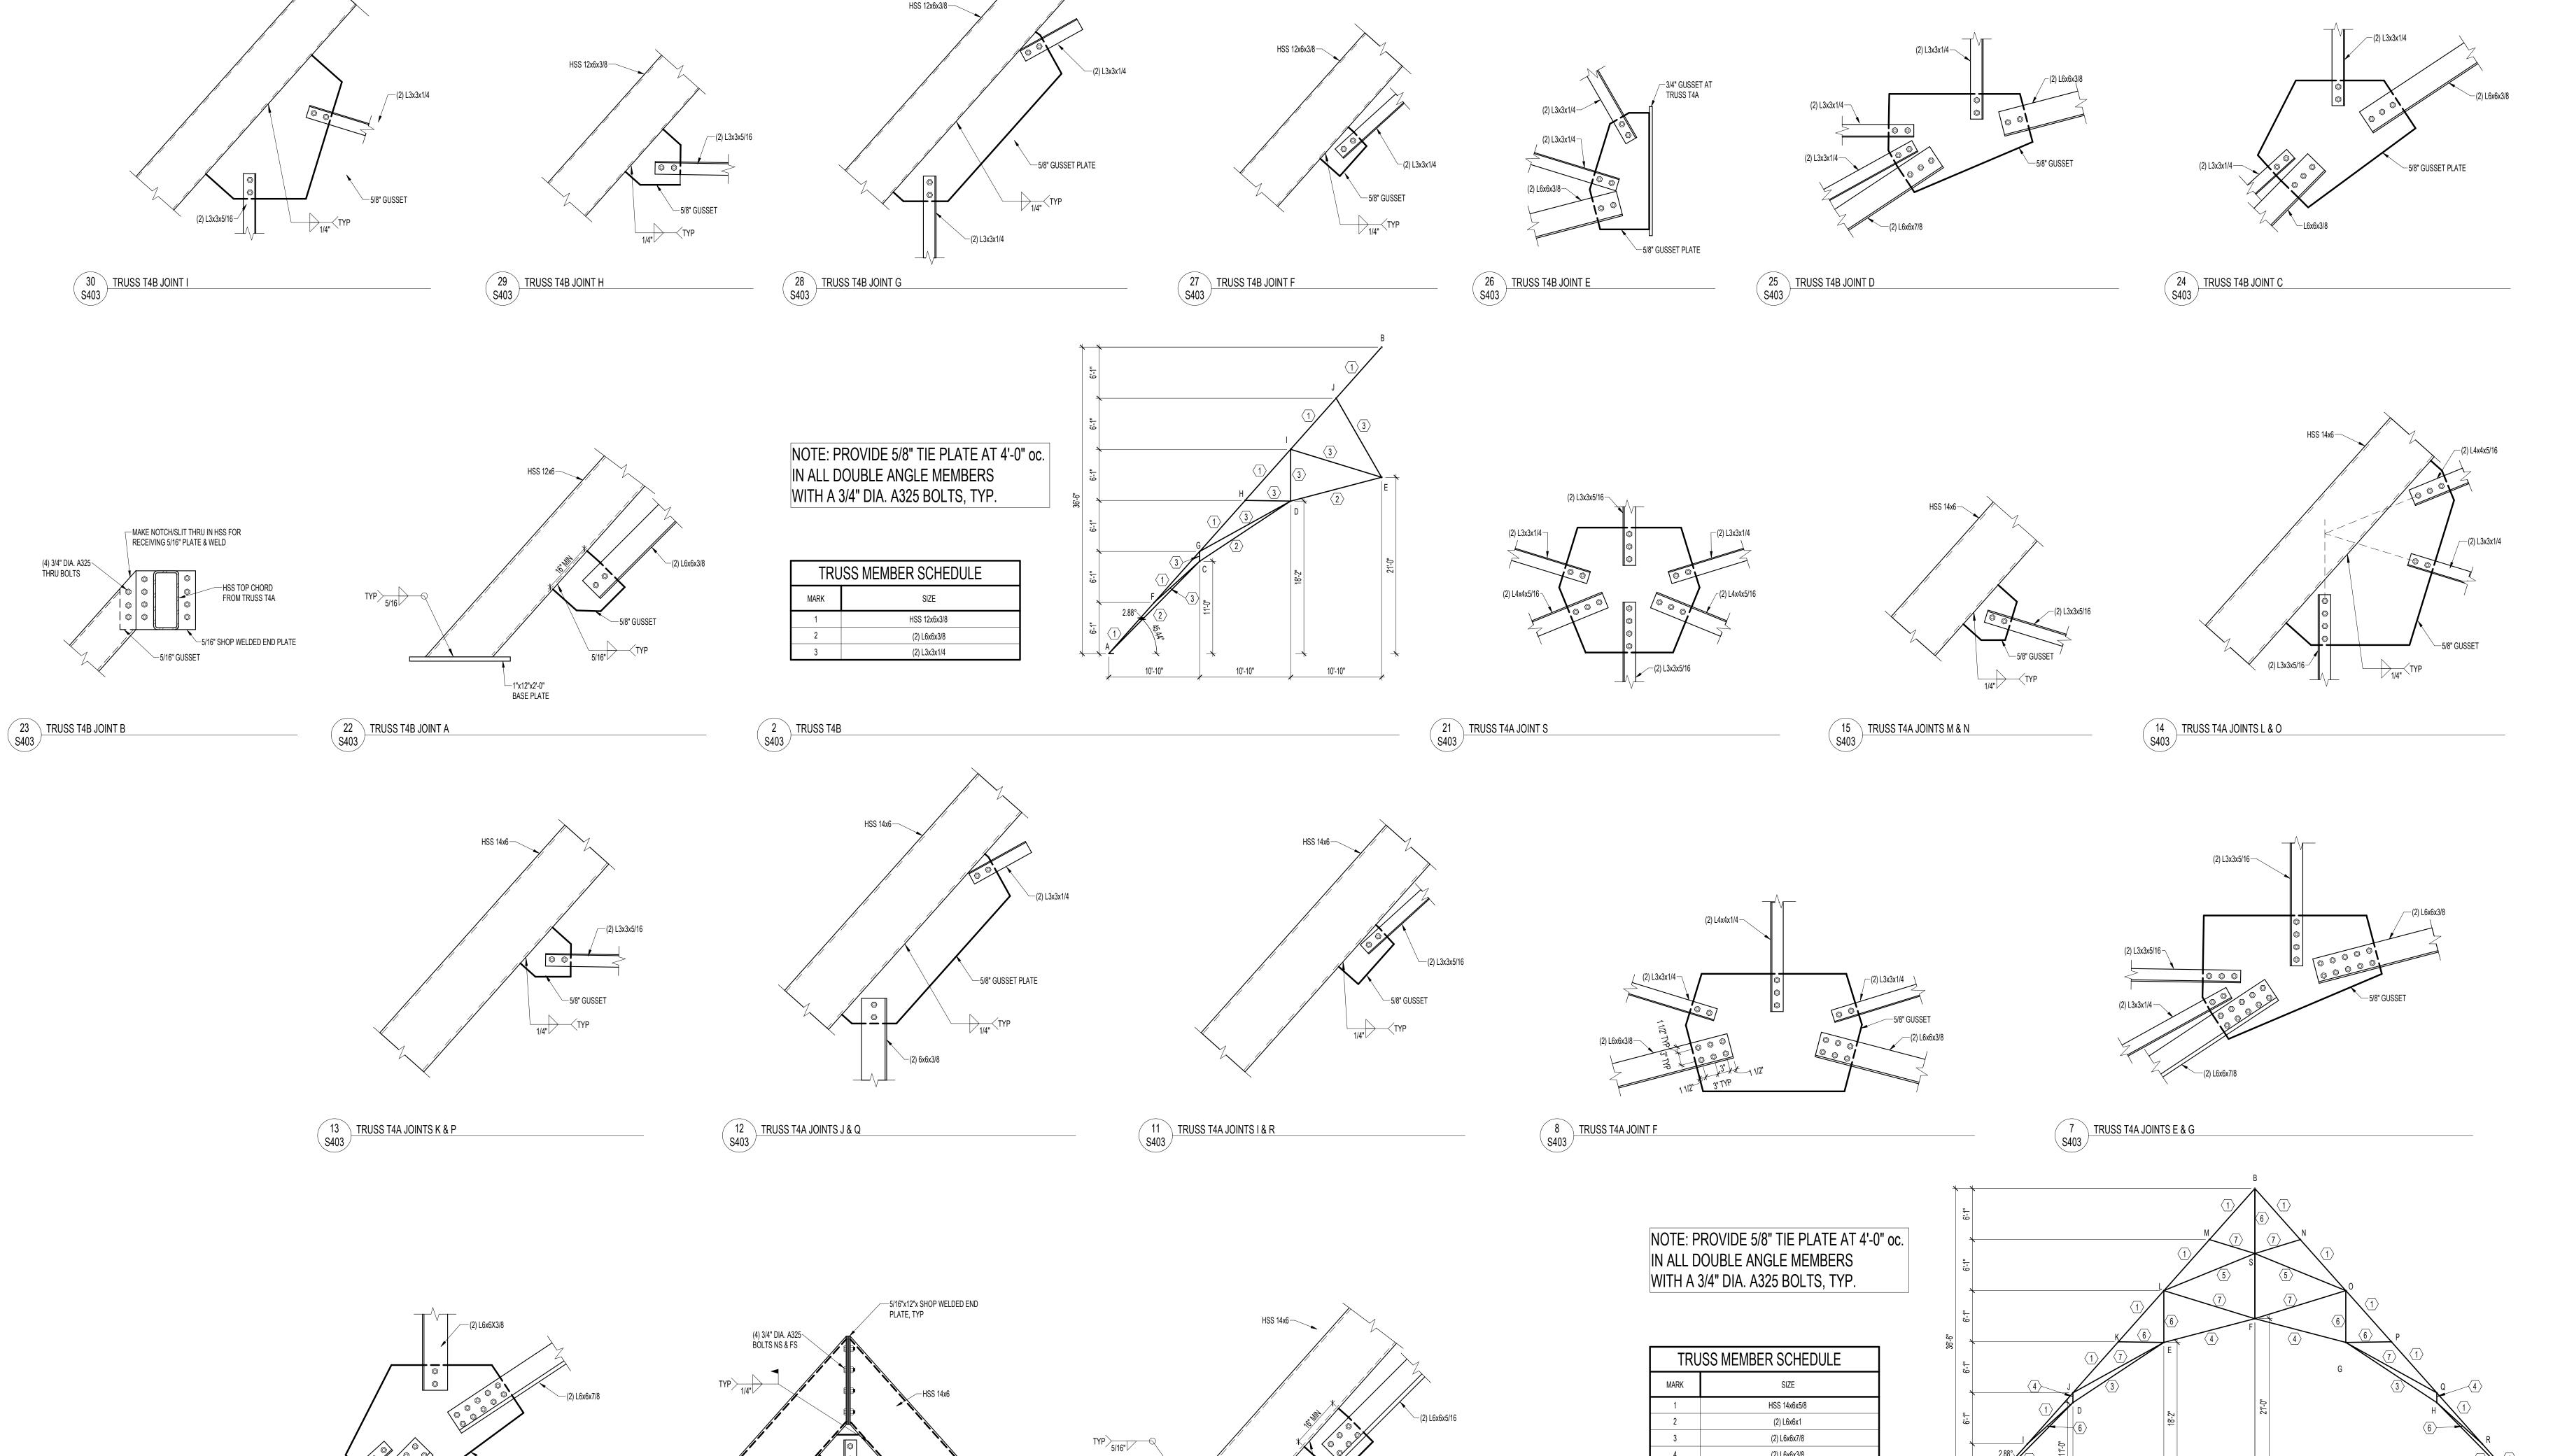

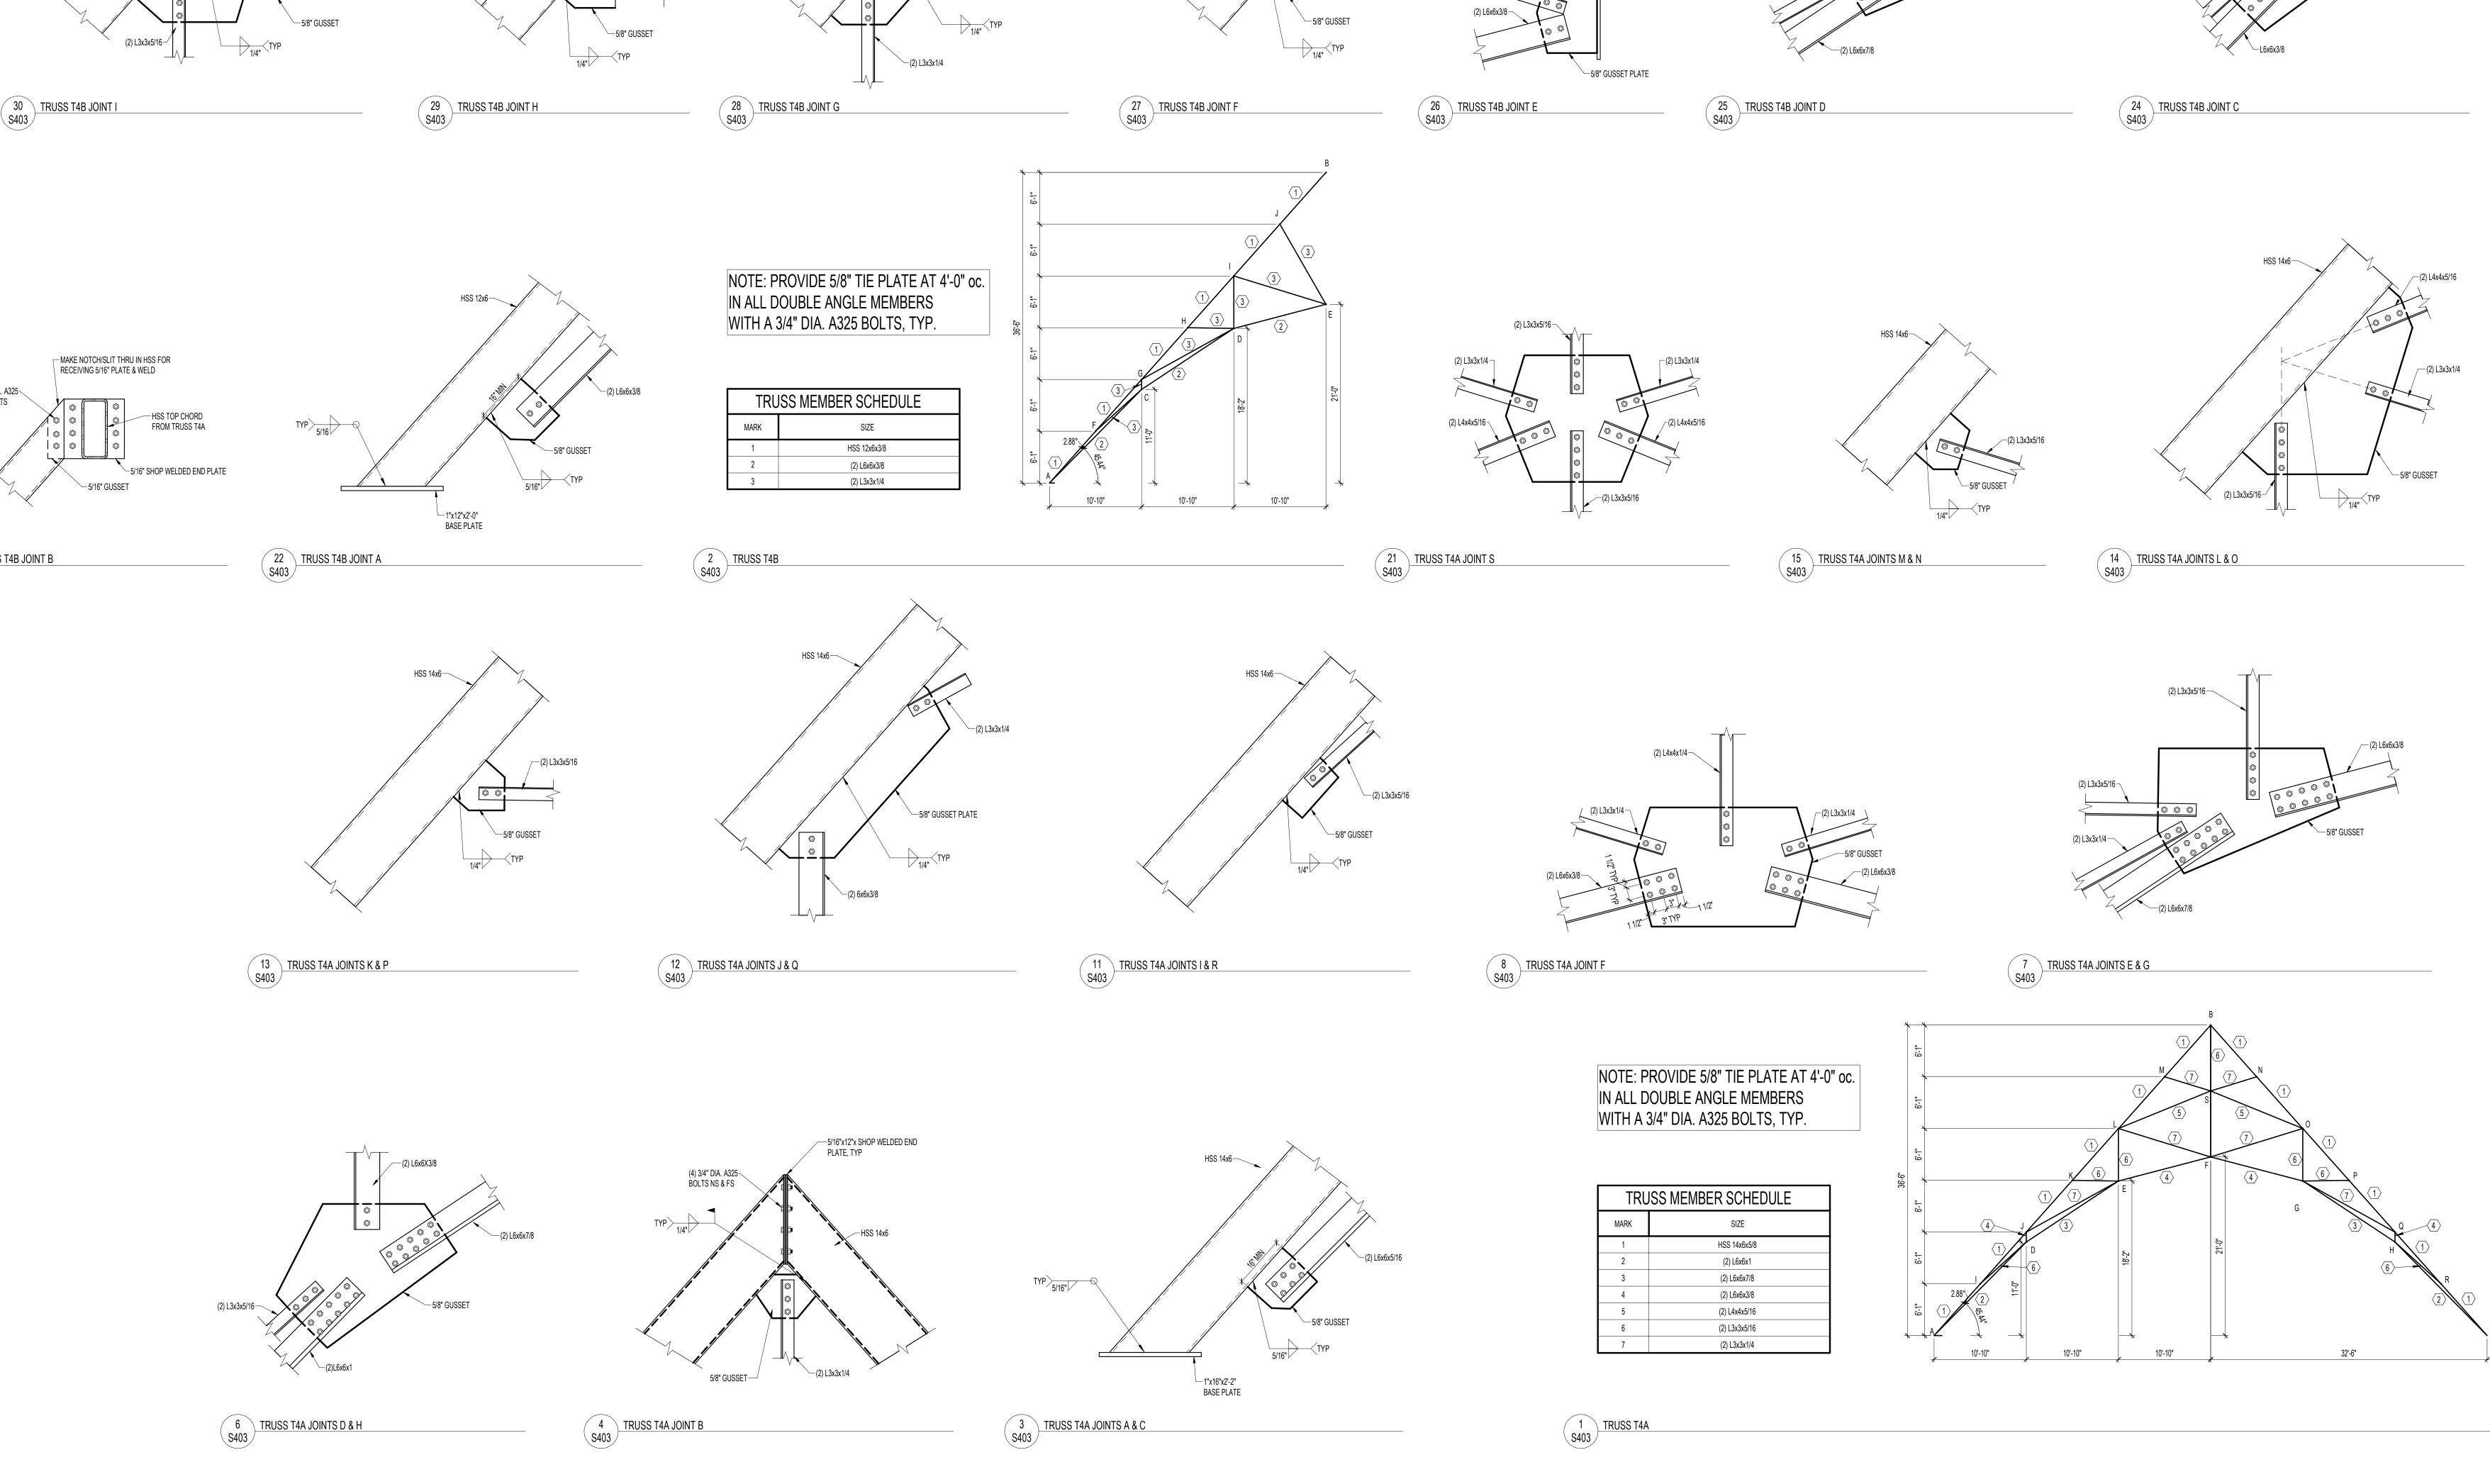



UIHLEIN | WILSON

RAMLOW | STEIN ARCHITECTURE | DESIGN | PLANNING

DATE	
BIIIE	
09/21/2018	

PROJECT NO 18-122