



7/16/18 BID DOCUMENTS

St. Josaphat Basilica Foundation 2333 S. 6th Street Milwaukee, WI 53215

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OWNER: FRANCISCAN FATHERS MINOR CONVENTUAL OF ST. JOSAPHAT CHURCH IN MILWAUKEE, 2333 S. 6TH STREET MILWAUKEE, WI 53215

ST. JOSAPHAT BASILICA FOUNDATION, INC. 620 W. LINCOLN AVENUE MILWAUKEE, WI 53215

ARCHITECT:
UIHLEIN/WILSON ARCHITECTS, INC. 322 E. MICHIGAN STREET, SUITE 400 MILWAUKEE, WI 53202 414-271-8899

STRUCTURAL ENGINEER: PIERCE ENGINEERS, INC. 241 N. BROADWAY AVE, SUITE 500 MILWAUKEE, WI 53202 414-278-6020



322 East Michigan Street Milwaukee, WI 53202 telephone | 414.271.8899

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REVISIONS

No. Date

Description

18-120

BASILICA OF ST. JOSAPHAT EXTERIOR REPAIR St. Josaphat Basilica Foundation

SHEET

TITLE SHEET & INDEX


7/16/18

PROJECT NO. 18-120

SHEET NO.

G1



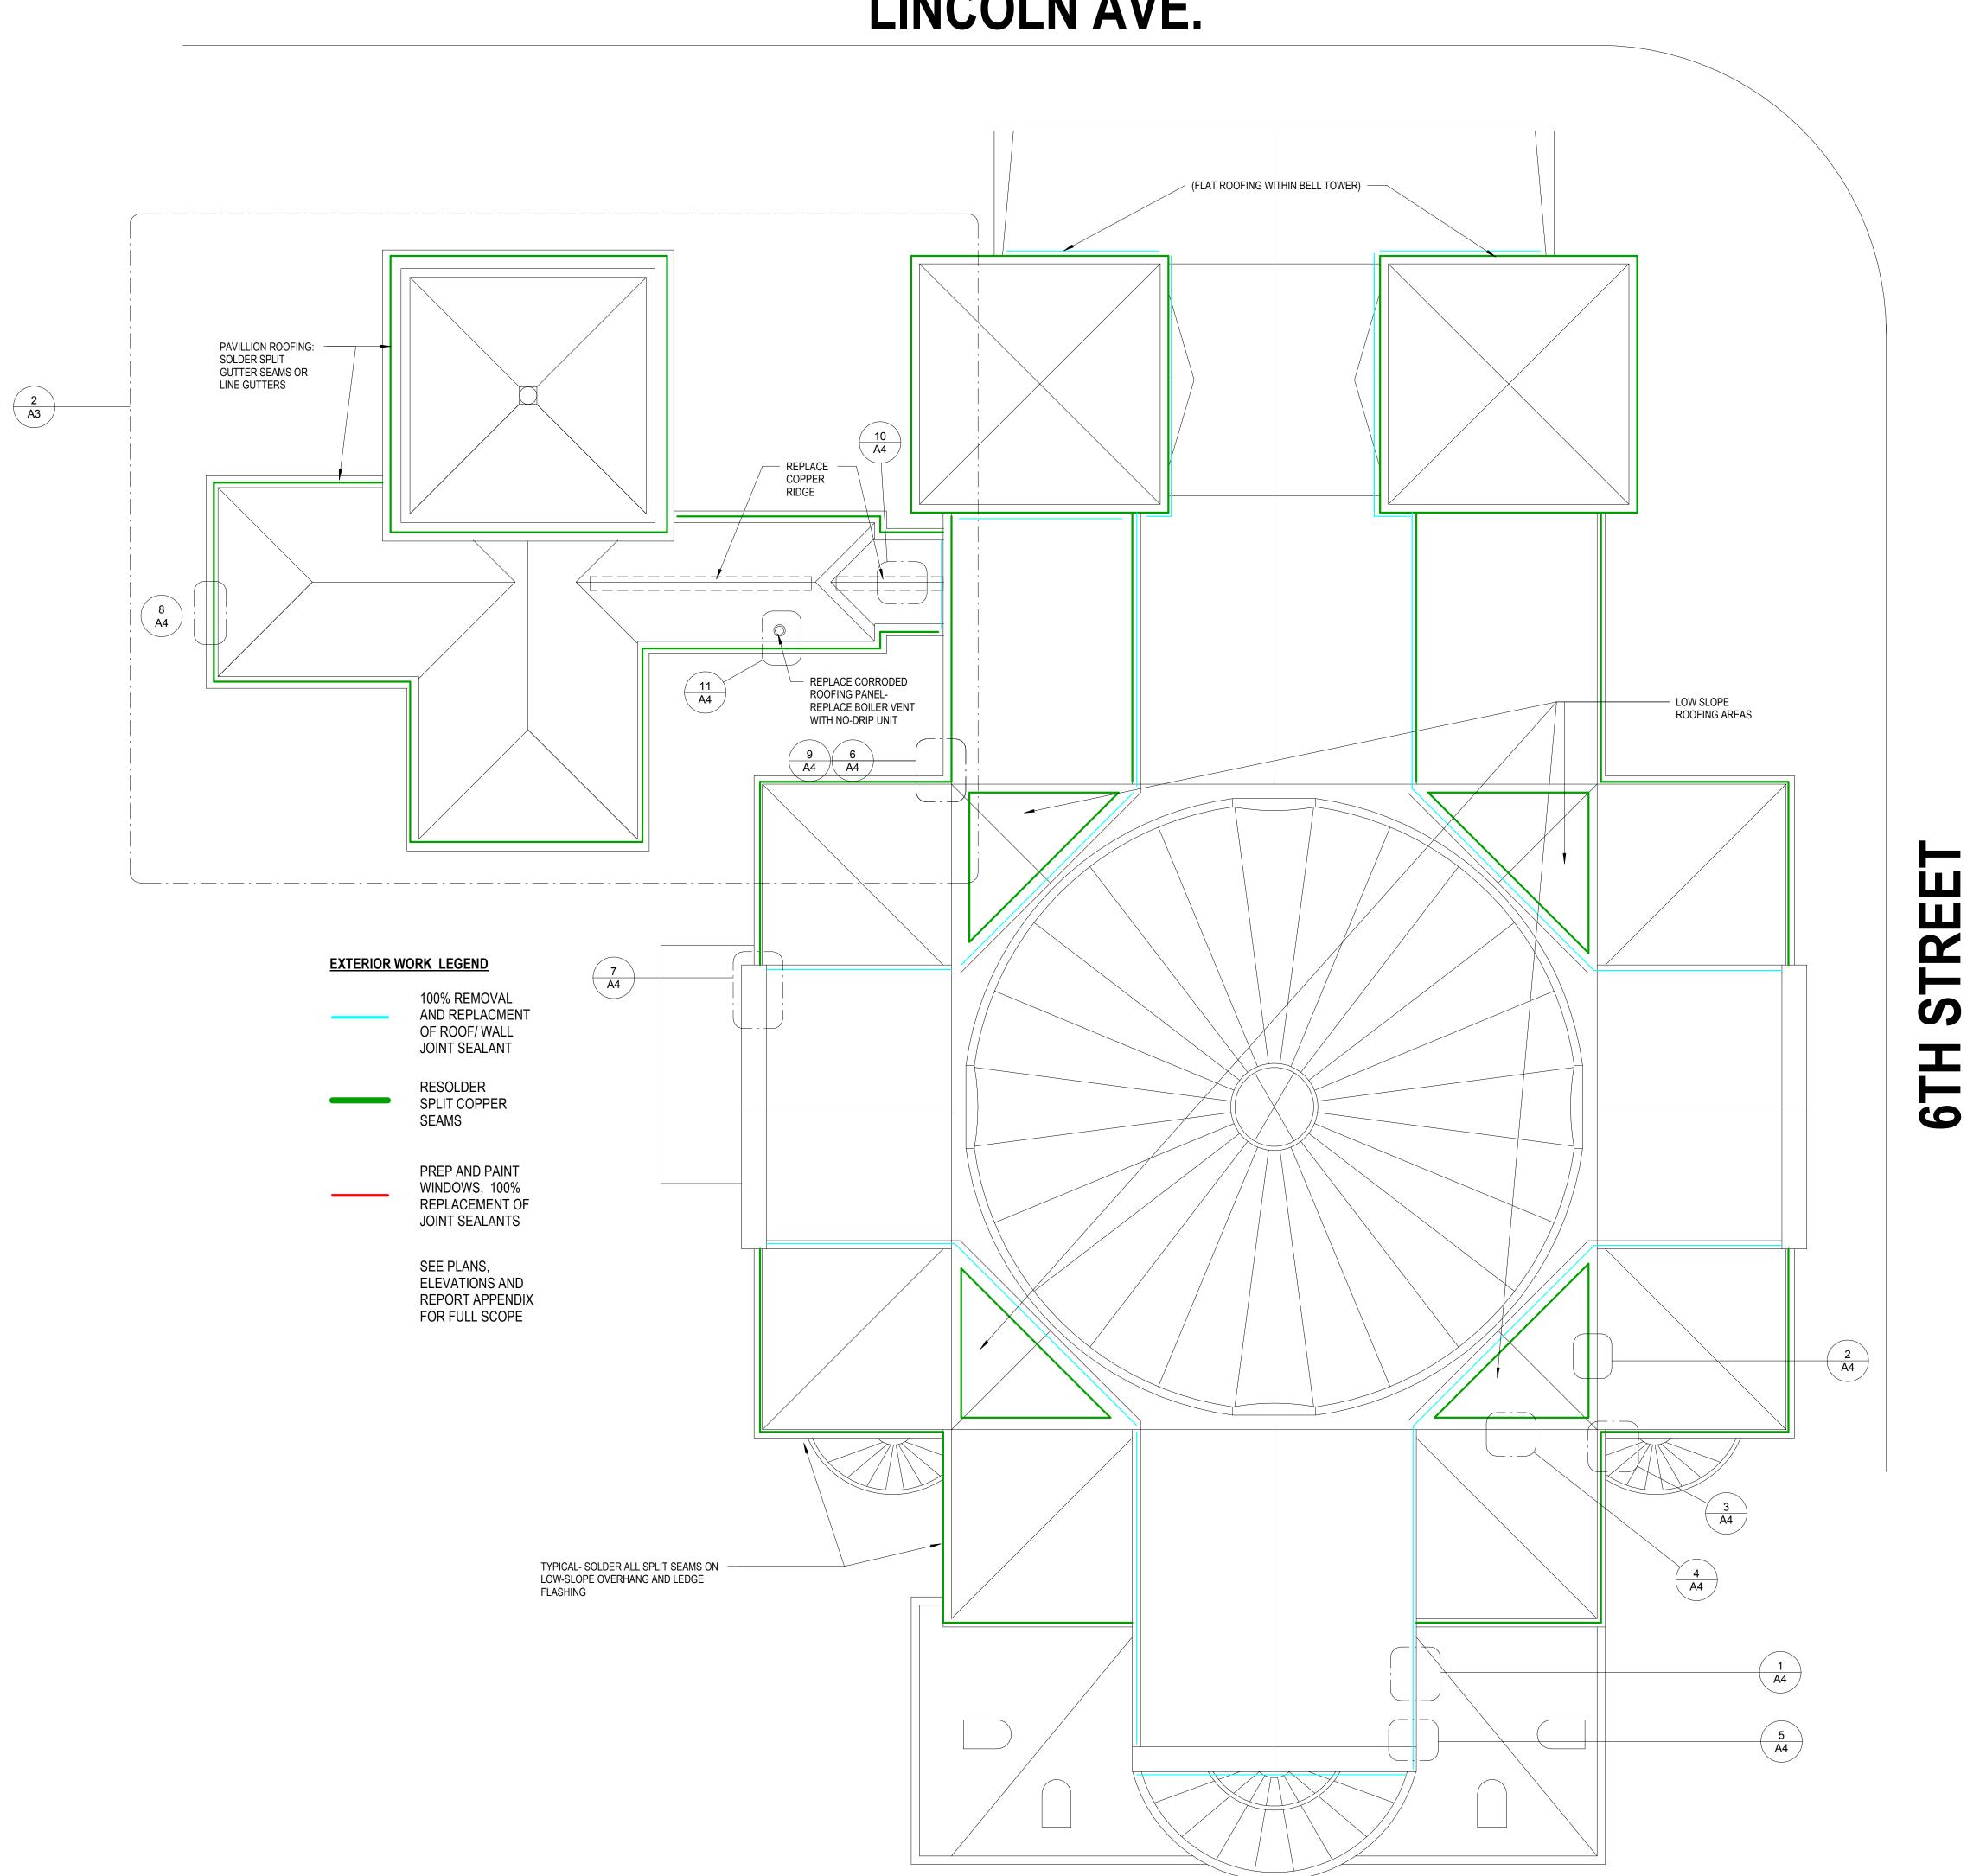



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REVISIONS

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Description

BASILICA OF ST. JOSAPHAT EXTERIOR REPAIR
St. Josaphat Basilica Foundation

SHEET

KEY PLAN


7/16/18


PROJECT NO.

18-120

SHEET NO.



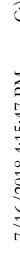

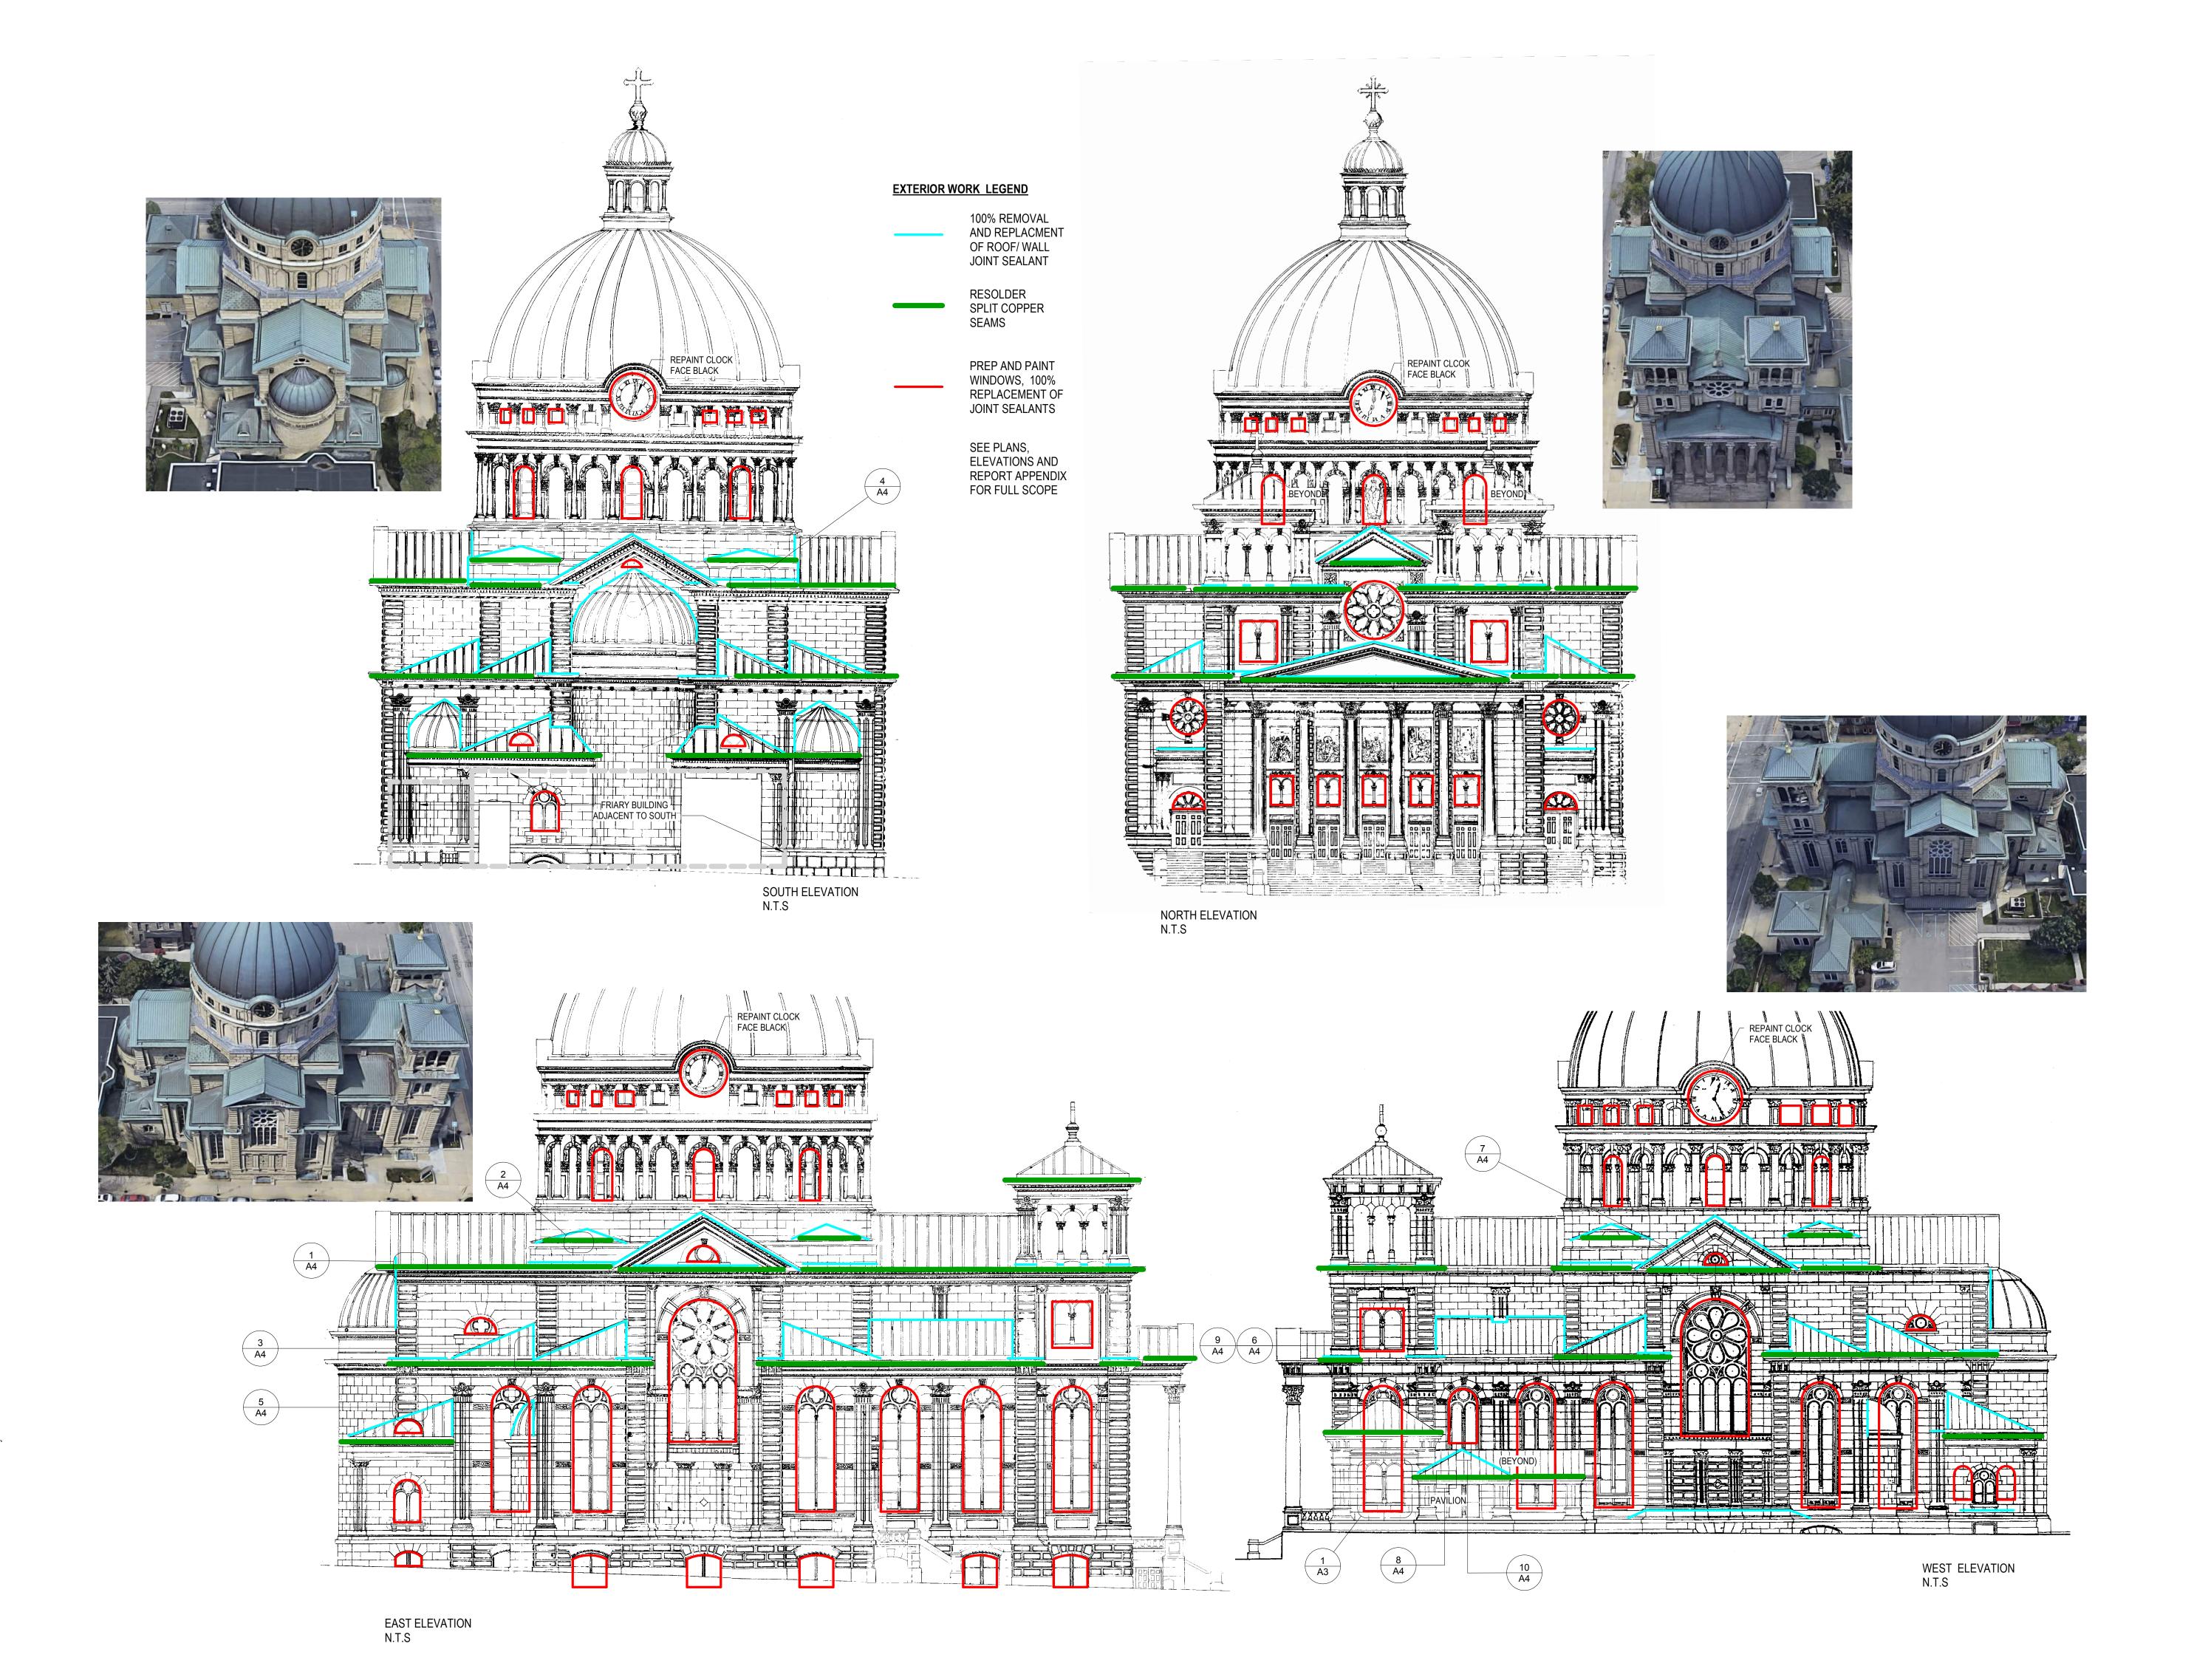



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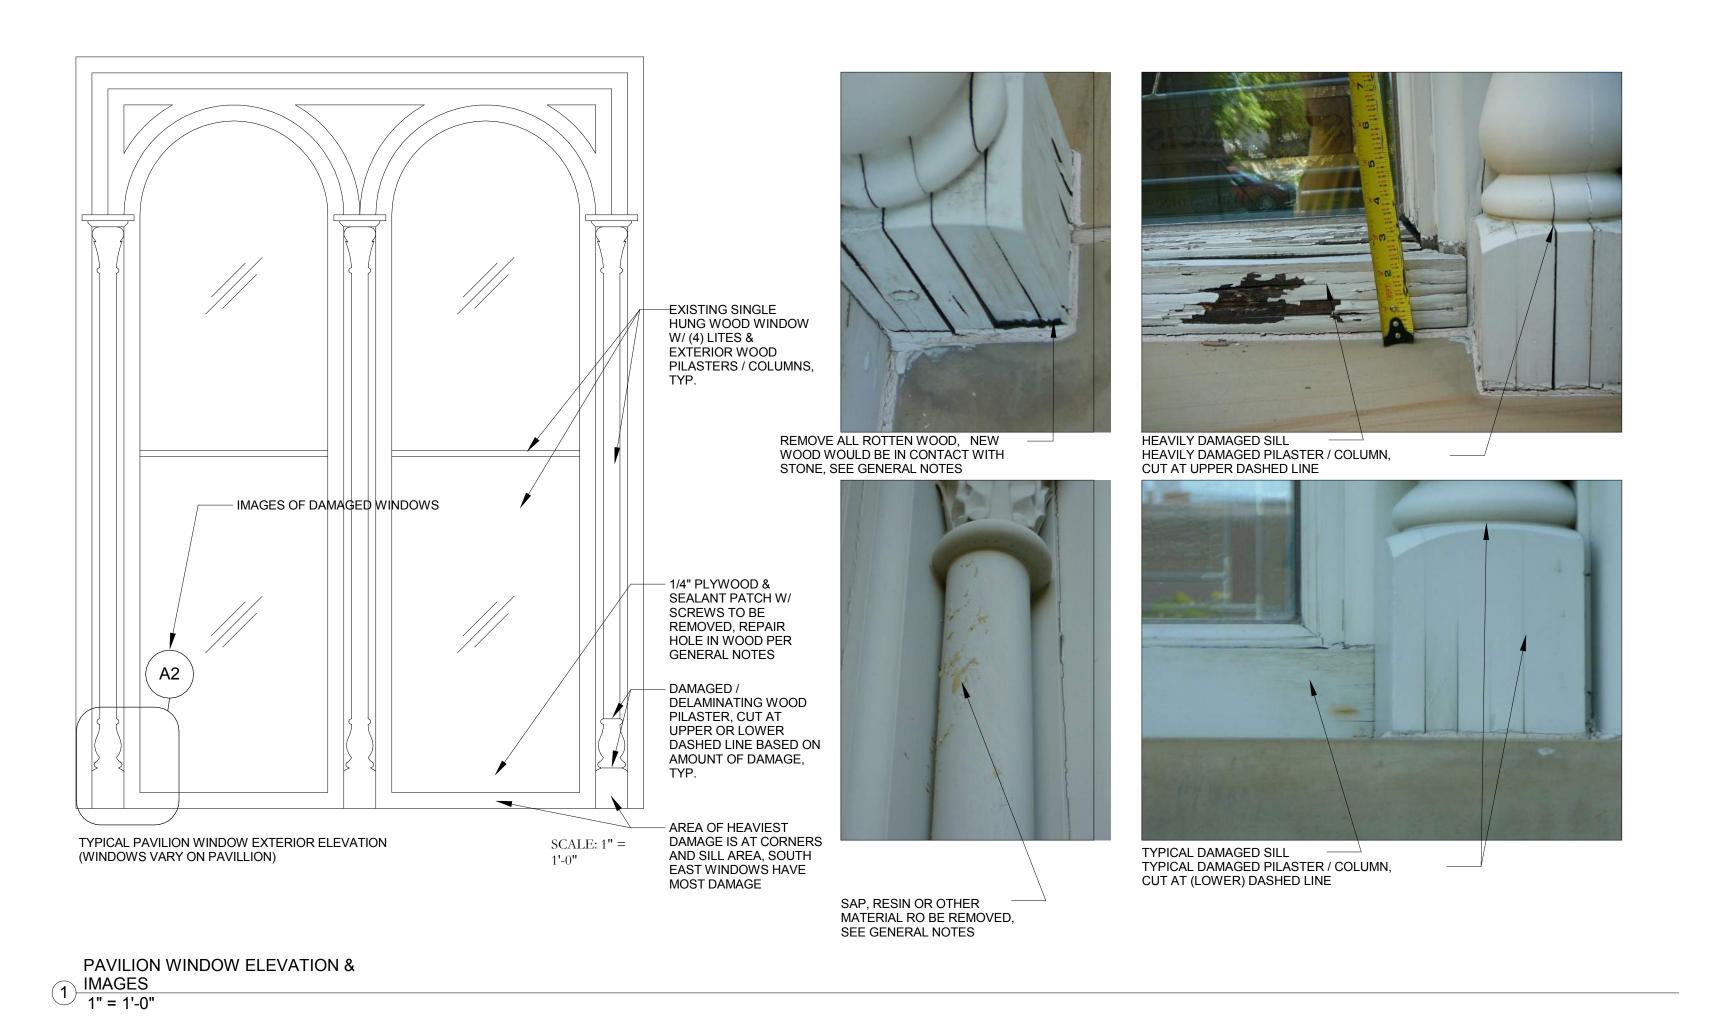
BASILICA OF ST. JOSAPHAT EXTERIOR REPAIR
St. Josaphat Basilica Foundation


KEY ELEVATIONS

7/16/18

PROJECT NO.

18-120 SHEET NO.



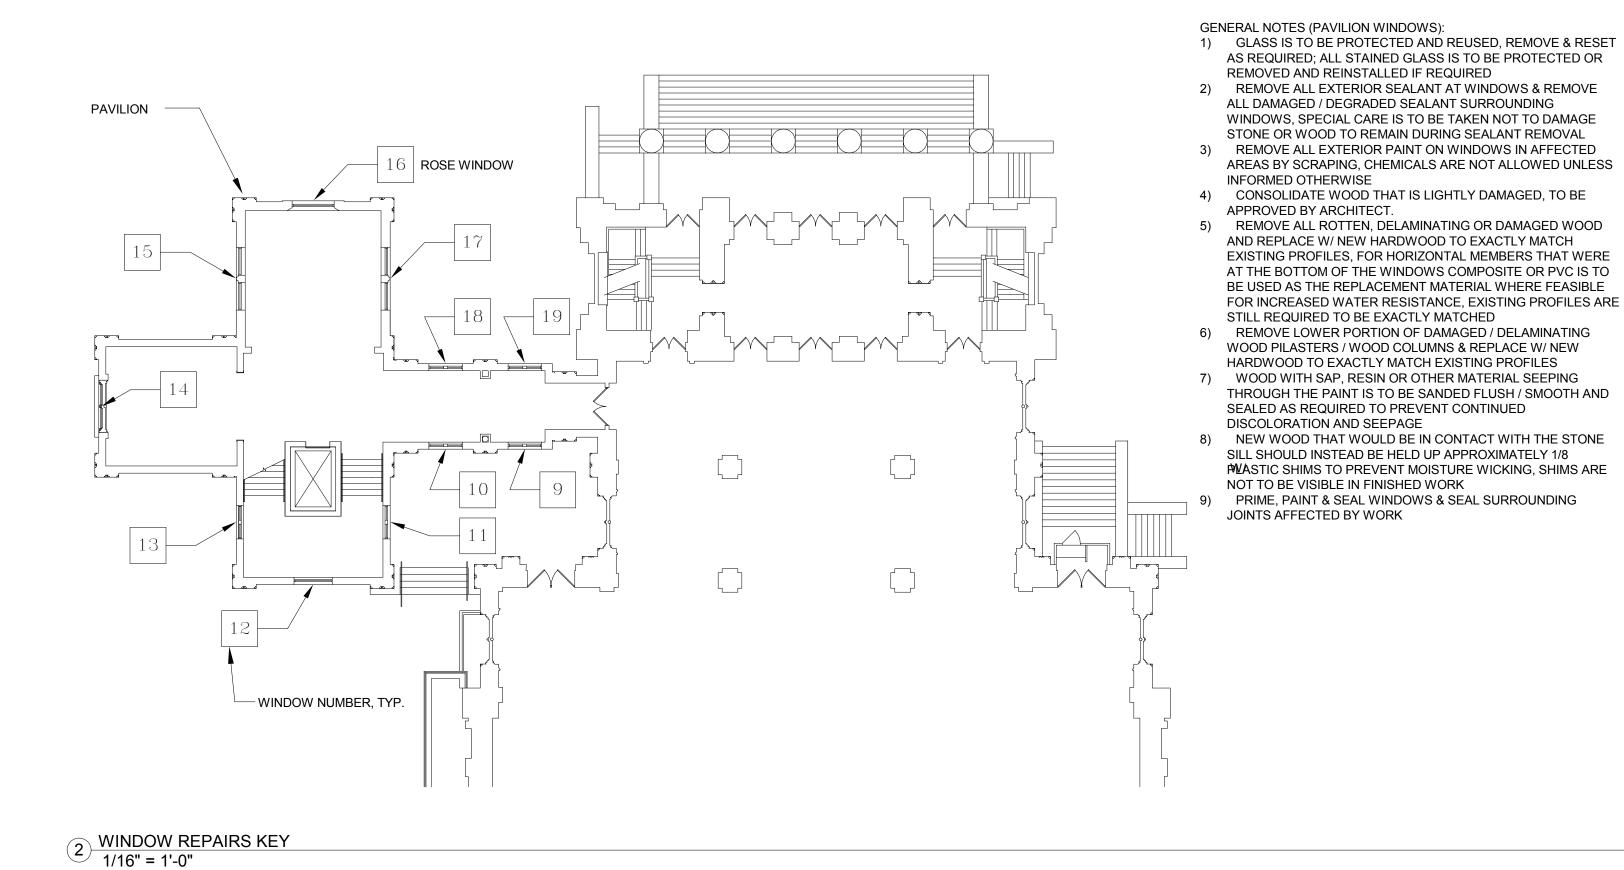

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REVISIONS

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Description

BASILICA OF ST. JOSAPHAT EXTERIOR REPAIR

St. Josaphat Basilica Foundation

SHEET

KEY PLAN -WINDOW REPAIR

7/16/18

PROJECT NO.

18-120 SHEET NO.




REPAIR SPLIT SEAM WITH

SOLDER COPPER OVERLAY,

REPLACE DAMAGED VENT WITH SIMILAR

12 DETAIL @ W. SIDE ALTER ROOF VENT

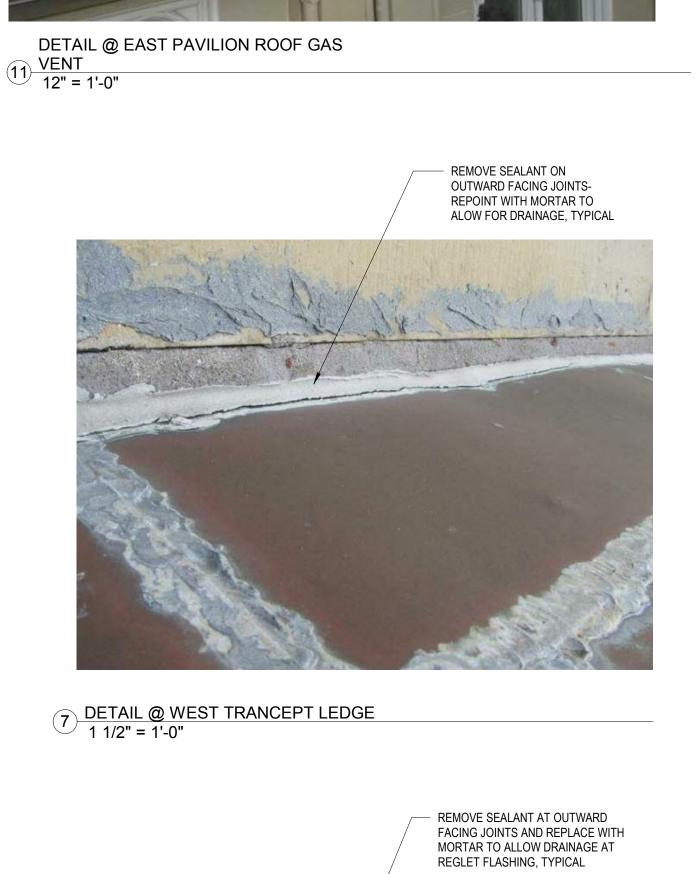

20 OZ. COPPER CLEATS @ 12" O.C.

FASTENED TO DECK W/ TWO
STAINLESS STEEL SCREWS

16 OZ. COPPER STANDING SEAM ROOF PANEL. FLAT-LOCK & SOLDER ALL JOINTS.

ENDS OF STANDING SEAMS BACK

AGAINST SEAM & SOLDER.

DOUBLE ROLL-LOCK STANDING SEAMS W/ ADJ. PANELS/CLEATS. FLAT-LOCK BOTTOM EDGE ONTO APRON OF GUTTER. FLATTEN

ADD STAINLESS STEEL DRIP PAN

AROUND FLUE VENT TO CATCH

SEAM ROOF PANELS

CONDENSATE, PIPE TO SANITARY

REPLACE 16 OZ. COPPER STANDING

20 OZ. COPPER CLEATS @ 12" O.C. FASTENED TO DECK W/ TWO

16 OZ. COPPER STANDING

ROSIN PAPER SLIP SHEET

SEAM ROOF PANEL

30# BASE SHEET

DECK

10 DETAIL @ EAST PAVILION ROOF RIDGE 12" = 1'-0"

STAINLESS STEEL

SCREWS


ROSIN PAPER SLIP SHEET

30# BASE SHEET.

INSTALL W/ 3" LAPS

ROOF FRAMING & DECK

20 OZ. COPPER GUTTER

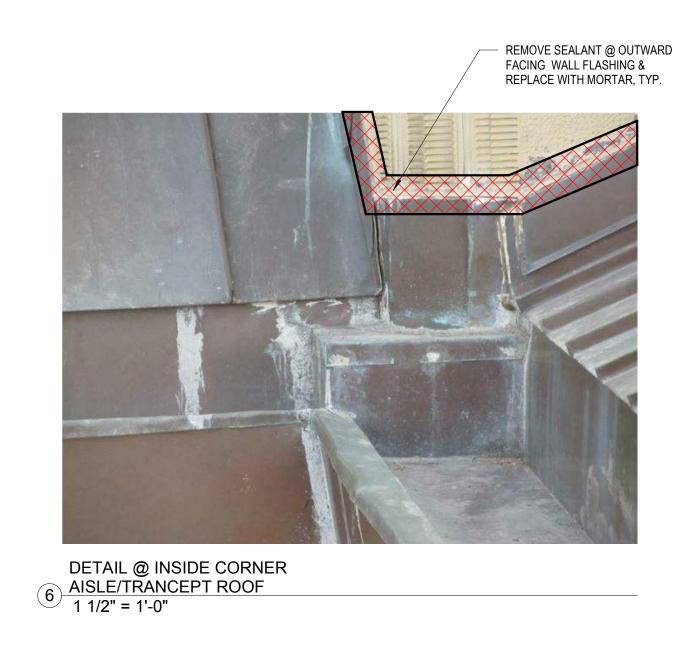

REPLACE 16 OZ. COPPER HIP CAP. INSTALL IN 8' MAX

SECTION LENGTHS W/ 2"

TOP EDGE OF ROOF

FLAP JOINTS. HOOK ONTO


PANELS. RIVET?? THROUGH

TREATED 1X4 WOOD
 NAILERS. BEVEL EDGE
 TO FIT TIGHTLY @ HIP.

FASTEN TO DECK @

9 DETAIL @ ROOF CORNER FLASHING 1 1/2" = 1'-0"

HEM @ 48" O.C. & MALLET

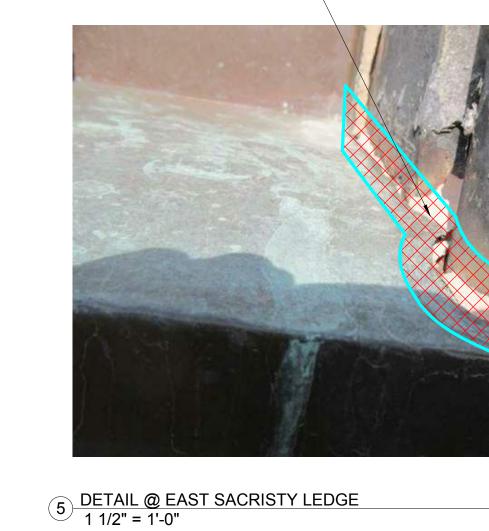


REMOVE & REPLACE SEALANT AT SKYWARD



REPLACE LOOSE, MISSING, OR OPEN FLASHING, TYP.

REPAIR SPLIT GUTTER SEAMS WITH SOLDERED COPPER OVERLAY, TYP.

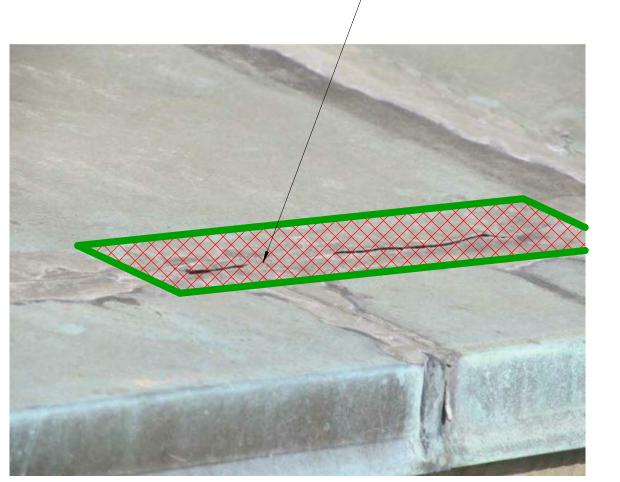


REPAIR SPLIT SEAM WITH SOLDERED COPPER OVERLAY, TYP.

DETAIL @ SE CENTER ROOF SOLDERED

SEAM

1 1/2" = 1'-0"

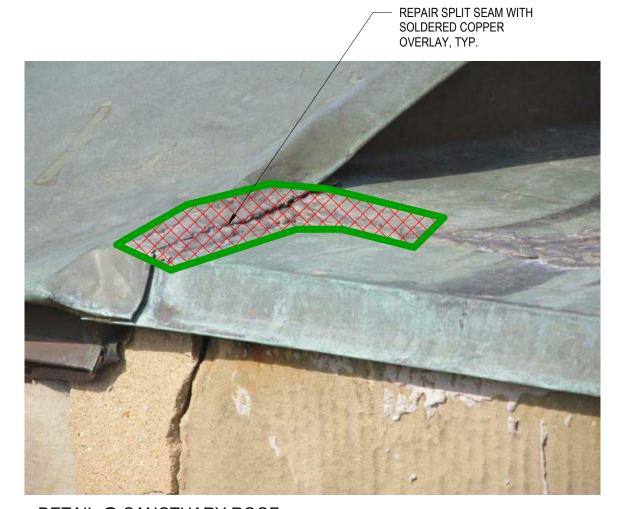

DETAIL @ SANCTUARY ROOF
SOLDERED SEAM
1 1/2" = 1'-0"

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No. Date

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Description

BASILICA OF ST. JOSAPHAT EXTERIOR REPAIR
St. Josaphat Basilica Foundation


SHEET

ARCHITECTURAL DETAILS

7/16/18

PROJECT NO. 18-120

SHEET NO.

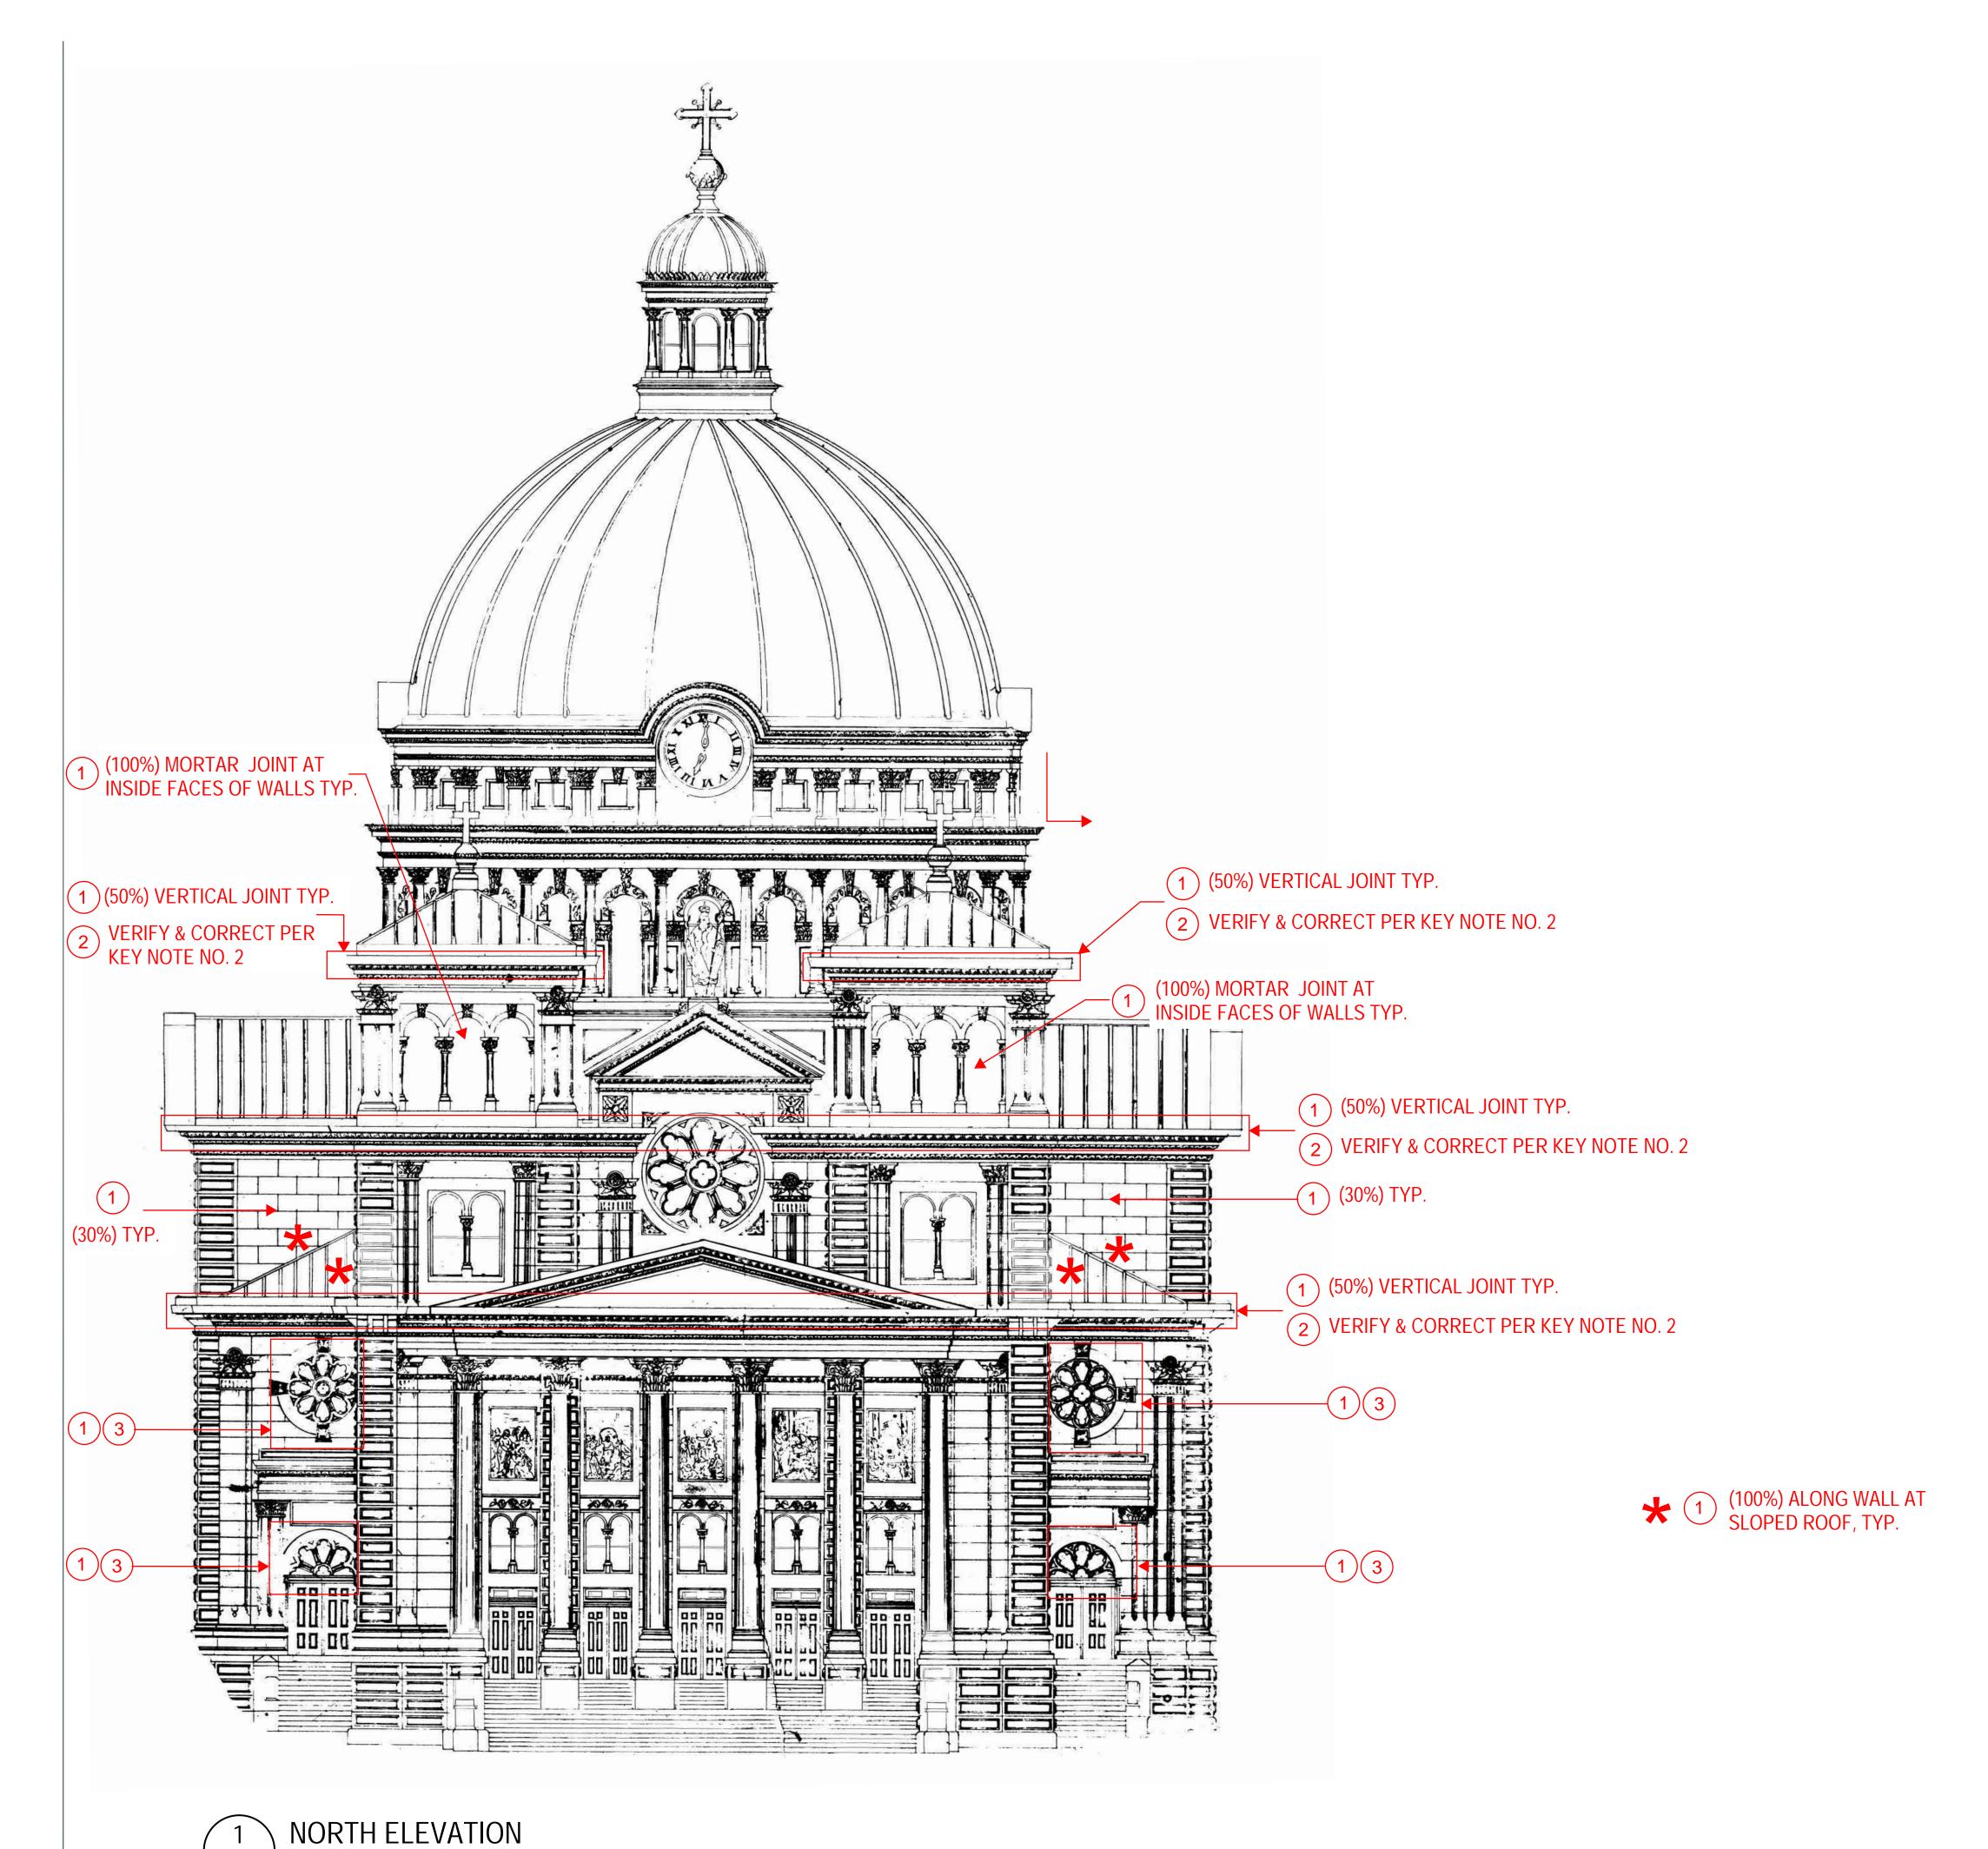

MARK	DESCRIPTION	
1	FAILING/WEATHERED/LOOSE MORTAR IN JOINT. PROVIDE NEW TUCK POINTING. SEE DETAIL 1/S5.	
2	SEALANT AT WRONG LOCATION. REMOVE SEALANT AND CLEAN. IF MORTAR LOSS NOTED, PROVIDE NEW TUCK POINTING PER DETAIL 1/S5.	
3	FAILING SELANT AT SKYWARD JOINT. REMOVE SEALANT, CLEAN, AND APPLY NEW SEALANT PER DETAIL 2/S5. IF MORTAR LOSS NOTED, PROVIDE NEW TUCK POINTING PRIOR TO APPLYING SEALANT.	
4	SPALL IN STONE FROM ANCHORS BEING TOO CLOSE TO EDGE ALONG STONE PROJECTION. REMOVE LOOSE SPALL AND PREVENT MOISTURE INTRUSION.	

NOTE

SEE ROOFING CONSULTANT'S DETAIL FOR SEALANT AT COPPER FLASHING, TYP.
 EXISTING PAINT IN ARCHED WINDOW FRAME HAS PEELED OFF. REMOVE PAINT,

CLEAN, AND APPLY NEW BREATHABLE PAINT, TYP.



ISSUE:

NO. DATE DESCRIPTION

1 7/13/2018 BID DOCUMENTS

ST. JOSAPHAT BASILICA

FACADE REVIEW

2333 S. 6th STREET MILWAUKEE, WI 53215

PE PROJECT: 18368

NORTH ELEVATION

CALE: AS NOTED RAWN BY: PE S1

	MARK	DESCRIPTION
	1	FAILING/WEATHERED/LOOSE MORTAR IN JOINT. PROVIDE NEW TUCK POINTING. SEE DETAIL 1/S5.
	2	SEALANT AT WRONG LOCATION. REMOVE SEALANT AND CLEAN. IF MORTAR LOSS NOTED, PROVIDE NEW TUCK POINTING PER DETAIL 1/S5.
	3	FAILING SELANT AT SKYWARD JOINT. REMOVE SEALANT, CLEAN, AND APPLY NEW SEALANT PER DETAIL 2/S5. IF MORTAR LOSS NOTED, PROVIDE NEW TUCK POINTING PRIOR TO APPLYING SEALANT.
	4	SPALL IN STONE FROM ANCHORS BEING TOO CLOSE TO EDGE ALONG STONE PROJECTION. REMOVE LOOSE SPALL AND PREVENT MOISTURE INTRUSION.

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NO. DATE DESCRIPTION 1 7/13/2018 BID DOCUMENTS

2. EXISTING PAINT IN ARCHED WINDOW FRAME HAS PEELED OFF. REMOVE PAINT


ST. JOSAPHAT **BASILICA**

FACADE REVIEW

2333 S. 6th STREET MILWAUKEE, WI 53215


PE PROJECT: 18368

EAST ELEVATION

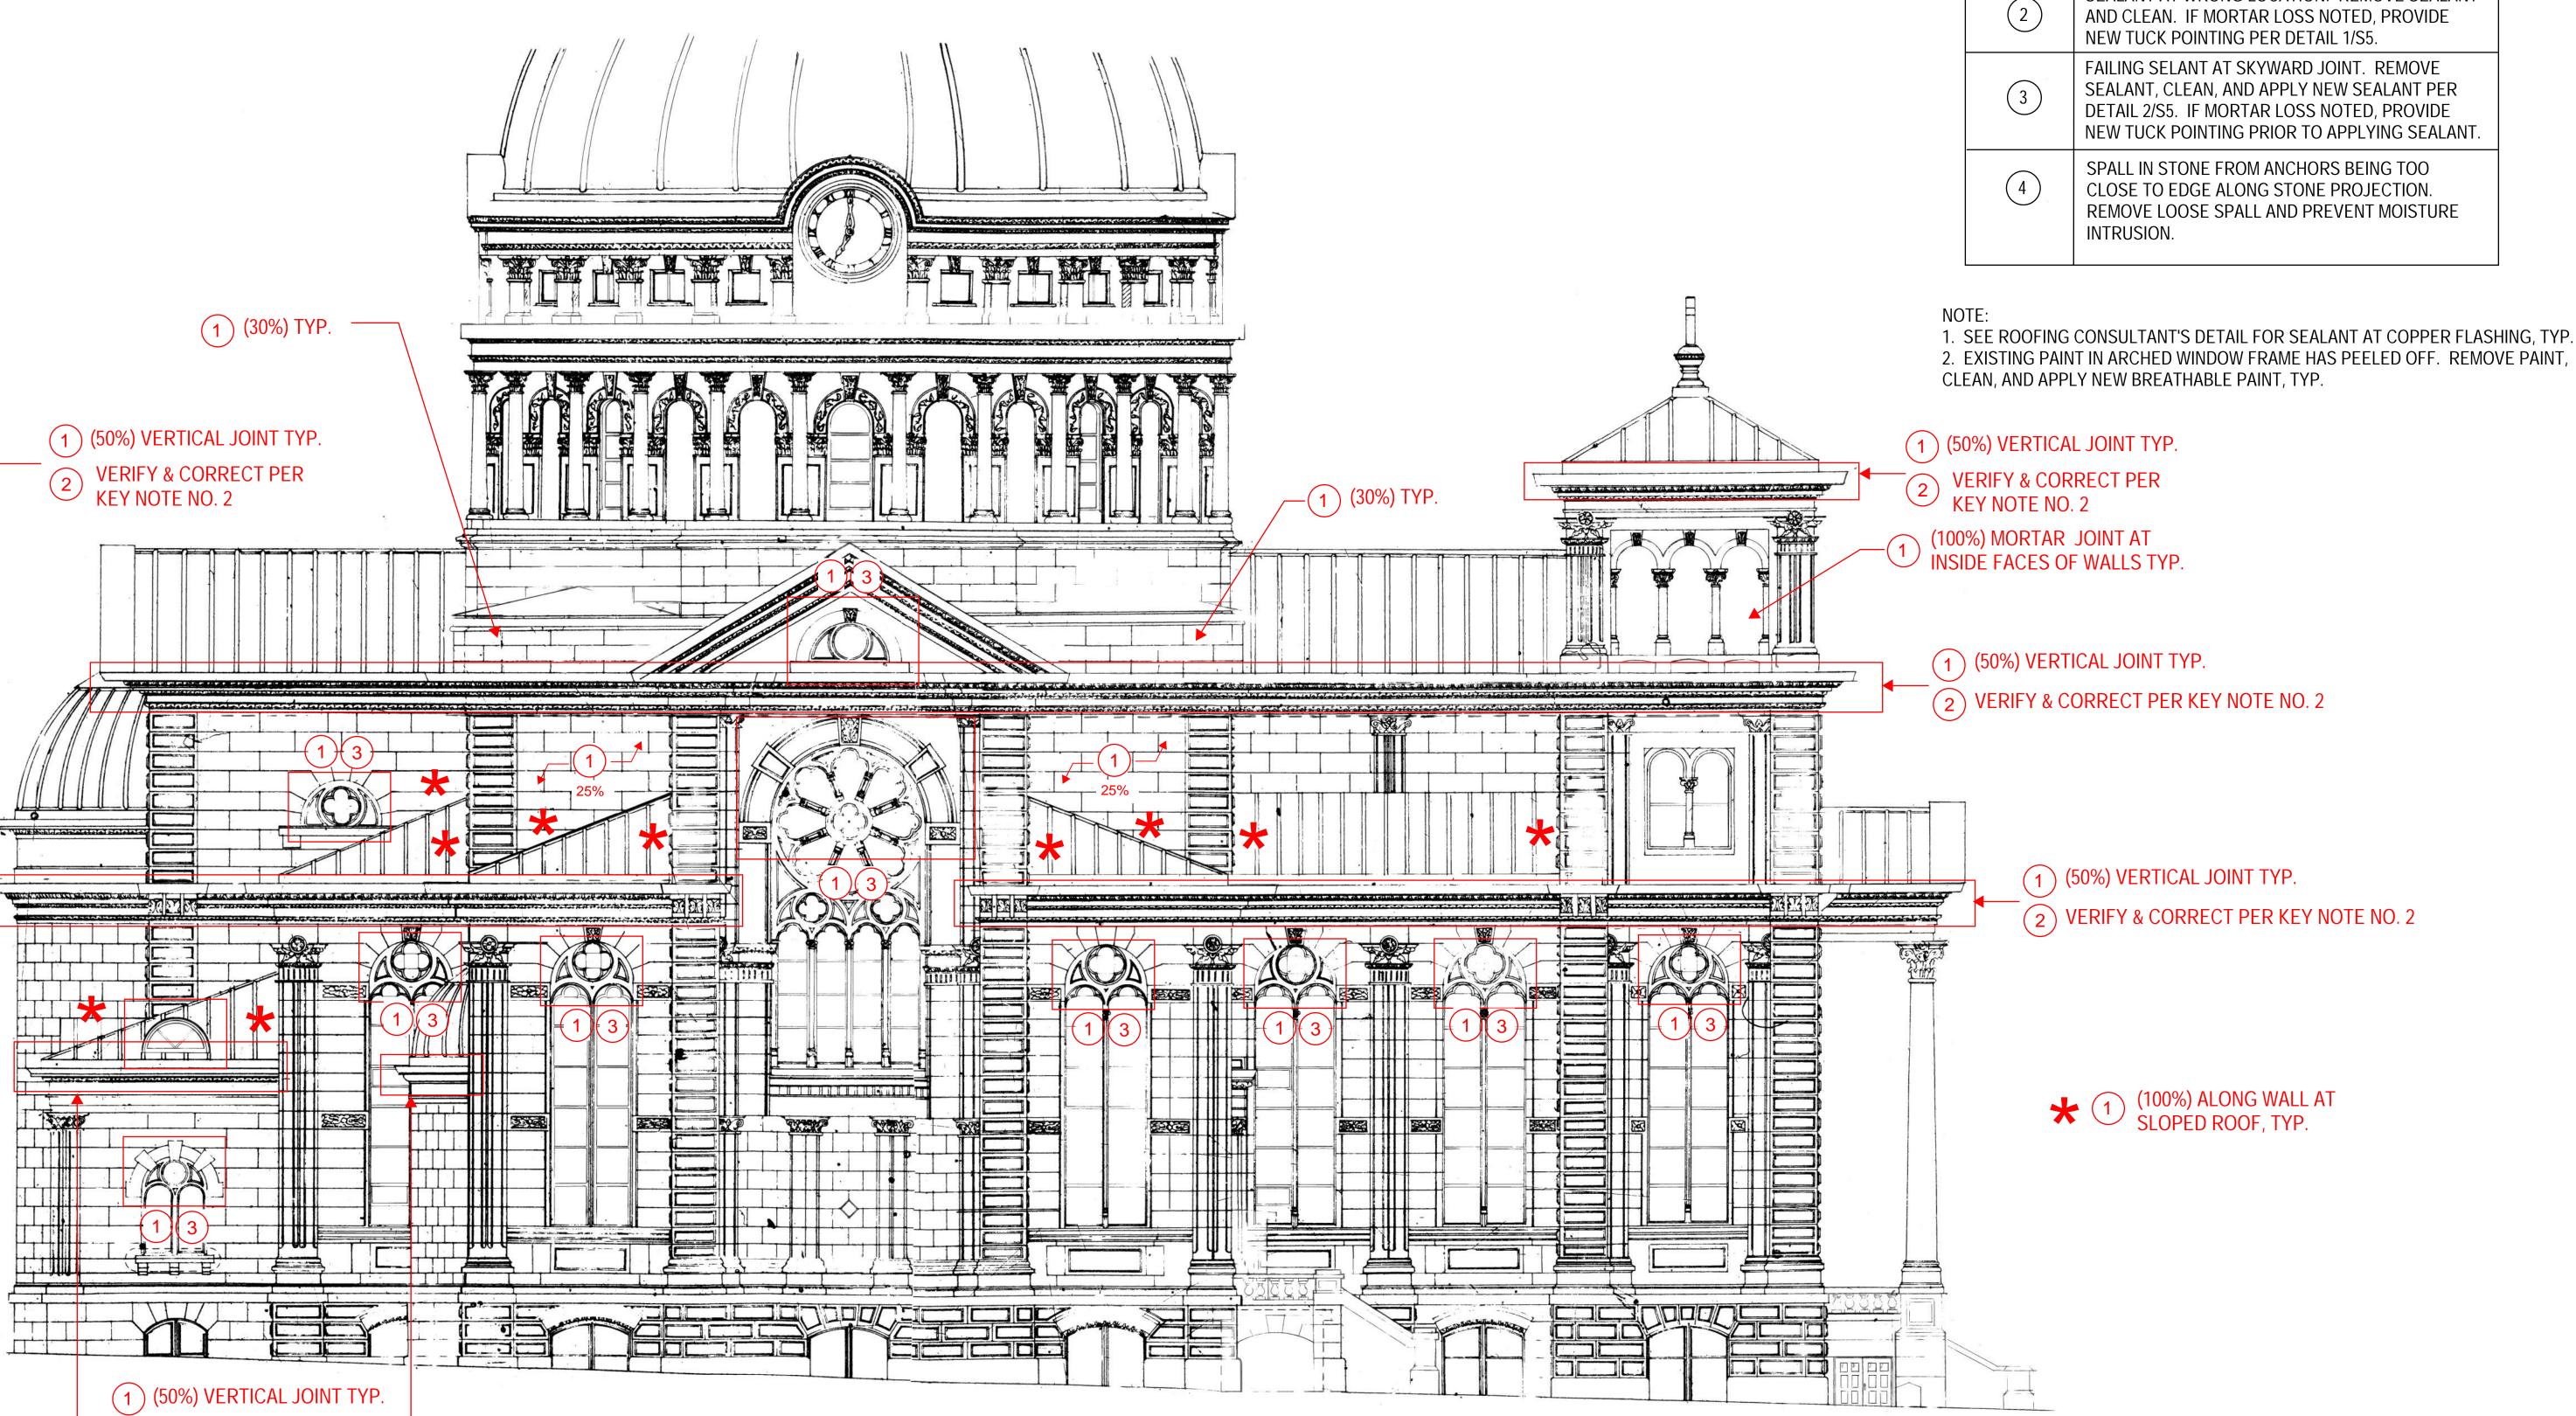

EAST ELEVATION

VERIFY & CORRECT PER KEY NOTE NO. 2

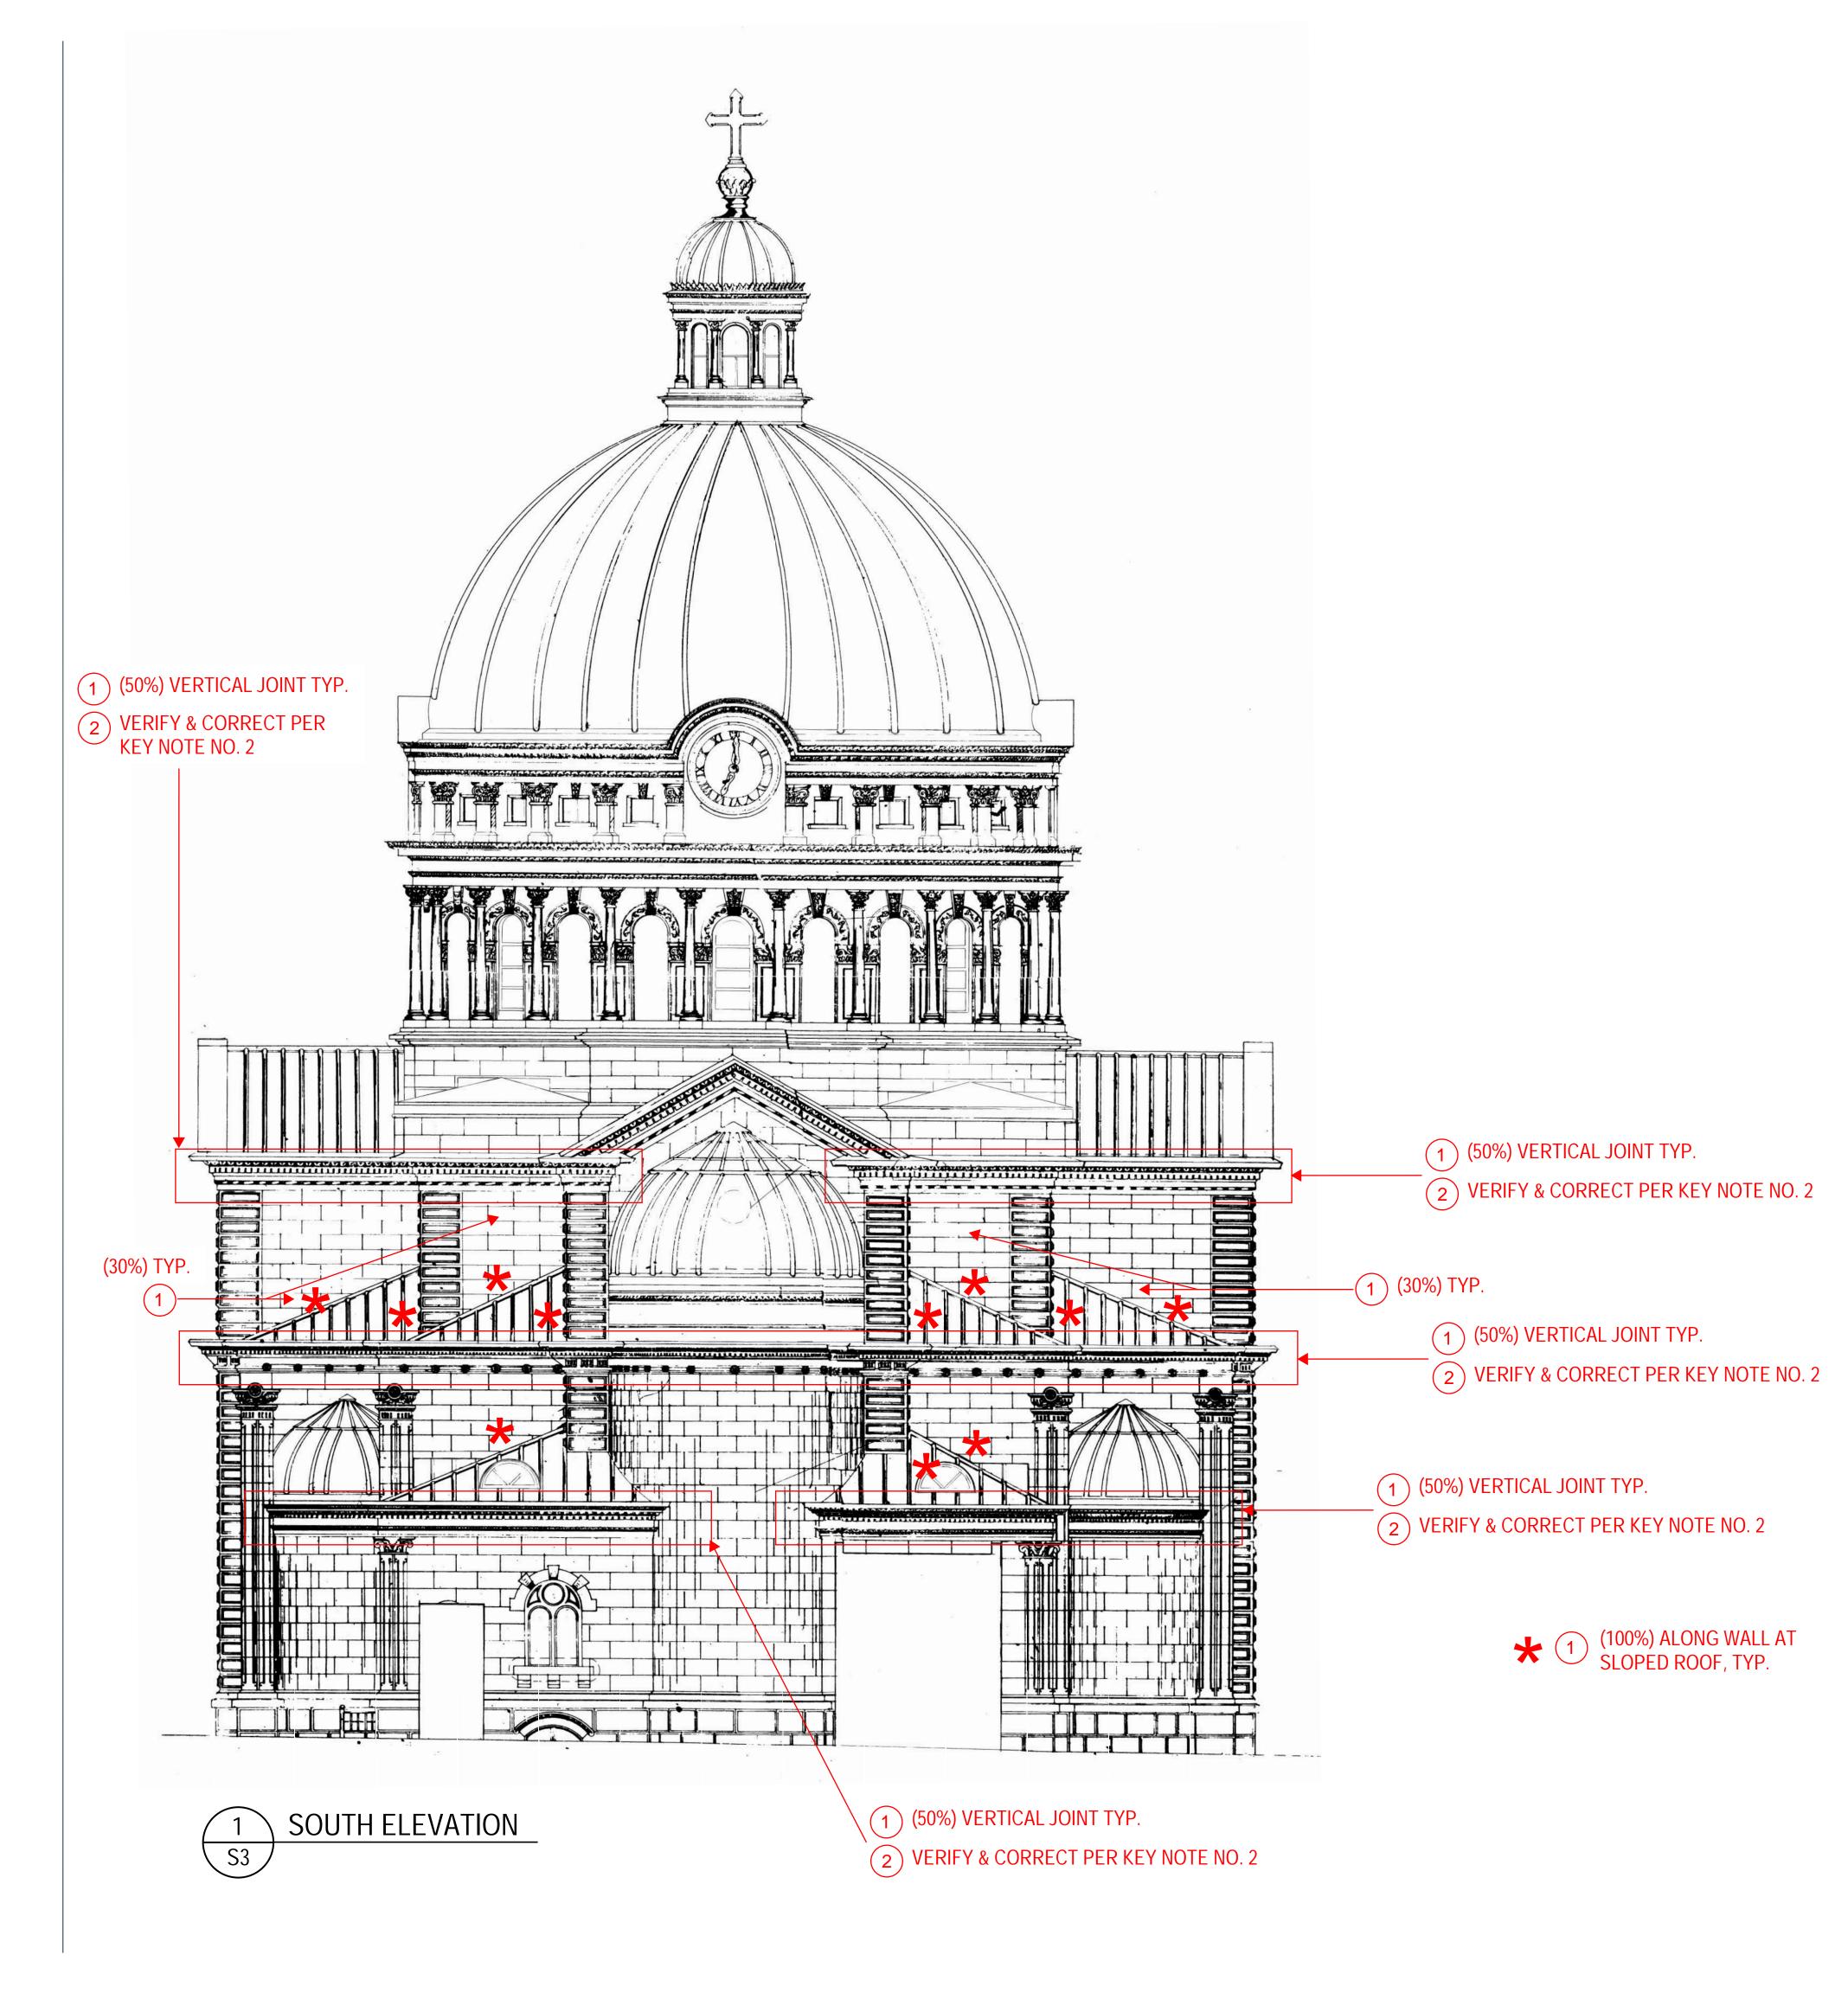

MARK	DESCRIPTION
1	FAILING/WEATHERED/LOOSE MORTAR IN JOINT. PROVIDE NEW TUCK POINTING. SEE DETAIL 1/S5.
2	SEALANT AT WRONG LOCATION. REMOVE SEALANT AND CLEAN. IF MORTAR LOSS NOTED, PROVIDE NEW TUCK POINTING PER DETAIL 1/S5.
3	FAILING SELANT AT SKYWARD JOINT. REMOVE SEALANT, CLEAN, AND APPLY NEW SEALANT PER DETAIL 2/S5. IF MORTAR LOSS NOTED, PROVIDE NEW TUCK POINTING PRIOR TO APPLYING SEALANT.
4	SPALL IN STONE FROM ANCHORS BEING TOO CLOSE TO EDGE ALONG STONE PROJECTION. REMOVE LOOSE SPALL AND PREVENT MOISTURE INTRUSION.

NOTE:

- SEE ROOFING CONSULTANT'S DETAIL FOR SEALANT AT COPPER FLASHING, TYP.
 EXISTING PAINT IN ARCHED WINDOW FRAME HAS PEELED OFF. REMOVE PAINT,
- CLEAN, AND APPLY NEW BREATHABLE PAINT, TYP.

PIERCE ENGINEERS, INC.
CONSULTING STRUCTURAL ENGINEERS

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FACADE REVIEW

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PE PROJECT: 18368

SOUTH ELEVATION

ALE: AS NOTED AWN BY: PE ECKED BY: PE

MARK	DESCRIPTION
1	FAILING/WEATHERED/LOOSE MORTAR IN JOINT. PROVIDE NEW TUCK POINTING. SEE DETAIL 1/S5.
2	SEALANT AT WRONG LOCATION. REMOVE SEALANT AND CLEAN. IF MORTAR LOSS NOTED, PROVIDE NEW TUCK POINTING PER DETAIL 1/S5.
3	FAILING SELANT AT SKYWARD JOINT. REMOVE SEALANT, CLEAN, AND APPLY NEW SEALANT PER DETAIL 2/S5. IF MORTAR LOSS NOTED, PROVIDE NEW TUCK POINTING PRIOR TO APPLYING SEALANT.
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NOTE

 SEE ROOFING CONSULTANT'S DETAIL FOR SEALANT AT COPPER FLASHING, TYP.
 EXISTING PAINT IN ARCHED WINDOW FRAME HAS PEELED OFF. REMOVE PAINT, CLEAN, AND APPLY NEW BREATHABLE PAINT, TYP.

(1) (50%) VERTICAL JOINT TYP.

2 VERIFY & CORRECT PER KEY NOTE NO. 2

(50%) VERTICAL JOINT TYP.

2 VERIFY & CORRECT PER KEY NOTE NO. 2

(100%) ALONG WALL AT SLOPED ROOF, TYP.

ST. JOSAPHAT BASILICA

NO. DATE DESCRIPTION

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FACADE REVIEW

2333 S. 6th STREET MILWAUKEE, WI 53215

PE PROJECT: 18368


WEST ELEVATION

S AS NOTED | S4



(1) (50%) VERTICAL JOINT TYP.

2 VERIFY & CORRECT PER KEY NOTE NO. 2

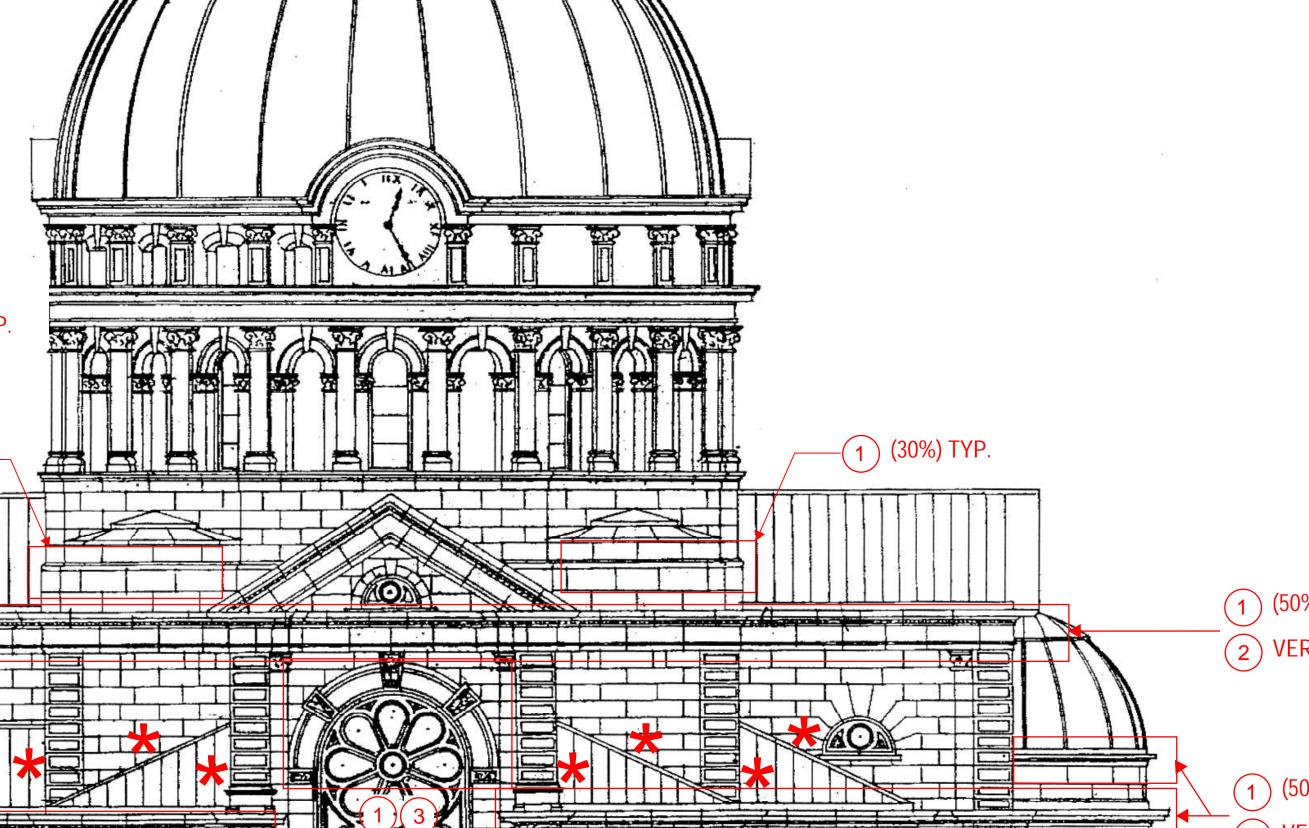

GENERAL REPAIR NOTES

1. CONTRACTOR TO SHORE ALL CONSTRUCTION AS REQUIRED TO SAFELY PERFORM ALL WORK.

APPROVED BY THE STRUCTURAL ENGINEER PRIOR TO USE ON THE BUILDING STRUCTURE.

- 2. CONTRACTOR IS TO LOCATE ALL AREAS OF DISREPAIR AND MARK AREAS ADEQUATELY.
- 3. ALL REPAIR MATERIALS, METHODS, BONDING AGENTS, SEALANTS, SEALERS, ETC MUST BE
- 4. CONTRACTOR MUST NOTIFY THE STRUCTURAL ENGINEER IMMEDIATELY IF ANY ITEMS UNCOVERED DURING CONSTRUCTION REPRESENT POTENTIAL STRUCTURAL CONCERNS.
- 5. STRUCTURAL ENGINEER SHALL BE NOTIFIED PRIOR TO PLACING ANY REPAIR MATERIALS IN ORDER TO VERIFY PROPER PROCEDURES ARE BEING FOLLOWED.
- 6. ALL MANUFACTURER RECOMMENDATIONS MUST BE FOLLOWED WHEN PLACING AND PREPARING FOR REPAIR MATERIALS.
- 7. ALL EXPOSED/CORRODED EXISTING REINFORCING MUST BE CLEANED AND COATED WITH A ZINC RICH PRIMER. EXISTING EPOXY COATING THAT HAS BEEN COMPROMISED MUST BE REMOVED AND ALL EXPOSED STEEL COATED WITH A ZINC RICH PRIMER.
- 8. ALL NEW STONE ANCHORS SHALL BE STAINLESS STEEL.
- 9. CONTRACTOR TO CLEAN THE AREA OF WORK AFTER THE COMPLETION OF ALL REPAIR WORK.

STANDARD ABBREVIATIONS <u>ABBREVIATION</u> WORD OR PHRASE & ———— AND DIA. — DIAMETER ETC. — ET CETRA MAX. — MAXIMUM MIN. — MINIMUM SS — STAINLESS STEEL TYP. — TYPICAL

MATERIAL DESIGN PROPERTIES

STONE MASONRY STRENGTHS:

LIME MORTAR (1 PART LIME : 3 PARTS SAND)


COMPRESSIVE STRENGTH 15,000 psi (MIN.) WATER ABSORPTION 5 % (MAX.) 1,300 psi (MIN.) MODULUS OF RUPTURE

REPLACEMENT STONE TO MATCH EXISTING STONE IN STRENGTH, TEXTURE, AND, COLOR AS MUCH AS POSSIBLE


STRUCTURAL STEEL STRENGTHS:

STAINLESS STEEL ANCHORS (SS 316)

Fy = 30,000 psi

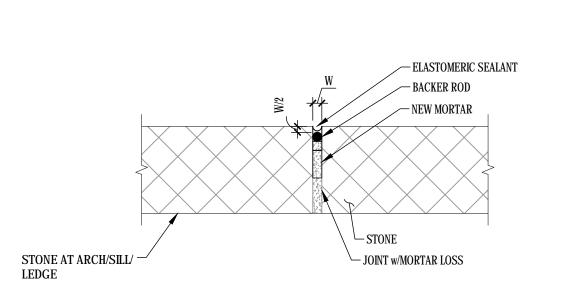

2 SKYWARD JOINT SEALING DETAIL

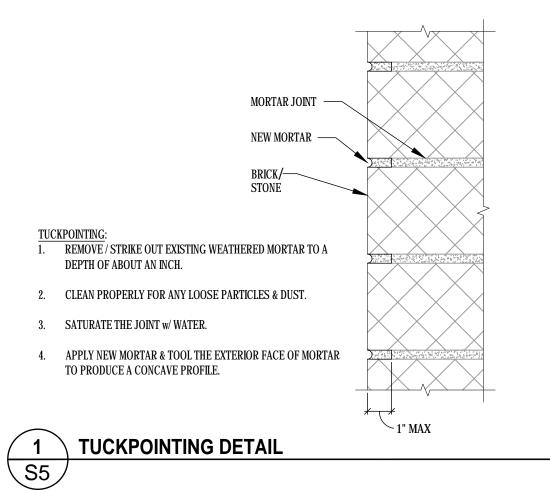

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FACADE REHABILITATION

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PE PROJECT: 18368