

# Park 7 Lofts - Bucks Block 7

MILWAUKEE, WISCONSIN | NOVEMBER 13, 2017



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### **CONTACT INFORMATION**

### **Kevin Newell**

CEO/President Royal Capital Group, LLC.

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MILWAUKEE | MADISON | TUCSON | CHICAGO

### PARK 7 LOFTS

550 West Juneau Avenue Milwaukee, WI 53212

Royal Capital Group, LLC. 710 N Plankinton Ave, Suite 300 Milwaukee, WI 53203

> 162642.00 075-35472

EA PROJECT NUMBER

HUD PROJECT NUMBER

ISSUED FOR: DPD MINOR MODIFICATION 10/16/17

**REVISION FOR:** DATE NO. DESCRIPTION

DRAWN BY CHECKED BY

SITE PLAN, VICINITY MAP + SITE PHOTOS

1 ARCHITECTURAL SITE PLAN
SCALE: 1/16" = 1'-0"





SITE PHOTOS















A001

### GENERAL

CONTRACTOR.

1. THE LOCATION OF ALL STRUCTURES, OBSTACLES, AND EXISTING FACILITIES SHALL NOT BE TAKEN AS CONCLUSIVE. IT SHALL BE ASSUMED THAT THE CONTRACTOR HAS VERIFIED SAID LOCATIONS AS A CONDITION OF HIS BID AND THEREFORE THE CONTRACTOR SHALL BE RESPONSIBLE FOR ALL DAMAGES RESULTING FROM HIS ACTIVITIES.

2. ALL CONTRACTORS SHALL BE RESPONSIBLE FOR OBTAINING ALL PERMITS NECESSARY TO CARRY OUT THEIR WORK.

3. THE CONTRACTOR SHALL SUBMIT FOR APPROVAL BY THE OWNER A LIST OF ALL MATERIALS PROPOSED TO BE USED PRIOR TO ORDERING OR DELIVERY.

4. ALL CONTRACTORS SHALL HAVE A COMPETENT FOREMAN, SUPERINTENDENT, OR OTHER REPRESENTATIVE AT THE SITE AT ALL

5. A PRE CONFERENCE WILL BE HELD PRIOR TO CONSTRUCTION START UP.

TIMES WHO HAS AUTHORITY TO ACT FOR THE

6. CONTRACTORS SHALL BE RESPONSIBLE FOR ADEQUATELY BARRICADING AREAS AND ERECTING A CONSTRUCTION FENCE AROUND THE PERIMETER OF THE SITE OF CONSTRUCTION TO PROTECT AGAINST PERSONAL INJURY AS WELL AS WARN TRAFFIC OF THE CONSTRUCTION SITE WHERE NECESSARY. SIGNING SHALL BE IN ACCORDANCE WITH THE MANUAL ON UNIFORM TRAFFIC CONTROL DEVICES (MUTCD) MOST RECENT VERSION WITH WISDOT SUPPLEMENT. ALL OTHER SIGNS MUST BE PRE-APPROVED BY OWNER.

7. ALL DIMENSIONS ARE TO THE EDGE OF FACE OF CURB, PAVEMENT, FACE OF BUILDING OR PROJECT WORK LIMIT LINE UNLESS OTHERWISE NOTED.

8. ALL CONSTRUCTION SHALL BE DONE IN ACCORDANCE WITH THE WISCONSIN DEPARTMENT OF TRANSPORTATION STANDARD SPECIFICATIONS FOR HIGHWAY AND STRUCTURE CONSTRUCTION - 2017 EDITION, HEREIN REFERRED TO AS THE STANDARD SPECIFICATIONS, EXCEPT AS MODIFIED HEREIN.

9. WHERE SPECIFIC PORTIONS OF THESE PLANS & SPECIFICATIONS ARE IN CONFLICT WITH THE WISCONSIN DEPARTMENT OF TRANSPORTATION STANDARD SPECIFICATIONS FOR HIGHWAY AND STRUCTURE CONSTRUCTION, 2017 EDITION. THESE PLANS & SPECIFICATIONS SHALL GOVERN.

10. CONSTRUCTION WORK AND STORAGE OF EQUIPMENT OR MATERIALS WILL NOT BE ALLOWED IN WETLAND AREAS.

11. A STREET EXCAVATION PERMIT WILL BE REQUIRED FOR WORK WITHIN THE PUBLIC RIGHT OF WAY/EASEMENTS. APPLICABLE PERMIT FEES WILL BE DETERMINED UPON RECEIPT OF THE PERMIT APPLICATION. COORDINATE PERMIT APPLICATION WITH THE CITY OF MILWAUKEE DPW ENGINEERING INSPECTOR, AFTER FINAL PLAN APPROVAL.

12. CITY OF MILWAUKEE PUBLIC WORKS INSPECTION IS NEEDED FOR ALL WORK WITHIN THE PUBLIC RIGHT OF WAY/EASEMENTS. CONTACT INSPECTION SUPERVISOR 72 HOURS LATERALS, SERVICES AND BOXES. PRIOR TO SCHEDULING WORK.

# <u>GRADING</u>

1. THE CONTRACTOR SHALL BE RESPONSIBLE FOR CONSTRUCTING THE PROPOSED SIDEWALKS, STORMWATER MANAGEMENT FACILITIES AND EROSION CONTROL DEVICES TO THE PROPOSED GRADE ELEVATIONS AND LOCATIONS SHOWN ON THE GRADING PLAN.

2. THE CONTRACTOR SHALL STRIP AND REMOVE TOPSOIL FOUND WITHIN THE GRADING LIMITS. GRADE LANDSCAPE AREAS LOW TO ALLOW FOR PLACEMENT OF TOPSOIL, SEED, MULCH AND PLANTINGS BY LANDSCAPE CONTRACTOR PER THE LANDSCAPE SPECIFICATIONS AND PLANS.

3. THE SUB GRADE FOR THE ROAD SHALL BE PREPARED IN ACCORDANCE WITH SECTION 31 22 16.15 OF THE CONTRACT SPECIFICATIONS. OPERATION OF SPREADING AND HAULING EQUIPMENT WILL NOT BE CONSIDERED AS ADEQUATE COMPACTION.

4. THE BASE COURSE SHALL BE PLACED ONLY ON SUB GRADE THAT HAS BEEN PROOF-ROLLED.

5. GRADING CONTRACTOR SHALL BE RESPONSIBLE FOR PROTECTION OF EXISTING PROPERTY CORNERS AND PERTINENT AREAS WITHIN ALL EASEMENTS.

SIDEWALK AND MISCELLANEOUS

1. WHERE INDICATED ON THE PLANS, INSTALL CONCRETE SIDEWALK IN ACCORDANCE WITH CONTRACT SPECIFICATION 32 16 00.

2. ALL SURPLUS EXCAVATED MATERIAL SHALL BE COORDINATED WITH THE GENERAL CONTRACTOR FOR ITS TEMPORARY LOCATION.

SANITARY AND WATER SERVICES

1. ALL SANITARY AND WATER SERVICE CONSTRUCTION SHALL BE IN ACCORDANCE WITH THE CONTRACT SPECIFICATIONS AND CITY OF MILWAUKEE STANDARDS. REFERENCES ARE STANDARD SPECIFICATIONS FOR SEWER AND WATER CONSTRUCTION IN WISCONSIN (2003 EDITION: ADDENDUM NO. 1 AND NO. 2, 2004), REGULATIONS OF THE DEPARTMENT OF SAFETY AND PROFESSIONAL SERVICES (DSPS) (SPS 382) FOR PRIVATE DEVELOPMENT WORK.

2. ALL PIPE MATERIALS AND CONSTRUCTION SHALL BE IN ACCORDANCE WITH THE FOLLOWING: SEE CONTRACT SPECIFICATIONS FOR DETAILS.

A. SANITARY LATERAL- SECTION 33 30 00 FOR PVC PIPE, ASTM D3034, SDR 26.

B. WATER BRANCH - SECTION 33 10 00 FOR DUCTILE IRON PIPE, ANSI/AWWA C151/A21.51, CLASS 55

3. ALL SANITARY PIPE JOINT CONNECTIONS SHALL BE PUSH-ON RUBBER GASKET. ALL WATER FITTINGS SHALL CONFORM TO SPECIFICATION SECTION 33 10 00. OFFSET FITTINGS SHALL BE MEGA-LUGS OR EQUAL.

4. WATER VALVES SHALL BE FURNISHED AND INSTALLED BY MILWAUKEE WATER WORKS.

5. BACKFILL MATERIAL FOR WATER UTILITIES SHALL BE CRUSHED STONE BACKFILL (CONTRACT SPECIFICATION SECTION 33 10 00) UNDER PAVED SURFACES OR SPOIL (STANDARD SPEC SECTION 8.43.5) UNDER LANDSCAPED AREAS.

7. IF APPLICABLE, SHELL-TYPE CUTTER WITH MULTIPLE CUTTING TEETH SHALL BE USED FOR TAPPING SERVICE CONNECTIONS. AS FOLLOWS:

A. CORPORATION STOPS SHALL NOT BE LOCATED CLOSER THAN ONE (1) FOOT FROM PIPE JOINTS. INSERTIONS ON OPPOSITE SIDES OF THE MAIN SHALL BE SEPARATED BY MIN. OF ONE (1) FOOT.

B. TEFLON TAPE SHALL BE PLACED ON THE CORPORATION STOP THREADS PRIOR TO INSTALLATION.

8. CONTRACTOR SHALL INSTALL TRACER WIRE WITH ALL NON-METALLIC WATER UTILITIES IN ACCORDANCE WITH SECTION 33 10 00 OF SPECIFICATIONS. THIS INCLUDES ALL

**UTILITY CONTACTS:** 

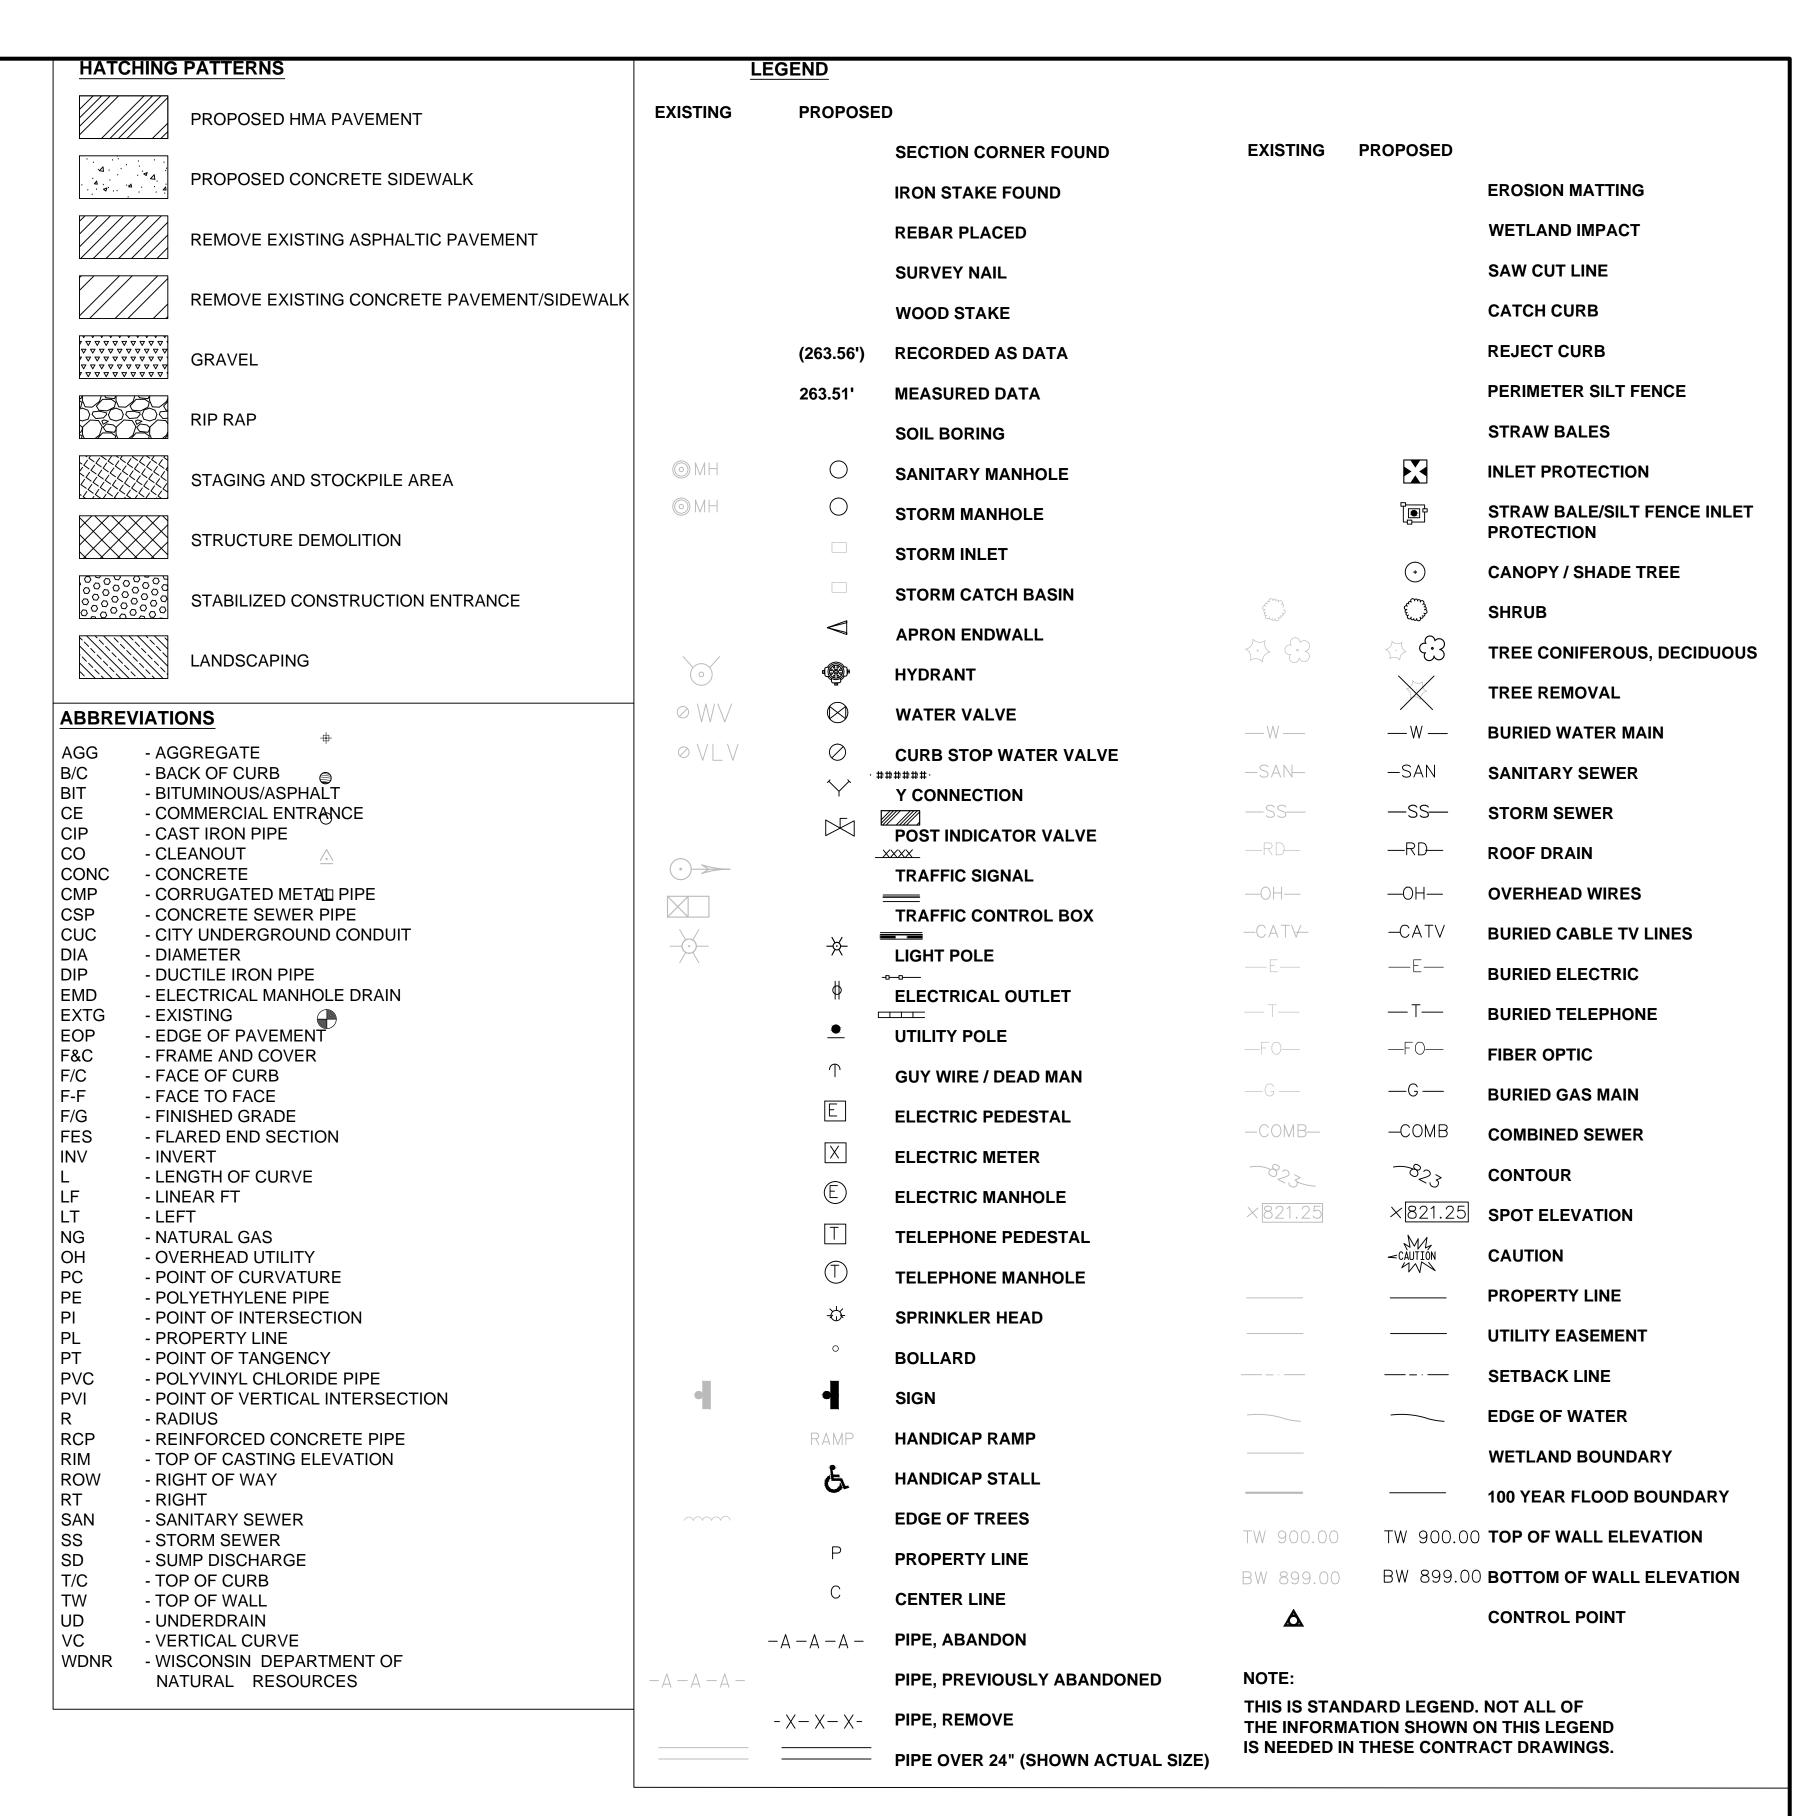
CITY OF MILWAUKEE (WATER & SEWER) CITY OF MILWAUKEE (INSPECTION SUPERVISOR)

CITY OF MILWAUKEE (DPW ENGINEERING INSPECTOR)

CITY OF MILWAUKEE (CITY ENGINEER)

WE ENERGIES EMERGENCY CONTACT

1-800-261-5325



# INDEX OF SHEETS

- GENERAL NOTES C100 C200 - SITE PLAN GRADING PLAN C300 UTILITY PLAN

### **SURVEY NOTES:**

1. HORIZONTAL DATUM: WISCONSIN STATE PLANE COORDINATE SYSTEM SOUTH ZONE NAD27. NORTH IS REFERENCED TO THE S. LINE OF THE SE  $\frac{1}{4}$  OF SECTION 20-7-22 PUBLISHED BY ÙÒY ÜŰÂŒÂŬÂÛÜ YÓÙ

2. VERTICAL DATUM: CITY OF MILWAUKEE DATUM. BENCHMARK IS THE MONUMENT FOR THE S  $\frac{1}{4}$ CORNER OF SECTION 20-T7N-R22E. ELEV = 19.18'.

 EXISTING CONDITIONS - EROSION CONTROL PLAN C501-502 - CONSTRUCTION DETAILS L100 LANDSCAPE PLAN

**ARCHITECTS** 

MILWAUKEE | MADISON | TUCSON | CHICAGO



3636 North 124th Street Wauwatosa, WI 53222 262-821-1171

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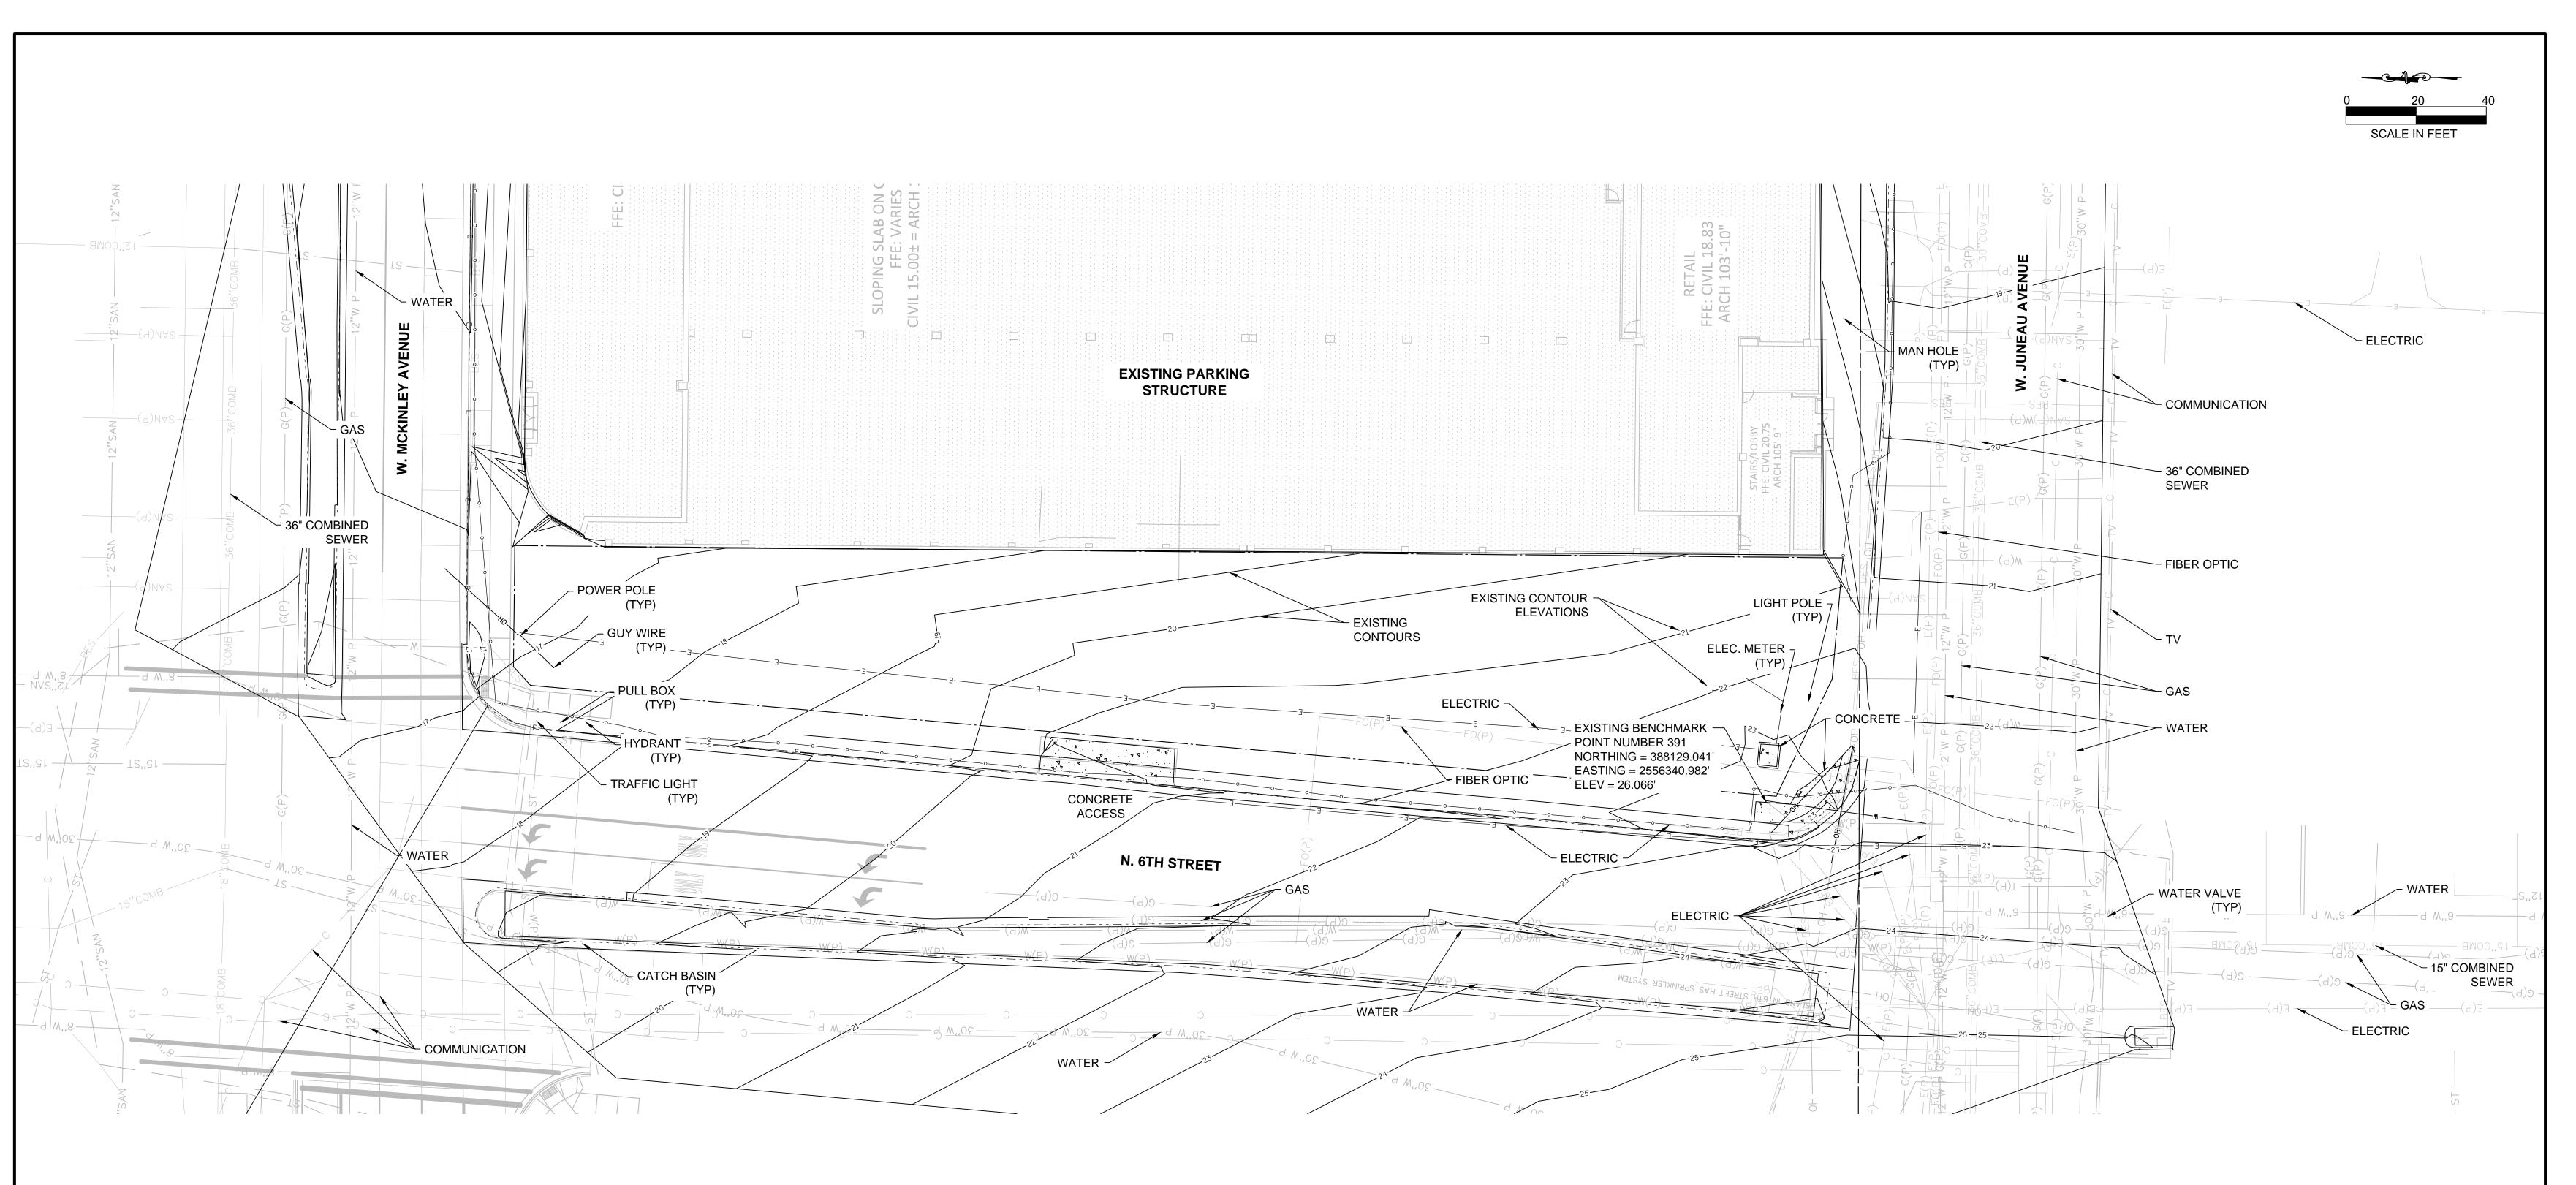
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APS

GENERAL NOTES AND LEGEND



### NOTES:

- 1. THE UNDERGROUND UTILITY INFORMATION AS SHOWN HEREON IS BASED, IN PART, UPON INFORMATION FURNISHED BY UTILITY COMPANIES, CITY OF MILWAUKEE, MILWAUKEE METROPOLITAN SEWERAGE DISTRICT, AND PRIVATE LOCATORS. WHILE THIS INFORMATION IS BELIEVED TO BE RELIABLE, ITS ACCURACY AND COMPLETENESS CANNOT BE GUARANTEED NOR CERTIFIED
- 2. ALL EXISTING UTILITIES SHOWN ARE BASED ON FIELD MARKINGS/PRINTS PROVIDED BY DIGGER'S HOTLINE, OR RECORD DRAWINGS BY OTHERS. CONTRACTOR SHALL CONTACT DIGGER'S HOTLINE AT 811 OR 1-800-242-8511 PRIOR TO PERFORMING EARTH MOVING OR EXCAVATION ACTIVITIES. CONTRACTOR SHALL CONTACT ANY OTHER UTILITY WHICH MAY BE PRESENT WHICH ARE NOT PART OF THE ONE CALL SYSTEM.
- 3. CONTRACTOR SHALL VERIFY ALL EXISTING UTILITY LOCATIONS (VERTICALLY AND HORIZONTALLY) PRIOR TO CONSTRUCTION. ANY DISCREPANCIES SHALL BE DISCUSSED WITH THE ENGINEER.

### **SURVEY NOTES:**

BENCHMARK TABLE

BM ON HYD

DESCRIPTION

ELEV.

26.066

PT. NO. NORTHING EASTING

391 388129.041

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Engberg Anderson

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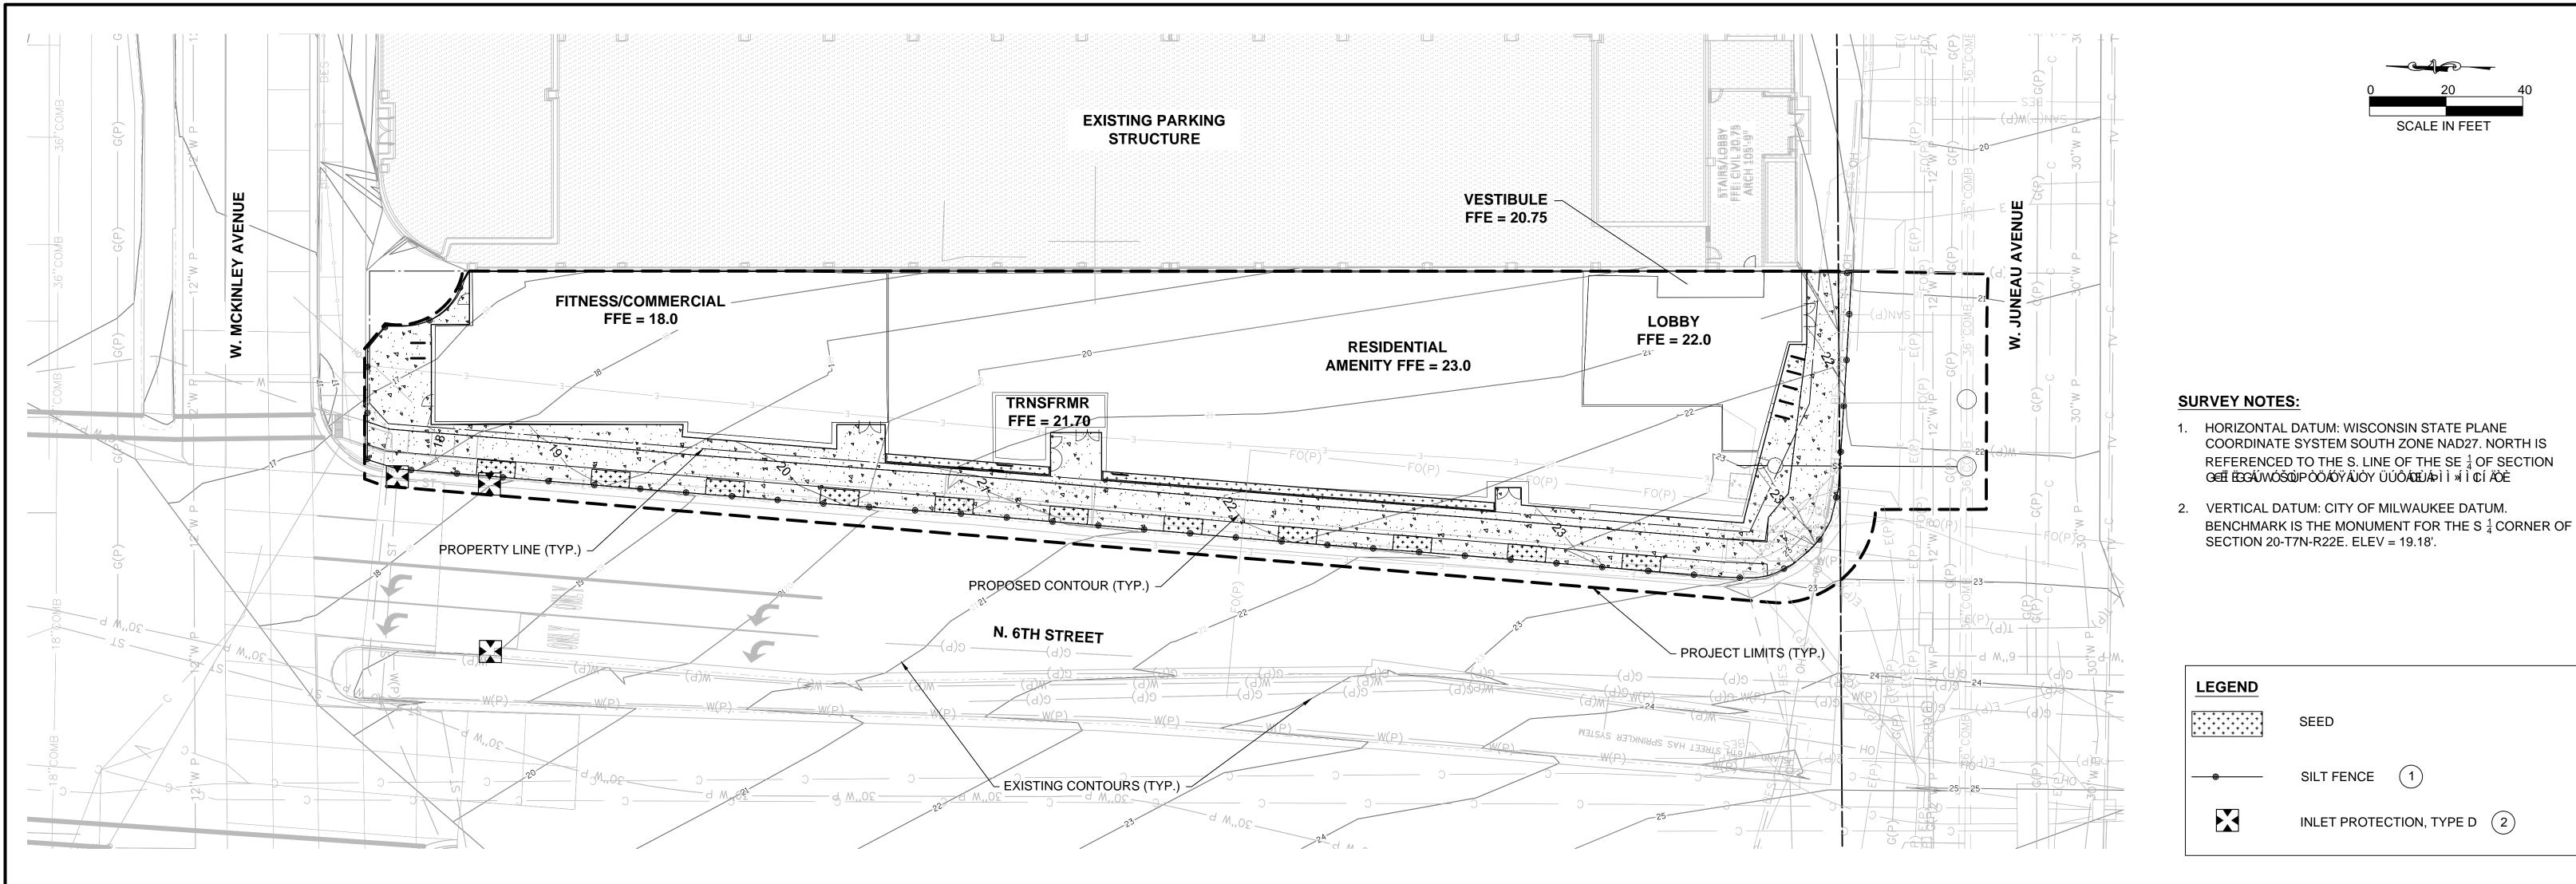
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EXISTING CONDITION



### **EROSION CONTROL NOTES**

SEDIMENTATION CONTROL SHALL COMPLY WITH THE REQUIREMENTS OF THE CITY OF MILWAUKEE AND EMPLOY EROSION CONTROL METHODS AS SHOWN IN THE DEPARTMENT OF NATURAL RESOURCES TECHNICAL STANDARDS WHICH CAN BE FOUND AT http://dnr.wi.gov/topic/stormwater/standards/const\_standards.html

CONSTRUCTION SITE EROSION CONTROL AND

- ALL EROSION CONTROL MEASURES SHALL BE ADJUSTED TO MEET FIELD CONDITIONS AT THE TIME OF CONSTRUCTION AND SHALL BE INSTALLED PRIOR TO ANY GRADING OR DISTURBANCE OF EXISTING SURFACE MATERIAL ON THE
- ALL EROSION AND SEDIMENT CONTROL MEASURES SHALL BE CHECKED FOR STABILITY AND OPERATION AFTER A RAINFALL OF 0.5" OR MORE, BUT NO LESS THAN ONCE EVERY WEEK. CONTRACTOR SHALL BE RESPONSIBLE FOR CLEAN UP AND REMOVAL OF ALL SEDIMENT AND ALL SEDIMENT CONTROL STRUCTURES. EROSION CONTROL MEASURES MUST BE IN WORKING CONDITION AT END OF EACH DAY. ALL RECORDS OF THE INSPECTION AND MAINTENANCE OF EROSION CONTROL MEASURES SHALL BE KEPT BY THE OWNER'S REPRESENTATIVE RESPONSIBLE FOR EROSION CONTROL INSPECTIONS.
- INSPECT AND MAINTAIN ALL INSTALLED EROSION CONTROL PRACTICES UNTIL CONTRIBUTING DRAINAGE AREA HAS BEEN STABILIZED.
- SILT FENCE SHALL BE INSTALLED IN HORSESHOE FASHION AROUND ALL TOPSOIL AND FILL STOCKPILES.
- ALL OFF-SITE SEDIMENT DEPOSITS FROM THIS PROJECT OCCURRING AS RESULT OF A STORM EVENT SHALL BE CLEANED UP BY END OF NEXT WORKING DAY. ALL OTHER OFF-SITE SEDIMENT DEPOSITS OCCURRING AS RESULT OF CONSTRUCTION ACTIVITIES SHALL BE CLEANED UP BY END OF THE WORK DAY.
- CONSTRUCTION SEQUENCE FOR EROSION CONTROL INCLUDES:
- 7.1. INSTALL SILT FENCE. 7.2. INSTALL INLET PROTECTION ON EXISTING STORM
- STRIP TOPSOIL, REMOVE AND/OR STOCKPILE.
- PERFORM ROUGH GRADING.
- INSTALL UTILITIES. 7.6. CONSTRUCT BUILDING.
- 7.7. INSTALL SIDEWALK.
- REMOVE ACCUMULATED SEDIMENT FROM SITE. REMOVE EROSION CONTROL MEASURES ONLY WHEN 7.9. SITE IS FULLY STABILIZED.
- SEVEN DAYS MUST BE IMMEDIATELY RESTORED WITH SEED 21 AND MULCH.

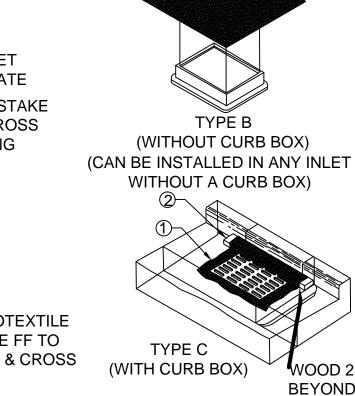
ALL EXPOSED SOIL AREAS NOT DISTURBED FOR UP TO

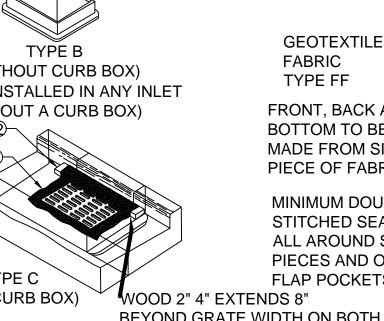
- IMMEDIATELY STABILIZE ALL DISTURBED AREAS THAT WILL 22. SEE LANDSCAPING PLAN FOR RESTORATION. REMAIN INACTIVE FOR 14 DAYS OR LONGER. BETWEEN SEPTEMBER 15 AND OCTOBER 15: STABILIZE WITH MULCH. TACKIFIER, AND A PERENNIAL SEED MIXED WITH WINTER WHEAT, ANNUAL OATS OR ANNUAL RYE, AS APPROPRIATE FOR REGION AND SOIL TYPE. OCTOBER 15 THROUGH COLD WEATHER; STABILIZE WITH A POLYMER AND DORMANT SEED MIX, AS APPROPRIATE FOR REGION AND SOIL TYPE.
- 10. RESTORATION OF ALL DISTURBED AREAS WITH SLOPES GREATER THAN 20% SHALL BE COMPLETED WITHIN 30 DAYS AFTER BEGINNING CONSTRUCTION ON SAID AREA.
- 11. SWEEP/CLEAN UP ALL SEDIMENT/TRASH THAT MOVES OFF-SITE DUE TO CONSTRUCTION ACTIVITY OR STORM EVENTS BEFORE THE END OF THE SAME WORKDAY OR AS DIRECTED BY CITY OF MILWAUKEE/OWNER/ OR ENGINEER. SEPARATE SWEPT MATERIALS (SOILS AND TRASH) AND DISPOSE OF APPROPRIATELY.

- 12. CONTRACTOR IS RESPONSIBLE FOR CONTROLLING DUST PER WDNR TECHNICAL STANDARD #1068 DUST CONTROL FOR CONSTRUCTION SITES.
- 13. PROPERLY DISPOSE OF ALL WASTE AND UNUSED BUILDING MATERIALS (INCLUDING GARBAGE, DEBRIS, CLEANING WASTES, OR OTHER CONSTRUCTION MATERIALS) AND DO NOT ALLOW THESE MATERIALS TO BE CARRIED BY RUNOFF INTO RECEIVING CHANNEL.
- 14. IF DEWATERING IS NEEDED, CONTRACTOR SHALL PROVIDE FOR SEDIMENT REMOVAL ACCORDING TO WDNR TECHNICAL STANDARD #1061. WATER PUMPED FROM THE SITE SHALL BE TREATED BY TEMPORARY SEDIMENTATION BASINS, GRIT CHAMBERS, SAND FILTERS, UPSLOPE CHAMBERS, HYDRO-CYCLONES, SWIRL CONCENTRATORS, OR OTHER APPROPRIATE CONTROLS. WATER MAY NOT BE DISCHARGED IN A MANNER THAT CAUSES EROSION OF THE SITE OR RECEIVING CHANNELS.
- 15. PROVIDE ANTI-SCOUR PROTECTION AND MAINTAIN NON-EROSIVE FLOW DURING DEWATERING, LIMIT PUMPING RATES, OR THE BASIN DESIGN RELEASE RATE WITH THE CORRECTLY FITTED HOSE AND GEOTEXTILE FILTER BAG. PERFORM DEWATERING OF ACCUMULATED SURFACE RUNOFF IN ACCORDANCE WITH WDNR TECHNICAL STANDARD #1061 DEWATERING.
- 16. MAKE PROVISIONS FOR WATERING DURING THE FIRST 8 WEEKS FOLLOWING SEEDING OR PLANTING OF DISTURBED AREAS WHENEVER MORE THAN 7 CONSECUTIVE DAYS OF DRY WEATHER OCCUR.
- CONTRACTOR IS RESPONSIBLE FOR COMPLYING WITH ALL APPLICABLE WDNR REMEDIATION AND WASTE MANAGEMENT REQUIREMENTS FOR HANDLING AND DISPOSING OF CONTAMINATED MATERIALS. SITE-SPECIFIC INFORMATION FOR AREAS WITH KNOWN OR SUSPECTED SOIL AND/OR GROUNDWATER CONTAMINATION CAN BE FOUND ON WDNR'S BUREAU OF REMEDIATION AND REDEVELOPMENT TRACKING SYSTEM (BRRTS) PUBLIC DATABASE AT http://dnr.wi.gov/topic/brownfields/botw.html
- 18. GRADING CONTRACTOR SHALL BE RESPONSIBLE FOR PROTECTION OF EXISTING PROPERTY CORNERS AND PERTINENT AREAS WITHIN ALL EASEMENTS.
- 19. CONTRACTOR IS RESPONSIBLE TO INSTALL ALL EROSION CONTROL DEVICES SHOWN ON THE PLANS IN ACCORDANCE WITH THE WDNR BEST MANAGEMENT PRACTICES.
- 20. SIDEWALKS SHALL BE CLEANED DAILY AS NEEDED. STREET SWEEPING SHALL BE COMPLETED TO MAINTAIN THE PUBLIC STREET FREE OF DUST AND DIRT.
- CONTRACTOR SHALL SEED & MULCH ALL DISTURBED AREAS WITHIN 7 DAYS.

### / 2" X 4" STAKE AND CROSS **GEOTEXTILE -**BRACING **FABRIC** TYPE FF BURIED FABRIC -\_\_\_ 2" X 4" STAKE MIN. 6' DEPTH AND CROSS **GEOTEXTILE** BRACING FABRIC **TYPE FF** ATTACH GEOTEXTILE INLET WITH OR FABRIC, TYPE FF TO WITHOUT GRATE THE STAKES & CROSS **BRACING**

**GENERAL NOTES** 





**GEOTEXTILE** 

FABRIC

TYPE FF

FRONT, BACK AND BOTTOM TO BE MADE FROM SINGLE PIECE OF FABRIC MINIMUM DOUBLE STITCHED SEAMS **ALL AROUND SIDE** PIECES AND ON FLAP POCKETS **BEYOND GRATE WIDTH ON BOTH** SIDES, SECURE TO GRATE WITH

- 4" X 6" OPENINGS WITH ROUNDED CORNERS, HOLE SHALL BE HEAT CUT INTO ALL FOUR SIDE PANELS. (CAN BE INSTALLED IN ANY INLET TYPE WITH OR WITHOUT A CURB

INLET SPECIFICATIONS AS PER

WIDTH TO MATCH

THE PLAN DIMENSION LENGTH AND

FLAP POCKET

USE REBAR OR STEEL ROD

WITH CAST CURB BOX USE

WOOD 2" X 4", EXTEND 10"

BEYOND GRATE WIDTH ON

OR PLASTIC TIES.

BOTH SIDES, LENGTH VARIES,

SECURE TO GRATE WITH WIRE

TAPER BOTTOM OF BAG

**SEPARATION BETWEEN** 

TO MAINTAIN 3' 0"

THE BAG AND THE

STRUCTURE AT THE

OVERFLOW HOLES

FOR REMOVAL OR FOR INLETS

### PLASTIC TIES. **INSTALLATION NOTES:**

2. FOR INLET PROTECTION, TYPE C (WITH CURB BOX) AN ADDITIONAL 18" OF FABRIC IS WRAPPED AROUND THE WOOD AND SECURED WITH STAPLES. THE WOOD SHALL NOT BLOCK THE ENTIRE HEIGHT OF THE CURB BOX OPENING.

1. FINISHED SIZE, INCLUDING FLAP POCKETS WHERE REQUIRED,

FACILITATE MAINTENANCE OR REMOVAL.

SHALL EXTEND A MINIMUM OF 10" AROUND THE PERIMETER TO

- 3. FLAP POCKETS SHALL BE LARGE ENOUGH TO ACCEPT WOOD 2"X4". THE REBAR, STEEL PIPE OR WOOD SHALL BE INSTALLED IN THE REAR FLAP AND SHALL NOT BLOCK THE TOP HALF OF THE CURB FACE OPENING.
- 4. FRONT LIFTING FLAP IS TO BE USED WHEN REMOVING AND MAINTAINING FILTER BAG.
- 5. INLET PROTECTION DEVICES SHALL BE MAINTAINED OR REPLACED AT THE DIRECTION OF THE ENGINEER.
- 6. MANUFACTURED ALTERNATIVES APPROVED AND LISTED ON THE DEPARTMENT'S EROSION CONTROL PRODUCT ACCEPTABILITY LIST MAY BE SUBSTITUTED.
- 7. WHEN REMOVING OR MAINTAINING INLET PROTECTION, CARE SHALL BE TAKEN SO THAT THE SEDIMENT TRAPPED ON THE GEOTEXTILE FABRIC DOES NOT FALL INTO THE INLET. ANY MATERIAL FALLING INTO THE INLET SHALL BE REMOVED IMMEDIATELY.

TYPE B & C

### TYPE FF GEOTEXTILE FABRIC (EXTEND FABRIC A MINIMUM OF 10"

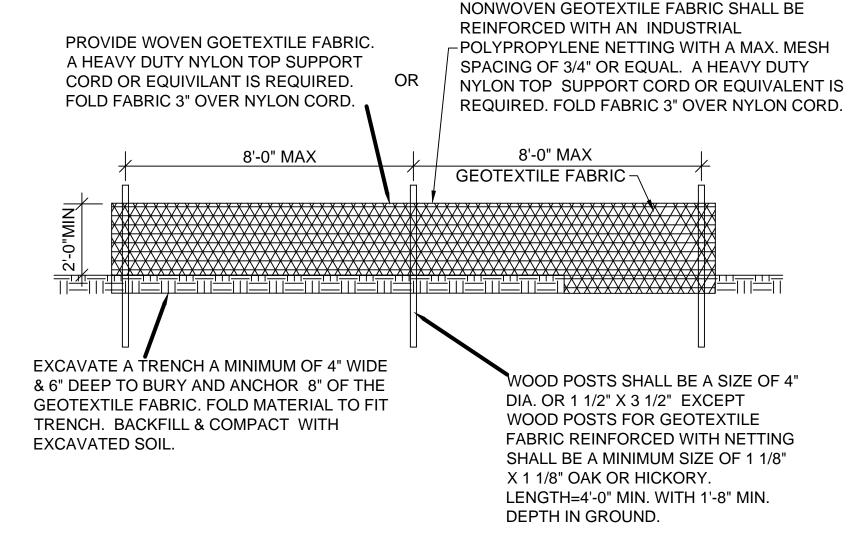
AROUND GRATE PERIMETER FOR MAINTENANCE OR REMOVAL.

THE CONTRACTOR SHALL DEMONSTRATE A METHOD OF MAINTENANCE, USING A SEWN FLAP, HAND HOLDS OR OTHER METHOD TO PREVENT ACCUMULATED SEDIMENT FROM ENTERING THE INLET.

### TYPE D

2 INLET PROTECTION NTS

- 1. DO NOT INSTALL INLET PROTECTION TYPE D IN INLETS SHALLOWER THAN 30", MEASURED FROM THE BOTTOM OF THE INLET TO THE TOP OF THE GRATE.
- 2. THE INSTALLED BAG SHALL HAVE A MINIMUM SIDE CLEARANCE, BETWEEN THE INLET WALLS AND THE BAG, MEASURED AT THE BOTTOM OF THE OVERFLOW HOLES, OF 3". WHERE NECESSARY THE CONTRACTOR SHALL CINCH THE BAG, USING PLASTIC ZIP TIES. TO ACHIEVE THE 3" CLEARANCE. THE TIES SHALL BE PLACED AT A MAXIMUM OF 4" FROM THE BOTTOM OF THE BAG.



### NOTES:

- 1. CONTRACTOR SHALL INSPECT SILT FENCE DAILY AND REPAIR OR REPLACE AS NEEDED. SEDIMENT SHALL BE REMOVED AND PROPERLY DISPOSED OF WHEN DEPOSITS REACH 1/2 THE HEIGHT OF THE FENCE.
- 2. ATTACH THE FABRIC TO THE POSTS WITH WIRE STAPLES OR WOODEN LATH AND



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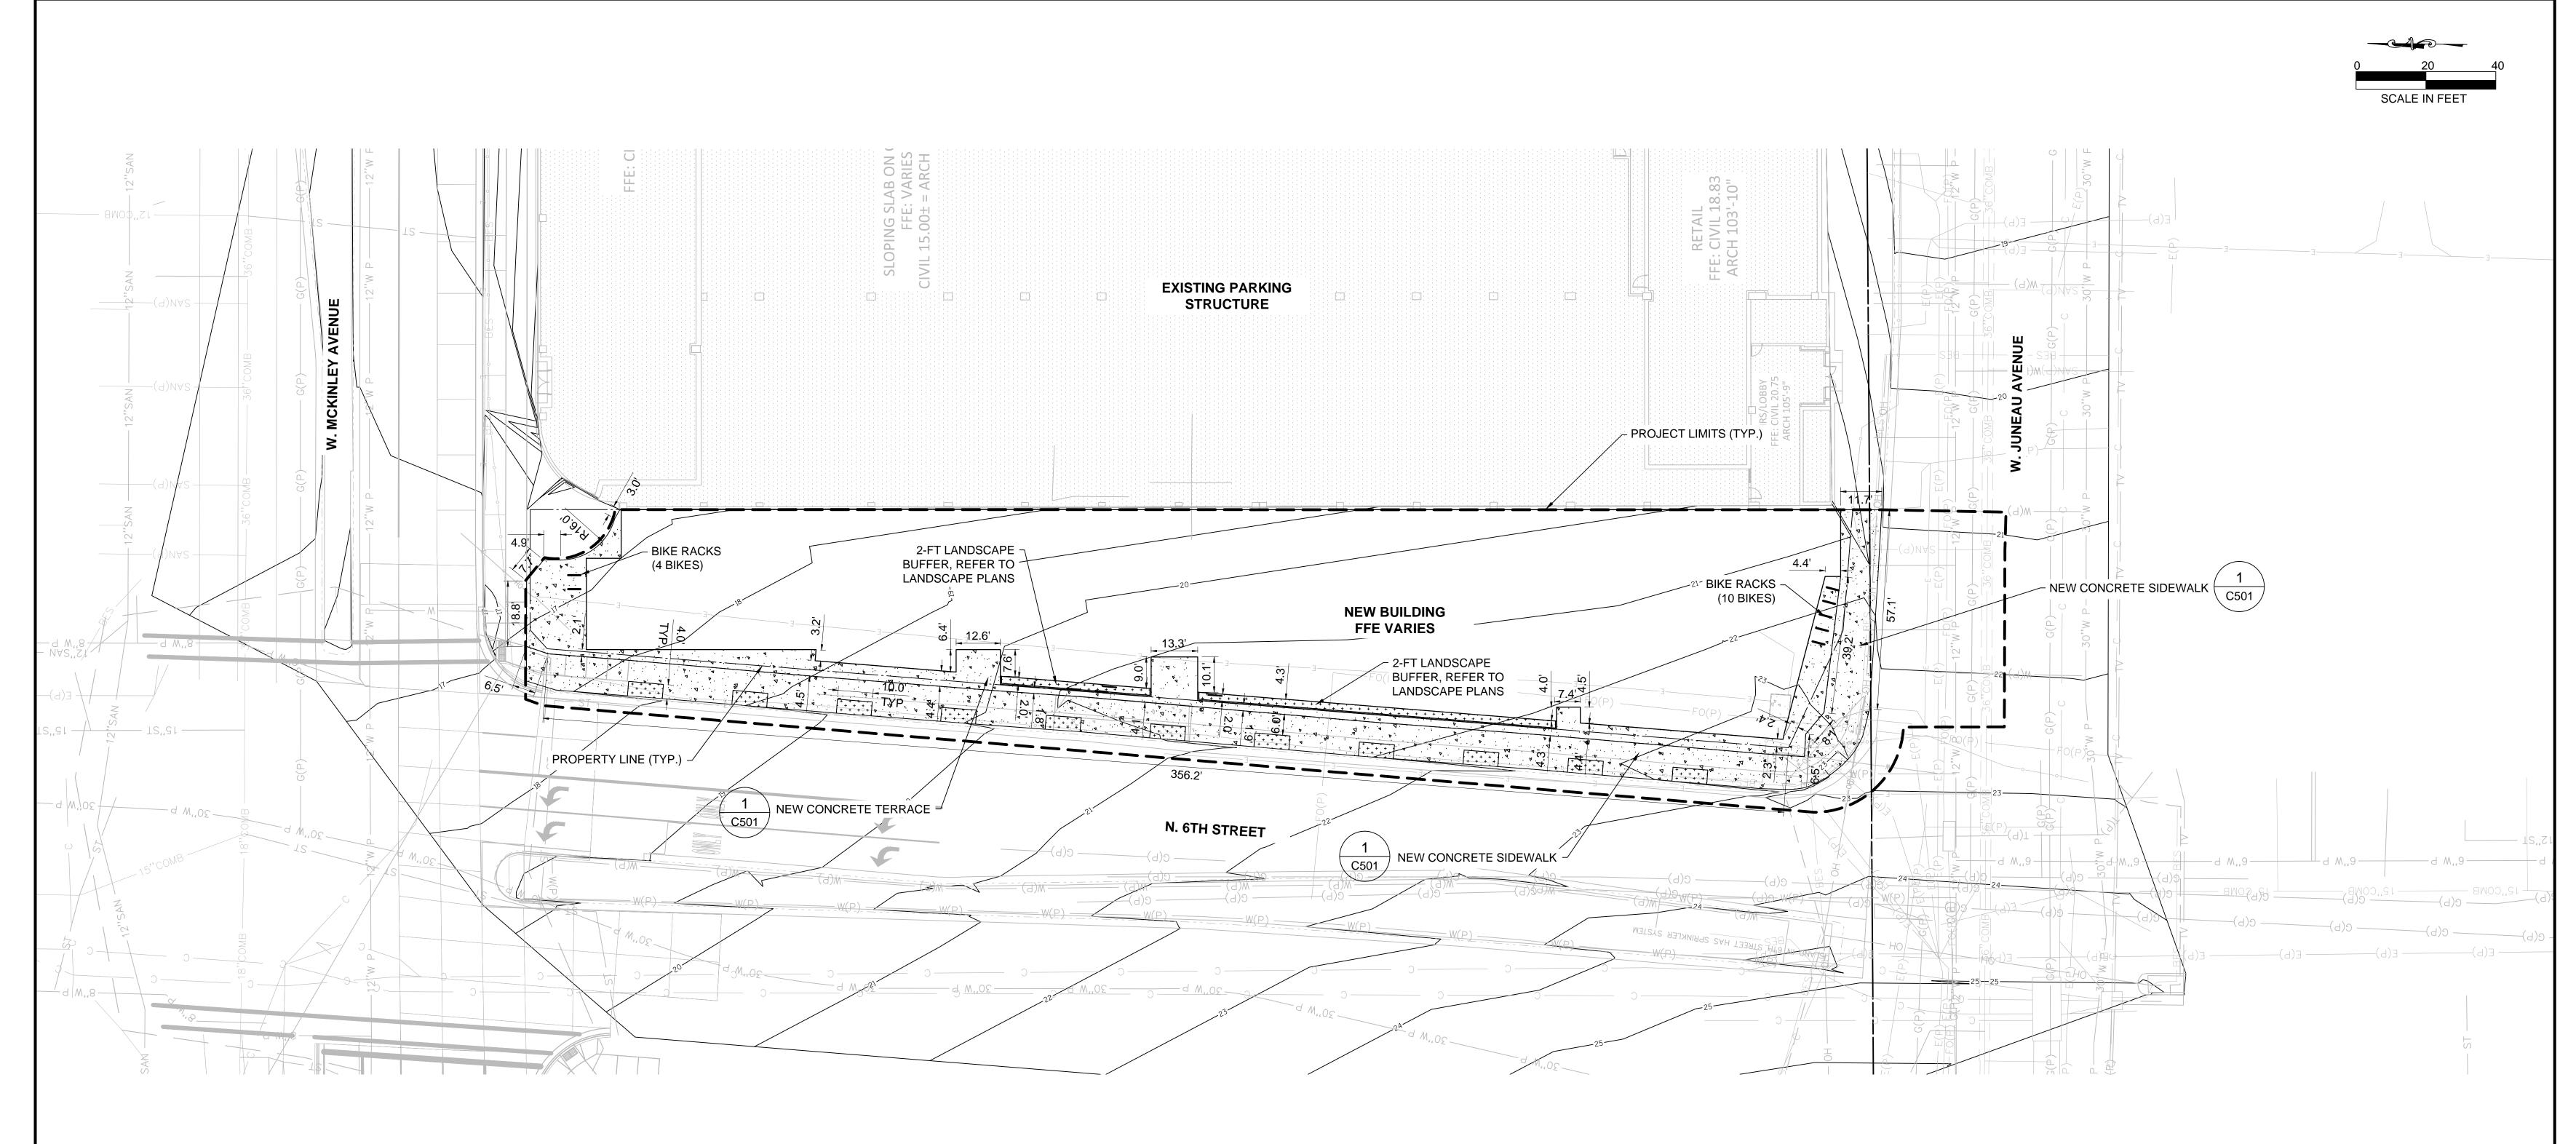
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DRAWN BY MAK CHECKED BY

**EROSION CONTROL PLAN** 



### **GENERAL NOTES:**

- 1. ALL DIMENSIONS AND CURB RADII ARE TO THE FACE OF CURB, EDGE OF PAVEMENT,
- FACE OF BUILDING OR PROJECT WORK LIMIT; UNLESS STATED OTHERWISE.
- 3. CONTRACTOR TO ENSURE THAT ALL EXTERIOR CONCRETE SLABS ARE BROOM FINISHED. 4. REFER TO LANDSCAPE PLANS FOR RESTORATION IN LANDSCAPED AREAS.

### **BUILDING USE & HEIGHT:**

BUILDING AA USE = MIXED USE, 1 STORY COMMERCIAL + 5 STORIES RESIDENTIAL

BUILDING AA HEIGHT = 6 STORIES, 88'-2" ABOVE GRADE AT HIGHEST POINT

### **BUILDING AREA:**

FIRST FLOOR AREA: 17,929 S.F.

### SITE DATA:

TOTAL PROPERTY AREA = 20,213 S.F. = 0.464 ACRES TOTAL DISTURBED AREA (PROJECT LIMITS) = 27,722 S.F. = 0.64 ACRES IMPERVIOUS AREA BEFORE CONSTRUCTION = 26,315 S.F. = 0.60 ACRES IMPERVIOUS AFTER CONSTRUCTION = 25,865 S.F. = 0.59 ACRES IMPERVIOUS DECREASE = 455 S.F. = 0.01 ACRES

### **GREEN SPACE:**

AREA = 27,722 S.F.GREEN SPACE = 1,567 S.F. 7% GREEN SPACE

PARCEL ADDRESS: 550 WEST JUNEAU AVE.

MILWAUKEE, WI 53212

### **ZONING:**

CURRENTLY: PLANNED DEVELOPMENT (PD) PROPOSED: PLANNED DEVELOPMENT (PD)

**LEGEND** 



LANDSCAPED AREA, REFER TO LANDSCAPE

PLANS

# **SURVEY NOTES:**

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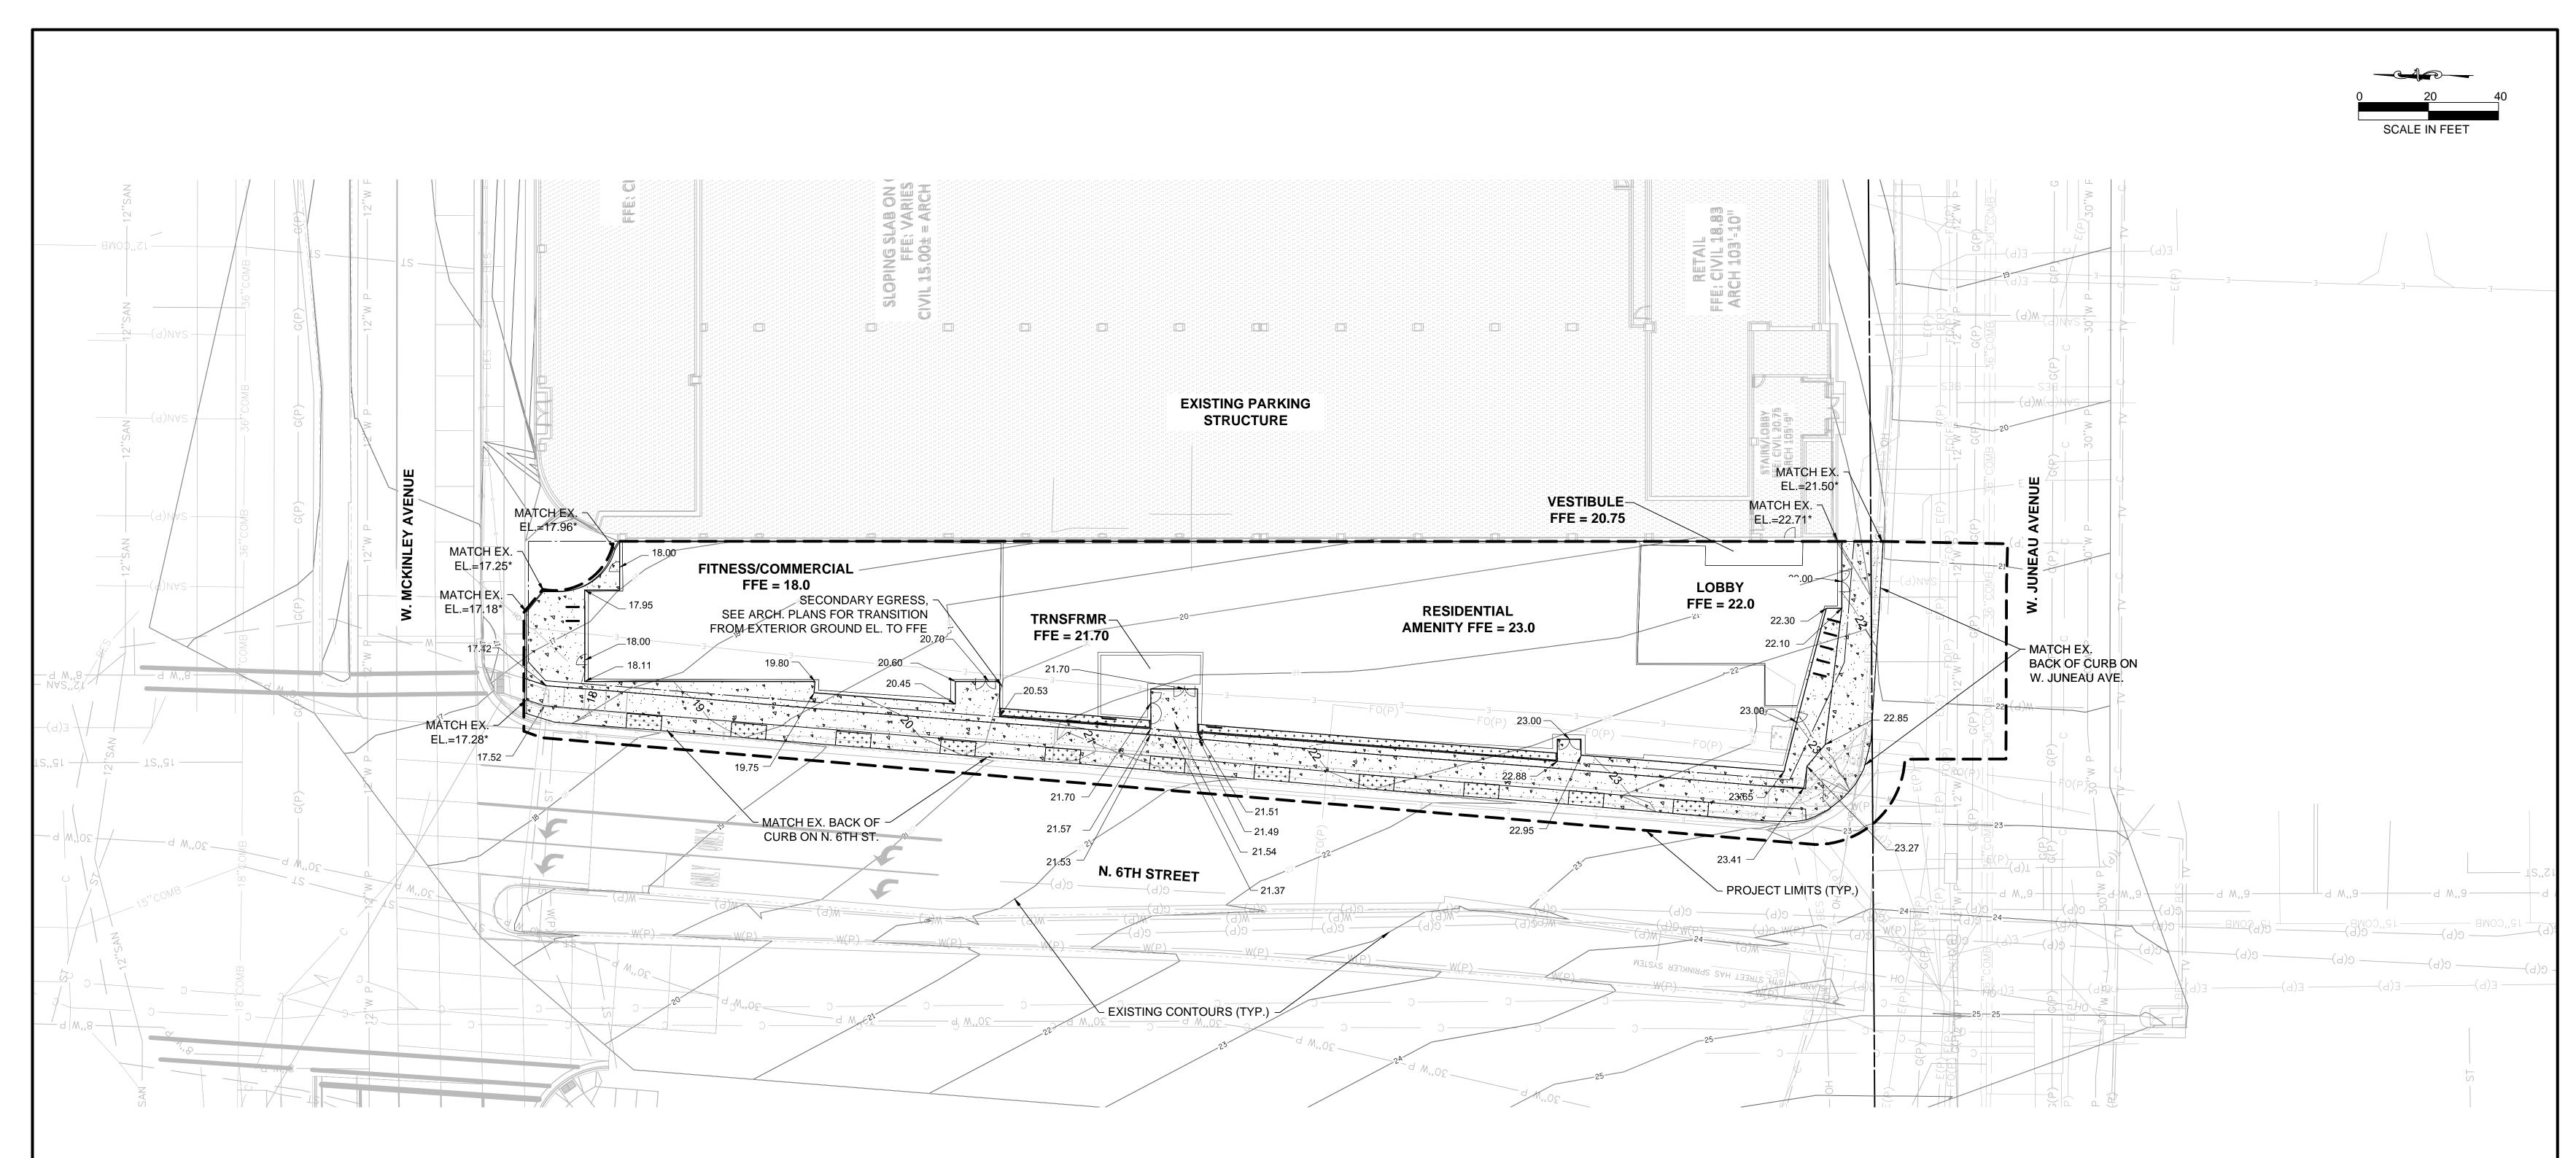
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DRAWN BY CHECKED BY

SITE PLAN



### **GENERAL NOTES:**

- 1. GRADE ALL SURFACES FOR POSITIVE DRAINAGE.
- 2. ALL GRADES SHOWN ARE FINISHED SURFACE OR FLOW LINE GRADES, UNLESS OTHERWISE NOTED.
- 3. ALL UTILITIES WITHIN THE PROJECT LIMITS SHALL BE ADJUSTED TO PROPOSED GRADING BY THE CONTRACTOR, UNLESS A GRADE MATCH IS INDICATED AT A SPECIFIC UTILITY. FINAL ADJUSTMENTS SHALL BE MADE AT THE TIME OF CONCRETE POURING FOR SIDEWALK TO MATCH THE EXISTING SURFACE.
- 4. UTILITY OWNERS SHALL BE CONTACTED PRIOR TO ADJUSTMENTS.
- 5. UTILITY OWNERS SHALL HAVE THE OPTION OF PERFORMING THE WORK THEMSELVES OR HAVING THE CONTRACTOR PERFORM THE WORK.
- 6. THE CONTRACTOR SHALL PAY ALL FEES, PERMITS, AND DEPOSITS FOR THE ADJUSTMENT WORK.
- ALL ADJUSTMENT WORK SHALL BE TO THE SPECIFICATIONS OF THE UTILITY OWNER AND IN ACCORDANCE WITH ANY REQUIRED PERMITS.
- 8. PAVEMENT RESTORATIONS SHALL MEET ADJACENT EXISTING PAVEMENTS AS A FLUSH MATCH.

\* EQUAL TO PROPOSED GRADES FROM ADJACENT PARKING STRUCTURE PROJECT.

LEGEND

75.96

NEW SPOT GRADE

NEW GRADING CONTOUR

100-YEAR FLOW PATH

### **SURVEY NOTES:**

- 1. HORIZONTAL DATUM: WISCONSIN STATE PLANE COORDINATE SYSTEM SOUTH ZONE NAD27.

  NORTH IS REFERENCED TO THE S. LINE OF THE SE \( \frac{1}{4} \) OF SECTION 20-7-22 PUBLISHED BY

  UOY ÜUOÂŒJÁÞÌ Ì »Í Ì ¢Í ÄÖÈ
- 2. VERTICAL DATUM: CITY OF MILWAUKEE DATUM. BENCHMARK IS THE MONUMENT FOR THE S  $\frac{1}{4}$  CORNER OF SECTION 20-T7N-R22E. ELEV = 19.18'.

Engberg Anderson ARCHITECTS

MILWAUKEE | MADISON | TUCSON | CHICAGO



3636 North 124th Street Wauwatosa, WI 53222 262-821-1171

# PARK 7 LOFTS

550 West Juneau Avenue Milwaukee, WI 53212

Royal Capital Group, LLC.

710 N Plankinton Ave, Suite 300 Milwaukee, WI 53203

EA PROJECT NUMBER HUD PROJECT NUMBER 162642.00

075-35472

ISSUED FOR:

DPD MINOR
MODIFICATIONS

REVISION FOR:

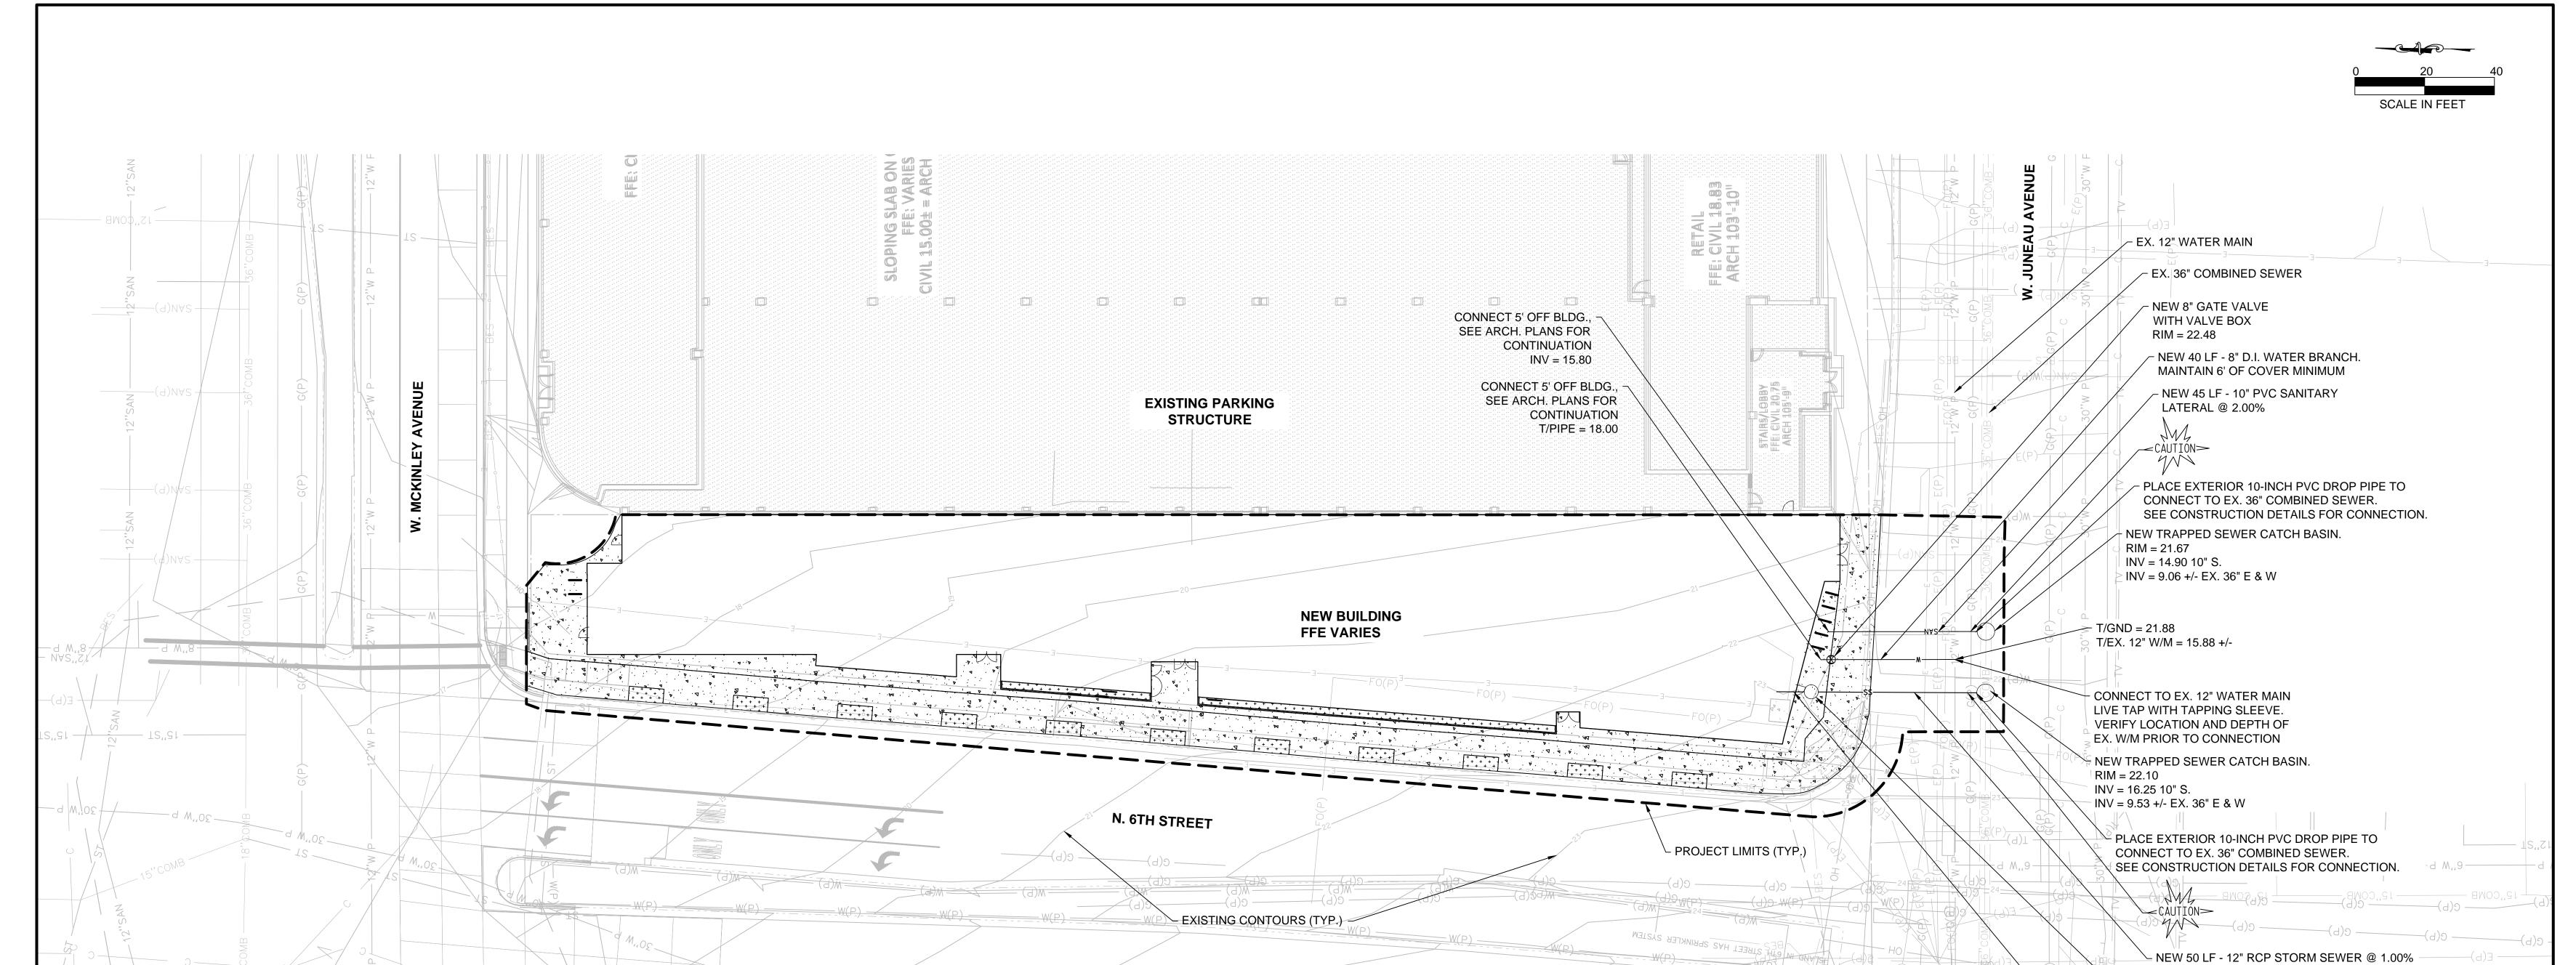
DATE

NO. DESCRIPTION

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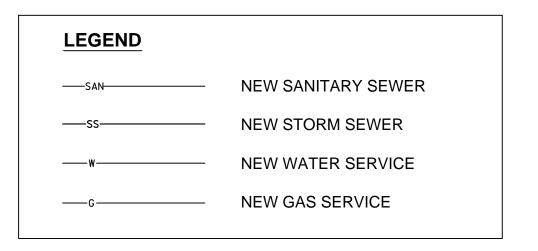
**GRADING PLAN** 



### GENERAL NOTES:

- 1. PIPE LENGTHS ARE TO CENTER OF STRUCTURE, UNLESS OTHERWISE NOTED.
- SEWER INSTALLATION SHALL PROCEED FROM DOWNSTREAM TO UPSTREAM.
- 3. CONTRACTOR SHALL ADJUST ALL EXISTING AND NEW UTILITY CASTINGS, MANHOLES, CLEANOUTS, AND ACCESS BOXES TO PROPOSED GRADING.
- 4. CONNECT SANITARY SERVICE IN ACCORDANCE WITH THE REQUIREMENTS OF CITY OF MILWAUKEE.
- 5. ALL EXISTING LATERALS NOT SHOWN AS REUSED SHALL BE ABANDONED AT THE MAIN PER CITY OF MILWAUKEE STANDARDS.
- 6. MAINTAIN PROPER DRAINAGE AT ALL TIMES DURING CONSTRUCTION.
- SANITARY LATERALS SHALL BE PVC, ASTM D-3034, SDR 35 IN CONFORMANCE WITH SECTION 8.10.0 OF THE STANDARD SPECIFICATIONS FOR SEWER AND WATER CONSTRUCTION IN WISCONSIN, CURRENT EDITION.
- 8. WATER BRANCH SHALL BE ANSI/AWWA C151/A21.51, CL 55, DUCTILE IRON PIPE.
- 9. CONTRACTOR SHALL VERIFY EXISTING PIPE INVERT, PIPE MATERIAL, PIPE SIZE AND LOCATION PRIOR TO CONSTRUCTION OF THE UTILITIES. ANY DISCREPANCIES SHALL BE DISCUSSED WITH THE OWNER.
- 10. SANITARY SEWER AND WATER MAIN SHALL BE CONSTRUCTED PER PROJECT SPECIFICATIONS AND IN ACCORDANCE WITH THE DEPARTMENT OF SAFETY AND PROFESSIONAL SERVICES AND THE CITY OF MILWAUKEE.
- 11. A MINIMUM OF 6.0 FEET OF COVER SHALL BE MAINTAINED OVER ALL WATER MAIN.
- 12. A MINIMUM OF 6.0 FEET OF COVER SHALL BE MAINTAINED OVER ALL SANITARY SEWER.
- 13. PER DSPS 382.40 (8) (b) PRIVATE WATER MAINS AND WATER SERVICES SHALL BE INSTALLED AT LEAST 5 FEET HORIZONTALLY FROM ANY SANITARY SEWER.
- 14. NO PRIVATE WATER MAIN OR WATER SERVICE MAY BE INSTALLED WITHIN 6 INCHES OF A STORM SEWER.

- 15. CLEANOUTS SHALL BE LOCATED NOT MORE THAN 100 FEET APART. THE CLEANOUT NEAR THE BUILDING SHALL BE WITHIN 5 FEET OF WHERE THE BUILDING DRAIN AND BUILDING SEWER CONNECTS. THE CLEANOUT MAY BE LOCATED EITHER INSIDE OR OUTSIDE OF BUILDING.
- 16. GENERALLY, FOR WATER SERVICE 4-INCHES OR LARGER, DEFLECTION WILL NOT BE ALLOWED AND CONTRACTOR SHALL USE 11.25, 22.5, 45 AND 90
   E. DEGREE BENDS WHEN NEEDED. CONTRACTOR SHALL NOT EXCEED 5 DEGREES PER PIPE OR AS RECOMMENDED BY MANUFACTURER.
- 17. PROVIDE TRACER WIRE FOR NON-METALLIC WATER SERVICE. SEE SPECIFICATIONS. TRACER WIRE FOR POTABLE WATER PIPE SHALL BE BLUE.
- 18. SANITARY, WATER AND STORM SEWER SHALL BE IN STALLED AT A MINIMUM DEPTH OF 60" TO AVOID CONFLICT WITH FUTURE CUC PACKAGE.



### **SURVEY NOTES:**

1. HORIZONTAL DATUM: WISCONSIN STATE PLANE COORDINATE SYSTEM SOUTH ZONE NAD27.

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NEW STORM SEWER

SEE ARCH. PLANS FOR CONTINUATION

JUNCTION BOX RIM = 22.85 N. INV =16.75 S. INV =16.65

2. VERTICAL DATUM: CITY OF MILWAUKEE DATUM. BENCHMARK IS THE MONUMENT FOR THE S  $\frac{1}{4}$  CORNER OF SECTION 20-T7N-R22E. ELEV = 19.18'.

Engberg Anderson ARCHITECTS

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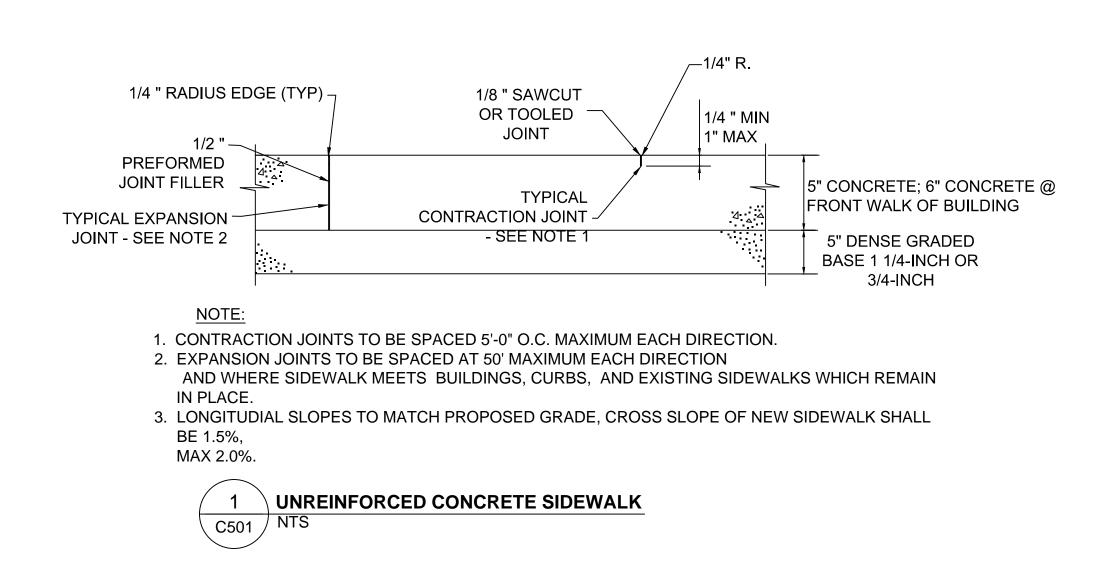
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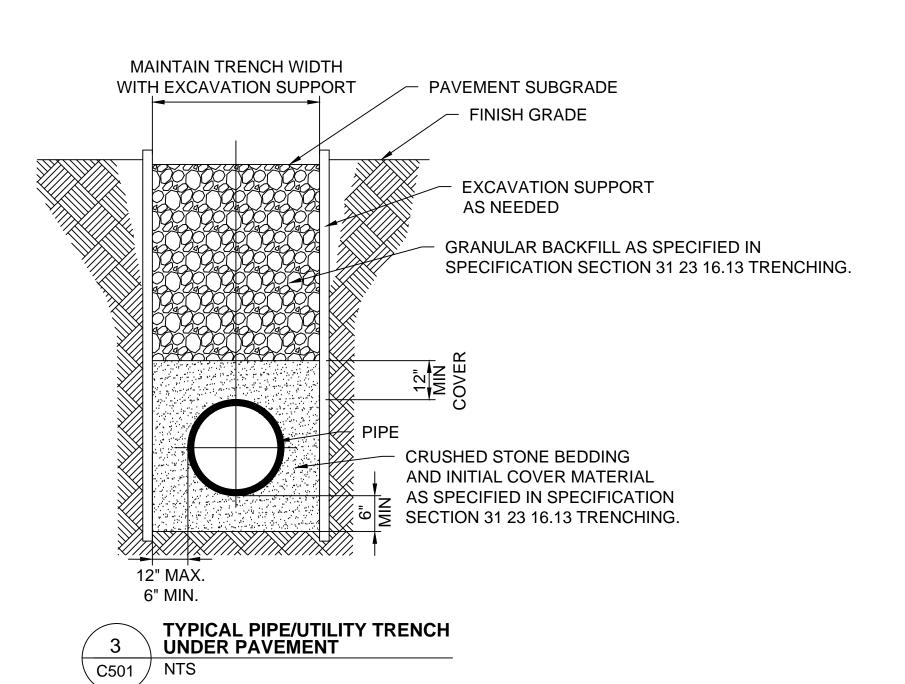
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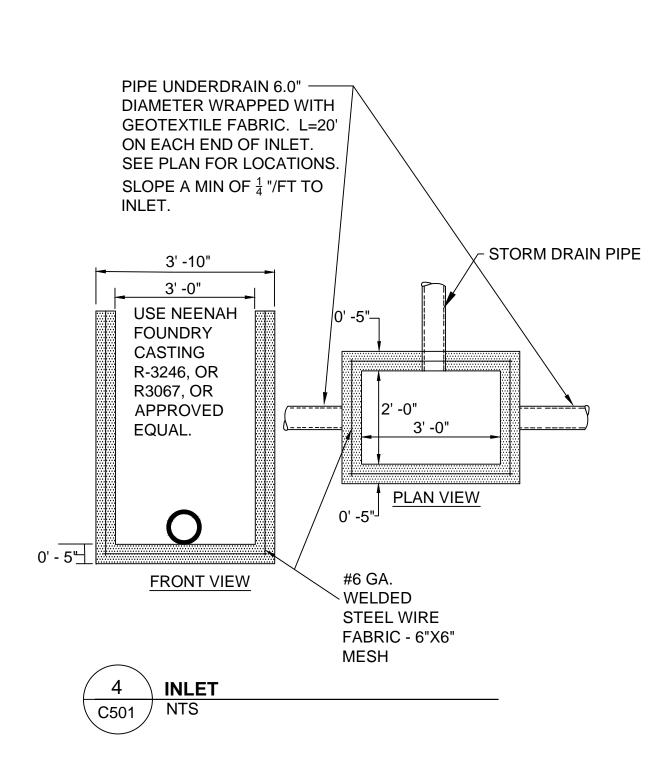
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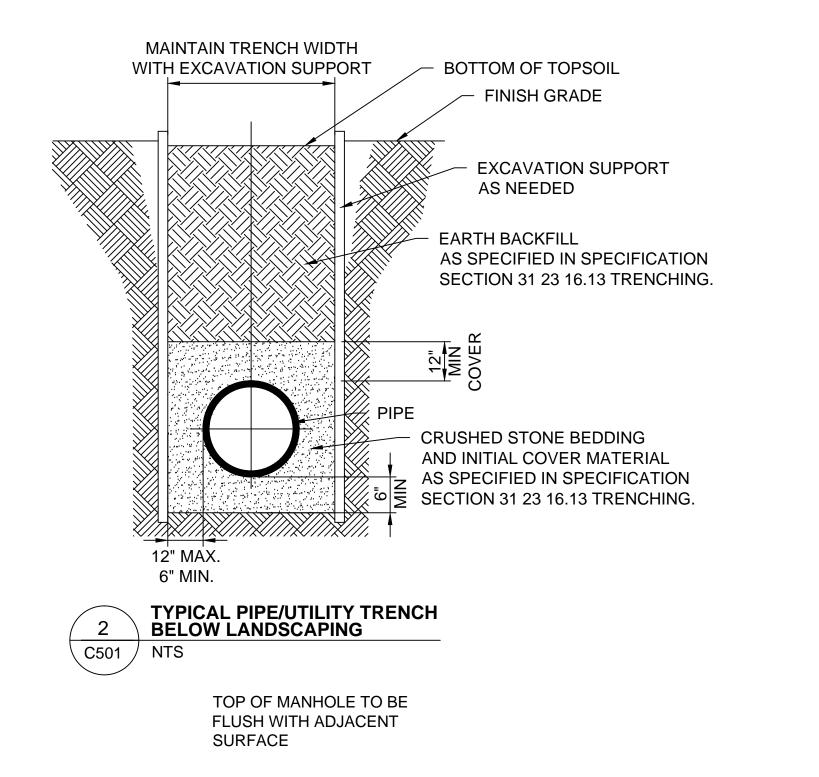
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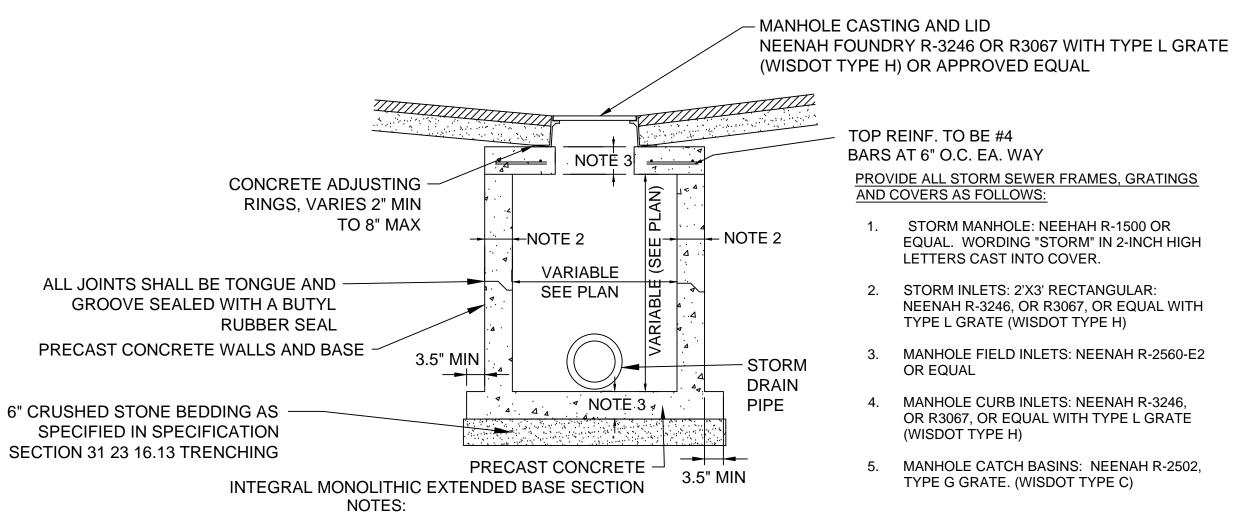
UTILITY PLAN











- ALL MANHOLES SHALL INCLUDE STEPS ON 16" CENTERS WHEN DEPTH (GRATE TO BOTTOM) IS 4.0' OR GREATER.
- 2. MINIMUM WALL THICKNESS SHALL BE 4 INCHES FOR 3-FT, 5 INCHES FOR 4-FT. 6 INCHES FOR 5-FT, 7 INCHES FOR 6-FT, 8 INCHES FOR 7-FT, AND 9 INCHES FOR 8-FT DIAMETER PRECAST MANHOLES.
- 3. PRECAST FLAT SLAB TOPS AND BASES WITH A DIAMETER OF 48" AND LESS SHALL HAVE A MINIMUM THICKNESS OF 6". PRECAST FLAT SLAB AND BASES WITH A DIAMETER LARGER THAN A MINIMUM THICKNESS OF 8"





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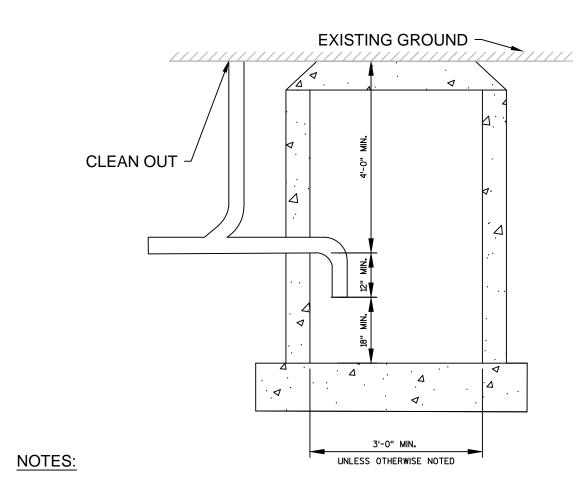
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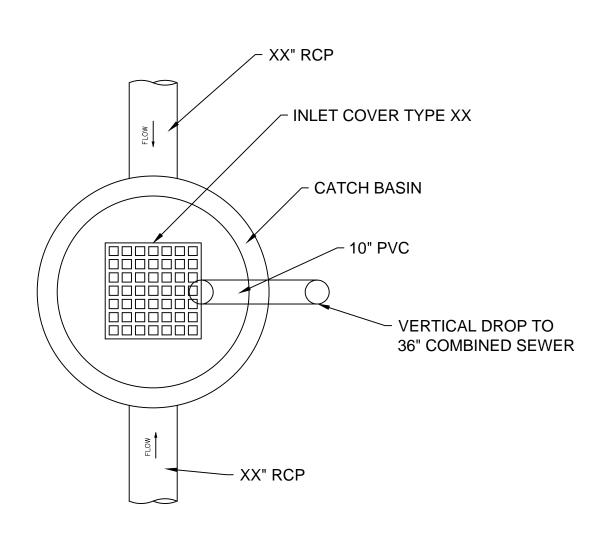
CONSTRUCTION

**DETAILS** 

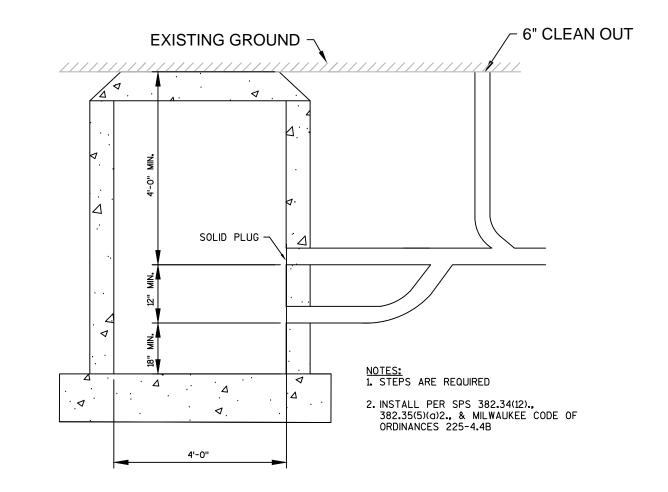
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1. INSTALL PER SPS 382.34(12)., 382.35(5)(a)2., & MILWAUKEE CODE OF ORDINANCES 225-4.4B




TRAPPED CATCH BASIN WITH EXTERIOR DROP CONNECTION (PLAN VIEW)




INSTALL PER SPS 382.34(12)., 382.35(5)(a)2., & MILWAUKEE CODE OF ORDINANCES 225-4.4B

COMBINED CATCH BASIN OR EXTERIOR SAND INTERCEPTOR FOR 12" OR LARGER PIPING.

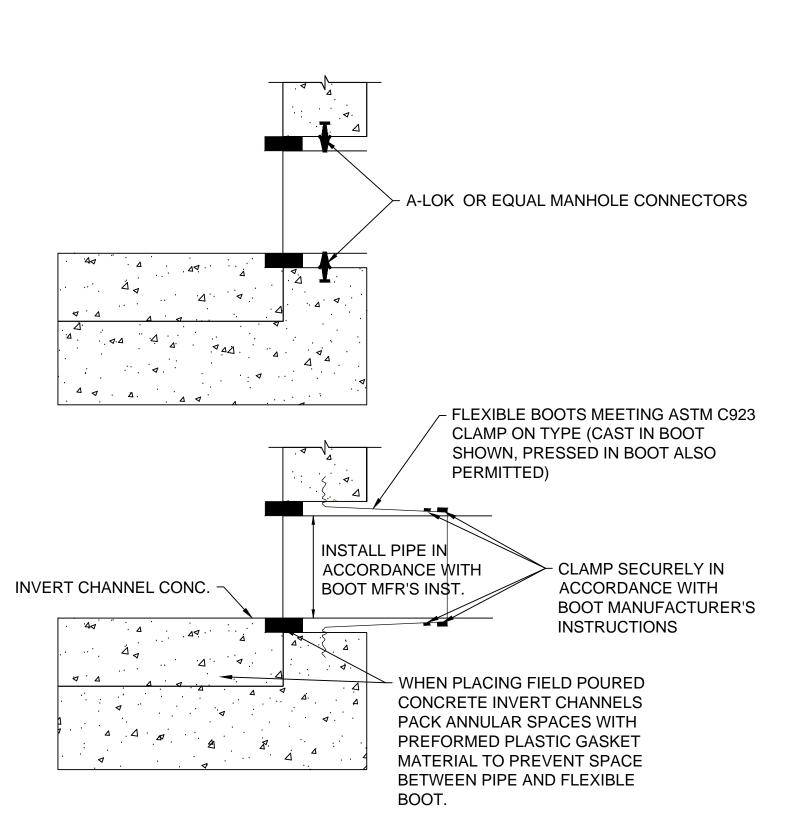1 COMBINED CATCH BASIN OR EXTERIOR SAND INTERCEPTOR
NTS



2 MANHOLE PIPE CONNECTION DETAIL NTS

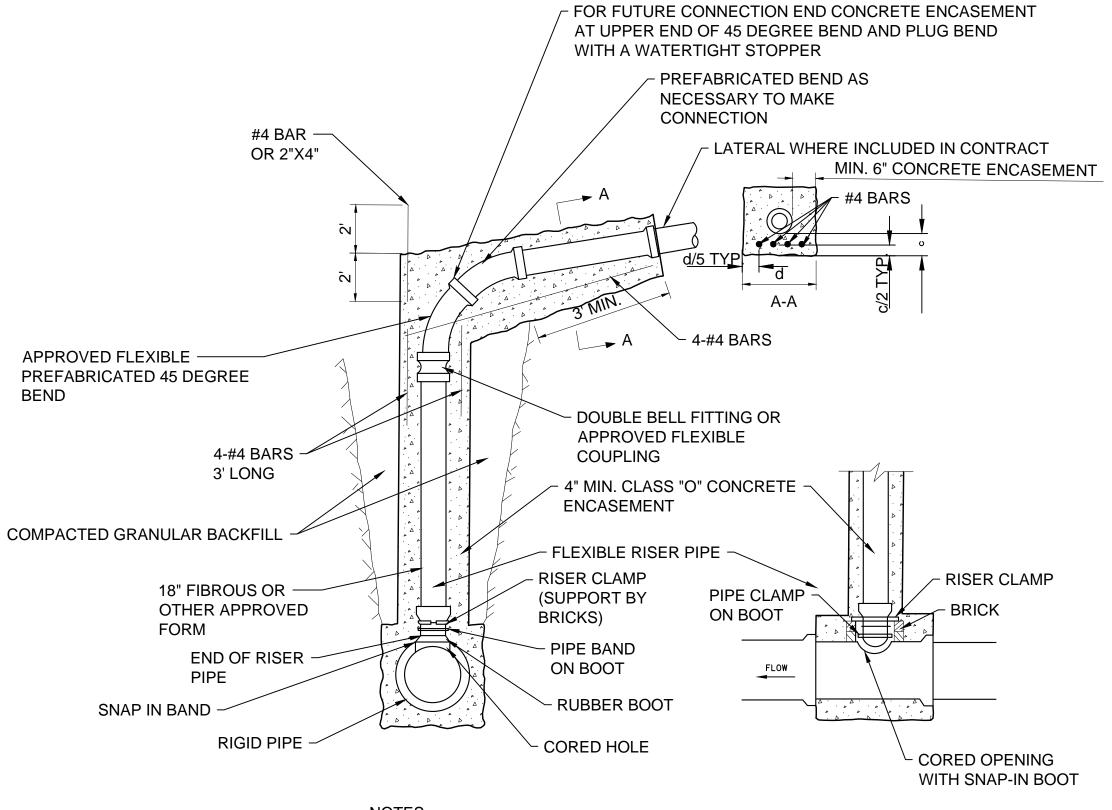


NOTES:

1. RISER CLAMP SUPPORTED ON BRICKS TO
PREVENT THE PUSH THRU OF RISER PIPE WHEN
CONCRETE IS PLACED.

- 2. PLEASE SEE RISER DETAIL "TYPE C" FLEXIBLE RISER TO RIGID MAIN (ALTERNATIVE B) FOR MORE DETAILS.
- 3. CONCRETE ENCASEMENT OF SEWERS 24" OR LARGER NOT REQUIRED.

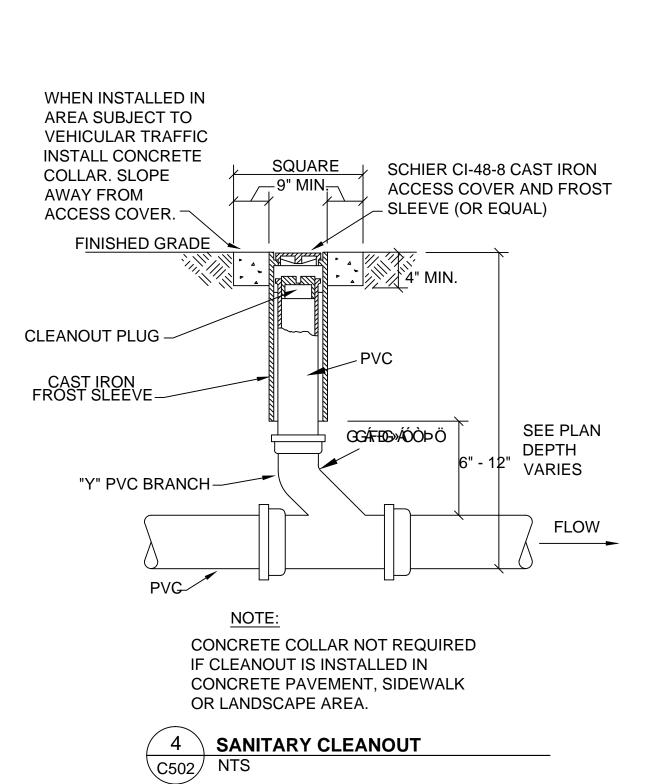3 DROP CONNECTION
C502 NTS



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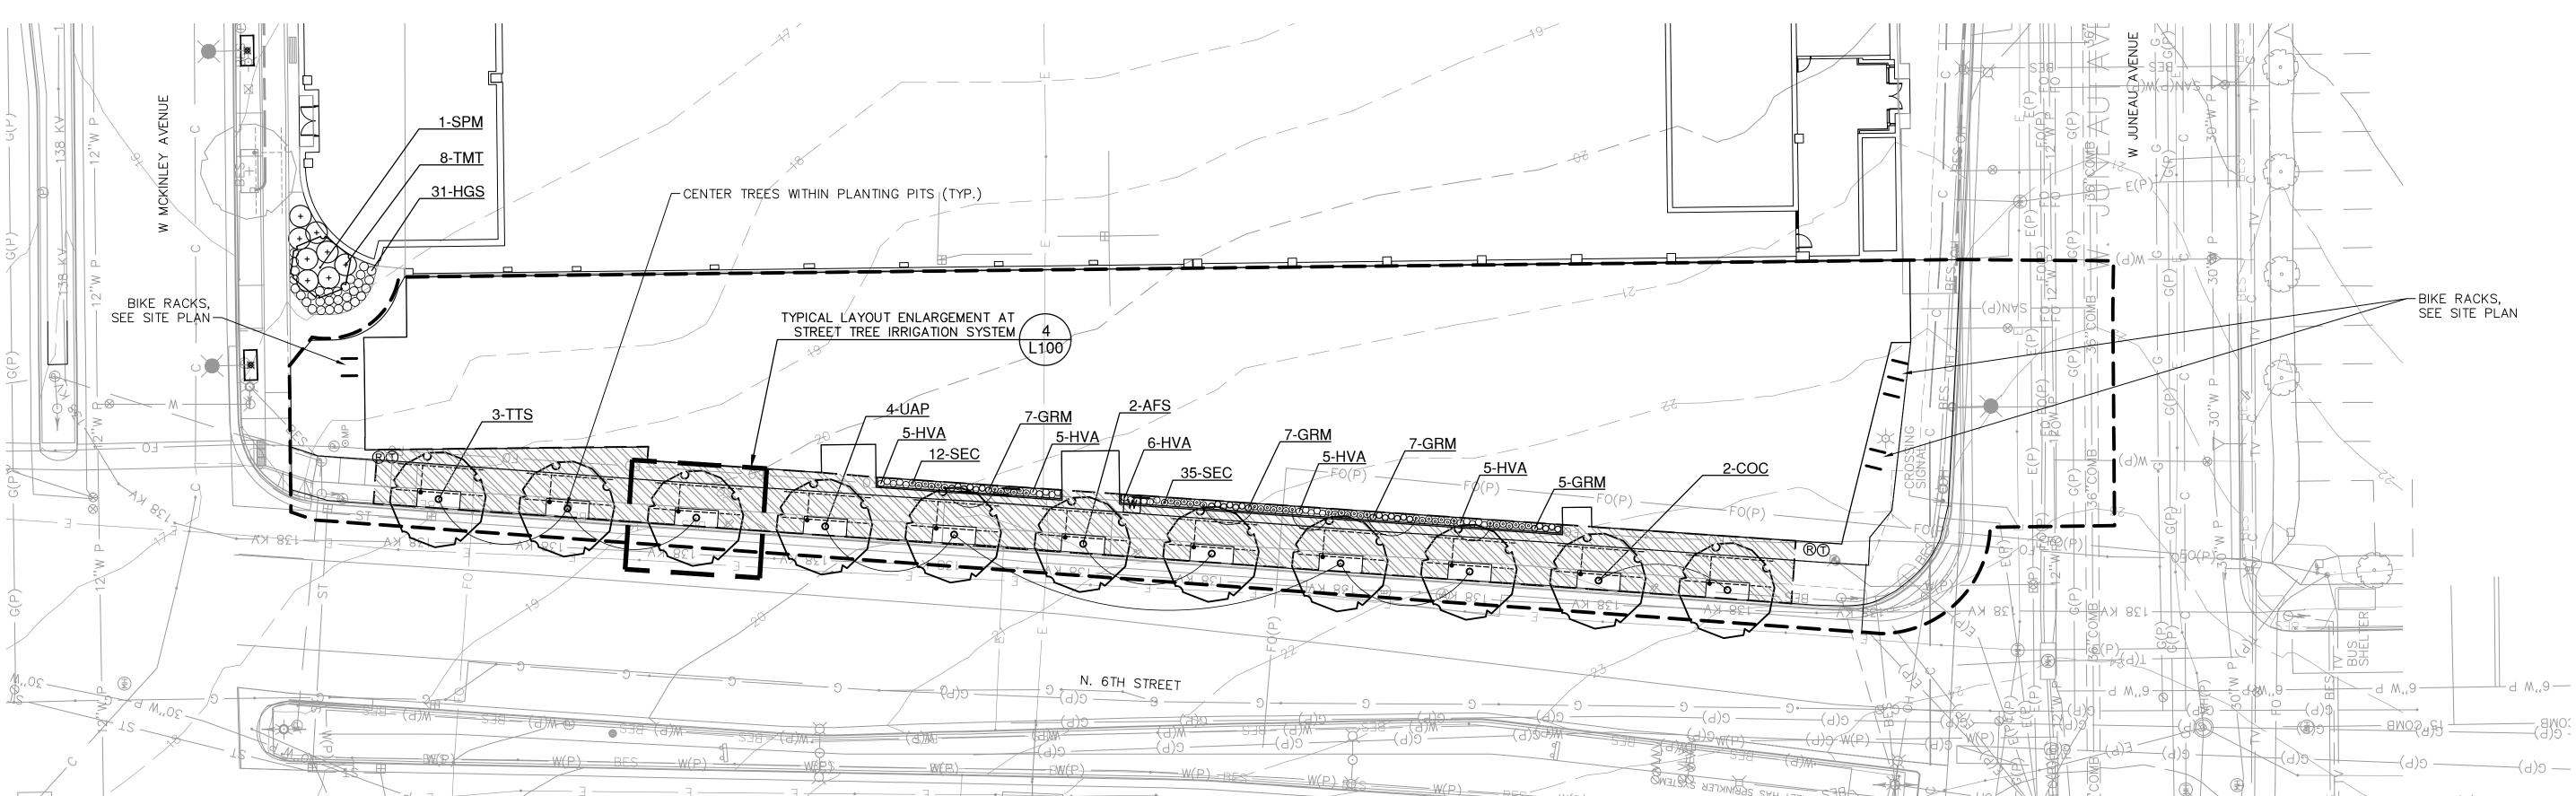
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CONSTRUCTION

**DETAILS** 

MAK

APS



-STREET TREE - SEE LANDSCAPE PLAN

STONE MULCH (TYP.)

SITE PLAN

-3" DIA. SOLID PVC PIPE, LAID FLAT, DRILL 1/4"

– 10" DIA. VALVE BOX (AS MFG. BY RAINBIRD —

-PROVIDE PVC ELBOW TO RECEIVE ALL OUTGOING

PVC PIPING AND VERTICAL PVC STAND PIPE

-CROWN/ROOT FLARE AT F.G. HOLD BACK

-3" TH. DECORATIVE STONE MULCH - SEE

-CONCRETE CURB AND GUTTER - SEE

PROVIDE SOIL MOISTURE SENSORS AT 12", 18", AND 24"

DEPTHS. LOCATE AT MID-POINT BETWEEN TREES (TYP.).

WIRES TO TERMINATE INSIDE VALVE BOX WITH MIN. 18" L WIRE LENGTH FOR CONNECTION TO MOISTURE METER.

BACKFILL FOR STREET TREES TO FILL ENTIRE 4'X10' TREE PLANTER AS SHOWN. DEPTH TO MATCH SIZE OF ROOT BALL. - SEE SPECIFICATIONS FOR MORE INFORMATION.

→ 3" BARK MULCH

→ PERENNIAL OR ORNAMENTAL GRASS

DEPTH AND COMPOSITION AS

→ AMENDED TOPSOIL TO 24"

SPECIFIED.

TO BE WATERMARK MODEL# 200SS AS MFG. BY THE IRROMETER COMPANY, INC. PROVIDE WEATHERPROOF LABELS ON EACH WIRE INDICATING SENSOR DEPTH.

-- PROVIDE NATURAL JUTE BURLAP SEPARATION ALONG

ALL EDGES BETWEEN STRUCTURAL SOIL AND

BACKFILL FOR STREET TREES (TYP.)

- STRUCTURAL SOILS BENEATH SIDEWALK -SEE SPECIFICATIONS. CONTRACTOR SHALL COORDINATE INSTALLATION OF STRUCTURAL

SOILS AND SIDEWALK PAVING

MATERIALS SCHEDULE

SPECIFICATIONS

PERENNIAL / ORNAMENTAL GRASS BED.

-PLANT SIZES SPECIFIED ARE MINIMUM ACCEPTABLE

— COMPACTED SUBGRADE

SECTION 32 90 00 PLANTING

DECORATIVE STONE MULCH AS SHOWN (TYP.)

MODEL# PVB10RND) SET FLUSH WITH TOP OF

DIA. HOLES ALONG BOTTOM OF PIPING AT 12" O.C.



LEGEND

LIMIT OF LANDSCAPE CONSTRUCTION

STREET TREE IN 4'X10' AT-GRADE /

PLANTER WITH DECORATIVE

STRUCTURAL SOIL BENEATH /

INTENT IS FOR CITY STAFF TO USE

FOR PROVIDING SUPPLEMENTAL IRRIGATION TO STREET TREES.

SIDEWALK - SEE WRITTEN

WATER SPIGOT, SEE MEP.

LAYOUT AND MATERIALS NOTES:

UNLESS OTHERWISE INDICATED, DIMENSIONS PROVIDED ARE TO CENTER POINTS OF SITE ELEMENTS AND OUTSIDE FACE

WHERE FURNITURE IS LOCATED ADJACENT TO BUILDING, PROVIDE 4" GAP BETWEEN FURNITURE ITEM AND EXTERIOR

5. DIMENSIONS FOR TRASH & RECYCLING RECEPTACLES SHOW DISTANCE TO CENTER POINT BETWEEN BOTH FIXTURES. REFER TO WRITTEN SPECIFICATIONS FOR MORE SPECIFIC

4. PROVIDE 4" GAP BETWEEN TRASH & RECYCLING

STREET TREES ARE TO BE LOCATED A MINIMUM OF 20' FROM ROADWAY LIGHT POLES AND TRAFFIC SIGNALS (TO MEET CITY

**SPECIFICATIONS** 

SITE FURNISHINGS KEY:

(R) RECYCLING RECEPTACLE

T TRASH RECEPTACLE

OF BUILDING.

FACADE.

REQUIREMENTS).

RECEPTACLES.

STONE MULCH AND PVC **IRRIGATION SYSTEM** 



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710 N Plankinton Ave, Suite 300

Milwaukee, WI 53203

EA PROJECT NUMBER 162642.00 075-35472 HUD PROJECT NUMBER

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DPD MINOR MODIFICATION	10/16/17
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REVISION FOR: NO. DESCRIPTION

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LANDSCAPE PLAN

				— 3" DIA. SOLID PVC PIPE. DRILL 1/4" DIA. HOLES ALONG BOTTOM OF PIPING AT 12" O.C.
	2	2'		
<del>-</del>	6'-8 7/8"	15'-3 1/8"		
4" CLEAR BETW. EDGE OF TREE PLANTER AND VALVE BOX (TYP.)				— 10" VALVE BOX, SEE DETAIL C1 FOR SPECIFIED MODEL. LOCATE CENTER AT 9" FROM EDGES OF PAVEMENT IN CORNERS OF TREE PLANTERS SHOWN ON LANDSCAPE PLAN.
6, (TYP.)	4" 9"			— CAP ALL ENDS OF PVC PIPE RUNS (TYP.)
	50	+	4	— ELECTRICAL RECEPTACLE — SEE ELECTRICAL. LOCATE IN CORNER OF TREE PLANTER, ON SIDEWALK SIDE, AND OPPOSITE THE 10" VALVE BOX. COORDINATE EXACT LOCATION OF RECEPTACLE AND CONDUIT TO AVOID PVC IRRIGATION PIPING AND TREE ROOT BALL (TYP.)
ELECTRICAL CONDUIT, SEE				— STREET TREE PLANTING PIT WITH DECORATIVE STONE MULCH (TYP.)
ELECTRICAL — COORDINATE INSTALLATION WITH ALL ADJACENT CONSTRUCTION AS NECESSARY TO AVOID CONFLICTS (TYP.)				— ADJACENT STREET CURB (TYP.)

NOTES:
1. PROVIDE ONE COMPLETE PVC IRRIGATION SYSTEM, AS SHOWN, FOR EACH STREET TREE (TYP).
2. PROVIDE DETAILED SHOP DRAWINGS OF PVC IRRIGATION SYSTEM AS INDICATED IN SECTION 12 93
00 SITE FURNISHINGS.
3. ALL DIMENSIONS SHOWN ARE TYPICAL CONDITION.
4. MAXIMUM TOTAL PVC PIPE LENGTH AT EACH TREE IS 50'.

TYPICAL LAYOUT ENLARGEMENT PLAN - STREET TREE IRRIGATION SYSTEM REFER TO LANDSCAPE PLAN FOR LOCATIONS AND EXTENTS OF STRUCTURAL SOILS

# CALL BEFORE YOU DIG STATE LAW REQUIRES YOU TO NOTIFY OWNERS AND OPERATORS OF UNDERGROUND FACILITIES AT LEAST 3 FULL WORKING DAYS BEFORE YOU DIG 1-800-242-8511

**VARIES** 

INSTALLATION OF MOISTURE SENSORS DURING BACKFILLING OF STRUCTURAL SOILS MUST BE

OVERSEEN BY CITY OF MILWAUKEE FORESTRY

REPRESENTATIVE. CONTACT DAVID SIVYER A MIN. OF 5 BUSINESS DAYS PRIOR TO

DIA. SOLID PVC (TYP.)

CONCRETE PAVING HOLD STONE -

RUNS (TYP)

- SEE SITE CIVIL MULCH DOWN

CAP ALL ENDS OF PVC PIPE

FINISHED GRADE

FLUSH-MOUNTED

SEE ELECTRICAL

ELEC. RECEPTACLE,

AREA (TYP)

REFER TO LANDSCAPE PLAN FOR LOCATIONS AND EXTENTS OF STRUCTURAL SOILS

PROVIDE CONTINUOUS LAYER OF GEOTEXTILE FILTER FABRIC

BENEATH ENTIRE PVC PIPING

CONDUIT FOR

VERTICAL STAND PIPE, 3"

INSTALLATION AT (414) 286-3729.

--- BUILDING FACADE

In accordance with Wisconsin statute 182.0175, damage to transmission facilities, excavator shall be solely responsible to provide advance notice to the designated "ONE CALL SYSTEM" not less than three working days prior to commencement of any excavation required to perform work contained on this drawing, and further, excavator shall comply with all other requirements of this statute relative to excavator's work.

DISCLAIMER: The underground utilities shown have been located from field survey information and existing drawings. The surveyor makes no guarantees that the underground utilities shown comprise all such utilities in the area, either in service or abandoned. The surveyor further does not warrant that the underground utilities shown are in the exact location indicated although he does certify that they are located as accurately as possible from information available. The surveyor has not physically located the

underground utilities.

-EXCAVATE PLANTING PIT TWICE THE DIAMETER OF BALL & DEPTH AS INDICATED ON DETAIL -LOOSEN SUBSOIL W/PICK TO ENSURE POROSITY

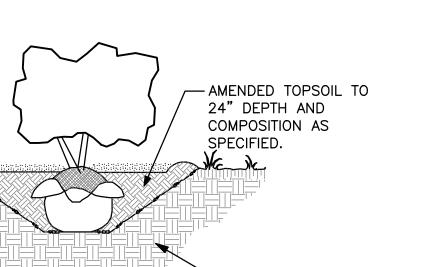
TYPICAL SECTION - STREET TREE IN AT-GRADE PLANTER

-PLACE PLANTING SOIL IN PLANTING PIT & FOOT TAMP -SELECT BEST VIEWING ANGLE, LIFT STOCK BY BALL & PLACE IN PLANTING PIT

-UNWRAP TOP HALF OF ROOT BALL -BACKFILL TO FINISHED GRADE WITH AMENDED TOPSOIL & TAMP -FORM 3" SAUCER TO ENCIRCLE STOCK & FILL WITH 3" SHREDDED

BARK MULCH -WATER IMMEDIATELY & FREQUENTLY. -PLANT SIZES SPECIFIED ARE MINIMUM ACCEPTABLE

SHRUB PLANTING DETAIL



UNDISTURBED

PERENNIAL / ORNAMENTAL GRASS PLANTING DETAIL

-FLOOD IMMEDIATELY & WATER FREQUENTLY PER WRITTEN

-LAYOUT PLANT MATERIAL AT SPACING AS SHOWN PER PLANT

-HAND BROADCAST UNIFORM 3" HARDWOOD MULCH THROUGHOUT

L100

1" = 5' - 0"



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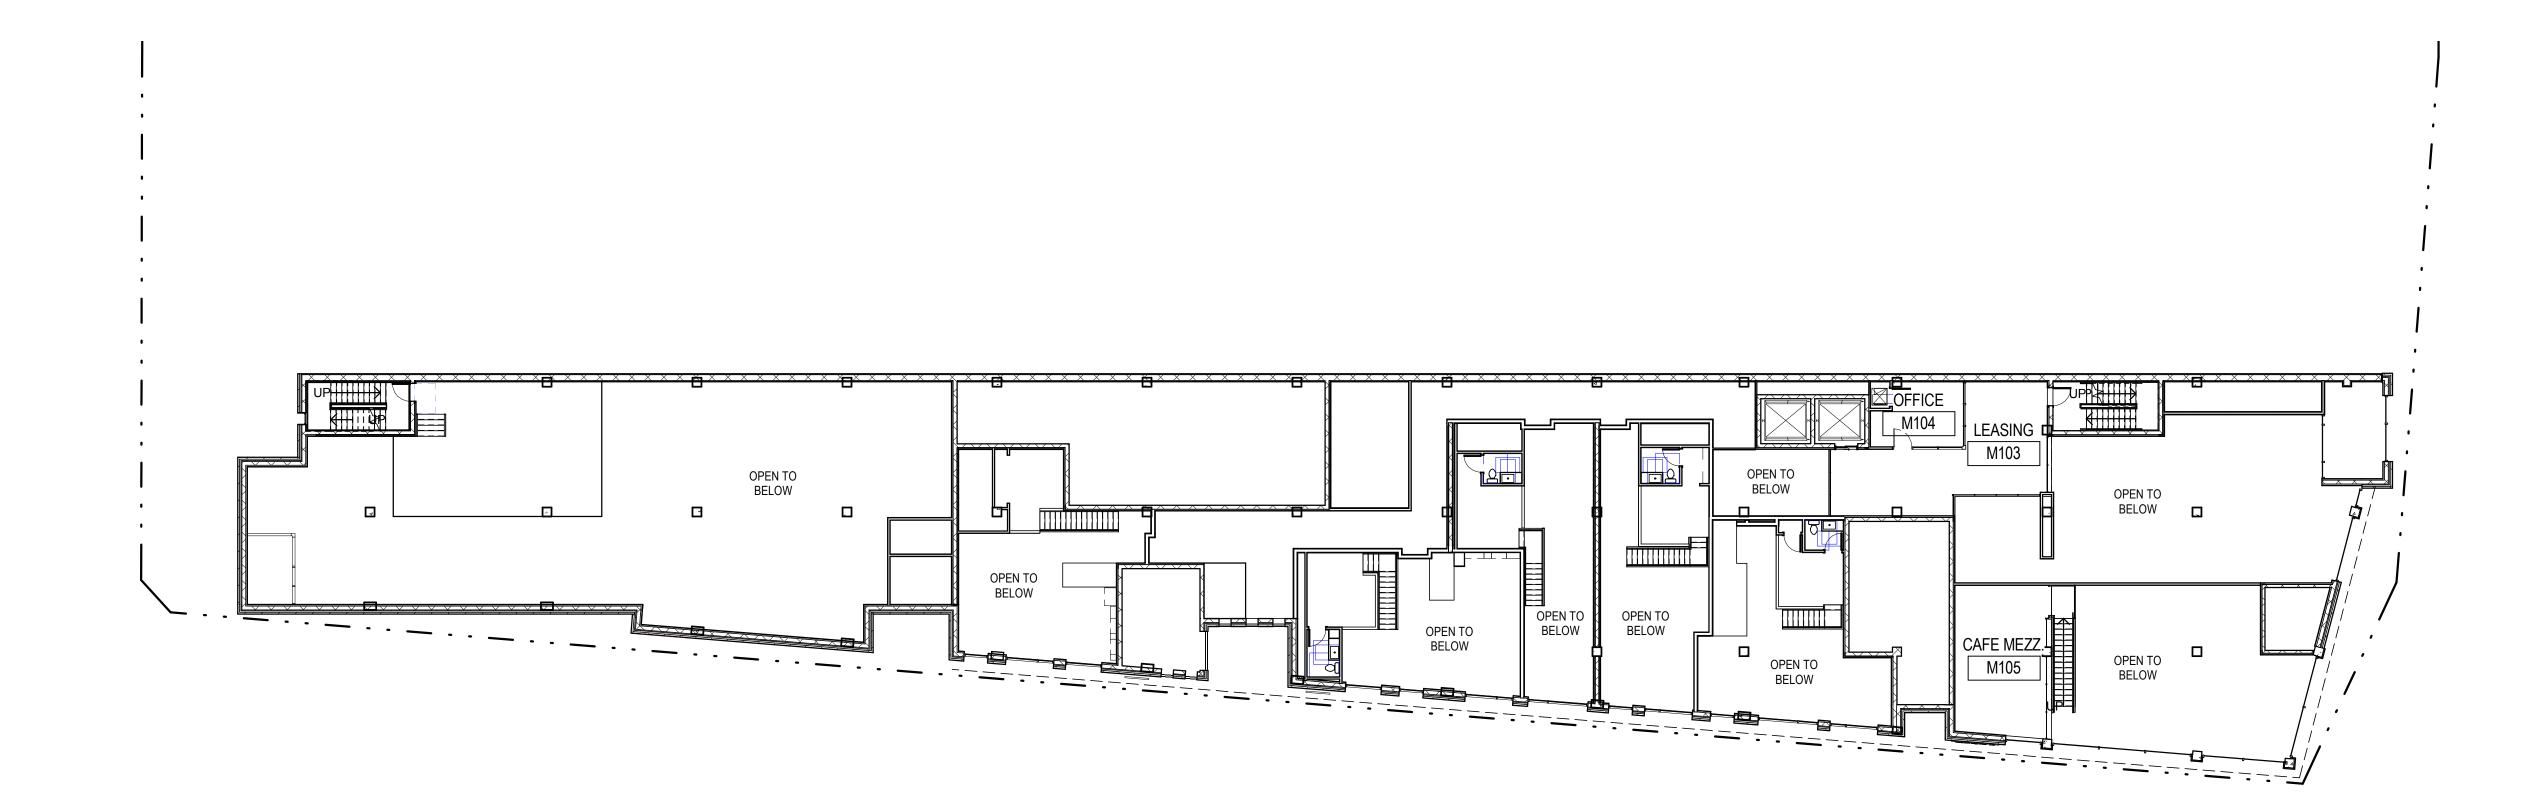
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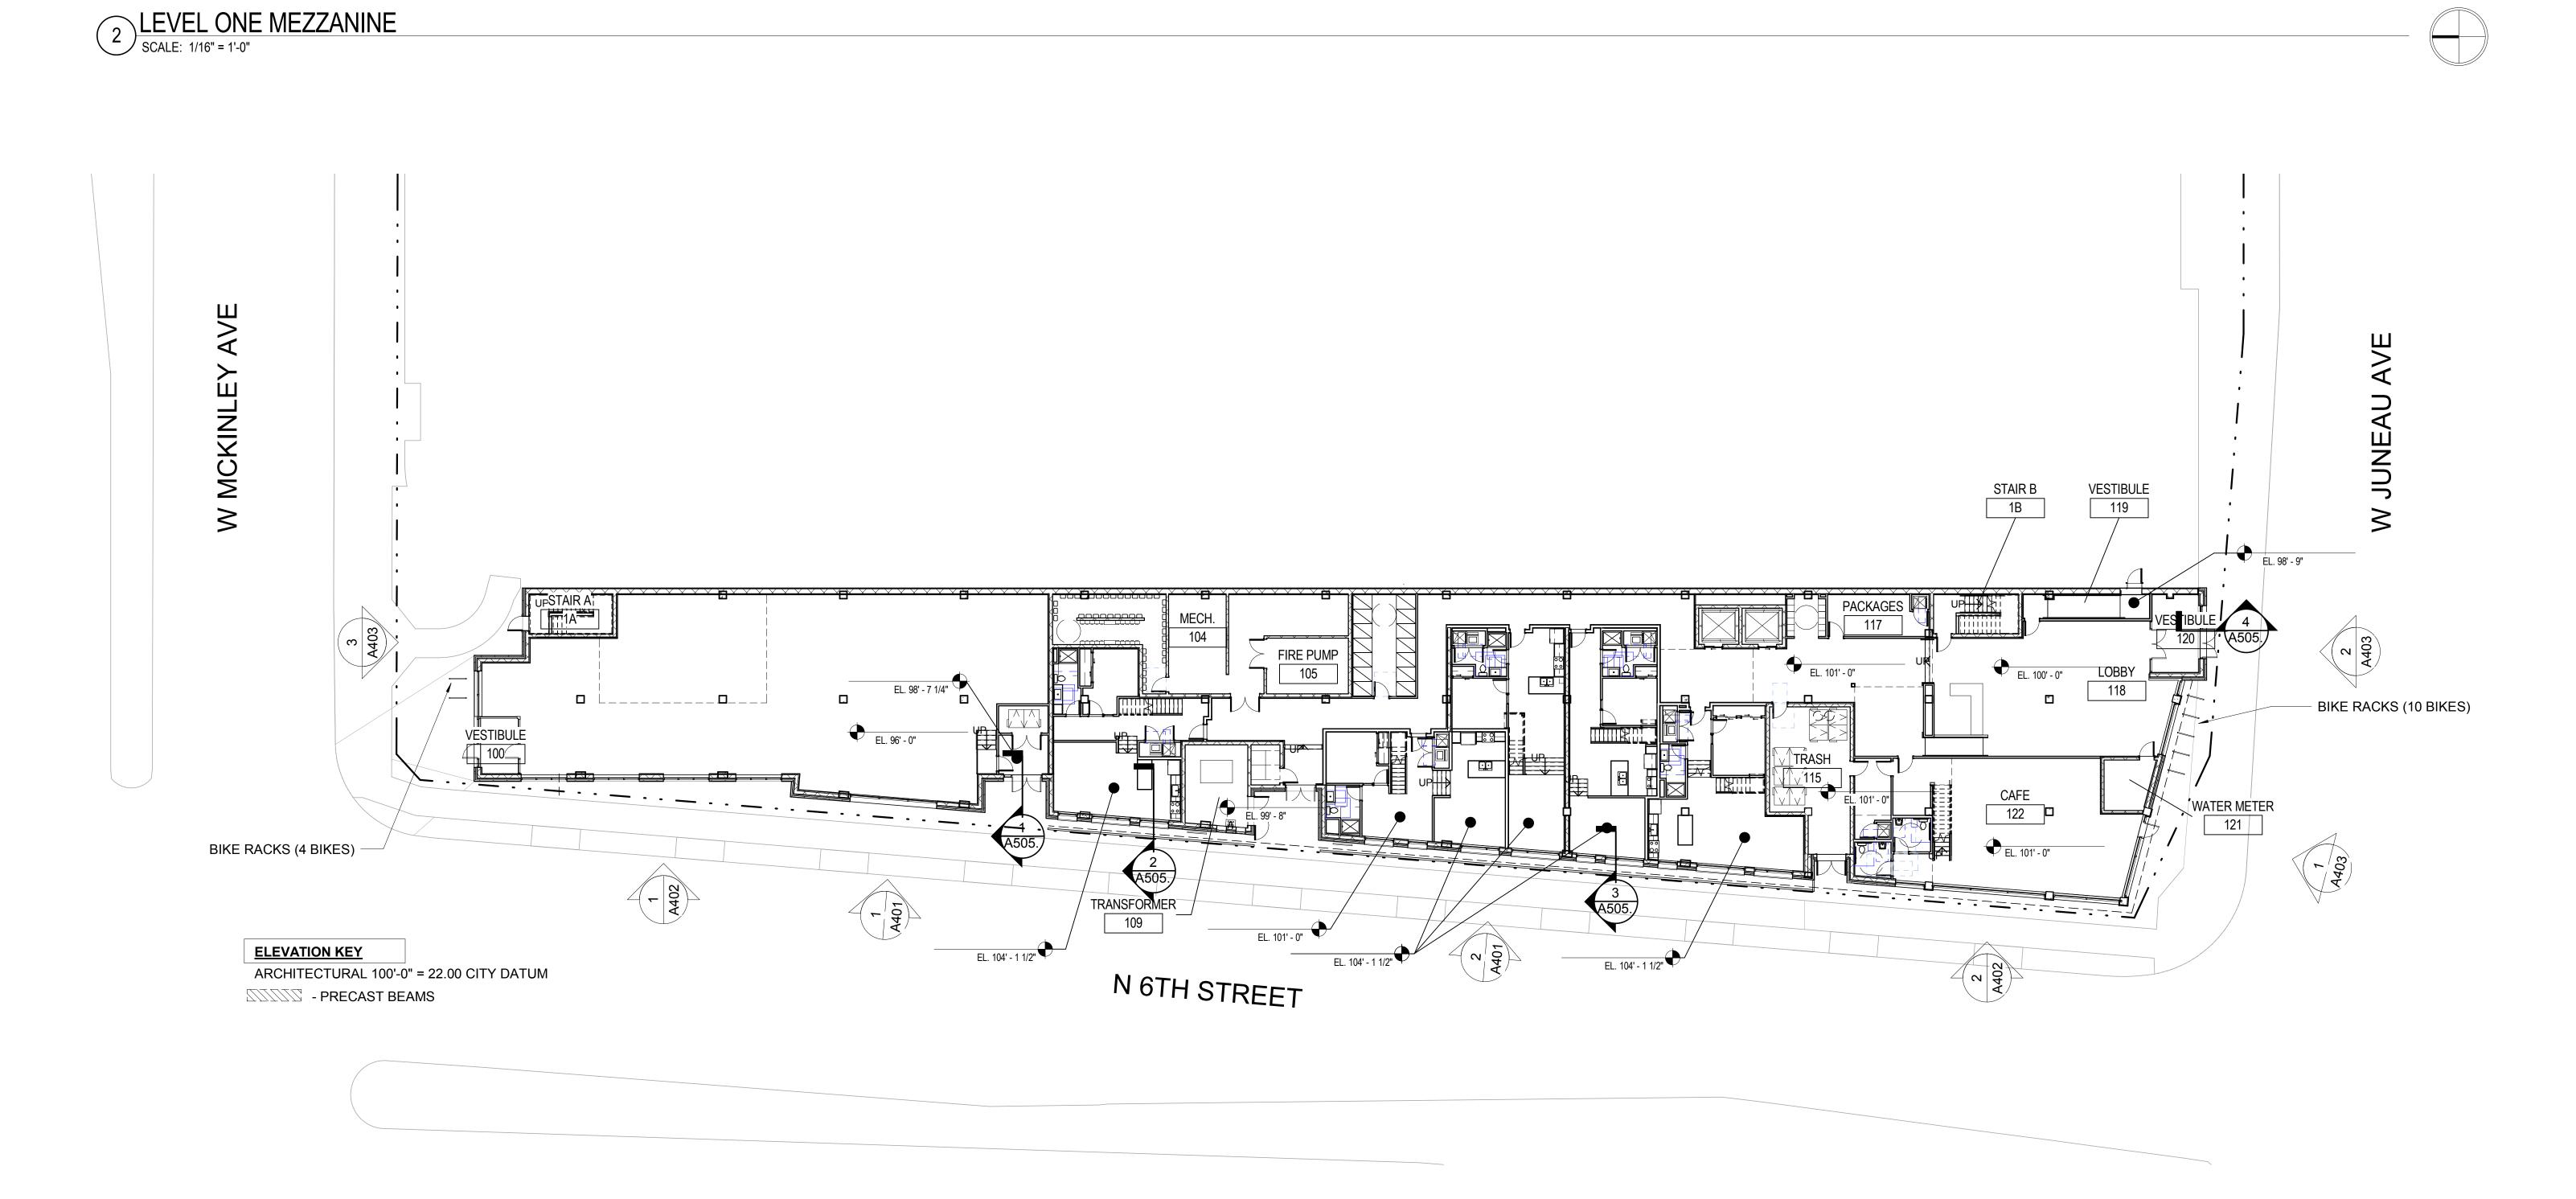
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Author

LEVEL ONE & MEZZANINE PLANS







FLAT PANEL CEMENT

SEE ENLARGED DRAWINGS FOR NOTES AND DIMENSIONS



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PLAN REVIEW	11/08/17
	_
REVISION FOR:	DATE


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NO. DESCRIPTION

EXTERIOR FINISHES LEGEND		
DESIGNATION	PRODUCT	COLOR
CB1	JAMES HARDIE FIBER CEMENT BOARD PANEL	ARCTIC WHITE (OR SIM.)
CB2	JAMES HARDIE FIBER CEMENT BOARD PANEL	IRON GRAY (OR SIM.)
CB3	JAMES HARDIE FIBER CEMENT BOARD PANEL	MATCH SW 6922 OUTRAGEOUS GREEN (OR SIM.)
M1	8" X 24" LARGE FORMAT MASONRY	PRAIRIE STONE ALABASTER GROUNDFACE (OR SIM.)
M2	4" X 12" UNIT MASONRY	ENDICOTT IRONSPOT VELOUR
MP1	PREFINISHED METAL PANEL	COLOR TO MATCH CB2

DRAWN BY Author CHECKED BY Checker

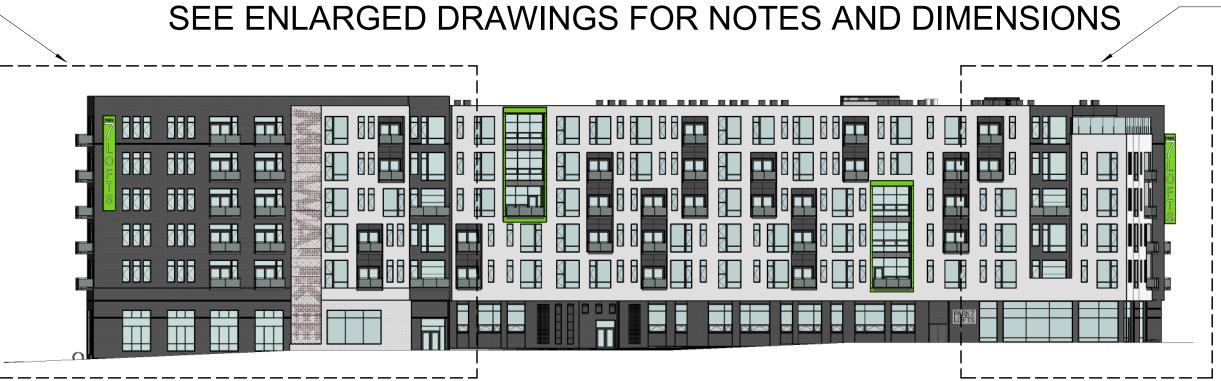BUILDING **ELEVATIONS** 



WEST ELEVATION - FLAT (SOUTH HALF)

SCALE: 1/8" = 1'-0"

MASONRY CONTROL

WINDOW ASSEMBLY

**BUILDING SIGNAGE:** 4'-0" X 0'-6" X 31'-6" WALL SIGN, BACKLIT RAISED

ALUMINUM LETTERS,
BACKGROUND COLOR
TO MATCH ACCENT

MASONRY REVEAL -COURSINGS

ALUMINUM FRAMED STOREFRONT, CLEAR GLAZING

**FIBERGLASS** 

WINDOW ASSEMBLY

4X12 UNIT MASONRY

GLASS GARAGE DOOR

MASONRY REVEAL

HUNG ALUMINUM BALCONY —

COURSING

WEST ELEVATION - FLAT (NORTH HALF)

SCALE: 1/8" = 1'-0"

PROJECTIONS -

JOINTS -

**FIBERGLASS** 

FIBERGLAS\$ SLIDING

4X12 UNIT MASONRY

NOT IN TRUE

ELEVATION

SEE 1/A401

MASONRY REVEAL

ROOF 180' - 0"

LEVEL THREE 132' - 0"

LEVEL ONE MEZZANINE 110' - 9"

MASONRY REVEAL COURSING

BUILDING SIGNAGE:

3'-6" X 0'-6" X 30'-0" BLADE SIGN, BACKLIT

RAISED ALUMINUM LETTERS, BACKGROUND COLOR TO MATCH ACCENT PROJECTIONS

COURSING

<sub>\_</sub>3 1/2"

ROOF 180' - 0"

LEVEL SIX 168' - 0"

LEVEL FOUR 144' - 0"

MASONRY REVEAL

COURSINGS

GLASS GARAGE DOOR

PATIO DOOR

**HUNG ALUMINUM** 

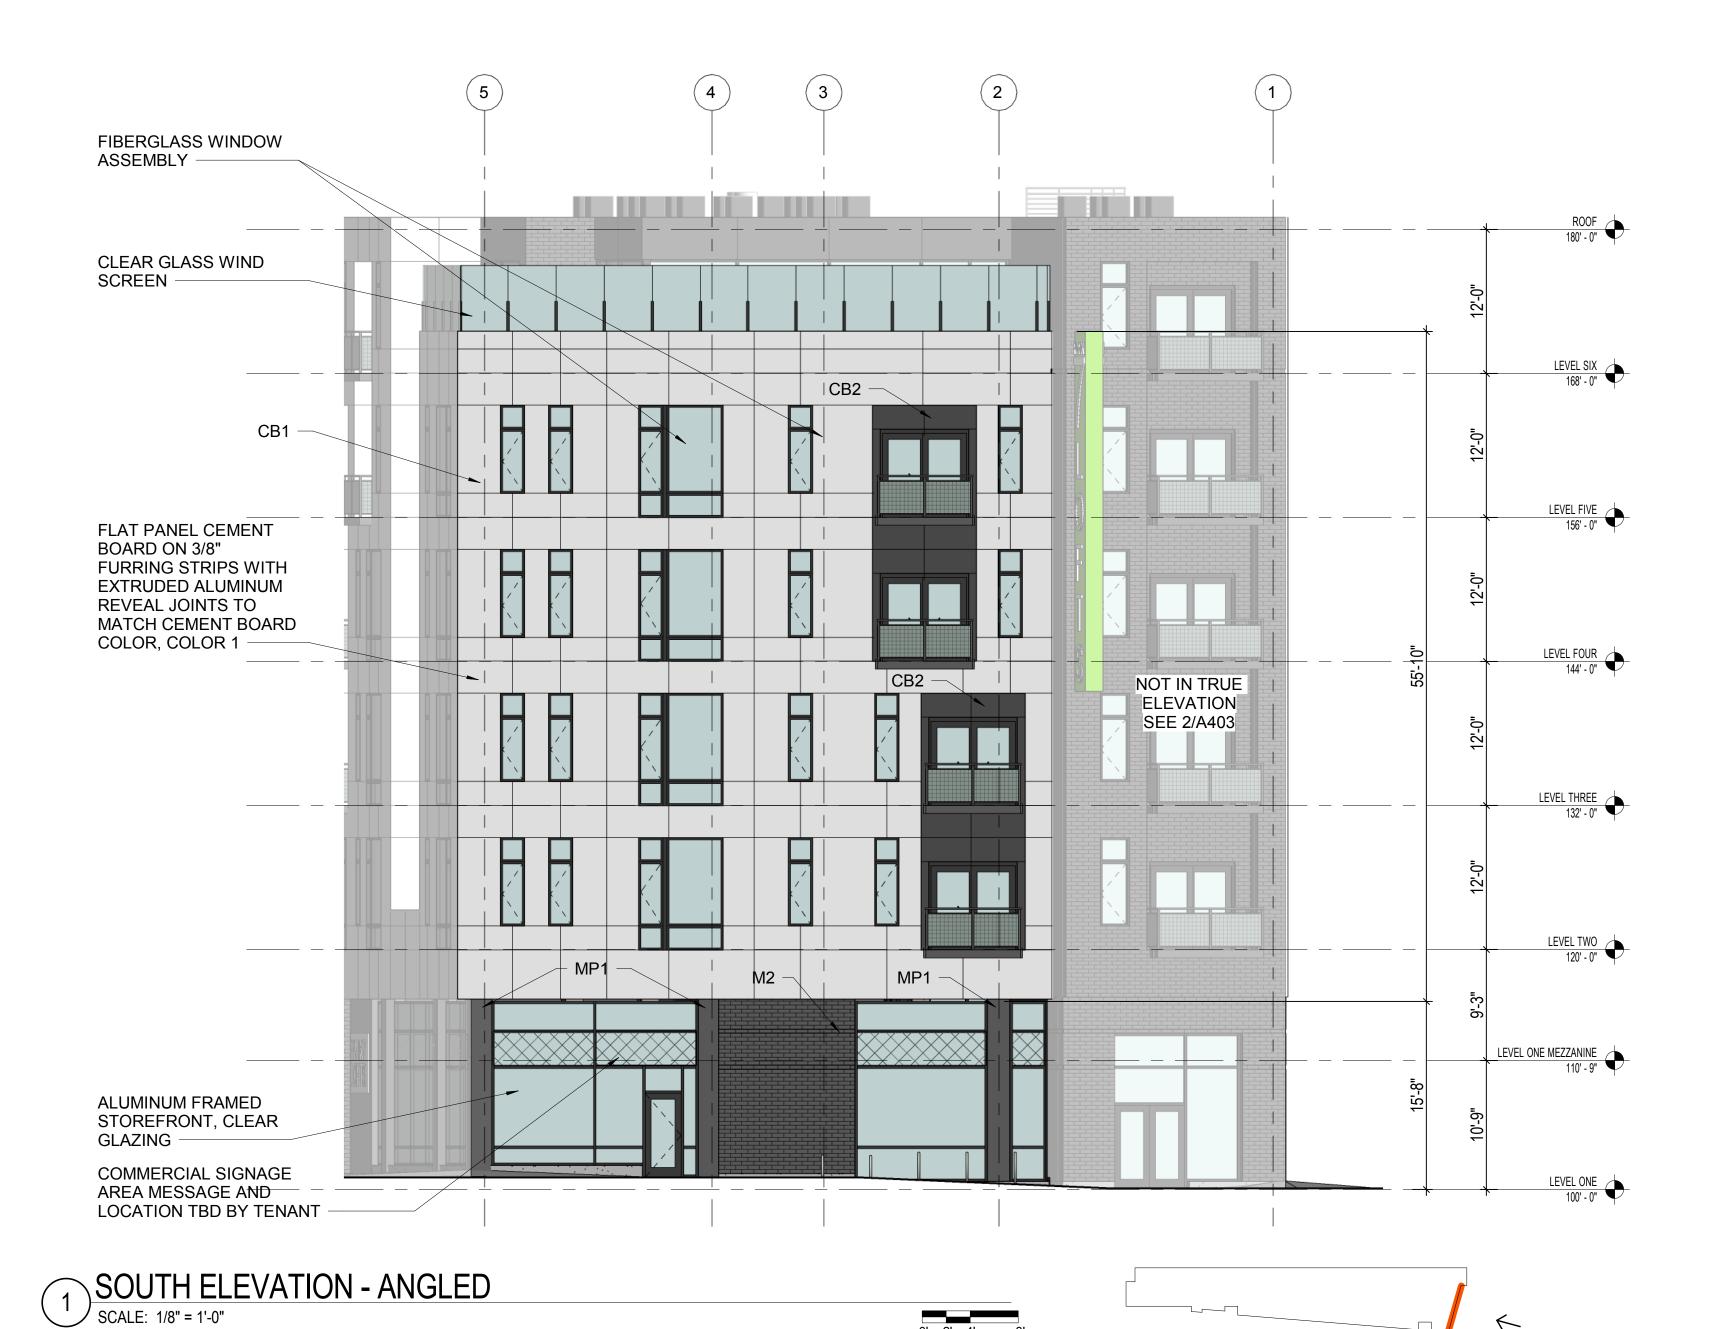
BALCONY

COMMERCIAL SIGNAGE AREA MESSAGE AND LOCATION TBD BY TENANT

NOT IN TRUE ELEVATION

SEE 2/A401

L\_\_\_\_\_\_ L\_\_\_\_\_\_\_\_







EXTERIOR FINISHES LEGEND			
DESIGNATION	PRODUCT	COLOR	
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MILWAUKEE | MADISON | TUCSON | CHICAGO

PARK 7 LOFTS

550 West Juneau Avenue Milwaukee, WI 53212

Royal Capital Group, LLC. 710 N Plankinton Ave, Suite 300

HUD PROJECT NUMBER

NO. DESCRIPTION

Milwaukee, WI 53203

EA PROJECT NUMBER 162642.00

ISSUED FOR:

075-35472

PLAN REVIEW 11/08/17

REVISION FOR: DATE

DRAWN BY Author

CHECKED BY Checker

BUILDING ELEVATIONS GENERAL NOTES - EXTERIOR WALL TYPES

WALL SECTION AT ACCENT CUTOUT

SCALE: 1/4" = 1'-0"

WALL SECTION AT LOFT UNITS

SCALE: 1/4" = 1'-0"

**EXTERIOR WALL ASSEMBLY 1** UTILITY SIZE MASONRY VENEER (4X12X4), 2" AIR SPACE, SHEET AIR & WATER BARRIER, (1) LAYER 5/8" FIRE RATED SHEATHING, 2X6 FIRE TREATED WOOD STUDS w/BATT INSULATION, VAPOR BARRIER, (2) LAYERS 5/8" TYPE 'X' GYPSUM WALL BOARD (UL U349)

**EXTERIOR WALL ASSEMBLY 2** UTILITY SIZE MASONRY VENEER (4X12X4), 2" AIR SPACE, NFPA 285 COMPLIANT 2" RIGID INSULATION (R-5/INCH MIN.), FLUID APPLIED AIR & WATER BARRIER, 8" CMU, 5/8" GYPSUM WALL BOARD

**EXTERIOR WALL ASSEMBLY 3** 5/16" CEMENT BOARD PANEL, 3/8" PLASTIC FURRING/AIR SPACE, SHEET AIR & WATER BARRIER, (1) LAYER 5/8" FIRE RATED SHEATHING, 2X6 FIRE TREATED WOOD STUDS w/BATT INSULATION, VAPOR BARRIER, (2) LAYERS 5/8" TYPE 'X' GYPSUM WALL BOARD (UL U349)

**EXTERIOR WALL ASSEMBLY 4** LARGE FORMAT MASONRY VENEER (8X24X4), 2" AIR SPACE, NFPA 285 COMPLIANT 2" RIGID INSULATION (R-5/INCH MIN.), FLUID APPLIED AIR & WATER BARRIER, 8" CMU, 5/8" GYPSUM WALL BOARD

**EXTERIOR WALL ASSEMBLY 5** 

5/16" CEMENT BOARD PANEL, 3/8" PLASTIC FURRING/AIR SPACE, SHEET AIR & WATER BARRIER, (1) LAYER 5/8" FIRE RATED SHEATHING, 2X6 FIRE TREATED WOOD STUDS w/BATT INSULATION, (1) LAYER 5/8" FIRE RATED SHEATHING, SHEET AIR & WATER BARRIER, 3/8" PLASTIC FURRING/AIR SPACE, 5/16" CEMENT **BOARD PANEL** 

### **EXTERIOR WALL ASSEMBLY 6**

5/16" CEMENT BOARD PANEL, 3/8" PLASTIC FURRING/AIR SPACE, SHEET AIR & WATER BARRIER, NFPA 285 COMPLIANT 2" RIGID INSULATION (R-5/INCH MIN.), FLUID APPLIED AIR & WATER BARRIER, 8" CMU, 5/8" GYPSUM WALL BOARD

**EXTERIOR WALL ASSEMBLY 7** 

WALL SECTION AT RES. ENTRY

SCALE: 1/4" = 1'-0"

PERFORATED METAL PANEL ATTACHED AT PERIMETER FRAME, AIR SPACE, MARINE GRADE PLYWOOD, 3/8" PLASTIC FURRING/AIR SPACE, SHEET AIR & WATER BARRIER, (1) LAYER 5/8" FIRE RATED SHEATHING, 2X6 FIRE TREATED WOOD STUDS w/BATT INSULATION, VAPOR BARRIER, (2) LAYERS 5/8" TYPE 'X' GYPSUM WALL BOARD (UL U349)

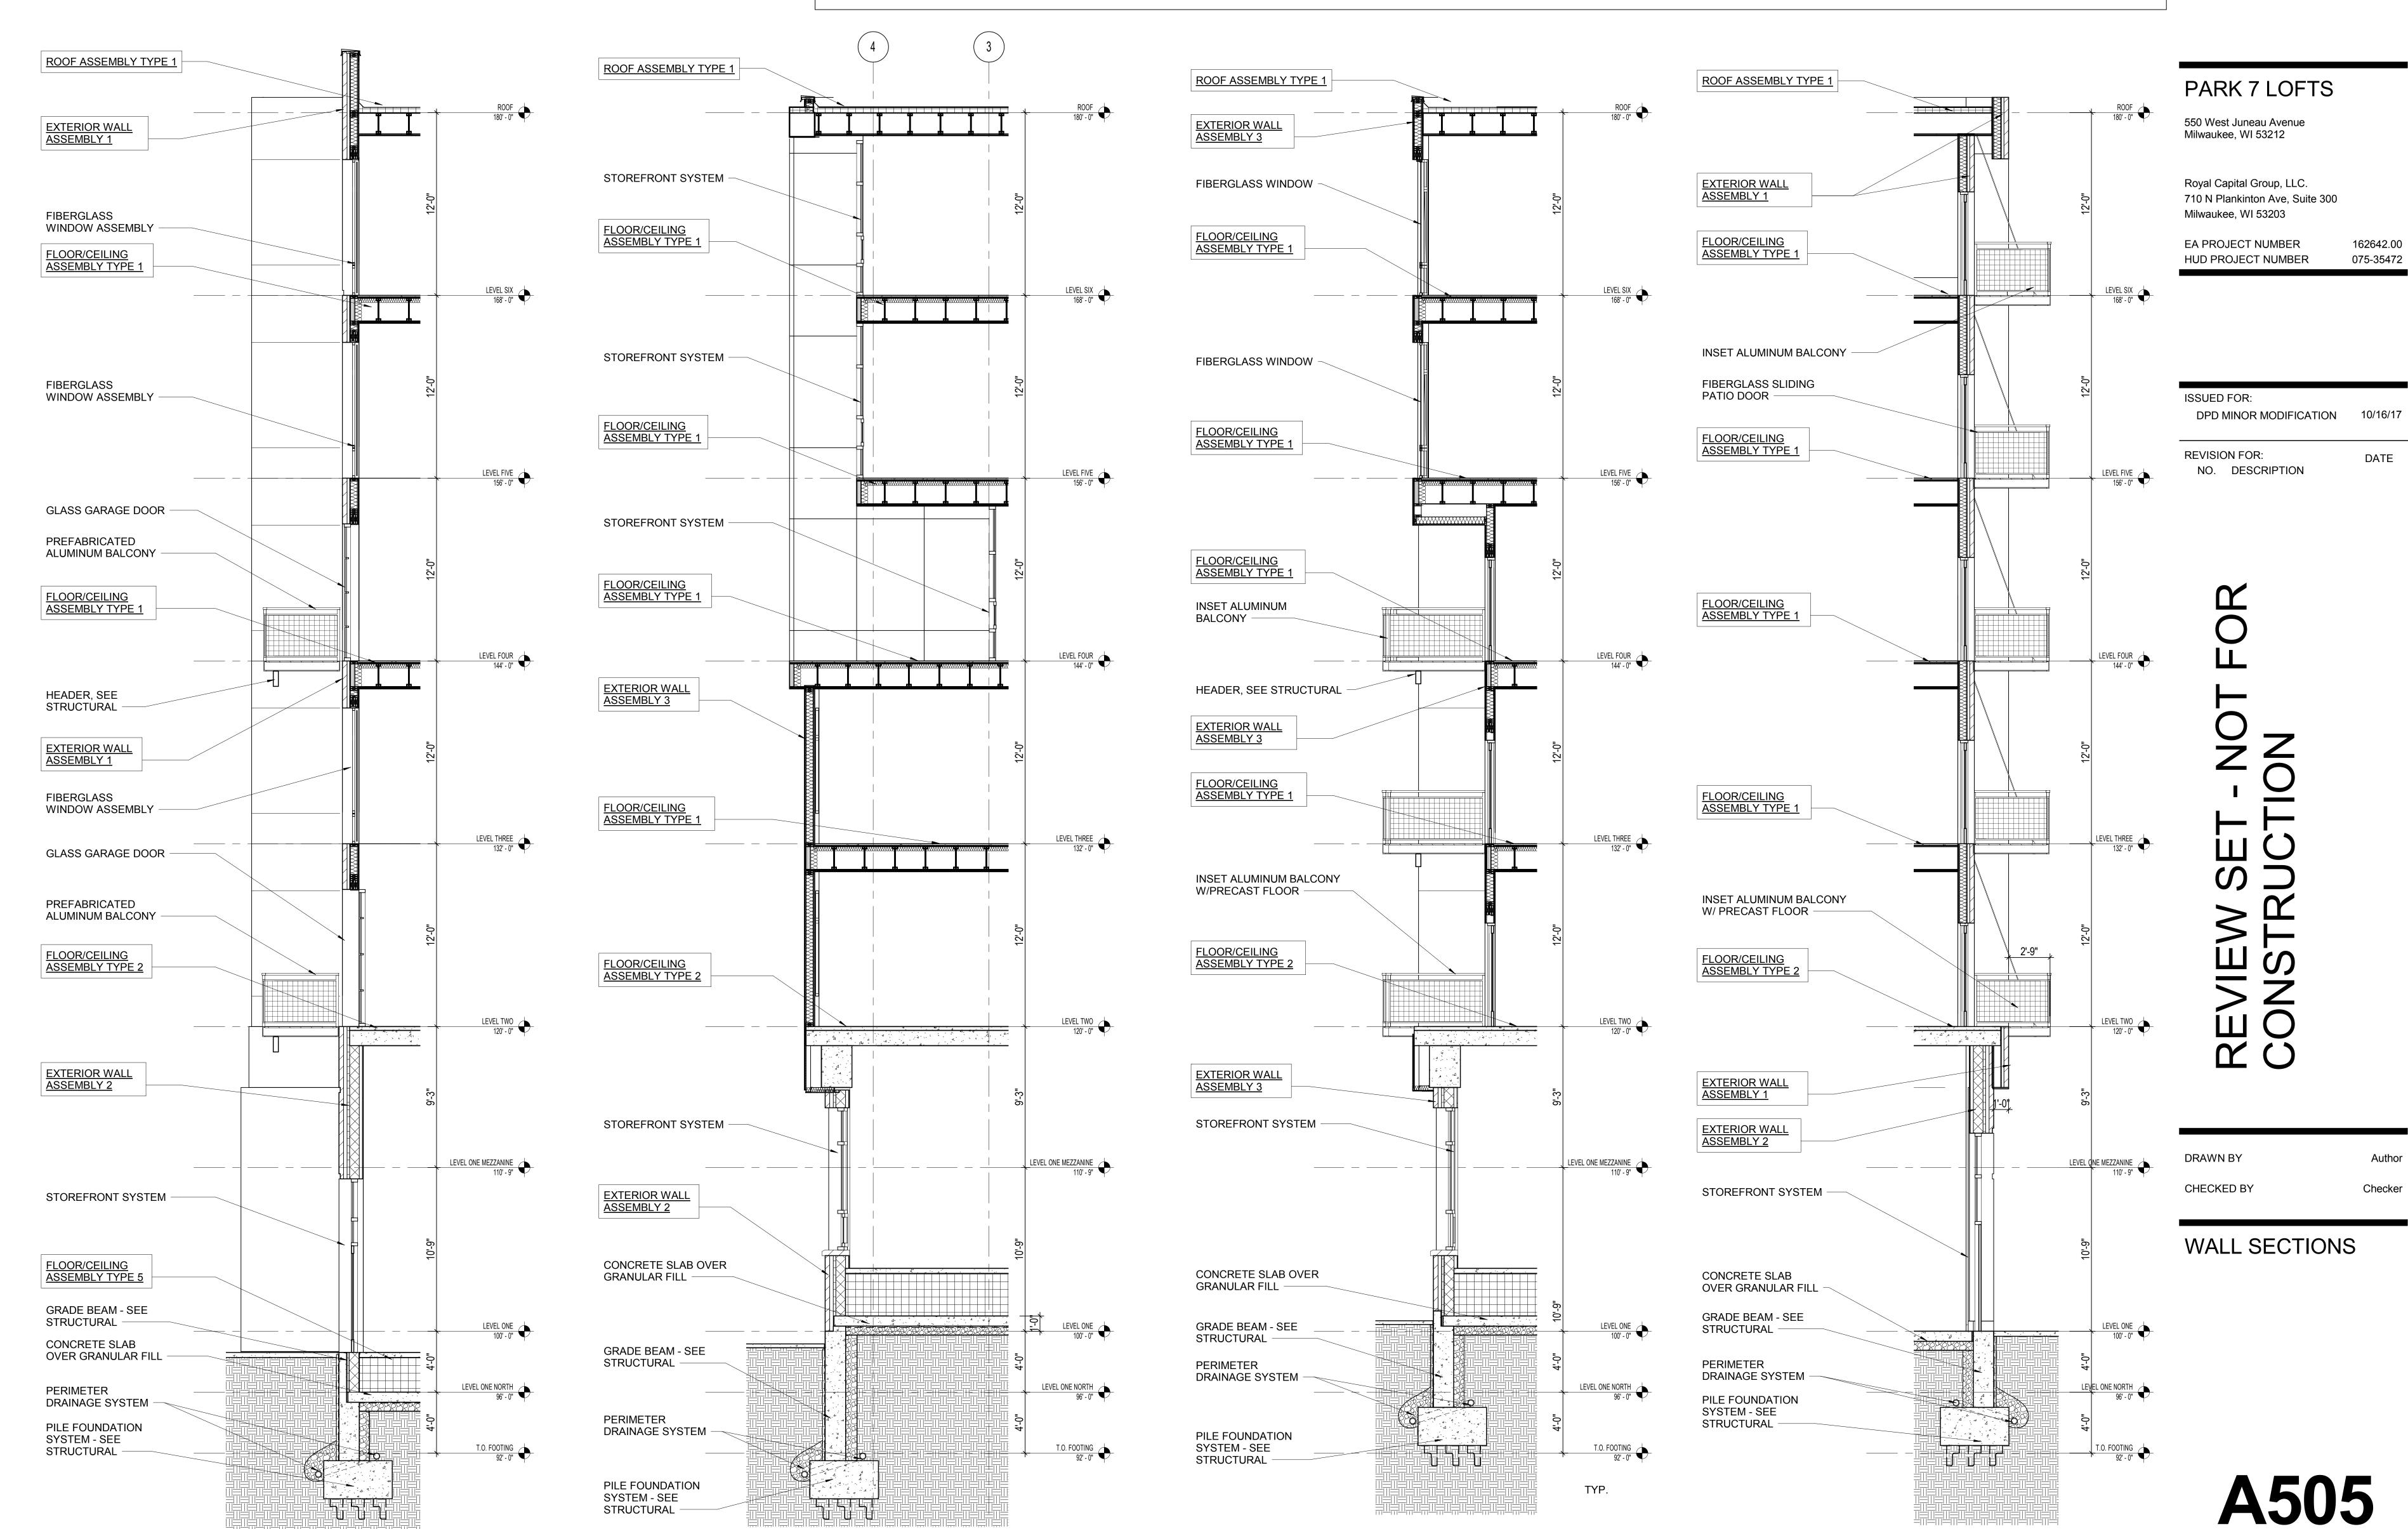
### **EXTERIOR WALL ASSEMBLY 8**

UTILITY SIZE MASONRY VENEER (4X12X4), 1" AIR SPACE, NFPA 285 COMPLIANT 2" RIGID INSULATION (R-5/INCH MIN.), FLUID APPLIED AIR & WATER BARRIER, 6" CMU, NFPA 285 COMPLIANT 2" RIGID INSULATION ON Z-FURRING CHANNELS, 5/8" GYPSUM WALL BOARD

**EXTERIOR WALL ASSEMBLY 9** 12" CMU, NFPA 285 COMPLIANT 2" RIGID INSULATION (R-5/INCH MIN.) ON Z-FURRING CHANNELS, 5/8" GYPSUM WALL BOARD (UL U912)



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WALL SECTION AT FULLY INSET BALCONY

SCALE: 1/4" = 1'-0"





PARK 7 LOFTS

PERSPECTIVE FROM NORTHWEST SCALE:

Engberg Anderson Project No. 162642.00





### PARK 7 LOFTS

PERSPECTIVE FROM SOUTHWEST SCALE:

Engberg Anderson Project No. 162642.00

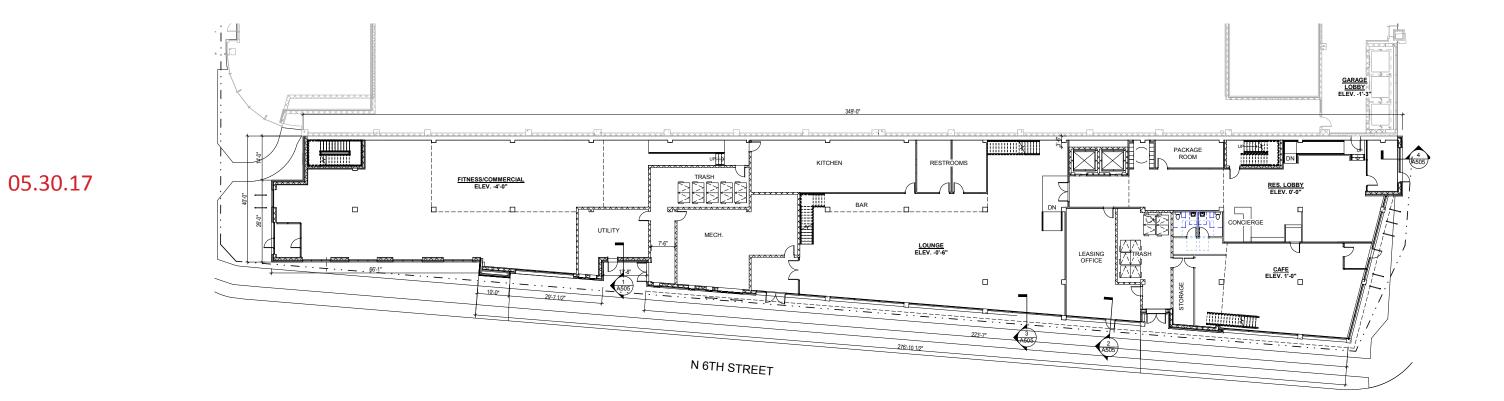




PARK 7 LOFTS


RESIDENTIAL ENTRY VIEW SCALE:

Engberg Anderson Project No. 162642.00



1 LEVEL ONE PLAN
SCALE: 3/32" = 1'-0"

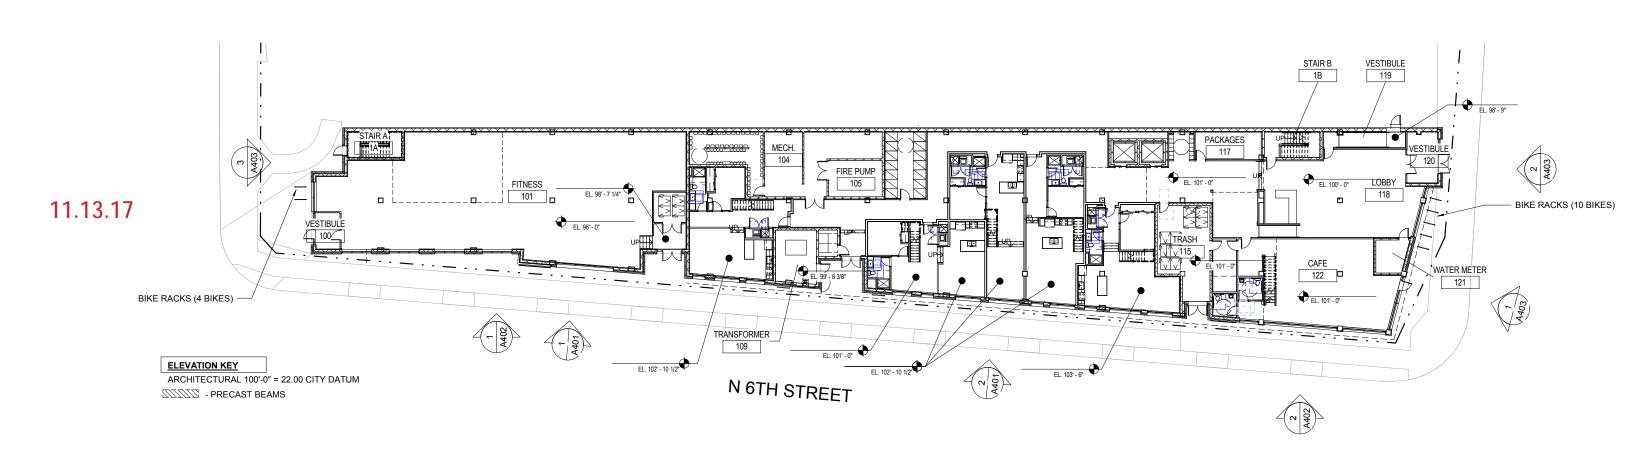1 LEVEL ONE PLAN
SCALE: 3/32" = 1'-0"




### 05.30.17




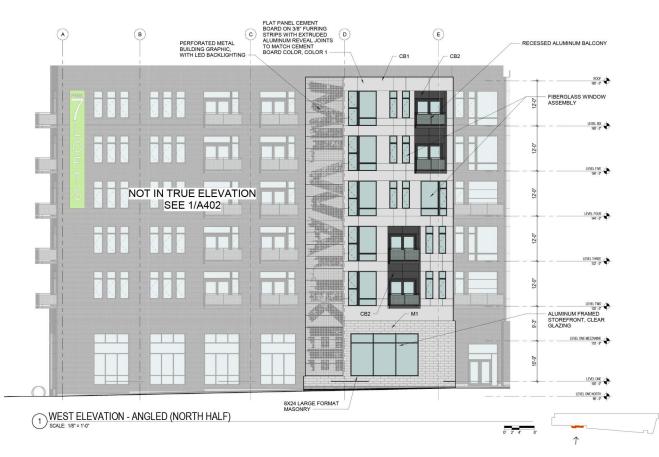
### 11.13.17

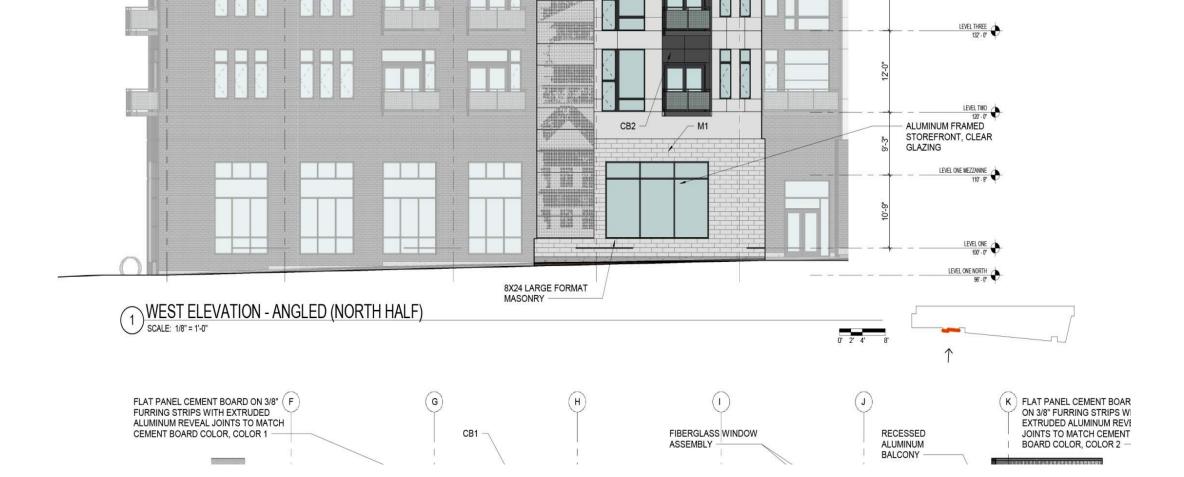






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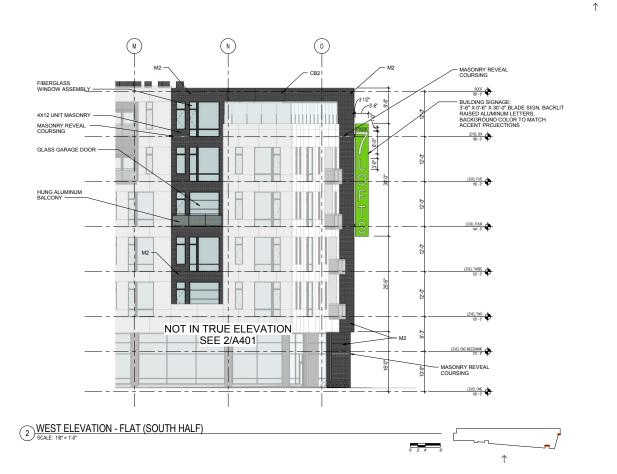


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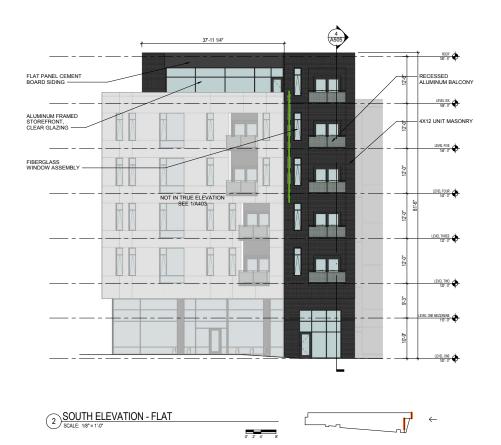




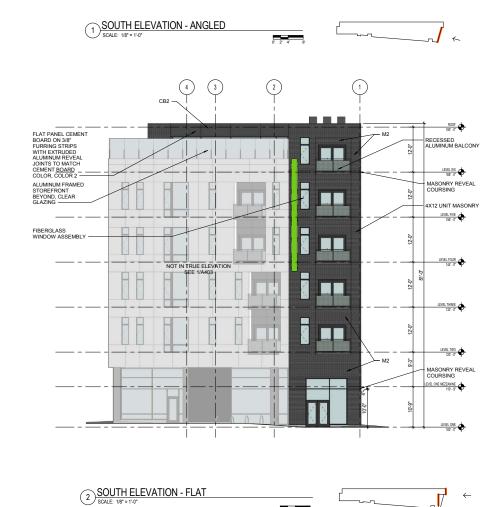


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