

The Hills Luxury Commons - Phase V | Block C

MILWAUKEE, WISCONSIN | JUNE 16, 2017



TABLE OF CONTENTS

CONTACT INFORMATION

Kevin Newell

CEO/President Royal Capital Group, LLC.


PH | 414.847.6275 EMAIL | k.newell@royalcapital.net

Terrell Walter

Project Manager - Multifamily Housing Royal Capital Group, LLC.


PH | 414.847.6275 EMAIL | t.walter@royalcapital.net

VICINITY MAP, SITE IMAGES + ARCHITECTURAL SITE PLAN	A001
GENERAL NOTES	C001C
EXISTING CONDITIONS	C002C
ALTA/NSPS LAND TITLE SURVEY	AS10AD30
EROSION CONTROL PLAN	C110C
EROSION CONTROL DETAILS	C111C
SITE PLAN	C200C
GRADING PLAN	C300C
UTILITY PLAN	C400C
CONSTRUCTION DETAILS	C501C
CONSTRUCTION DETAILS	C502C
CONSTRUCTION DETAILS	C503C
CONSTRUCTION DETAILS	C504C
OVERALL LANDSCAPE PLAN	L100
LANDSCAPE NOTES, SCHEDULES & DETAILS	L101
BUILDING ELEVATIONS	A401
BUILDING ELEVATIONS	A402
WALL SECTIONS	A510
PERSPECTIVE ALONG EAST BROWN STREET	A900

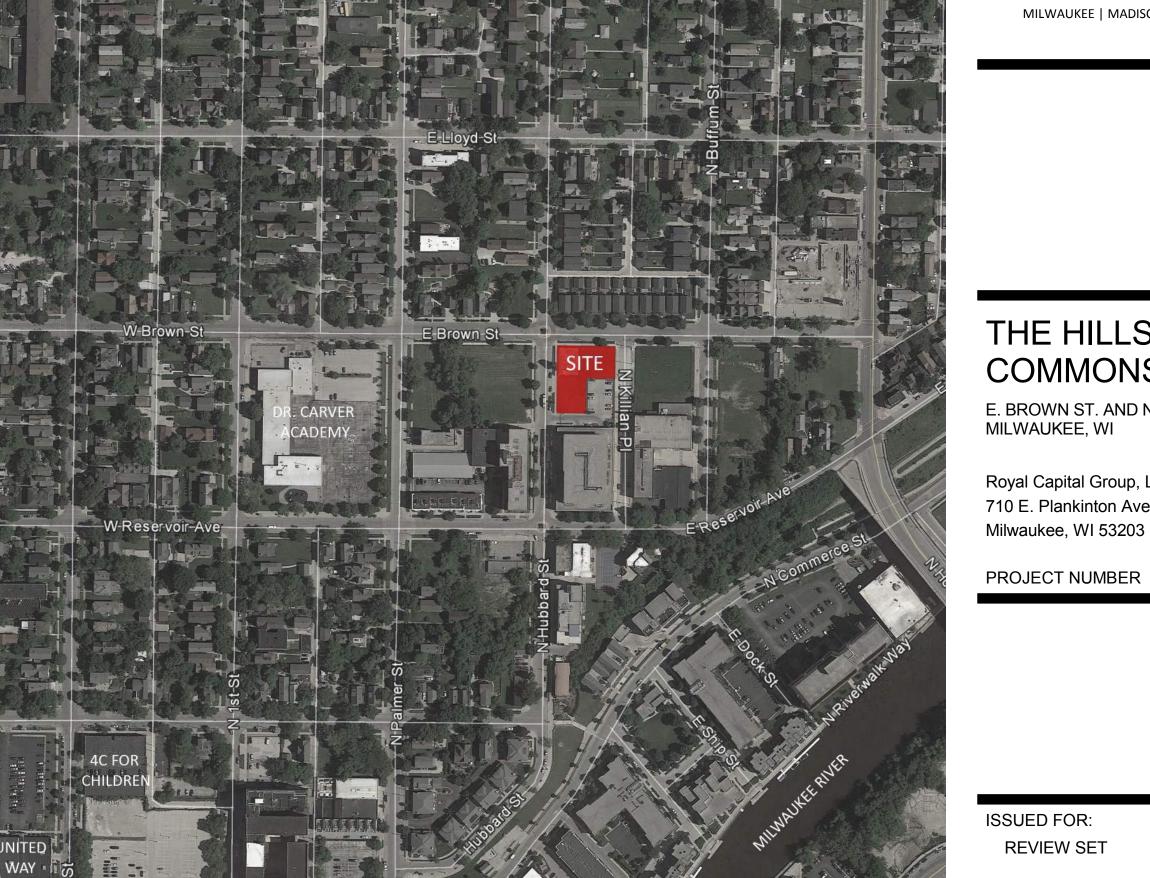

REVISION FOR: NO. DESCRIPTION



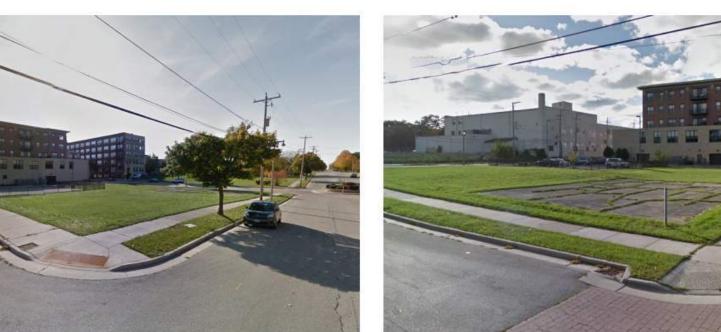





SITE IMAGES

VICINITY MAP

THE HILLS LUXURY COMMONS- BLOCK C

E. BROWN ST. AND N. HUBBARD ST. MILWAUKEE, WI

Royal Capital Group, LLC. 710 E. Plankinton Ave, Suite 300

Milwaukee, WI 53203

ISSUED FOR: **REVIEW SET** 06/16/17

DATE

DRAWN BY Author CHECKED BY

ARCHITECTURAL SITE PLAN, VICINITY MAP & SITE PHOTOS

A001



GENERAL

- 1. THE LOCATION OF ALL STRUCTURES. OBSTACLES, AND EXISTING FACILITIES SHALL NOT BE TAKEN AS CONCLUSIVE, IT SHALL BE ASSUMED THAT THE CONTRACTOR HAS VERIFIED SAID LOCATIONS AS A CONDITION OF HIS BID AND THEREFORE THE CONTRACTOR SHALL BE RESPONSIBLE FOR ALL DAMAGES RESULTING FROM HIS ACTIVITIES.
- 2. ALL CONTRACTORS SHALL BE RESPONSIBLE FOR OBTAINING ALL PERMITS NECESSARY TO CARRY OUT THEIR WORK.
- 3. THE CONTRACTOR SHALL SUBMIT FOR APPROVAL BY THE OWNER A LIST OF ALL MATERIALS PROPOSED TO BE USED PRIOR TO ORDERING OR DELIVERY.
- 4. ALL CONTRACTORS SHALL HAVE A COMPETENT FOREMAN, SUPERINTENDENT, OR OTHER REPRESENTATIVE AT THE SITE AT ALL TIMES WHO HAS AUTHORITY TO ACT FOR THE CONTRACTOR.
- 5. A PRE CONFERENCE WILL BE HELD PRIOR TO CONSTRUCTION START UP.
- 6. CONTRACTORS SHALL BE RESPONSIBLE FOR ADEQUATELY BARRICADING AREAS AND ERECTING A CONSTRUCTION FENCE AROUND THE PERIMETER OF THE SITE OF CONSTRUCTION TO PROTECT AGAINST PERSONAL INJURY AS WELL AS WARN TRAFFIC OF THE CONSTRUCTION SITE WHERE NECESSARY. SIGNING SHALL BE IN ACCORDANCE WITH THE MANUAL ON UNIFORM TRAFFIC CONTROL DEVICES (MUTCD) MOST RECENT VERSION WITH WISDOT SUPPLEMENT. ALL OTHER SIGNS MUST BE PRE-APPROVED BY OWNER.
- 7. ALL DIMENSIONS ARE TO THE EDGE OF FACE OF CURB, PAVEMENT, FACE OF BUILDING OR PROJECT WORK LIMIT LINE UNLESS OTHERWISE NOTED.
- 8. ALL ROAD AND PAVING CONSTRUCTION SHALL BE DONE IN ACCORDANCE WITH THE WISCONSIN DEPARTMENT OF TRANSPORTATION STANDARD SPECIFICATIONS FOR HIGHWAY AND STRUCTURE CONSTRUCTION - 2016 EDITION HEREIN REFERRED TO AS THE STANDARD SPECIFICATIONS, EXCEPT AS MODIFIED
- 9. WHERE SPECIFIC PORTIONS OF THESE PLANS & SPECIFICATIONS ARE IN CONFLICT WITH THE WISCONSIN DEPARTMENT OF TRANSPORTATION STANDARD SPECIFICATIONS FOR HIGHWAY AND STRUCTURE CONSTRUCTION, 2016 EDITION, THESE PLANS & SPECIFICATIONS SHALL GOVERN.
- 10. CONSTRUCTION WORK AND STORAGE OF EQUIPMENT OR MATERIALS WILL NOT BE ALLOWED IN WETLAND AREAS.
- 11. A STREET EXCAVATION PERMIT WILL BE REQUIRED FOR WORK WITHIN THE PUBLIC RIGHT OF WAY/EASEMENTS. APPLICABLE PERMIT FEES WILL BE DETERMINED UPON RECEIPT OF THE PERMIT APPLICATION. COORDINATE PERMIT APPLICATION WITH XXXXXXXX. CITY OF MILWAUKEE DPW ENGINEERING INSPECTOR, AFTER FINAL PLAN APPROVAL.
- 12. CITY OF MILWAUKEE PUBLIC WORKS INSPECTION IS NEEDED FOR ALL WORK WITHIN THE PUBLIC RIGHT OF WAY/EASEMENTS. CONTACT XXXXXXXX, INSPECTION SUPERVISOR 72 HOURS PRIOR TO SCHEDULING WORK.

GRADING

- 1. THE CONTRACTOR SHALL BE RESPONSIBLE FOR CONSTRUCTING THE PROPOSED ROADS, SIDEWALKS, CONCRETE SLAB, STORMWATER MANAGEMENT FACILITIES AND EROSION CONTROL DEVICES TO THE PROPOSED GRADE ELEVATIONS AND LOCATIONS SHOWN ON THE GRADING PLAN.
- 2. THE CONTRACTOR SHALL STRIP AND REMOVE TOPSOIL FOUND WITHIN THE GRADING LIMITS. GRADE LANDSCAPE AREAS LOW TO ALLOW FOR PLACEMENT OF TOPSOIL, SEED, MULCH AND PLANTINGS BY LANDSCAPE CONTRACTOR PER THE LANDSCAPE SPECIFICATIONS AND PLANS.
- 3. THE SUB GRADE FOR THE ROAD SHALL BE PREPARED IN ACCORDANCE WITH SECTION 31

- 22 16.15 OF THE CONTRACT SPECIFICATIONS. OPERATION OF SPREADING AND HAULING EQUIPMENT WILL NOT BE CONSIDERED AS ADEQUATE COMPACTION.
- 4. THE BASE COURSE SHALL BE PLACED ONLY ON SUB GRADE THAT HAS BEEN PROOF-ROLLED.
- 5. GRADING CONTRACTOR SHALL BE RESPONSIBLE FOR PROTECTION OF EXISTING PROPERTY CORNERS AND PERTINENT AREAS WITHIN ALL EASEMENTS.

- 1. THE PAVING CONTRACTOR SHALL BE RESPONSIBLE FOR PLACING THE CRUSHED STONE BASE ON THE ROAD TO THE DEPTHS INDICATED.
- 2. BASE COURSE IN PROPOSED ASPHALT PAVEMENT AREAS SHALL BE IN ACCORDANCE WITH THE SITE PLAN AND THE TYPICAL PAVEMENT SECTION SHOWN ON THE DETAIL DRAWING. THE CRUSHED STONE SHALL MEET THE REQUIREMENTS OF SECTION 305, 1/4-INCH GRADATION OF THE STANDARD SPECIFICATIONS. THE BASE COURSE SHALL BE COMPACTED USING ROLLERS, VIBRATORY ROLLERS. OR A COMBINATION OF BOTH AS DETAILED IN SECTION 305 OF THE STANDARD SPECIFICATIONS.
- 3. PRIOR TO PLACING THE ASPHALT PAVEMENT, THE SURFACE OF THE CRUSHED STONE BASE COURSE SHALL BE GRADED TO PROPER ELEVATION AND CROWN AND COMPACTED IN ACCORDANCE WITH SECTION 305.3.2 OF THE STANDARD SPECIFICATIONS.
- 4. EQUIPMENT UTILIZED IN THE MIXING, TRANSPORT, LAYING AND COMPACTING OF THE ASPHALT BINDER AND SURFACE COURSES SHALL COMPLY WITH SECTION 450 OF THE STANDARD SPECIFICATIONS. SUFFICIENT EQUIPMENT IN GOOD OPERATING CONDITION SHALL BE MAINTAINED AT THE SITE AT ALL TIMES TO PERFORM THE WORK WITH NO DELAYS.
- 5. ASPHALT LOWER LAYER AND UPPER LAYER SHALL BE INSTALLED IN ACCORDANCE PROJECT SPECIFICATIONS AND WITH SECTIONS 455, 460, AND 465 OF THE WISCONSIN DEPARTMENT OF TRANSPORTATION STANDARD SPECIFICATIONS FOR HIGHWAY AND STRUCTURE CONSTRUCTION, 2016 EDITION.
- 6. PRIOR TO PLACING THE SURFACE COURSE. THE PAVING CONTRACTOR SHALL REMOVE ALL FOREIGN MATTER FROM THE SURFACE OF THE UPPER LAYER AND REPAIR, BY SAW CUTTING, REMOVAL AND REPLACEMENT, ANY DEPRESSION OR SIGNS OF FAILURE AND ALL SURFACE IRREGULARITIES AS DIRECTED BY THE ENGINEER. A TACK COAT SHALL BE APPLIED PRIOR TO PLACEMENT OF THE SURFACE COURSE.
- 7. TO AVOID HAVING LONGITUDINAL JOINTS IN THE UPPER LAYER, THE UPPER LAYER SHALL BE PLACED WITH PASS WIDTHS SUCH THAT THE LONGITUDINAL JOINTS ARE OFFSET A MINIMUM OF ONE FOOT. JOINTS SHALL BE TACKED PRIOR TO LAYING NEW ASPHALT.

SIDEWALK AND MISCELLANEOUS

- 1. WHERE INDICATED ON THE PLANS, INSTALL CONCRETE SIDEWALK IN ACCORDANCE WITH CONTRACT SPECIFICATION 32 16 00.
- 2. ALL SURPLUS EXCAVATED MATERIAL SHALL BE COORDINATED WITH THE GENERAL CONTRACTOR FOR ITS TEMPORARY LOCATION.

SANITARY AND WATER SERVICES

- 1. ALL SANITARY AND WATER SERVICE CONSTRUCTION SHALL BE IN ACCORDANCE WITH THE CONTRACT SPECIFICATIONS AND CITY OF MILWAUKEE STANDARDS. REFERENCES ARE STANDARD SPECIFICATIONS FOR SEWER AND WATER CONSTRUCTION IN WISCONSIN (2003 EDITION: ADDENDUM NO. 1 AND NO. 2, 2004), REGULATIONS OF THE DEPARTMENT OF SAFETY AND PROFESSIONAL SERVICES (DSPS) (SPS 382) FOR PRIVATE DEVELOPMENT WORK.
- 2. ALL PIPE MATERIALS AND CONSTRUCTION SHALL BE IN ACCORDANCE WITH THE FOLLOWING: SEE CONTRACT SPECIFICATIONS FOR DETAILS.

A. SANITARY LATERAL- SECTION 33 30 00 FOR PVC PIPE, ASTM D3034, SDR 35.

B. HYDRANT LEADS - SECTION 33 10 00 FOR PVC PIPE, AWWA C-900, CLASS 235 (DR-18).

C. WATER SERVICE - SECTION 33 10 00 FOR PVC PIPE, AWWA C-900, CLASS 235 (DR-18).

3. ALL SANITARY PIPE JOINT CONNECTIONS SHALL BE PUSH-ON RUBBER GASKET. ALL WATER FITTINGS SHALL CONFORM TO SPECIFICATION SECTION 33 10 00. OFFSET FITTINGS SHALL BE MEGA-LUGS OR EQUAL.

4. WATER VALVES SHALL BE EITHER AFC SERIES 2500, CLOW F-6100, MUELLER 2360-20, KENNEDY KEN-SEAL OR M&H RESILIENT WEDGE GATE VALVES WITH STAINLESS STEEL BOLTS, MEETING THE REQUIREMENTS OF AWWA C-509 AND IN ACCORDANCE WITH **SECTION 33 10 00.**

5. BACKFILL MATERIAL FOR WATER UTILITIES SHALL BE CRUSHED STONE BACKFILL (CONTRACT SPECIFICATION SECTION 33 10 00) UNDER PAVED SURFACES OR SPOIL (STANDARD SPEC SECTION 8.43.5) UNDER LANDSCAPED AREAS.

6. HYDRANTS SHALL BE EITHER CLOW MEDALLION, MUELLER CENTURIAN, WATEREOUS PACER, OR KENNEDY GUARDIAN. MEETING THE REQUIREMENTS OF AWWA C-502 | AGG AND IN ACCORDANCE WITH SECTION 33 10 00 | B/C OF CONTRACT SPECIFICATIONS. HYDRANTS SHALL HAVE BRONZE ON BRONZE SEAT BRONZE UPPER VALVE PLATE, BREAK AWAY FLANGE, OIL OR GREASE RESERVOIR, 5-1/2 INCH VALVE OPENING, TWO 2-1/2 INCH HOSE NOZZLES AND ONE 4-1/2 INCH PUMPER NOZZLE. STAINLESS STEEL BOLTS SHALL BE USED UNDERGROUND.

7. IF APPLICABLE, SHELL-TYPE CUTTER WITH MULTIPLE CUTTING TEETH SHALL BE USED FOR TAPPING SERVICE CONNECTIONS, AS FOLLOWS:

A. CORPORATION STOPS SHALL NOT BE LOCATED CLOSER THAN ONE (1) FOOT FROM PIPE JOINTS. INSERTIONS ON OPPOSITE SIDES OF THE MAIN SHALL BE SEPARATED BY MIN. OF ONE (1) FOOT.

B. TEFLON TAPE SHALL BE PLACED ON THE CORPORATION STOP THREADS PRIOR TO INSTALLATION.

8. CONTRACTOR SHALL INSTALL TRACER WIRE | OH WITH ALL NON-METALLIC WATER UTILITIES IN PC ACCORDANCE WITH SECTION 33 10 00 OF SPECIFICATIONS. THIS INCLUDES ALL LATERALS, SERVICES AND BOXES.

UTILITY CONTACTS: CITY OF MILWAUKEE (WATER & SEWER)

CITY OF MILWAUKEE (INSPECTION SUPERVISOR)

CITY OF MILWAUKEE (DPW ENGINEERING INSPECTOR)

CITY OF MILWAUKEE (CITY ENGINEER)


SURVEY NOTES:

(NGVD) OF 1929.

WE ENERGIES **EMERGENCY CONTACT** 1-800-261-5325

HATCHING PATTERNS PROPOSED HMA PAVEMENT PROPOSED CONCRETE SIDEWALK REMOVE EXISTING ASPHALTIC PAVEMENT REMOVE EXISTING CONCRETE PAVEMENT/SIDEWALK GRAVEL STAGING AND STOCKPILE AREA STRUCTURE DEMOLITION STABILIZED CONSTRUCTION ENTRANCE LANDSCAPING **ABBREVIATIONS**

- AGGREGATE - BACK OF CURB - BITUMINOUS/ASPHALT - COMMERCIAL ENTRANCE - CAST IRON PIPE - CLEANOUT CONC - CONCRETE - CORRUGATED METAL PIPE - CONCRETE SEWER PIPE - CITY UNDERGROUND CONDUIT - DIAMETER - DUCTILE IRON PIPE - ELECTRICAL MANHOLE DRAIN - EXISTING - EDGE OF PAVEMENT - FRAME AND COVER - FACE OF CURB - FACE TO FACE - FINISHED GRADE - FLARED END SECTION - INVERT - LENGTH OF CURVE - LINEAR FT - LEFT - NATURAL GAS - OVERHEAD UTILITY - POINT OF CURVATURE - POLYETHYLENE PIPE - POINT OF INTERSECTION - PROPERTY LINE - POINT OF TANGENCY - POLYVINYL CHLORIDE PIPE - POINT OF VERTICAL INTERSECTION - RADIUS RCP - REINFORCED CONCRETE PIPE - TOP OF CASTING ELEVATION ROW - RIGHT OF WAY RT - RIGHT SAN - SANITARY SEWER - STORM SEWER SD - SUMP DISCHARGE

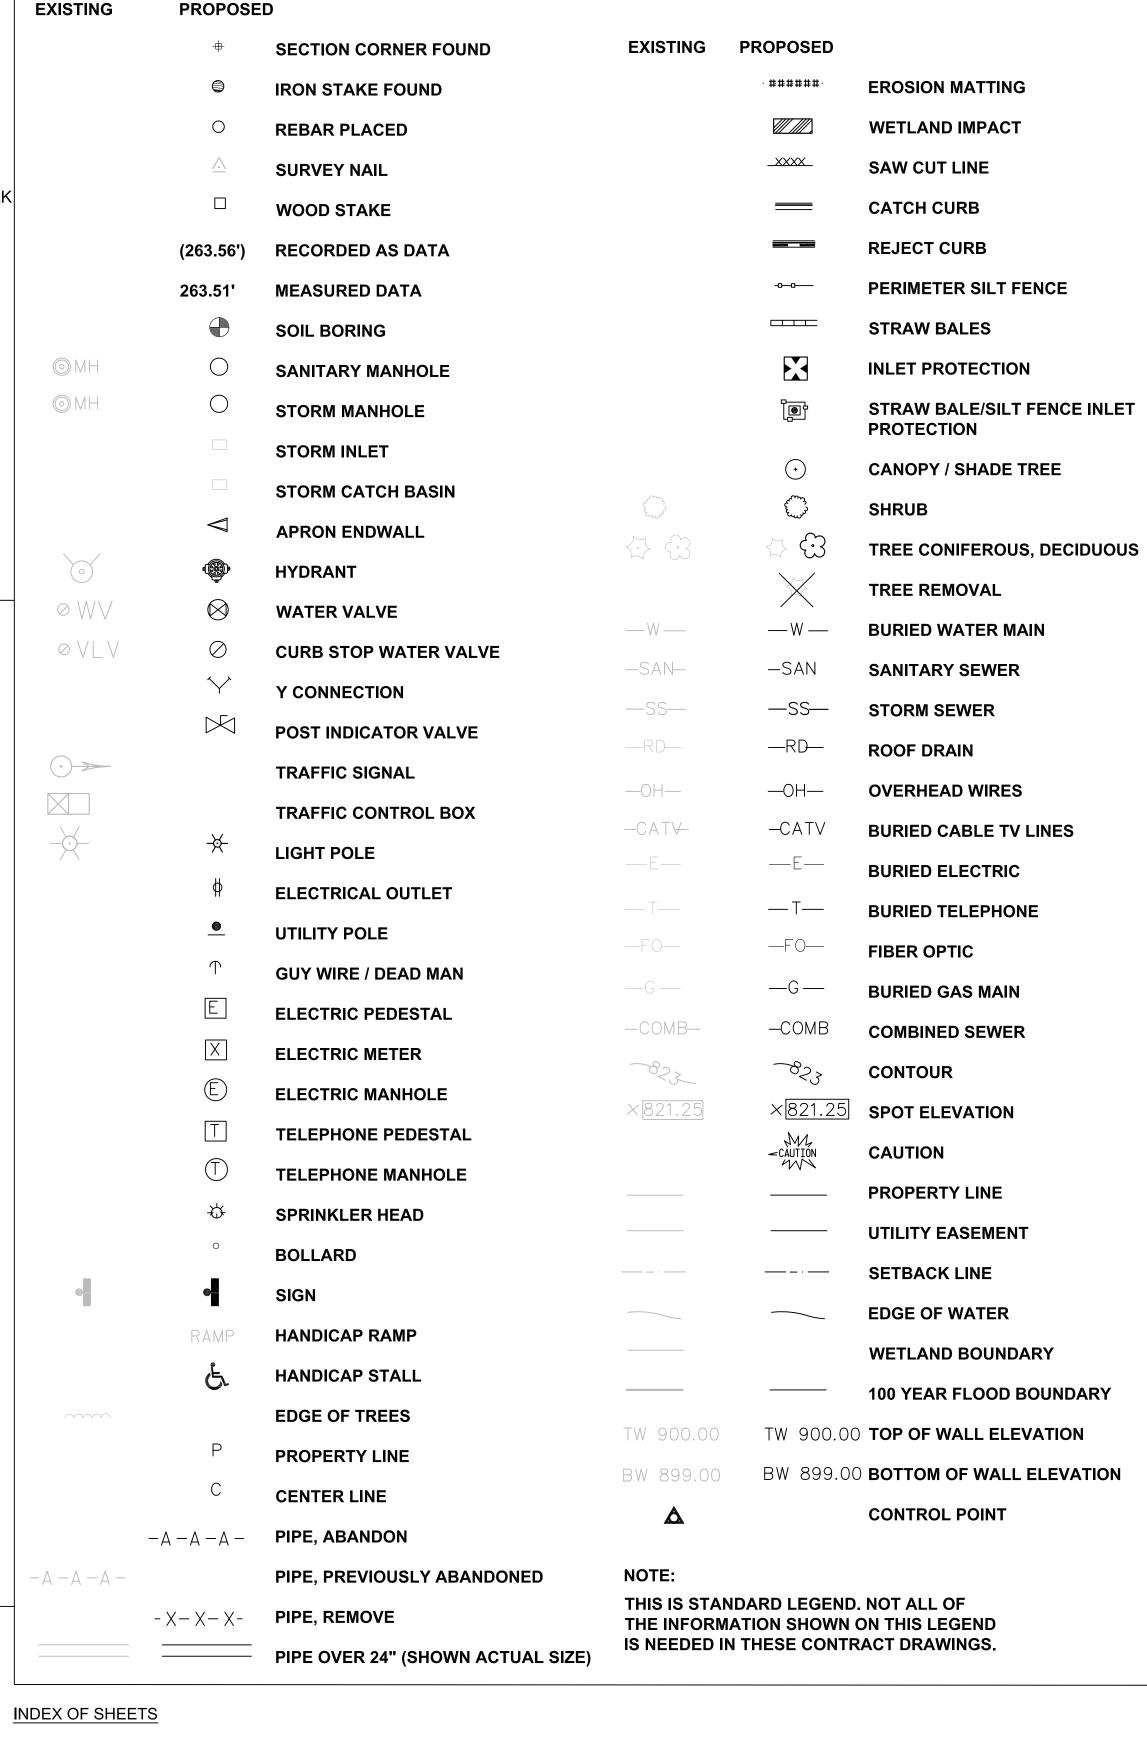

 GENERAL NOTES C001C C002C EXISTING CONDITIONS AS101D30 - ALTA/NSPS LAND TITLE SURVEY C110C - EROSION CONTROL PLAN C111C - EROSION CONTROL DETAILS C200C SITE PLAN C300C GRADING PLAN C400C UTILITY PLAN

C501C-504C - CONSTRUCTION DETAILS

LEGEND

SHEET 1

CHECKED BY

3636 North 124th Street

Wauwatosa, WI 53222

262-821-1171

CONSULTANT

CONSULTANT

CONSULTANT

S

.S ≥

BROWN AUKEE,

DESCRIPTION

05/11/17 CITY ZONING SUBMITTAL

05/11/2017

05/11/2017

SHEET 13

DATE

GENERAL NOTES AND

LEGEND

BLOCK C

T/C

TW

UD

1. HORIZONTAL DATUM: COORDINATE SYSTEM IS ASSUMED HOLDING THE

2. VERTICAL DATUM: ELEVATIONS SHOWN ON THE PLAN ARE REFERENCED

TO THE CITY OF MILWAUKEE STANDARD BENCH MARKS. CITY OF

NORTH LINE OF LOT 1, CSM NO. 6980 AS ASSUMED TO BEAR N89° 36' 30"E.

MILWAUKEE DATA ARE REFERENCED TO THE LEVEL OF THE MILWAUKEE

RIVER AS IT WAS IN THE MONTH OF MARCH, 1836 A.D. ADD 580.603 TO

PLACE ELEVATIONS ON THE NATIONAL GEODETIC VERTICAL DATUM

WDNR

- TOP OF CURB

- TOP OF WALL

- UNDERDRAIN


- VERTICAL CURVE

- WISCONSIN DEPARTMENT OF

NATURAL RESOURCES

PLAN NOTES:

1. CITY UNDERGROUND CONDUIT (CUC) SHALL REMAIN IN SERVICE. THIS CUC PACKAGE SHALL NOT BE EXPOSED OR UNDERMINED DURING THE CONSTRUCTION OF THE BLOCK BEAST AMD WEST BUILDINGS INCLUDING THE SEWER LATERALS, WATER LATERALS, SIDEWALK AND/OR DRIVEWAYS. THE CONTRACTOR SHALL TAKE ALL NECESSARY PRECAUTIONS INCLUDING TIGHT SHEATHING TO ENSURE THE CUC PACKAGE REMAINS INTACT, IN SERVICE AND WITHOUT DAMAGE.

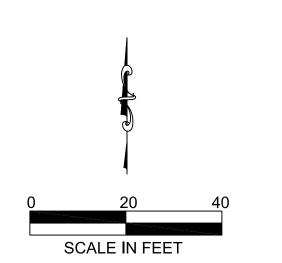

NOTES:


- 1. THE UNDERGROUND UTILITY INFORMATION AS SHOWN HEREON IS BASED, IN PART, UPON INFORMATION FURNISHED BY UTILITY COMPANIES, CITY OF MILWAUKEE, MILWAUKEE METROPOLITAN SEWERAGE DISTRICT, AND PRIVATE LOCATORS. WHILE THIS INFORMATION IS BELIEVED TO BE RELIABLE, ITS ACCURACY AND COMPLETENESS CANNOT BE GUARANTEED NOR CERTIFIED TO.
- 2. ALL EXISTING UTILITIES SHOWN ARE BASED ON FIELD MARKINGS/PRINTS PROVIDED BY DIGGER'S HOTLINE, OR RECORD DRAWINGS BY OTHERS. CONTRACTOR SHALL CONTACT DIGGER'S HOTLINE AT 811 OR 1-800-242-8511 PRIOR TO PERFORMING EARTH MOVING OR EXCAVATION ACTIVITIES. CONTRACTOR SHALL CONTACT ANY OTHER UTILITY WHICH MAY BE PRESENT WHICH ARE NOT PART OF THE ONE CALL SYSTEM.
- 3. CONTRACTOR SHALL VERIFY ALL EXISTING UTILITY LOCATIONS (VERTICALLY AND HORIZONTALLY) PRIOR TO CONSTRUCTION. ANY DISCREPANCIES SHALL BE DISCUSSED WITH THE ENGINEER.

SURVEY NOTES:

- 1. HORIZONTAL DATUM: COORDINATE SYSTEM IS ASSUMED HOLDING THE NORTH LINE OF LOT 1, CSM NO. 6980 AS ASSUMED TO BEAR N89° 36' 30"E.
- 2. VERTICAL DATUM: ELEVATIONS SHOWN ON THE PLAN ARE REFERENCED TO THE CITY OF MILWAUKEE STANDARD BENCH MARKS. CITY OF MILWAUKEE DATA ARE REFERENCED TO THE LEVEL OF THE MILWAUKEE RIVER AS IT WAS IN THE MONTH OF MARCH, 1836 A.D. ADD 580.603 TO PLACE ELEVATIONS ON THE NATIONAL GEODETIC VERTICAL DATUM (NGVD) OF 1929.

BENCHMARK TABLE

PT. NO.	NORTHING	EASTING	DESCRIPTION	ELEV.
2203	5007.292	5056.818	CP SET T	74.622
2204	5006.742	5201.200	CP SET T	79.294

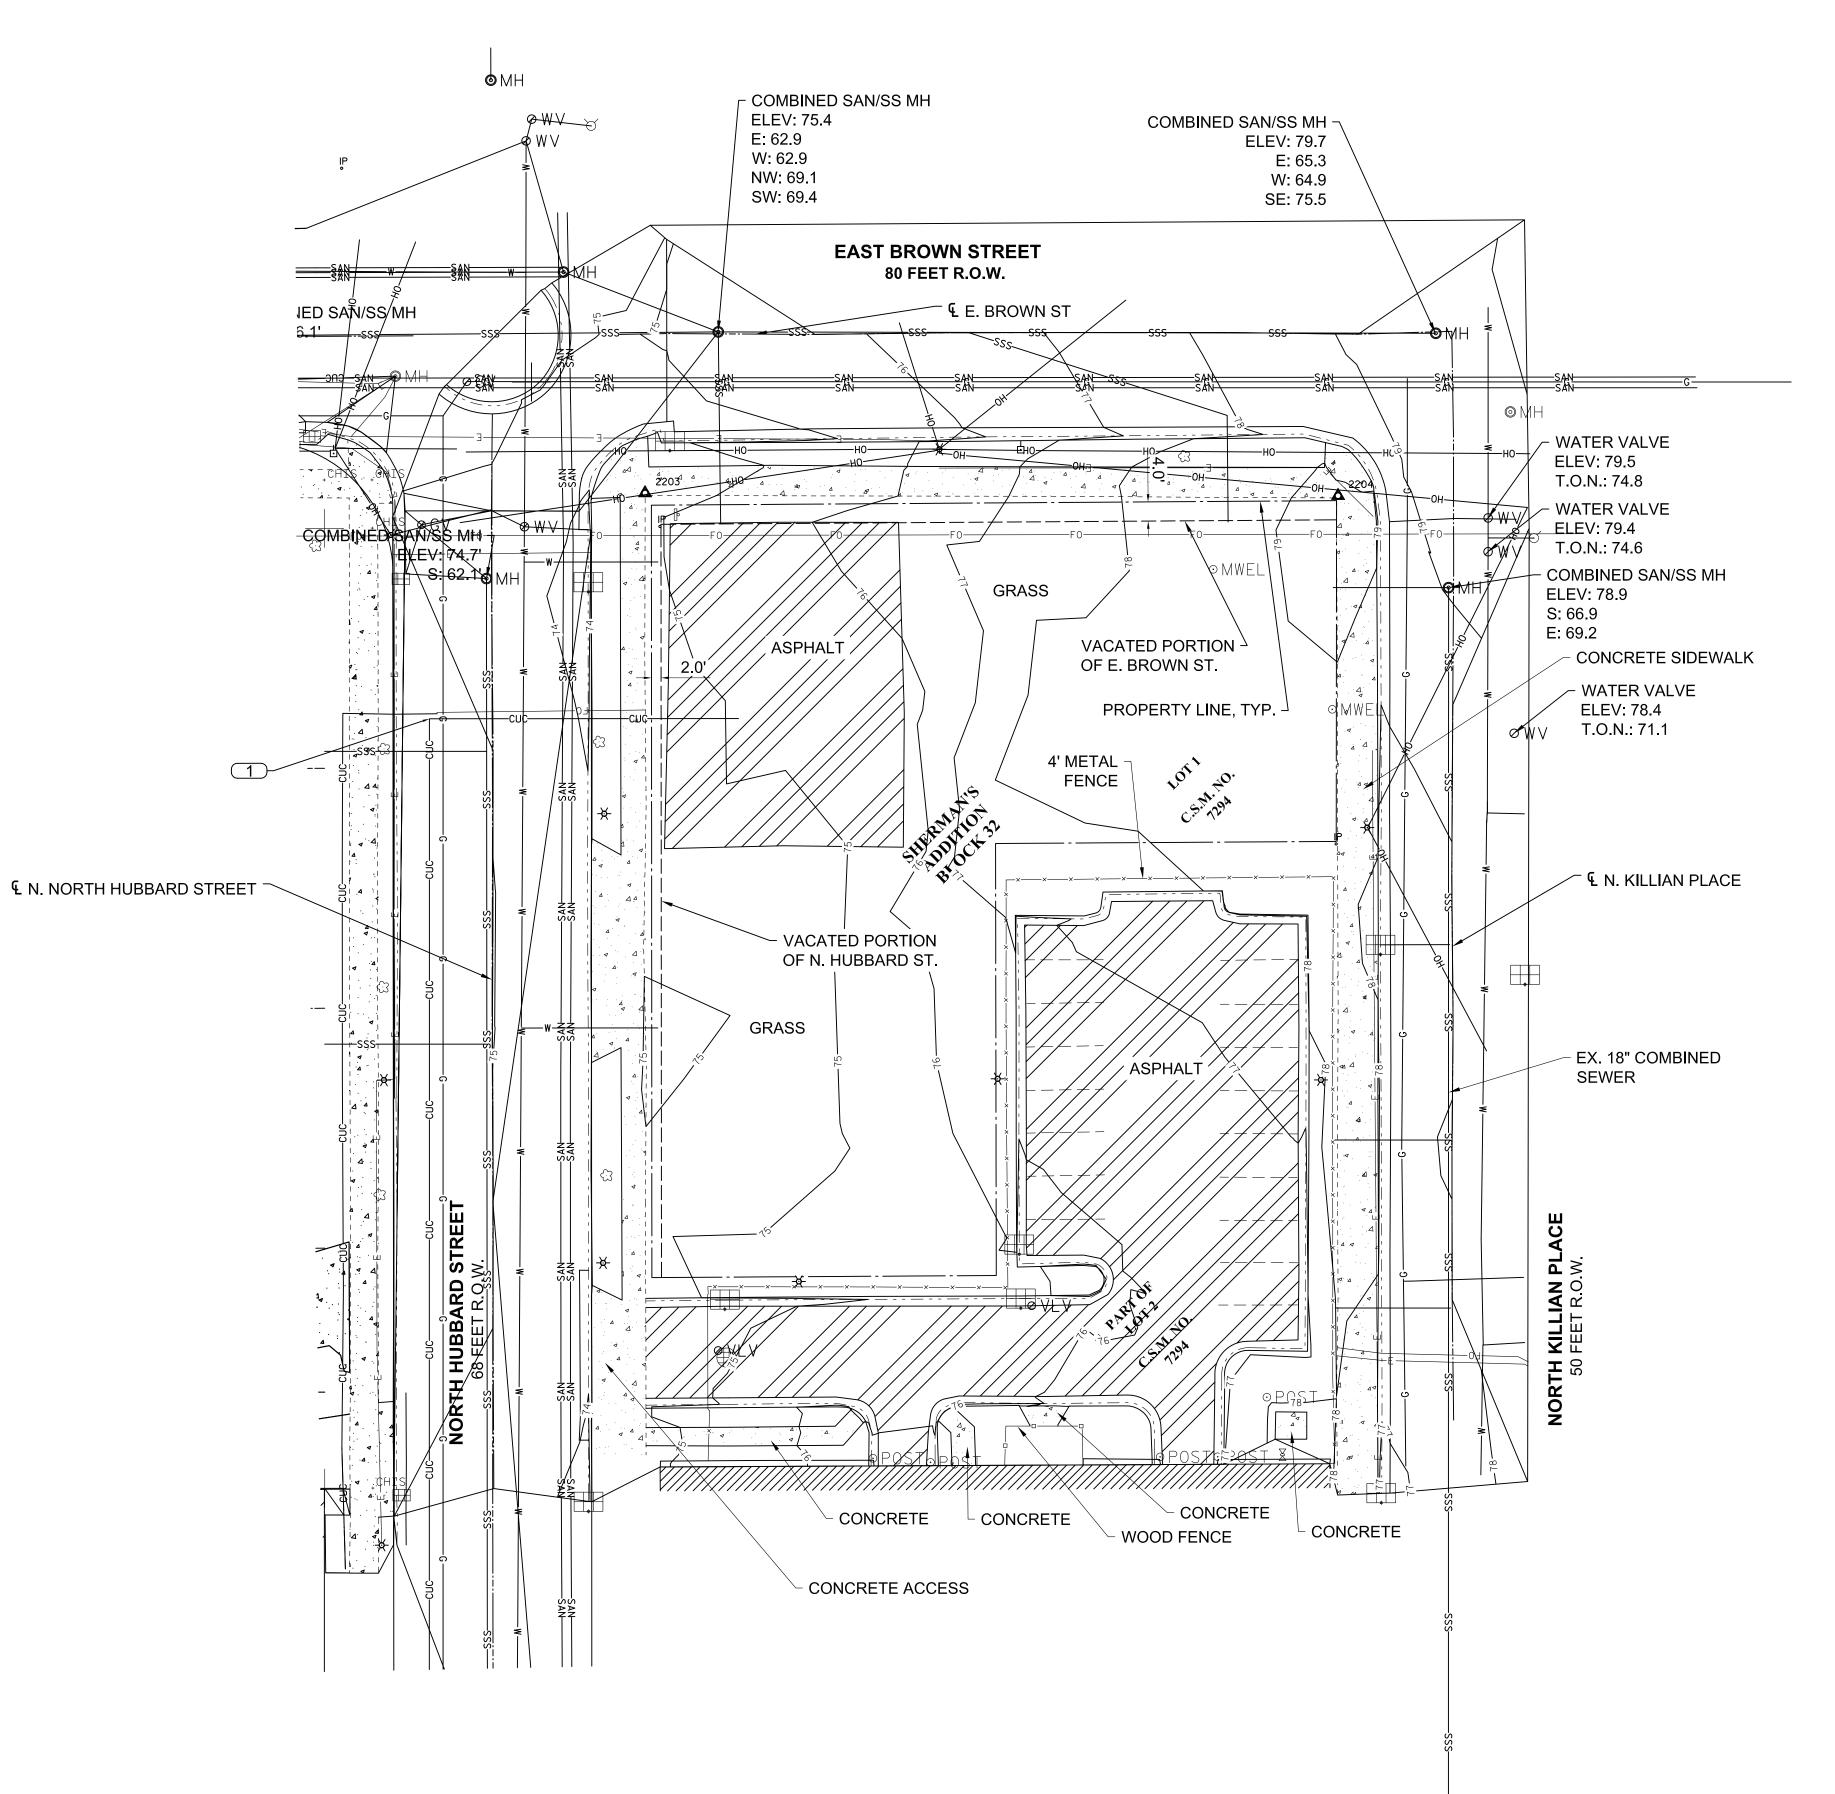



CONSULTANT

262-821-1171

CONSULTANT

CONSULTANT

ER ST.

APITAL GROUP, LLC ION: EAST BROWN ST. AND NORTH P. MILWAUKEE, WI

VISIONS DATE DESCRIPTION
01 05/11/17 CITY ZONING SUBMITTAL

CHECKED BY DATE 05/11/2017

EXISTING CONDITIONS BLOCK C

C002C

SHEET 2 of SHI


ALTA/NSPS LAND TITLE SURVEY

PREMISES KNOWN AS: LOT 2 OF CERTIFIED SURVEY MAP NO. 7294 AND VACATED PORTIONS OF EAST BROWN STREET AND NORTH HUBBARD STREET

in NE1/4 Section 20 & NW1/4 Section 21-7-23

CITY OF MILWAUKEE MILWAUKEE COUNTY, WIS.

Royal Capital Group LLC

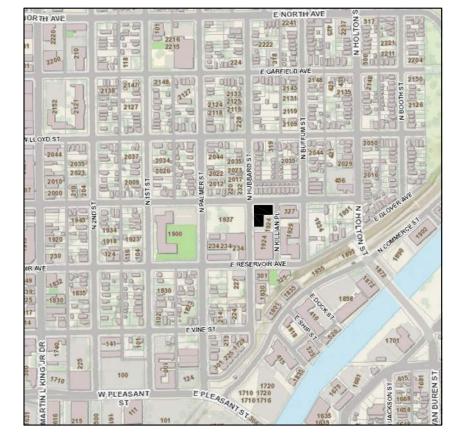

VICINITY MAP (NTS)

NOTES:

- A. Bearings shown hereon referenced to the west line of the NW1/4 Section 21, T7N, R22E, recorded by SEWRPC to bear S00°33'14"E
- B. This survey was prepared based on First American Title Insurance Company, Title Commitment No. NCS-745286-MKE dated July 01, 2015 which lists the following easements and/or restrictions.
 - Not survey related, not shown If affects site, shown on plat
 - If affects site, shown on plat
 - 4-10 Not survey related, not shown 11 Not survey related, not shown
 - Not survey related, not shown
 - Vacated areas shown on plat
 - 14-17 Not survey related, not shown
- C. The subect property is not in a 100 year flood plain. The Flood Insurance Rate Map, Community Panel No.: 55079C0091E, Zone X, effective date 9/26/2008
- D. There are zero regular and zero handicap parking spaces marked on this site.
- E. The basic zoning information listed below is taken from municipal codes and does not reflect regulations that may apply. Site is zoned PD — Planned Development District

YARD REQUIREMENTS

1. Setbacks. A planned development exceeding 5 acres in size shall provide a setback of at least 25 feet around the perimeter ot the site, unless a smaller setback is approved by the common council because adjacent buildings have setbacks that are less than 25 feet. Setback areas shall be landscaped and used only for recreation, direct access to the development, utility right—of—way, sidewalks, ponds, water detention basins and drainage channels.

– prepared by – J.K.R. SURVEYING, INC. 8121 22ND AVENUE KENOSHA, WI 53143

CERTIFIED TO: First American Title Insurance Company; Royal Capital Group LLC

This is to certify that this map or plat and the survey on which it is based were made in accordance with the 2016 Minimum Standard Detail Requirements for ALTA/NSPS Land Title Surveys, jointly established and adopted by ALTA and NSPS; including Items 1, 2, 3, 4, 6(a) 8, 9, 11, 13 of Table A thereof.


May 5, 2017 The fieldwork was completed on... May 10, 2017 Date of plat:....

JEFFREY K. RAMPART

WISCONSIN REGISTERED LAND SURVEYOR License No.....S-2141

Dated.... Phone 262-652-8110 Fax 262-652-9695

Email: jeff@jkrsurveying.com

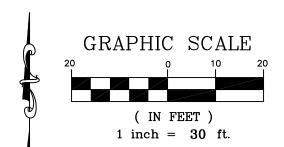

LEGEND

+ CHISELED CROSS ── W ── UG WATER ROUND INLET INLET / CATCH BASIN — OH— OVERHEAD UG FIBER OPTIC UG TELEPHONE — SAN— UG SANITARY SEWER
— SSS— UG COMBINED SEWER CONCRETE BLDG BUILDING

LEGAL DESCRIPTION (AS FURNISHED)....

Lot 2 Certified Survey Map No. 7294 recorded in the office of the Register of Deeds for Milwaukee County, Wisconsin, on September 30, 2003, in Reel 5678, Images 3792-3795 inclusive, as Document No. 8638882, being a redivision of lots 1—13 of the Resubdivision of Block 32, Sherman's Addition and a part of Block 13, Park Addition all being a part of the SE1/4 of the NE1/4 of Section 20, and the SW1/4 of the NW1/4 of Section 21, Township 7 North, Range 22 East, City of Milwaukee, Milwaukee County, Wisconsin, together with that part of vacated East Brown Street and North Hubbard Street adjacent thereto.

LAND AREA - 16,577 S.F.

Property Address: 301 E. Brown Street Milwaukee, WI

Tax Key Number: 353-1512-100-9

NW COR. SECTION 21-2-22 (concrete monument) The Homes at Brewers Hill Commons E. Brown Street (76' wide) vacated portion of —East Brown Street per File No. 021642 vacant land 70.98 x — | x fence x — x vacated portion of North Hubbard Street per File No. 021642 INCLUDED Street

DRAWN BY JKR 05/11/2017 CHECKED BY 05/11/2017

PROJE(

PROJECT

3636 North 124th Street Wauwatosa, WI 53222

262-821-1171

CONSULTANT

TITLE SURVEY

ALTA/NSPS LAND

VELOPMENT

BREWER

ALTA/NSPS LAND TITLE SURVEY

SHEET TITLE

AS101D30


SHEET # 1 SHEET # 1


EROSION CONTROL NOTES


- CONSTRUCTION SITE EROSION CONTROL AND SEDIMENTATION CONTROL SHALL COMPLY WITH THE REQUIREMENTS OF THE CITY OF MILWAUKEE AND EMPLOY EROSION CONTROL METHODS AS SHOWN IN THE DEPARTMENT OF NATURAL RESOURCES TECHNICAL STANDARDS WHICH CAN BE FOUND AT: http://dnr.wi.gov/topic/stormwater/standards/const_standards.html
- 2. ALL EROSION CONTROL MEASURES SHALL BE ADJUSTED TO MEET FIELD CONDITIONS AT THE TIME OF CONSTRUCTION AND SHALL BE INSTALLED PRIOR TO ANY GRADING OR DISTURBANCE OF EXISTING SURFACE MATERIAL ON THE
- ALL EROSION AND SEDIMENT CONTROL MEASURES SHALL BE CHECKED FOR STABILITY AND OPERATION AFTER A RAINFALL OF 0.5" OR MORE, BUT NO LESS THAN ONCE EVERY WEEK. CONTRACTOR SHALL BE RESPONSIBLE FOR CLEAN UP AND REMOVAL OF ALL SEDIMENT AND ALL SEDIMENT CONTROL STRUCTURES. EROSION CONTROL MEASURES MUST BE IN WORKING CONDITION AT END OF EACH DAY. ALL RECORDS OF THE INSPECTION AND MAINTENANCE OF EROSION CONTROL MEASURES SHALL BE KEPT BY THE OWNER'S REPRESENTATIVE RESPONSIBLE FOR **EROSION CONTROL INSPECTIONS.**
- 4. INSPECT AND MAINTAIN ALL INSTALLED EROSION CONTROL PRACTICES UNTIL CONTRIBUTING DRAINAGE AREA HAS BEEN STABILIZED.
- 5. SILT FENCE SHALL BE INSTALLED IN HORSESHOE FASHION AROUND ALL TOPSOIL AND FILL STOCKPILES.
- 6. ALL OFF-SITE SEDIMENT DEPOSITS FROM THIS PROJECT OCCURRING AS RESULT OF A STORM EVENT SHALL BE CLEANED UP BY END OF NEXT WORKING DAY. ALL OTHER OFF-SITE SEDIMENT DEPOSITS OCCURRING AS RESULT OF CONSTRUCTION ACTIVITIES SHALL BE CLEANED UP BY END OF THE WORK DAY.
- CONSTRUCTION SEQUENCE FOR EROSION CONTROL INCLUDES:
- 7.1. INSTALL SILT FENCE.
- 7.2. INSTALL INLET PROTECTION ON EXISTING STORM
- INLETS. INSTALL STABILIZED CONSTRUCTION ENTRANCE/EXIT.
- STRIP TOPSOIL, REMOVE AND/OR STOCKPILE.
- 7.5. PERFORM ROUGH GRADING.
- INSTALL UTILITIES.
- INSTALL INLET PROTECTION.
- CONSTRUCT BUILDINGS. 7.9. INSTALL PAVEMENTS.
- 7.10. REMOVE ACCUMULATED SEDIMENT FROM SITE.
- 7.11. REMOVE EROSION CONTROL MEASURES ONLY WHEN
- SITE IS FULLY STABILIZED.
- 8. ALL EXPOSED SOIL AREAS NOT DISTURBED FOR UP TO SEVEN DAYS MUST BE IMMEDIATELY RESTORED WITH SEED AND MULCH.
- 9. IMMEDIATELY STABILIZE ALL DISTURBED AREAS THAT WILL REMAIN INACTIVE FOR 14 DAYS OR LONGER. BETWEEN SEPTEMBER 15 AND OCTOBER 15: STABILIZE WITH MULCH. TACKIFIER, AND A PERENNIAL SEED MIXED WITH WINTER WHEAT, ANNUAL OATS OR ANNUAL RYE, AS APPROPRIATE FOR REGION AND SOIL TYPE. OCTOBER 15 THROUGH COLD WEATHER: STABILIZE WITH A POLYMER AND DORMANT SEED MIX, AS APPROPRIATE FOR REGION AND SOIL TYPE.
- 10. RESTORATION OF ALL DISTURBED AREAS WITH SLOPES GREATER THAN 20% SHALL BE COMPLETED WITHIN 30 DAYS AFTER BEGINNING CONSTRUCTION ON SAID AREA.
- 11. SWEEP/CLEAN UP ALL SEDIMENT/TRASH THAT MOVES OFF-SITE DUE TO CONSTRUCTION ACTIVITY OR STORM EVENTS BEFORE THE END OF THE SAME WORKDAY OR AS DIRECTED BY CITY OF MILWAUKEE/OWNER/ OR ENGINEER. SEPARATE SWEPT MATERIALS (SOILS AND TRASH) AND DISPOSE OF APPROPRIATELY.
- 12. CONTRACTOR IS RESPONSIBLE FOR CONTROLLING DUST PER WDNR TECHNICAL STANDARD #1068 DUST CONTROL FOR CONSTRUCTION SITES.
- 13. PROPERLY DISPOSE OF ALL WASTE AND UNUSED BUILDING MATERIALS (INCLUDING GARBAGE, DEBRIS, CLEANING WASTES, OR OTHER CONSTRUCTION MATERIALS) AND DO NOT ALLOW THESE MATERIALS TO BE CARRIED BY RUNOFF INTO RECEIVING CHANNEL.
- 14. IF DEWATERING IS NEEDED, CONTRACTOR SHALL PROVIDE FOR SEDIMENT REMOVAL ACCORDING TO WDNR TECHNICAL STANDARD #1061. WATER PUMPED FROM THE SITE SHALL BE TREATED BY TEMPORARY SEDIMENTATION BASINS, GRIT CHAMBERS, SAND FILTERS, UPSLOPE CHAMBERS, HYDRO-CYCLONES, SWIRL CONCENTRATORS, OR OTHER APPROPRIATE CONTROLS. WATER MAY NOT BE DISCHARGED IN A MANNER THAT CAUSES EROSION OF THE SITE OR RECEIVING CHANNELS.
- 15. PROVIDE ANTI-SCOUR PROTECTION AND MAINTAIN NON-EROSIVE FLOW DURING DEWATERING, LIMIT PUMPING RATES, OR THE BASIN DESIGN RELEASE RATE WITH THE CORRECTLY FITTED HOSE AND GEOTEXTILE FILTER BAG. PERFORM DEWATERING OF ACCUMULATED SURFACE RUNOFF IN ACCORDANCE WITH WDNR TECHNICAL STANDARD #1061 DEWATERING.

- 16. FOR NON-CHANNELIZED FLOW ON DISTURBED OR CONSTRUCTED SLOPES, PROVIDE CLASS 1 TYPE B EROSION CONTROL MATTING. SELECT EROSION MATTING FROM APPROPRIATE MATRIX IN WISDOT'S PRODUCT ACCEPTABILITY LIST (PAL); INSTALL AND MAINTAIN PER WDNR TECHNICAL STANDARD #1052 NON-CHANNEL EROSION
- 17. MAKE PROVISIONS FOR WATERING DURING THE FIRST 8 WEEKS FOLLOWING SEEDING OR PLANTING OF DISTURBED AREAS WHENEVER MORE THAN 7 CONSECUTIVE DAYS OF DRY WEATHER OCCUR.
- 18. INSTALL ADDITIONAL EROSION AND SEDIMENT CONTROL MEASURES (SUCH AS TEMPORARY SEDIMENT BASINS, DITCH CHECKS, EROSION CONTROL MATTING, SILT FENCING, FILTER SOCKS, WATTLES, SWALES, ETC.) AS NEEDED OR AS DIRECTED BY CITY OF MILWAUKEE.
- 19. CONTRACTOR IS RESPONSIBLE FOR COMPLYING WITH ALL APPLICABLE WDNR REMEDIATION AND WASTE MANAGEMENT REQUIREMENTS FOR HANDLING AND DISPOSING OF CONTAMINATED MATERIALS. SITE-SPECIFIC INFORMATION FOR AREAS WITH KNOWN OR SUSPECTED SOIL AND/OR GROUNDWATER CONTAMINATION CAN BE FOUND ON WDNR'S BUREAU OF REMEDIATION AND REDEVELOPMENT TRACKING SYSTEM (BRRTS) PUBLIC DATABASE AT http://dnr.wi.gov/topic/brownfields/botw.html
- 20. GRADING CONTRACTOR SHALL BE RESPONSIBLE FOR PROTECTION OF EXISTING PROPERTY CORNERS AND PERTINENT AREAS WITHIN ALL EASEMENTS.
- 21. CONTRACTOR IS RESPONSIBLE TO INSTALL ALL EROSION CONTROL DEVICES SHOWN ON THE PLANS IN ACCORDANCE WITH THE WDNR BEST MANAGEMENT PRACTICES.
- 22. PARKING LOTS AND DRIVES SHALL BE CLEANED DAILY AS NEEDED. STREET SWEEPING SHALL BE COMPLETED TO MAINTAIN THE PUBLIC STREET FREE OF DUST AND DIRT.
- 23. CONTRACTOR SHALL SEED & MULCH ALL DISTURBED AREAS WITHIN 7 DAYS.
- 24. SEE LANDSCAPING PLAN FOR RESTORATION.

ANTICIPATED START OF CONSTRUCTION: XX ANTICIPATED CONSTRUCTION DURATION: XX MONTHS ANTICIPATED END OF CONSTRUCTION: XX

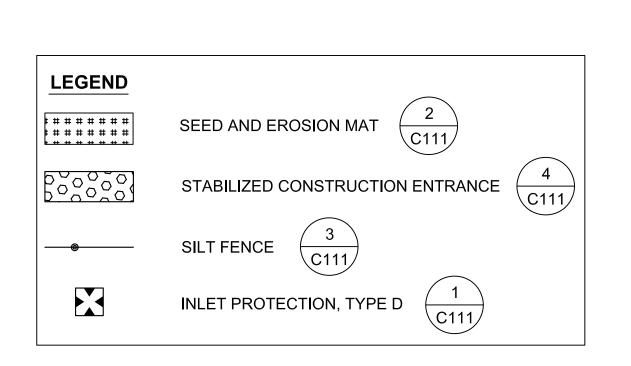

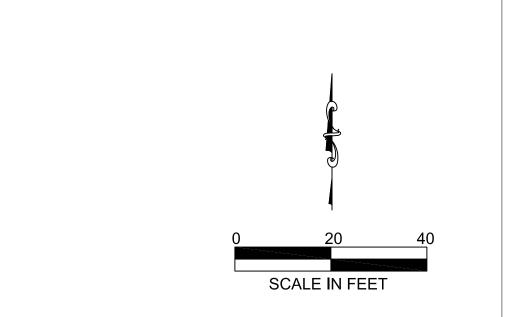

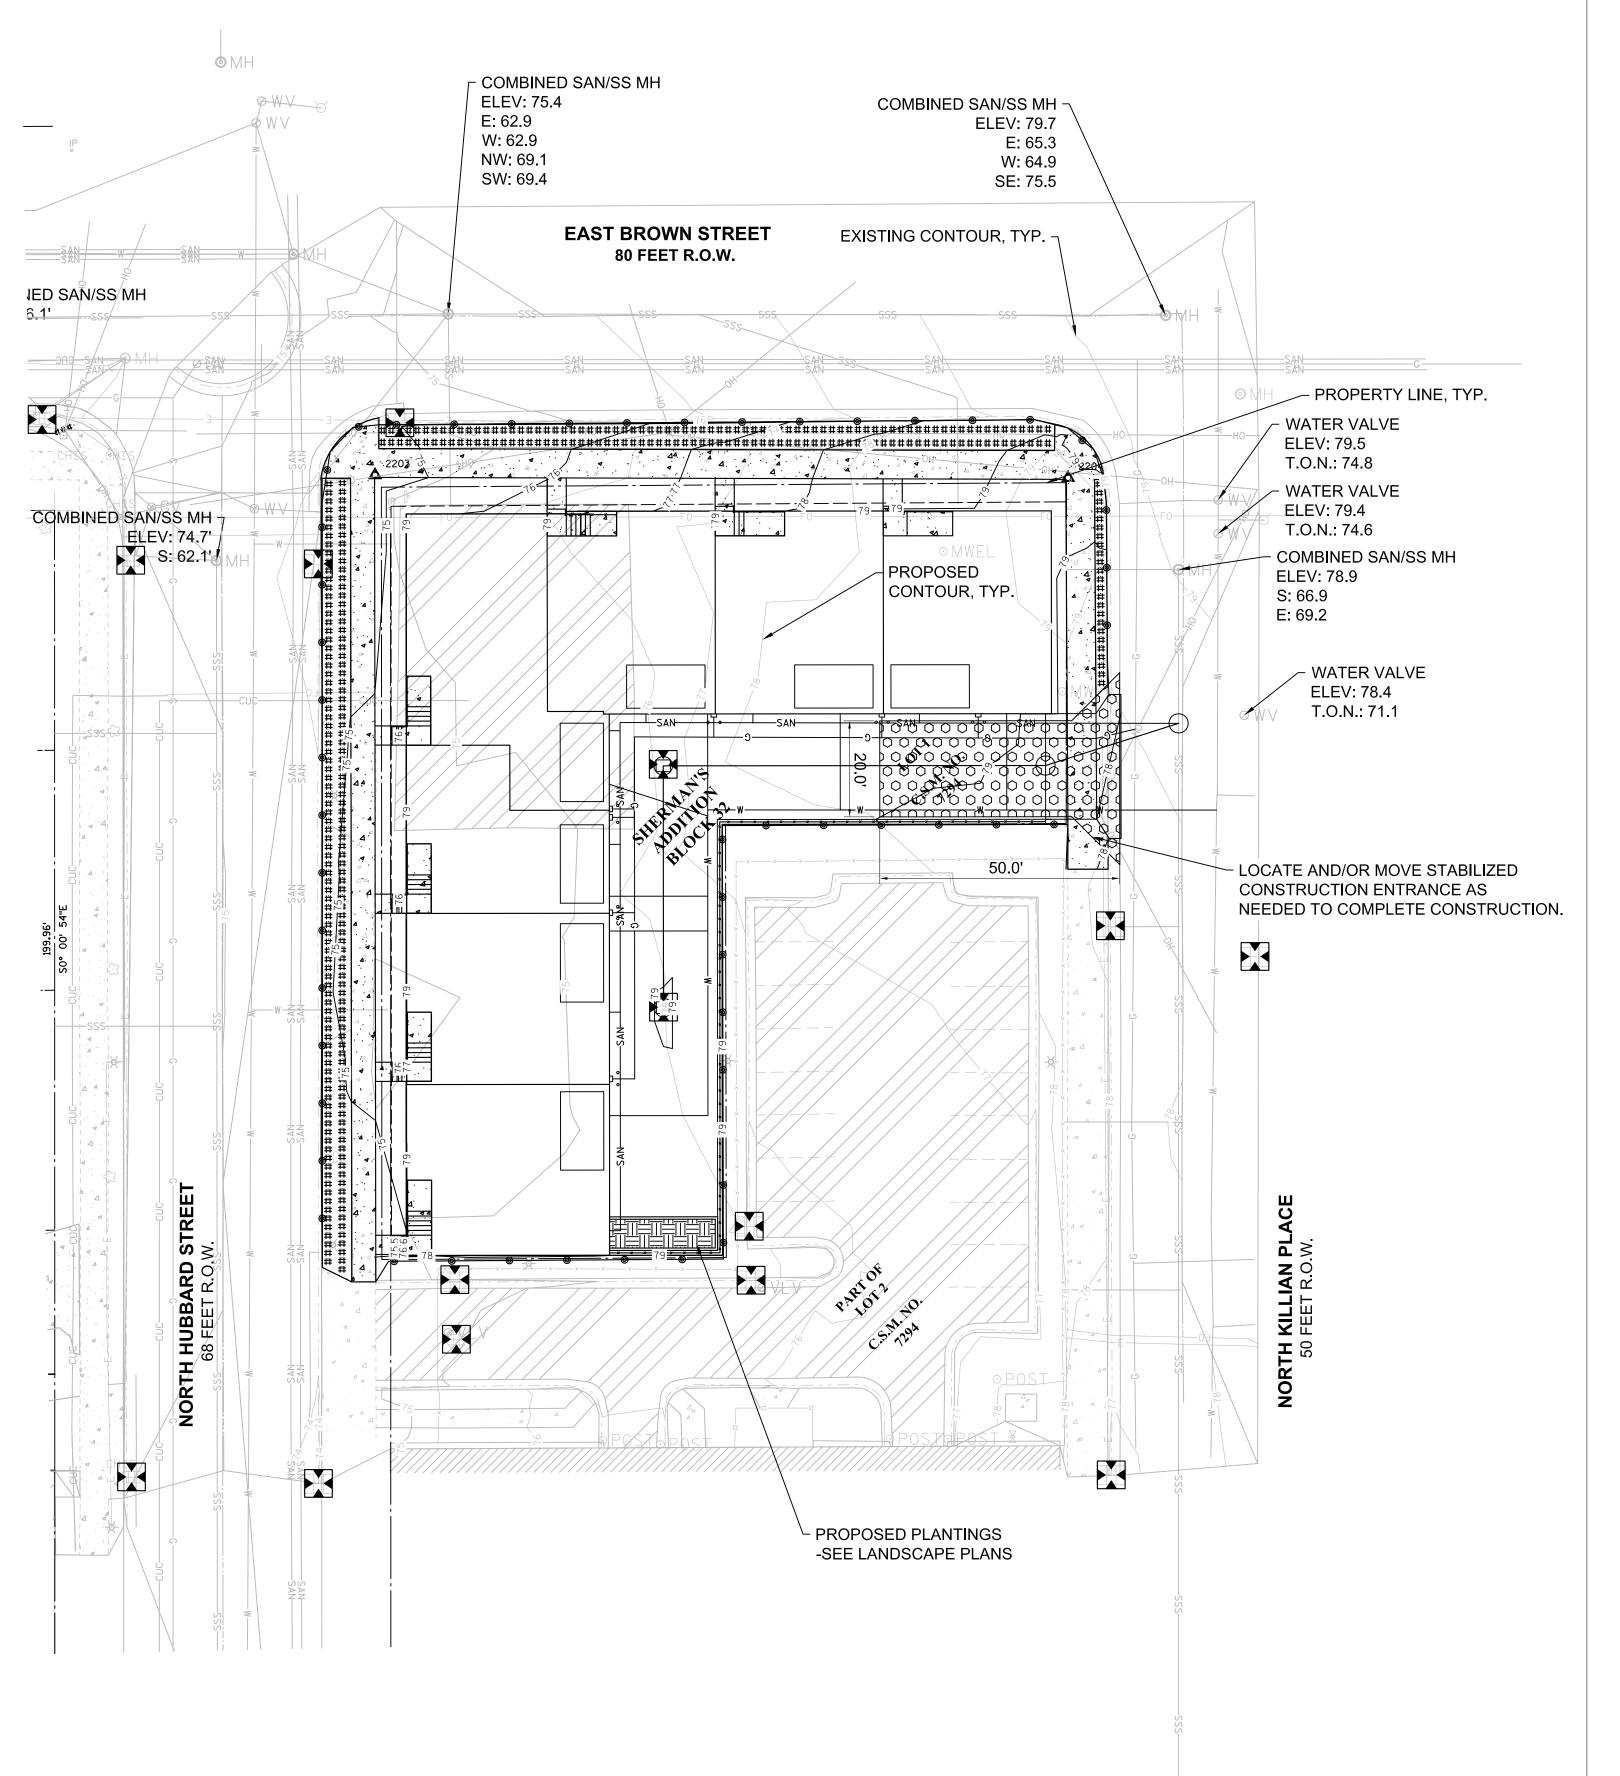



Wauwatosa, WI 53222 262-821-1171

CONSULTANT

CONSULTANT

CONSULTANT

Ö

OSION

 \bigcirc

ST


BROWN'AUKEE, '

DESCRIPTION 05/11/17 CITY ZONING SUBMITTAL 05/11/2017 CHECKED BY DATE

EROSION CONTROL PLAN BLOCK C

05/11/2017

C110C

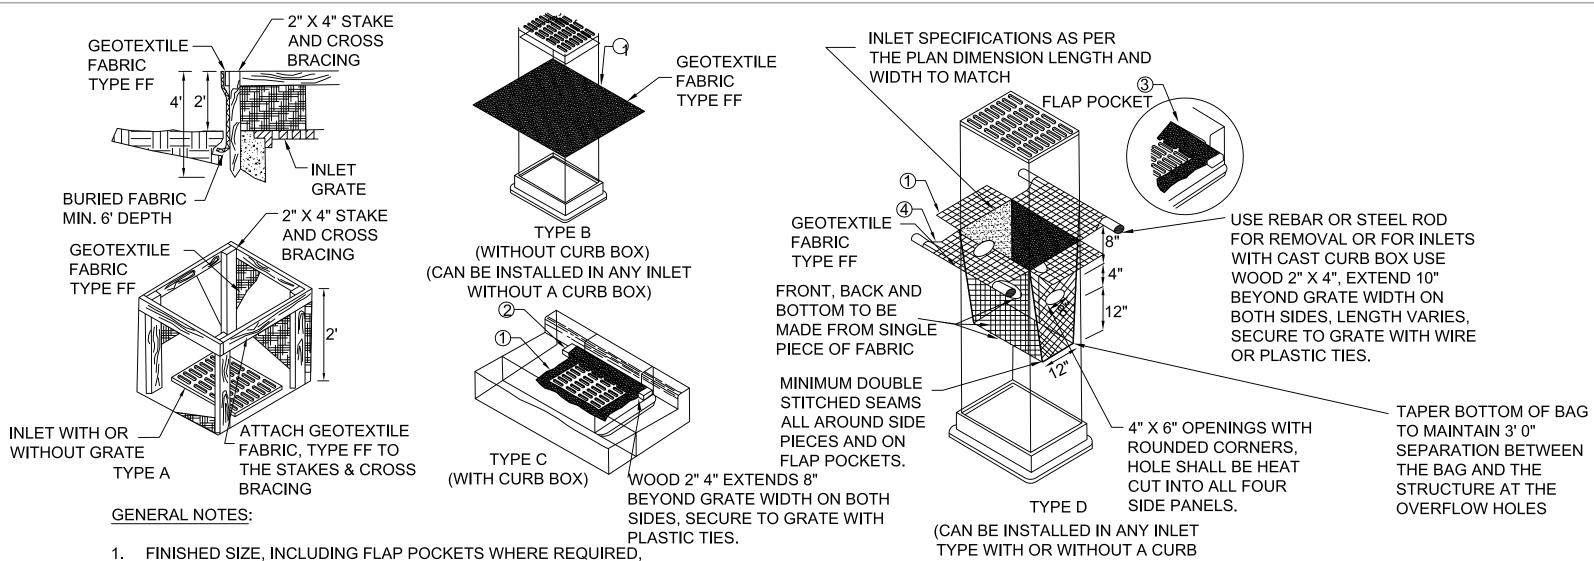

- SHALL EXTEND A MINIMUM OF 10" AROUND THE PERIMETER TO FACILITATE MAINTENANCE OR REMOVAL.
- 2. FOR INLET PROTECTION, TYPE C (WITH CURB BOX) AN ADDITIONAL 18" OF FABRIC IS WRAPPED AROUND THE WOOD AND SECURED WITH STAPLES. THE WOOD SHALL NOT BLOCK THE ENTIRE HEIGHT OF THE CURB BOX OPENING.
- 3. FLAP POCKETS SHALL BE LARGE ENOUGH TO ACCEPT WOOD 2"X4". THE REBAR, STEEL PIPE OR WOOD SHALL BE INSTALLED IN THE REAR FLAP AND SHALL NOT BLOCK THE TOP HALF OF THE CURB FACE OPENING.
- 4. FRONT LIFTING FLAP IS TO BE USED WHEN REMOVING AND MAINTAINING FILTER BAG.
- 5. INLET PROTECTION DEVICES SHALL BE MAINTAINED OR REPLACED AT THE DIRECTION OF THE ENGINEER.
- 6. MANUFACTURED ALTERNATIVES APPROVED AND LISTED ON THE DEPARTMENT'S EROSION CONTROL PRODUCT ACCEPTABILITY LIST MAY BE SUBSTITUTED.
- 7. WHEN REMOVING OR MAINTAINING INLET PROTECTION, CARE SHALL BE TAKEN SO THAT THE SEDIMENT TRAPPED ON THE GEOTEXTILE FABRIC DOES NOT FALL INTO THE INLET. ANY MATERIAL FALLING INTO THE INLET SHALL BE REMOVED IMMEDIATELY.

TYPE B & C


INSTALLATION NOTES

- 1. TYPE FF GEOTEXTILE FABRIC (EXTEND FABRIC A MINIMUM OF 10" AROUND GRATE PERIMETER FOR MAINTENANCE OR REMOVAL.
- 2. THE CONTRACTOR SHALL DEMONSTRATE A METHOD OF MAINTENANCE, USING A SEWN FLAP, HAND HOLDS OR OTHER METHOD TO PREVENT ACCUMULATED SEDIMENT FROM ENTERING THE INLET.

TYPE D

- 1. DO NOT INSTALL INLET PROTECTION TYPE D IN INLETS SHALLOWER THAN 30", MEASURED FROM THE BOTTOM OF THE INLET TO THE TOP OF THE GRATE.
- 2. THE INSTALLED BAG SHALL HAVE A MINIMUM SIDE CLEARANCE, BETWEEN THE INLET WALLS AND THE BAG, MEASURED AT THE BOTTOM OF THE OVERFLOW HOLES, OF 3", WHERE NECESSARY THE CONTRACTOR SHALL CINCH THE BAG, USING PLASTIC ZIP TIES, TO ACHIEVE THE 3" CLEARANCE, THE TIES SHALL BE PLACED AT A MAXIMUM OF 4" FROM THE BOTTOM OF THE BAG.




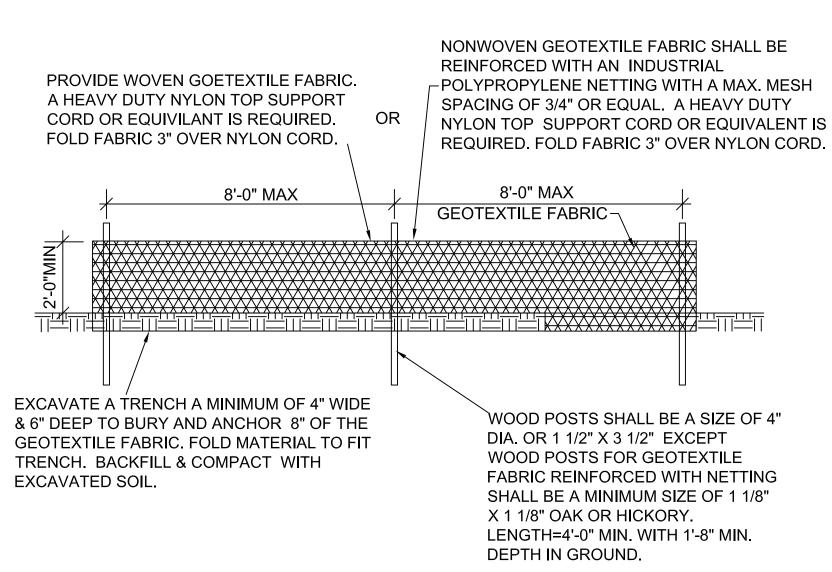


NOTES:


- 1. CONTRACTOR SHALL INSPECT SILT FENCE DAILY AND REPAIR OR REPLACE AS NEEDED. SEDIMENT SHALL BE REMOVED AND PROPERLY DISPOSED OF WHEN DEPOSITS REACH 1/2 THE HEIGHT OF THE FENCE.
- 2. ATTACH THE FABRIC TO THE POSTS WITH WIRE STAPLES OR WOODEN LATH AND NAILS.



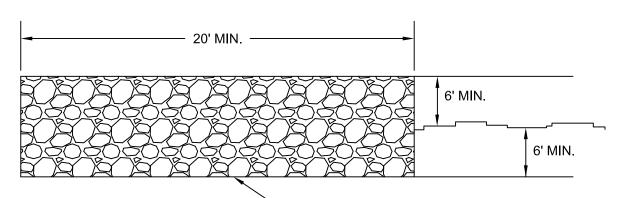

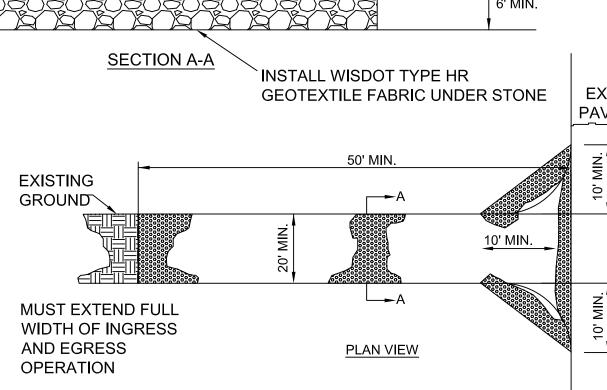

- 1. TRACKING MATS SHALL BE INSPECTED DAILY. DEFICIENT AREAS SHALL BE REPAIRED OR REPLACED IMMEDIATELY.
- LEAST 12" DEEP OVER THE LENGTH AND WIDTH OF ENTRANCE).
- 3. SURFACE WATER ALL SURFACE WATER FLOWING TO OR PIPED THROUGH THE ENTRANCE MAINTAINING POSITIVE DRAINAGE. PIPE INSTALLED THROUGH THE STABILIZED CONSTRUCTION ENTRANCE SHALL BE PROTECTED WITH A STONE OVER THE PIPE TO BE SIZED ACCORDING TO THE DRAINAGE. WHEN THE SCE IS LOCATED AT A HIGH SPOT AND HAS NO DRAINAGE TO CONVEY, A PIPE WILL NOT BE NECESSARY. PIPE SHOULD BE SIZED ACCORDING TO THE BE REQUIRED.
- 4. LOCATION A STABILIZED CONSTRUCTION ENTRANCE SHALL BE LOCATED AT EVERY POINT WHERE CONSTRUCTION TRAFFIC ENTERS OR LEAVES A CONSTRUCTION SITE. VEHICLES LEAVING THE SITE MUST TRAVEL OVER THE ENTIRE LENGTH OF THE STABILIZED CONSTRUCTION

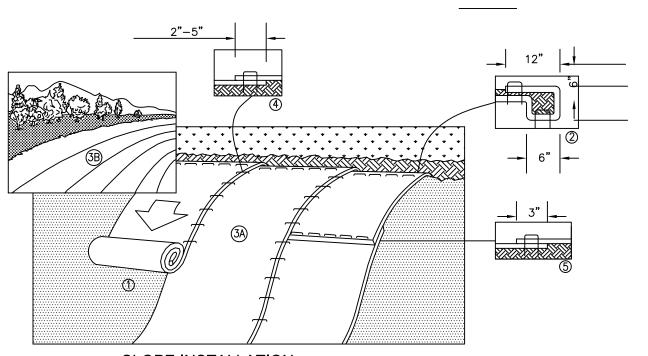

SLOPE INSTALLATION 1. PREPARE SOIL BEFORE INSTALLING BLANKETS, INCLUDING ANY NECESSARY APPLICATION OF LIME, FERTILIZER, AND

SEED. 2. BEGIN AT THE TOP OF THE SLOPE BY ANCHORING THE BLANKET IN A 6" (15CM) DEEP X 6" (15CM) WIDE TRENCH WITH APPROXIMATELY 12" (30CM) OF BLANKET EXTENDED BEYOND THE UP-SLOPE PORTION OF THE TRENCH. ANCHOR THE

BLANKET WITH A ROW OF STAPLES/STAKES APPROXIMATELY 12" (30CM) APART IN THE BOTTOM OF THE TRENCH. BACKFILL AND COMPACT THE TRENCH AFTER STAPLING. APPLY SEED TO COMPACTED SOIL AND FOLD REMAINING 12" (30CM) PORTION OF BLANKET BACK OVER SEED AND COMPACTED SOIL. SECURE BLANKET OVER COMPACTED SOIL WITH A ROW OF STAPLES/STAKES SPACED APPROXIMATELY 12" (30CM) APART ACROSS THE WIDTH OF THE BLANKET.

3. ROLL THE BLANKETS (A.) DOWN OR (B.) HORIZONTALLY ACROSS THE SLOPE. BLANKETS WILL UNROLL WITH APPROPRIATE SIDE AGAINST THE SOIL SURFACE. ALL BLANKETS MUST BE SECURELY FASTENED TO SOIL SURFACE BY PLACING STAPLES/STAKES IN APPROPRIATE LOCATIONS AS SHOWN IN THE STAPLE PATTERN GUIDE. WHEN USING OPTIONAL DOT SYSTEM, STAPLES/STAKES SHOULD BE PLACED THROUGH EACH OF THE COLORED DOTS CORRESPONDING TO THE APPROPRIATE STAPLE PATTERN.

4. THE EDGES OF PARALLEL BLANKETS MUST BE STAPLED WITH APPROXIMATELY 2"-5" (5CM-12.5CM) OVERLAP DEPENDING ON BLANKET TYPE. TO ENSURE PROPER SEAM ALIGNMENT, PLACE THE EDGE OF THE OVERLAPPING BLANKET (BLANKET BEING INSTALLED ON TOP) EVEN WITH THE COLORED SEAM STITCH ON THE PREVIOUSLY INSTALLED BLANKET.

5. CONSECUTIVE BLANKETS SPLICED DOWN THE SLOPE MUST BE PLACED END OVER END (SHINGLE STYLE) WITH AN APPROXIMATE 3" (7.5CM) OVERLAP. STAPLE THROUGH OVERLAPPED AREA, APPROXIMATELY 12" (30CM) APART ACROSS ENTIRE BLANKET WIDTH.

NOTES:


TRACKING MAT

EGRESS POINTS

FOR CONSTRUCTION

- 1. INSTALLATION TO BE COMPLETED IN ACCORDANCE WITH MANUFACTURER'S SPECIFICATIONS.
- 2. DO NOT SCALE DRAWINGS.
- 3. IN LOOSE SOIL CONDITIONS THE USE OF STAPLE OR STAKE LENGTHS GREATER THAN 6" (15CM) MAY BE NECESSARY TO PROPERLY SECURE THE BLANKETS.



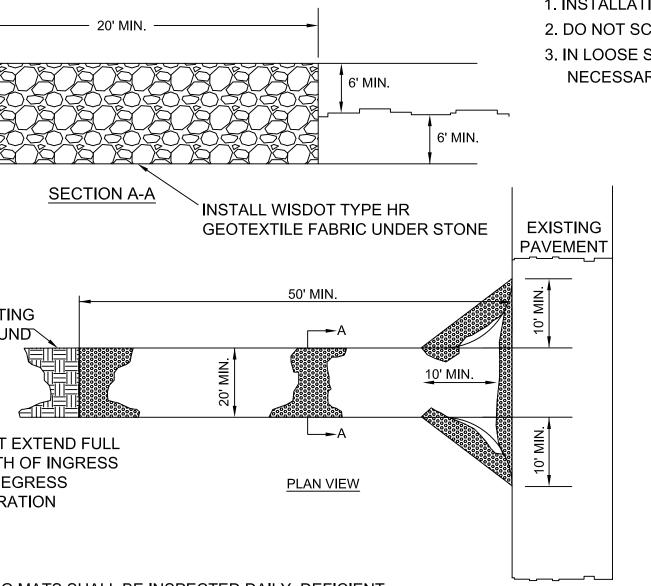

- 2. STONE CLEAR OR WASHED (3"-6" SHALL BE PLACED AT
- DIVERTED TOWARD CONSTRUCTION ENTRANCES SHALL BE MOUNTABLE BERM WITH 5:1 SLOPES AND MINIMUM OF 6" OF AMOUNT OF RUNOFF TO BE CONVEYED. A 6" MINIMUM WILL
- ENTRANCE.





3636 North 124th Street Wauwatosa, WI 53222 262-821-1171

CONSULTANT

CONSULTANT

CONSULTANT

. S BROWN AUKEE,

DESCRIPTION

05/11/17 | CITY ZONING SUBMITTAL 05/11/2017 CHECKED BY DATE 05/11/2017

EROSION CONTROL DETAILS BLOCK C

GENERAL NOTES:

- 1. ALL DIMENSIONS AND CURB RADII ARE TO THE FACE OF CURB, EDGE OF PAVEMENT, FACE OF BUILDING OR PROJECT WORK LIMIT; UNLESS STATED OTHERWISE.
- 2. CONTRACTOR TO ENSURE THAT ALL EXTERIOR CONCRETE SLABS ARE BROOM FINISHED.
- 3. REFER TO LANDSCAPE PLANS FOR RESTORATION IN LANDSCAPED AREAS.

BUILDING USE & HEIGHT:

BUILDING USE = MULTIFAMILY RESIDENTIAL
BUILDING HEIGHT = 2 STORIES, 28'-8" ABOVE GRADE AT HIGHEST POINT

BUILDING AREA:

BUILDING - FIRST FLOOR AREA: 9,900 S.F.

TOTAL FIRST FLOOR AREA: 9,900 S.F.

SITE DATA:

TOTAL AREA OF LOTS = 16,577, S.F. = 0.38 ACRES
TOTAL DISTURBED AREA (PROJECT LIMITS) = 22,500 S.F. = 0.52 ACRES
IMPERVIOUS AREA BEFORE CONSTRUCTION = 3,300 S.F. = 0.076 ACRES
IMPERVIOUS AFTER CONSTRUCTION = 14,740 S.F. = 0.34 ACRES
IMPERVIOUS INCREASE = 11,440 S.F. = 0.26 ACRES

GREEN SPACE:

LOT:
AREA = 16,577 S.F.
GREEN SPACE = 1,837 S.F.
11.1% GREEN SPACE

PARKING DATA:

TOTAL GARAGES = 7

PARCEL ADDRESS: 301 E. BROWN STREET MILWAUKEE, WI 53202

ZONING


CURRENTLY: PLANNED DEVELOPMENT (PD)
PROPOSED: PLANNED DEVELOPMENT (PD)

PLAN NOTES:

- 1. CITY UNDERGROUND CONDUIT (CUC) SHALL REMAIN IN SERVICE. THIS CUC PACKAGE SHALL NOT BE EXPOSED OR UNDERMINED DURING THE CONSTRUCTION OF THE BLOCK B EAST AMD WEST BUILDINGS INCLUDING THE SEWER LATERALS, WATER LATERALS, SIDEWALK AND/OR DRIVEWAYS. THE CONTRACTOR SHALL TAKE ALL NECESSARY PRECAUTIONS INCLUDING TIGHT SHEATHING TO ENSURE THE CUC PACKAGE REMAINS INTACT, IN SERVICE AND WITHOUT DAMAGE.
- 2. 5" CONCRETE SIDEWALK, SEE DETAIL 1, SHEET C501C.
- 3. 7" THICK CONCRETE SLABS AT DRIVEWAY APPROACHES, SEE DETAIL 3, SHEET C501C.
- 4. R1-1 STOP SIGN SIZE 6, TUBULAR STEEL POST, SEE DETAIL 1, SHEET C504C.
- 5. HMA PAVEMENT CONSISTS OF 4" OF ASPHALTIC PAVEMENT TYPE E-1 ON 4" OF DENSE GRADED 1 1/4-INCH ON 8" DENSE GRADED 3-INCH, SEE DETAIL 2, SHEET C501C.

9. 6-INCH VERTICAL CONCRETE CURB, SEE DETAIL 4, SHEET C502C.

- 6. CONCRETE STEPS, SEE DETAIL 4, SHEET C501C.
- 7. BOLLARD (TYP.), SEE DETAIL 3, SHEET C502C.
- 8. MODULAR BLOCK WALL, SEE DETAIL 1, SHEET C502C.

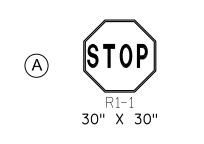

SIGN KEY:


LEGEND



SURVEY NOTES:

- 1. HORIZONTAL DATUM: COORDINATE SYSTEM IS ASSUMED HOLDING THE NORTH LINE OF LOT 1, CSM NO. 6980 AS ASSUMED TO BEAR N89 $^\circ$ 36' 30"E.
- 2. VERTICAL DATUM: ELEVATIONS SHOWN ON THE PLAN ARE REFERENCED TO THE CITY OF MILWAUKEE STANDARD BENCH MARKS. CITY OF MILWAUKEE DATA ARE REFERENCED TO THE LEVEL OF THE MILWAUKEE RIVER AS IT WAS IN THE MONTH OF MARCH, 1836 A.D. ADD 580.603 TO PLACE ELEVATIONS ON THE NATIONAL GEODETIC VERTICAL DATUM (NGVD) OF 1929.

0 20 40
SCALE IN FEET

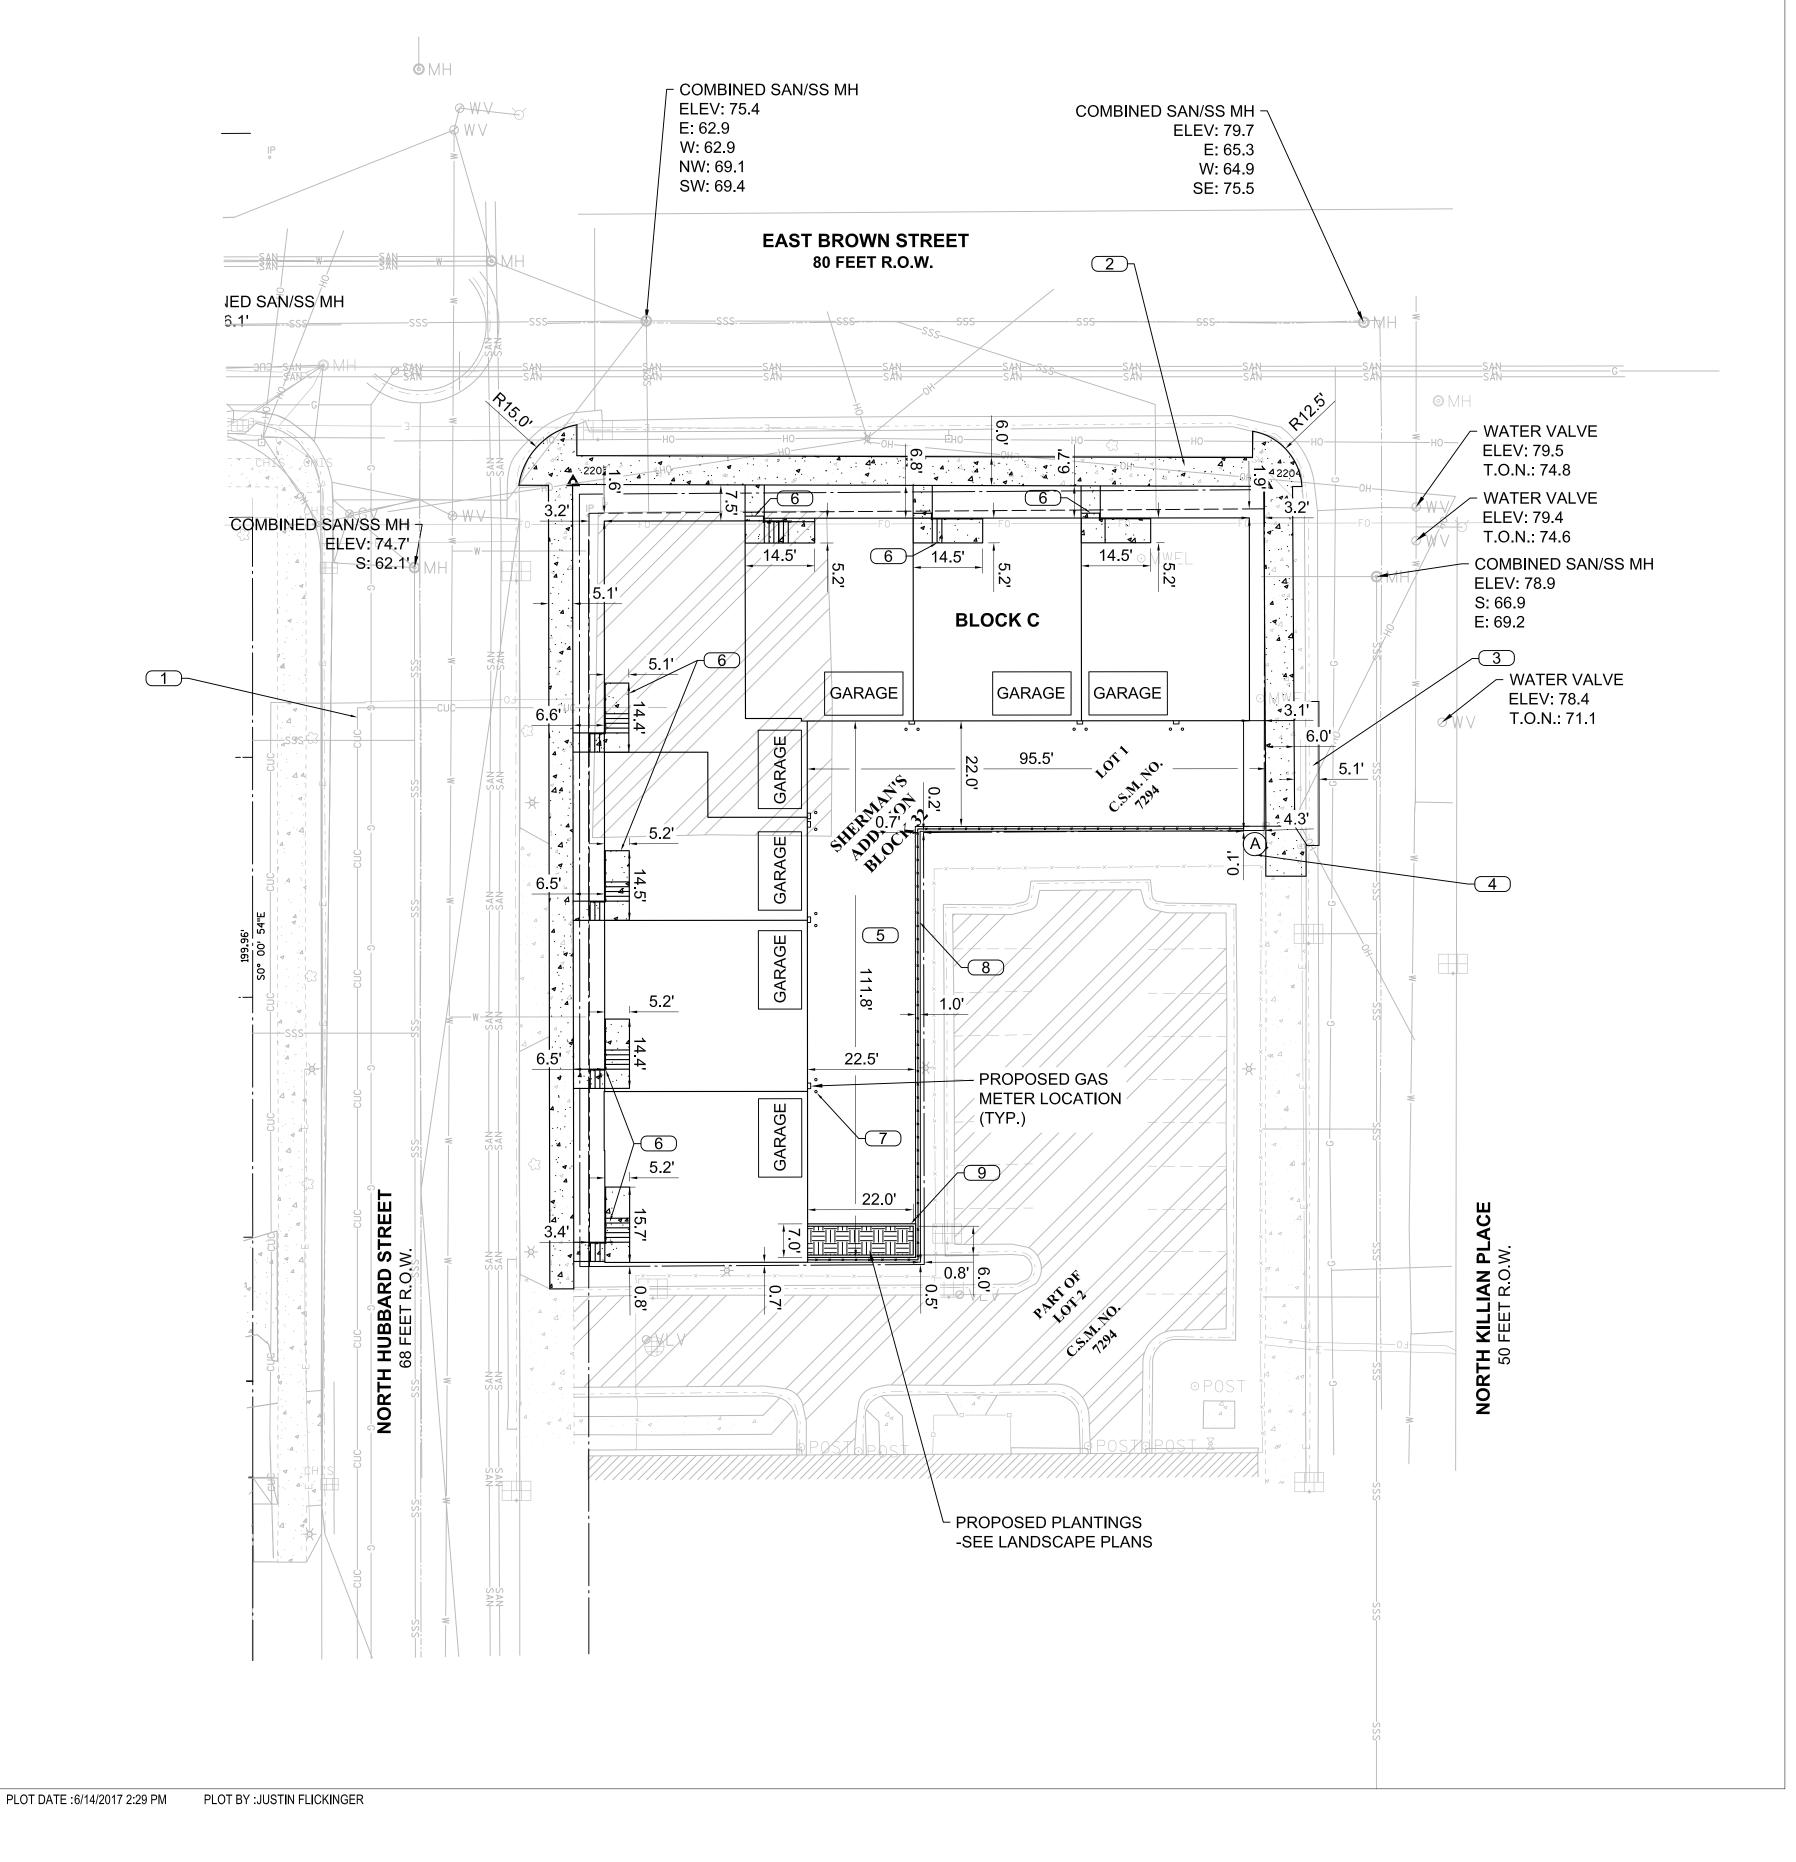



Wauwatosa, WI 53222 262-821-1171

CONSULTANT

CONSULTANT

CONSULTANT

L CAPITAL GROUP, LLC

ST

REVISIONS DATE DESCRIPTION
01 05/11/17 CITY ZONING SUBMITTAL

DRAWN BY DATE 05/11/2017

CHECKED BY CMB 05/11/2017

SITE PLAN

C200C

BLOCK C


SHEET 5 of

GENERAL NOTES:

- 1. SEE DEMOLITION PLANS FOR EXISTING LOT DEMOLITION.
- 2. GRADE ALL SURFACES FOR POSITIVE DRAINAGE.
- 3. ALL GRADES SHOWN ARE FINISHED SURFACE OR FLOW LINE GRADES, UNLESS OTHERWISE NOTED.
- 4. CONTRACTOR TO STRIP AND STOCKPILE TOPSOIL FROM SITE BEFORE GRADING.
- 5. ALL UTILITIES WITHIN THE PROJECT LIMITS SHALL BE ADJUSTED TO PROPOSED GRADING BY THE CONTRACTOR, UNLESS A GRADE MATCH IS INDICATED AT A SPECIFIC UTILITY.
- 6. FINAL ADJUSTMENTS SHALL BE MADE AT THE TIME OF PAVING TO MATCH THE PAVEMENT SURFACE.
- 7. UTILITY OWNERS SHALL BE CONTACTED PRIOR TO ADJUSTMENTS.
- 8. UTILITY OWNERS SHALL HAVE THE OPTION OF PERFORMING THE WORK THEMSELVES OR HAVING THE CONTRACTOR PERFORM THE WORK.
- 9. THE CONTRACTOR SHALL PAY ALL FEES, PERMITS, AND DEPOSITS FOR THE ADJUSTMENT WORK.
- 10. ALL ADJUSTMENT WORK SHALL BE TO THE SPECIFICATIONS OF THE UTILITY OWNER AND IN ACCORDANCE WITH ANY REQUIRED PERMITS.
- 11. PAVEMENT RESTORATIONS SHALL MEET ADJACENT EXISTING PAVEMENTS AS A FLUSH MATCH.
- 12. A GRADING AND DRAINAGE RECORD DRAWING PREPARED TO CITY OF MILWAUKEE STANDARDS IS REQUIRED PRIOR TO OCCUPANCY PERMIT.

PLAN NOTES:

1. CITY UNDERGROUND CONDUIT (CUC) SHALL REMAIN IN SERVICE. THIS CUC PACKAGE SHALL NOT BE EXPOSED OR UNDERMINED DURING THE CONSTRUCTION OF THE BLOCK B EAST AMD WEST BUILDINGS INCLUDING THE SEWER LATERALS, WATER LATERALS, SIDEWALK AND/OR DRIVEWAYS. THE CONTRACTOR SHALL TAKE ALL NECESSARY PRECAUTIONS INCLUDING TIGHT SHEATHING TO ENSURE THE CUC PACKAGE REMAINS INTACT, IN SERVICE AND WITHOUT DAMAGE.

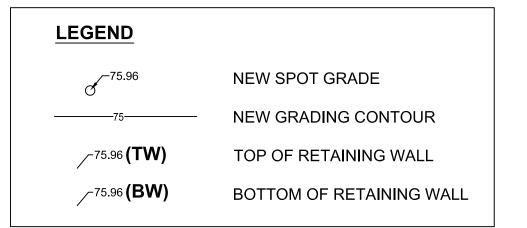



SURVEY NOTES:

- 1. HORIZONTAL DATUM: COORDINATE SYSTEM IS ASSUMED HOLDING THE NORTH LINE OF LOT 1, CSM NO. 6980 AS ASSUMED TO BEAR N89° 36' 30"E.
- 2. VERTICAL DATUM: ELEVATIONS SHOWN ON THE PLAN ARE REFERENCED TO THE CITY OF MILWAUKEE STANDARD BENCH MARKS. CITY OF MILWAUKEE DATA ARE REFERENCED TO THE LEVEL OF THE MILWAUKEE RIVER AS IT WAS IN THE MONTH OF MARCH, 1836 A.D. ADD 580.603 TO PLACE ELEVATIONS ON THE NATIONAL GEODETIC VERTICAL DATUM (NGVD) OF 1929.

BENCHMARK TABLE

PT. NO.	NORTHING	EASTING	DESCRIPTION	ELEV.
2203	5007.292	5056.818	CP SET T	74.622
2204	5006.742	5201.200	CP SET T	79.294

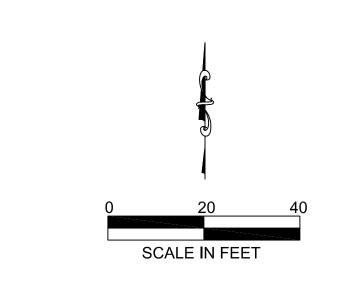

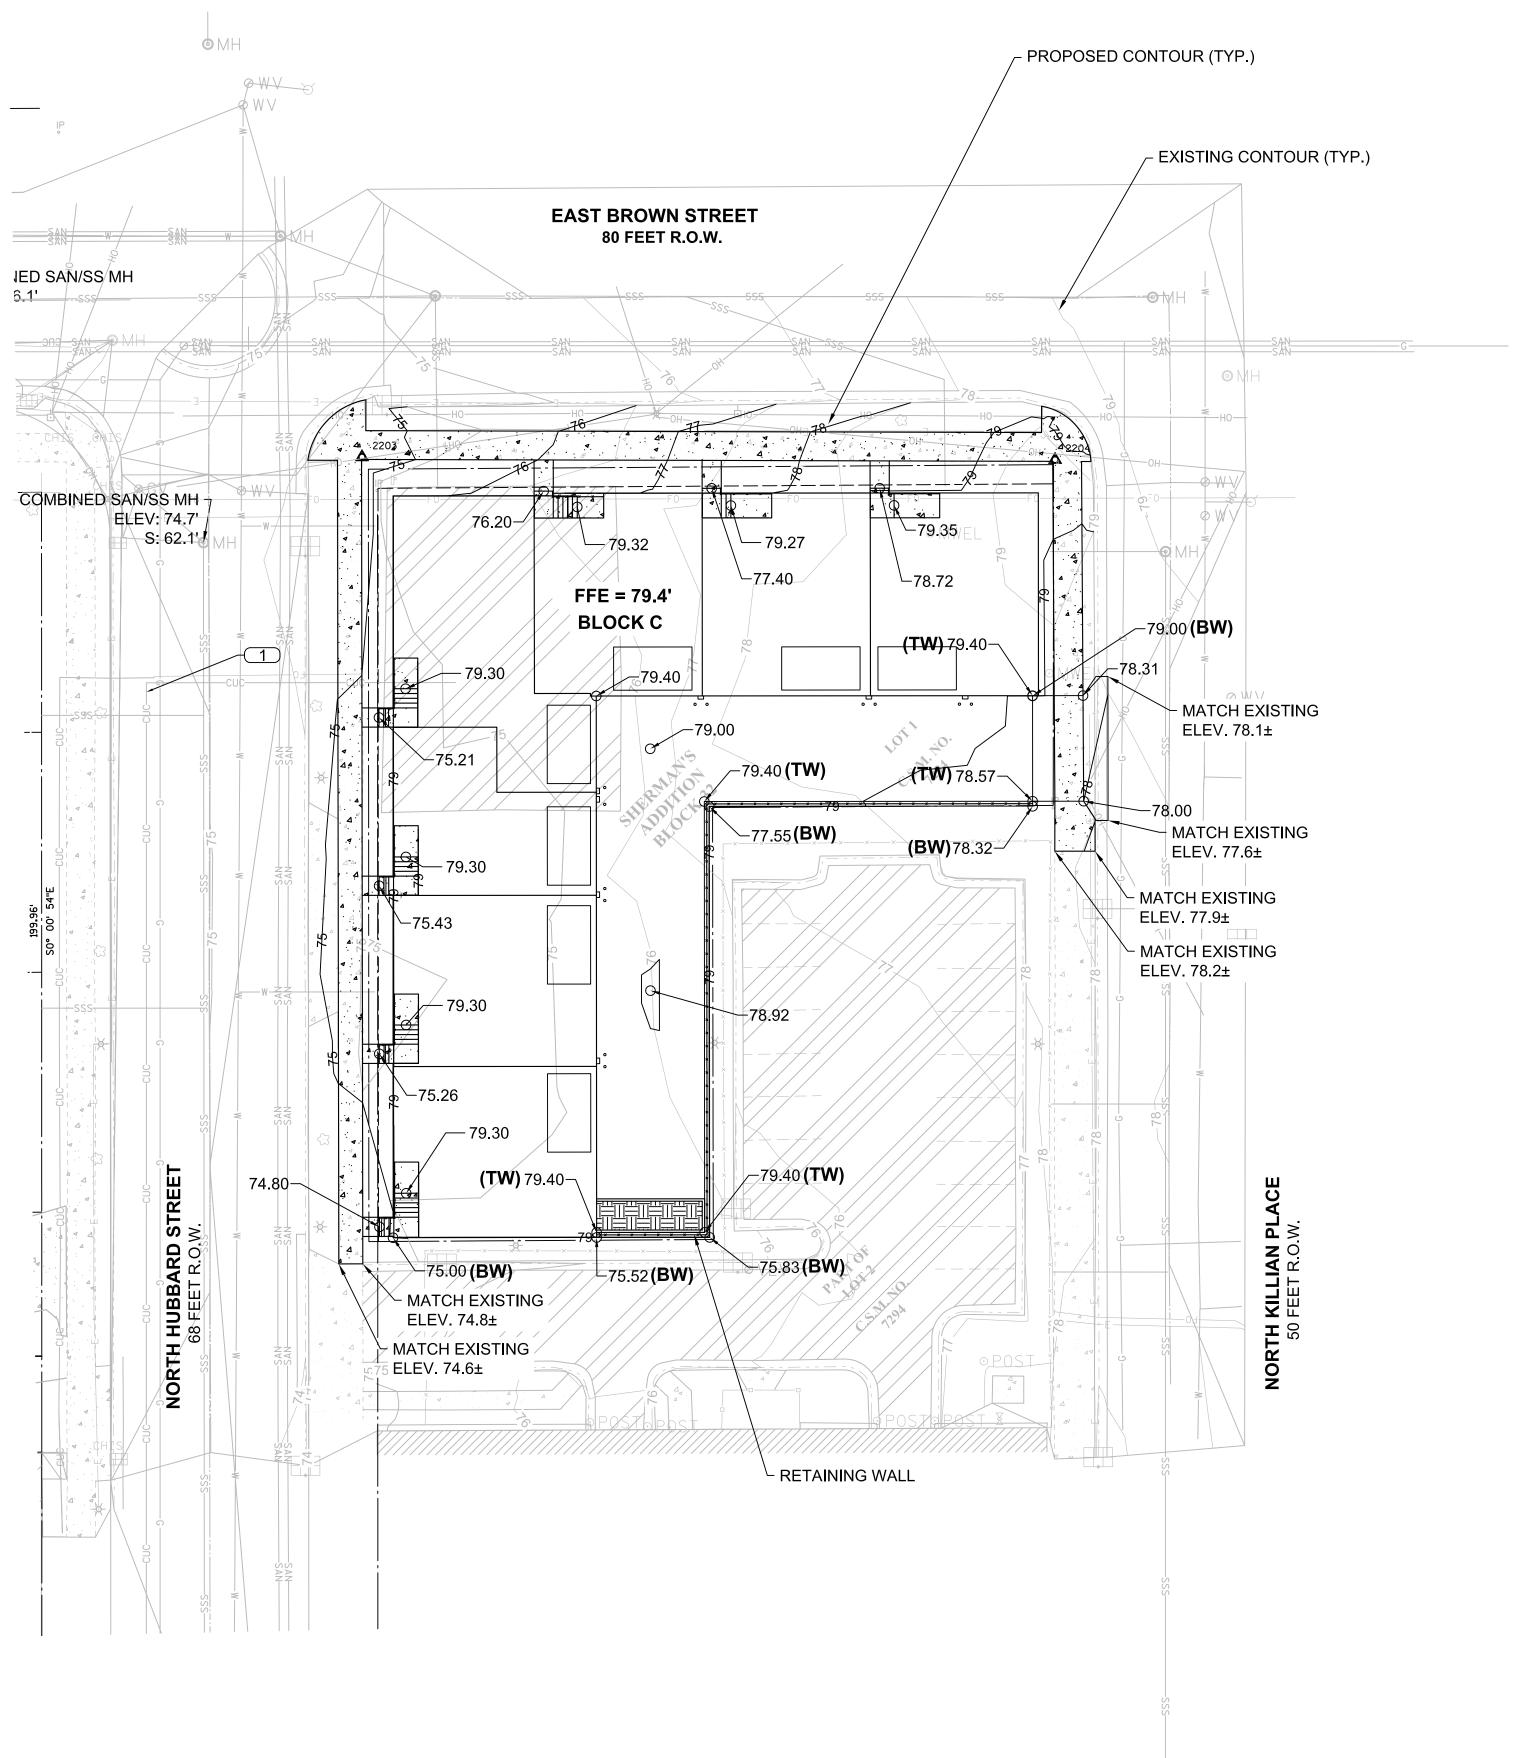



CONSULTANT

CONSULTANT

CONSULTANT

THE HILLS LUXURY COMMONS - BLOCK C
APITAL GROUP, LLC
ION: EAST BROWN ST. AND NORTH PALMER ST.

REVISIONS DATE DESCRIPTION

01 05/11/17 CITY ZONING SUBMITTAL

DRAWN BY DATE

JAF 05/11/2017

CHECKED BY DATE

GRADING PLAN BLOCK C


05/11/2017

C300C

SHEET 6 of


GENERAL NOTES:

- 1. PIPE LENGTHS ARE TO CENTER OF STRUCTURE, UNLESS OTHERWISE NOTED.
- 2. SEWER INSTALLATION SHALL PROCEED FROM DOWNSTREAM TO UPSTREAM.
- 3. CONTRACTOR SHALL ADJUST ALL EXISTING AND NEW UTILITY CASTINGS, MANHOLES, CLEANOUTS, AND ACCESS BOXES TO PROPOSED GRADING.
- 4. CONNECT SANITARY SERVICE IN ACCORDANCE WITH THE REQUIREMENTS OF CITY OF MILWAUKEE.
- 5. ALL EXISTING LATERALS NOT SHOWN AS REUSED SHALL BE ABANDONED AT THE MAIN PER CITY OF MILWAUKEE STANDARDS.
- 6. MAINTAIN PROPER DRAINAGE AT ALL TIMES DURING CONSTRUCTION.
- 7. SEE CONSTRUCTION DETAIL SHEETS FOR SITE AND UTILITY DETAILS.
- 8. SANITARY LATERALS SHALL BE PVC, ASTM D-3034, SDR 35 IN CONFORMANCE WITH SECTION 8.10.0 OF THE STANDARD SPECIFICATIONS FOR SEWER AND WATER CONSTRUCTION IN WISCONSIN, CURRENT EDITION.
- 9. WATER SERVICE SHALL BE PVC, AWWA C-900, CLASS 235 (DR-18).
- 10. CONTRACTOR SHALL VERIFY EXISTING PIPE INVERT, PIPE MATERIAL, PIPE SIZE AND LOCATION PRIOR TO CONSTRUCTION OF THE UTILITIES. ANY DISCREPANCIES SHALL BE DISCUSSED WITH THE OWNER.
- 11. SANITARY SEWER AND WATER MAIN SHALL BE CONSTRUCTED PER PROJECT SPECIFICATIONS AND IN ACCORDANCE WITH THE DEPARTMENT OF SAFETY AND PROFESSIONAL SERVICES AND THE CITY OF MILWAUKEE.
- 12. SEE DEMOLITION PLANS FOR PIPE ABANDONMENT AND REMOVAL.
- 13. A MINIMUM OF 6.0 FEET OF COVER SHALL BE MAINTAINED OVER ALL WATER MAIN.
- 14. A MINIMUM OF 6.0 FEET OF COVER SHALL BE MAINTAINED OVER ALL SANITARY SEWER.
- 15. PER DSPS 382.40 (8) (b) PRIVATE WATER MAINS AND WATER SERVICES SHALL BE INSTALLED AT LEAST 5 FEET HORIZONTALLY FROM ANY SANITARY SEWER.
- 16. NO PRIVATE WATER MAIN OR WATER SERVICE MAY BE INSTALLED WITHIN 6 INCHES OF A STORM SEWER.
- 17. CLEANOUTS SHALL BE LOCATED NOT MORE THAN 100 FEET APART. THE CLEANOUT NEAR THE BUILDING SHALL BE WITHIN 5 FEET OF WHERE THE BUILDING DRAIN AND BUILDING SEWER CONNECTS. THE CLEANOUT MAY BE LOCATED EITHER INSIDE OR OUTSIDE OF BUILDING.
- 18. GENERALLY, FOR WATER SERVICE 4-INCHES OR LARGER, DEFLECTION WILL NOT BE ALLOWED AND CONTRACTOR SHALL USE 11.25, 22.5, 45 AND 90 DEGREE BENDS WHEN NEEDED. CONTRACTOR SHALL NOT EXCEED 5 DEGREES PER PIPE OR AS RECOMMENDED BY MANUFACTURER.
- 19. PROVIDE TRACER WIRE FOR NON-METALLIC WATER SERVICE. SEE SPECIFICATIONS. TRACER WIRE FOR POTABLE WATER PIPE SHALL BE BLUE.

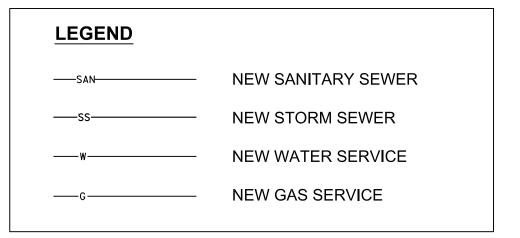

SURVEY NOTES:

- 1. HORIZONTAL DATUM: COORDINATE SYSTEM IS ASSUMED HOLDING THE NORTH LINE OF LOT 1, CSM NO. 6980 AS ASSUMED TO BEAR N89° 36' 30"E.
- 2. VERTICAL DATUM: ELEVATIONS SHOWN ON THE PLAN ARE REFERENCED TO THE CITY OF MILWAUKEE STANDARD BENCH MARKS. CITY OF MILWAUKEE DATA ARE REFERENCED TO THE LEVEL OF THE MILWAUKEE RIVER AS IT WAS IN THE MONTH OF MARCH, 1836 A.D. ADD 580.603 TO PLACE ELEVATIONS ON THE NATIONAL GEODETIC VERTICAL DATUM (NGVD) OF 1929.

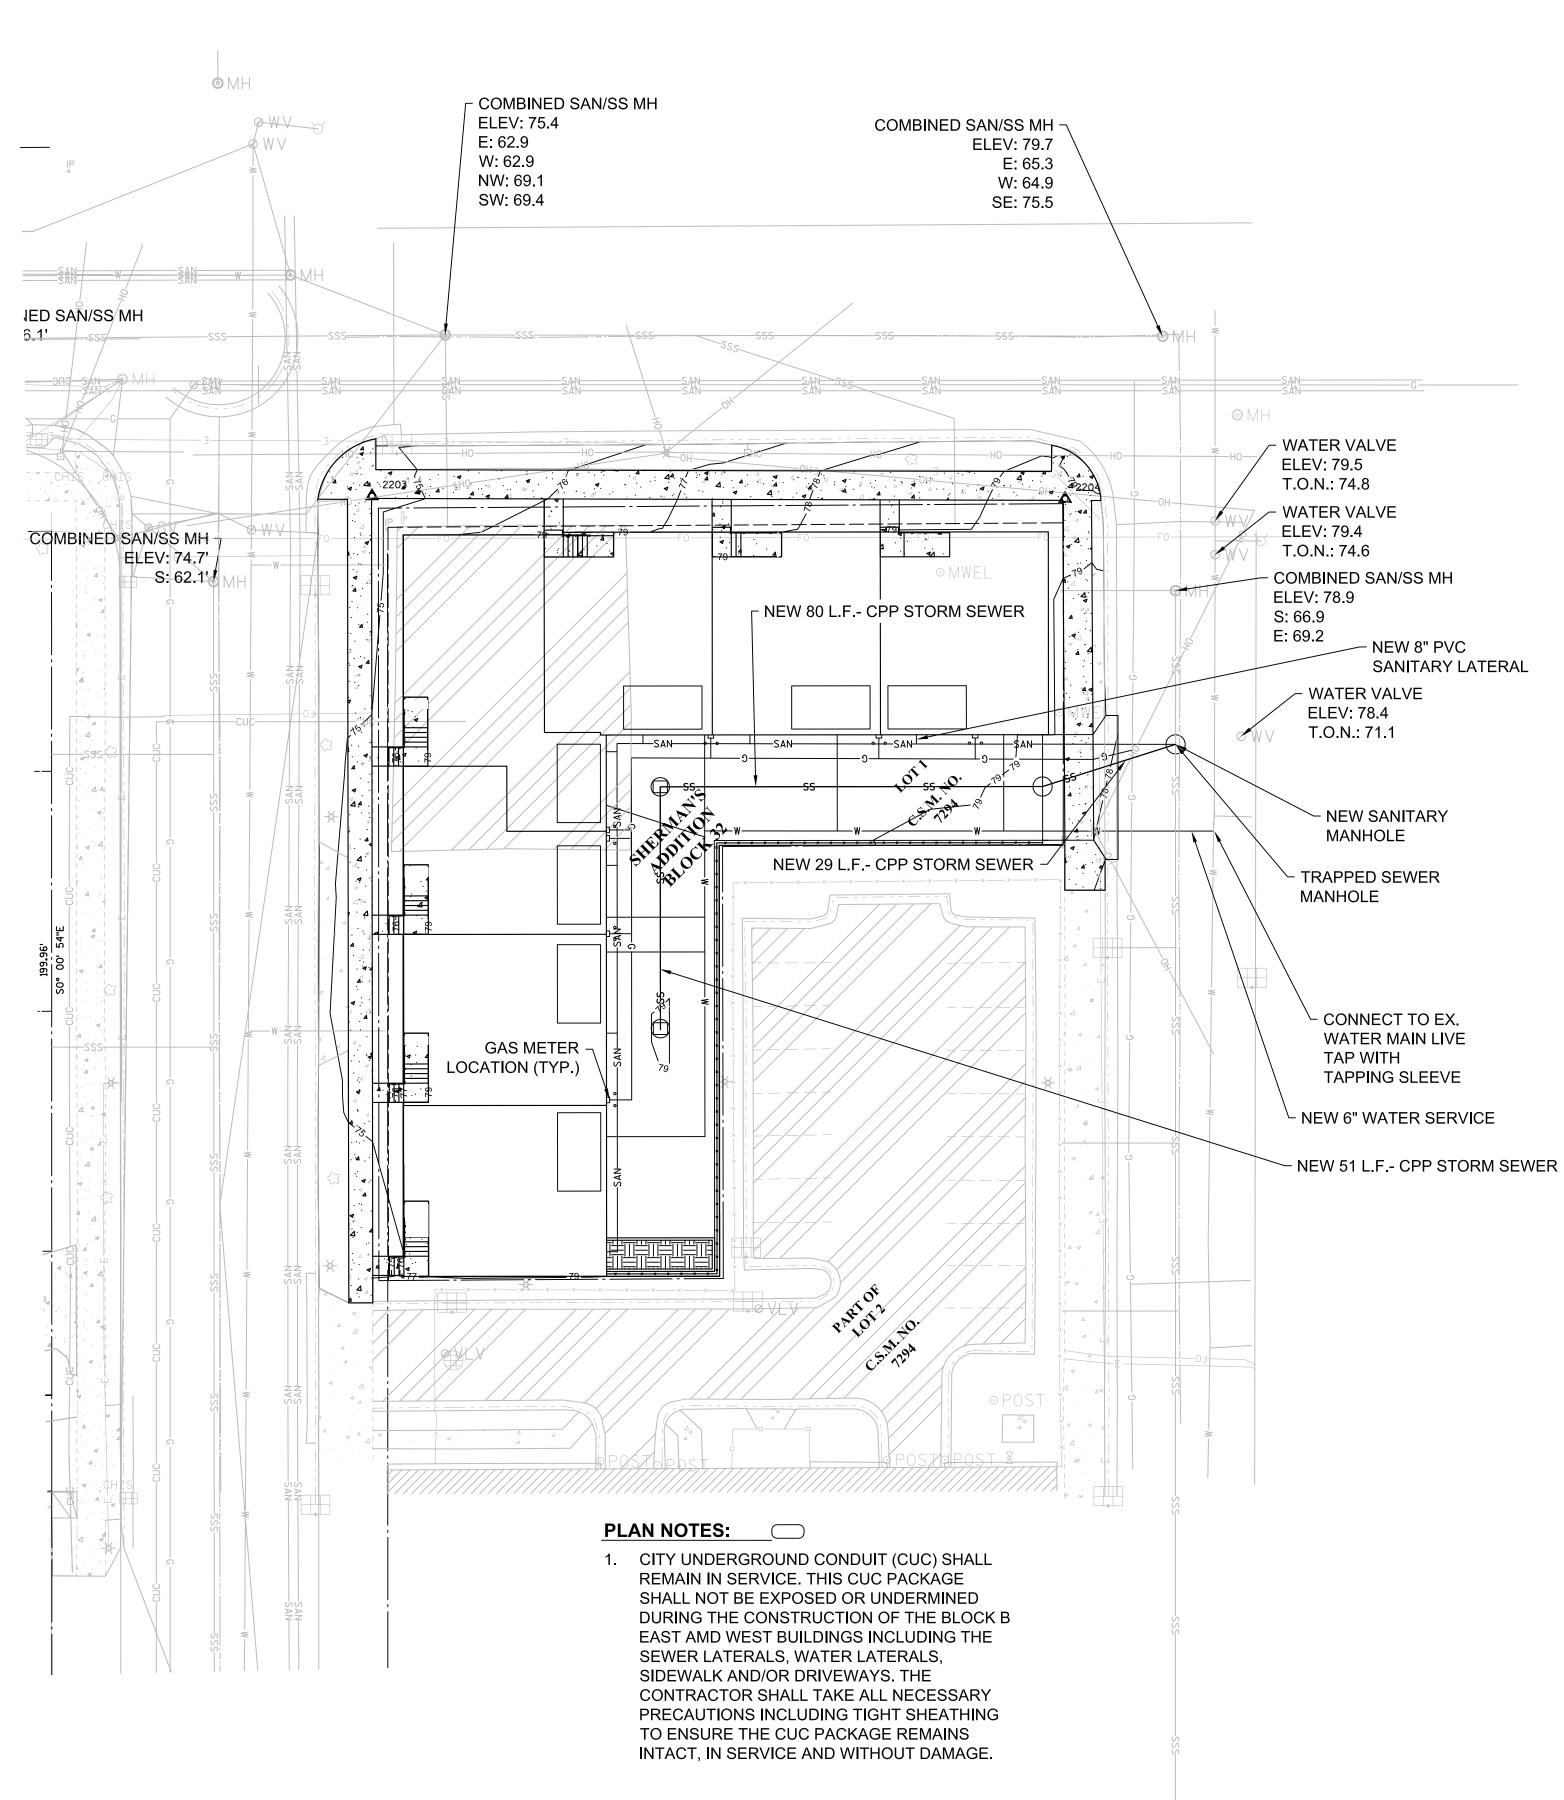



3636 North 124th Street Wauwatosa, WI 53222 262-821-1171

CONSULTANT

CONSULTANT

CONSULTANT

 \circ

OMMONS - BLOCK C

T. AND NORTH PALMER ST.

CAPITAL GROUP, LLC TION: EAST BROWN ST. AND N MILWAUKEE, WI

BIONS DATE DESCRIPTION
1 05/11/17 CITY ZONING SUBMITTAL


DRAWN BY DATE
JAF 05/11/2017

CHECKED BY DATE
CMB 05/11/2017

UTILITY PLAN BLOCK C

C400C

SHEET 7

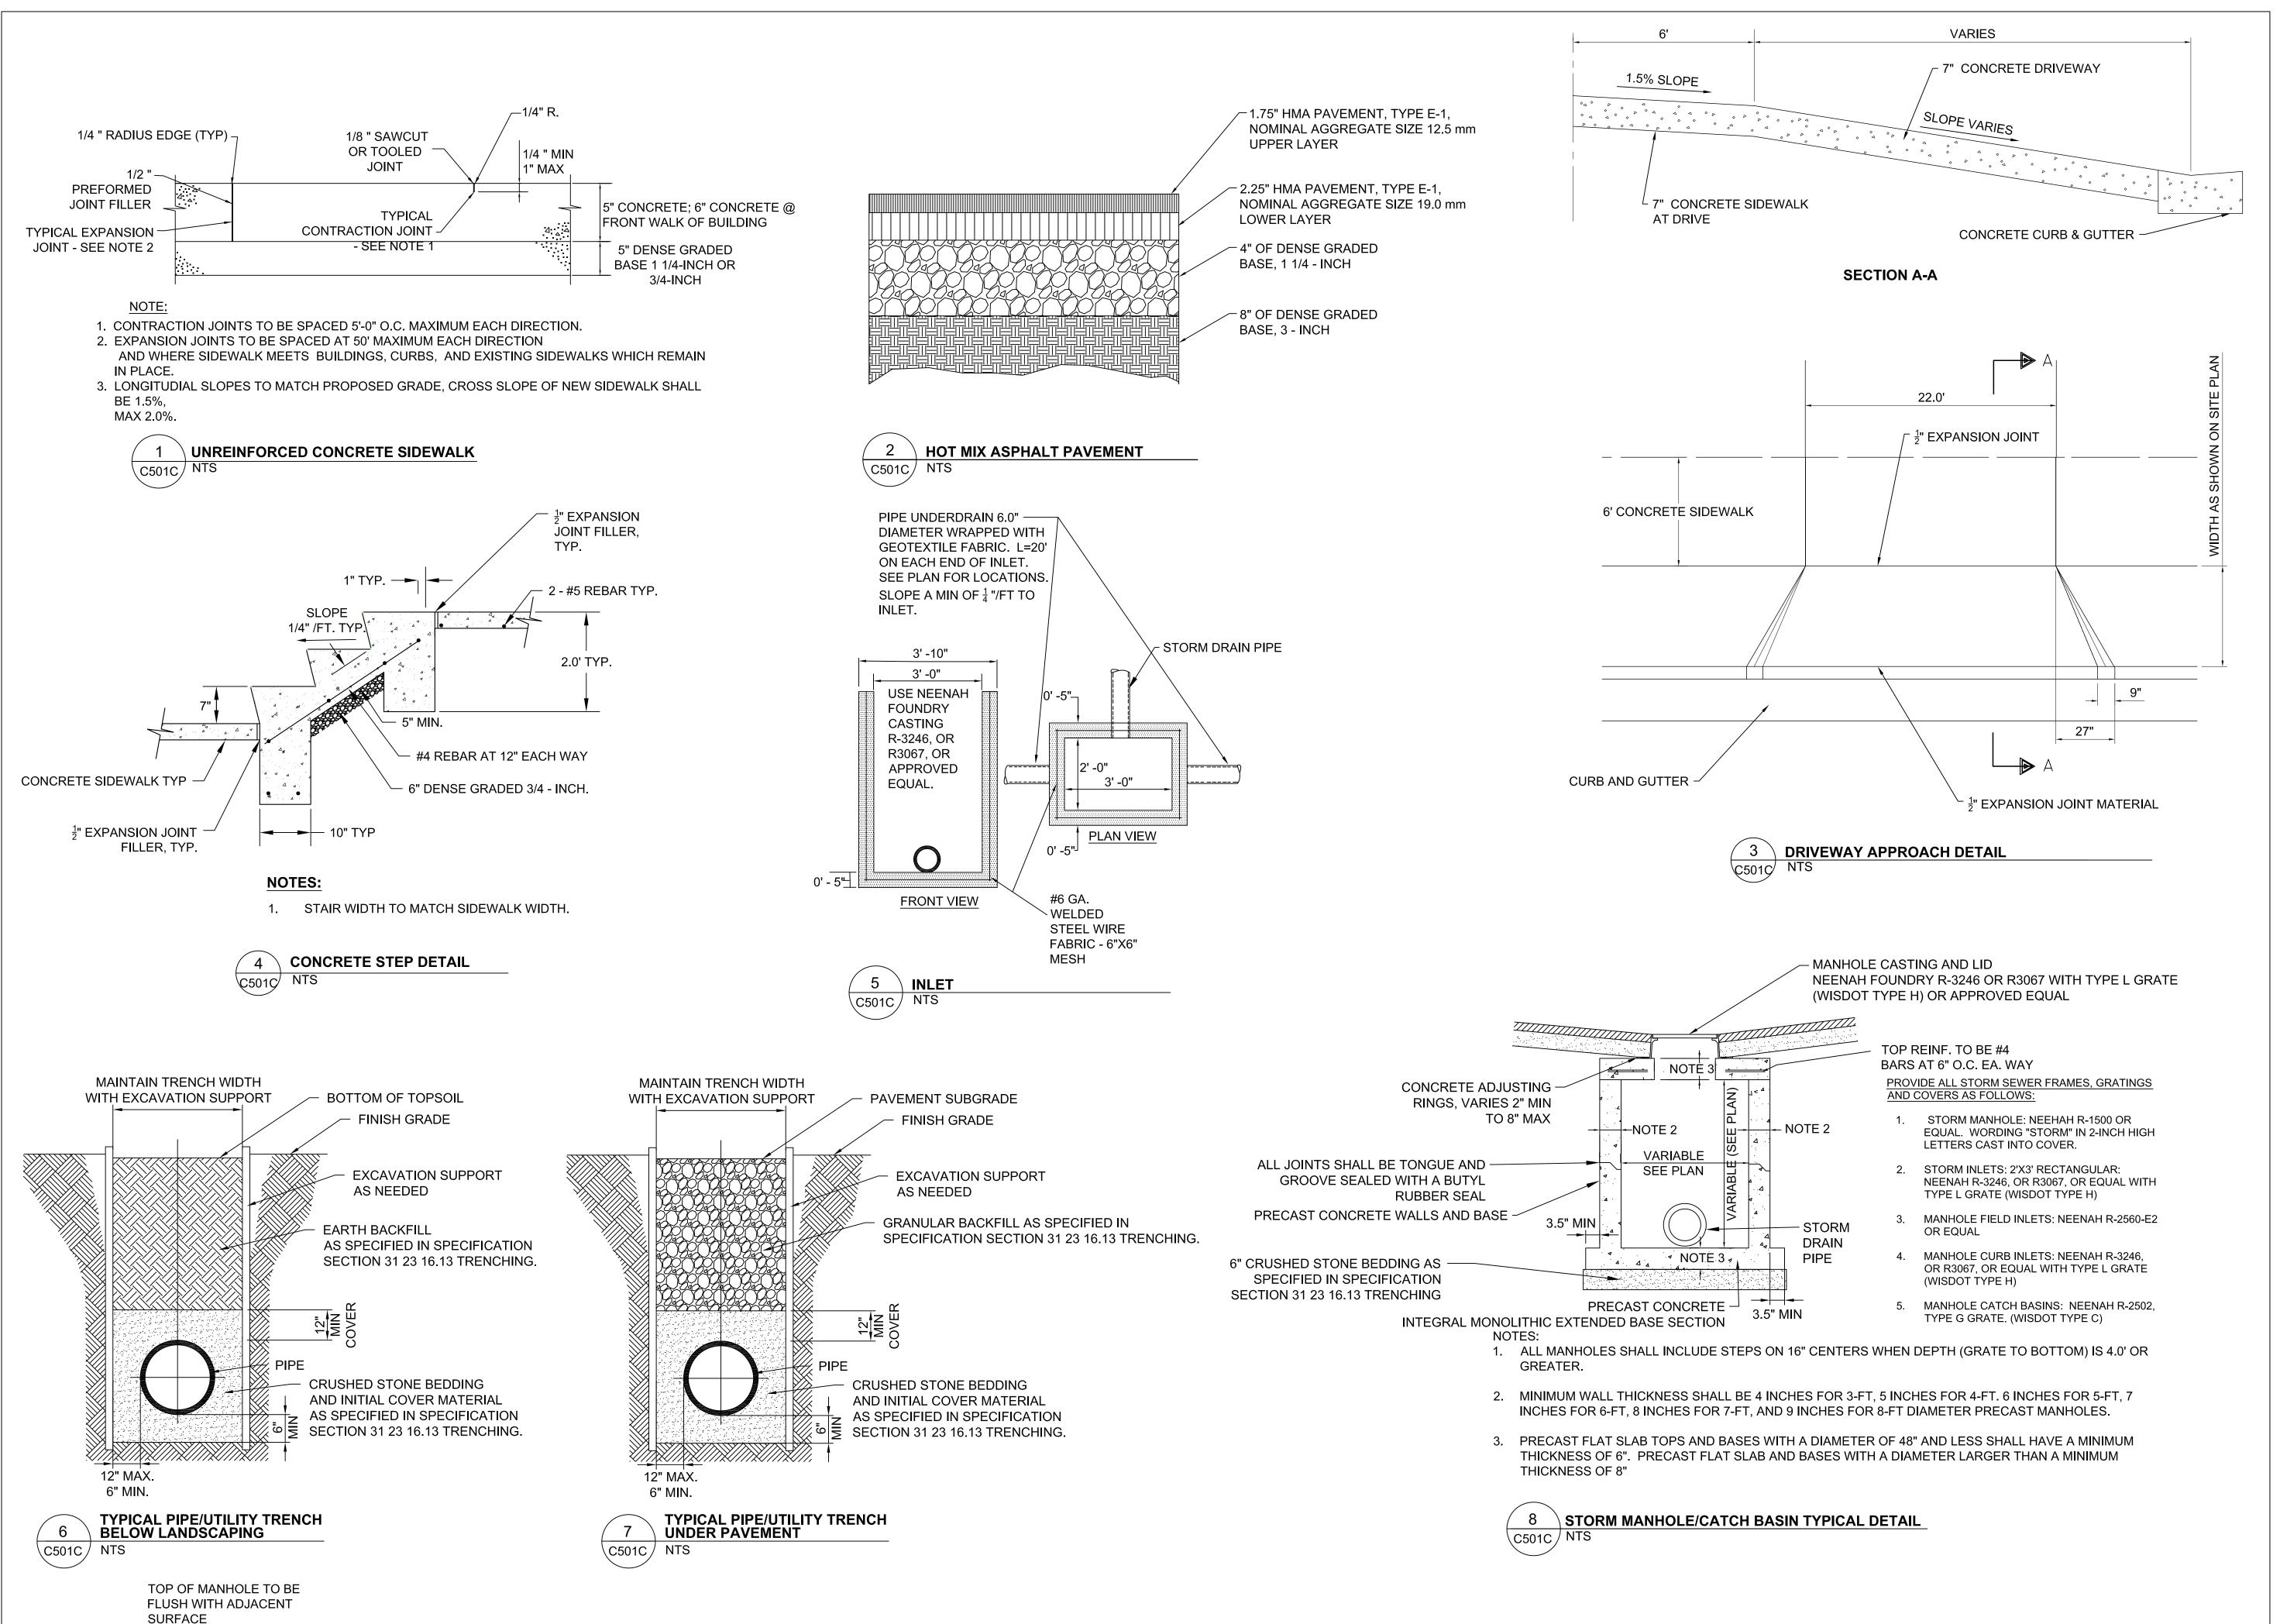

KSingh Engineer Scientist Consulta

3636 North 124th Street Wauwatosa, WI 53222

CONSULTANT

262-821-1171

CONSULTANT

CONSULTANT

 \Box

CONST

 \circ

HILLS LUXURY COMMONS - BLOCK C

TAL GROUP, LLC

EAST BROWN ST. AND NORTH PALMER ST

MILWAUKEE, WI

REVISIONS DATE DESCRIPTION

01 05/11/17 CITY ZONING SUBMITTAL

DRAWN BY DATE


JAF 05/11/2017

CHECKED BY DATE


CONSTRUCTION DETAILS
BLOCK C


05/11/2017

C501C

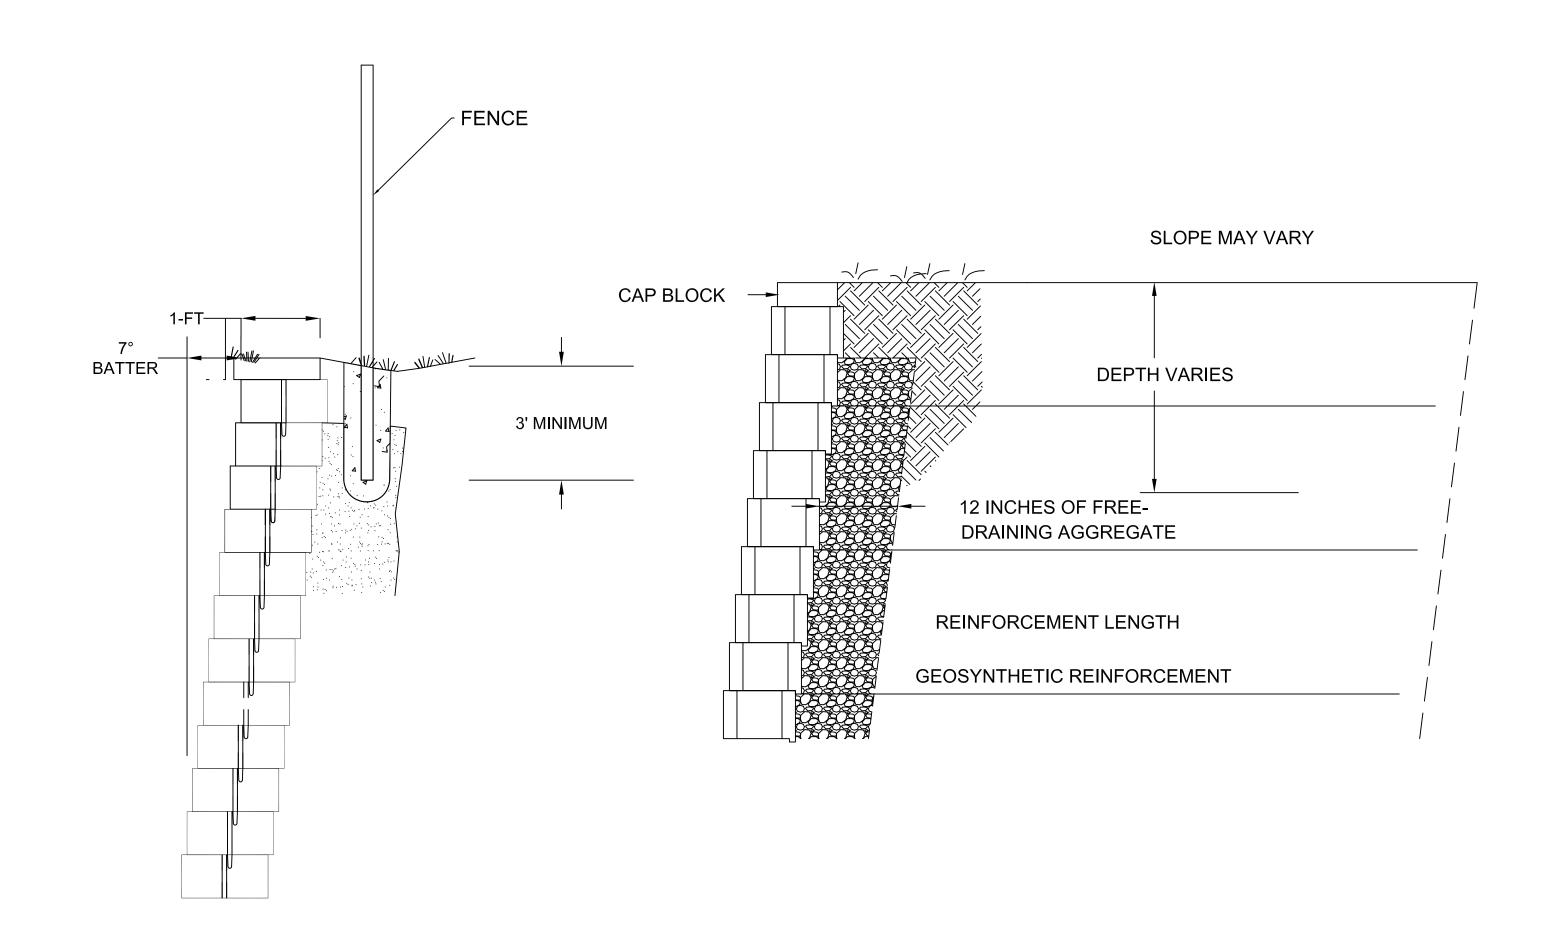



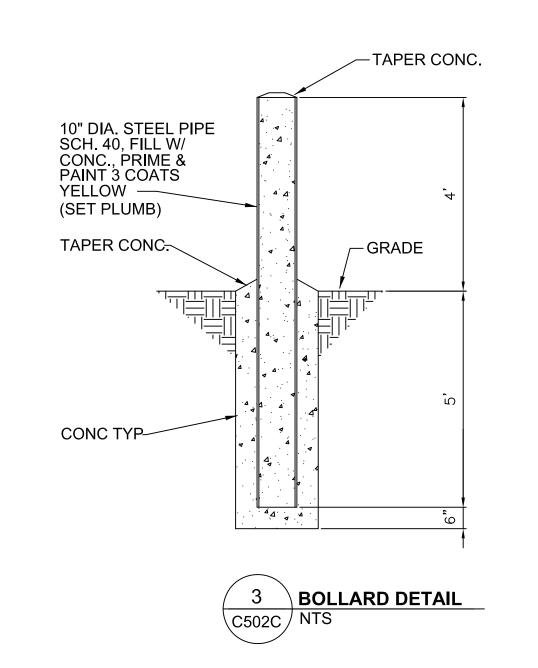

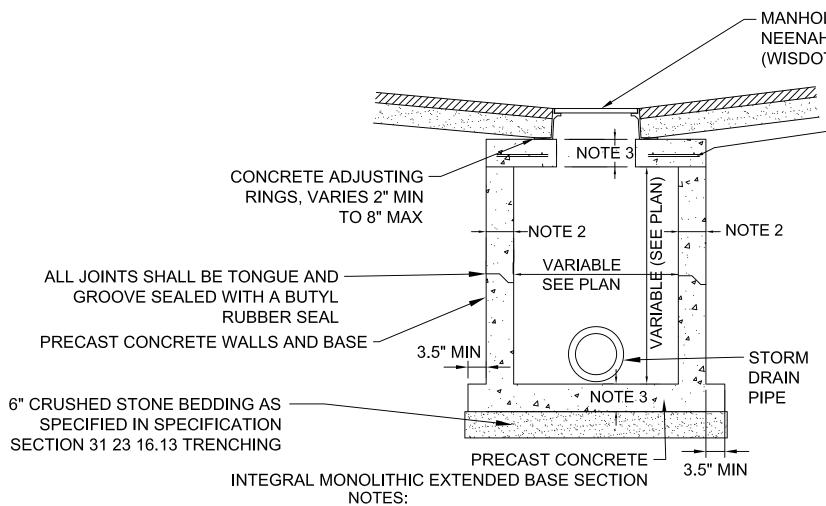

GREATER.


MANHOLE CASTING AND LID
NEENAH FOUNDRY R-3246 OR R3067 WITH TYPE L GRATE
(WISDOT TYPE H) OR APPROVED EQUAL

TOP REINF. TO BE #4
BARS AT 6" O.C. EA. WAY

PROVIDE ALL STORM SEWER FRAMES, GRATINGS AND COVERS AS FOLLOWS:

- STORM MANHOLE: NEEHAH R-1500 OR EQUAL. WORDING "STORM" IN 2-INCH HIGH LETTERS CAST INTO COVER.
- 2. STORM INLETS: 2'X3' RECTANGULAR: NEENAH R-3246, OR R3067, OR EQUAL WITH TYPE L GRATE (WISDOT TYPE H)
- 3. MANHOLE FIELD INLETS: NEENAH R-2560-E2 OR EQUAL
- 4. MANHOLE CURB INLETS: NEENAH R-3246, OR R3067, OR EQUAL WITH TYPE L GRATE (WISDOT TYPE H)
- 5. MANHOLE CATCH BASINS: NEENAH R-2502, TYPE G GRATE. (WISDOT TYPE C)
- 1. ALL MANHOLES SHALL INCLUDE STEPS ON 16" CENTERS WHEN DEPTH (GRATE TO BOTTOM) IS 4.0' OR
- 2. MINIMUM WALL THICKNESS SHALL BE 4 INCHES FOR 3-FT, 5 INCHES FOR 4-FT. 6 INCHES FOR 5-FT, 7 INCHES FOR 6-FT, 8 INCHES FOR 7-FT, AND 9 INCHES FOR 8-FT DIAMETER PRECAST MANHOLES.
- 3. PRECAST FLAT SLAB TOPS AND BASES WITH A DIAMETER OF 48" AND LESS SHALL HAVE A MINIMUM THICKNESS OF 6". PRECAST FLAT SLAB AND BASES WITH A DIAMETER LARGER THAN A MINIMUM THICKNESS OF 8"



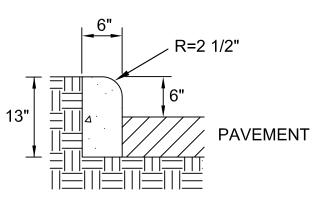

NOTES:

- 1. LATERAL CONTRACTION JOINTS SHALL BE PLACED AT INTERVALS OF NOT MORE THAN 15' NOR LESS THAN 6' IN LENGTH. THE JOINTS SHALL BE A MINIMUM OF 3" IN DEPTH.
- 2. EXPANSION JOINTS SHALL BE PLACED TRANSVERSELY AT RADIUS POINTS ON CURVES OF RADIUS OF 200' OR LESS, AND AT ANGLE POINTS, OR AS DIRECTED BY THE ENGINEER. THE EXPANSION JOINT SHALL BE A ONE PIECE ASPHALTIC MATERIAL HAVING THE SAME DIMENSIONS AS CURB & GUTTER AT THAT STATION AND BE 1/2" THICK.
- 3. IN ALL CASES, CONCRETE CURB SHALL BE PLACED ON THOROUGHLY COMPACTED CRUSHED AGGREGATE BASE COURSE (MIN. 2"). AN EXPANSION JOINT ONE (1) INCH IN WIDTH SHALL BE CONSTRUCTED BETWEEN VERTICAL CURB AND TYPE "G" CURB.





3636 North 124th Street Wauwatosa, WI 53222 262-821-1171

CONSULTANT

CONSULTANT

CONSULTANT

RTH PALMER ST.


- CAPITAL GROUP, LLC ATION: EAST BROWN ST. AND NORTH PALMI

CLIENT: BOYAL O

REVISIONS	DATE	DESCRIPTION
01	05/11/17	CITY ZONING SUBMITT
·-		
DRAWN BY		DATE
JAF		05/11/2017
CHECKED BY		DATE
CMB		05/11/2017


CONSTRUCTION DETAILS
BLOCK C

C502C

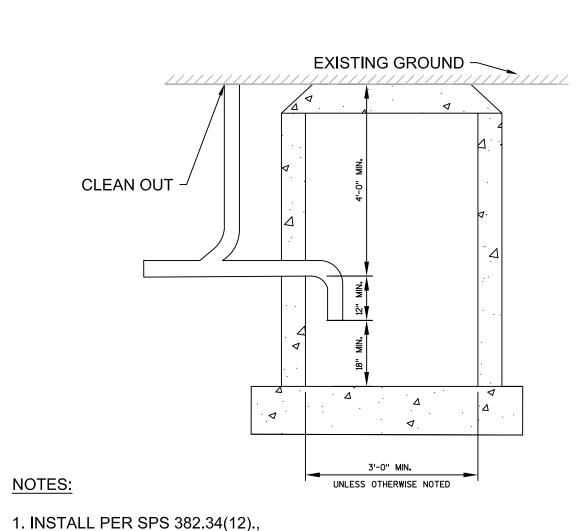

382.35(5)(a)2., & MILWAUKEE CODE OF

ORDINANCES 225-4.4B

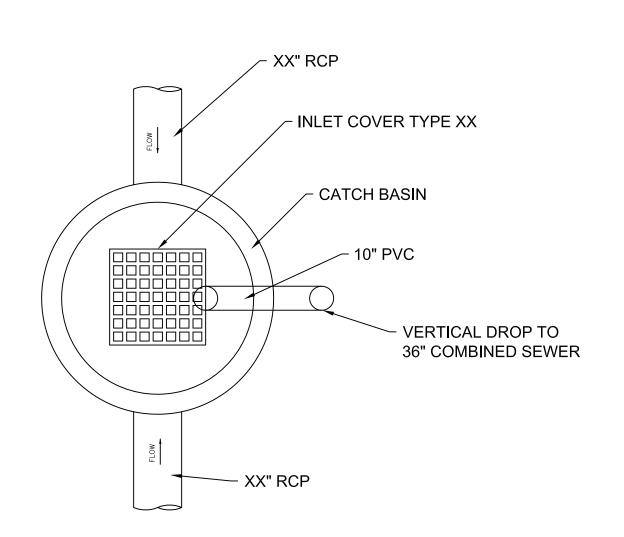

TRAPPED CATCH BASIN WITH EXTERIOR DROP CONNECTION (PLAN VIEW)


COMBINED CATCH BASIN OR EXTERIOR SAND INTERCEPTOR


WITH SNAP-IN BOOT


┌─ 6" CLEAN OUT EXISTING GROUND SOLID PLUG -NOTES: 1. STEPS ARE REQUIRED 2. INSTALL PER SPS 382.34(12)., 382.35(5)(a)2., & MILWAUKEE CODE OF ORDINANCES 225-4.4B 4'-0"

INSTALL PER SPS 382.34(12)., 382.35(5)(a)2., & MILWAUKEE CODE OF ORDINANCES 225-4.4B

COMBINED CATCH BASIN OR EXTERIOR SAND INTERCEPTOR FOR 12" OR LARGER PIPING.

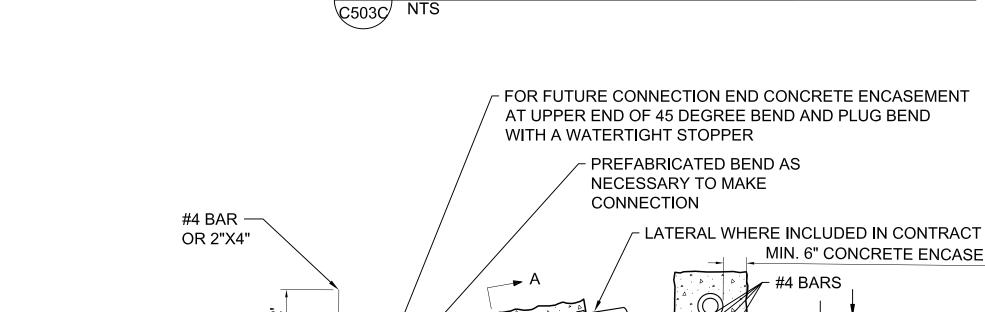

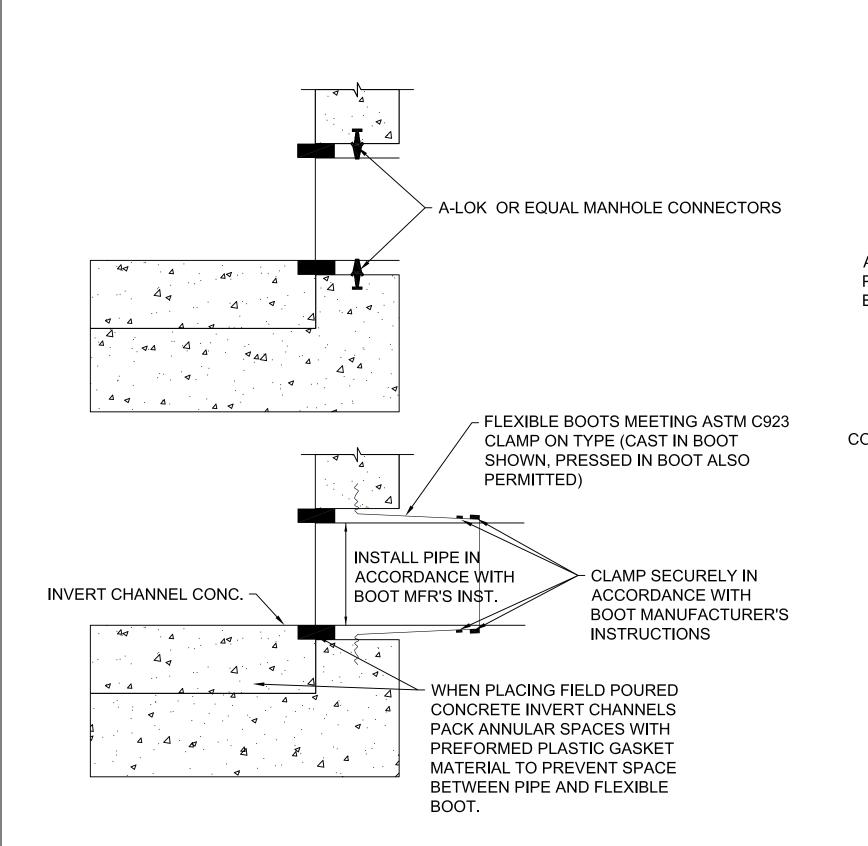


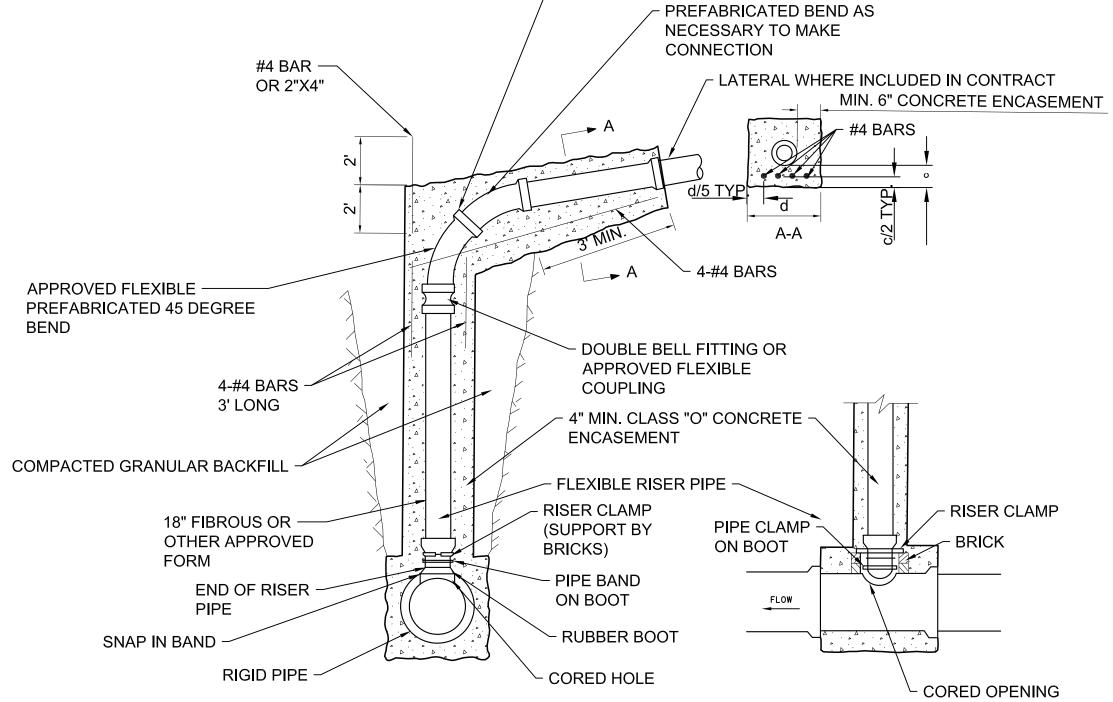

1. RISER CLAMP SUPPORTED ON BRICKS TO PREVENT THE PUSH THRU OF RISER PIPE WHEN CONCRETE IS PLACED.

- 2. PLEASE SEE RISER DETAIL "TYPE C" FLEXIBLE RISER TO RIGID MAIN (ALTERNATIVE B) FOR MORE DETAILS.
- 3. CONCRETE ENCASEMENT OF SEWERS 24" OR LARGER NOT REQUIRED.

 $\sqrt{3}$ DROP CONNECTION C503C NTS

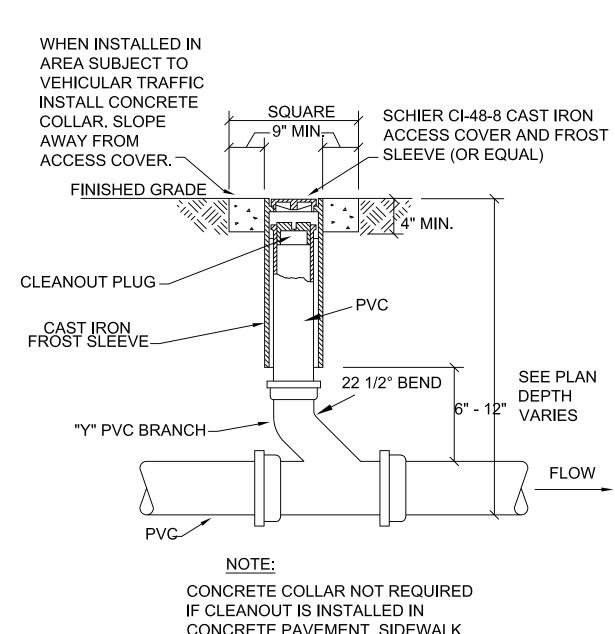

CONCRETE PAVEMENT, SIDEWALK OR LANDSCAPE AREA.

4 \ SANITARY CLEANOUT C503C NTS

CONSTRUCTION DETAILS BLOCK C

CHECKED BY

3636 North 124th Street Wauwatosa, WI 53222

262-821-1171

CONSULTANT

CONSULTANT

CONSULTANT

ST

EAST BROWN MILWAUKEE, V

DESCRIPTION

05/11/17 | CITY ZONING SUBMITTAL

05/11/2017


05/11/2017


DATE

SHEET 11

2 MANHOLE PIPE CONNECTION DETAIL

C503C

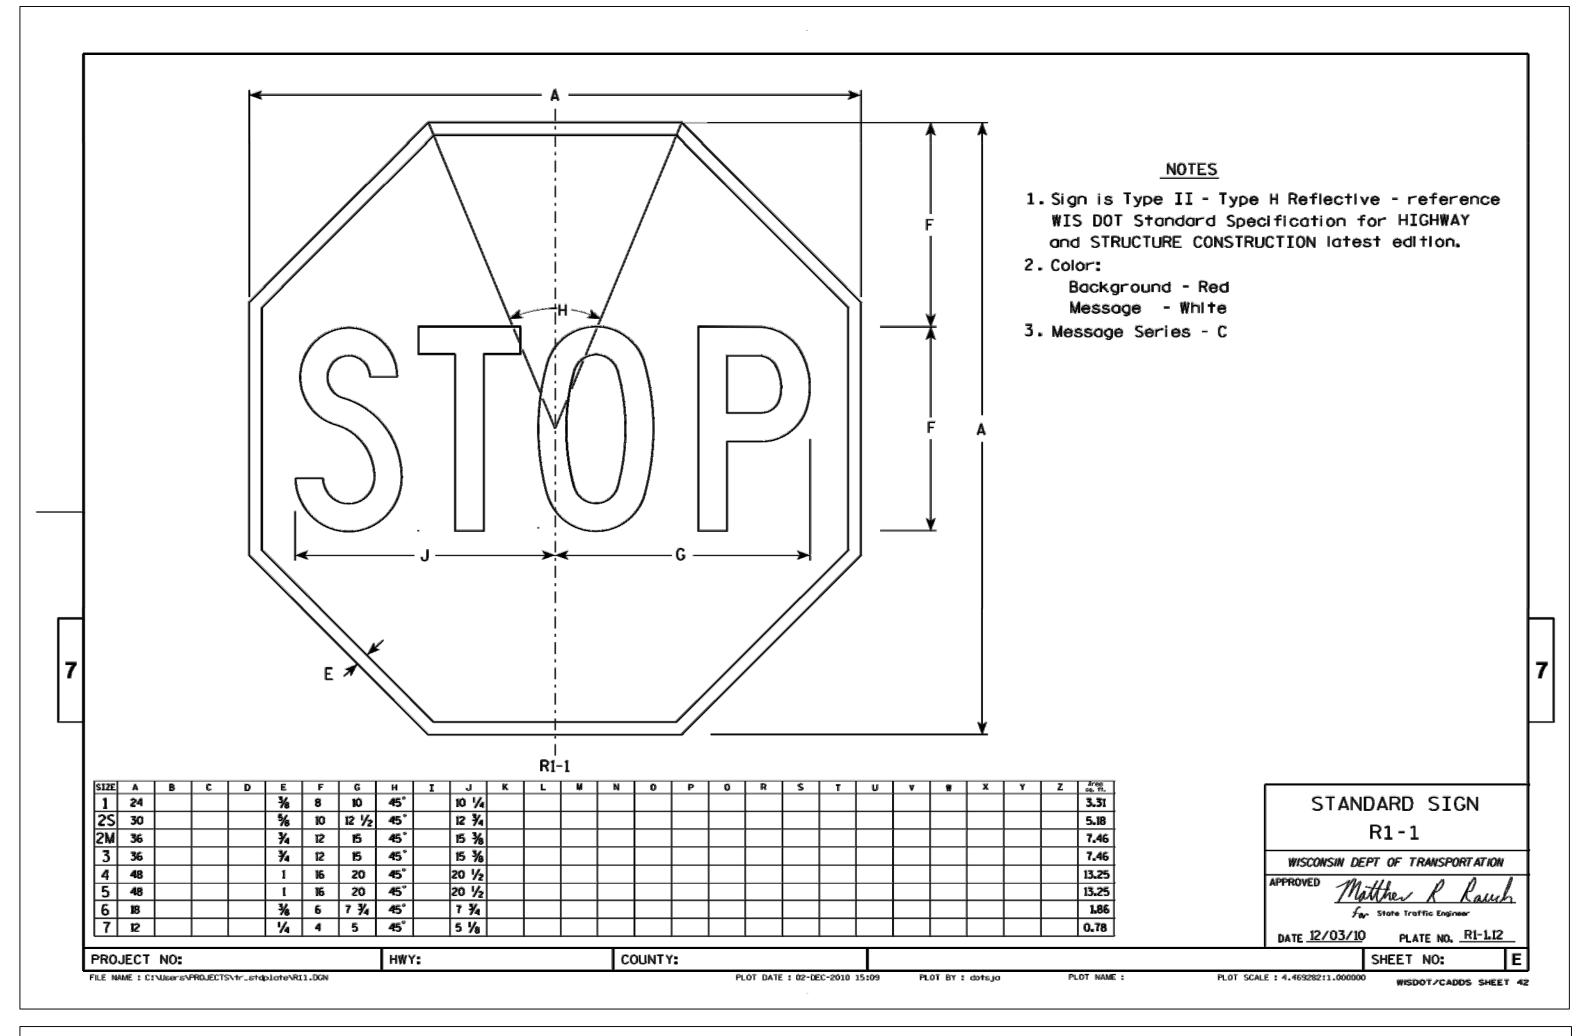

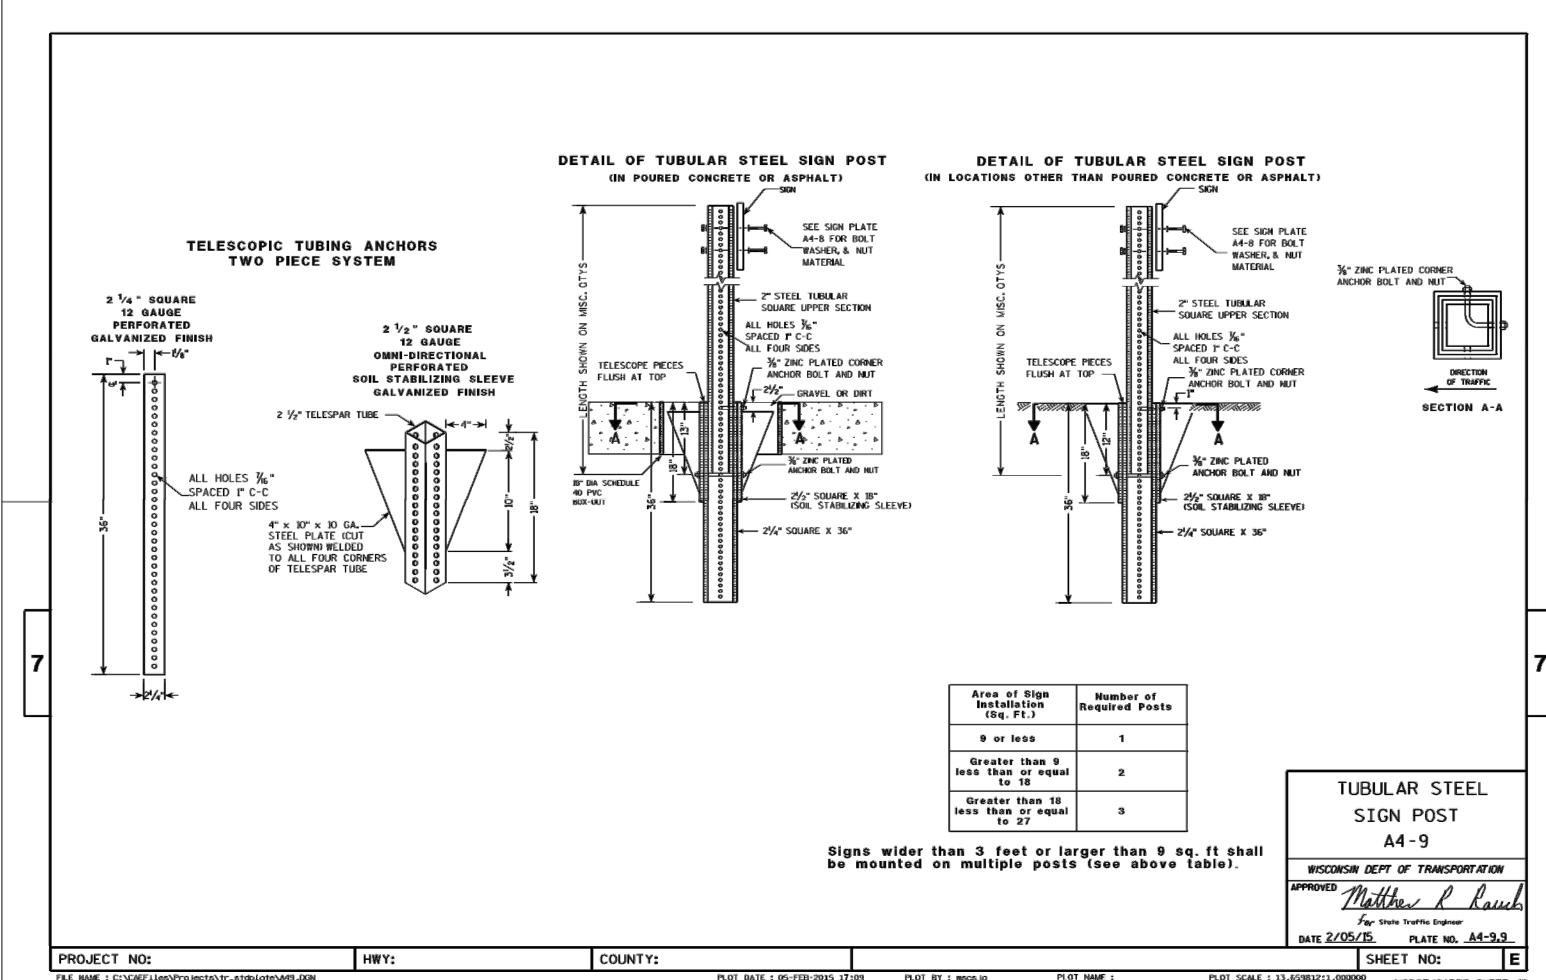





3636 North 124th Street Wauwatosa, WI 53222 262-821-1171

CONSULTANT

CONSULTANT

CONSULTANT

YAL CAPITAL GROUP, LLC
OCATION: EAST BROWN ST. AND NORTH PALMER
MILWAUKEE, WI

REVISIONS DATE DESCRIPTION
01 05/11/17 CITY ZONING SUBMITTAL


CONSTRUCTION DETAILS
BLOCK C

DATE

CHECKED BY

C504C

SHEET 12 of SH

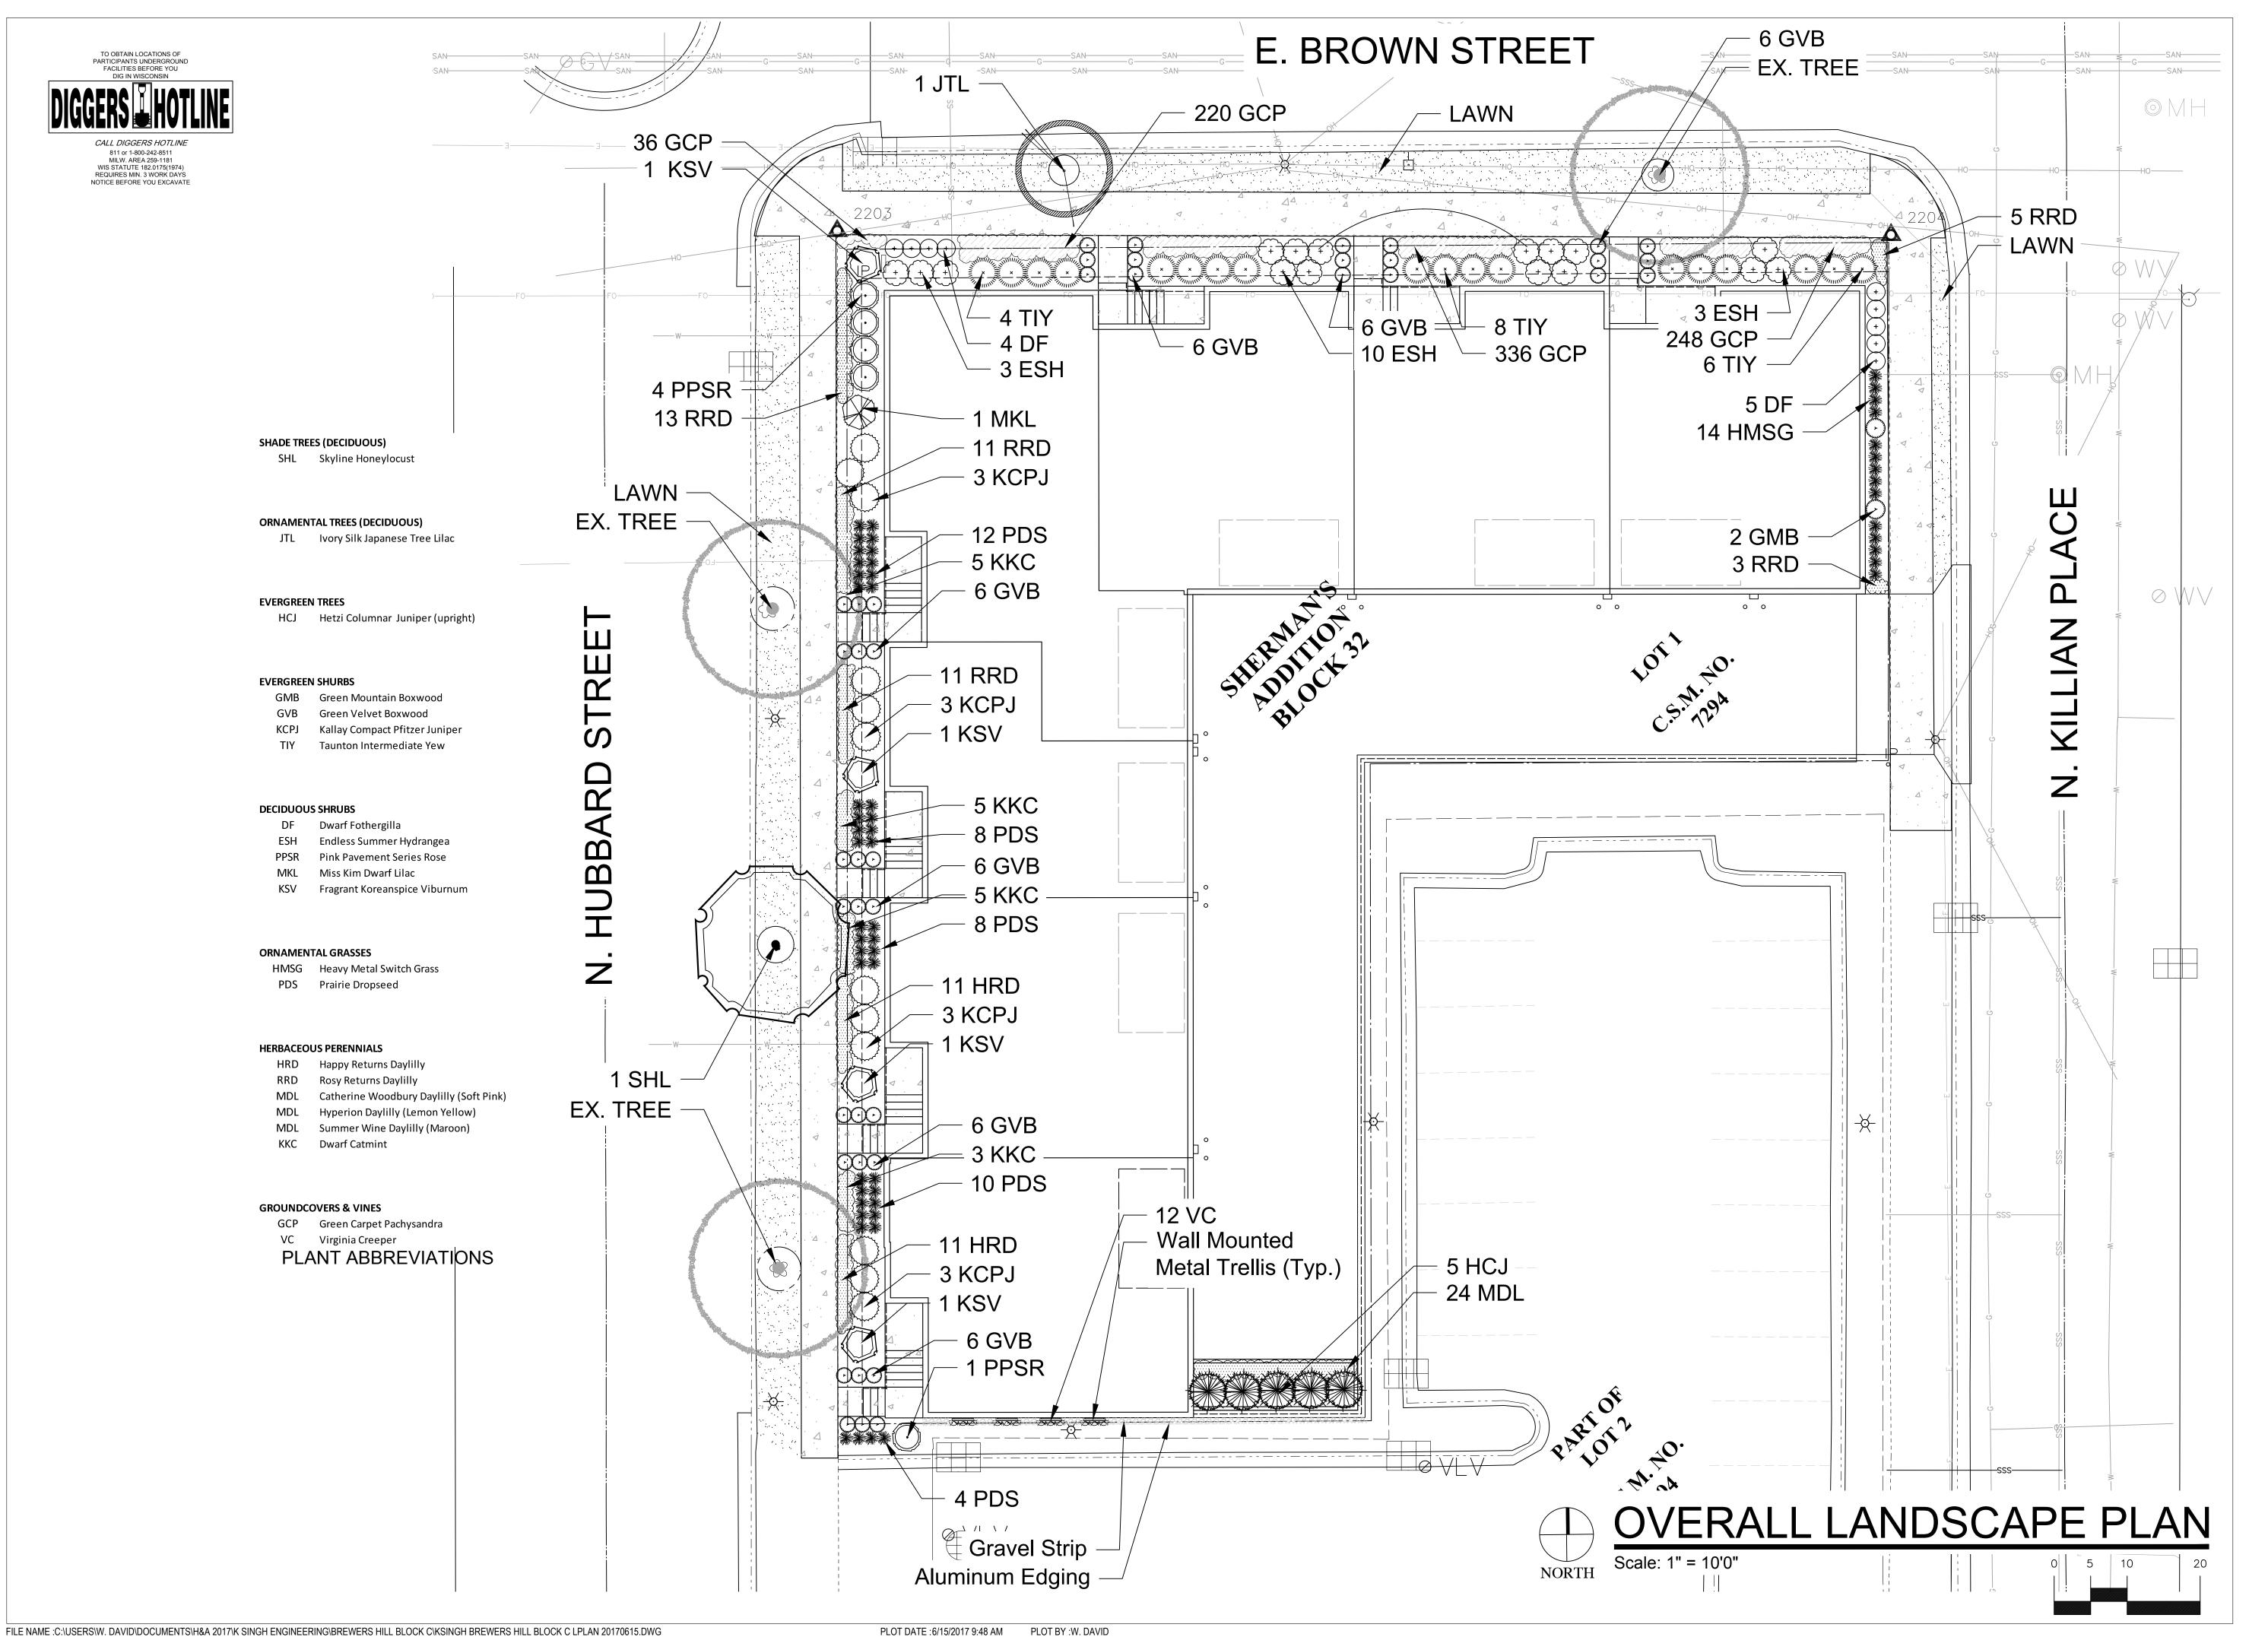

KSingh Engineers Scientists Consultar

3636 North 124th Street Wauwatosa, WI 53222 262-821-1171

HELLER & ASSOCIATES, LLC LANDSCAPE ARCHITECTURE

One Redwood Court Racine, Wisconsin 53402 ph 262.639.9733 fx 262.639.9737 david@wdavidheller.com

CONSULTANT

CONSULTANT

O V


OJECT TITLE: THE HILLS LUXURY COMMONS BI ENT: ROYAL CAPITAL GROUP, LLC

DRAWN BY WDH/PCA 06/15/2017

CHECKED BY APS 06/15/2017

L 100

1 of 2

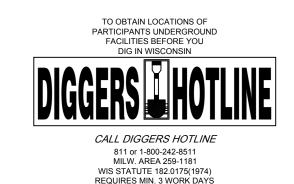

NOTICE BEFORE YOU EXCAVAT

Seed Compositions: Cedar Creek Premium Blue Tag (Ph: 888-313-6807) 10% Mid Atlantic Kentucky Bluegrass 20% Merit Kentucky Bluegrass 20% Boreal Red Fescue

20% Pennant Fine Perennial Ryegrass

10% Atlantis Kentucky Bluegrass 10% Dragon Kentucky Bluegrass 10% Palmer III Fine Perennial Ryegrass Seed at rate of 3# per 1000 SF

- 1. Contractor responsible for contacting Diggers Hotline (811 or 800-242-8511) to have site marked prior to excavation or planting.
- 2. Contractor to verify all plant quantities shown on Plant & Material List and landscape planting symbols and report any discrepancies to Landscape Architect or General Contractor.
- 3. All plantings shall comply with standards as described in American Standard of Nursery Stock Z60.1 ANSI (latest version). Landscape Architect reserves the right to inspect, and potentially reject any plants that are inferior, compromised, undersized, diseased, improperly transported, installed incorrectly or damaged. No sub-standard "B Grade" or "Park Grade" plant material shall be accepted. Plant material shall originate from nursery(ies) with a similar climate as the planting site.
- 4. Any potential plant substitutions must be approved by Landscape Architect or Owner. All plants must be installed as per sizes indicated on Plant & Material Schedule, unless approved by Landscape Architect. Any changes to sizes shown on plan must be submitted in writing to the Landscape Architect prior to installation.
- 5. Topspoil in Parking Lot Islands (if applicable): All parking lot islands to be backfilled with topsoil to a minimum depth of 18" to insure long-term plant health. Topsoil should be placed within 3" of finish grade by General Contractor / Excavation Contractor during rough grading operations/activity. The landscape contractor shall be responsible for the fine grading of all disturbed areas, planting bed areas, and lawn areas. Crown all parking lot islands a minimum of 6" to provide proper drainage, unless otherwise specified
- 6. Tree Planting: Plant all trees slightly higher than finished grade at the root flare. Remove excess soil from the top of the root ball, if needed. Remove and discard non-biodegradable ball wrapping and support wire. Removed biodegradable burlap and wire cage (if present) from the top $\frac{1}{3}$ of the rootball and carefully bend remaining wire down to the bottom of the hole. Once the tree has been placed into the hole and will no longer be moved, score the remaining \frac{2}{3} of the burlap and remove the twine. Provide one slow release fertilizer packets (per 1" caliper) for each tree planted.
- 7. Tree Planting: Backfill tree planting holes 80% existing soils removed from excavation and 20% Soil Amendments (see Note 11). Avoid air pockets and do not tamp soil down. Discard any gravel, rocks, heavy clay, or concrete pieces. When hole is $\frac{2}{3}$ full, trees shall be watered thoroughly, and water left to soak in before proceeding to fill the remainder of the hole. Water again to full soak in the new planting. Each tree shall receive a 3" deep, 4-5' diameter (see planting details or planting plan) shredded hardwood bark mulch ring / saucer around all trees. Do not build up any mulch onto the trunk of any tree. Trees that are installed incorrectly will be replaced at the time and expense of the Landscape Contractor.
- 8. Shrub Planting: All shrubs to be planted in groupings as indicated on the Landscape Plan. Install with the planting of shrubs a $\frac{50}{50}$ mix of Soil Amendments with blended, pulverized topsoil. Install topsoil into all plant beds as needed to achieve proper grade and displace undesirable soils (see planting detail). Remove all excessive gravel, clay and stones from plant beds prior to planting. When hole(s) are $\frac{2}{3}$ full, shrubs shall be watered thoroughly, and water left to soak in before proceeding. Provide slow-release fertilizer packets at the rater of 1 per 24" height/diamter of shrub at planting.
- 9. Mulching: All tree rings to receive a 3" deep layer of high quality shredded hardwood bark mulch (not pigment dyed or enviro-mulch). All shrub planting and perennial planting bed areas (groupings) shall receive a 2-3" layer of shredded hardwood bark mulch, and groundcover areas a 1-2" layer of the same mulch. Do not mulch annual flower beds (if applicable). Do not allow mulch to contact plant stems and tree trunks.
- 10. Edging: All planting beds shall be edged with a 4" deep spade edge using a flat landscape spade or a mechanical edger. Bedlines are to be cut crisp, smooth as per plan. A clean definition between landscape beds and lawn is required. Pack mulch against lawn edge to hold in place.
- 11. Plant bed preparation/Soil Amendment composition: All perennial, groundcover and annual areas (if applicable) are required to receive a blend of organic soil (Soil Amendments) amendments prior to installation. Roto-till the following materials at the following ratio, into existing soil beds or installed topsoil beds to a depth of approximately 8"-10". Containerized and balled & burlapped plant material should be back-filled with amended soil:

Per 100 SF of bed area (Soil Amendment composition):

3/4 CY Peat Moss or Mushroom Compost

3/4 CY blended/pulverized Topsoil $\frac{1}{4}$ CY composted manure

In roto-tilled beds only, also include in above mixture:

2 lbs Starter Fertilizer

12. Installation preparation for all seeded areas: remove/kill off any existing unwanted vegetation prior to seeding. Prepare the topsoil (if adequate or provide as in item #6 above) and seed bed by removing all surface stones 1" or larger. Apply a starter fertilizer (20-10-5, or approved comparable) and specified seed uniformly at the specified rate, and provide mulch covering suitable to germinate and establish turf. Provide seed and fertilizer specifications to Landscape Architect and Owner prior to installation. Erosion control measures are to be used in swales and on slopes in excess of 1:3 and where applicable (see Civil Engineering Drawings). Methods of installation may vary are the discretion of the Landscape Contractor on his/her responsibility to establish and guarantee a smooth, uniform, quality turf. A minimum of 2" of blended, prepared and non-compacted topsoil is required for all lawn areas. If straw mulch is used as a mulch covering, a tackifier may be necessary to avoid wind dispersal of mulch covering. Marsh hay containing reed canary grass is NOT acceptable as a mulch covering.

An acceptable quality seed installation is defined as having:


No bare spots larger than one (1) square foot


No more than 10% of the total area with bare areas larger than one (1) square foot


A uniform coverage through all turf areas


- 13. Warranty and Replacements: All plantings are to be watered thoroughly at the time of planting, through construction and upon completion of project as required. Trees, Evergreens, and Shrubs (deciduous and evergreen) shall be guaranteed (100% replacement) for a minimum of one (1) year from the date of project completion. Perennials, groundcovers, and ornamental grasses shall be guaranteed for a minimum of one (1) growing season. Perennials, groundcovers, and ornamental grasses planted after September 15th shall be guaranteed through May 31st of the following year. Only one replacement per plant will be required during the warranty period, except for losses or replacements due to failure to comply with specified requirements. Watering and general ongoing maintenance instructions are to be supplied by the Landscape Contractor to the Owner upon completion of the project.
- 14. The Landscape Contractor is responsible for the watering and maintenance of all landscape areas for a period of 45 days after the substantial completion of the landscape installation. This shall include all trees, shrubs, evergreens, perennials, ornamental grasses, turf grass, no-mow grass, and native prairie seed mix / stormwater seed mix. Work also includes weeding, edging, mulching (only if required), fertilizing, trimming, sweeping up grass clippings, pruning and deadheading.
- 15. Project Completion: Landscape Contractor is responsible to conduct a final review of the project, upon completion, with the Landscape Architect, Client or Owner / Client Representative, and the General Contractor to answer questions, provide written care instructions for new plantings and turf, and insure that all specifications have been met.


LANDSCAPE GENERAL NOTES

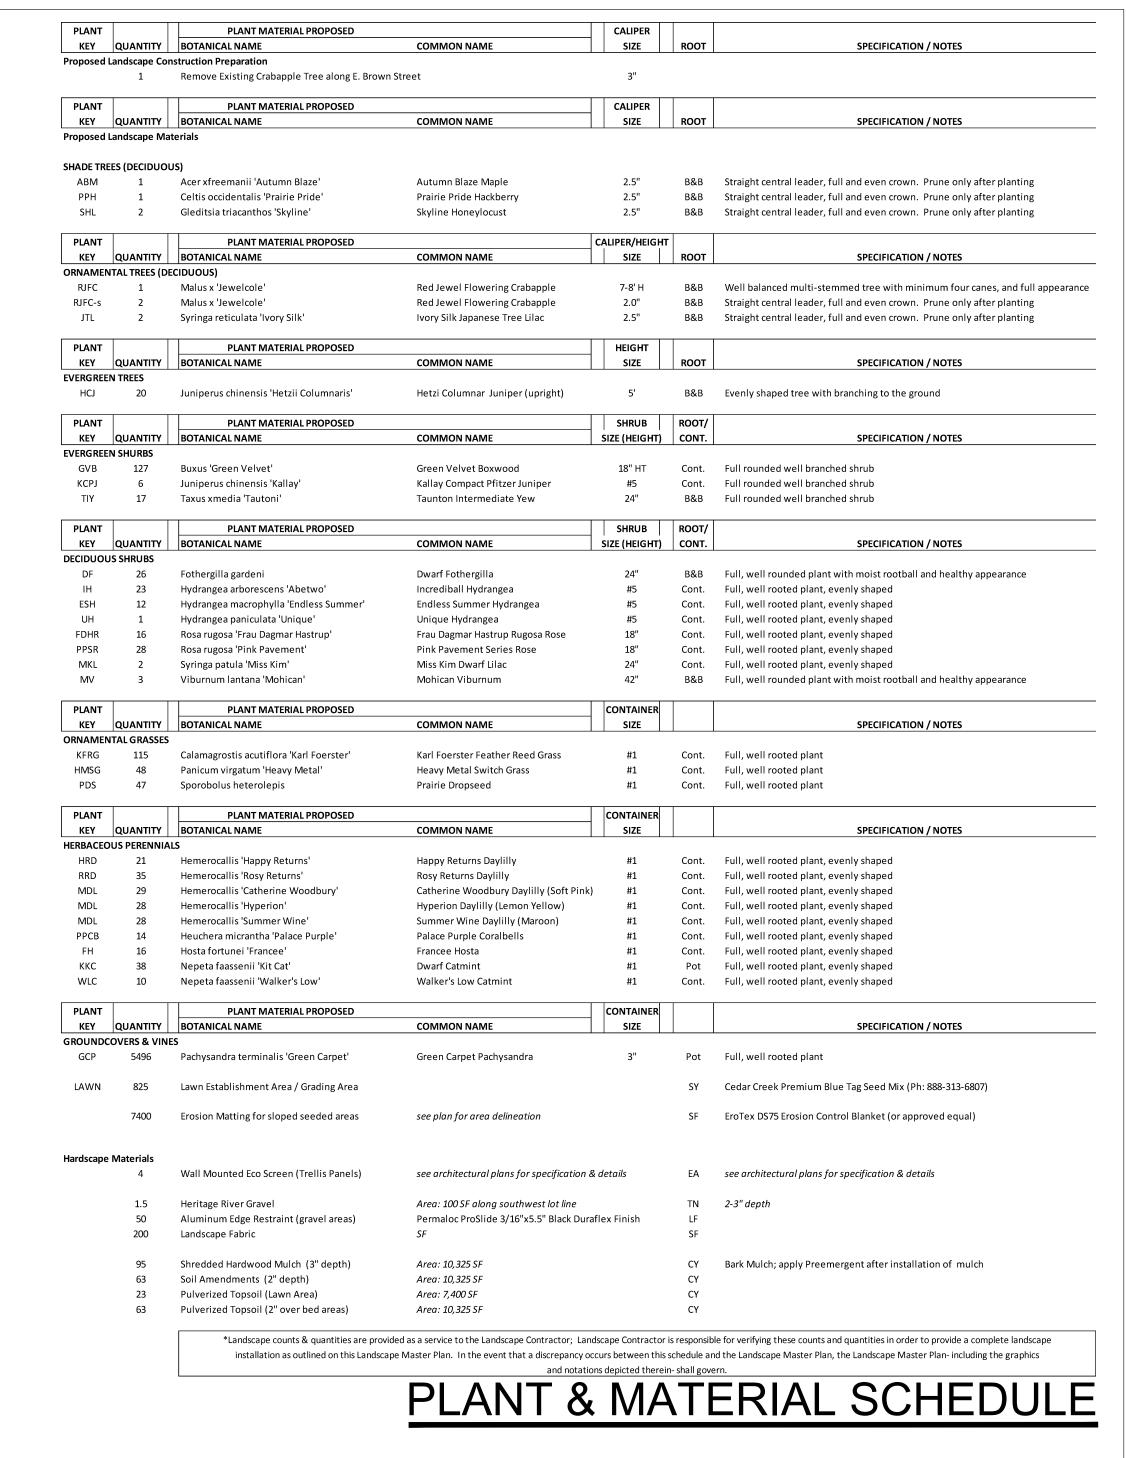


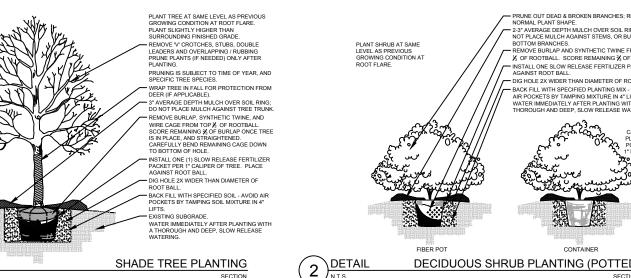

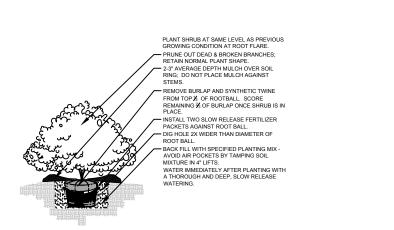

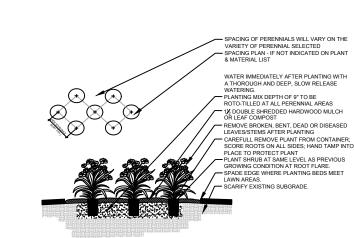

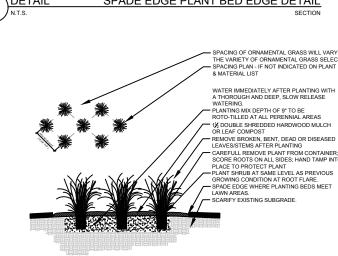

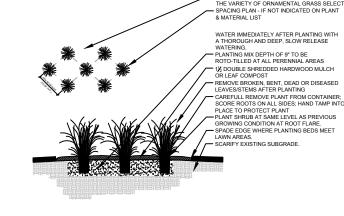

PLANTING & HARDSCAPE DETAILS



3636 North 124th Street Wauwatosa, WI 53222 262-821-1171



CONSULTANT

 \circ

쩝

WDH/PCA 06/15/2017

DATE

06/15/2017

CHECKED BY



E. BROWN ST. AND N. HUBBARD ST. MILWAUKEE, WI

Royal Capital Group, LLC.
710 E. Plankinton Ave, Suite 300

Milwaukee, WI 53203

PROJECT NUMBER

ISSUED FOR:

REVIEW SET	06/16/17
REVISION FOR: NO. DESCRIPTION	DATE


REVIEW SET - NOT FOR CONSTRUCTION

DRAWN BY Author
CHECKED BY Checker

ELEVATIONS





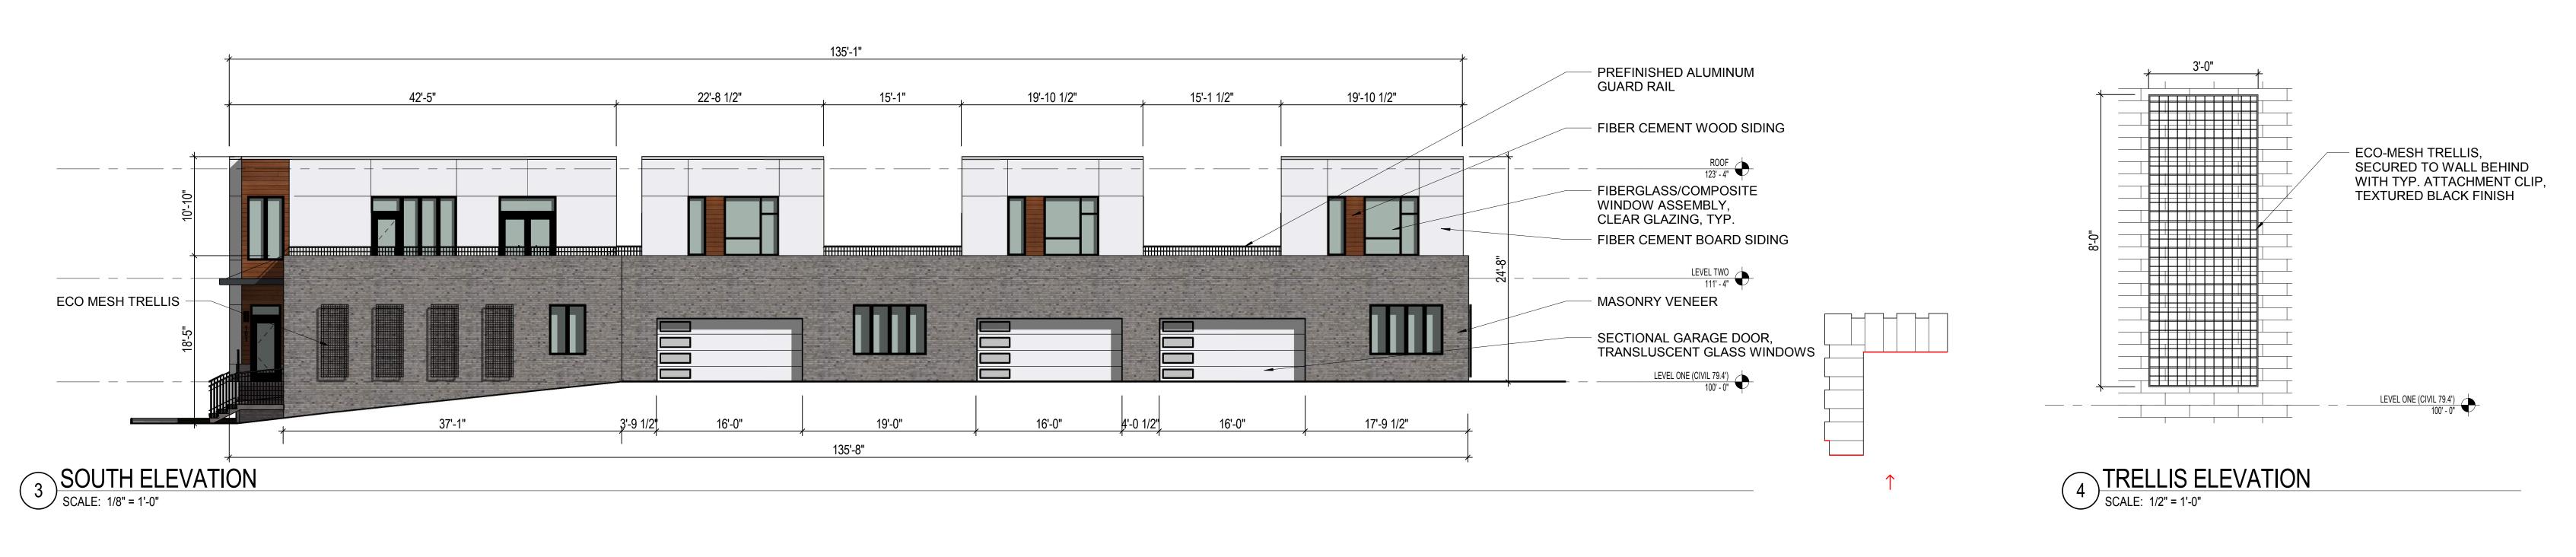

THE HILLS LUXURY COMMONS- BLOCK C

172715.02

E. BROWN ST. AND N. HUBBARD ST. MILWAUKEE, WI

Royal Capital Group, LLC. 710 E. Plankinton Ave, Suite 300 Milwaukee, WI 53203

PROJECT NUMBER

ISSUED FOR:	
REVIEW SET	06/16/17
REVISION FOR:	DATE

NO. DESCRIPTION


REVIEW SET - NOT FOR CONSTRUCTION


DRAWN BY Author


CHECKED BY Checker

ELEVATIONS



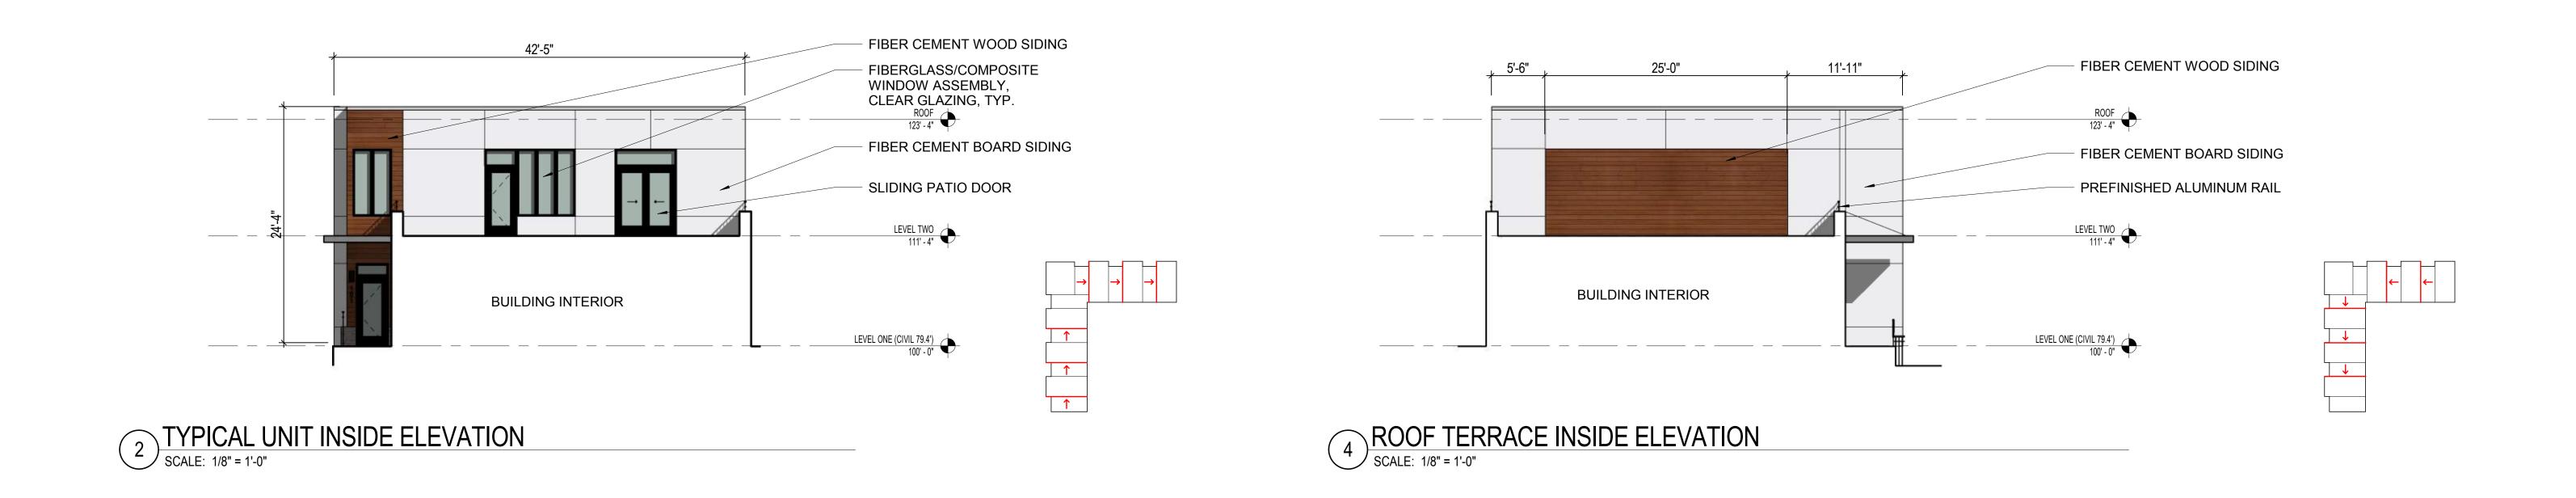

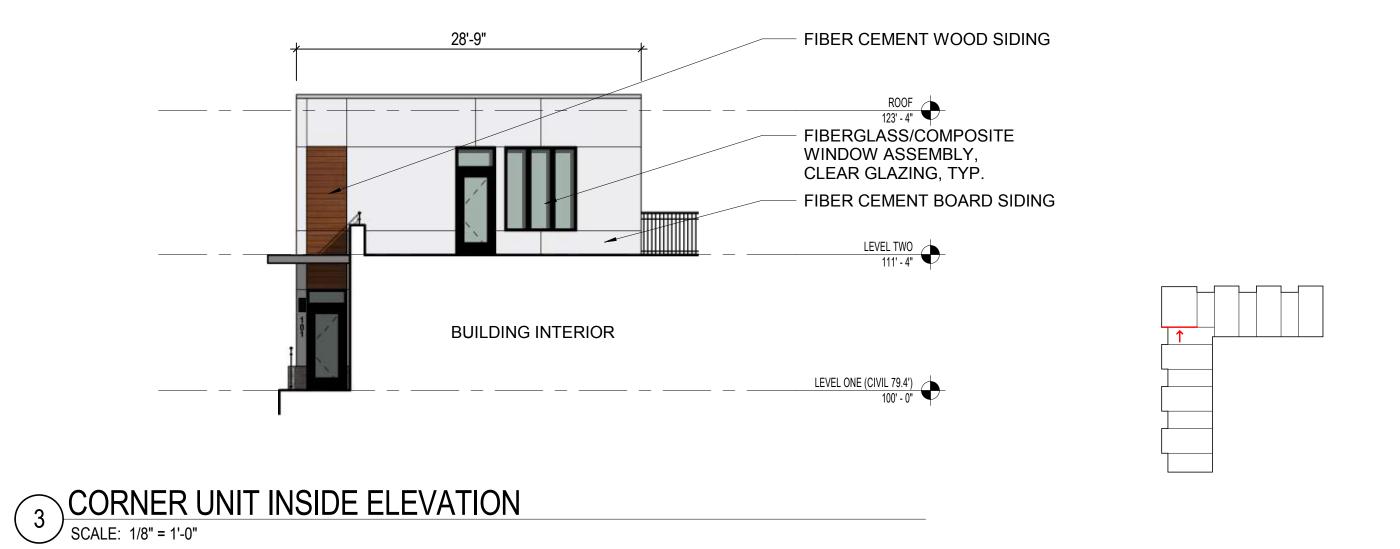

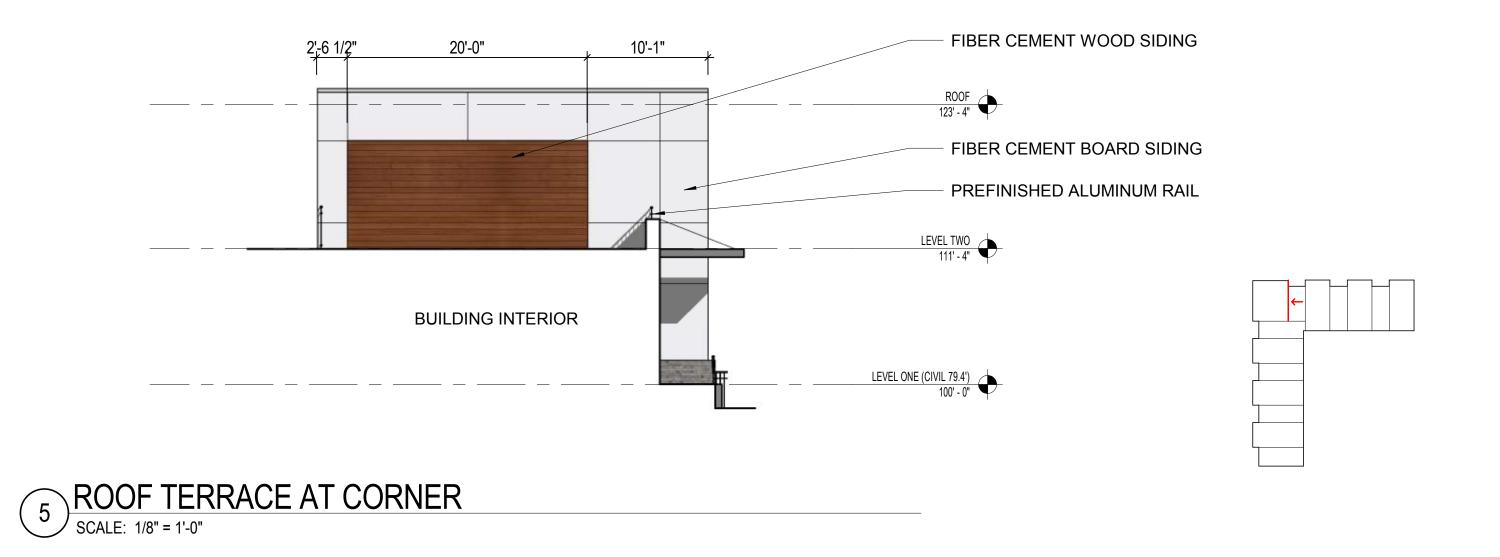

THE HILLS LUXURY COMMONS- BLOCK C


E. BROWN ST. AND N. HUBBARD ST. MILWAUKEE, WI

Royal Capital Group, LLC. 710 E. Plankinton Ave, Suite 300 Milwaukee, WI 53203

PROJECT NUMBER

ISSUED FOR: REVIEW SET	06/16/17
REVISION FOR:	DATE

NO. DESCRIPTION

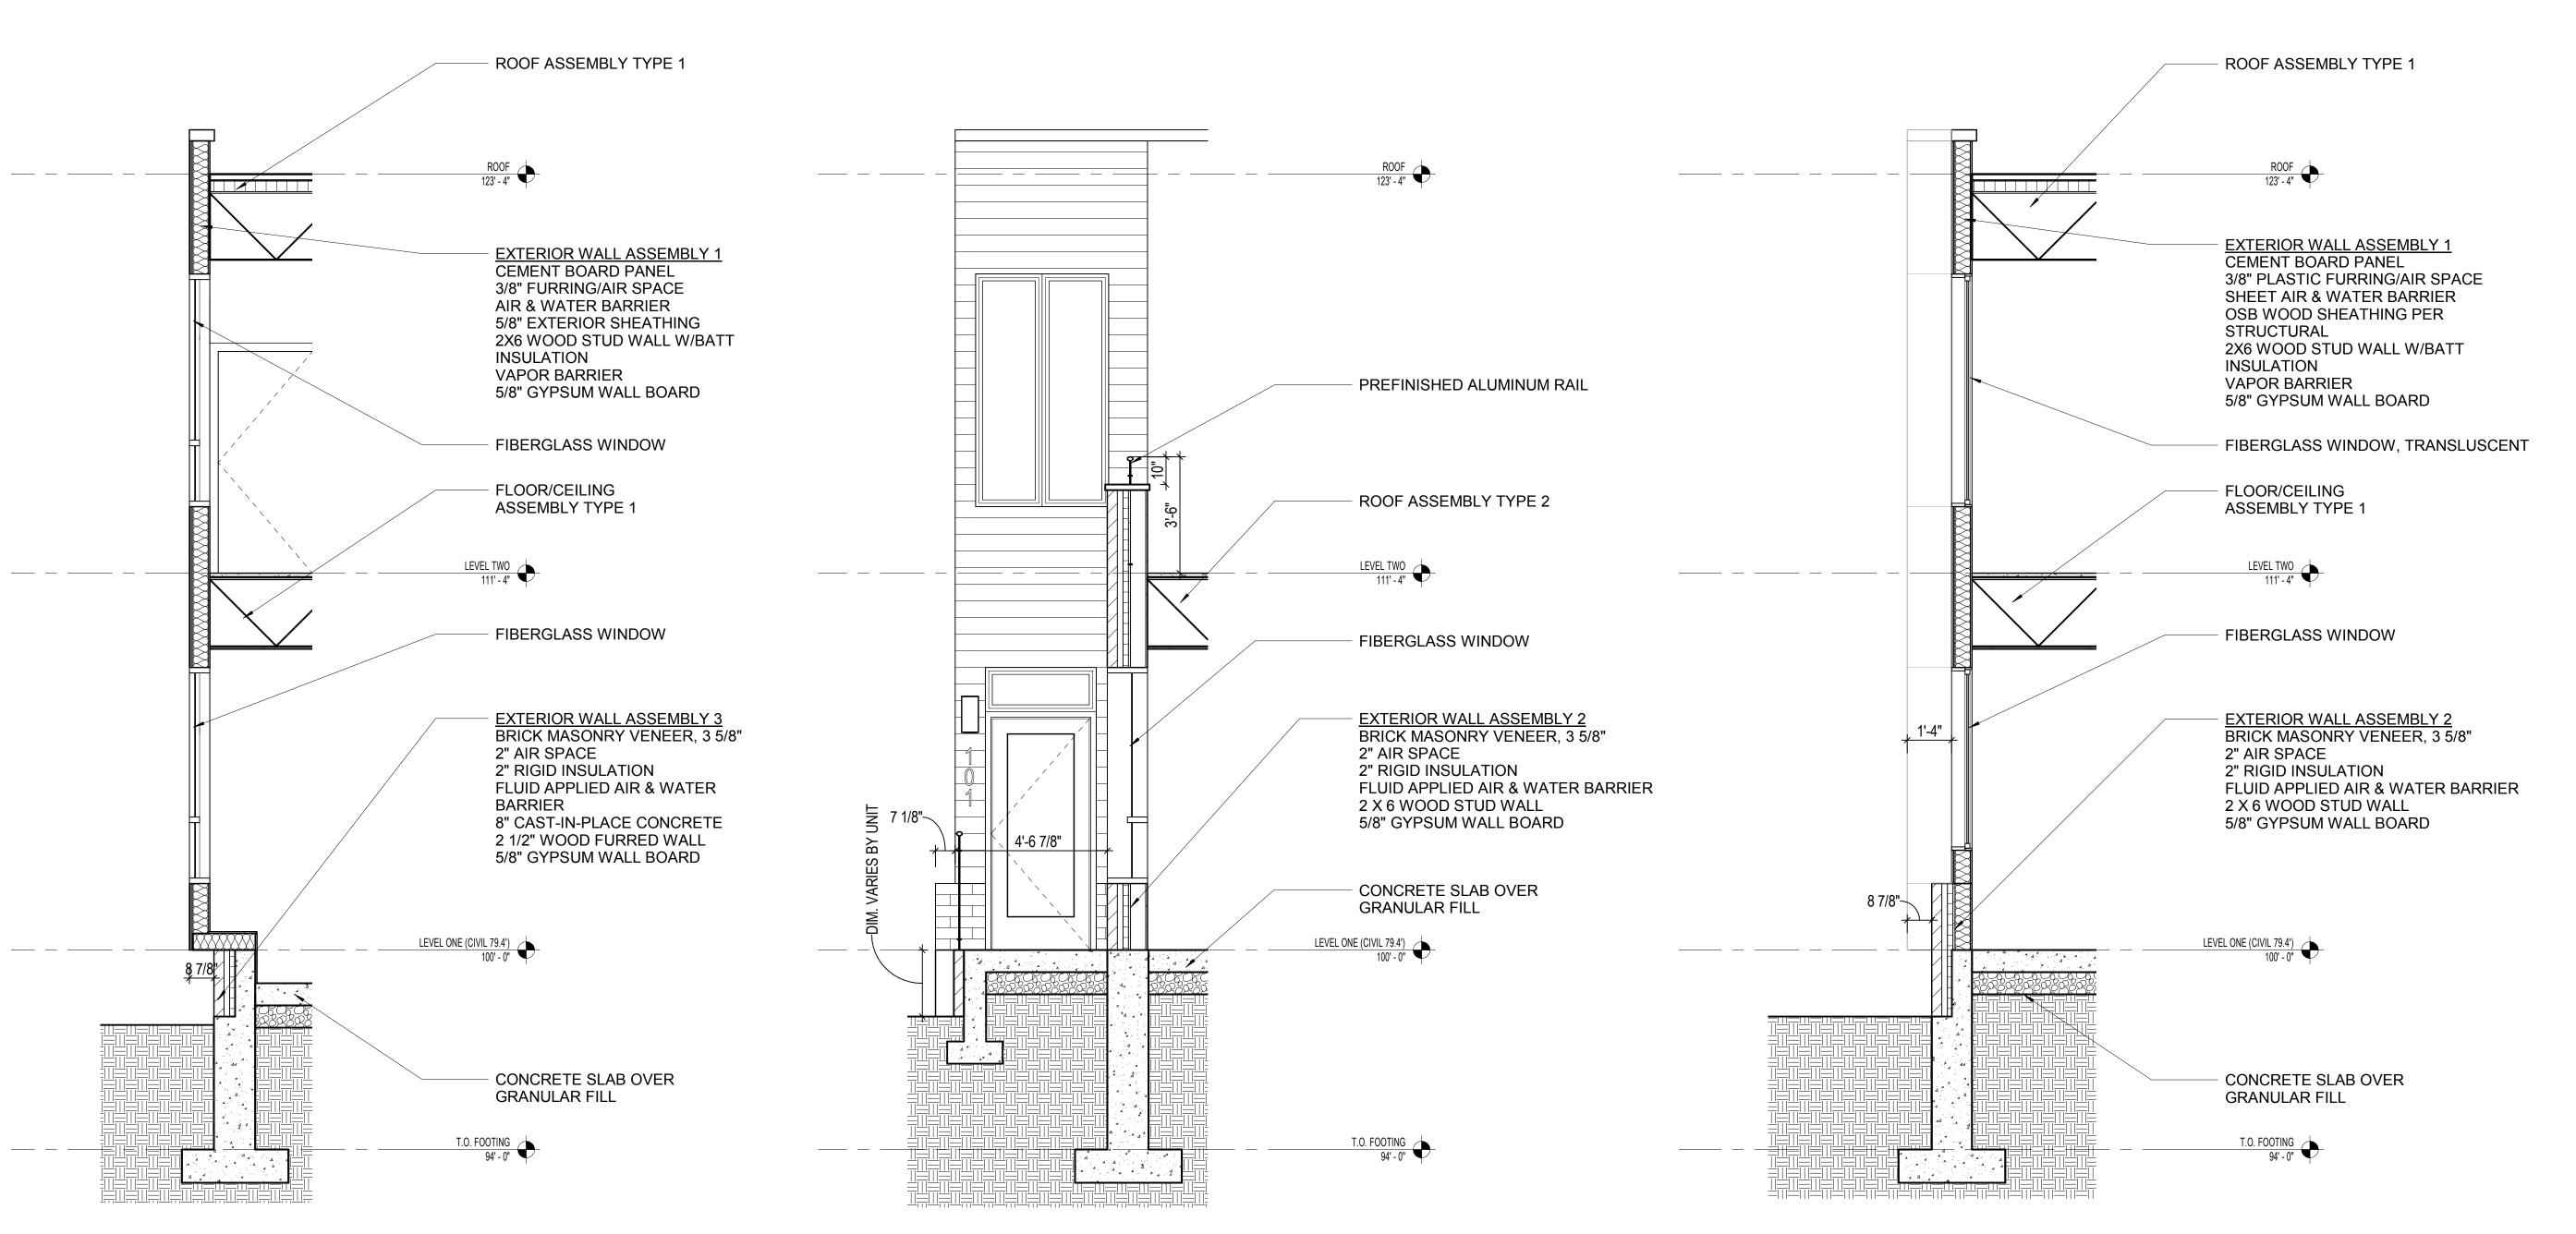

WALL SECTION AT WOOD SIDING

SCALE: 3/8" = 1'-0"

WALL SECTION AT 1-STORY MASONRY WALL

SCALE: 3/8" = 1'-0"

A510

REVIEW SET - NOT FOR CONSTRUCTION

DRAWN BY Author

CHECKED BY Checker

WALL SECTIONS





THE HILLS LUXURY COMMONS- BLOCK C

PERSPECTIVE VIEW ALONG E. BROWN ST. SCALE:

MILWAUKEE | MADISON | TUSCON | CHICAGO | Engberg Anderson Project No. 172715.02