







The images above are shown as an example of corten steel planter boxes that were used in a similar water feature context.



THE UNDERGROUND UTILITY INFORMATION SHOWN ON THIS MAP IS BASED ON FIELD MARKINGS AND INFORMATION FURNISHED BY UTILITY COMPANIES AND THE LOCAL MUNICIPALITY. WHILE THIS INFORMATION IS BELIEVED TO BE RELIABLE, ITS ACCURACY AND COMPLETENESS CANNOT BE GUARANTEED.

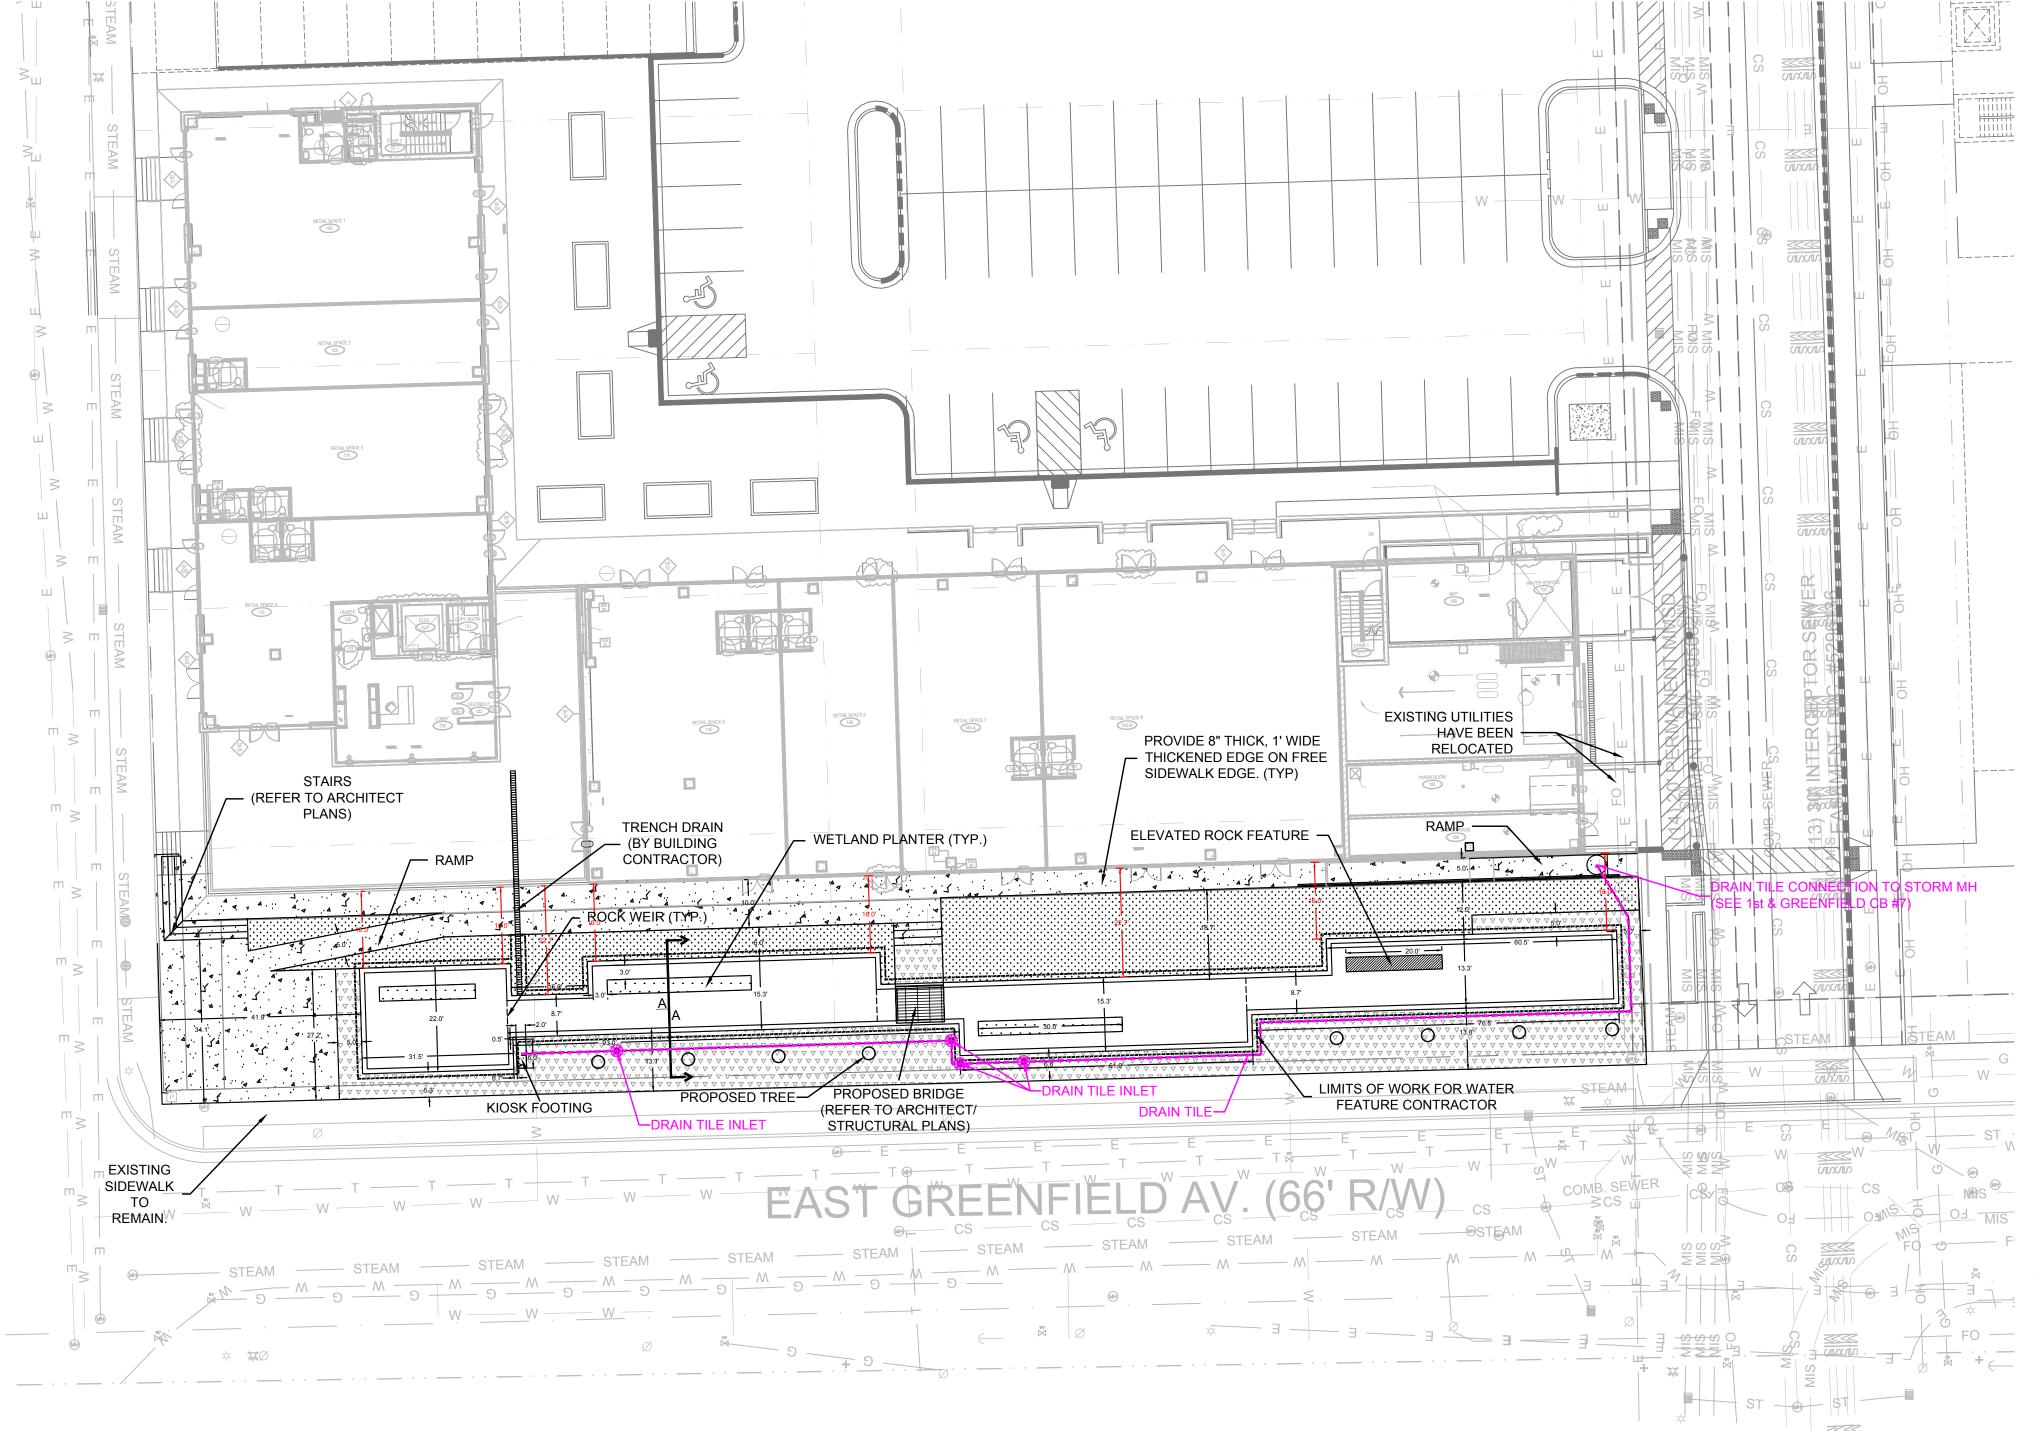


WATER FEATURE SECTION VIEW A-A-PLANTER WALL — PROPOSED DRAIN TILE -- COMPACTED SUBGRADE - LINER SYSTEM

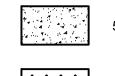


5" THICK CONCRETE WALK



OVERLAND PLANTER

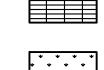

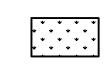

LANDSCAPE AREA (REFER TO ARCHITECT



GRAVEL/ GRANITE



DRAIN TILE



- THE UNDERGROUND UTILITY INFORMATION SHOWN ON THIS DRAWING IS BASED ON FIELD LOCATIONS AND/OR RECORDS FURNISHED BY MUNICIPALITIES ACCURACY OF WHICH CANNOT BE GUARANTEED. THERE MAY BE ADDITIONAL UNDERGROUND UTILITY INSTALLATIONS WITHIN THE PROJECT AREA THAT
- 2. VERIFY ACTUAL LOCATIONS AND INVERTS IN THE FIELD. ANY POTENTIAL ERRORS, OMISSIONS, OR DISCREPANCIES SHALL BE BROUGHT TO THE ATTENTION OF THE ENGINEER PRIOR TO PROCEEDING WITH CONSTRUCTION.
- WORK TO BE COMPLETED IS INDICATED IN BOLD TYPE LINES AND EXISTING CONDITIONS ARE INDICATED BY LIGHT TYPE LINES.
- 4. ELECTRONIC CIVIL FILES ARE AVAILABLE UPON WRITTEN REQUEST. DO NOT USE ELECTRONIC CIVIL FILES TO LAYOUT FOUNDATIONS, COLUMN LINES, LIGHT POLES, OR OTHER NON CIVIL SITE WORK. REFER TO ARCHITECTURAL DRAWINGS FOR DIMENSIONS OF BUILDING AND ARCHITECTURAL FEATURES.
- 5. DIMENSIONS ARE FROM FACE OF CURB OR EDGE OF
- 6. WORK WITHIN THE PUBLIC RIGHT OF WAY, INCLUDING BUT NOT LIMITED TO DRIVEWAY CURB AND GUTTER SHALL BE COMPLETED PER MUNICIPAL AND/OR COUNTY REQUIREMENTS AND STANDARDS.

SIGMA www.thesigmagroup.com 1300 West Canal Street Milwaukee, WI 53233 Phone: 414-643-4200 Fax: 414-643-4210

10-25-2016 9-22-2016 ISSUED FOR CONSTRUCTION 8-31-2016 NO. REVISION DATE BY


DRAWING NO. 15867 - Site Plan and Details.dwg

DRAWN BY: JWK DATE: 9-22-2016

PROJECT NO: 15867 CHECKED BY: CTC

APPROVED BY: SHEET NO.:

C 100

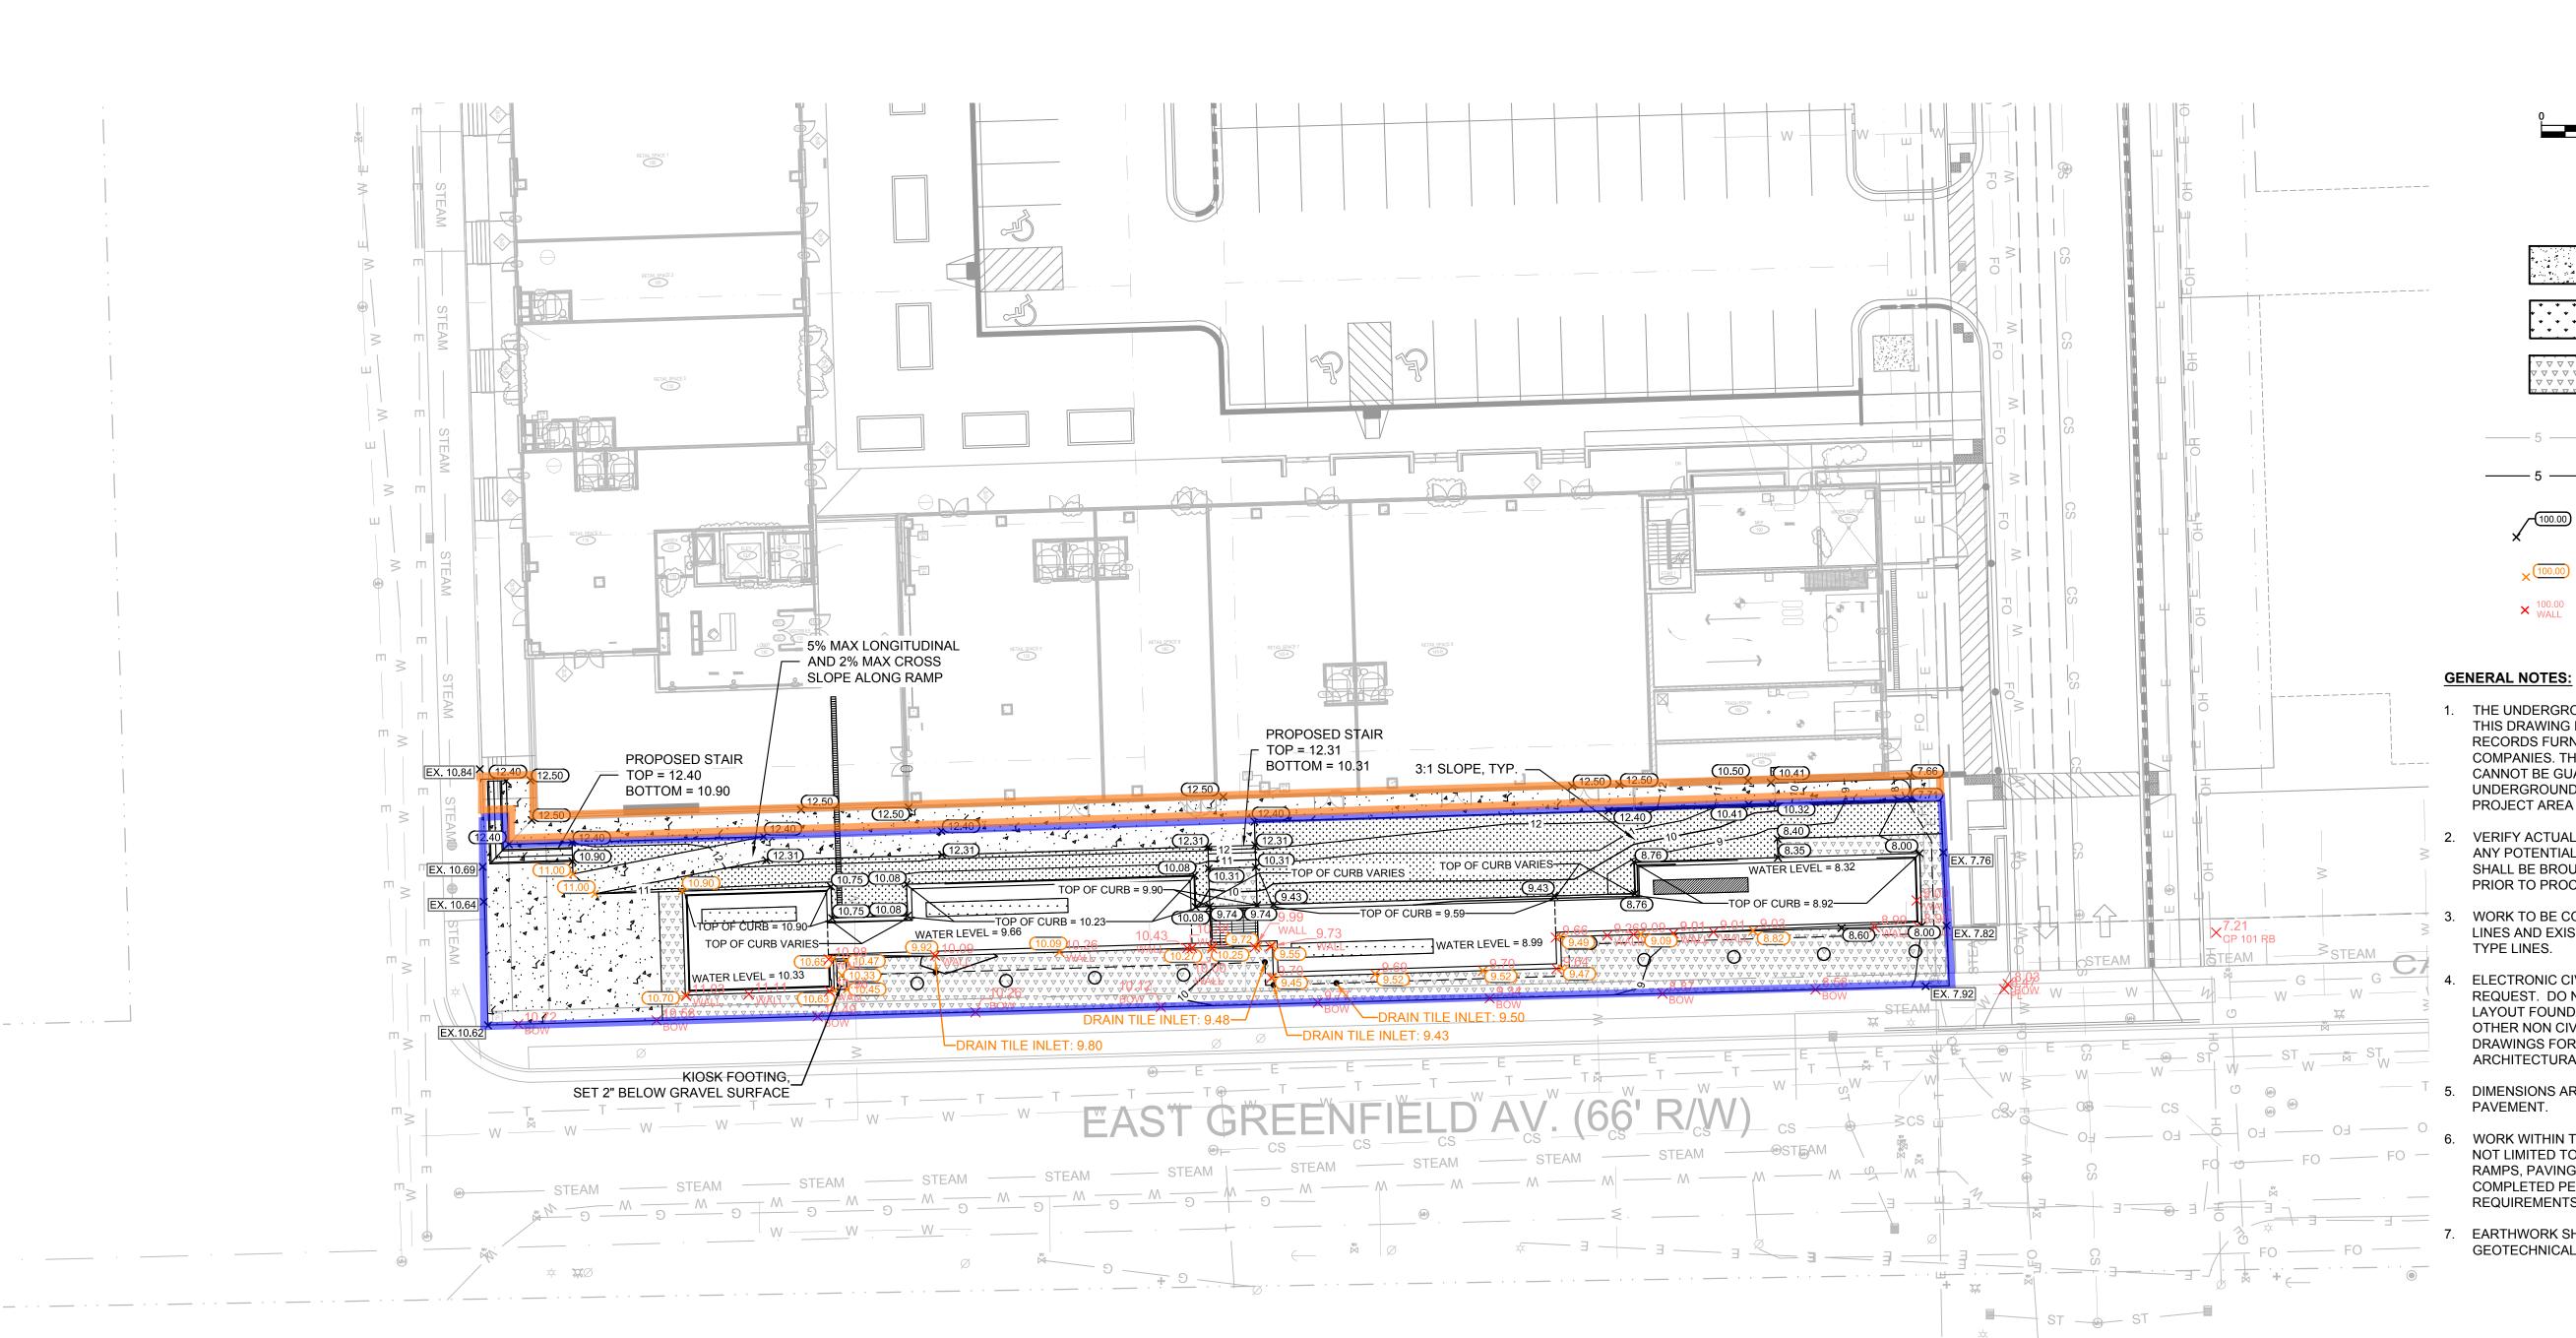



LEGEND:

TO ARCHITECT PLANS)

5" THICK CONCRETE WALK

LANDSCAPE AREA (REFER

GRAVEL/ GRANITE

_____ 5 ____ EXISTING CONTOUR _____ 5 ____ PROPOSED CONTOUR

PROPOSED ASPHALT SPOT GRADE

× (100.00) SPOT GRADE CHANGED 10/24/2016

100.00 WALL SPOT GRADES SHOT 10/21/2016

THE UNDERGROUND UTILITY INFORMATION SHOWN ON THIS DRAWING IS BASED ON FIELD LOCATIONS AND/OR RECORDS FURNISHED BY MUNICIPALITIES AND UTILITY COMPANIES. THE LOCATION AND ACCURACY OF WHICH CANNOT BE GUARANTEED. THERE MAY BE ADDITIONAL UNDERGROUND UTILITY INSTALLATIONS WITHIN THE PROJECT AREA THAT ARE NOT SHOWN.

 VERIFY ACTUAL LOCATIONS AND INVERTS IN THE FIELD. ANY POTENTIAL ERRORS, OMISSIONS, OR DISCREPANCIES SHALL BE BROUGHT TO THE ATTENTION OF THE ENGINEER PRIOR TO PROCEEDING WITH CONSTRUCTION.

3. WORK TO BE COMPLETED IS INDICATED IN BOLD TYPE LINES AND EXISTING CONDITIONS ARE INDICATED BY LIGHT TYPE LINES.

4. ELECTRONIC CIVIL FILES ARE AVAILABLE UPON WRITTEN REQUEST. DO NOT USE ELECTRONIC CIVIL FILES TO LAYOUT FOUNDATIONS, COLUMN LINES, LIGHT POLES, OR OTHER NON CIVIL SITE WORK. REFER TO ARCHITECTURAL DRAWINGS FOR DIMENSIONS OF BUILDING AND ARCHITECTURAL FEATURES.

5. DIMENSIONS ARE FROM FACE OF CURB OR EDGE OF PAVEMENT.

6. WORK WITHIN THE PUBLIC RIGHT OF WAY, INCLUDING BUT NOT LIMITED TO DRIVEWAY OPENINGS, SIDEWALK AND RAMPS, PAVING, AND CURB AND GUTTER SHALL BE COMPLETED PER MUNICIPAL AND/OR COUNTY REQUIREMENTS AND STANDARDS.

7. EARTHWORK SHALL BE IN ACCORDANCE WITH GEOTECHNICAL ENGINEER'S RECOMMENDATIONS.

GRADING PLAI

CB #3 10-25-2016
CB #2 9-22-2016
CB #1 9-12-2016
ISSUED FOR CONSTRUCTION 8-31-2016
NO. REVISION DATE BY

DRAWING NO. 15867 - SCHEME 2.dwg

DRAWN BY: JWK

DATE: 9-22-2016

PROJECT NO: 15867

CHECKED BY: CTC

APPROVED BY: SHEET NO.:

C 200

PARTICIPANTS UNDERGROUND FACILITIES BEFORE YOU DIG IN WISCONSIN

CALL DIGGERS HOTLINE

1-800-242-8511
TOLL FREE
WIS STATUTE 182.0175(1974)
REQUIRES MIN. 3 WORK DAYS
NOTICE BEFORE YOU EXCAVATE

MILW. AREA 259-1181

THE UNDERGROUND UTILITY INFORMATION SHOWN ON THIS MAP IS BASED ON FIELD MARKINGS AND INFORMATION FURNISHED BY UTILITY COMPANIES AND THE LOCAL MUNICIPALITY. WHILE THIS INFORMATION IS BELIEVED TO BE RELIABLE, ITS ACCURACY AND COMPLETENESS CANNOT BE GUARANTEED.

eppstein uhen : architects

milwaukee 3 3 3 East Chicago Street Milwaukee, Wisconsin 53202 telephone 414 . 271 . 5350 222 West Washington Ave, Suite 650 Madison, Wisconsin 53703 telephone 608.442.5350

PROJECT INFORMATION

Freshwater Plaza -Mixed Use Building

1st and Greenfield Milwaukee, Wisconsin

ISSUANCE AND REVISIONS

CONSTRUCTION DOCUMENTS

DATE DESCRIPTION

1 08/09/16 CB#7


2 08/22/16 WATER FEATURE CONSTRUCTION DOCUMENTS

KEY PLAN

SHEET INFORMATION

PROJECT MANAGER PROJECT NUMBER 11/13/2015

ARCH SITE PLAN

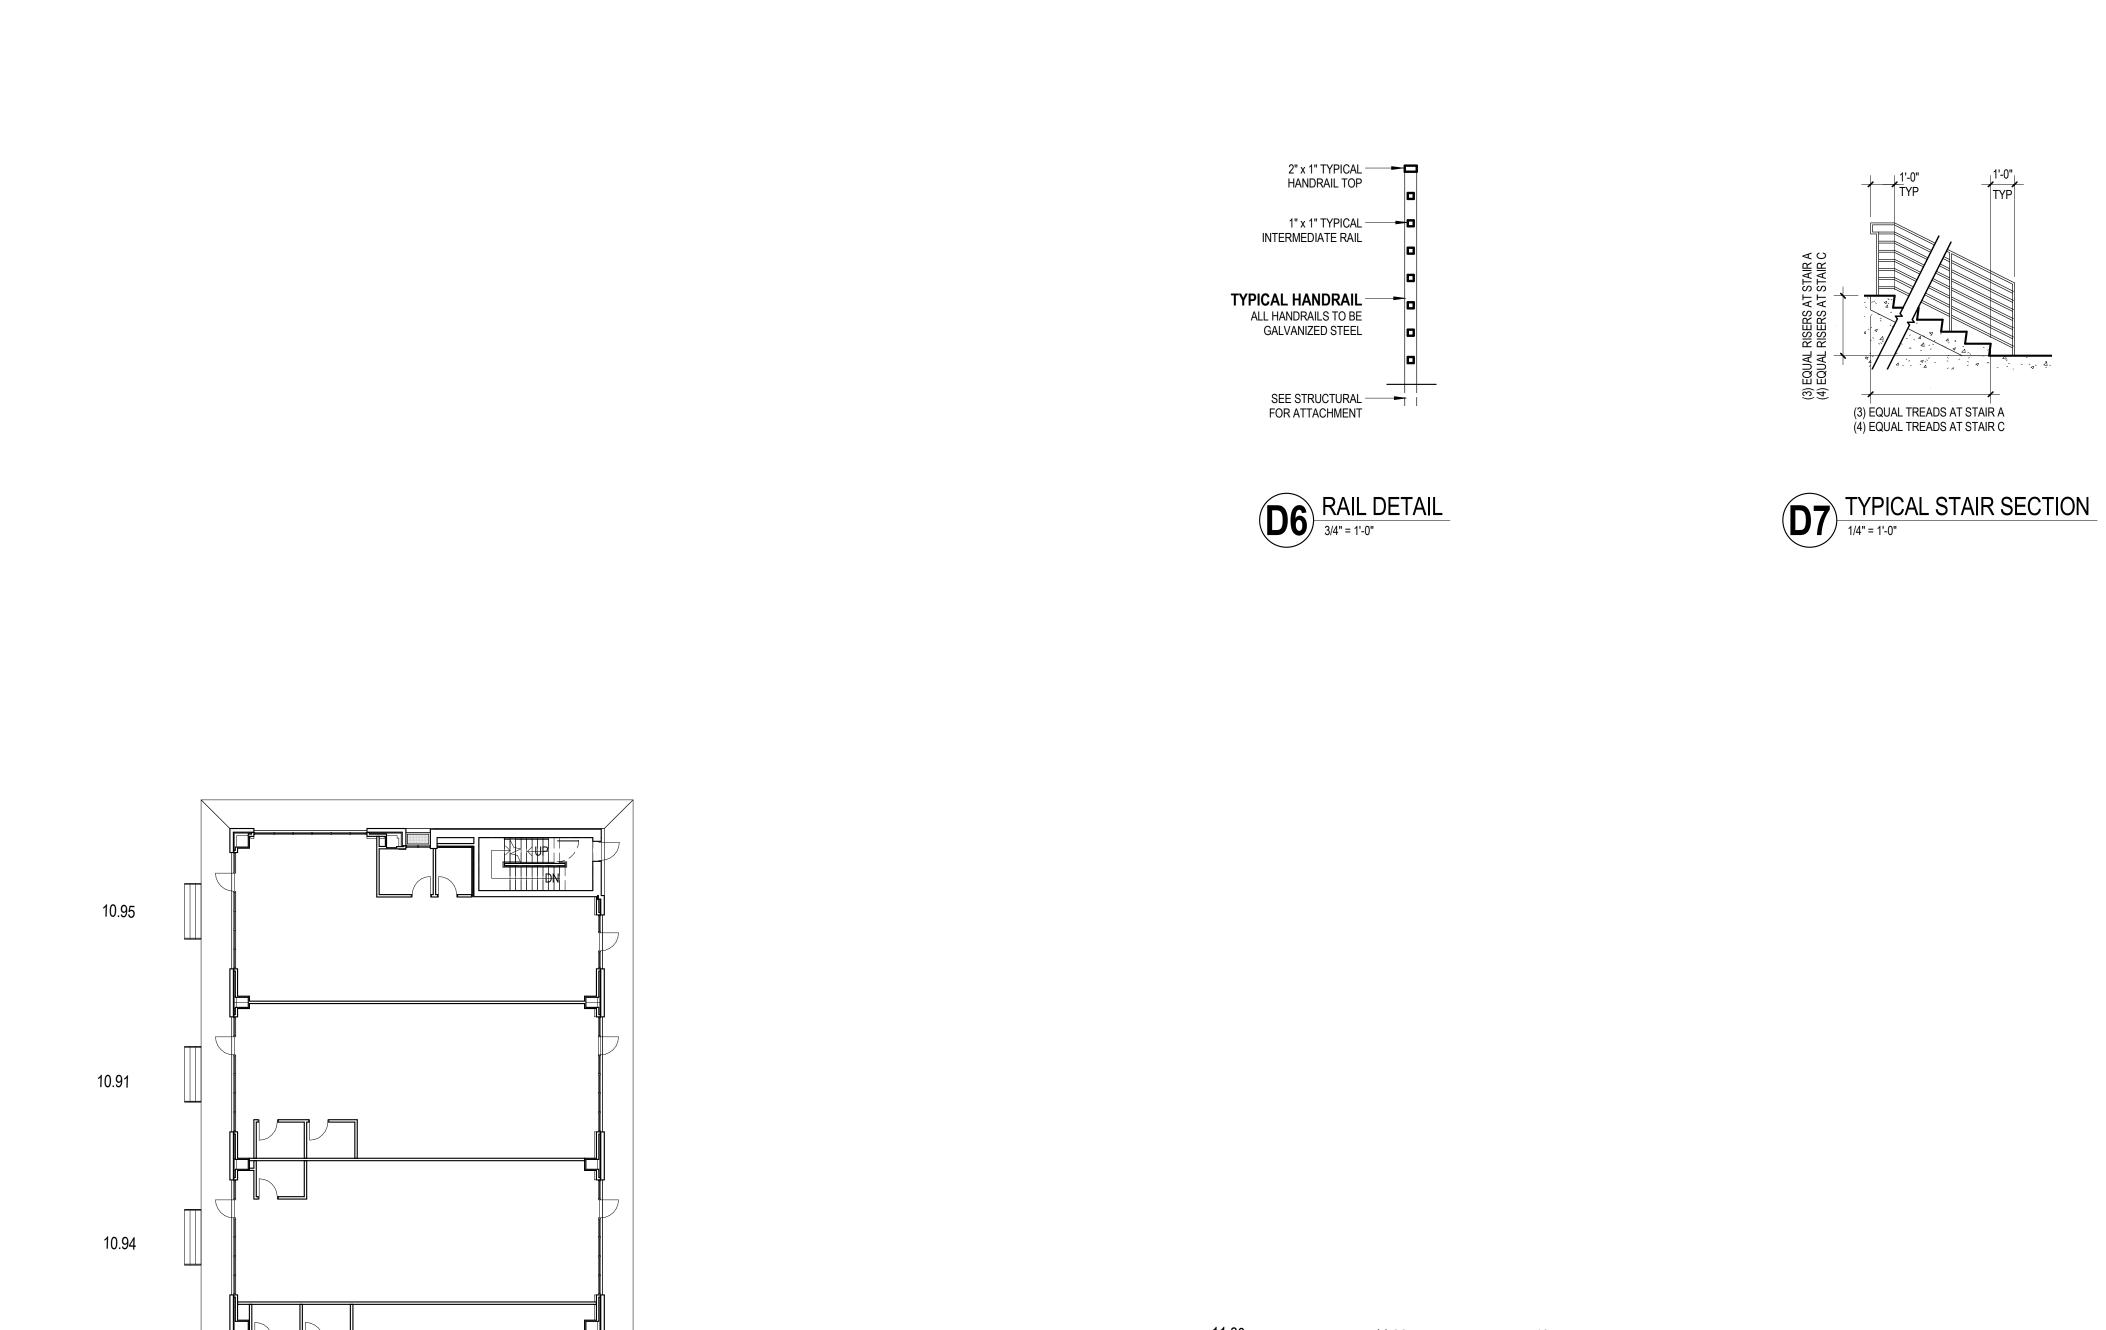

C1 RAILS AT PLAZA

10.97

HAND TROWLED

PICTURE FRAME
CONTROL JOINTS AT
PLAZA

DOUBLE SLAB DRAINBASIS OF DESIGN:
HYDROTECH - SPLIT
SLAB SYSTEM - SEE
MANUFACTURER DETAIL

ARCH SITE PLAN

1/16" = 1'-0"

Align with Plaza downspout

By Water Feature Contractor


PROVIDE FOUNDATION WALL FOR INFORMATION KIOSK


STAIR C

SEE CIVIL FOR ELEVATIONS, PLAN POSITION OF BRIDGE, STAIR A, STAIR C, AND OTHER INFORMATION.

AS400

© Eppstein Uhen Architects, Inc.

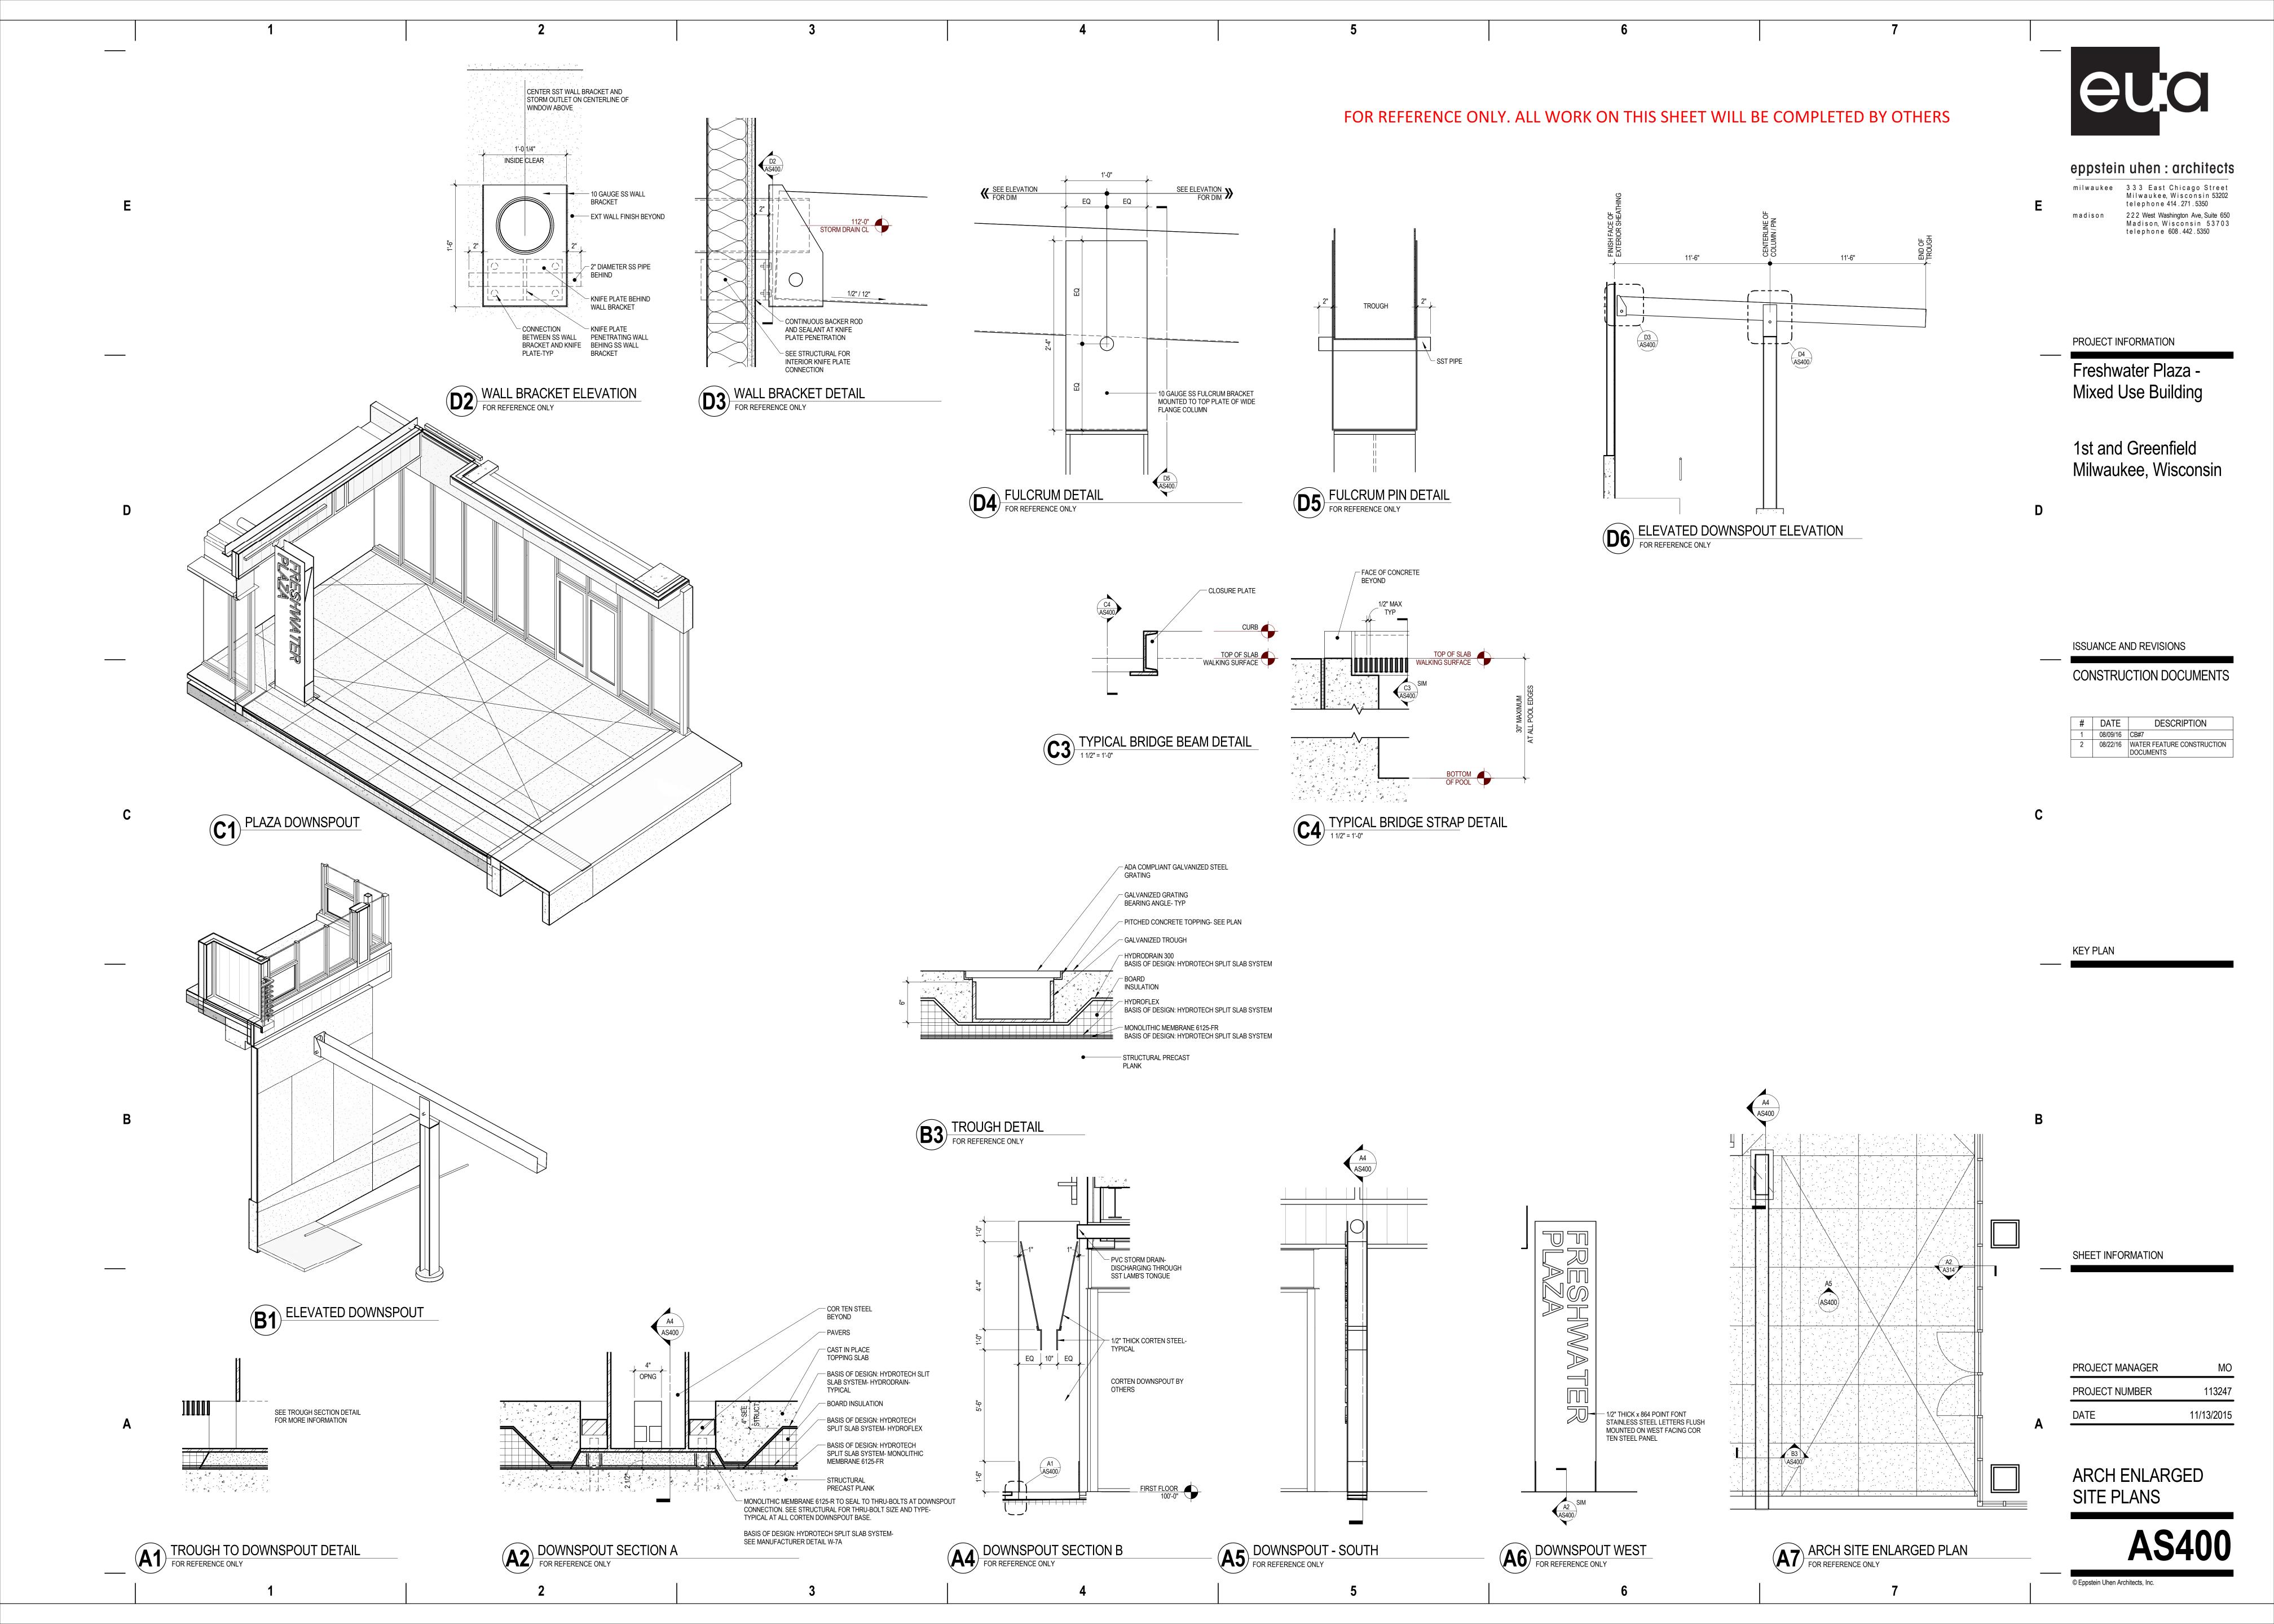

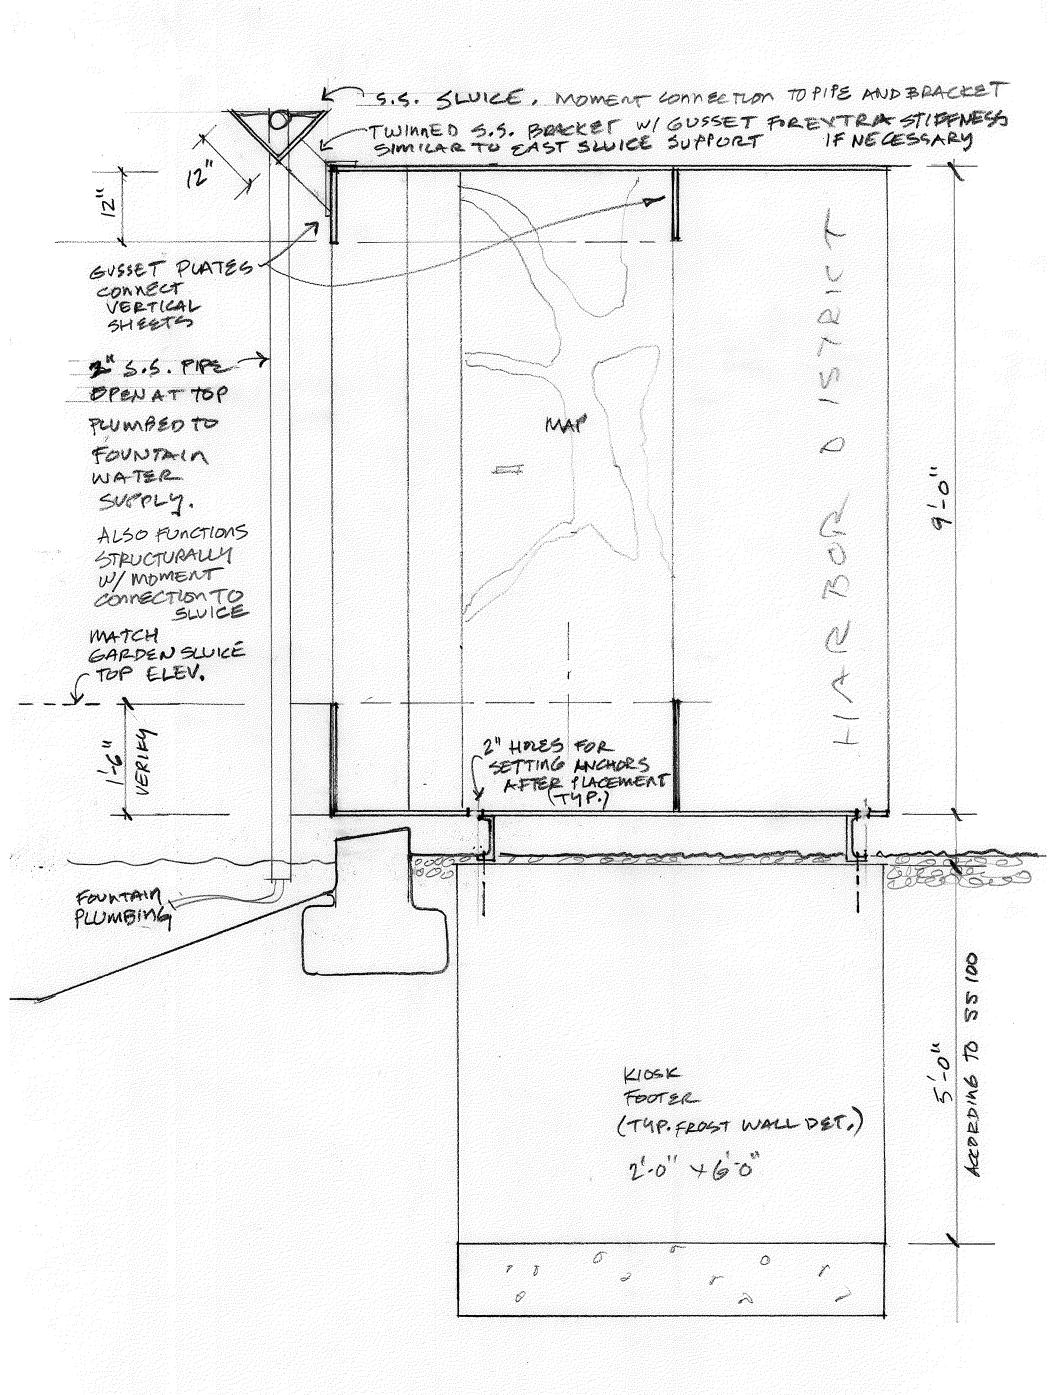


HOSK-SECTION FACING EAST

9/4"=1"0" NW (9/20/16)


NOTE: LIGHT FIXTURE-TO BE PETAILED 5.5 SWICE -S.B. BRACKET CORTEN GUSSET-2" 515, PIPE -520 0 P S 2 400L 1 CONNECTION . (SPE 45?) FOOTER IN DISTANCE


> KIOSK-COMPOSIT SECT. STUDY 3/4"=1"-0" DW (9/20/16)

9/20/16) WF-101

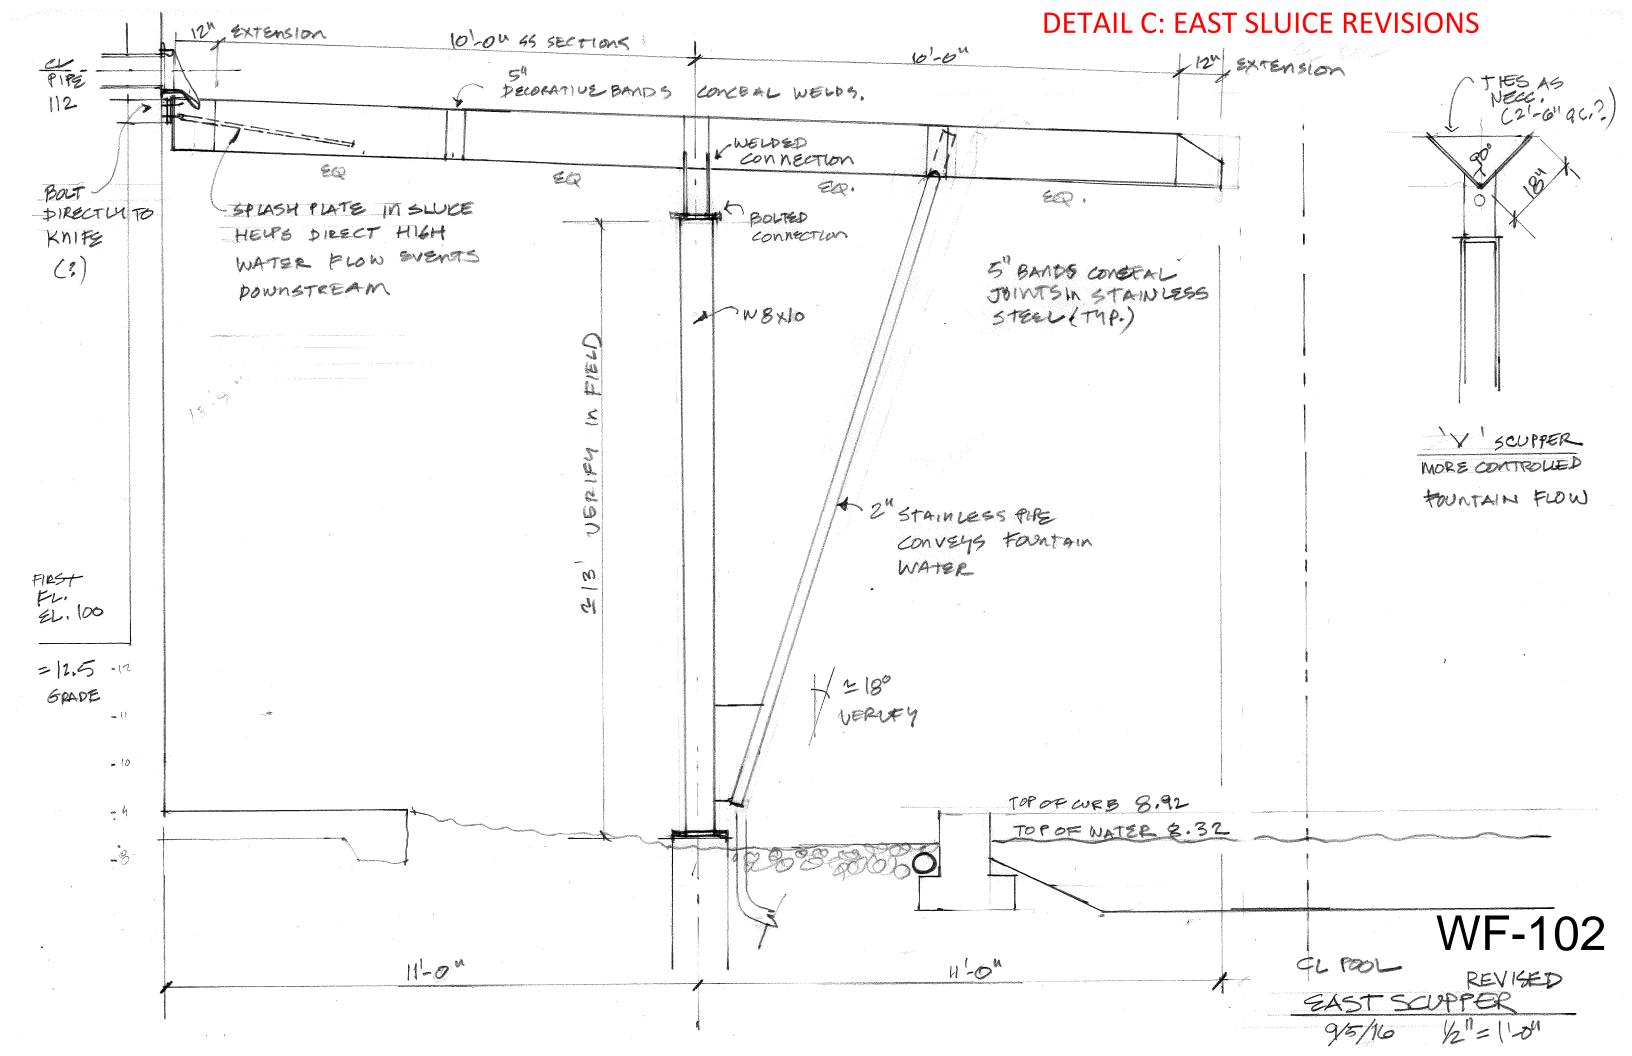

TRESHWATER PLAZA LIGHTING PLAN NTS

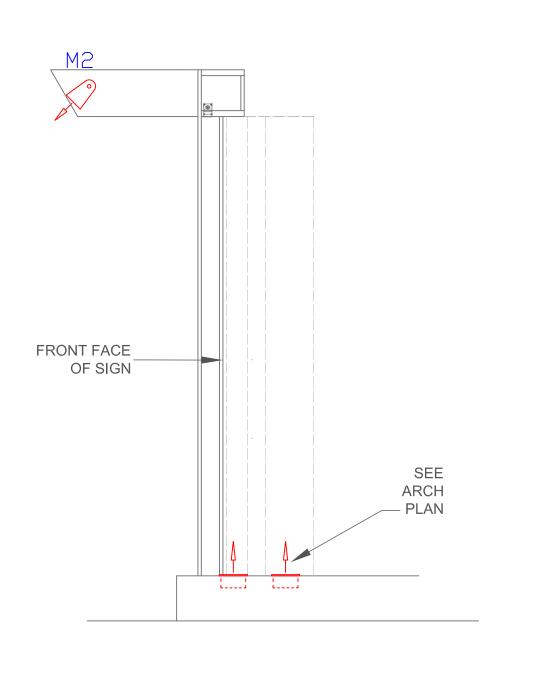

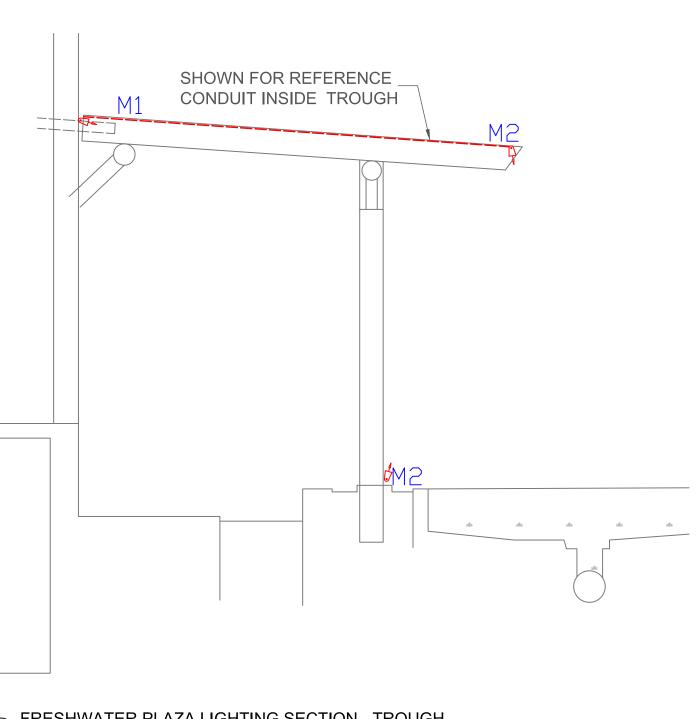

FRESHWATER PLAZA LIGHTING SECTION - TROUGH

CREATIVE LIGHTING
DESIGN & ENGINEERING
N140 W13843 CEDAR LANE
GERMANTOWN, WI 53022
PHONE 262 242 4432
FAX 262 242 1020
WWW.CLD-E.COM
INFO@CLD-E.COM

FRESHWATER PLAZA LIGHTING

ARCHITECTURAL LIGHTING DESIGN

EL-01





CREATIVE LIGHTING
DESIGN & ENGINEERING
N140 W13843 CEDAR LANE
GERMANTOWN, WI 53022
PHONE 262 242 4432
FAX 262 242 1020
WWW.CLD-E.COM
INFO@CLD-E.COM

FRESHWATER PLAZA LIGHTING

NOT FOR CONSTRUCTION

EL-02

CREATIVE LIGHTING DESIGN & ENGINEERING, LLC Freshwater Plaza LIGHTING FIXTURE SCHEDULE

September 19, 2016

											NOT	/ES
	TYPE	LOCATION	EFFECT	FIXTURE DESCRIPTION	MANUFACTURER	PART #	WATTS	VOLTS	EST#	LAMPING	SPECF'N	INSTALL
	B1	Building Balconies	Blue Moonlight wash	Lumenbeam Large Blue LED 40d Floodlight, Visor, White Finish, Short Yoke, Horiz. Spread Lens	Lumenpulse	LBL-volts-BLUE-FL-LSLH-WH-NO-SY / LBL-VS-WH-BK	50	120-277	2	Included		1
	В3	Building Paraphet	White Plaza Seating Wash	Lumenbeam Large 2700K LED 40d Floodlight, Visor, White Finish, Horizontal Spread Lens	Lumenpulse	LBL-volts-27K-FL-LSLH-WH-NO-SY / LBL-VS-WH-BK	50	120-277	1	Included		1
٧	B4	Building Balconies	Blue Moonlight wash	Lumenbeam Medium Blue LED 20d Floodlight, Visor, White Finish, Short Yoke, Verti. Spread Lens	Lumenpulse	LBM-volts-BLUE-NF-LSLV-WH-NO-SY / LBM-VS-WH-BK	28	120-277	5	Included		1
	L1			Deleted								
	L2			Deleted								
	L3	At Planters	Highlight Water @ Planter	Linear LED Strip, 12" long, HO narrow beam, 2700K, Bronze finish, Screw Mnt, 24vdc	Luminii	BOSW-12"-27K-HO-Graze-S-BZ-F3 / F4 (see note)	6.5	24vdc	8	Included	A, C	5
	L4	Under edge of Bridge	Glow under bridge	Linear LED Strip, 72" long, SO wide beam, 2700K, Bronze finish, Screw Mnt, 24vdc	Luminii	BOSW-72"-27K-SO-F-S-BZ-F3 / F4 (see note)	19.2	24vdc	2	Included	A, C	9
	M1	At troughs	White Spotlights	6 Degree LED spot, 2700k, Bronze Finish, Non-dim, Canopy Cover Mnt., Visor	Lumenpulse	LBS-volts-27K-VN-BRZ-NO-CN / LBS-VS-BRZ-BK	14	120-277	1	Included		6
	M2	Trough Waterfall	White Spotlight	6 Degree LED spot, Vertical Spread Lens, 2700k, Bronze Finish, Non-dim, Yolk Mnt., Visor	Lumenpulse	LBS-volts-27K-VN-LSLV-BRZ-NO-CRC / LBS-VS-	14	120-277	4	Included		8
	N1	Kiosk J-Box	Power Supply	Power Supply for U1, U2, 20 watt, Enclosure Req'd.	BK Lighting	TRe20	1w-20w	120-277	3	na	С	
	N2	12" Above Grade	Power Supply	96 watt max., 24vdc Power supply for L3, L4, Wet location enclosure.	Luminii	PSD-96-24-volt	71,68,68,68	120,240,277	3	na	A, C	
	N3	12" Above Grade	Power Supply	Power Supply for Z1 (or U1), 60 watt, Wet location enclosure.	BK Lighting	TR-60-volt	25	120, 277	1	na	С	
	U1	Exterior	Pipe/Trough Uplight	In-grade Uplight, Brass Mitique, AR-111 REMOTE Transformer, SORAA lamp	BK Lighting	B-C02-AR-RS-0-MIT-GM-R	15	12VAC	2	SR111-12-08D-927-03	С	3
	U2	Kiosk	Signage Uplight	In-grade Uplight, Brass Mitique, Integral LED, REMOTE Transformer,	BK Lighting	B-CO2-LED-RS-e64-WFL-MIT	7	12VAC	2	Included	С	2
	Z1	Walls @ steps		Step Light, Backbox Mnt, Rectangular, Brass Mitique Finish, 2700k LED, 12VAC	BK Lighting	B-SQ-LED-e100-A9-MIT	5	12VAC	7	Included	С	7

GENERAL NOTES:

- · This design includes plaza water feature only. Lighting for oher walk and step areas, including West steps, are to be designed by others.
- . Unless otherwise shown, lighting controls and zones by contractor, and to comply with Local Energy Code. All controls and switch locations to be verified with owner.
- Fixture quantities are estimates only, contractor to verify actual quantities. Contractor to verify and include all lamps and accessories for a complete, operating system. Contractor to provide owner with lighting and control system that complies with all local, state and national codes and industry practice. Contractor to provide one-year warranty on all lighting and control equipment from date of turn over to owner.
- · Hide all controllers and transformers from view. Must be in accessible locations for possible maintenance
- Contractor to verify Loads on all controllers. Confirm voltage and power connections to all dimmers prior to energizing.
- Verify with Mfgr all fixture components for a complete system before ordering.
- Dimming and Driver compatibility needs to be verified before ordering fixtures
- Maintain voltage drop between remote transformers and fixtures to 3% or lower
- Field Verify all measurements and run lengths before ordering fixtures.
- Contractor to verify suitable UL or similar listing on all products

SPECIFICATION NOTES:

- A VERIFY LENGTHS and components for a complete system with mfgr. Exact length must be factory ordered. "e" Type letter suffix indicated end unit -order F3 single connector for end of runs, or F4 dual connector for middle of runs. 48" Joiner is p/n IP67-48, or supply wires may be custom ordered.
- **B** Requires 0-10v dim Control. Other dimming control options acceptable.
- C Requires Remote power supply. Two styles (PSV & PSD) and wattages available Verify w/Mfgr. Locate N1 & N2 hidden in Bench vertical supports per architect.

INSTALLATION NOTES:

- Locate and attach fixture B3 at front edge of roof as shown on plan, center B4 between balconies, Locate and attach B1 at front edge of the roof at the right corner of the window on the prefinished metal panel portion. Aim out for even coverage of plaza.
- 2 Locate per architect detail at base of Kiosk signage, each side.
- Install so paver is flush w/ finish walk, center 6" in front of vertical trough. Aim onto trough 2/3r'ds up face.
- 4 Install facing down to wash Kiosk face, 4"-6" in front of lettered side. Aim 2/3 up face. Hide supply wiring, if possible, or route supply wiring through base. Verify any exposed wiring w/ architect.
- 5 Locate at and attach to Wier to illuminate water stream. Hide direct view of fixture. Route Wiring along planter hidden from view and route to accesable power supply.
- 6 Locate M1 4-6" from surface to be illuminated and aim 2/3r'ds up/out along surface.
- 7 Mount 12" min above steps or just under cap of wall at consistant height.
- 8 Mount M2 above downspout 18" from building façade, or inside trough at end to aim down water. Align lens ribs perpendicular to trough. Center on downspout and aim down waterway.
- 9 Mount L4 under bridge, approx. 2"-4" from outside edge, hide strip from direct view.

