
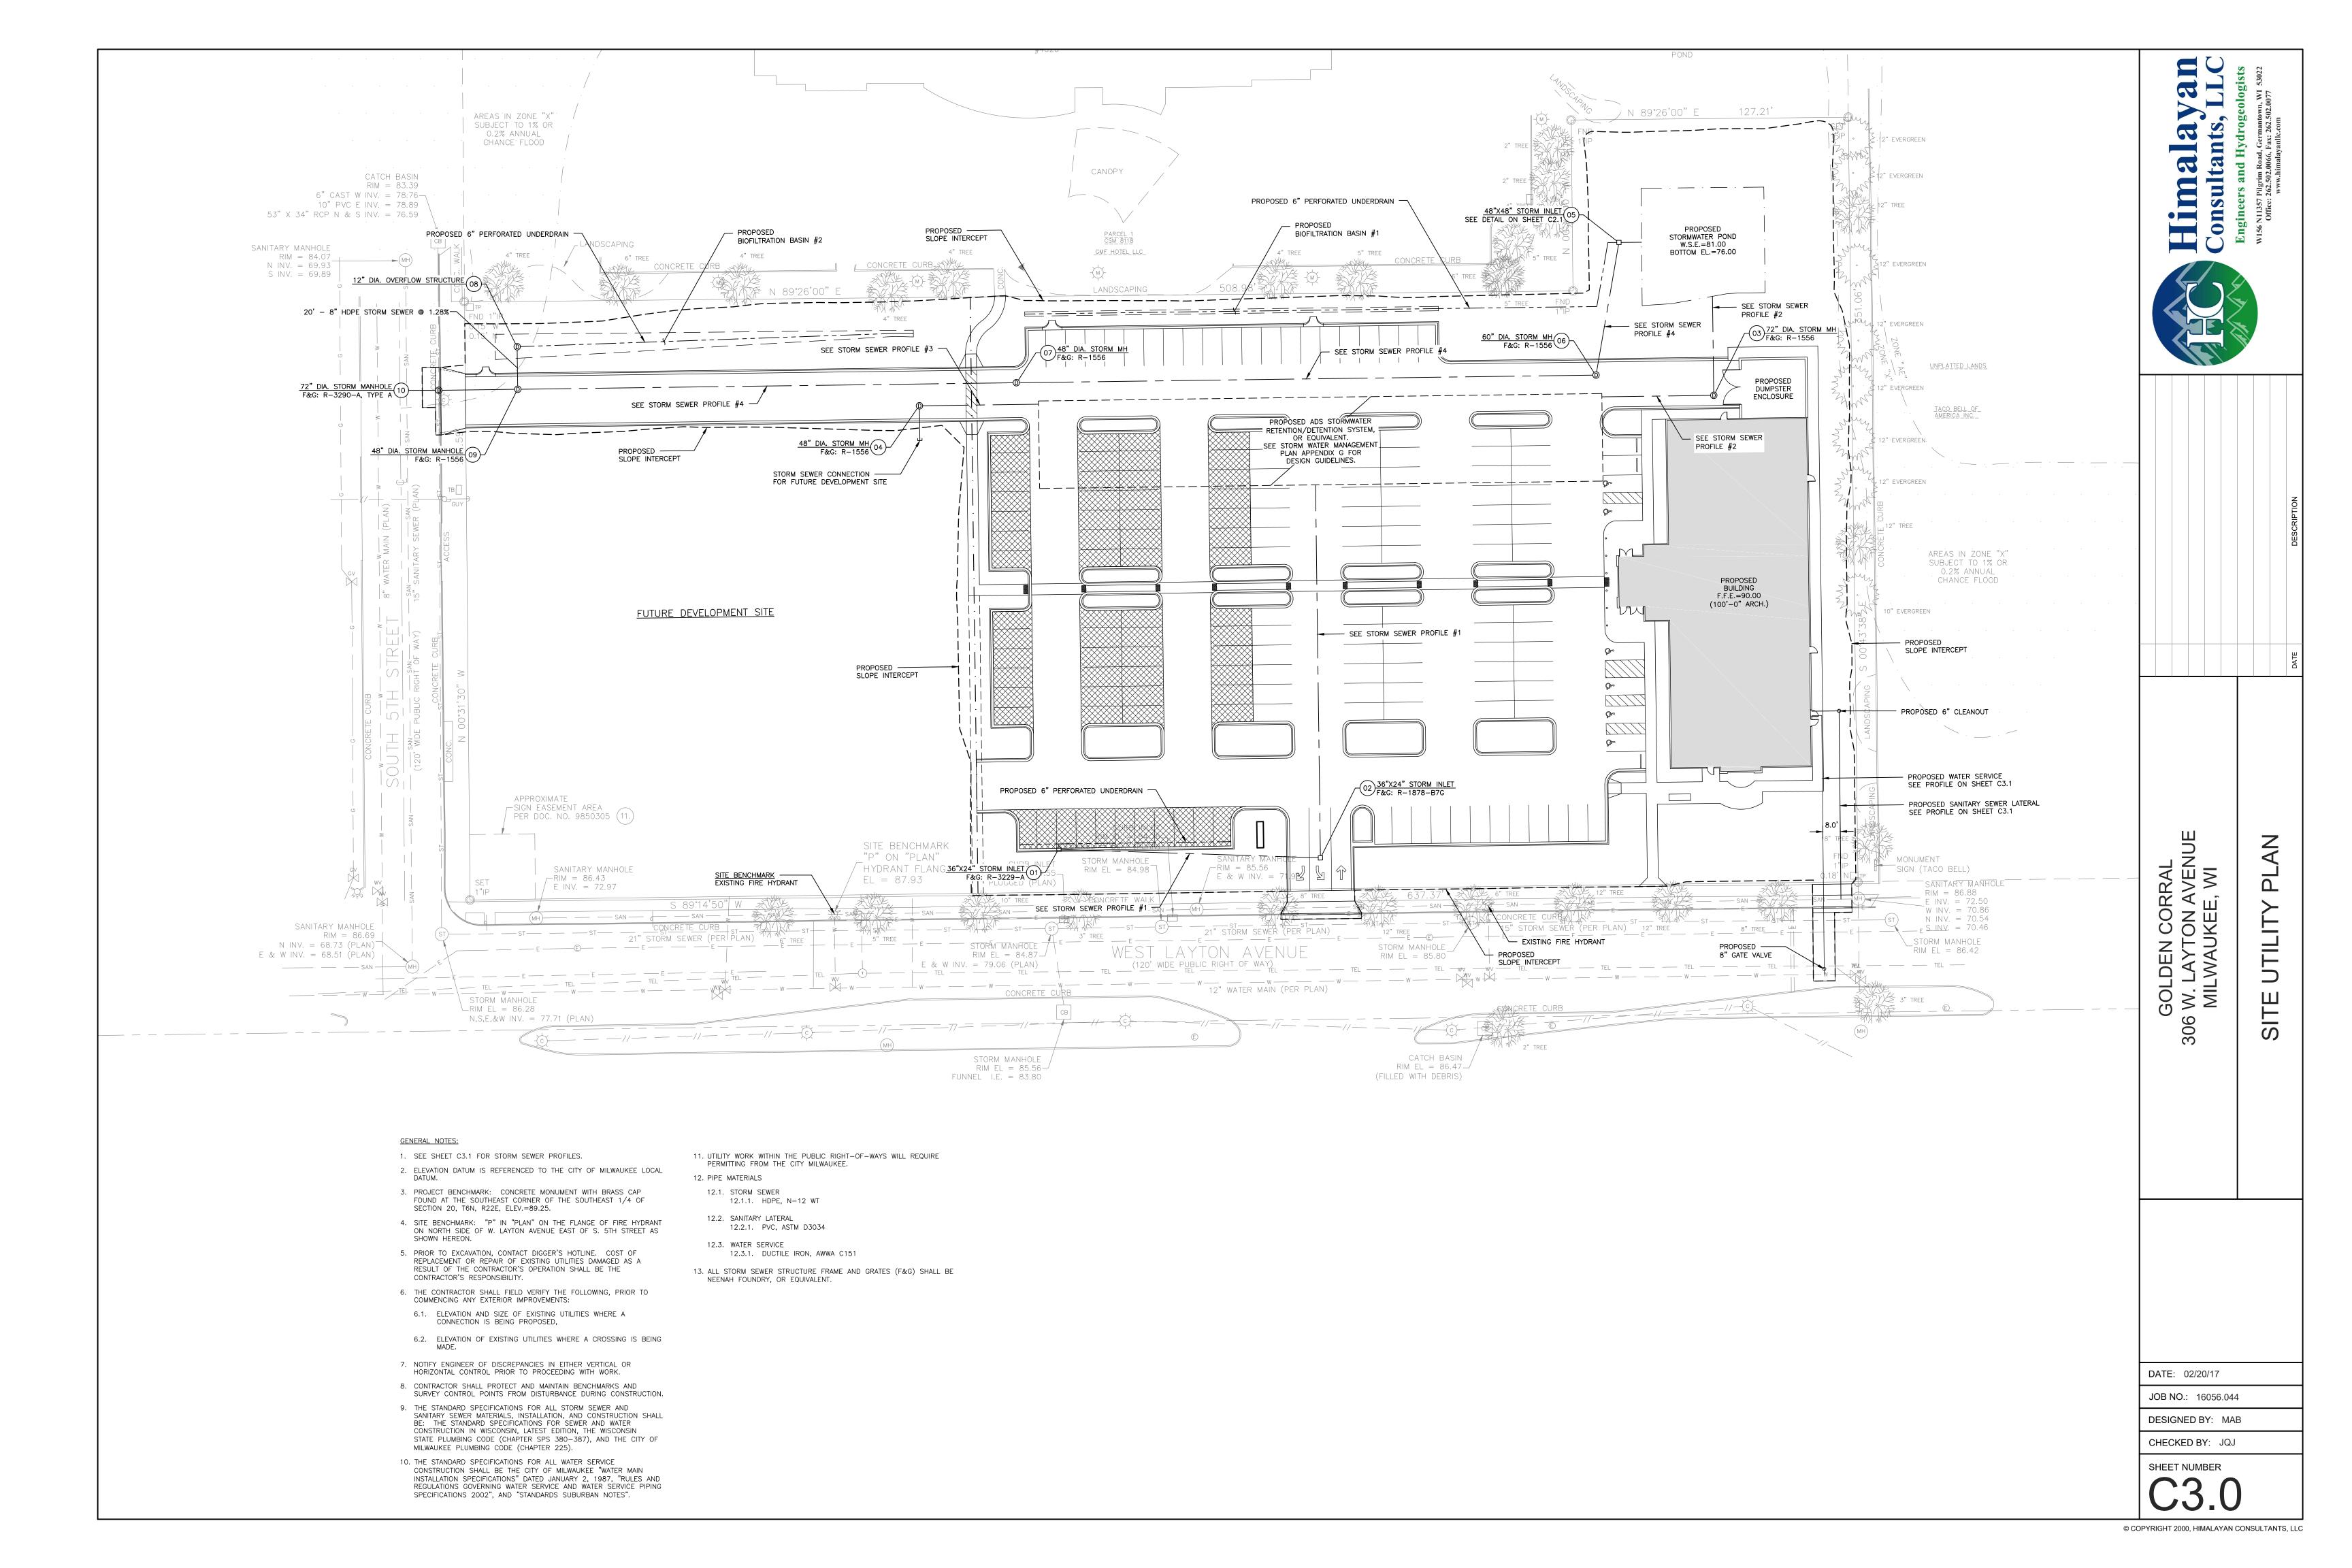
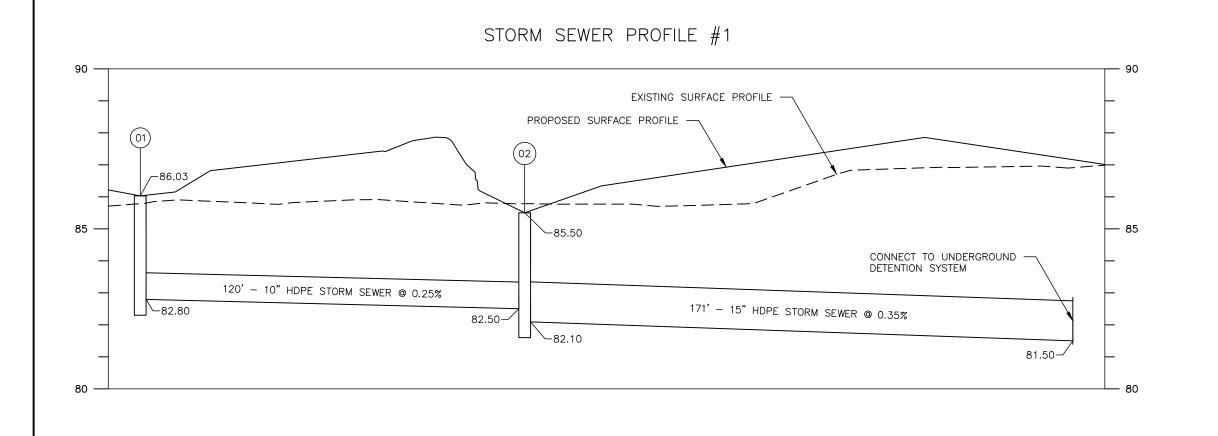
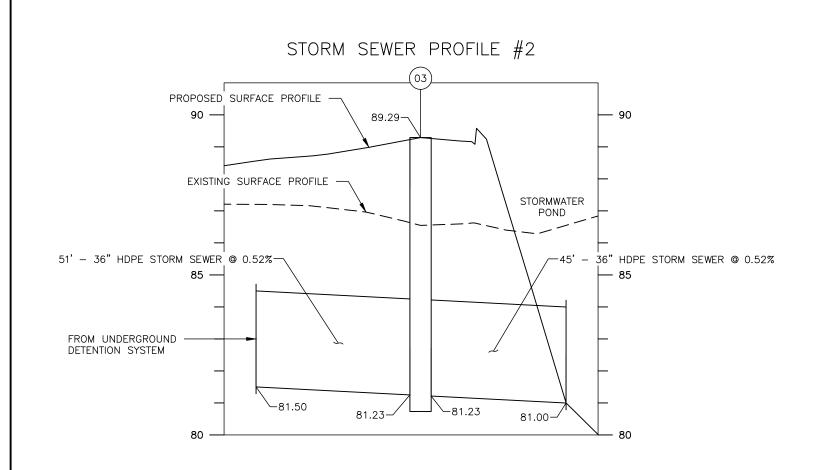



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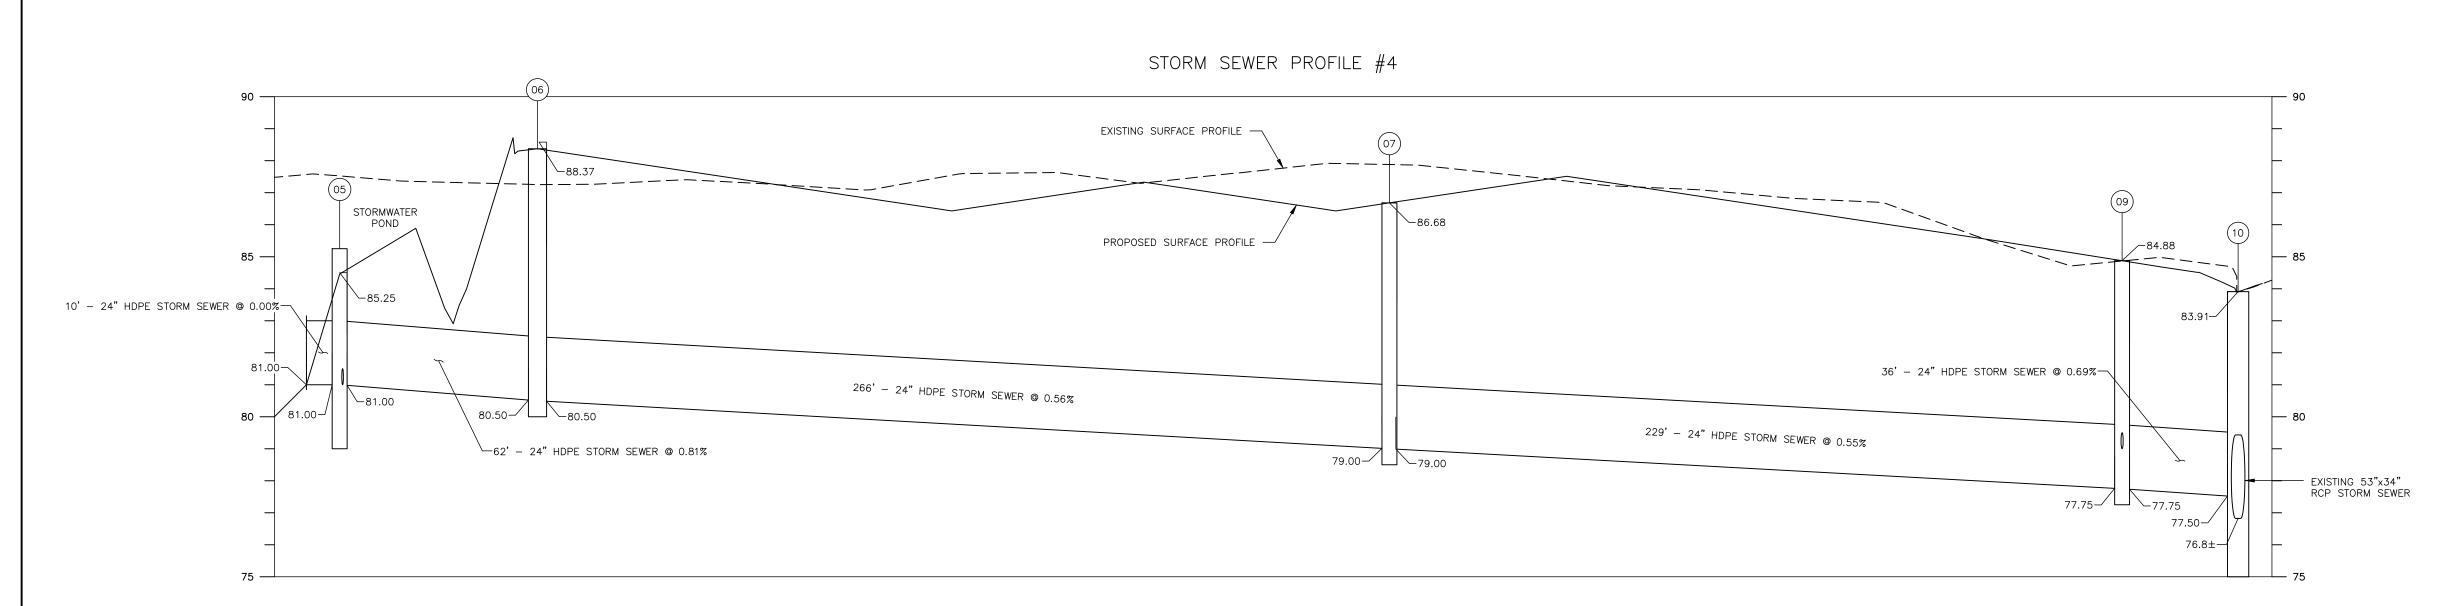


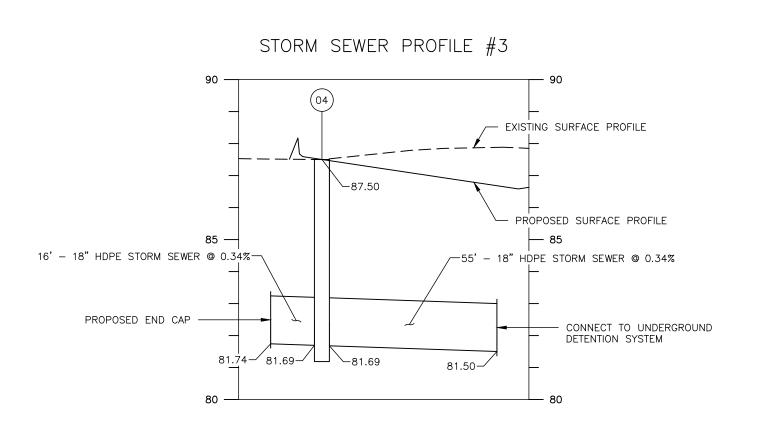

	WATER SERVICE	
	90 — PROPOSED SURFACE PROFILE —	— 90 –
	87.02	_
	EXISTING SURFACE PROFILE	-
	85 —	— 85
	5' — 8" DUCTILE IRON PIPE @ 5.89% PROPOSED 8" RESILIENT WEDGE GATE VALVE & VALVE BOX	- - .33
3' - 8" DUCTILE IRON PIPE @	43' - 8" DUCTILE IRON PIPE @ 5.89%—	_
CONNECT TO EXISTING - 12" WATER MAIN WITH	73' - 8" DUCTILE IRON PIPE @ 0.20%	— 80
MECHANICAL JOINT TAPPING SLEEVE	79.38 -79.52	– — 78
	79.4 ASSUMED MILET BE FIELD VEDIFIED	


								Com	putati	ons Fo	or Sewe	rs of	Drain	age Sy	stem								
Pro	ject Name			Golden	Corral				F	roject	Location		;	300 W. La	ayton Ave	nue, Milw	aukee			Date	02/0)1/17	
	Job No.	16056.044	1	Desi	gned By	M. B	abich			Che	cked By	J. (Jolie		Sheet	1	of	1		Rainfall	10-	Year	
			1								Total								Time	f Flow in			
Loca	ation of Sev	ver	Dr	ainage A				and Rur	noff Data		Runoff			Des	sign Com	outations				ewer			
			а	Α	С	Ca	Σ Ca			- 1	Q		Sewer										
ln	From	То	Individual Area in Acres	Accumulated Area in Acres	Individual Impervious Coefficient	Individual Ca	Accumulated Ca	Rainfall Frequency Curve Used (years)	Initial Time of Concentration (min.)	Rainfall Intensity in. per hr. = I	Total Runoff Cu. Ft. per Sec. CIA=Q	Length of Sewer (ft)	Inside Diameter of Se (in)	Necessary Drop in Length Given (ft)	Actual Drop in Length Given (ft)	Mannings Roughness Coefficient	Parts Full for Actual Drop	Velocity ftt. per sec. for Actual Drop	Time of Flow in Section (min.)	Total Elapsed Time at End of Section (min.)	Invert (In)	Invert (Out)	Slope
Site	1	2	0.27	0.27	0.66	0.18	0.18	10	10.0	5.14	0.92	118	10	0.18	0.30	0.012	0.66	2.42	0.8	10.8			0.25%
Site	2	UD	0.60	0.27	0.76	0.46	0.10	10	10.8	5.00	3.17	209	15	0.43	0.60	0.012	0.71	3.43	1.0	11.8			0.25%
		OD.	0.00	0.01	0.70	0.40	0.00	10	10.0	0.00	0.17	200	10	0.40	0.00	0.012	0.71	0.40	1.0	11.0			0.2070
	4	UD	1.15	1.15	0.75	0.86	0.86	10	10.0	5.14	4.43	70	18	0.11	0.40	0.012	0.51	4.90	0.2	10.2			0.57%
	5	6									17.03	62	24	0.30	0.50	0.012	0.66	7.73	0.1	0.1			0.81%
	6	7									17.03	266	24	1.28	1.50	0.012	0.76	6.64	0.7	0.7			0.56%
	7	9									17.03	229	24	1.10	1.25	0.012	0.77	6.55	0.6	0.6			0.55%
	8	9									1.43	20	8	0.20	0.25	0.011	0.74	5.17	0.1	0.1			1.25%
	9	10									18.43	36	24	0.20	0.25	0.012	0.74	7.35	0.1	0.1			0.69%


RUNOFF BASED ON THE 500-YEAR STORM EVENT -

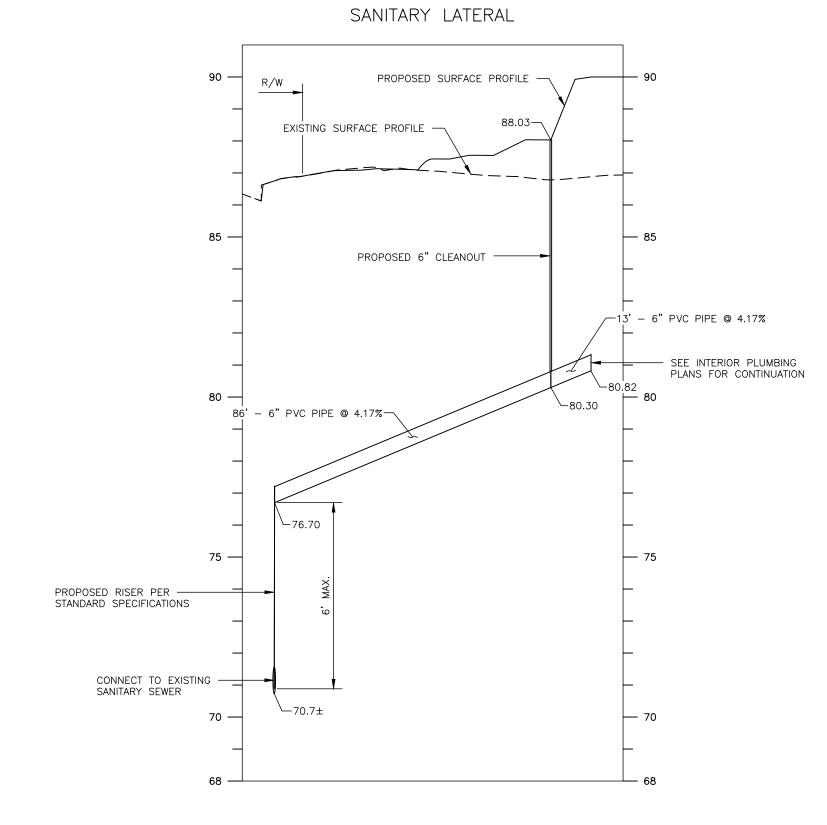

PROFILES GOLDEN CORRAL 306 W. LAYTON AVENUE MILWAUKEE, WI DATE: 02/20/17 JOB NO.: 16056.044 DESIGNED BY: MAB CHECKED BY: JQJ

SHEET NUMBER

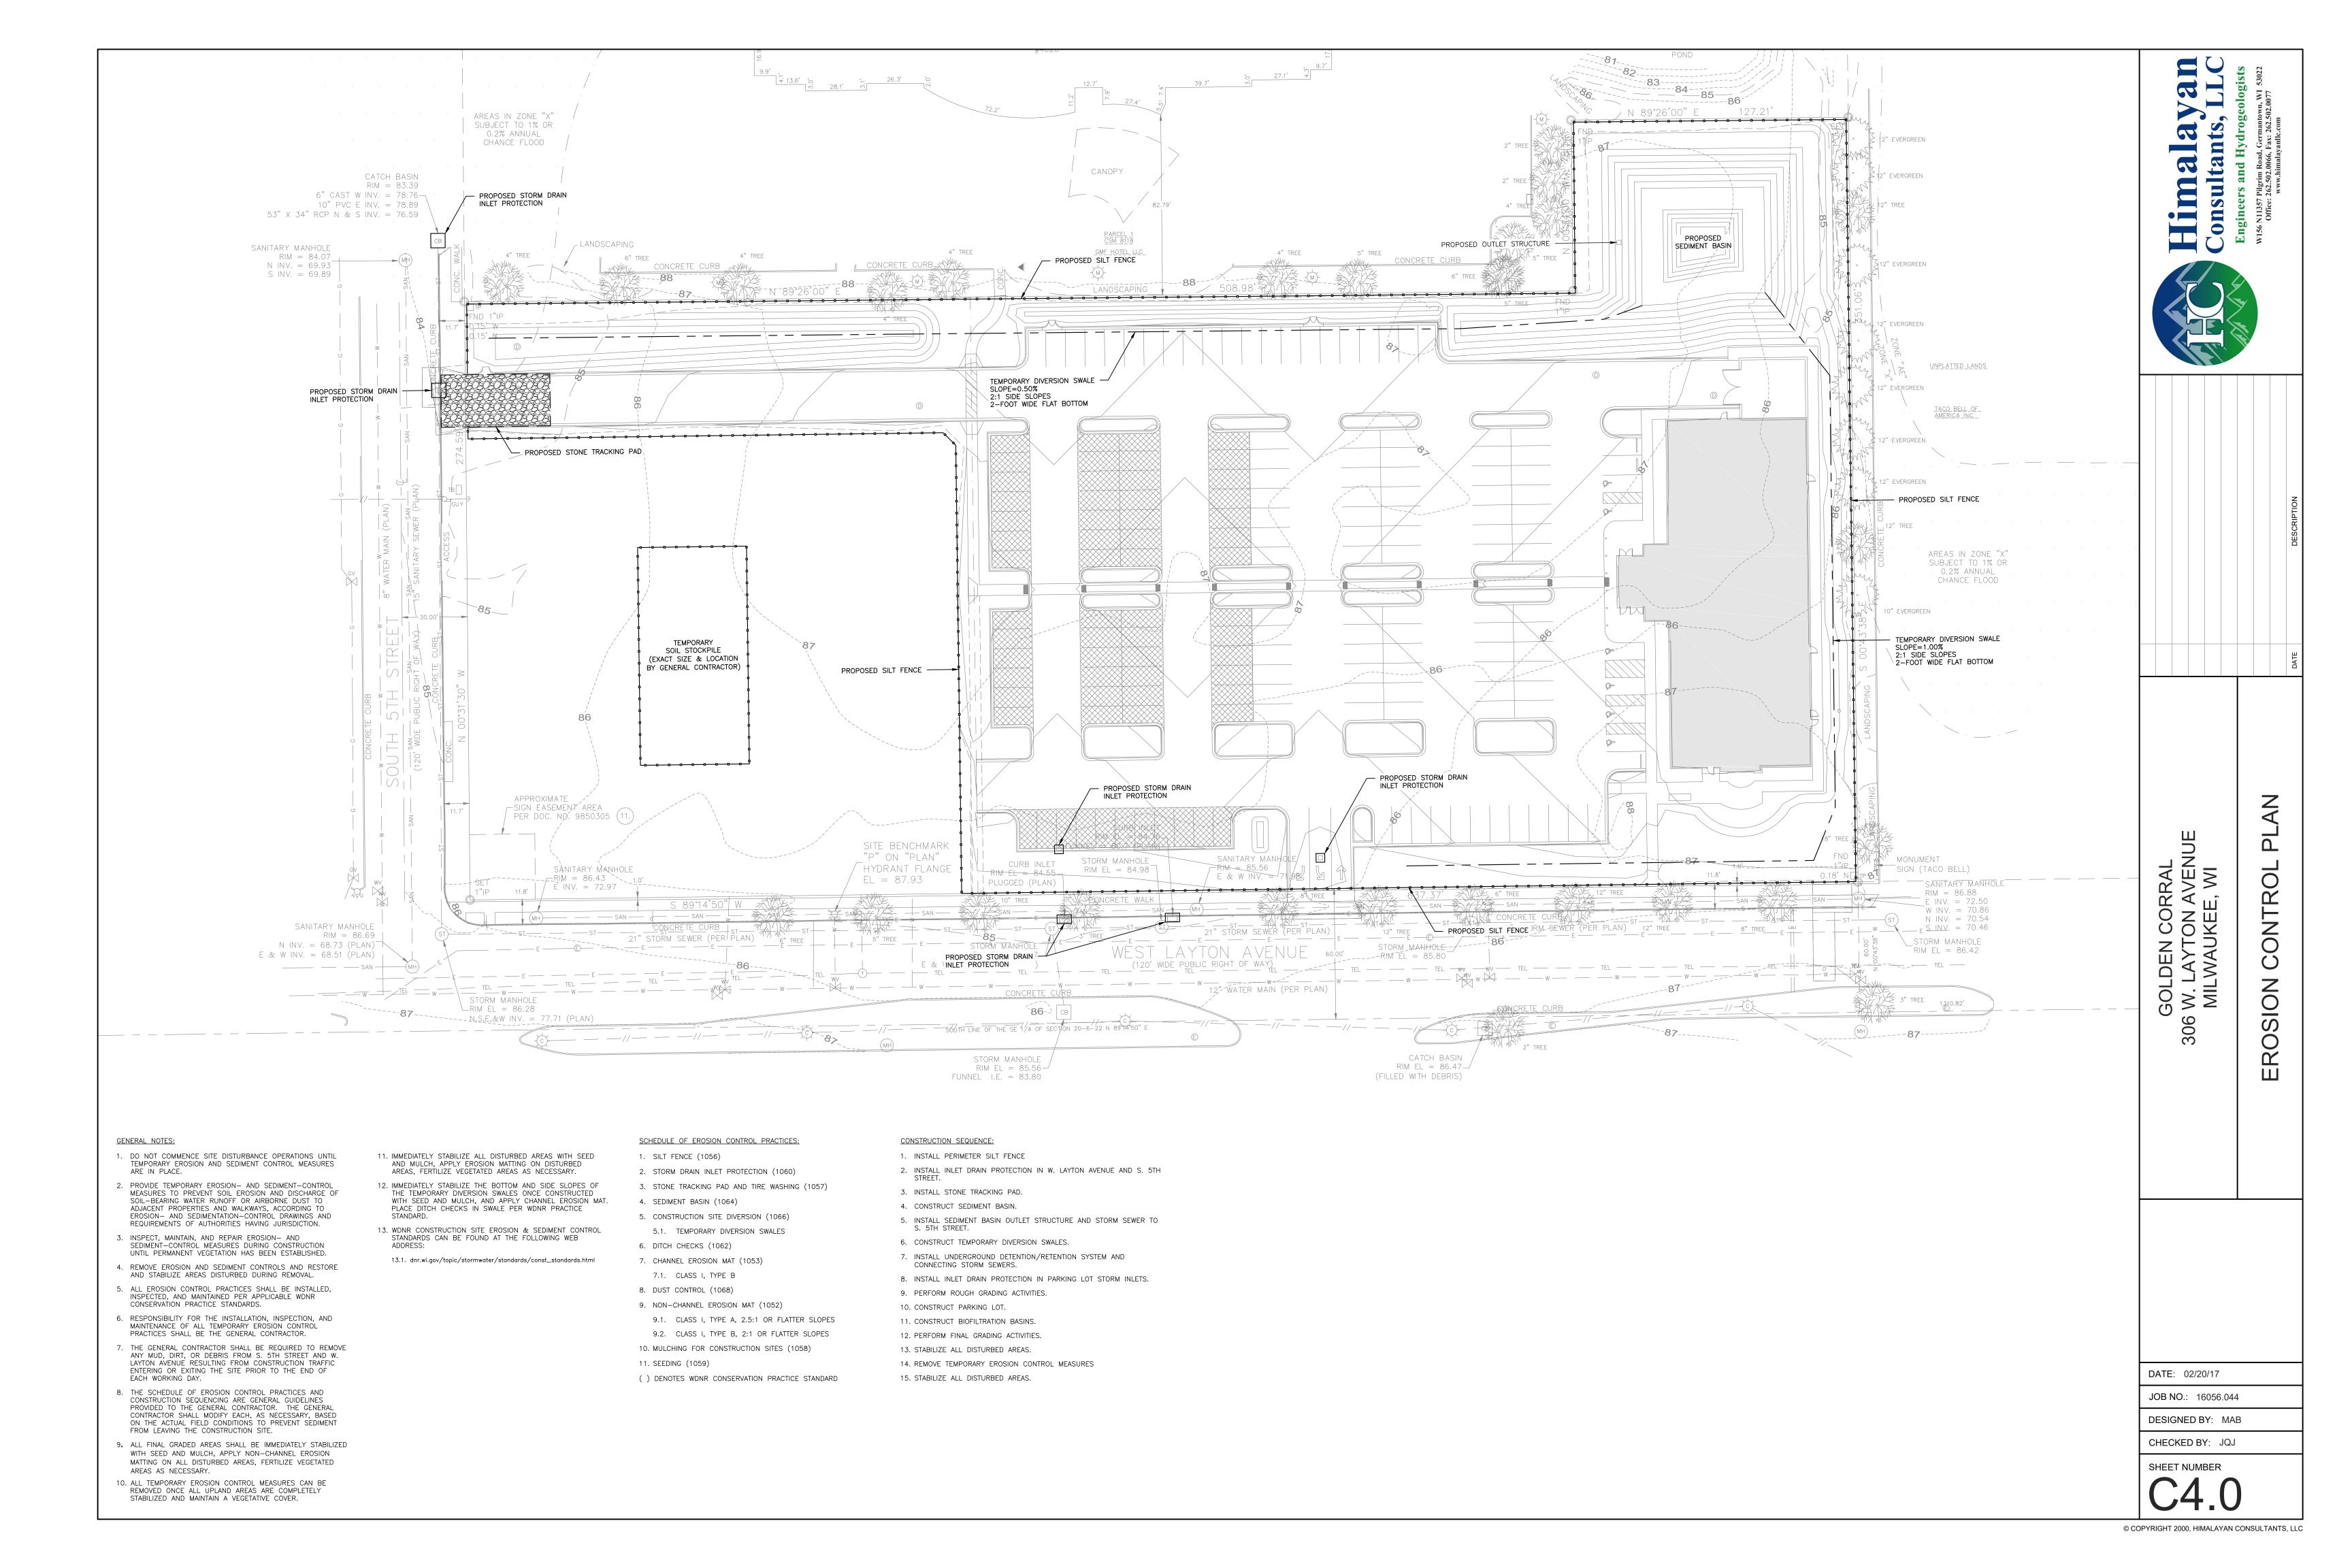

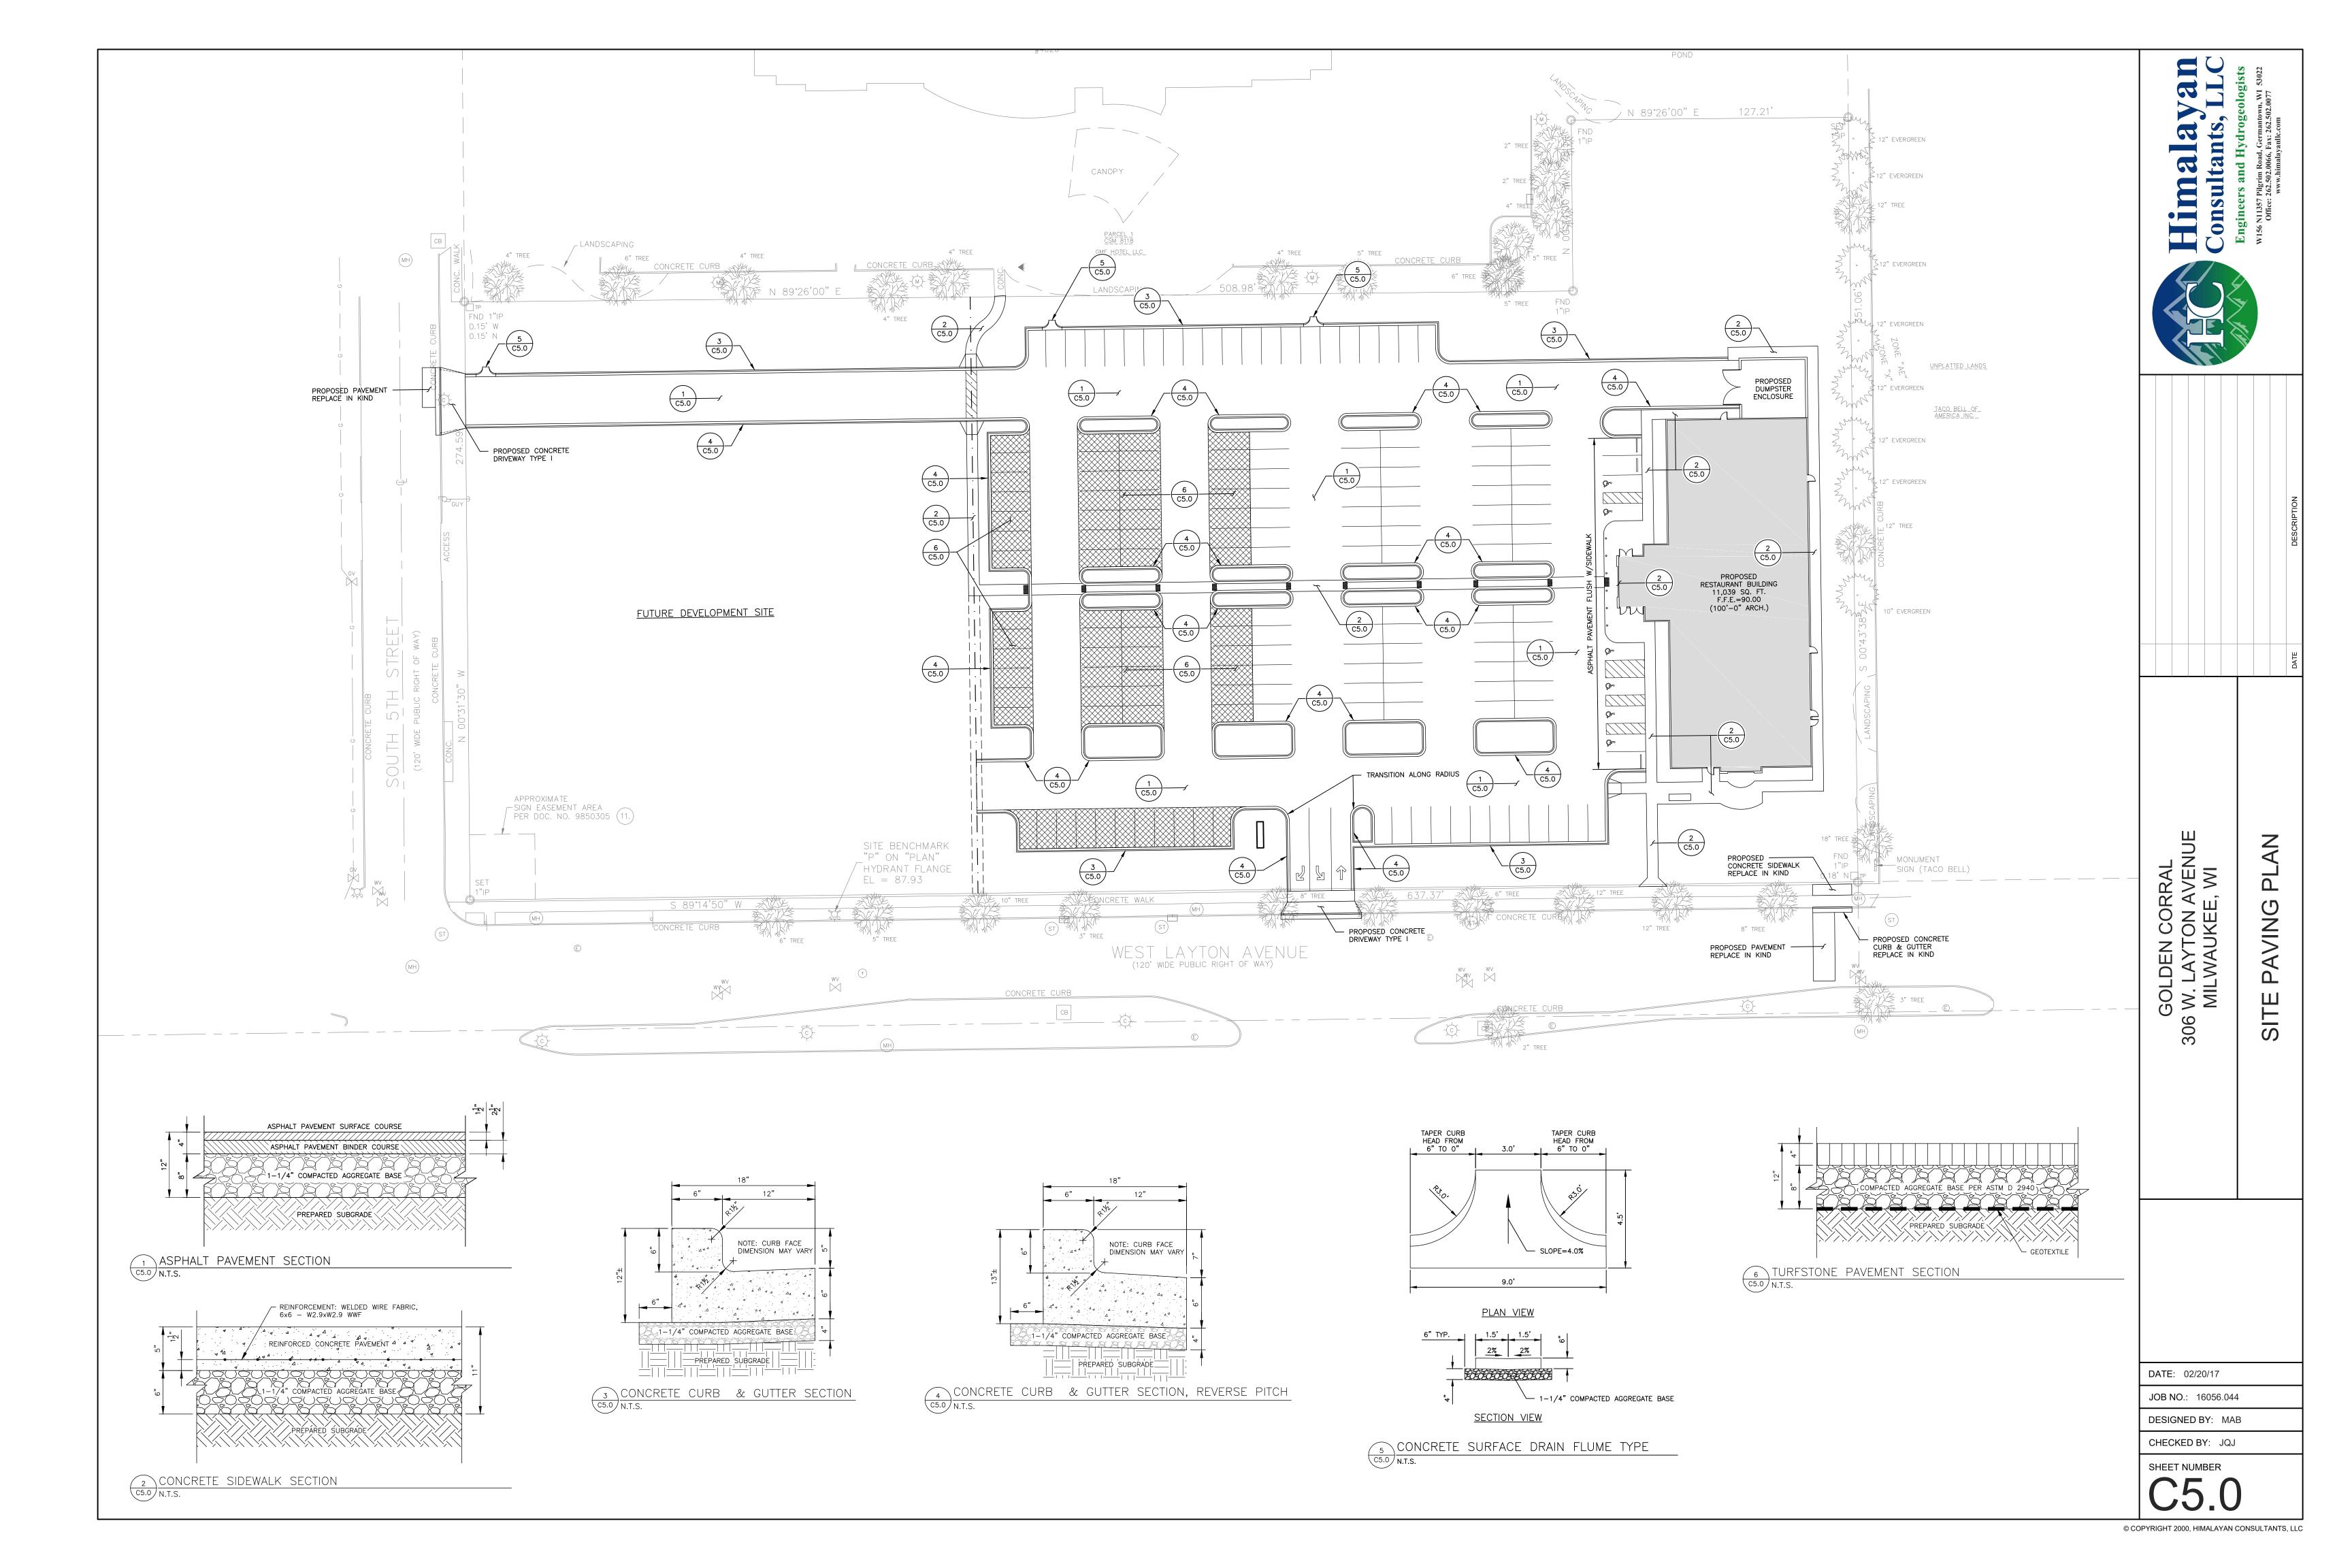

LANDSCAPE

GOLDEN

CORRAL

12/16/16

01/17/17

02/02/17


02/20/17

Landscape Architecture

and Master Planning Design Consulting

11525 W. North Avenue Suite 1B

Wauwatosa, WI 53226

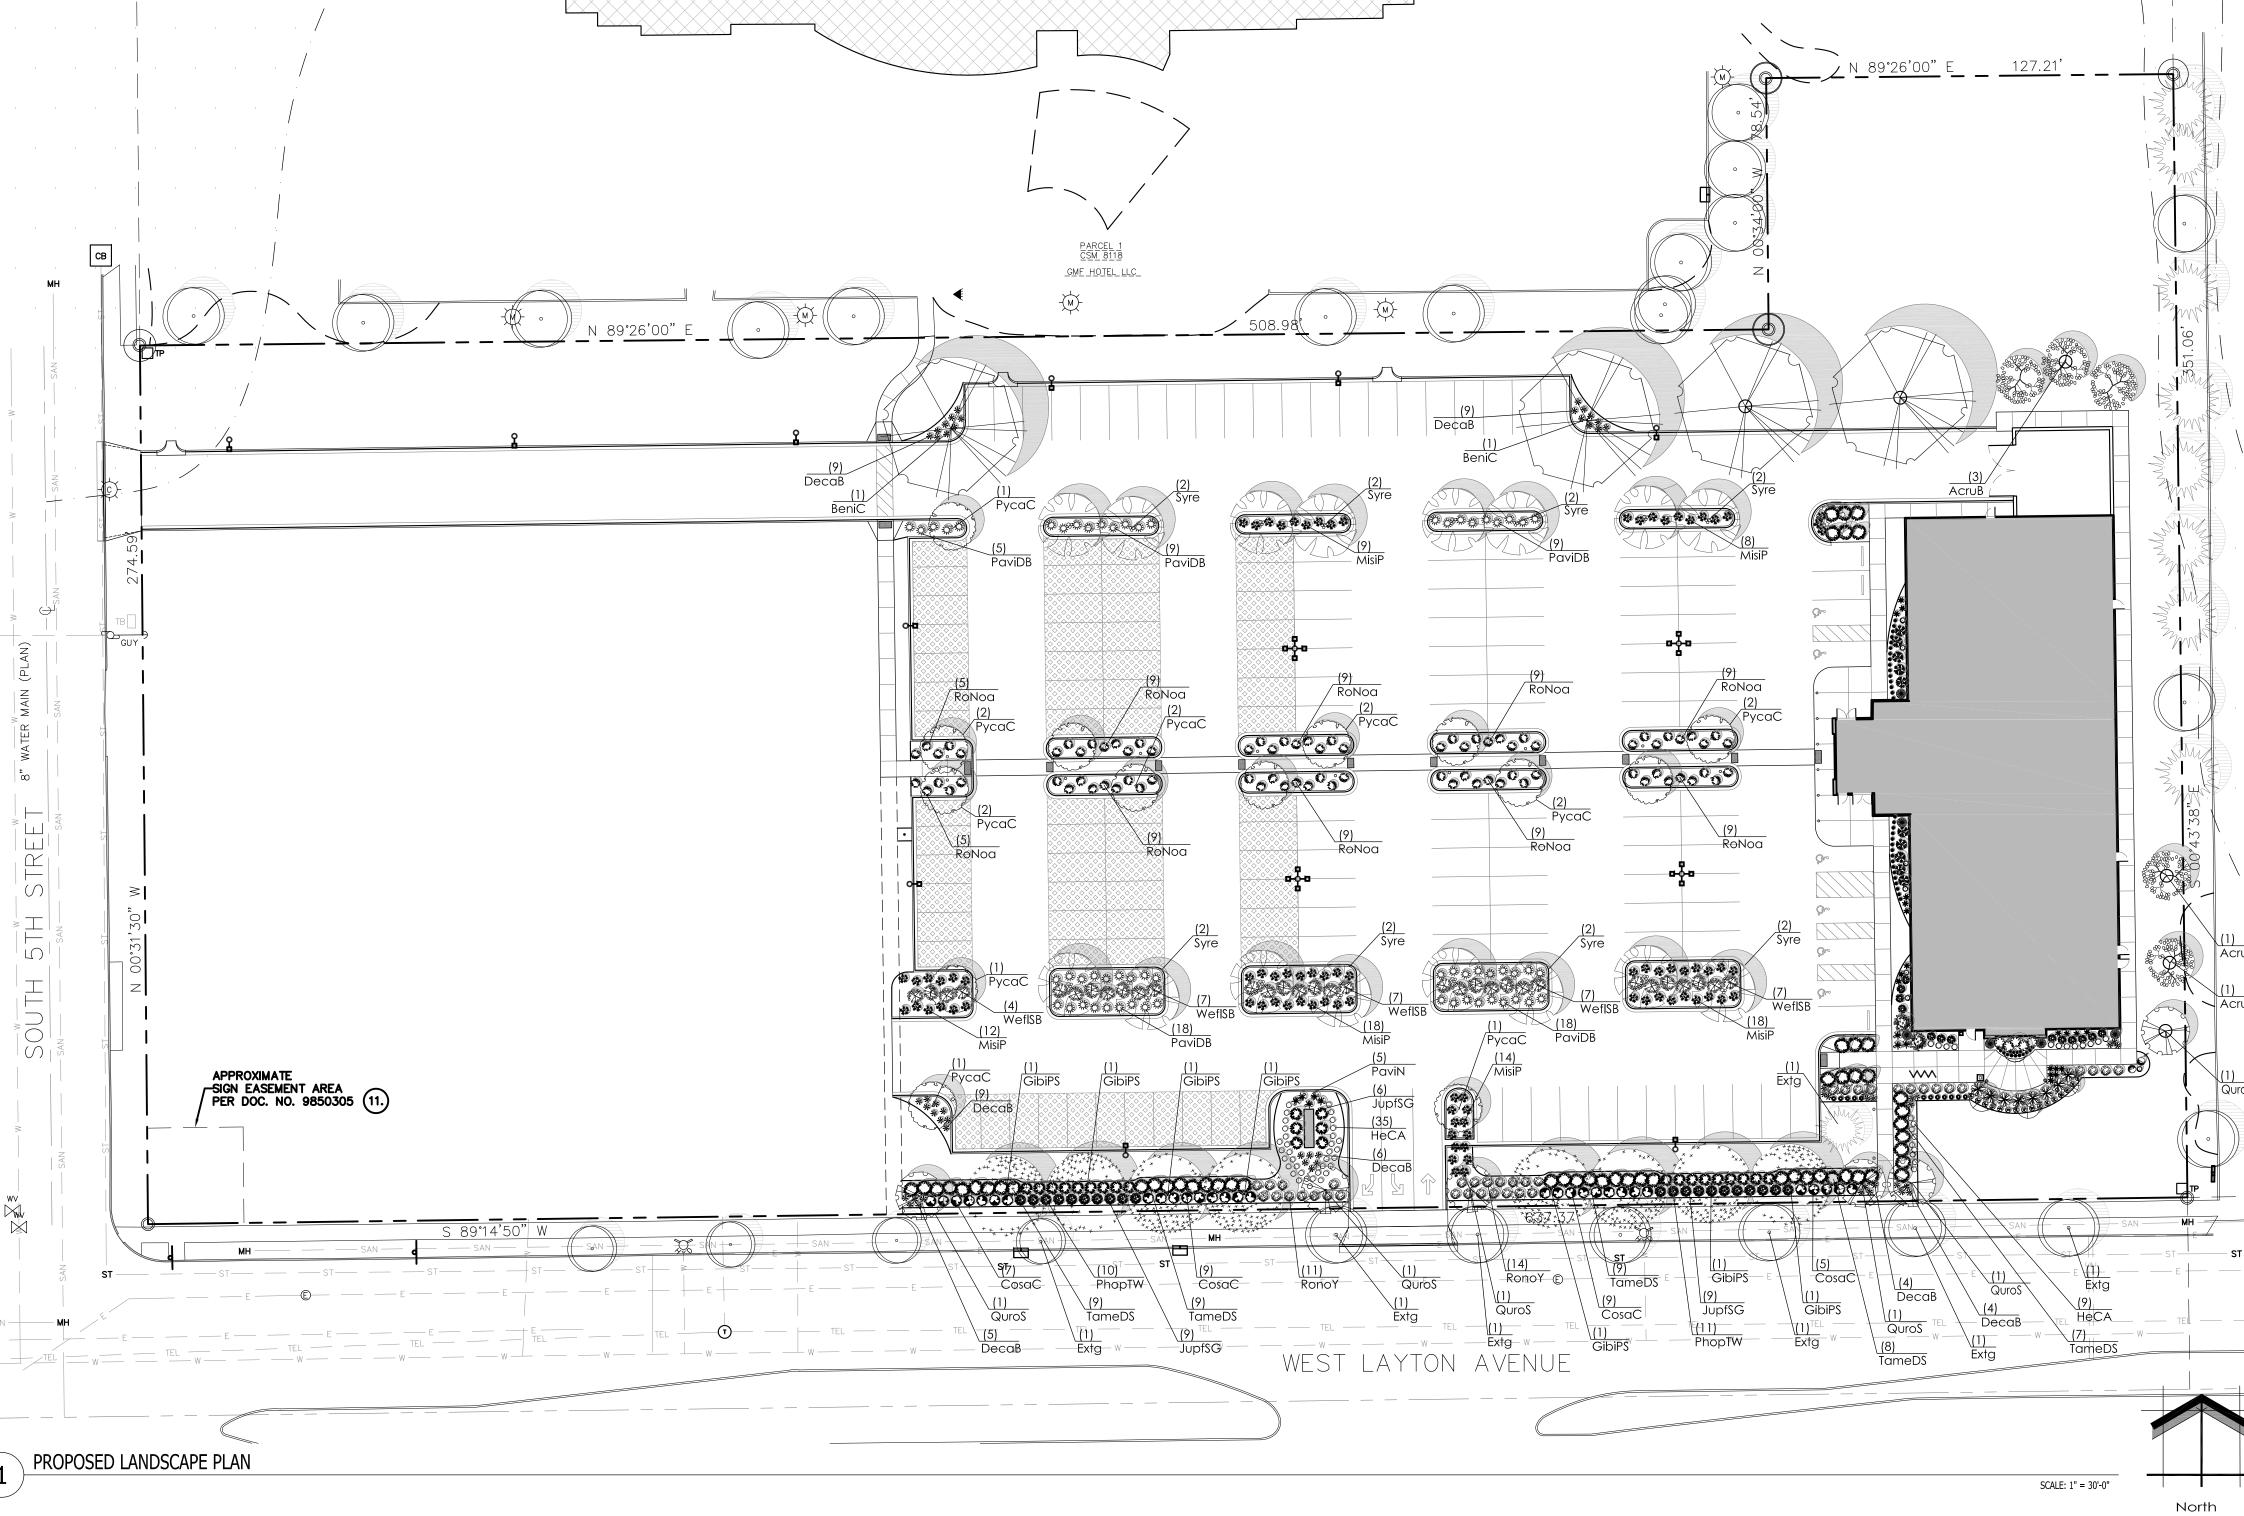

<u>Proposed Plant Material Table - LSP1.1</u>

Broadleaf Deciduous Shrub

Quantity	Code Name	Symbol	Scientific Name	Common Name	Planting Size	Comments
5	AcruB	0	Acer rubrum 'Brandywine'	Brandywine Red Maple	2 1/2"-Cal - B&B	
4	BeniC	₩	Betula Nigra 'Cully'	Heritage River Birch	2 1/2"-Cal - B&B	
8	GibiPS	a	Ginko biloba 'Princeton Sentry'	Princeton Sentry Maidenhair Tree	2 1/2"-Cal - B&B	
14	PycaC	0	Pyrus calleryana 'Chanticleer'	Chanticleer Pear	2 1/2"-Cal - B&B	
6	QuroS		Quercus robur 'Skymaster'	Skymaster English Oak	2 1/2"-Cal - B&B	
16	Syre		Syringa reticulata	Ivory Silk tree lilac	2 1/2"-Cal - B&B	
_	Extg	0	Existing	Existing	Existing	

Broadleaf Eve	rgreen Tree					
Quantity	Code Name	Symbol	Scientific Name	Common Name	Planting Size	Comments
-	Extg	and the same of th	Existing	Existing	Existing	
Perennial						
Quantity	Code Name	Symbol	Scientific Name	Common Name	Planting Size	Comments

Hemerocallis x 'Chicago Apache' Chicago Apache Daylily

Quantity	Code Name	Symbol	Scientific Name	Common Name	Planting Size	Comments
30	CosaC	3	Cornus sanguinea 'Cato'	Arctic Sun Red Twig Dogwood	24" - Cont	
21	PhopTW	0	Physocarpus opulifolius 'SMPOTW'	Tiny Wine Ninebark	24" - Cont	
82	RoNoa	Party.	Rosa x 'Noa'	Flower Carpet Amber Groundcover Rose	24" - Cont	
25	RonoY		Rosa x 'Noalesa'	Flower Carpet Yellow Groundcover Rose	24" - Cont	
32	WefISB	200° C	Weigela florida 'Bokrasopin'	Sonic Bloom Pink Reblooming Weigela	24" - Cont	
Conifer Ever	green Shrub					
Quantity	Code Name	Symbol	Scientific Name	Common Name	Planting Size	Comments
0.4	lum fC C	311/4	Lunin artus van fizariana a IAAa a Caral	Con of Cold Iunipar	10" 04" DOD	

Jobise	No.	Juniperus x prizeriaria Monsari	sed of Gold Juniber	10 - 24 - D&D	
TameDS	0	Taxus x media 'Densformis Select'	Select Dense Spreading Yew	18" - 24" - B&B	
ass					·
Code Name	Symbol	Scientific Name	Common Name	Planting Size	Commen
DecaB	*	Deschampsia caespitosa Bronzeschleier	Bronze Veil Tuft Hair Grass	1-Gal - Cont	
MisiP	**	Miscanthus sinensis 'Purpuracens'	Purple Silver Grass	1-Gal - Cont	
PaviDB	ZW.	Panicum virgatum 'Dallas Blues'	Dallas Blues Switch Grass	1-Gal - Cont	
PaviN	*	Panicum virgatum 'Northwind'	Northwind Switch Grass	1-Gal - Cont	
	TameDS ass Code Name DecaB MisiP PaviDB	TameDS ass Code Name Symbol DecaB MisiP PaviDB	TameDS Taxus x media 'Densformis Select' ass Code Name Symbol Scientific Name DecaB Deschampsia caespitosa Bronzeschleier MisiP Miscanthus sinensis 'Purpuracens' PaviDB Panicum virgatum 'Dallas Blues'	TameDS Taxus x media 'Densformis Select' Select Dense Spreading Yew ass Code Name Symbol Scientific Name Common Name DecaB Deschampsia caespitosa Bronzeschleier Bronze Veil Tuft Hair Grass MisiP Miscanthus sinensis 'Purpuracens' Purple Silver Grass PaviDB Panicum virgatum 'Dallas Blues' Dallas Blues Switch Grass	TameDS Taxus x media 'Densformis Select' Select Dense Spreading Yew 18" - 24" - B&B ass Code Name Symbol Scientific Name Common Name Planting Size DecaB Deschampsia caespitosa Bronzeschleier Bronze Veil Tuft Hair Grass 1-Gal - Cont MisiP Miscanthus sinensis 'Purpuracens' Purple Silver Grass 1-Gal - Cont PaviDB Panicum virgatum 'Dallas Blues' Dallas Blues Switch Grass 1-Gal - Cont

PARCEL IS ZONED LB1: AS PER TABLE 295-405-C TYPE "A" LANDSCAPE IS REQUIRED. A FENCE IS NOT REQUIRED 1. DECIDUOUS STREET TREES (2.5" C) ARE REQUIRED AT 25'-0" O.C. 290 LINEAL FEET OF PARKING ALONG STREET

FRONTAGE 290 / 25 = 11.6 2. SHRUBS ARE REQUIRED: 2 STAGGERED ROWS AT A MAXIMUM

SPACING OF 4'-0" ON CENTER. 3. AS PER TABLE 295-405-2 INTERIOR PARKING LOT LANDSCAPING

2 TREES (2.5" C) AND 2 SHRUBS FOR EVERY 8 PARKING STALLS 170 PARKING STALLS

43 TREES REQUIRED 43 SHRUBS REQUIRED

> UNDERGROUND SEWER AND UTILITY INFORMATION AS SHOWN IS OBTAINED FROM THE RECORDS OF MUNICIPALITY AND LOCAL UTILITY COMPANIES. THE ACCURACY OF WHICH CAN NOT BE GUARANTEED OR WISCONIN CALL THE MILWAUKEE CERTIFIED TO

THE LOCATIONS OF EXISTING UTILITY INSTALLATIONS AS SHOWN ON THIS SURVEY ARE APPROXIMATE. THERE MAY BE OTHER UNDERGROUND UTILITY INSTALLATIONS WITHIN THE PROJECT AREA THAT ARE NOT SHOWN.

TO OBTAIN LOCATION OF PARTICIPANT'S UNDERGROUND FACILITIES BEFORE YOU DIG IN UTILITY ALERT NETWORK <u>(800)-242-8511</u>, (262) 432-7910

(now what's **below.** Call before you die

SALT TOLERANT GRASS SEED MIX REINDER'S 1-262-786-3300

20% SEA LINK CREEPING RED FESCUE

20% KENBLUE KENTUCKY BLUE GRASS

APPLY AT A RATE OF 175 POUNDS PER ACRE.

REFER TO SUPPLIERS SPECIFICATIONS AND

INSTALLATION CUT SHEETS FOR FURTHER

25% FULTS ALKALIGRASS

INFORMATION

15% SPARTAN HARD FESCUE 20% QUEBEC PERENNIAL RYE GRASS

LANDSCAPE PLAN GENERAL NOTES

* * PLANT MATERIAL SHOWN ON LANDSCAPE PLAN IS DEPICTED AT MATURE GROWTH. * *

AT LEAST SEVENTY-TWO HOURS PRIOR TO ANY EXCAVATION, CONTRACTOR SHALL VERIFY UTILITY LOCATIONS AS GIVEN BY THE ELECTRIC, GAS, TELEPHONE, WATER, SEWER, AND CABLE TELEVISION COMPANIES, UTILITIES OR ENTITIES. REVIEW WITH OWNER'S REPRESENTATIVE SITE MECHANICAL, SITE ELECTRICAL AND LIGHTING, SITE GRADING AND DRAINAGE, SITE IRRIGATION AND ALL OTHER DRAWINGS PERTAINING TO UNDERGROUND UTILITY LOCATIONS. RECORD SET OF INFORMATION THE SAME AS IN POSSESSION OF OWNER'S REPRESENTATIVE. ALSO REVIEW OWNER'S "MARK SETS" OF ALL OF THESE DRAWINGS IN POSSESSION OF THE CONTRACTOR OR OWNER. MARK ALL SUCH UTILITIES ON THE SITE PRIOR TO COMMENCING. COORDINATE WITH OWNER BEFORE AND DURING CONSTRUCTION. REPAIR ANY DAMAGE TO ANY SYSTEM THAT IS CAUSED BY LANDSCAPE CONTRACTOR AT NO COST TO OWNER.

ALL PLANTINGS SPECIFIED FOR THE GOLDEN CORRAL PROJECT PLANTING TABLES (SHEETS LSP1.1 & LSP1.2) SHALL COMPLY WITH STANDARDS AS DESCRIBED IN AMERICAN STANDARD OF NURSERY STOCK ANSI Z60.1 2014 AND ANSI STANDARDS FOR PLANTING 2012

DEVIATIONS FROM THE APPROVED THE GOLDEN CORRAL PROJECT PLANS SHALL BE NOTED ON THE RECORD DRAWING BY THE CONTRACTOR AND ONLY WITH PRIOR APPROVAL OF THE LANDSCAPE ARCHITECT AND OWNER'S REPRESENTATIVE. VERBAL AGREEMENTS OR REVISIONS WITHOUT A CHANGE ORDER WILL NOT BE RECOGNIZED BY LANDSCAPE ARCHITECT AND OWNER.

ALL PLANTS MUST BE BID AND SELECTED PER THE SPECIES SPECIFIED ON THE PLANS. THE SIZES OF PLANT MATERIAL LISTED HEREIN IS A MINIMUM ACCEPTABLE SIZE. ADDITIONALLY, IF EXCESSIVE PRUNING REDUCES THE CROWN THE PLANT SHALL BE REPLACED.

PROTECT PUBLIC FROM CONSTRUCTION WITH BARRIERS AND BARRICADES. ALL AREAS THAT WERE DISTURBED DURING CONSTRUCTION AND AREAS NOT COVERED WITH PAVEMENT, BUILDING, PLANTING BEDS, OR TREE PITS ARE TO BE TOPSOILED 3" DEEP (MIN.) AND SHALL BE SODDED/SEEDED WITH SPECIFIED LAWN GRASS. LANDSCAPE CONTRACTOR SHALL INCLUDE COST PER SQUARE YARD FOR ADDITIONAL SEED OPERATIONS AS MAY BE POSSIBLY REQUIRED TO REESTABLISH ADJACENT TURF GRASS AREAS WHICH MAY BECOME DAMAGED DURING THE CONSTRUCTION PROCESS OR TO REPAIR DAMAGE DONE BY OTHERS.

CONTRACTOR IS RESPONSIBLE FOR FURNISHING ALL MATERIALS, TOOLS, EQUIPMENT, LABOR, AND PLANTS NECESSARY FOR PROPER PLANTING AND INSTALLATION OF ALL LANDSCAPE MATERIAL.

QUANTITIES ON PLANT MATERIALS LIST ARE FOR CONVENIENCE OF BIDDING ONLY. CONTRACTOR IS RESPONSIBLE FOR ALL PLANTS SHOWN ON LANDSCAPE PLANS AND COVERAGE OF ALL AREAS DELINEATED. THE PLANS ARE TO SUPERSEDE THE PLANT LIST IN ALL CASES.

CONTRACTOR IS RESPONSIBLE FOR ALL ESTIMATING AND BIDDING, ALL AREAS, QUANTITIES MATERIALS SHOULD BE FIELD VERIFIED WITH SITE CONDITIONS.

WHERE DISCREPANCIES OCCUR BETWEEN THE LANDSCAPE PLANS AND/OR ARCHITECTURAL AND/OR THE CIVIL DRAWINGS (AND ANY OTHER SITE DRAWINGS) THE DISCREPANCIES MUST BE BROUGHT TO THE LANDSCAPE ARCHITECTS ATTENTION FOR COORDINATION AND RESOLUTION.

11. ALL DISEASED, NOXIOUS OR INAPPROPRIATE MATERIALS SHALL BE REMOVED FROM THE PROPOSED SITE PRIOR TO THE START OF CONSTRUCTION AND DURING THE MAINTENANCE PERIOD.

12. GENERAL CONTRACTOR SHALL LEAVE THE SITE FREE OF CONSTRUCTION DEBRIS. ALL LAWN AND PLANTING AREAS SHALL SLOPE TO DRAIN A MINIMUM OF 2% UNLESS NOTED OTHERWISE

AND REVIEWED WITH OWNER'S REPRESENTATIVE FOR FINAL APPROVAL 14. FINISH GRADES FOR SHRUB AND GROUND COVER AREAS SHALL BE HELD 1" BELOW TOP OF ADJACENT

PAVEMENTS AND CURBS, UNLESS NOTED OTHERWISE ON THE PLANS. REFER TO LSP1.4 FOR FURTHER INFORMATION. 15. ALL PERENNIAL, ANNUAL AND GROUND COVER AREAS TO RECEIVE A BLEND OF ORGANIC SOIL AMENDMENTS PRIOR TO PLANTING. TILL THE FOLLOWING MATERIALS INTO EXISTING TOPSOIL TO A DEPTH

OF APPROXIMATELY 8". A DEPTH OF 12" IN TREE PITS. PROPORTIONS AND QUANTITIES MAY REQUIRE ADJUSTMENT DEPENDING ON THE CONDITION OF EXISTING SOIL. REFER TO LSP1.4 FOR FURTHER INFORMATION. PER EVERY 100 SQUARE FEET ADD:

CUBIC YARD OF COMPOSTED MANURE OR OTHER COMPOSTED, ORGANIC MATERIAL ALL SHRUBS TO BE POCKET PLANTED WITH A 50/50 MIX OF COMPOSTED, ORGANIC MATERIAL AND EXISTING SOIL. INSTALL TOPSOIL INTO ALL BEDS AS NEEDED TO ACHIEVE PROPER GRADE. REMOVE ALL EXCESSIVE GRAVEL, CLAY AND STONES. REFER TO LSP1.4 FOR FURTHER INFORMATION. PLANT ALL TREES SLIGHTLY HIGHER THAN FINISHED GRADE AT ROOT FLARE. BACK FILL HOLE WITH 2/3

ONE - 2 CUBIC FOOT BALE OF PEAT MOSS, 2 POUNDS OF 5 -10 -5 GARDEN FERTILIZER, 1/4

EXISTING TOPSOIL AND ORGANIC SOIL AMENDMENTS SPECIFIED IN NOTE 15. AVOID ANY AIR POCKETS. DISCARD ANY GRAVEL CLAY OR STONES. REFER TO LSP1.4 FOR FURTHER INFORMATION. ALL TREES TO BE INSTALLED, STAKED AND GUYED ACCORDING TO DETAILS. REFER TO ANSI STANDARDS FOR PLANTING 2012 AND DETAILS ON LSP1.4 FOR FURTHER INFORMATION.

PROVIDE A 4'-0" - 5'-0" DIAMETER MULCH RING ALL LAWN TREES.

ALL PLANTINGS TO BE WATERED AT THE TIME OF PLANTING, THROUGHOUT CONSTRUCTION AND UPON COMPLETION OF PROJECT AS REQUIRED.

WHERE SPECIFIED, ALL PLANT BEDS, PITS AND TREE RINGS ARE TO RECEIVE A MINIMUM OF 2'-3" DRESSING OF SHREDDED HARDWOOD OAK BARK MULCH SHAVINGS FREE OF GROWTH, WEEDS, FOREIGN MATTER detrimental to plant life or germination inhibiting ingredients. Landscape contractor to PROVIDE A SAMPLE TO OWNER FOR APPROVAL. CONTRACTOR TO TAKE CARE WITH INSTALLATION NOT TO DAMAGE OR COVER PLANTS. REFER TO LSP1.4 FOR FURTHER INFORMATION.

LAWN INSTALLATION: CONTRACTOR TO FURNISH AND PREPARE TOPSOIL (3" MIN) AND SEED BED (REMOVE ALL STONES 1" OR LARGER), APPLY STARTER FERTILIZER AND SEED UNIFORMLY. PROVIDE A MULCH COVERING SUITABLE TO GERMINATE AND ESTABLISH TURF. EROSION CONTROL MESH SHOULD BE USED IN SWALES AND STEEP GRADES WHERE APPLICABLE. METHODS OF INSTALLATION MAY VARY AT THE DISCRETION OF CONTRACTOR. IT IS HIS/HER RESPONSIBILITY TO ESTABLISH AND GUARANTEE A SMOOTH, UNIFORM, QUALITY TURF. IF STRAW MULCH IS USED AS A COVERING, A TACKIFIER MAY BE NECESSARY TO AVOID WIND DAMAGE.

REQUIRED SEED MIXES: PREMIUM 60 GRASS SEED MIX REINDER'S (262) 786-3300

20% AMERICAN KENTUCKY BLUE GRASS 20% ALPINE KENTUCKY BLUE GRASS 20% LANGARA KENTUCKY BLUE GRASS 20% VICTORY CHEWINGS FESCUE 10% FIESTA III PERENNIAL RYE GRASS 10% CUTTER PERENNIAL RYE GRASS APPLY AT A RATE OF 175 POUNDS PER ACRE. REFER TO SUPPLIERS SPECIFICATIONS AND INSTALLATION CUT SHEETS FOR FURTHER INFORMATION

NO-MOW LOW GROW GRASS SEED MIX REINDER'S 45% SPARTAN HARD FESCUE 40% AZAY SHEEP FESCUE 15% TRANSIT ANNUAL RYE GRASS APPLY AT A RATE OF 175 POUNDS PER ACRE. REFER TO SUPPLIERS SPECIFICATIONS AND

INSTALLATION CUT SHEETS FOR FURTHER INFORMATION 24. DURING THE INITIAL "30 DAY MAINTENANCE PERIOD" THE LANDSCAPE CONTRACTOR IS REQUIRED TO PROVIDE AND ON-GOING PLEASANT VISUAL ENVIRONMENT WHEREAS ANY PLANT WHICH IS NOT RESPONDING TO TRANSPLANTING OR THRIVING SHALL IMMEDIATELY BE REPLACED. NEW LAWNS SHALL WATERED AND REPAIRED & WEEDS MUST CONSTANTLY BE REMOVED, NO EXCEPTIONS WILL BE GRANTED.

25. ALL NEWLY PLANTED TREES AND SHRUBS ARE TO RECIEVE AN APPLICATION OF AN ANTI-DESICANT TRANSPIRANT SPRAY THAT WILL EFFECTIVELY REDUCE THE WATER LOSS OF TRANSPIRATION OF PLANT MATERIAL AND REDUCE THE STRESS OF TRANSPLANTATION. IT IS RECOMENDED AS PART OF THE ONGOING MAINTENANCE THAT ANY BROADLEAF EVERGREEN AND CONIFEROUS TREE AND SHRUBS (EXCLUDING ARBORVITAE) RECIEVE AN APPLIATION OF AN ANTI-DESICANT SPRAY TO REDUCE THE LOSS OF MOISTURE DUE TO WINTER DESICCATION AS WELL. MAINTENANCE. THE OWNER SHALL TEND AND MAINTAIN ALL PLANT MATERIALS IN A HEALTHY GROWING

CONDITION AS PER THE APPROVED PLAN. PLANTINGS SHALL BE REPLACED WHEN NECESSARY AND KEPT FREE FROM REFUSE & DEBRIS. ALL PLANTING MATERIAL WHICH IS DYING OR DAMAGED BEYOND RECOVERY SHALL BE REPLACED WITHIN SIX (6) MONTHS OR BY THE NEXT PLANTING SEASON, WHICHEVER COMES FIRST. LANDSCAPE / SITE DEMOLITION CONTRACTOR TO VERIFY LOCATIONS OF EXISTING TREES AND SHRUBS BE SALVAGED AND CLEARLY TAG THEM WITH MARKING TAPE AND CONSTRUCTION FENCE.

TO OBTAIN LOCATION OF PARTICIPANT'S UNDERGROUND FACILITIES BEFORE YOU DIG IN WISCONSIN



WISCONSIN STATUTE 182.0175 (1974) REQUIRES A MINIMUM OF 3 DAYS NOTICE BEFORE YOU EXCAVATE (NOT INCLUDING SATURDAY, SUNDAY OR LEGAL HOLIDAYS)

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Job Number:

Sheet Number:

L16-085

ARCHITECT.

PROPOSED LANDSCAPE PLAN,

AND PLANT MATERIAL TABLE

GENERAL NOTES,

BOZA Submittal

Proposed Plant Material Table - Foundation and Pedestrian Plaza - LSP1.2

Quantity	Code Name	Symbol	Scientific Name	Common Name	Planting Size	Comments
1	AcpaRD	0	Acer palmatum dissectum 'Red Dragon'	Red Dragon Japanese Maple	6' - 7' - B&B	
2	МаМ	6	Malus 'Marilee'	Marilee Flowering Crab	1 1/2" Cal - B&B	

broadicar be	CIGOOO3 31110D					
Quantity	Code Name	Symbol	Scientific Name	Common Name	Planting Size	Comments
8	FomaBS	***	Fothergilla major 'Blue Shadow'	Blue Shadow Witch Alder	18" - 24"- Cont	
10	НураВ	*	Hydrangea paniculata 'Bobo'	Bobo Hardy Hydrangea	18" - 24"- Cont	
3	HypaL	®	Hydrangea paniculata 'Limelight'	Limelight Hardy Hydrangea	4' - 5' - Cont	1
13	SpjaT		Spiraea japonica 'Tracy'	Double Play Big Bang Spirea	18" - Cont	
14	RonoY		Rosa x 'Noalesa'	Flower Carpet Yellow Groundcover Rose	18" - Cont	
2	Vica\$I	4	Viburnum carlesii 'J.N. Select A''	Spice Island Koreanspice viburnum	24" - 30" - B&B	

Conifer Everg	onifer Evergreen Shrub									
Quantity	Code Name	Symbol	Scientific Name	Common Name	Planting Size	Comments				
7	JucoGC		Juniperus communis 'Gold Cone'	Gold Cone Juniper	3' - 4' - B&B					
5	JucoM	E CALLE	Juniperus communis 'Mondap'	Alpine Carpet Juniper	18" - 24" - B&B					
13	TameDS	0	Taxus x media 'Densformis Select'	Select Dense Spreading Yew	18" - 24" - B&B					
2	ThocB	9	Thuja occidentalis 'Bobazam'	Mr. Bowling Ball Arborvitae	18" - 24"- Cont					

		4990	, ,			
6	ThocH		Thuja occidentalis 'Holmstrup'	Holmstrup Dwarf Arborvitae	4' - 5' - B&B	
Perennial Gr	ass					
Quantity	Code Name	Symbol	Scientific Name	Common Name	Planting Size	Comments
15	DecaNL		Deschampsia caespitosa 'Northern Lights'	Northern Lights Tufted Hair Grass	1-Gal - Cont	
12	DecaB	*	Deschampsia caespitosa Bronzeschleier	Bronze Veil Tuft Hair Grass	1-Gal - Cont	
3	MisiP	*	Miscanthus sinensis 'Purpuracens'	Purple Silver Grass	1-Gal - Cont	
19	PaviHR	*	Panicum virgatum 'Hot Rod'	Hot Rod Switch Grass	1-Gal - Cont	

3	PaviN	*	Panicum virgatum 'Northwind'	Northwind Switch Grass	1-Gal - Cont	
Perennial						
Quantity	Code Name	Symbol	Scientific Name	Common Name	Planting Size	Comments
12	EcBF		Echinacea 'Burgundy Fireworks'	Burgundy Fireworks Coneflower	4 1/2" pot	
31	HePF		Heuchera x 'Peach Flambe'	Peach Flambe Coral Bells	1-Gal - Cont	
16	RuT	8	Rudbeckia 'TigerEye'	TigerEye Gloriosa Daisy	4 1/2" pot	
12	SaneE	0	Salvia nemorosa 'East Friesland'	East Friesland Salvia	4 1/2" pot	

1. Tree Form - Single Stem Specimen

SCALE: 1" = 10'-0"

LANDSCAPE DESIGN

Landscape Architecture and Master Planning Design Consulting

11525 W. North Avenue Suite 1B Wauwatosa, WI 53226 Tel (414) 476-1204 www.insitelandscape.com mdavis@insitelandscape.com

<u>Project:</u>

GOLDEN CORRAL

306 W. Layton Avenue Milwaukee, WI 53207

Issuance and Revisions:

02/02/17

02/20/17


Date	Number	Description
12/16/16		Client Review Submittal
01/17/17		BOZA Review Meeting

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PROPOSED PARTIAL LANDSCAPE PLAN AT FOUNDATION & PEDESTRIAN PLAZA, AND PLANT MATERIAL TABLE

Date of Drawing:	02/20/17
Scale:	1" = 10'-0"
Drawn By:	MCD
Job Number:	L16-085
Shoot Number:	

Sheet Number:

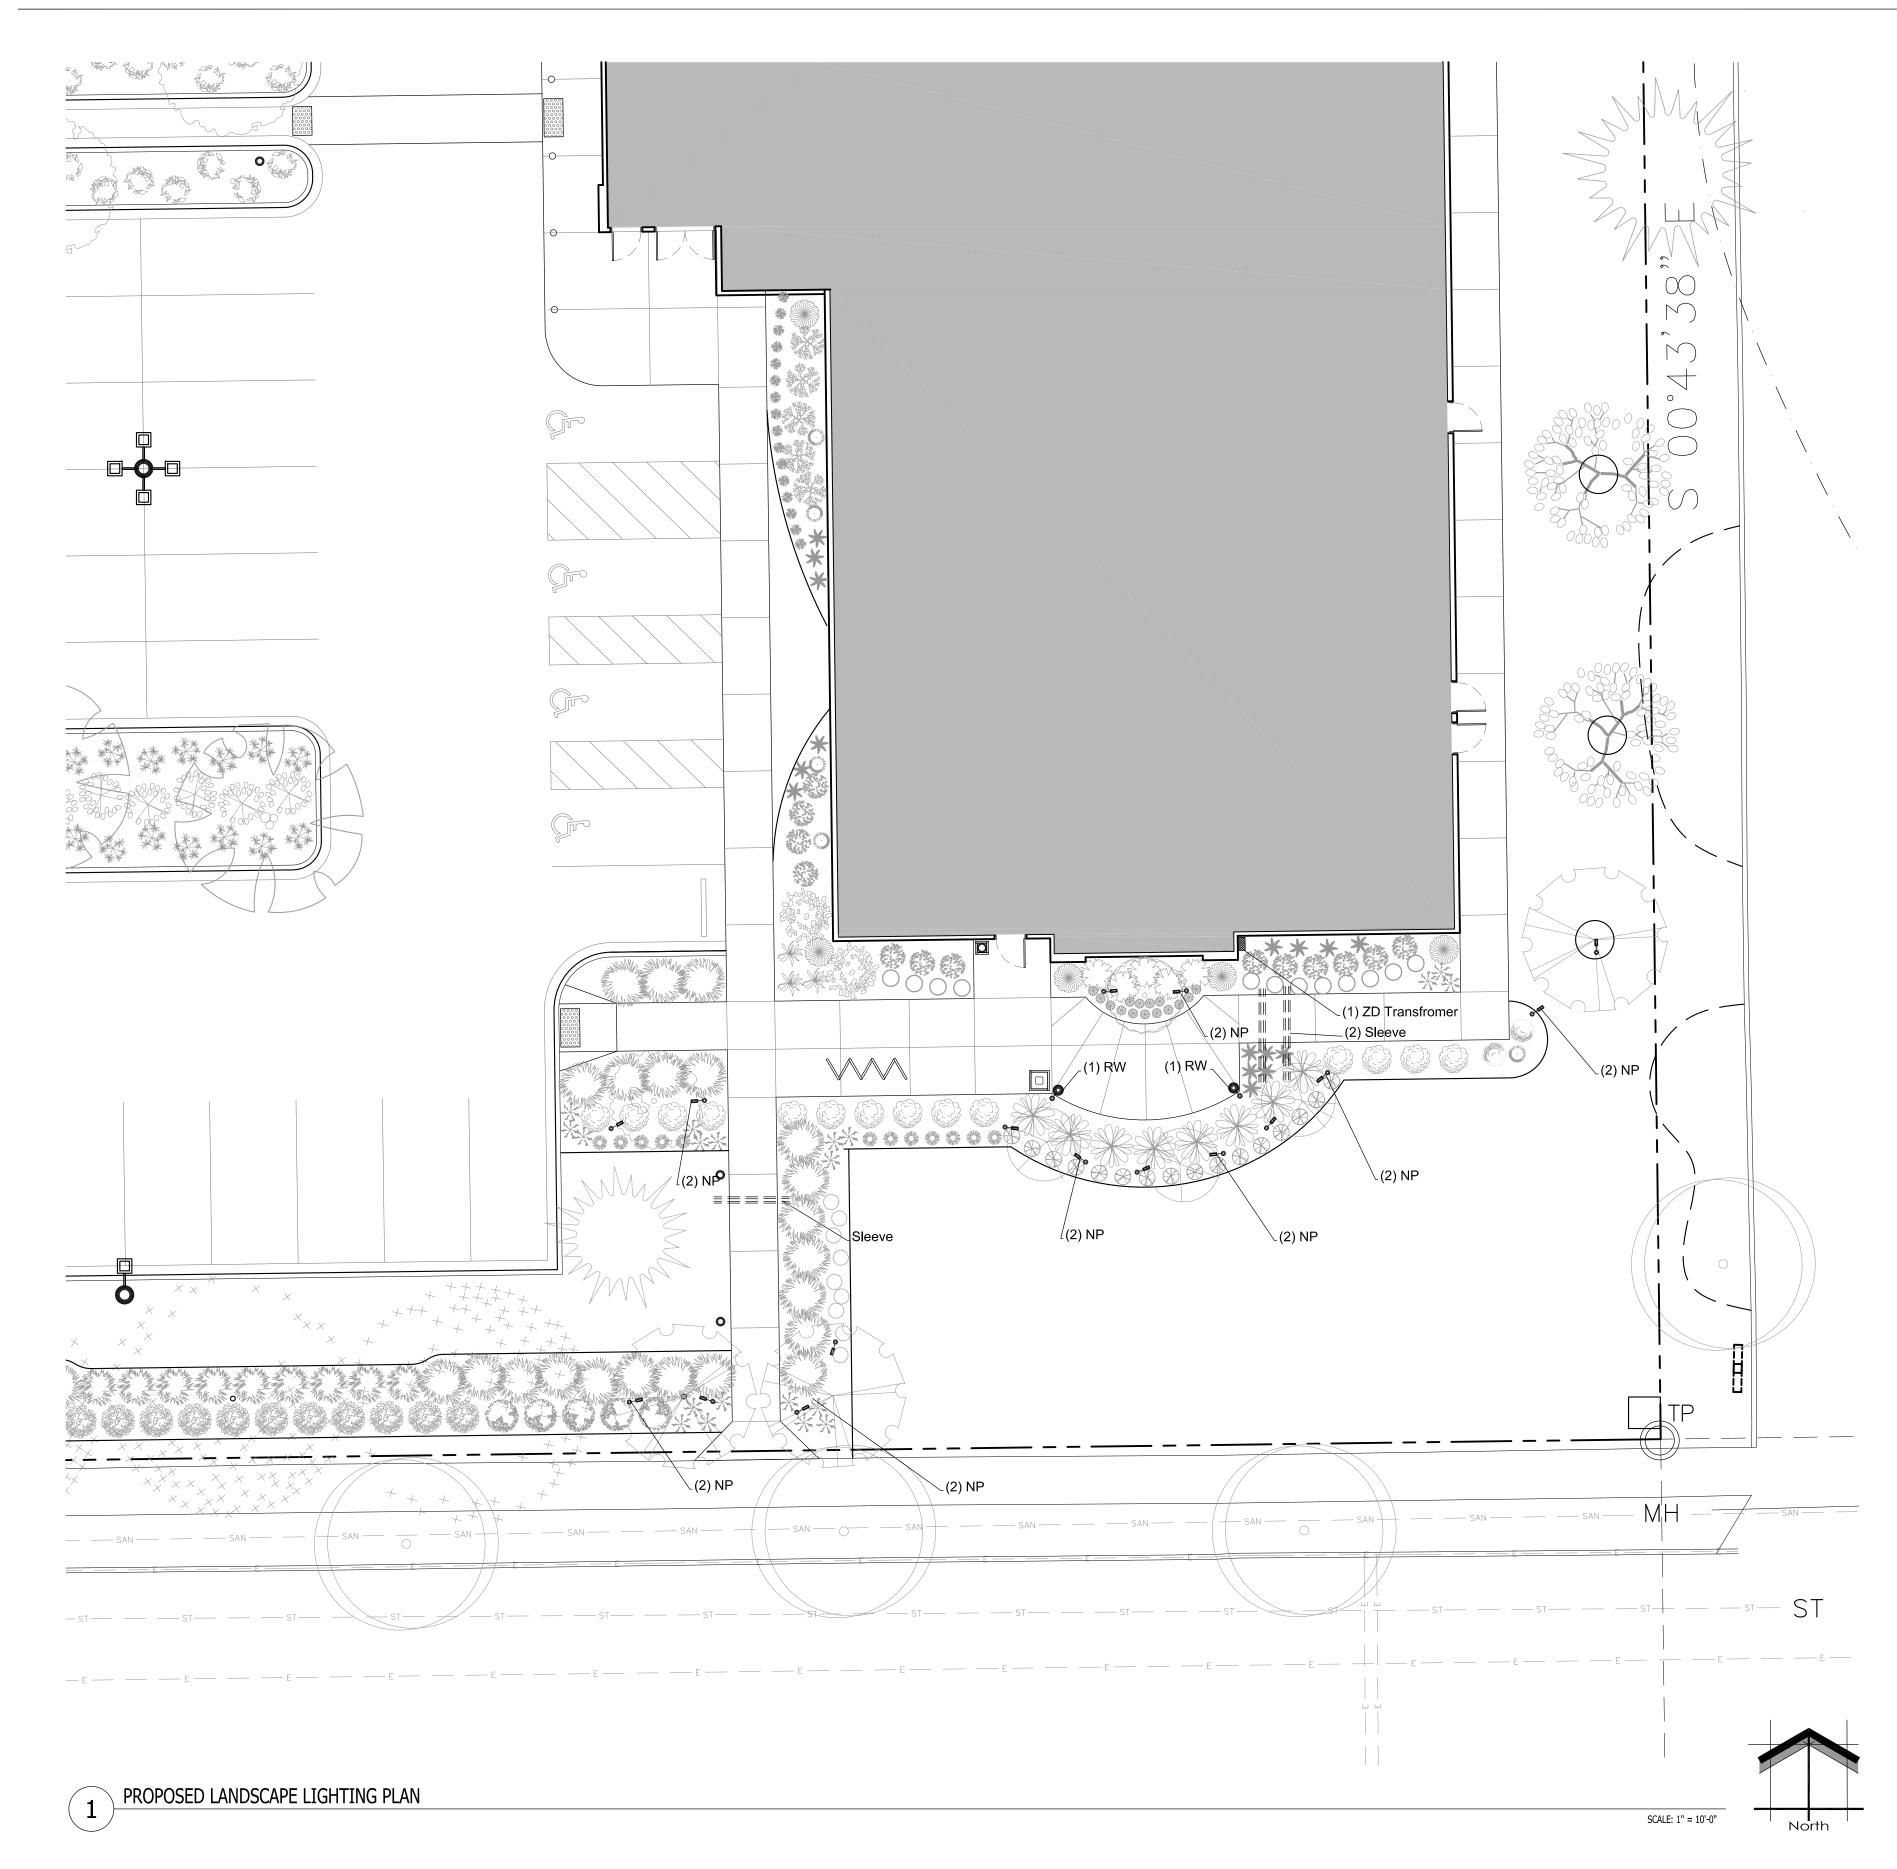

LANDSCAPE LOW VOLTAGE LIGHTING SCHEDULE

Quantity | Code Name Symbol Description \mid FX-LUMINARE NP UP LIGHT W/ 3 LED LAMP & BRONZE METALLIC FINISH ON A LARGE SLOT SPIKE AND RISER. COLOR TEMPERATURE RANGE TO BE SET AT 3000 DEGREES KELVIN FOR UPLIGHTING PLANT MATERIAL. NP-ZD-3LED-BZ REFER TO CUT SHEETS FOR FURTHER INFORMATION AND INSTALLATION INSTRUCTIONS.

FX-LUMINARE RW DIRECTIONAL PATH LIGHT W/ 3 LED LAMP & BRONZE METALLIC FINISH WITH A 24" RISER SUPER J BOX (SJ-12). REFER TO CUT SHEETS FOR FURTHER AND INFORMATION AND INSTALLATION RW-ZD-3LED-24R-BZ Transformer FX-LUMINARE LUXOR ZD 300 WITH COLOR WATT TRANSFORMER W/ STAINLESS STEEL FINISH FINISH. LUXOR WI-FI MODULE P/N FXWIFIMOD. REFER TO CUT SHEETS FOR FURTHER INFORMATION AND INSTALLATION PX-300

INSTRUCTIONS, LOCATIONS TO BE DETERMINED Approximate locations for pipe sleeve and cabling Pipe Sleeve and Cable

LOW VOLTAGE LIGHTING INSTALLER'S NOTE:

1. AT LEAST SEVENTY-TWO HOURS PRIOR TO ANY EXCAVATION, CONTRACTOR SHALL VERIFY UTILITY LOCATIONS AS GIVEN BY THE ELECTRIC, GAS, TELEPHONE, WATER, SEWER, AND CABLE TELEVISION COMPANIES, UTILITIES OR ENTITIES. REVIEW WITH OWNER'S REPRESENTATIVE SITE MECHANICAL, SITE ELECTRICAL AND LIGHTING, SITE GRADING AND DRAINAGE, SITE IRRIGATION AND ALL OTHER DRAWINGS PERTAINING TO UNDERGROUND UTILITY LOCATIONS. RECORD SET OF INFORMATION THE SAME AS IN POSSESSION OF OWNER'S REPRESENTATIVE. ALSO REVIEW OWNER'S "MARK SETS" OF ALL OF THESE DRAWINGS IN POSSESSION OF THE CONTRACTOR OR OWNER. MARK ALL SUCH UTILITIES ON THE SITE PRIOR TO COMMENCING. COORDINATE WITH OWNER BEFORE AND DURING CONSTRUCTION. REPAIR ANY DAMAGE TO ANY SYSTEM THAT IS CAUSED BY LIGHTING INSTALLER AT NO COST TO OWNER.

2. DEVIATIONS FROM THE APPROVED THE GOLDEN CORRAL PROJECT PLANS SHALL BE NOTED ON THE RECORD DRAWING BY THE LIGHTING INSTALLER /CONTRACTOR AND ONLY WITH PRIOR APPROVAL OF THE LANDSCAPE ARCHITECT AND OWNER'S REPRESENTATIVE. VERBAL AGREEMENTS OR REVISIONS WITHOUT A CHANGE ORDER WILL NOT BE RECOGNIZED BY LANDSCAPE ARCHITECT AND OWNER.

3. LOW VOLTAGE FIXTURES TO BE INSTALLED BY F/X LUMINARE FACTORY-TRAINED & CERTIFIED TECHNICIANS WHOM IS ABLE TO PROVIDE LUXOR ZD & ZDC SYSTEM PROGRAMMING AND IN-FIELD SUPPORT.

4. FIXTURES SHALL BE INDIVIDUALLY PROGRAMMABLE & DIMMABLE TO ACHIEVE MULTIPLE LUMEN OUTPUTS BASED ON LOCATION AND APPLICATION OF EACH FIXTURE; SEE "LIGHTING PROGRAM SCHEDULE."

5. LIGHTING CONTROLLER SHALL BE WI-FI COMPATIBLE TO ALLOW APP-BASED ON DEMAND SWITCHING & DIMMING OF INDIVIDUAL FIXTURES.

6. RECOMMENDED LIGHTING SUPPLIER: REINDERS INC. REINDERS IS AN AUTHORIZED FX LUMINAIRE MASTER DISTRIBUTOR AND IS FACTORY-TRAINED & CERTIFIED TO PROVIDE IN-FIELD SUPPORT FOR THE INSTALLATION AND PROGRAMMING OF LUXOR ZD & ZDC SYSTEMS. CONTACT: JOEL REINDERS, JPR@REINDERS.COM, 262-372-5780.

7. ALL FIXTURES ARE TO RECEIVE BETWEEN 10.0 AND 15 VOLTS.

8. INSTALLATION OF FIXTURES AND ASSOCIATED EQUIPMENT ARE TO CONFORM TO NEC AND UL 1838.

9. CONTRACTOR TO VERIFY EXISTING POWER LOCATIONS AND REQUIREMENTS.

10. PIPE SLEEVES ARE TO BE 2" WATER TIGHT SCHEDULE 40 PIPE AND SHOULD BE BURIED IN THE SOIL AT A 6" MINIMUM DEPTH (IN AREAS SUCH AS LAWNS AND FLOWER BEDS 10"-12" IS RECOMMENDED TO AVOID DAMAGE FROM TILLING OR AERATION AND EDGING.

11. METAL FENCE INSTALLER TO COORDINATE WITH LIGHTING INSTALLER REGARDING INSTALLATION LOGISTICS AND TIMING.

12. CONCRETE CONTRACTOR TO COORDINATE WITH LIGHTING INSTALLER REGARDING THE INSTALLATION OF PIPE SLEEVES, CABLE AND ELECTRICAL BOXES BEING PLACED IN CONCRETE FORMS. PIPE SLEEVES ARE TO BE PLACED IN GRANULAR BASE COURSE ENDS ARE TO BE TAPED SHUT AND MARKED WITH FLAGS.

13. ALL CABLE TO BE PROTECTED IN 1" SLEEVE, MINIMUM.

14. ALL FIXTURES THAT ARE SPECIFIED AS LED COLOR CHANGING SHALL USE RGBW TECHNOLOGY AND SHALL HAVE ADJUSTABILITY OF THE FOLLOWING ATTRIBUTE VALUES: HUE, SATURATION AND INTENSITY. COLOR PALETTES WILL BE DETERMINED UPON INSTALLATION AND/OR FINAL

15. ALL LOW VOLTAGE LIGHTING CABLE CONNECTIONS TO BE DONE WITH A SILICONE-FILLED LOCKING KITCHLER 15529BLPRO CONNECTOR OR ACE BRASS SCREW-TIGHT LUG WITH SHRINK TUBE CONNECTOR

16. LOW VOLTAGE LIGHTING CABLE SHALL BE UL (1493) AND RATED FOR OUTDOOR USE (SUNLIGHT RESISTANT). LOW VOLTAGE LIGHTING CABLE GAUGE TO BE SIZED APPROPRIATELY BASED ON THE LOAD AND LENGTH OF THE LIGHTING RUN.

17. LANDSCAPE LIGHTING CONTRACTOR TO COORDINATE POWER REQUIREMENTS AND LOCATION OF EXTERIOR / WATER PROOF GFCI OUTLETS FOR

PROPOSED NEW TRANSFORMER LOCATIONS WITH GENERAL CONTRACTOR AND LANDSCAPE ARCHITECT.

18. REVIEW AND FOLLOW MANUFACTURERS INSTALLATION INSTRUCTIONS FOR MOUNTING AND INSTALLING TRANSFORMERS

19. OWNER TO COORDINATE WITH LANDSCAPE ARCHITECT AND LIGHTING INSTALLER LIGHT SELECTION OF COLOR CAPABLE (ZDC) VERSUS NON COLORED (ZD) LIGHT FIXTURES.

20. FINAL THEME COLORS (IF DESIRED) AND TIMES TO BE ADJUSTED WITH OWNER AFTER INSTALLATION.

LANDSCAPE

Landscape Architecture and Master Planning Design Consulting

> 11525 W. North Avenue Suite 1B Wauwatosa, WI 53226 Tel (414) 476-1204 www.insitelandscape.com mdavis@insitelandscape.com

GOLDEN **CORRAL**

306 W. Layton Avenue Milwaukee, WI 53207

Issuance and Revisions:

12/16/16	Client Review Submittal
01/17/17	BOZA Review Meeting
02/02/17	BOZA Submittal
02/20/17	Plan Commission Submittal

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<u>Sheet Title:</u>

PROPOSED LANDSCAPE LIGHTING PLAN, GENERAL NOTES, AND FIXTURE SCHEDULE

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Date of Drawing:	02/20/17
Scale:	1" = 10'-0"
Drawn By:	MCD
Job Number:	L16-085

Sheet Number:



<u>Project:</u>

GOLDEN **CORRAL**

306 W. Layton Avenue Milwaukee, WI 53207

Issuance and Revisions:

SCALE: NONE

Date	Number	Description
12/16/16		Client Review Submittal
01/17/17		BOZA Review Meeting
02/02/17		BOZA Submittal
02/20/17		Dl Cii

Submittal

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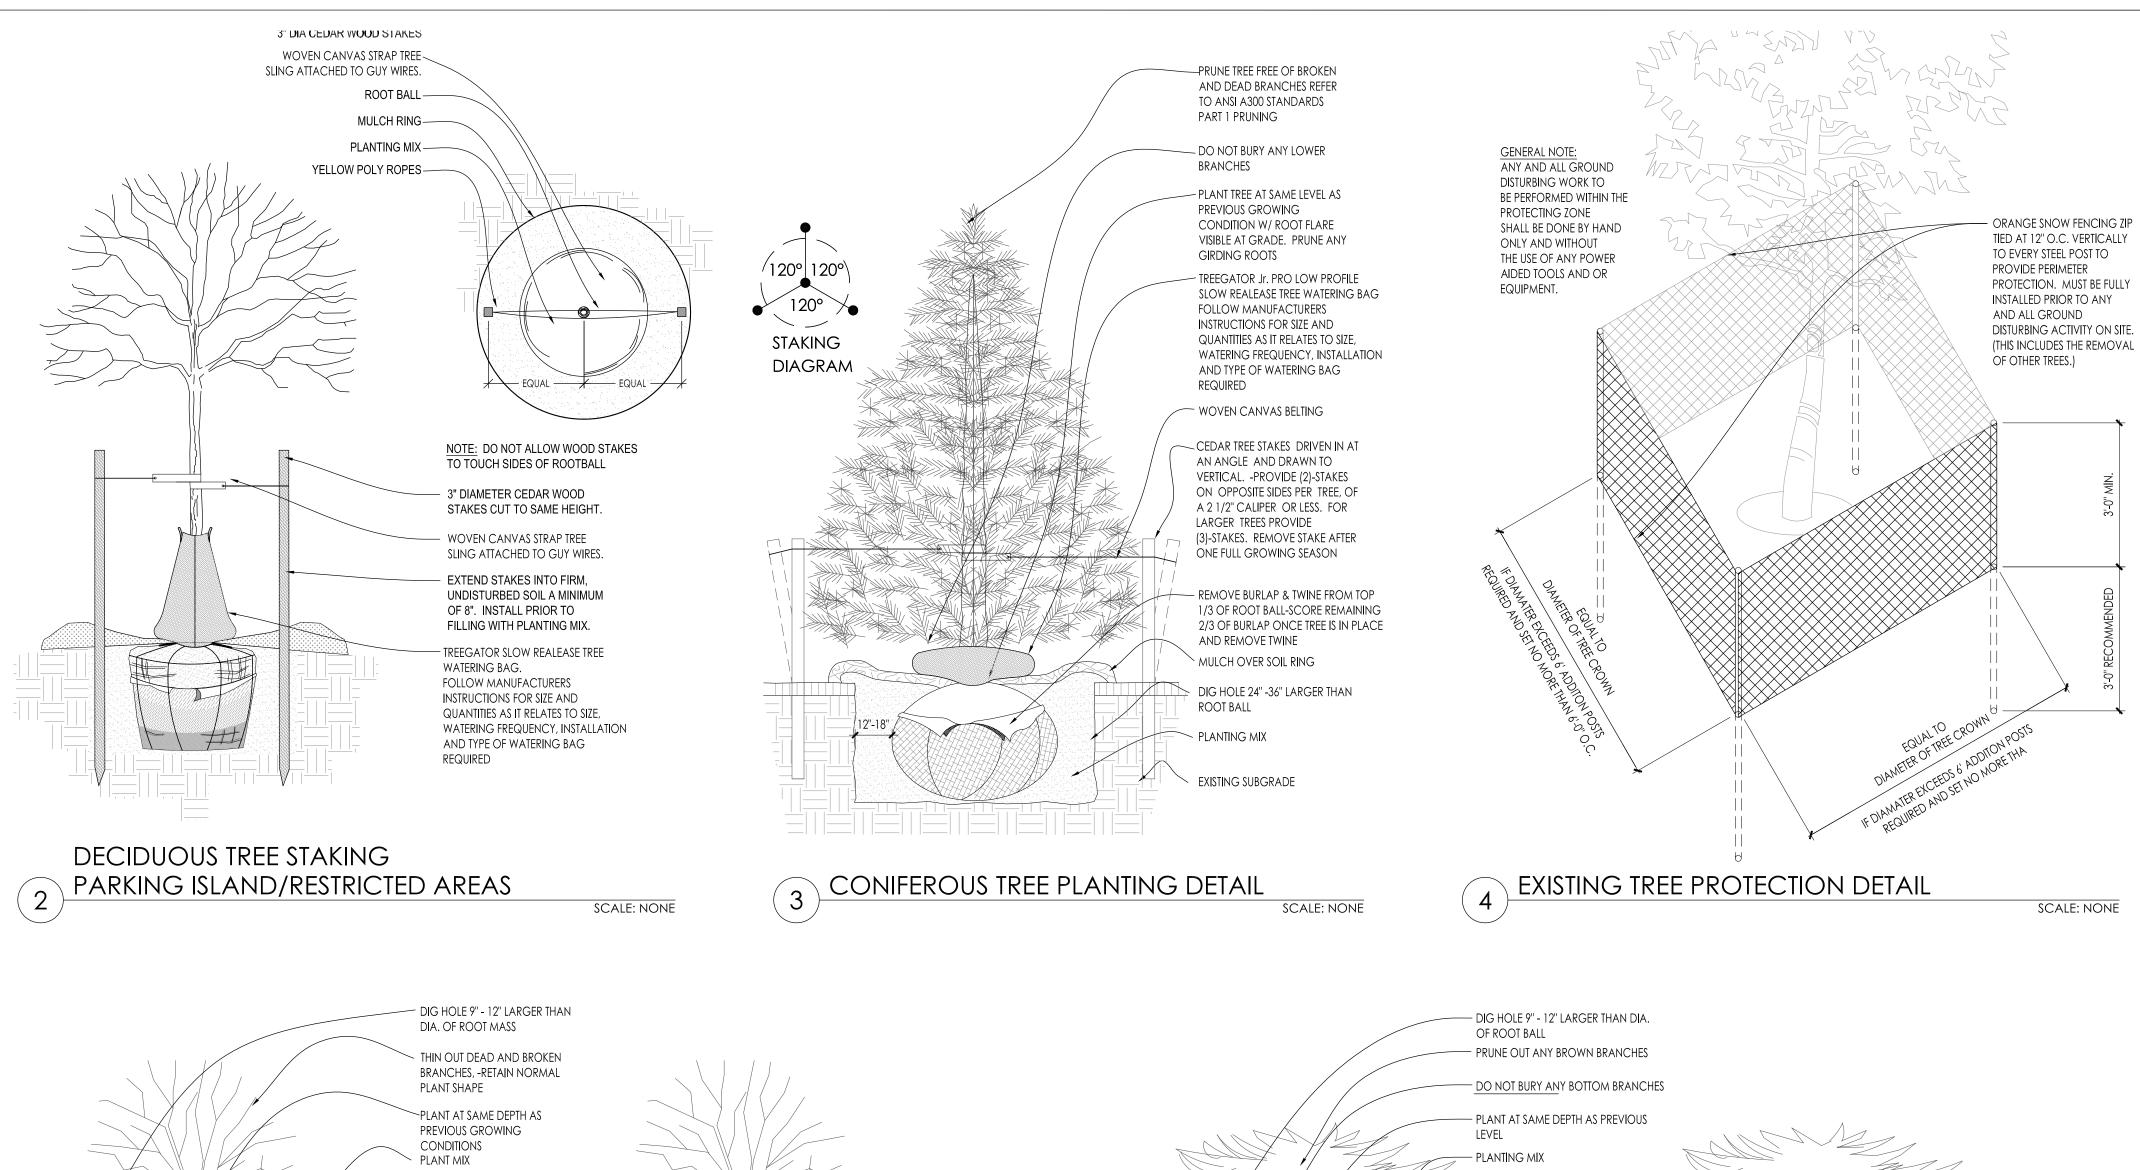
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Sheet Title:

PROPOSED LANDSCAPE PLAN, PLANTING DETAILS

Date of Drawing:	02/20/17
Scale:	As Notec
Drawn By:	MCD
Job Number:	L16-085

Sheet Number:



- MULCH LAYER 9" - 12" PAPER FIBER POT CONTAINER GROWN REMOVE ENTIRE POT IF IT IS POSSIBLE. IF ROOTS HAVE PENETRATED POT, CAREFULLY REMOVE FROM PLASTIC POT AND SCORE ROOTS 1" REMOVE RIM AND SCORE SIDES WITH KNIFE *REFER TO CONIFER BALLED DEEP WITH A SHARP KNIFE AND BURLAPPED INSTALLATION

- FINISHED GRADE-MULCH 9" - 12" <u>CONTAINER GROWN</u>
CAREFULLY REMOVE FROM PLASTIC POT AND SCORE BALLED & BURLAPPED REMOVE BURLAP AND TWINE FROM TOP 1/3 OF ROOT BALL AND SCORE REMAINING 2/3 ROOTS 1" DEEP WITH A SHARP KNIFE

DECIDUOUS SHRUB PLANTING DETAIL SCALE: NONE

PERIMETER OF BUILDING PERENNIALS AND/OR PERENNIAL GRASSES SHREDDED HARDWOOD BARK MULCH ____ SPADE EDGE EARTHEN BED EDGE STANDARD -TURF GRASS 12" MINIMUM OF PLANTING SOIL MIX UNDISTURBED EARTH VARIES W/ BEDS REFER TO PLANS

PERENNIAL BED PLANTING DETAIL

SLOPE PLANTING DETAIL

REFER TO TYPICAL DECIDUOUS TREE DETAIL FOR STAKING

DECIDUOUS TREE PLANTING DETAIL

PRUNE TREE FREE OF BROKEN

AND DEAD BRANCHES REFER

- TREEGATOR SLOW REALEASE TREE

FOLLOW MANUFACTURERS

INSTRUCTIONS FOR SIZE AND

AND TYPE OF WATERING BAG

PLANT TREE WITH ROOT FLARE

REMOVE BURLAP & TWINE FROM TOP 1/3 OF ROOT

BALL-SCORE REMAINING 2/3

OF BURLAP ONCE TREE IS IN

PLACE AND REMOVE TWINE

CEDAR TREE STAKES DRIVEN IN

(2)-STAKES ON OPPOSITE SIDES PER TREE, OF A 2 1/2" CALIPER

OR LESS. FOR LARGER TREES

-WOVEN CANVAS STRAP TREE

SLING ATTACHED TO GUY

MBESH OVER SOIL RING

DIG HOLE 24" -36" LARGER

SCALE: NONE

THAN ROOT BALL

- PLANTING MIX

— EXISTING SUBGRADE

ORIGINAL SLOPE

MODIFIED SLOPE

MULCH 3" MIN.

PLANTING SOIL

EXISTING SUBGRADE

SCALE: NONE

SCALE: NONE

STAKE AFTER ONE FULL

GROWING SEASON

PROVIDE (3)-STAKES. REMOVE

AT AN ANGLE AND DRAWN

TO VERTICAL. -PROVIDE

VISIBLE AT GRADE. PRUNE ANY

QUANTITIES AS IT RELATES TO SIZE,

WATERING FREQUENCY, INSTALLATION

TO ANSI A300 STANDARDS

PART 1 PRUNING

WATERING BAG.

REQUIRED

REQUIRED

GIRDING ROOTS

WRAP TREE IN FALL AS

(120° /

STAKING

DIAGRAM

Staking

DIAGRAM

4" TALL EARTH SAUCER BUILT ON LOW SIDE -

9 SPADE EDGE PLANT BED EDGE DETAIL

BEDLINES ARE TO BE CUT CRISP AS PER PLAN. A CLEAN DEFINITION BETWEEN TURF AND PLANTING BED IS REQUIRED. TOPSOIL / PLANTING MIX TOP OF MULCH SHOULD BE CRESTED 1-2" ABOVE TURF FOR POSITIBE DRAINGE. SLOPE GRADUALLY. 3" (+/-) MULCH BED -

SCALE: NONE

SCALE: NONE

CONIFEROUS SHRUB PLANTING DETAIL

306 W. Layton Avenue Milwaukee, WI 53207

Issuance and Revisions:

|Number | Description 12/16/16 Client Review Submittal 01/17/17 **BOZA Review**

Meeting 02/02/17 **BOZA Submittal** 02/20/17

Submittal

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ARCHITECT.

<u>Sheet Title:</u>


PROPOSED PHOTOMETRIC LIGHT LEVEL CALCULATIONS PLAN, GENERAL NOTES, AND FIXTURE TABLE

02/20/17

1" = 30'-0"

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	Drawn By:
	Job Number:

L16-085 Sheet Number:

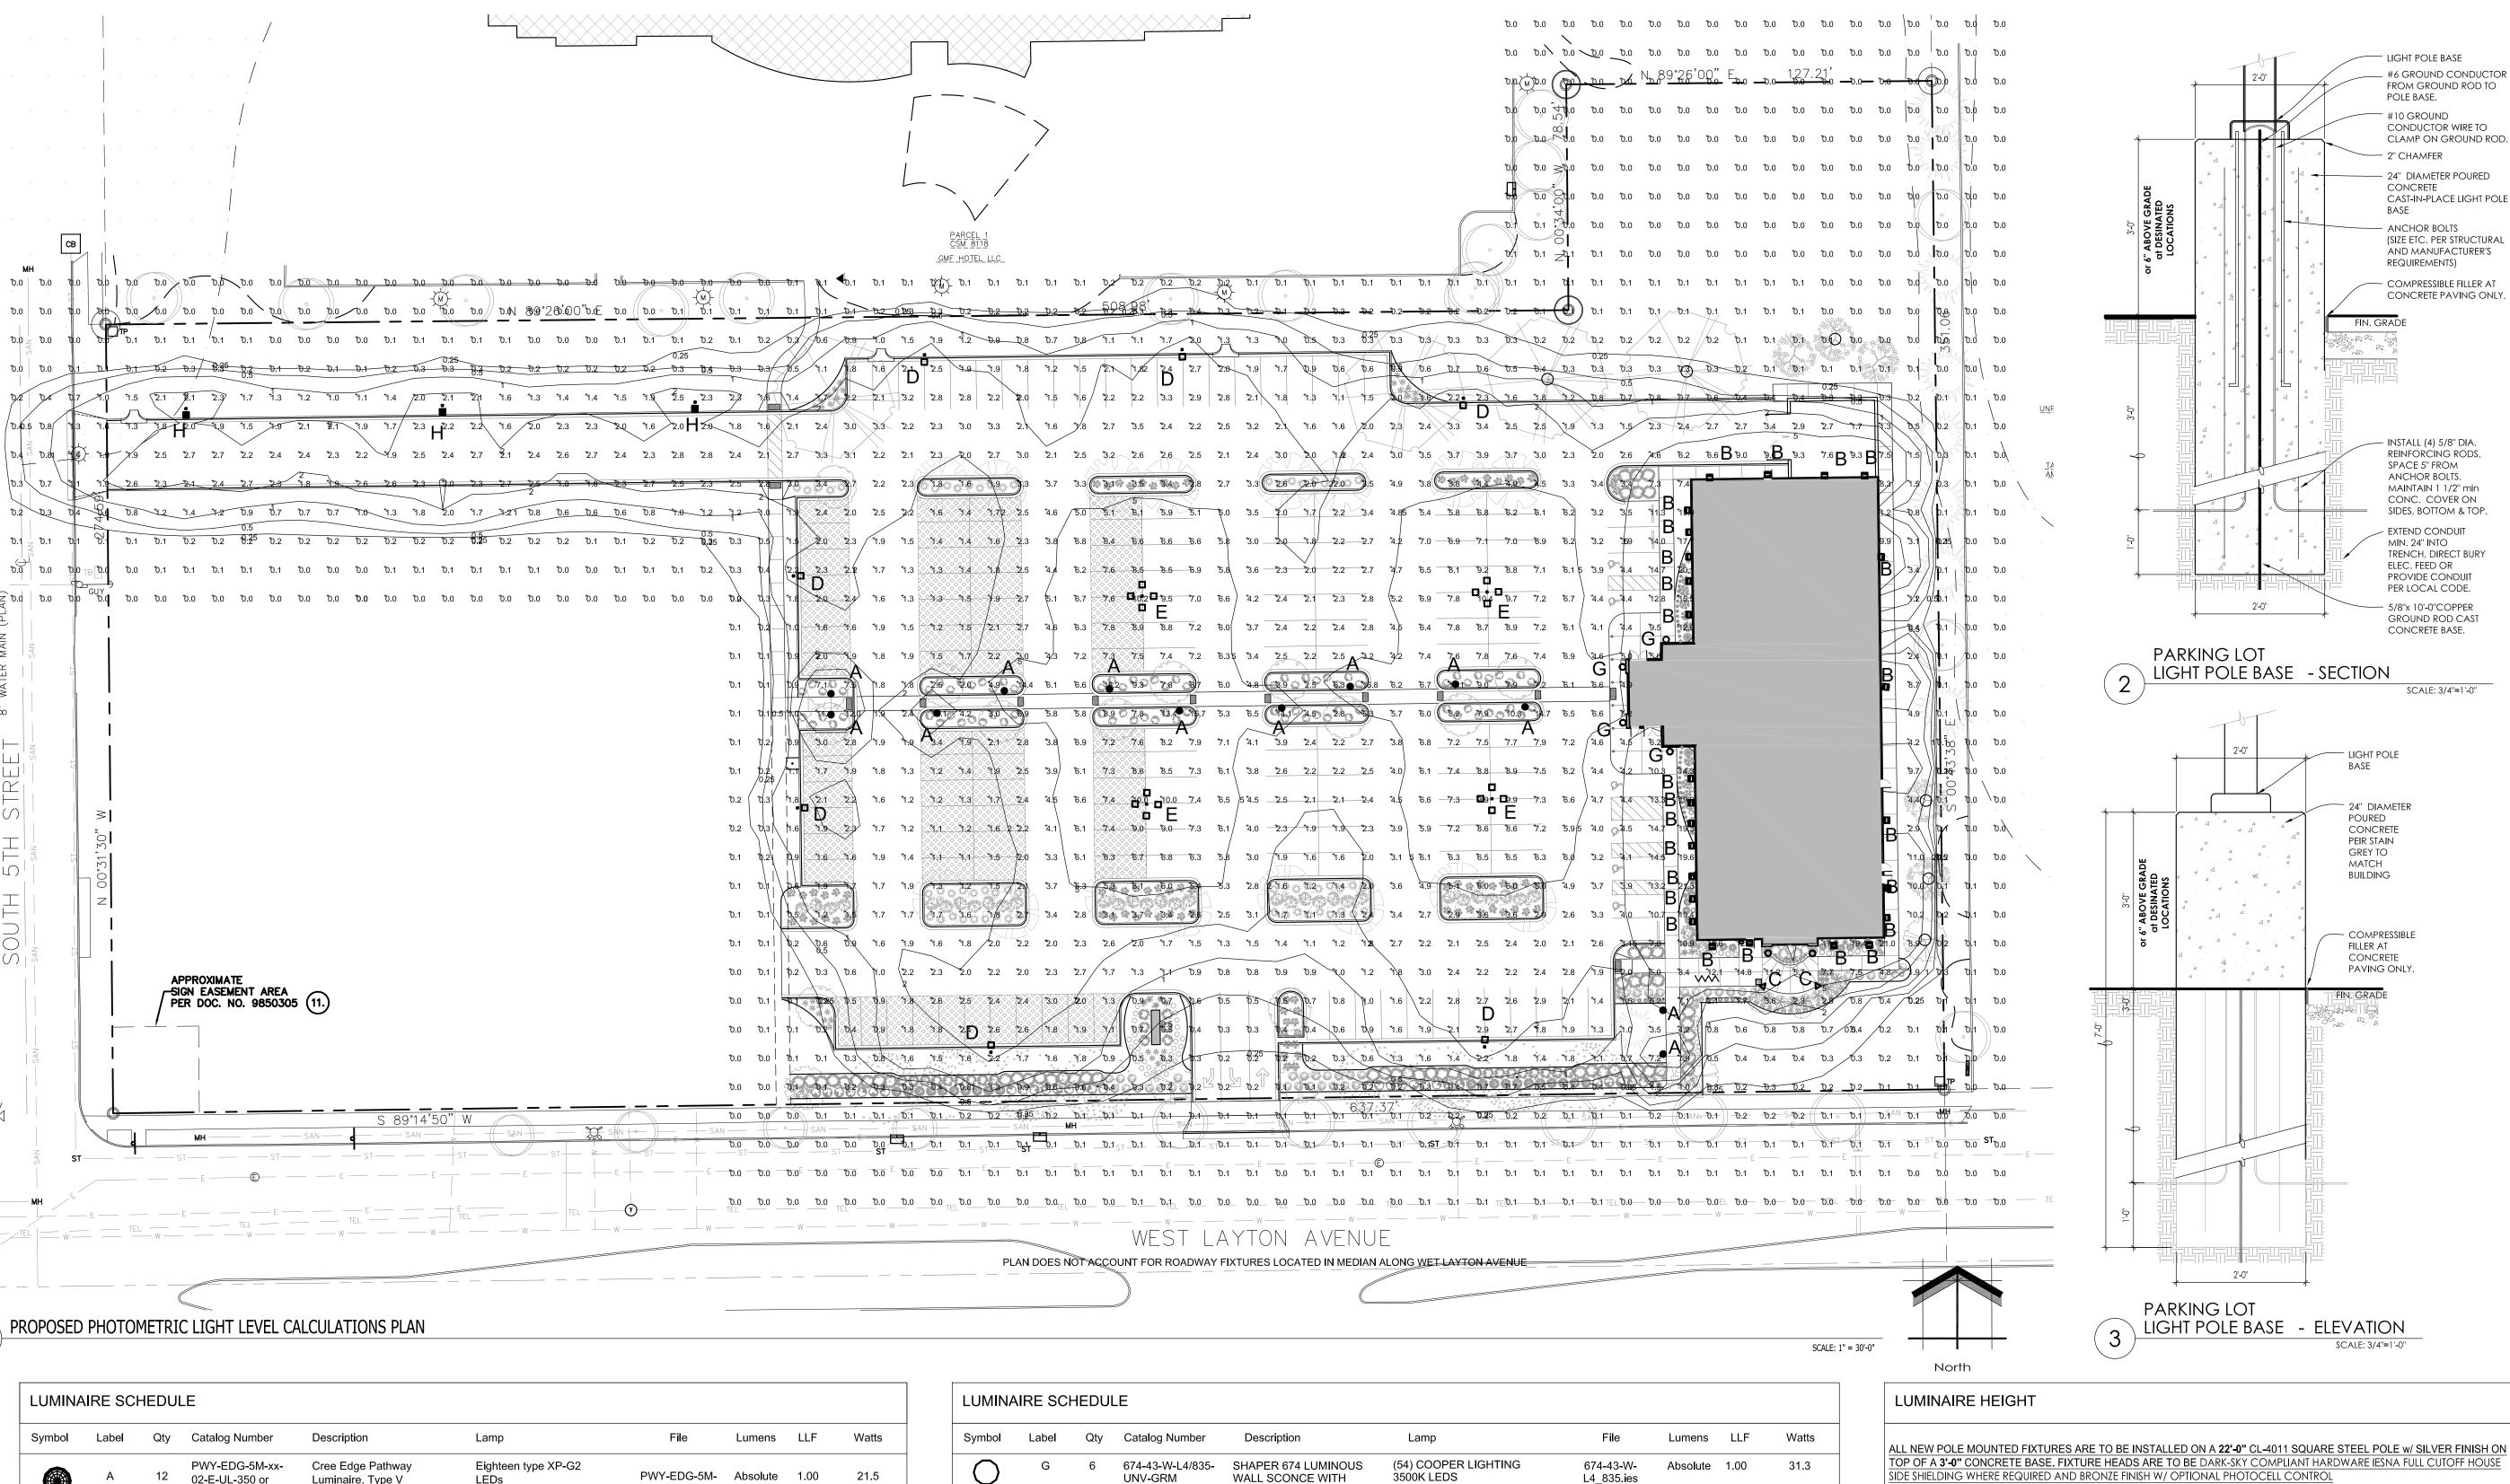

LUMINA	AIRE SC	HEDU	LE						
Symbol	Label	Qty	Catalog Number	Description	Lamp	File	Lumens	LLF	Watts
	А	12	PWY-EDG-5M-xx- 02-E-UL-350 or BXBPx518E-UH	Cree Edge Pathway Luminaire, Type V Medium, 18 LEDs, 120- 277V, 350mA, 5700K	Eighteen type XP-G2 LEDs	PWY-EDG-5M- xx-02-E-UL- 350_PL05699- 001B.IES	Absolute	1.00	21.5
	В	25	XSPWAx3FC-U	Cree XSPW Series Wallpack Luminaire, Type III Medium, 5700K, C Input Power Designator	4 type MDA LEDs	XSPWAx3MC- U_RESTL-2014- -0030.IES	Absolute	1.00	42.96
Δ	С	2	RW-3LED-12R-BZ	7-1/2"L. X 4-1/8"W. X 3"H. LED PATHLIGHT DIFFUSED LENS LOW VOLTAGE LIGHT FIXTURE REFER TO LSP1.3 FOR FURTHER INFORMATION		RW-3LED-12R- XX.IES	Absolute	1.00	7.88
	D	7	OSQ A NM 4ME A 57K-UL-CS w/OSQ- BLSMF CL-SSP-4011-25 -D6-PS-ABL	CONFIGURED FROM Cree OSQ Series Area Luminaire, Type IV Medium w/ Backlight Shield, A Input Power Designator, 5700K	CONFIGURED FROM Twelve type MDA LEDs	OSQ A xx 4ME A 57K-UL w- OSQ- BLSMF_CONF IGURED.ies	Absolute	1.00	112
	Е	4	OSQ A NM 4ME A 57K-UL-CS w/OSQ CL-SSP-4011-25 -D6-PS-ABL	CONFIGURED FROM Cree OSQ Series Area Luminaire, Type IV Medium, A Input Power Designator, 5700K	CONFIGURED FROM Eight type MDA 4000K LEDs	OSQ A xx 4ME A 57K_CONFIGU RED.ies	Absolute	1.00	448

Symbol	Label	Qty	Catalog Numb	er	Description	Lamp		File	Lumens	LLF	Watts
0	G	6	674-43-W-L4/8 UNV-GRM	W H A	HAPER 674 LUMINOUS ALL SCONCE WITH ORIZONTAL TRIM BARS ND VERTICAL FIN ETAIL, GUN METAL.	(54) COOPER LIGI 3500K LEDS	HTING	674-43-W- L4_835.ies	Absolute	1.00	31.3
	Н	7	OSQ A NM 2N 57K-UL-CS w/OSQ- BLSN CL-SSP-4011 -D6-PS-ABL	O //F T -25 S	ONFIGURED FROM Cree SQ Series Area Luminaire, pe II Medium w/ Backlight nield, B Input Power esignator, 5700K	CONFIGURED FROM MDA LEDs		OSQ A xx 2ME B 57K-UL w- OSQ- BLSMF_CONF IGURED.ies	Absolute	1.00	86
STATIS	TICS										
Description	ı		Symbol	Avg	Max	Min	Max/Min	Avg/Min			
Calc Zone	#1		+	2.2 fc	28.5 fc	0.0 fc	N / A	N/A			

1. BASED ON THE INFORMATION PROVIDED, ALL DIMENSIONS AND LUMINAIRE LOCATIONS SHOWN REPRESENT RECOMMENDED POLE PLACEMENTS AND LUMINAIRE ORIENTATION. THE ENGINEER AND/OR ARCHITECT MUST DETERMINE APPLICABILITY OF THE LAYOUT TO RELEVANT FIELD CONDITIONS.

2. THE DEPICTED ILLUMINATION RESULTS ARE BASED UPON ILLUMINATION MEASUREMENTS AS CALCULATED BY AN INDEPENDENT LABORATORY. LUMINAIRE CHARACTERISTICAL DATA WAS MEASURED UNDER CONTROLLED CONDITIONS IN ACCORDANCE WITH APPROVED ILLUMINATION ENGINEERING SOCIETY METHODS. ACTUAL ON-SITE PERFORMANCE OF ANY MANUFACTURER'S LUMINAIRES MAY VARY FROM LABORATORY TEST RESULTS DUE TO VARIATIONS IN: ELECTRICAL VOLTAGE, TOLERANCE IN LAMPS, AND OTHER VARIABLE FIELD CONDITIONS.

3. IF EXISTING LUMINAIRES ARE INCLUDED IN THIS REPORT, THEIR ILLUMINATION CHARACTERISTICS ARE BASED UPON A COMBINATIONS OF CUSTOMER'S PROVIDED SPECIFICATIONS & OUR BEST ESTIMATIONS.

EXISTING CONDITIONS GENERAL NOTES:

LANDSCAPE DESIGN, INC. MAKES NO WARRANTY AS TO THEIR ACCURACY. CONTRACTOR TO FIELD VERIFY EXISTING CONDITIONS IMPERATIVE TO THEIR NEW WORK. REPORT ANY DISCREPANCIES BETWEEN THE DRAWINGS AND FIELD CONDITIONS TO THE LANDSCAPE ARCHITECT FOR REVIEW. ANY WORK PERFORMED PRIOR TO RESOLUTION OF DISCREPANCIES BY THE LANDSCAPE ARCHITECT IS

VERIFY ALL EXISTING CONDITIONS, DIMENSIONS, AND ALIGNMENT OF WALLS. BRING ANY DISCREPANCIES TO THE LANDSCAPE ARCHITECTS ATTENTION PRIOR TO FABRICATION / CONSTRUCTION BEGINS 3. VERIFY LOCATION OF ACCESS PANELS W/ MECHANICAL AND ELECTRICAL EQUIPEMENT FOR ACCESSIBILITY OF MECHANICAL & ELECTRICAL ITEMS.

1. INFORMATION PERTAINING TO EXISTING CONDITIONS GIVEN ON THESE ARCHITECTURAL DRAWINGS REPRESENTS TO THE BEST OF OUR KNOWLEDGE THE ACTUAL EXISTING FIELD CONDITIONS. INSITE SUBJECT TO REMOVAL AND REPLACEMENT AT NO ADDITIONAL COST TO THE CONTRACT.

TO OBTAIN LOCATION OF PARTICIPANT'S UNDERGROUND FACILITIES BEFORE YOU DIG IN WISCONSIN WISCONSIN STATUTE 182.0175 (1974) REQUIRES A MINIMUM OF 3 DAYS NOTICE BEFORE YOU EXCAV (NOT INCLUDING SATURDAY, SUNDAY OR LEGAL HOLIDAYS)

UNDERGROUND SEWER AND UTILITY INFORMATION AS SHOWN IS OBTAINED FROM THE RECORDS OF MUNICIPALITY AND LOCAL UTILITY COMPANIES. THE

CERTIFIED TO. THE LOCATIONS OF EXISTING UTILITY INSTALLATIONS AS SHOWN ON THIS SURVEY ARE APPROXIMATE. THERE MAY BE OTHER UNDERGROUND UTILITY INSTALLATIONS WITHIN THE PROJECT AREA THAT ARE NOT SHOWN.

THIS LIGHTING PLAN REPRESENTS ILLUMINATION LEVELS CALCULATED FROM LABORATORY DATA TAKEN UNDER CONTROLLED CONDITIONS IN ACCORDANCE WITH THE ILLUMINATING ENGINEERING SOCIETY (IES) APPROVED METHODS. ACTUAL

PERFORMANCE OF ANY MANUFACTURER'S LUMINAIRES MAY VARY DUE TO CHANGES IN ELECTRICAL VOLTAGE, TOLERANCE IN LAMPS/LED'S &OTHER MAY VARY DUE TO CHANGES IN ELECTRICAL VOLTAGE, TOLERANCE IN LAMPS/LED'S & OTHER VARIABLE | FIELD CONDITIONS. CALCULATIONS DO NOT INCLUDE OBSTRUCTIONS SUCH AS BUILDINGS CURBS, LANDSCAPING, OR ANY

OTHER ARCHITECTURAL ELEMENTS UNLESS NOTED.

TO OBTAIN LOCATION OF PARTICIPANT'S UNDERGROUND FACILITIES BEFORE YOU DIG IN ACCURACY OF WHICH CAN NOT BE GUARANTEED OR WISCONIN CALL THE MILWAUKEE UTILITY ALERT NETWORK <u>(800)-242-8511</u>, (262) 432-7910 (877) 500-9592



- PRELIMINARY -FOR ESTIMATING AND REVIEW ONLY

Drawing Title:

FLOOR PLAN

Date:

Scale:

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Sheet:

A1.1

Job:

FLOOR PLAN SCALE: 1/8" = 1'-0" THIS BOX IS 1/2" x 1/2"

RTL


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THE CLIENT AGREES TO INDEMIENTENT OF THE ARCHITECT

TVE DESIGN, THE PRIOR U

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Drawing Title:

SIGNAGE & TRASH ENCLOSURE ELEVATIONS

1/2" x 1/2" Date: 02.20.17 Scale: NOTED Drawn: RTL Job: 16-132

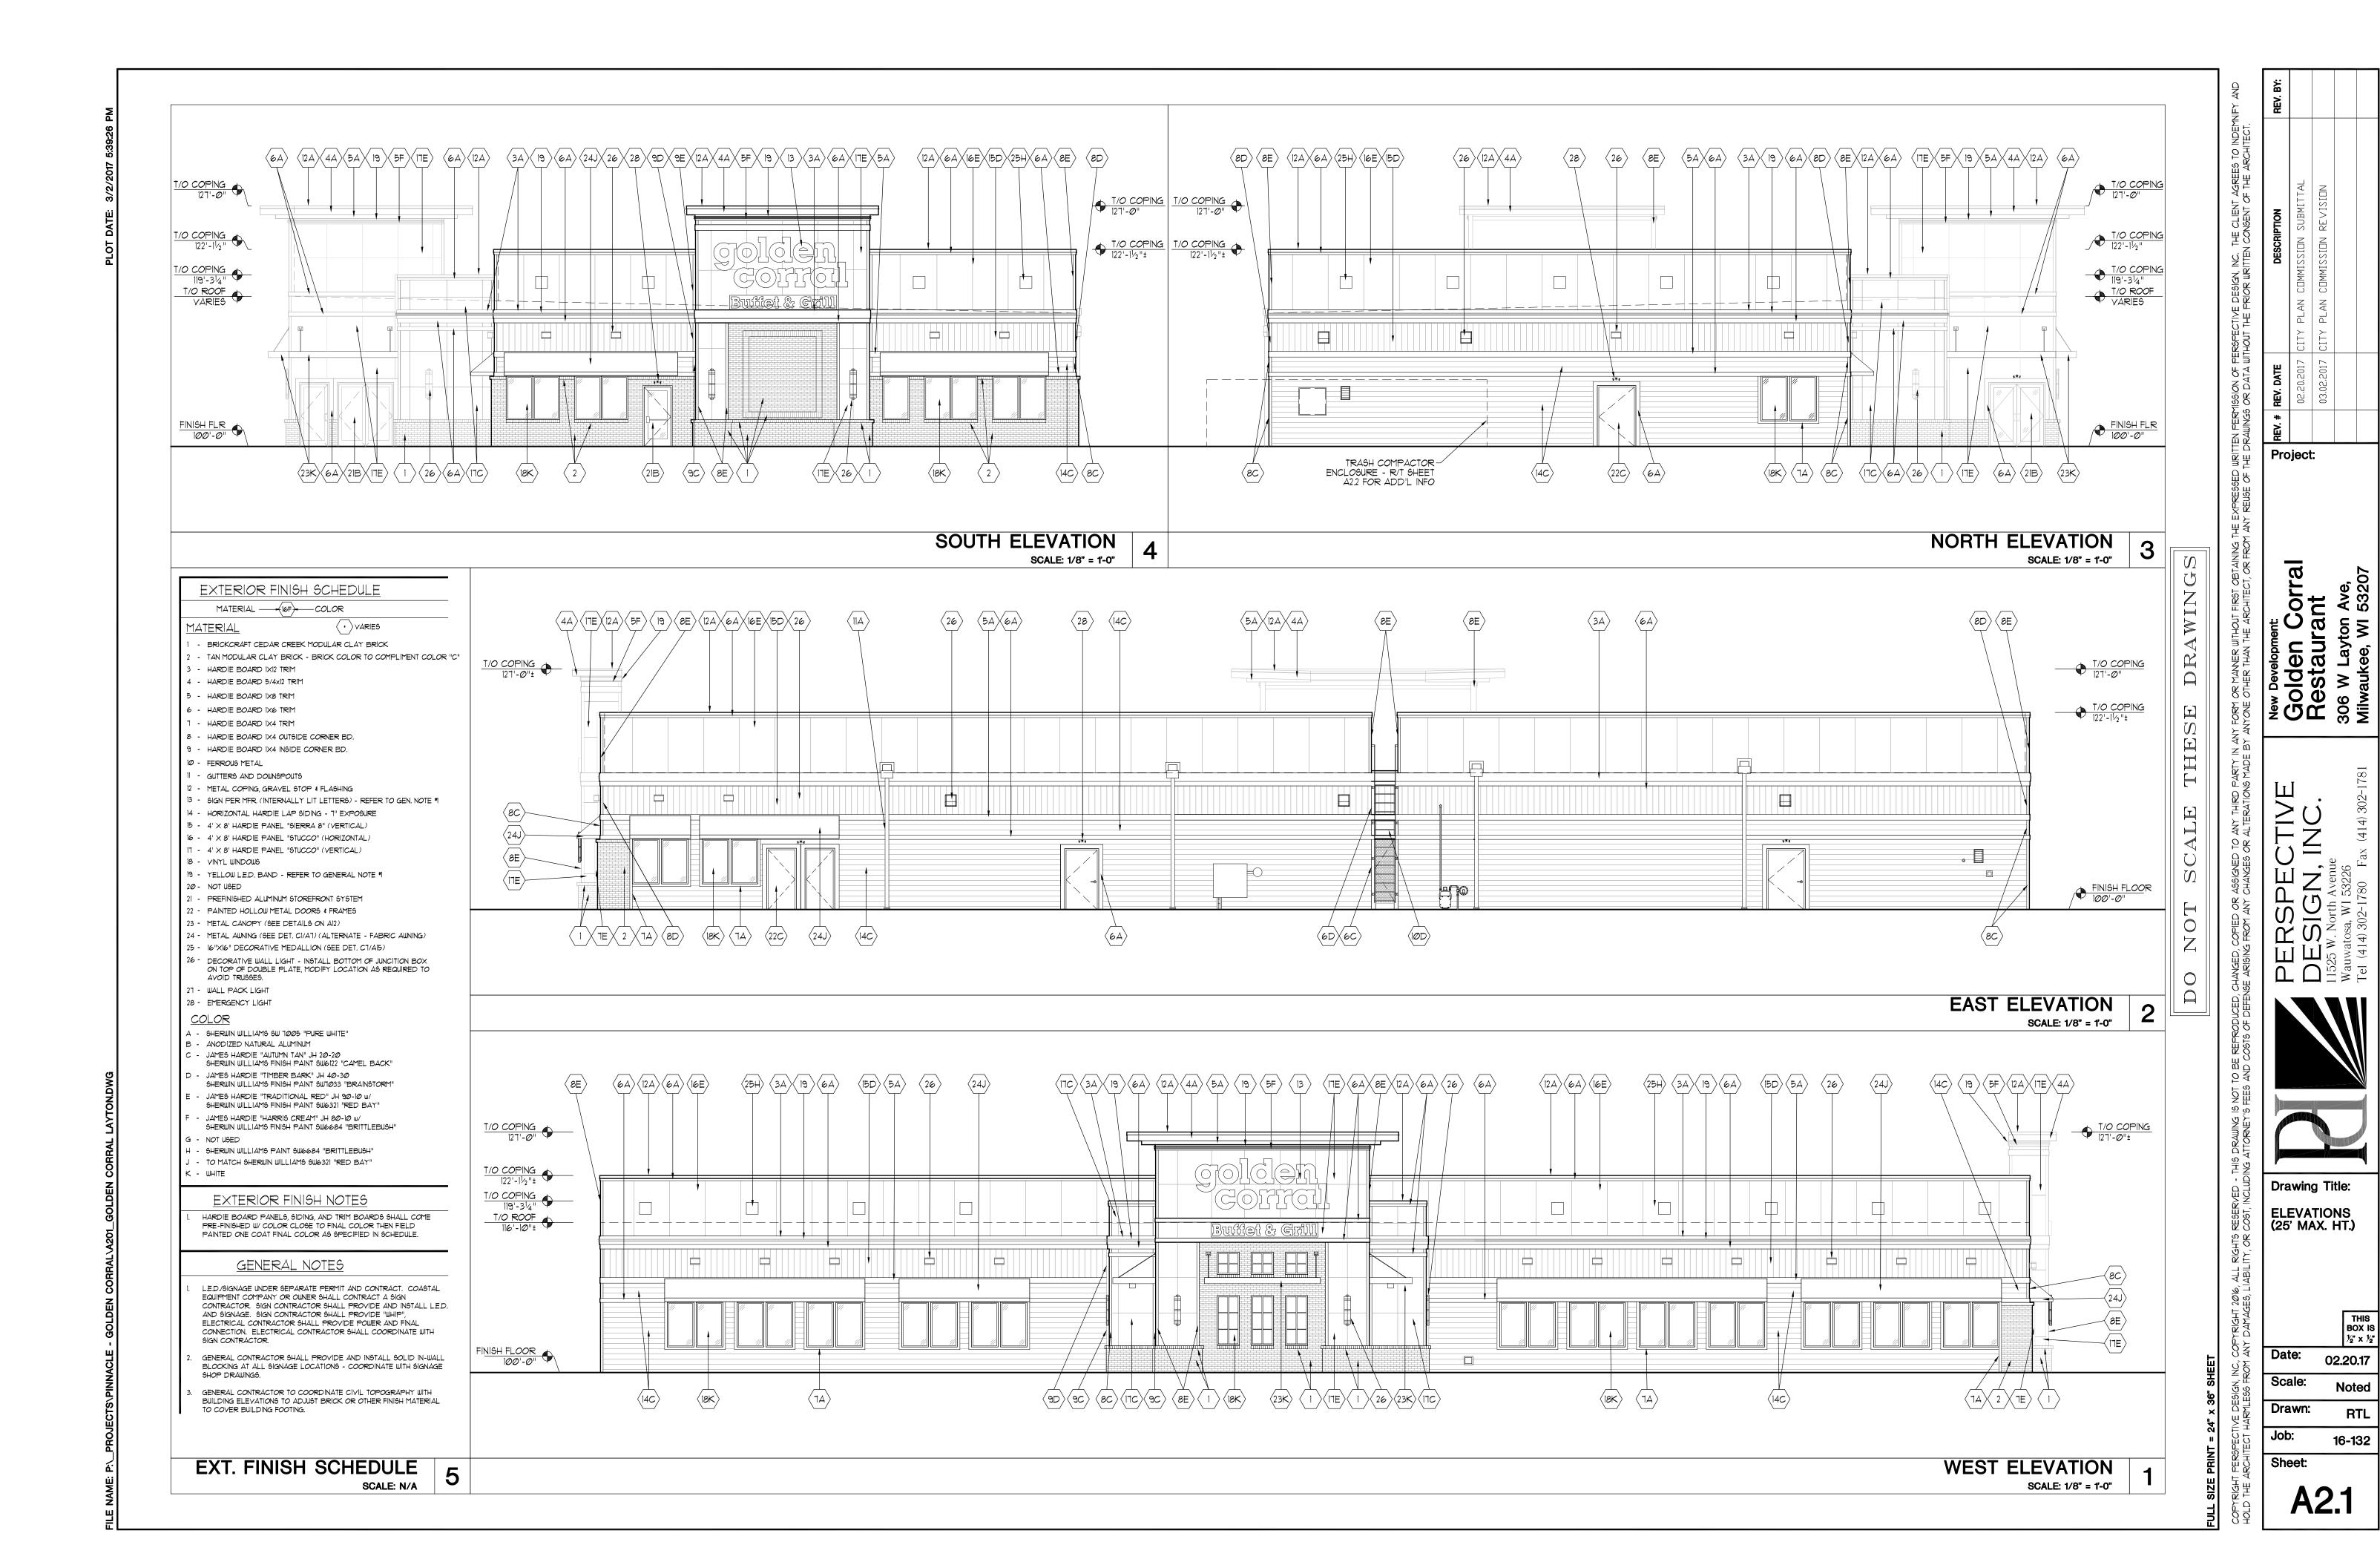Sheet: **A2.2**

SCALE: 1/4" = 1'-0"

SCALE: 1/4" = 1'-0"

NOT USED NOT USED 6 3 SCALE: N/A SCALE: N/A / G" DIA, STD, STEEL PIPE GATE POST w/ WELDED STEEL CAP PLATE. IX8 CONT. SQUARE EDGE— COMPOSITE TRIM CAP PIECE / IX8 CONT. SQUARE EDGE COMPOSITE TRIM CAP PIECE TIX6 VERTICAL GROOVED EDGE COMPOSITE BOARDS ON STEEL GATE FRAME NOTE: COMPOSITE BOARDS PAINTED SWTØ33 "BRAINSTORM BRONZE" TO MATCH BUILDING -RESTAURANT BUILDING /6" DIA. STD. STEEL PIPE GATE POST w/ WELDED STEEL CAP PLATE. 31'-5 3/4" 4'-8" 7'-4" 14'-0" IX6 VERTICAL GROOVED— EDGE COMPOSITE -IX6 VERTICAL GROOVED EDGE COMPOSITE NOTE: COMPOSITE BOARDS PAINTED SWIØ33 "BRAINSTORM BRONZE" TO MATCH BUILDING T/O FENCE 101'-6" BOARDS (SQ. EDGE BOARDS (SQ. EDGE BOARDS @ CORNERS) W/ HIDDEN FASTENERS INTO BOARDS @ CORNERS) W. HIDDEN FASTENERS INTO 1/0 GATE POST 106'-0" T/O GATE POST 106'-0" 2×6 HORIZ. COMPOSITE NAILERS 2×6 HORIZ. COMPOSITE NAILERS 3" DIA. GALV. FENCE— POST 3" DIA. GALV. FENCE POST BLDG FIN. FLOOR 100'-0" BLDG FIN. FLOOR B/O FOOTING 96'-0" B/O FOOTING 96'-0" SLOTS IN COMPOSITE-GATE BOLTS W/1½" DIA. HOLES DRILLED 3" DEEP IN CONC. SLAB @ OPEN \$ CLOSED POS. BOARDS TO ALLOW ACCESS TO GATE BOLTS FROM BOTH SIDES TRASH ENCLOSURE SIDE ELEVATION 5 TRASH ENCLOSURE FRONT ELEVATION SCALE: 1/4" = 1'-0" SCALE: 1/4" = 1'-0" INTERNALLY ILLUMINATED INDIVIDUAL CHANNEL LETTERS W/YELLOW PLASTIC FACE MOUNTED TO A RACEWAY (PAINTED TO MATCH ADJACENT BUILDING MATERIAL) /-IIØ SQ. FT. SIGN AREA INTERNALLY ILLUMINATED INDIVIDUAL CHANNEL LETTERS W/YELLOW PLASTIC FACE MOUNTED TO A RACEWAY (PAINTED TO MATCH ADJACENT BUILDING MATERIAL) \sim 120 SQ. FT. SIGN AREA ∕35 SQ. FT. SIGN AREA / -INTERNALLY ILLUMINATED ROUTED LETTERS W/ WHITE ACRYLIC FACE -INTERNALLY ILLUMINATED ROUTED LETTERS W/ WHITE ACRYLIC FACE 10'-2 9/16" TYELLOW L.E.D. BAND TYELLOW L.E.D. BAND T/O SIGN 114'-0" 15'-Ø 5/8" 15'-Ø 5/8" —ALUM. CABINET FACE PAINTED \$W6321 "RED BAY" w/ \$W6684 "BRITTLEBUSH" BORDER ─INTERNALLY ILLUMINATED
INDIVIDUAL CHANNEL
LETTERS W/ YELLOW
PLASTIC FACE Buffet & Grill -ALUM. CLADDING PAINTED SW1033 "BRAINSTORM BRONZE" TO MATCH BUILDING 28 SQ. FT. CHANGEABLE-COPY SIGN AREA CHANGEABLE COPY 8'-Ø" INTERNALLY ILLUMINATED PLASTIC FACE CHANGEABLE COPY T/O MASONRY 103'-4" -BRICKCRAFT "CEDAR CREEK" MODULAR CLAY BRICK SIGN BASE TO MATCH BUILDING 6'-0" 8'-0" 8'-8" SOUTH WALL SIGN ELEVATION 7 WEST WALL SIGN ELEVATION 4 MONUMENT SIGN ELEVATION

SCALE: 1/4" = 1'-0"