

MILWAUKEE HISTORIC PRESERVATION COMMISSION SUBMITTAL FOR

FORTRESS BUILDING - ADAPTIVE RE-USE CITY OF MILWAUKEE, WISCONSIN CONCEPTUAL SITE DRAWINGS

A E R I A L M A P



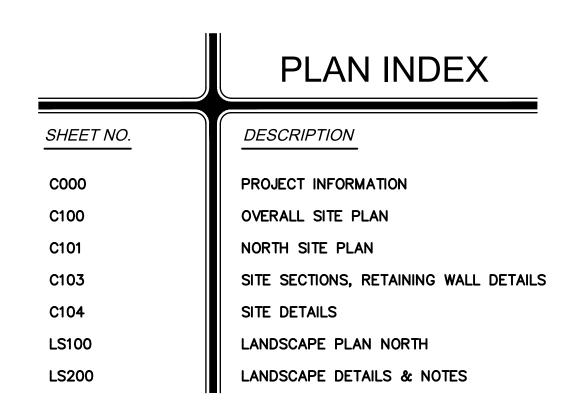

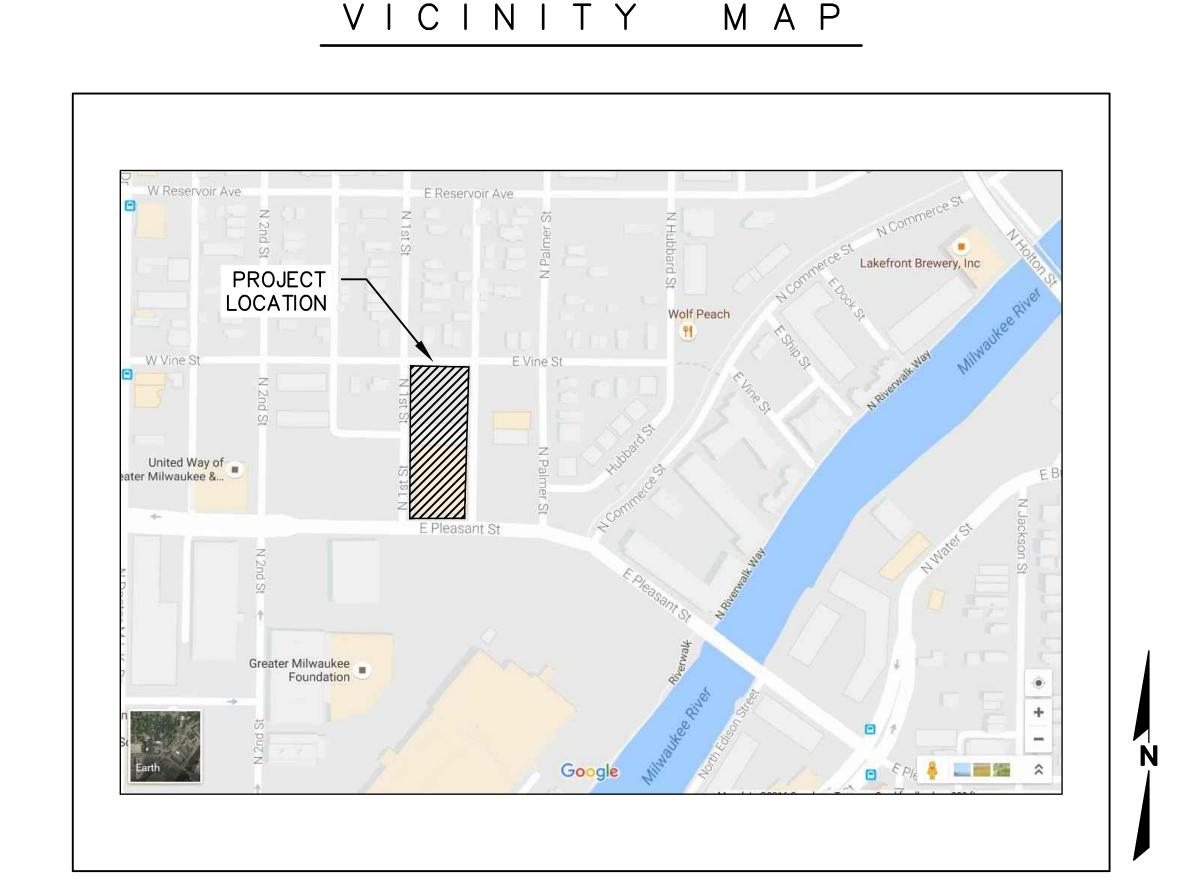

DATE DESCRIPTION

nith National
Beyond Surveying
and Engineering

RTRESS BUILDING

FY OF MILWAUKEE

PROJECT INI

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R.A. Smith National, Inc.
DATE: 09/01/16
SCALE: N.T.S.

JOB NO. 3160154
PROJECT MANAGER:
DAVID J. CLEARY, P.E.
DESIGNED BY: AJS

COOO

CHECKED BY: DJC

OWNER:


THE ALEXANDER COMPANY
345 W. WASHINGTON AVE
SUITE 301
MADISON, WI 53703
PH.: 608/258-5580

APPROVAL AGENCY:


CITY OF MILWAUKEE
809 N. BROADWAY
2ND FLOOR
MILWAUKEE, WI 53202
PH.: 414/286-5714

ENGINEER:



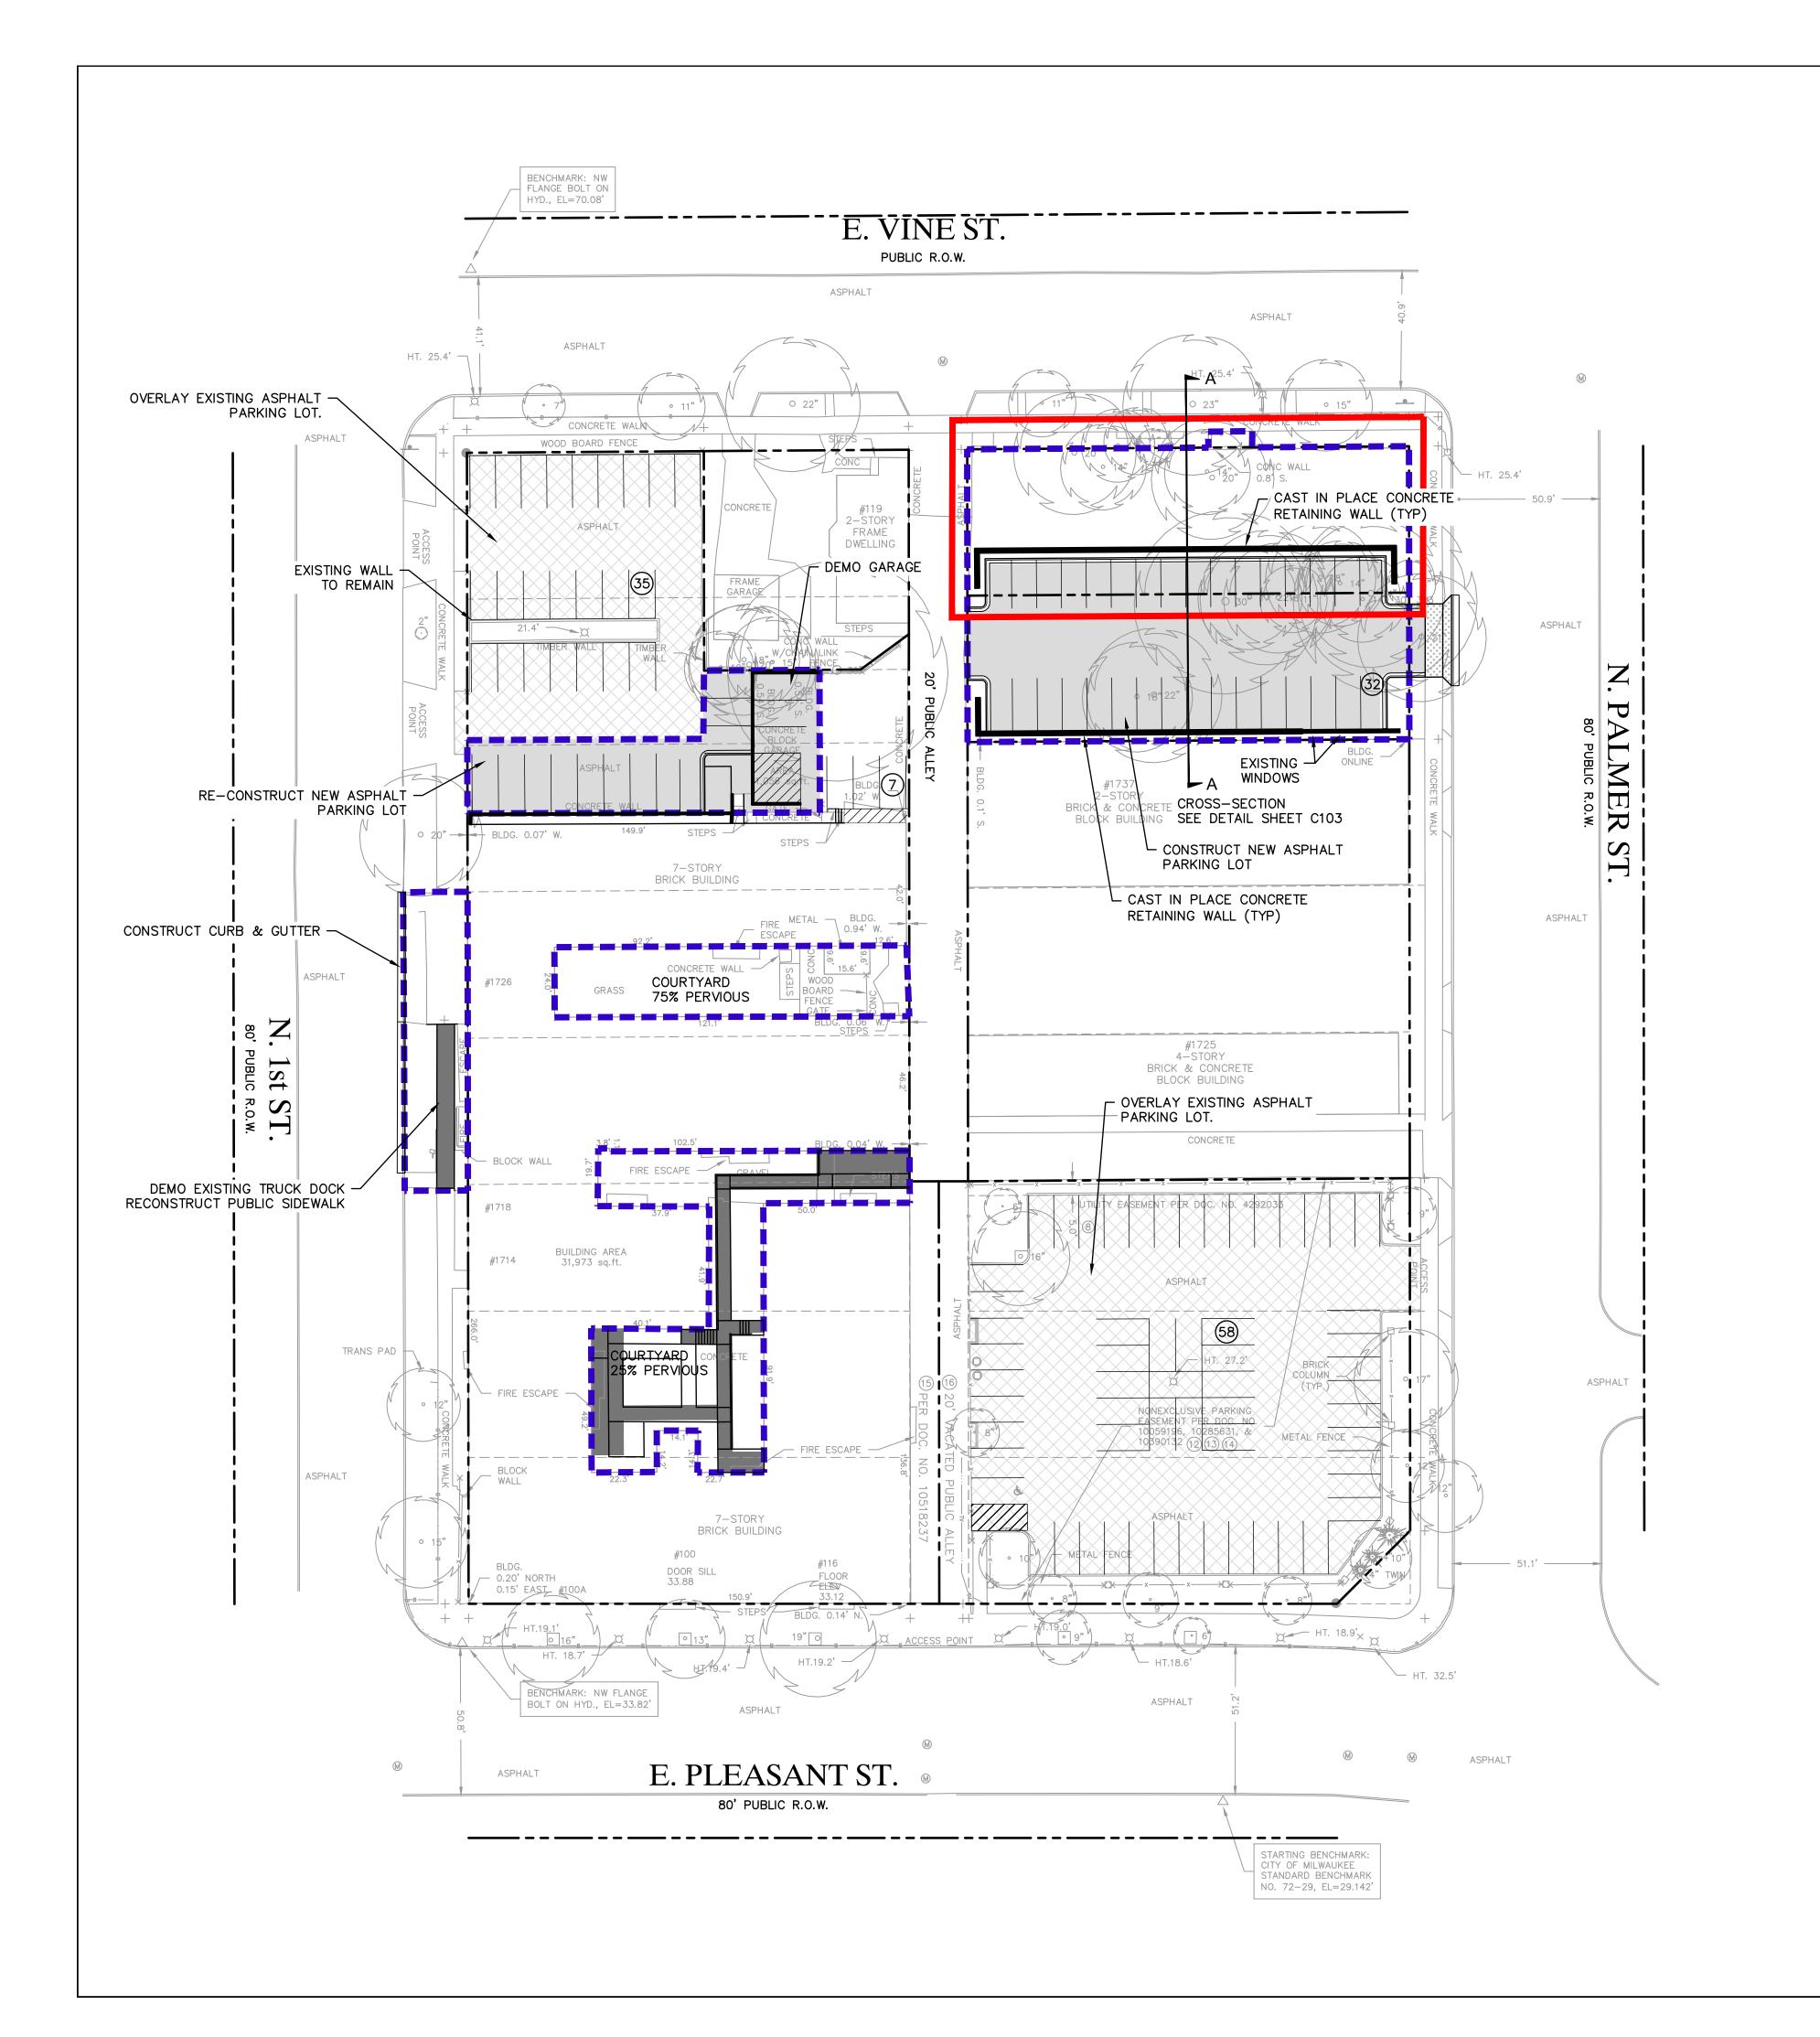

LEGEND

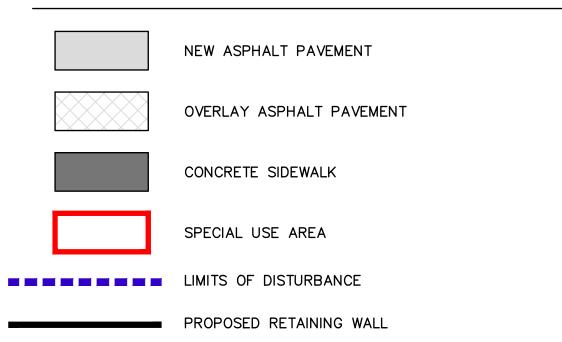

PROPOSED CURB & GUTTER

PARKING CALCULATIONS

NORTHWEST LOT ALLEY PARKING NORTHEAST LOT SOUTHEAST LOT	35 STALLS (28 COMPACT) 7 STALLS (0 COMPACT) 32 STALLS (32 COMPACT) 58 STALLS (35 COMPACT)
TOTAL	132 STALLS (95 COMPACT)

SITE CALCULATIONS

	SQFT	AC
TOTAL PARCEL AREA	93,802	2.15
EXISTING IMPERVIOUS EXISTING PERVIOUS	72,761 21,041	1.67 0.48
PROPOSED IMPERVIOUS PROPOSED PERVIOUS	79,998 13,804	1.83 0.32
TOTAL DISTURBED AREA ADDED IMPERVIOUS	29,704 7,237	0.68 0.16

MILWAUKEE STORM WATER REQUIREMENTS

- A STORM WATER MANAGEMENT PLAN IS REQUIRED UNDER ANY OF THE FOLLOWING SCENARIOS:
- 1. DEVELOPMENT OR REDEVELOPMENT ACTIVITIES CAUSE A LAND DISTURBING ACTIVITY OF 1 ACRE OR MORE.
- 2. DEVELOPMENT OR REDEVELOPMENT ACTIVITIES CAUSE THE CUMULATIVE AREA OF ALL LAND DISTURBING ACTIVITIES AT A PROPERTY TO BE 1 ACRE OR MORE OVER A 3-YEAR PERIOD.
- 3. DEVELOPMENT OR REDEVELOPMENT ACTIVITIES CAUSE AN INCREASE OF 0.5 ACRES OR MORE OF IMPERVIOUS AREA.
- THE PROPOSED SITE IMPROVEMENTS DO NOT TRIGGER REQUIREMENTS FOR A STORM WATER MANAGEMENT PLAN SUBMITTAL TO THE CITY OF

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RIM ELEVATIONS ARE GIVEN TO THE FACE OF CURB FOR INLET GRATES OR THE CENTER OF THE MANHOLE STRUCTURE FOR MANHOLES. PIPE LENGTHS ARE MEASURED TO THE CENTER OF STRUCTURE OR THE END OF PIPE WHERE THERE IS AN ENDWALL.



Hearing Impaired TDD (800) 542-2289

www.DiggersHotline.com

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SS BUILDING MILWAUKEE SITE FORTRESS CITY OF MIL 0


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SCALE: 1" = 30'

JOB NO. **3160154** PROJECT MANAGER: DAVID J. CLEARY, P.E.

DESIGNED BY: AJS CHECKED BY: DJC

SHEET NUMBER C100

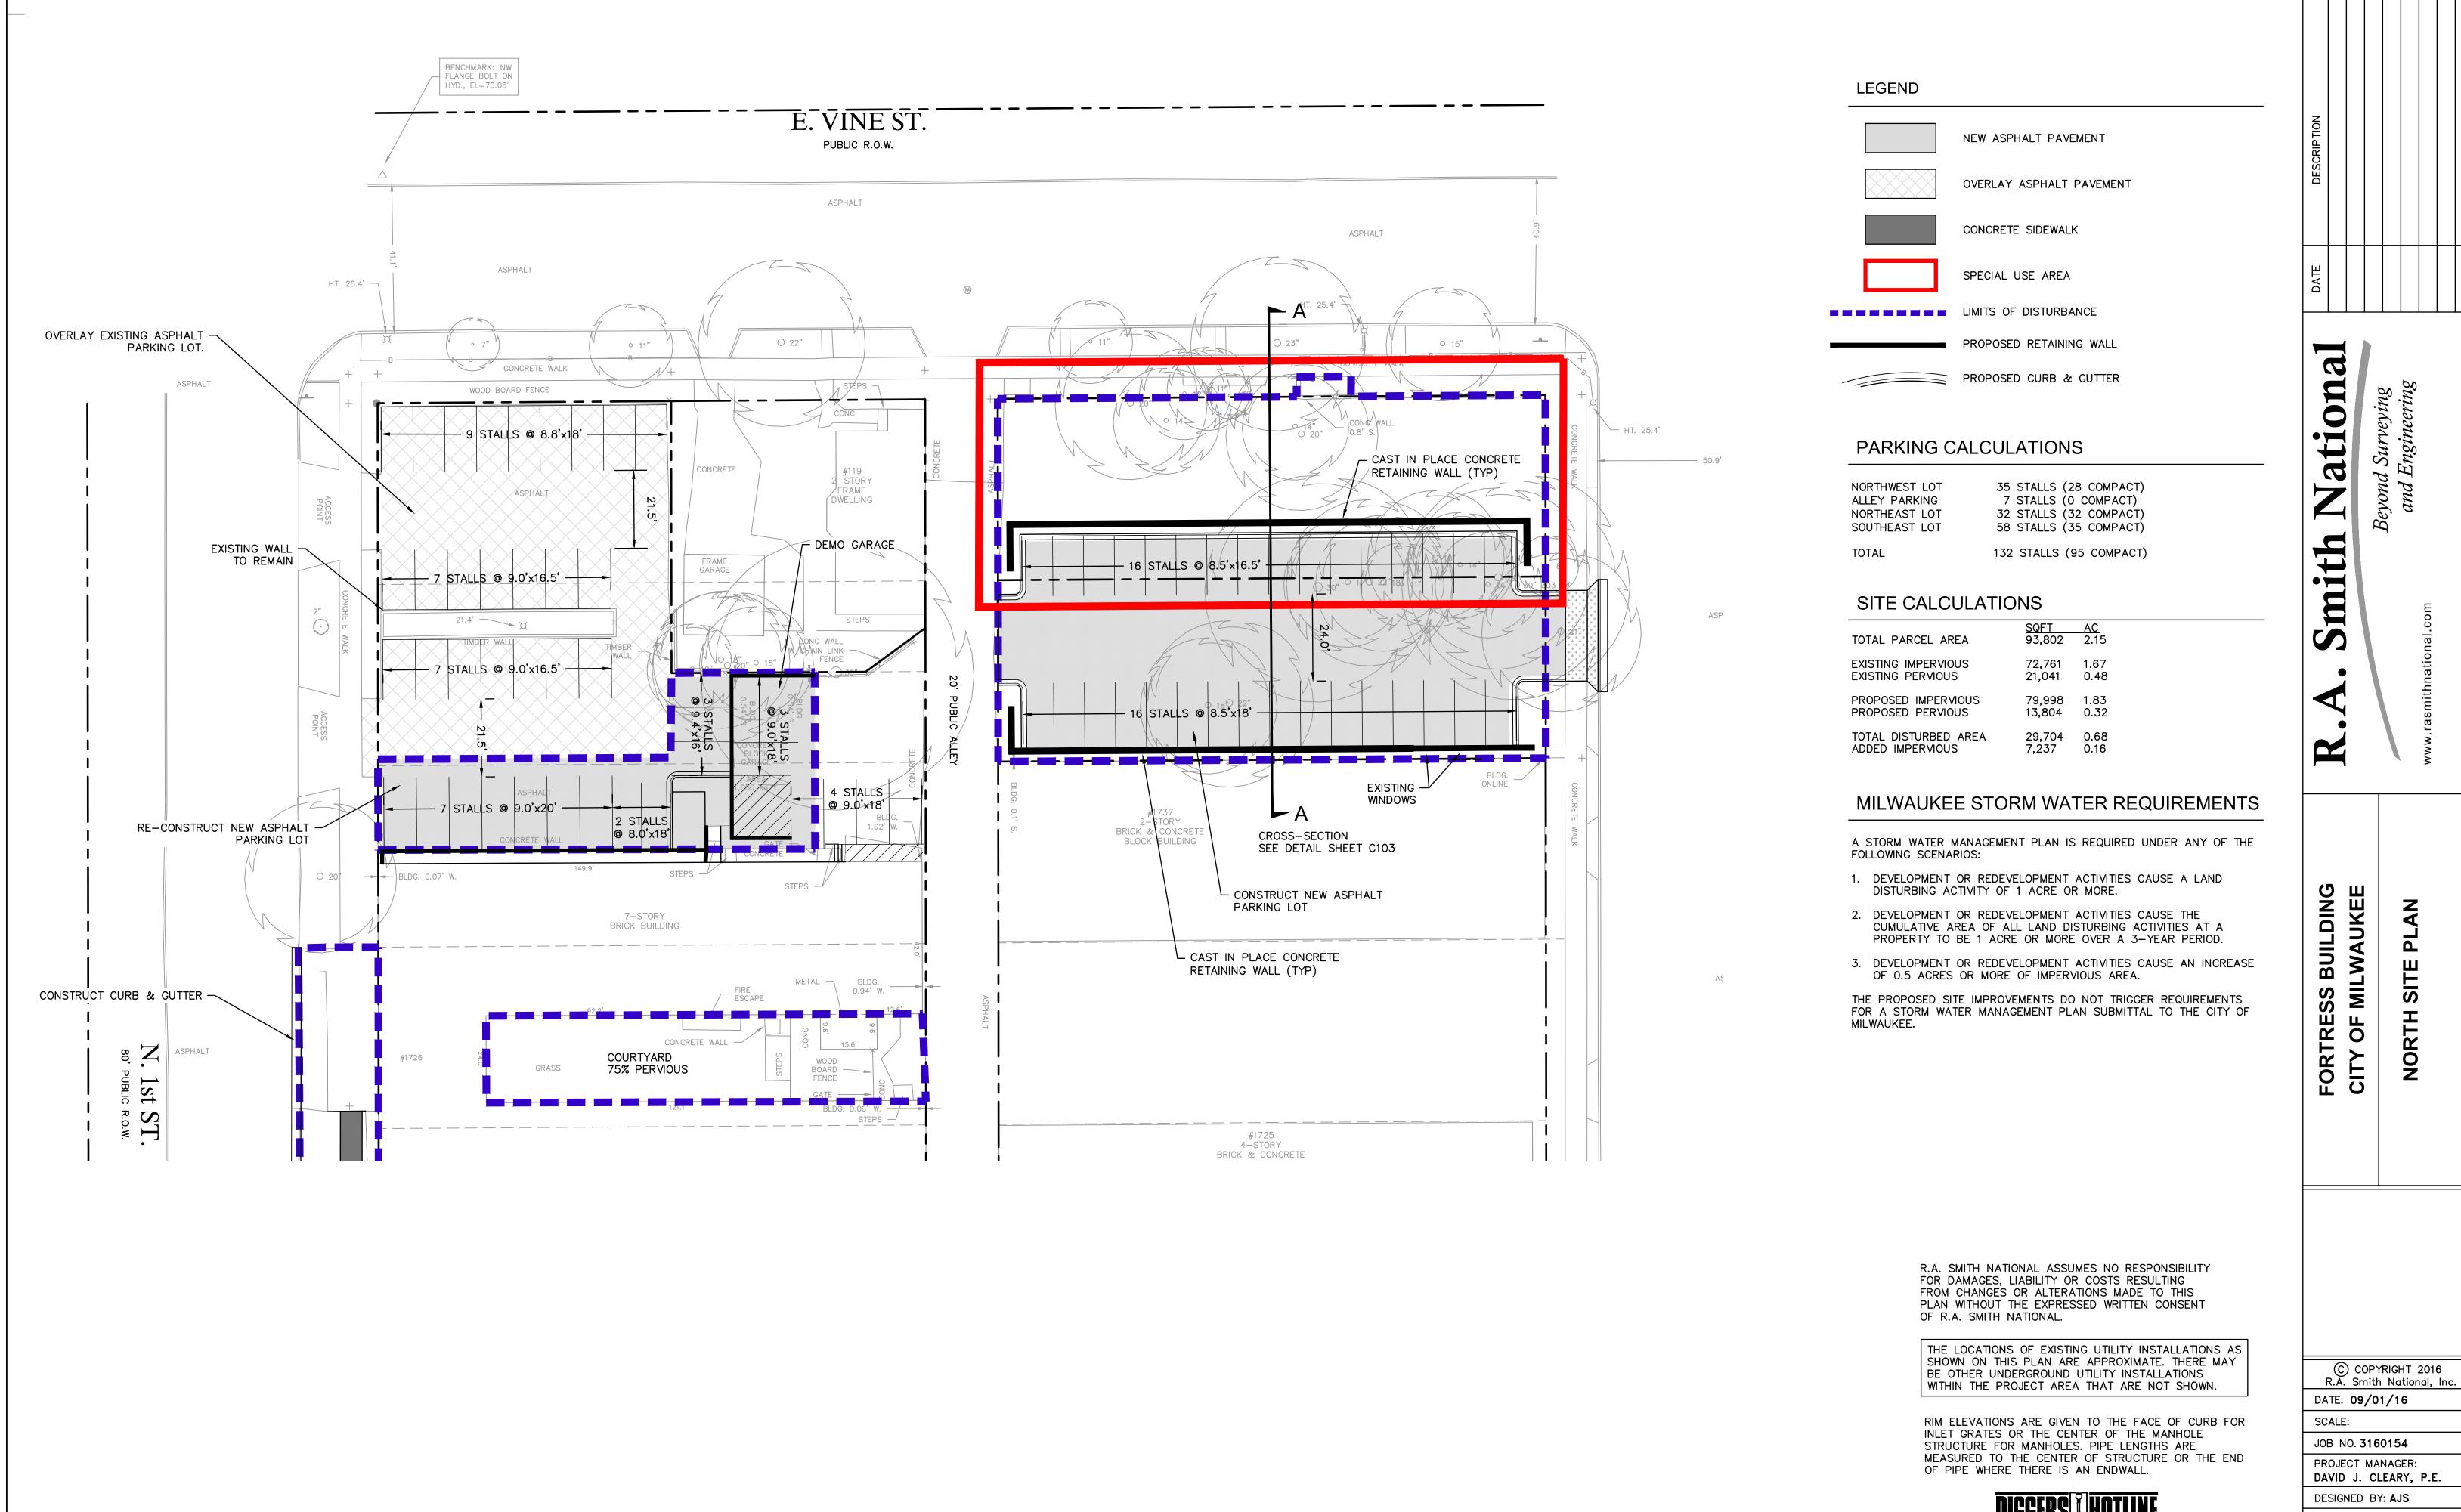


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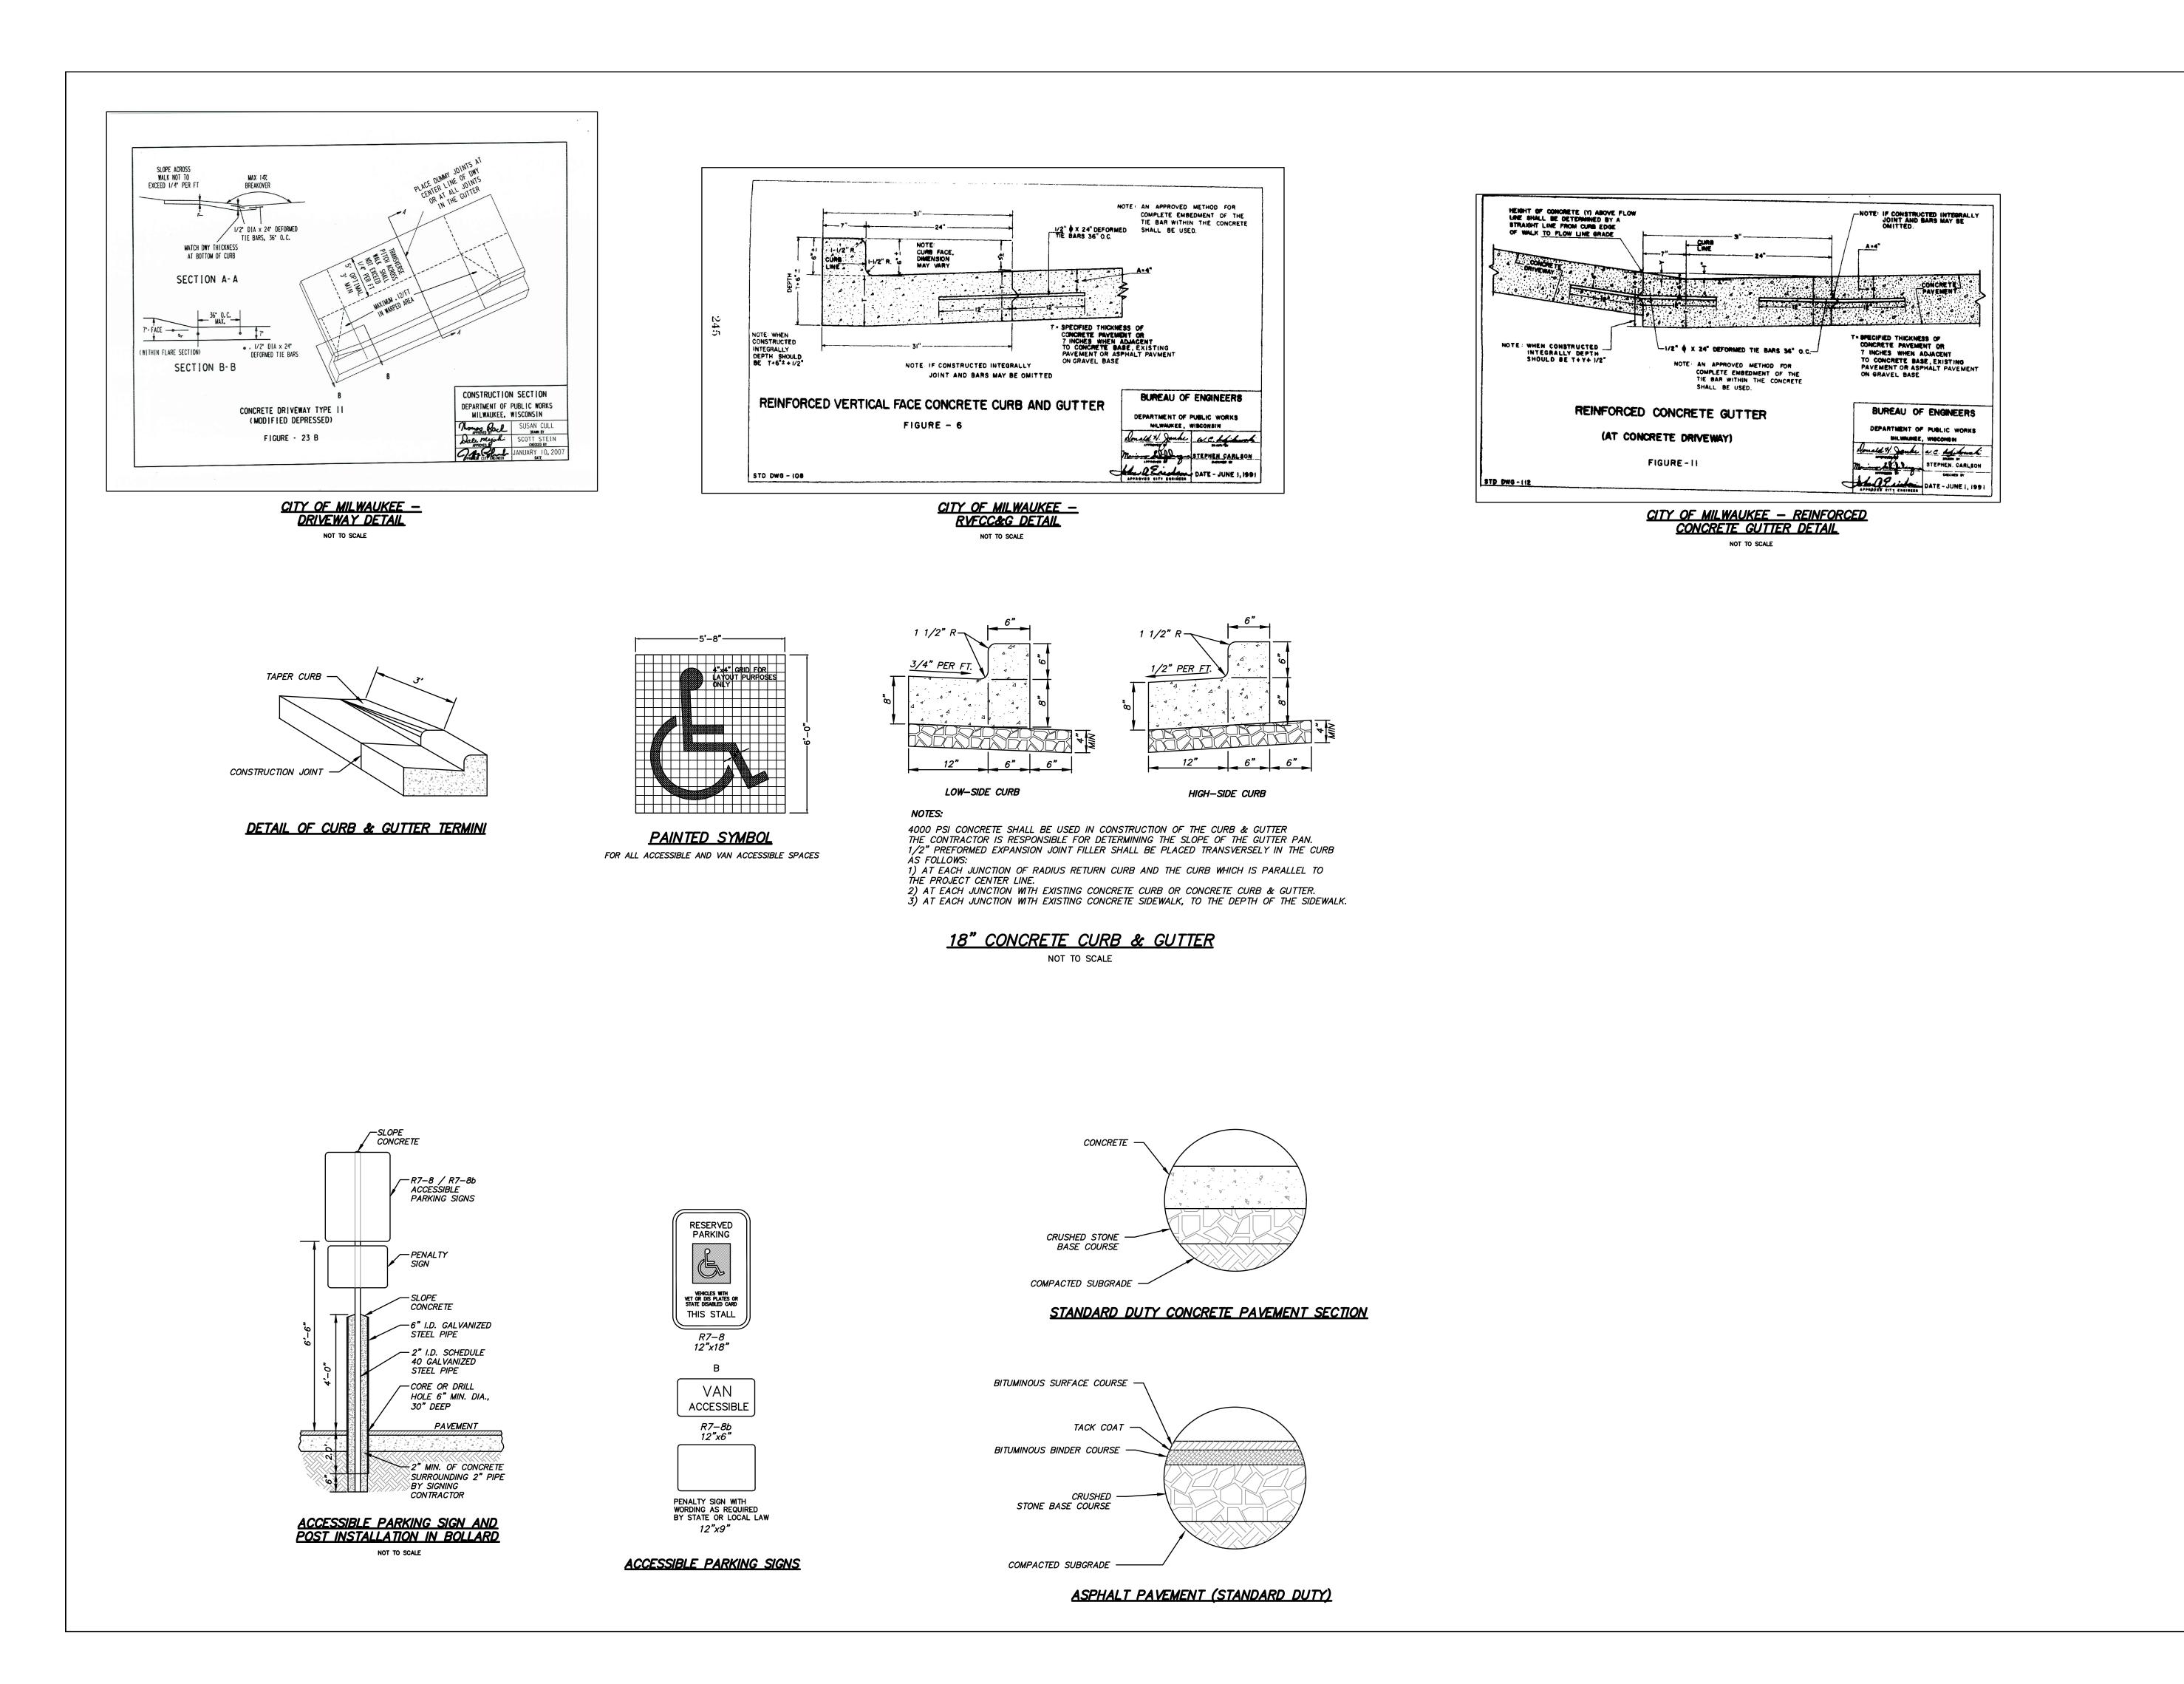
Toll Free (800) 242-8511

Milwaukee Area (414) 259-1181 Hearing Impaired TDD (800) 542-2289

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SHEET NUMBER
C101



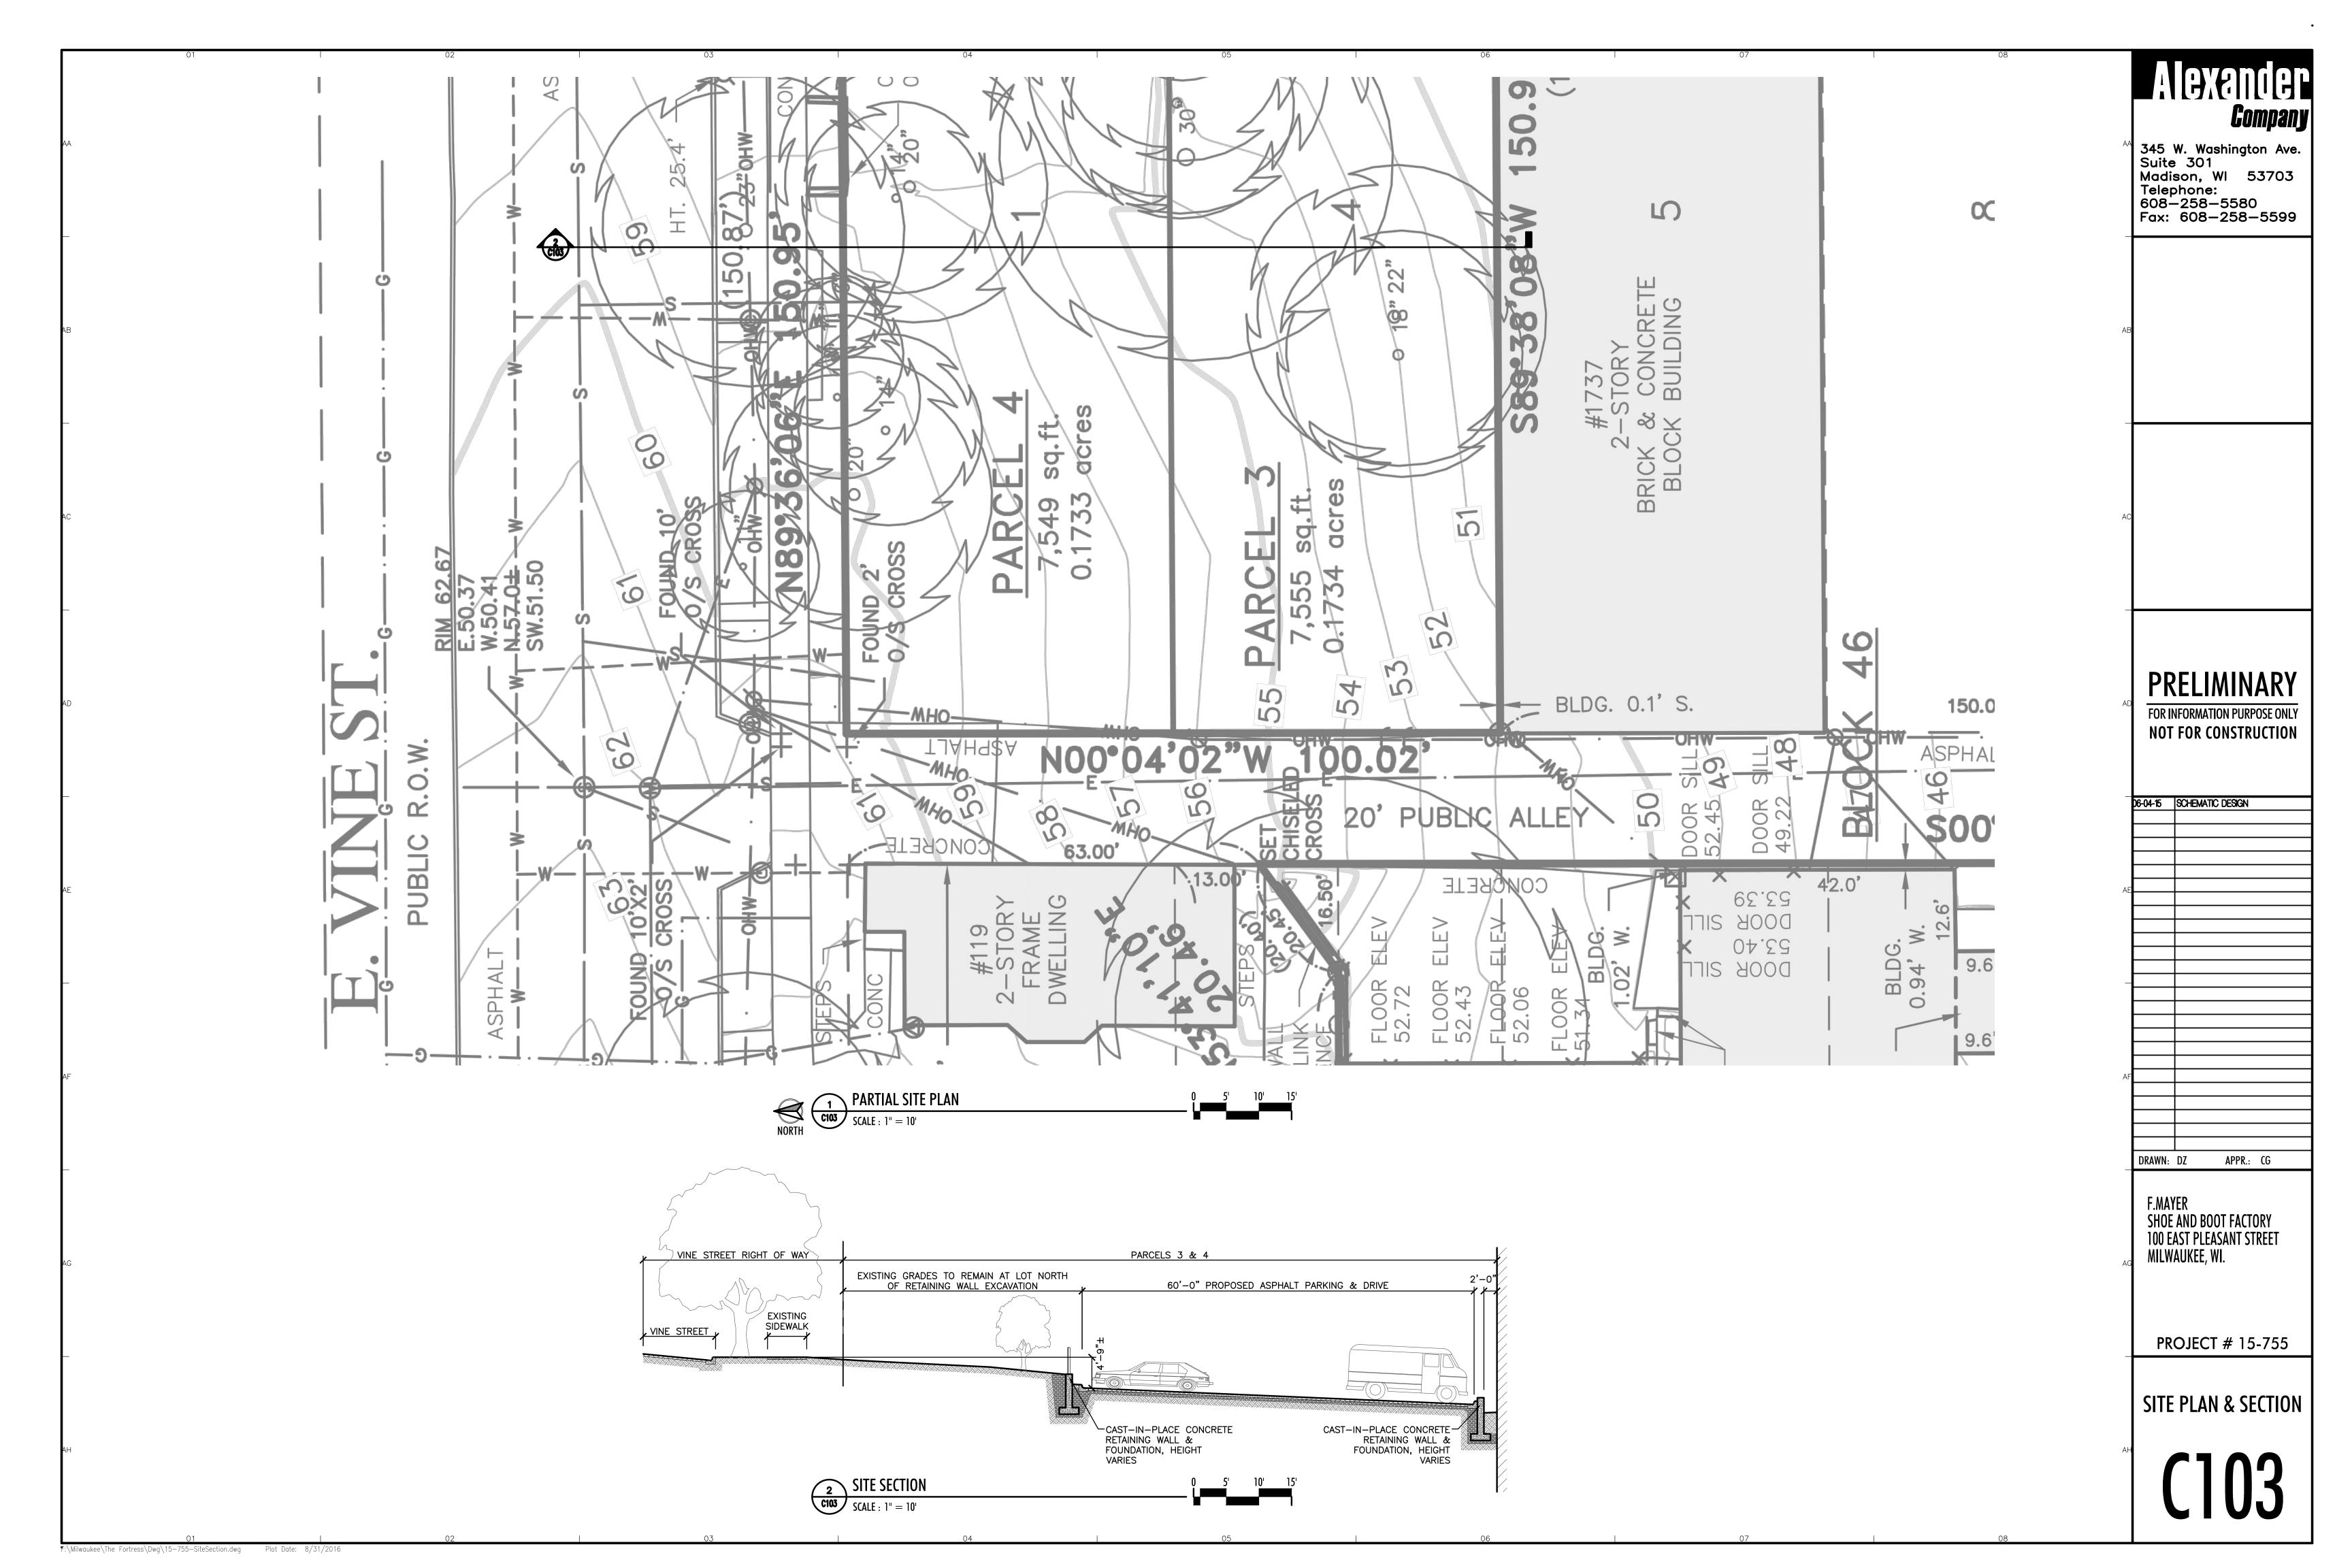

R.A. Smith National

FORTRESS BUILDING
CITY OF MILWAUKEE
SITE DETAILS

CITY

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SCALE: N.T.S.


JOB NO. 3160154

PROJECT MANAGER:
DAVID J. CLEARY, P.E.

DESIGNED BY: AJS

CHECKED BY: DJC


SHEET NUMBER C104

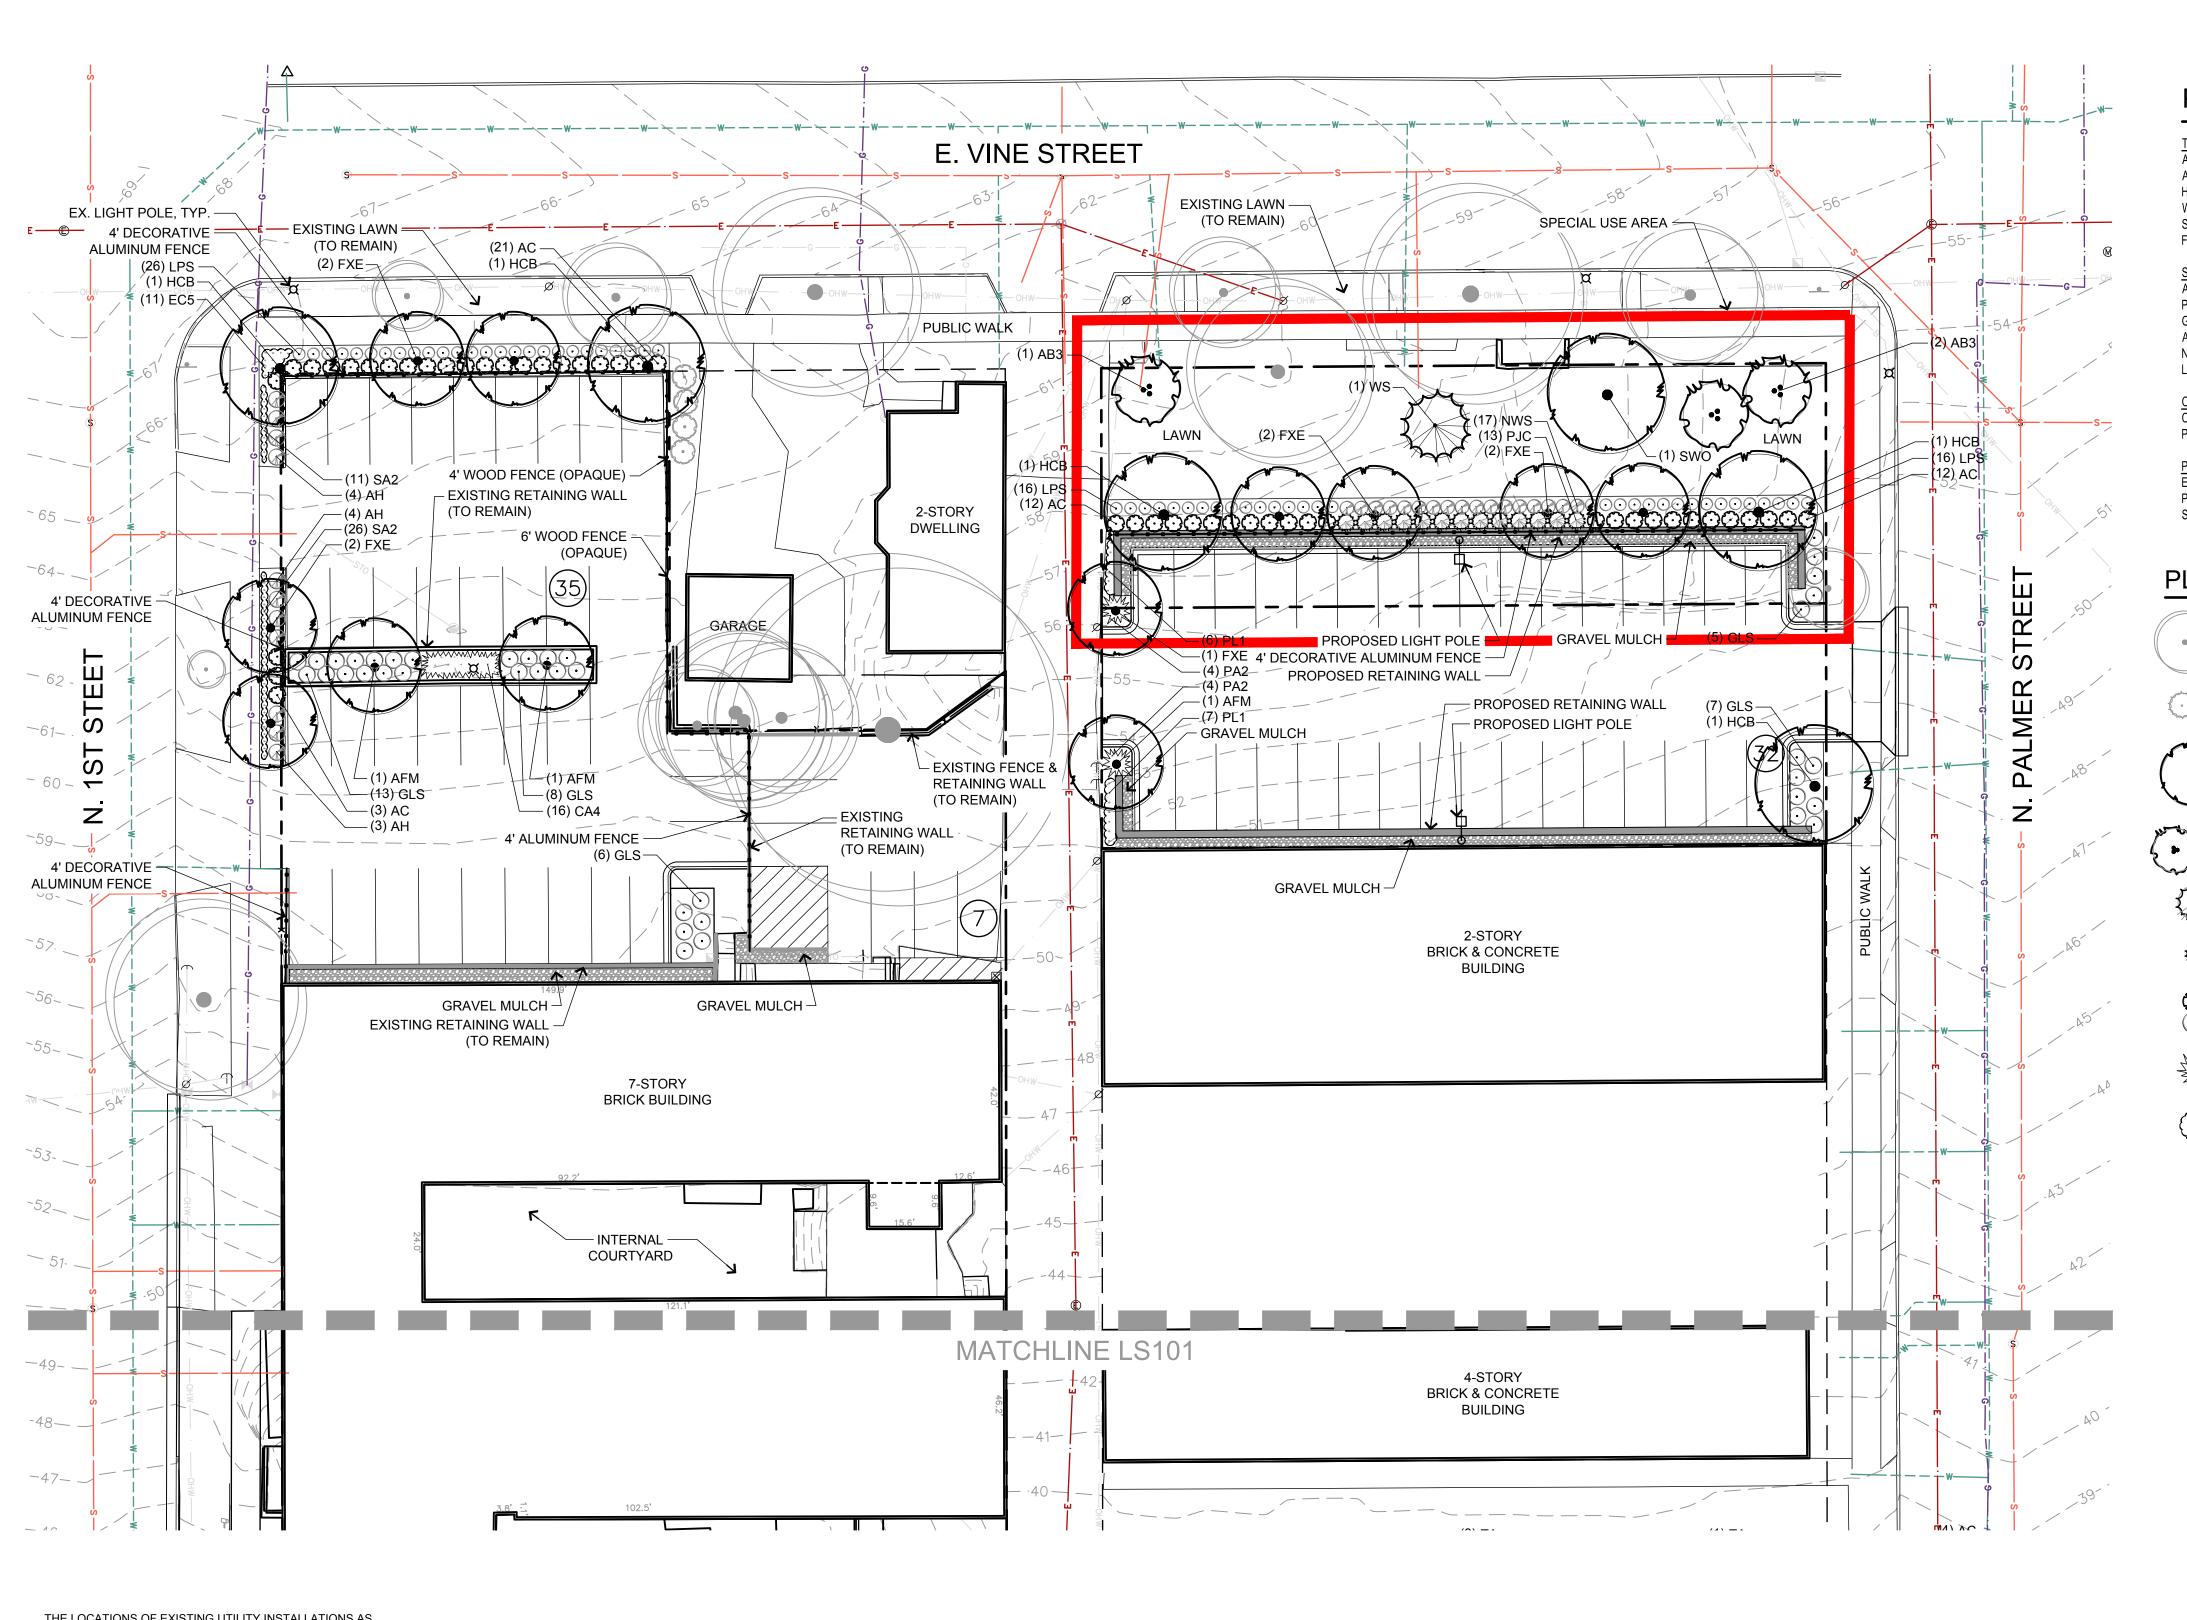


PLANT SCHEDULE NORTH

TREES AFM AB3 HCB WS SWO FXE	QTY 3 3 5 1 1 9	COMMON NAME Freeman Maple Autumn Brilliance Serviceberry Common Hackberry White Spruce Swamp White Oak 'Frontier' Elm	BOTANICAL NAME Acer freemanii `Autumn Fantasy` Amelanchier x grandiflora `Autumn Brilliance` Celtis occidentalis Picea glauca Quercus bicolor Ulmus x `Frontier`	SIZE 2 1/2" CAL 7` HT 2 1/2" CAL 7` HT 2 1/2" CAL 2 1/2" CAL	ROOT B&B B&B B&B B&B B&B	REMARKS Full, matching heads Clump, min. 3 stems Full, matching heads Fully Branched to Ground Full, matching heads Full, matching heads
SHRUBS AH PJC GLS AC NWS LPS	QTY 11 13 39 48 17 58	COMMON NAME Annabelle Smooth Hydrangea Kallay Compact Pfitzer Juniper Gro-Low Fragrant Sumac Alpine Currant Nearly Wild Shrub Rose Little Princess Spirea	BOTANICAL NAME Hydrangea arborescens `Annabelle` Juniperus chinensis `Kallays Compact` Rhus aromatica `Gro-Low` Ribes alpinum Rosa shrub `Nearly Wild` Spiraea x japonica `Little Princess`	SIZE 24" HT 24" HT 15" HT 36"HT 18" HT 18" HT	ROOT CONT. CONT. CONT. CONT. CONT.	<u>REMARKS</u>
ORNAMENTAL GRASSES CA4 PA2	QTY 16 8	COMMON NAME Karl Foerster Feather Reed Grass Hameln Dwarf Fountain Grass	BOTANICAL NAME Calamagrostis x acutiflora `Karl Foerster` Pennisetum alopecuroides `HameIn`	<u>SIZE</u> 1 GAL. 1 GAL.	ROOT POT POT	REMARKS 24" Spacing 24" Spacing
PERENNIALS EC5 PL1 SA2	QTY 11 13 37	COMMON NAME Kim's Knee High Purple Coneflower Little Spire Russian Sage May Night Salvia	BOTANICAL NAME Echinacea purpurea 'Kim's Knee High' TM Perovskia x 'Little Spire' Salvia nemorosa 'May Night'	<u>SIZE</u> 4 1/2" 4 1/2" 4 1/2"	ROOT POT POT POT	REMARKS 18" Spacing 24" Spacing 18" Spacing

PLANT SYMBOL KEY

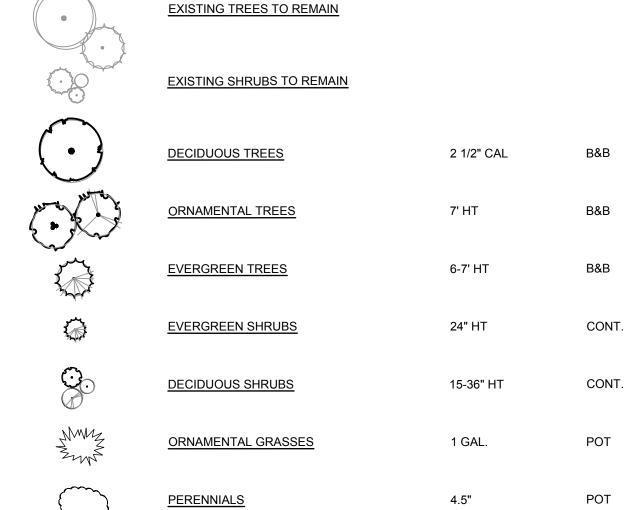



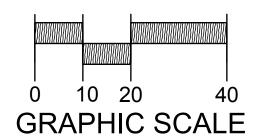

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FORTRESS BUILDING CITY OF MILWAUKEE ANDSC NC

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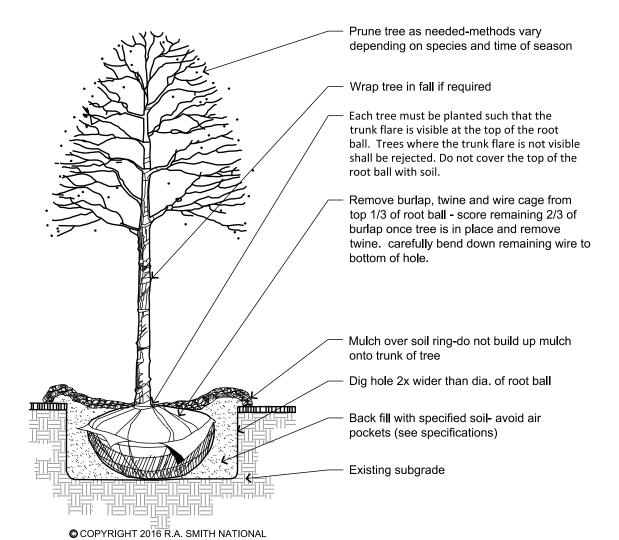
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JOB NO. **3160154** PROJECT MANAGER: DAVID J. CLEARY, P.E.

DESIGNED BY: LJH CHECKED BY: LJH

SHEET NUMBER LS100

PLANTING DETAILS



DECIDUOUS TREE PLANTING DETAIL

Belt strapping Wood stake 3" dia. cedar Woven cloth belt strapping nail to -3" dia. cedar wood -EQUAL ★EQUAL > stakes - cut to same **PLAN VIEW** Do not let stakes touch sides of root ball - Extend stakes into firm, undisturbed soil a min. of 8". © COPYRIGHT 2016 R.A. SMITH NATIONAL install prior to filling with planting mix. SECTION **VIEW**


- Each tree must be planted such that the trunk flare is visible at the top of the root ball. Trees where the trunk flare is not visible shall be rejected. Do not cover the top of the root ball Remove burlap, twine and wire cage from top 1/3 of root ball - score remaining 2/3 of burlap once tree is in place and remove twine carefully bend down remaining wire to bottom Mulch over soil ring-do not build up mulch onto trunk of tree Dig hole 2x wider than dia. of root ball Back fill with specified soil - avoid air pockets (see specifications) Existing subgrade


DECIDUOUS TREE STAKING FOR RESTRICTED AREAS


P-PL-TREE-DEC-01

EVERGREEN TREE PLANTING DETAIL

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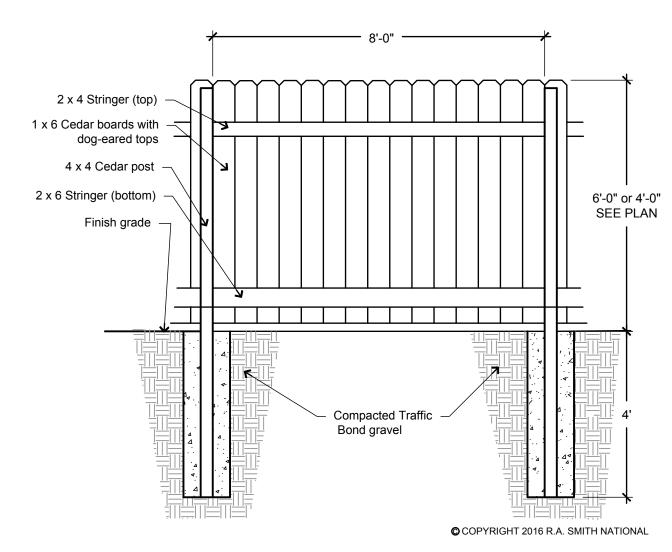


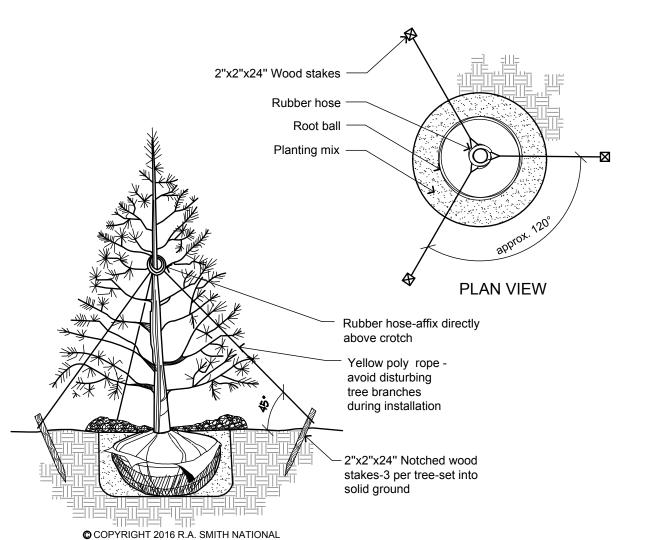EVERGREEN STAKING DETAIL

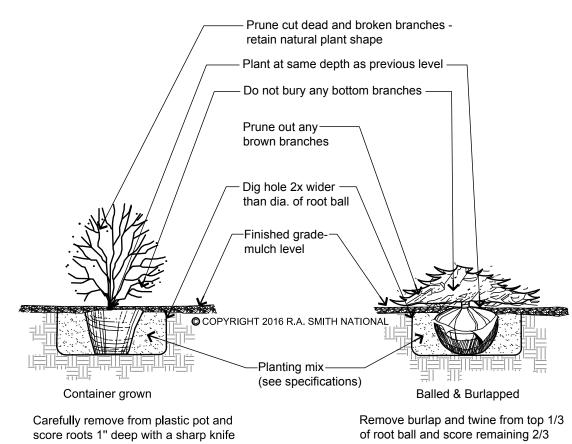P-PL-TREE-EVER-02

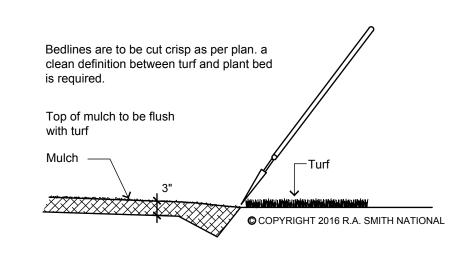SHOVEL CUT PLANT BED EDGING DETAIL


SHRUB PLANTING DETAIL



└─1" Square Picket —1-5/8" x 1-5/8" Stringer - ALL POSTS TYPICALLY INSTALLED IN CONCRETE IN ACCORDANCE FENCE PARTS WITH LOCAL CONDITIONS AND 1202 - 48 PICKET STANDARD BUILDING PRACTICES 70 -1/2" - 13 HOLE IND. STRINGER 2 - 1/2" POST 2 - 1/2" ALUMINUM POST CAP 70 - 1/2" - 13 HOLE IND. HEADER

NOTES.

1. INSTALLATION TO BE COMPLETED IN ACCORDANCE WITH MANUFACTURER'S SPECIFICATIONS. 2. ALL DIMENSIONS ARE CONSIDERED TRUE AND REFLECT MANUFACTURER'S SPECIFICATIONS. 3. CONTRACTOR'S NOTE: FOR PRODUCT AND COMPANY INFORMATION VISIT www.CADdetails.com/info

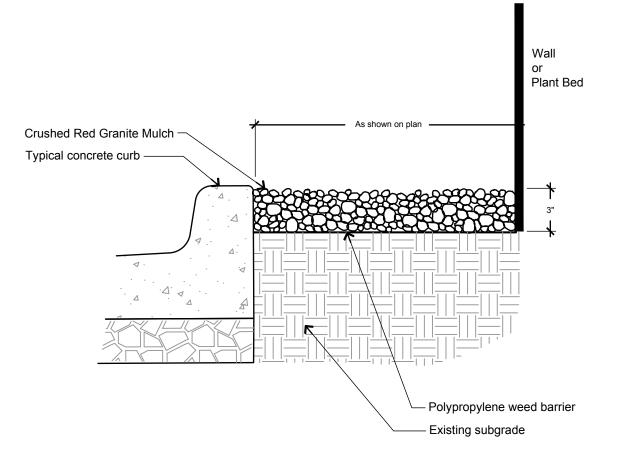

GRAVEL MULCH DETAIL

DECORATIVE ALUMINUM FENCE

P-PL-BDEG-01

GENERAL LANDSCAPE NOTES

- 1. Contractor responsible for contacting public and private underground utility locating service to have site marked prior to any digging or earthwork.
- 2. Contractor to verify all plant quantities shown on plant list and verify with plan. Report any discrepancies immediately to general contractor.
- 3. All plantings shall comply with standards as described in American Standard of Nursery Stock ANSI Z60.1 (latest version). General contractor or owner's representative reserves the right to inspect and potentially reject any plants that are inferior, compromised, undersized, diseased, improperly transported, installed
- 4. Any potential plant substitutions must be submitted in writing and approved by the general contractor or owner's representative prior to installation. All plants must be installed as per sizes shown on plant material schedule, unless approved by general contractor or owner's representative.
- Topsoil should be placed to within 3" of finish grade by general / grading contractor during rough grading operations. All parking lot islands and planting beds to be backfilled with topsoil to a minimum depth of 18" and crown all planting islands and beds a minimum of 6" to provide proper drainage (unless otherwise specified) by grading contractor to insure long term plant health.
- 5. The landscape contractor to be responsible for the fine grading of all landscaped areas. A minimum depth of 3" of blended, prepared and non-compacted topsoil is required for all seeded areas. Finished landscaped areas to be smooth, uniform and provide positive drainage away from all structures and pavement.
- Plant all trees slightly higher than finished grade at root flare. Remove excess soil from top of root ball, if needed. Scarify side walls of tree pit prior to installation. Remove and discard non-biodegradable ball wrapping and support wire. Remove biodegradable burlap and wire cage (if applicable) from top one-third of rootball. Carefully bend remaining wire down to the bottom of hole once the tree has been placed into the hole and will no longer be moved. Score the remaining two-thirds of burlap and remove twine. Backfill pit with 80% existing soil removed from excavation and 20% plant starter mix blended prior to backfilling holes. Discard any gravel, heavy clay or stones. Avoid any air pockets and do not tamp soil down. When hole is two-thirds full, trees shall be watered thoroughly, and water left to soak in before proceeding.
- Provide a 3" deep, 4 ft. diameter shredded hardwood bark mulch ring around all lawn trees. Do not build up any mulch onto trunk of any tree. Trees that are installed incorrectly will be replaced at the time and expense of the landscape contractor. Stake trees according to the staking detail.
- . Shrub planting: all shrubs to be pocket planted with a 50/50 mix of plant starter and topsoil. Install topsoil into all plant beds as needed to achieve proper grade and replace undesirable soil (see planting detail). Remove all excessive gravel, clay and stones from plant beds prior to planting. When hole is two-thirds full, shrubs shall be watered thoroughly and water left to soak in before proceeding.
- 9. Mulching: all tree and shrub planting beds to receive a 3" deep layer of high quality shredded hardwood bark mulch (not enviromulch). All perennial planting areas to receive a 2" layer and groundcover areas a 1-2" layer of the same mulch. Do not mulch annual flower beds (if applicable). Do not allow mulch to contact plant stems
- 10. Gravel Mulch: gravel mulch areas to receive a 3" deep layer of (Mississippi Stone Medium), see detail.
- 11. Edging: edge all planting beds with a 4" deep spaded edge (shovel cut or mechanical). Bedlines are to be cut crisp, as per plan. A clean definition between lawn area
- 2. Plant bed preparation: all perennial, ornamental grass, annual and groundcover areas are required to receive a blend of organic soil amendments prior to installation. Rototill the following materials, at the ratio given, into the required 18" of topsoil to a depth of approx. 8" -
- Per every 100 square feet of bed area add:
- 2 cu. ft. bale of peat moss 2 lbs. of 5-10-5 slow release fertilizer 1/4 cu. yard of composted manure
- 13. Lawn installation for all seeded turfgrass areas: remove / kill off any existing unwanted vegetation prior to seeding. Prepare the topsoil and seed bed by removing all surface stones 1" or larger and grading lawn areas to finish grade. Apply a starter fertilizer and specified seed uniformly and provide mulch covering suitable to germinate and establish turf. Provide seed and fertilizer mix information to general contractor prior to installation. Erosion control measures are to be used in swales and on steep grades, where applicable. Methods of installation may vary at the discretion of the landscape contractor on his/her responsibility to establish and guarantee a smooth, uniform, quality turf. A minimum depth of 3" of blended, prepared and non-compacted topsoil is required for all lawn areas. If straw mulch is used as a mulch covering, a tackifier may be necessary to avoid wind damage. Marsh hay containing reed canary grass is not acceptable as a mulch covering.
- An acceptable quality turf is defined as having no more than 10% of the total area with bare spots larger than 1 square foot and uniform coverage throughout all turf
- 14. Seed mix for lawn areas use only a premium quality seed mix installed at recommended rates. Premium blend seed mix example (or equivalent): 50% blended bluegrass, 25% creeping red fescue, 25% perennial rye applied at 5 lbs per 1,000 SF. Provide seed specifications to general contractor prior to installation.
- 15. Lawn installation for all sodded turfgrass areas: remove / kill off any existing unwanted vegetation prior to sodding. Prepare the topsoil and sod bed by removing all surface stones 1" or larger and grading lawn areas to finish grade. Apply a 10-10-10 starter fertilizer uniformly throughout areas prior to laying the sod. Use only premium sod blend according to TPI (revised 1995) and ASPA standards. Install sod uniformly with staggered joints, laid tightly end to end and side to side. Roll sod with a walk behind roller and water immediately upon installation to a 3" depth. Stake any sod installed on steep slopes or in swales, etc. Landscape contractor is responsible to provide a smooth, uniform, healthy turf, and is responsible for the first two mowings of the newly installed turf, and is also responsible for the required watering during this period.
- 16. Warranty and replacements: Trees, evergreens, and shrubs to be guaranteed (100% replacement) for a minimum of one (1) year from the date of substantial project completion. Perennials, groundcovers, and ornamental grasses to be guaranteed for a minimum of one growing season from the date of substantial project completion. Perennials, groundcovers, and ornamental grasses planted after September 1st shall be guaranteed through May 31st of the following year. Only one replacement per plant will be required during the warranty period, except for losses or replacements due to failure to comply with specified requirements.
- The landscape contractor is responsible for the watering and maintenance of all landscape areas at time of planting, throughout construction and for a period of 60 days after the substantial completion of the installation. This includes all trees, shrubs, evergreens, perennials, ornamental grasses, turf grass, meadow grass and wildflower areas. Work also includes weeding, edging, mulching (only if required), fertilizing, trimming, sweeping up grass clippings, pruning and deadheading.
- 18. Project completion: upon substantial completion of the project, the landscape contractor is responsible to conduct a final review with the owner's representative and the general contractor to answer questions and insure that all specifications have been met. The landscape contractor is to provide watering and general ongoing maintenance instructions (in writing) for the new plantings and lawn to the owner and general contractor.

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FORTRES CITY OF

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DATE: **09/01/16** SCALE: NTS

JOB NO. **3160154** PROJECT MANAGER:

DAVID J. CLEARY, P.E. DESIGNED BY: LJH

CHECKED BY: LJH

SHEET NUMBER LS200

` CEDAR FENCE DETAIL

DETAIL-FILE