
LYNDE AND HARRY BRADLEY FOUNDATION PARKING 1241 N. FRANKLIN PL. MILWAUKEE, WI 53202

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LION HOUSE PARKING LOT
PARCEL 1 - 3590111000 PARCEL 2 - 3590112000 PARCEL 3 - 3590109100 PARCEL 4 - 3590110000 PARCEL A - 3590105000 PARCEL B - 3590104100
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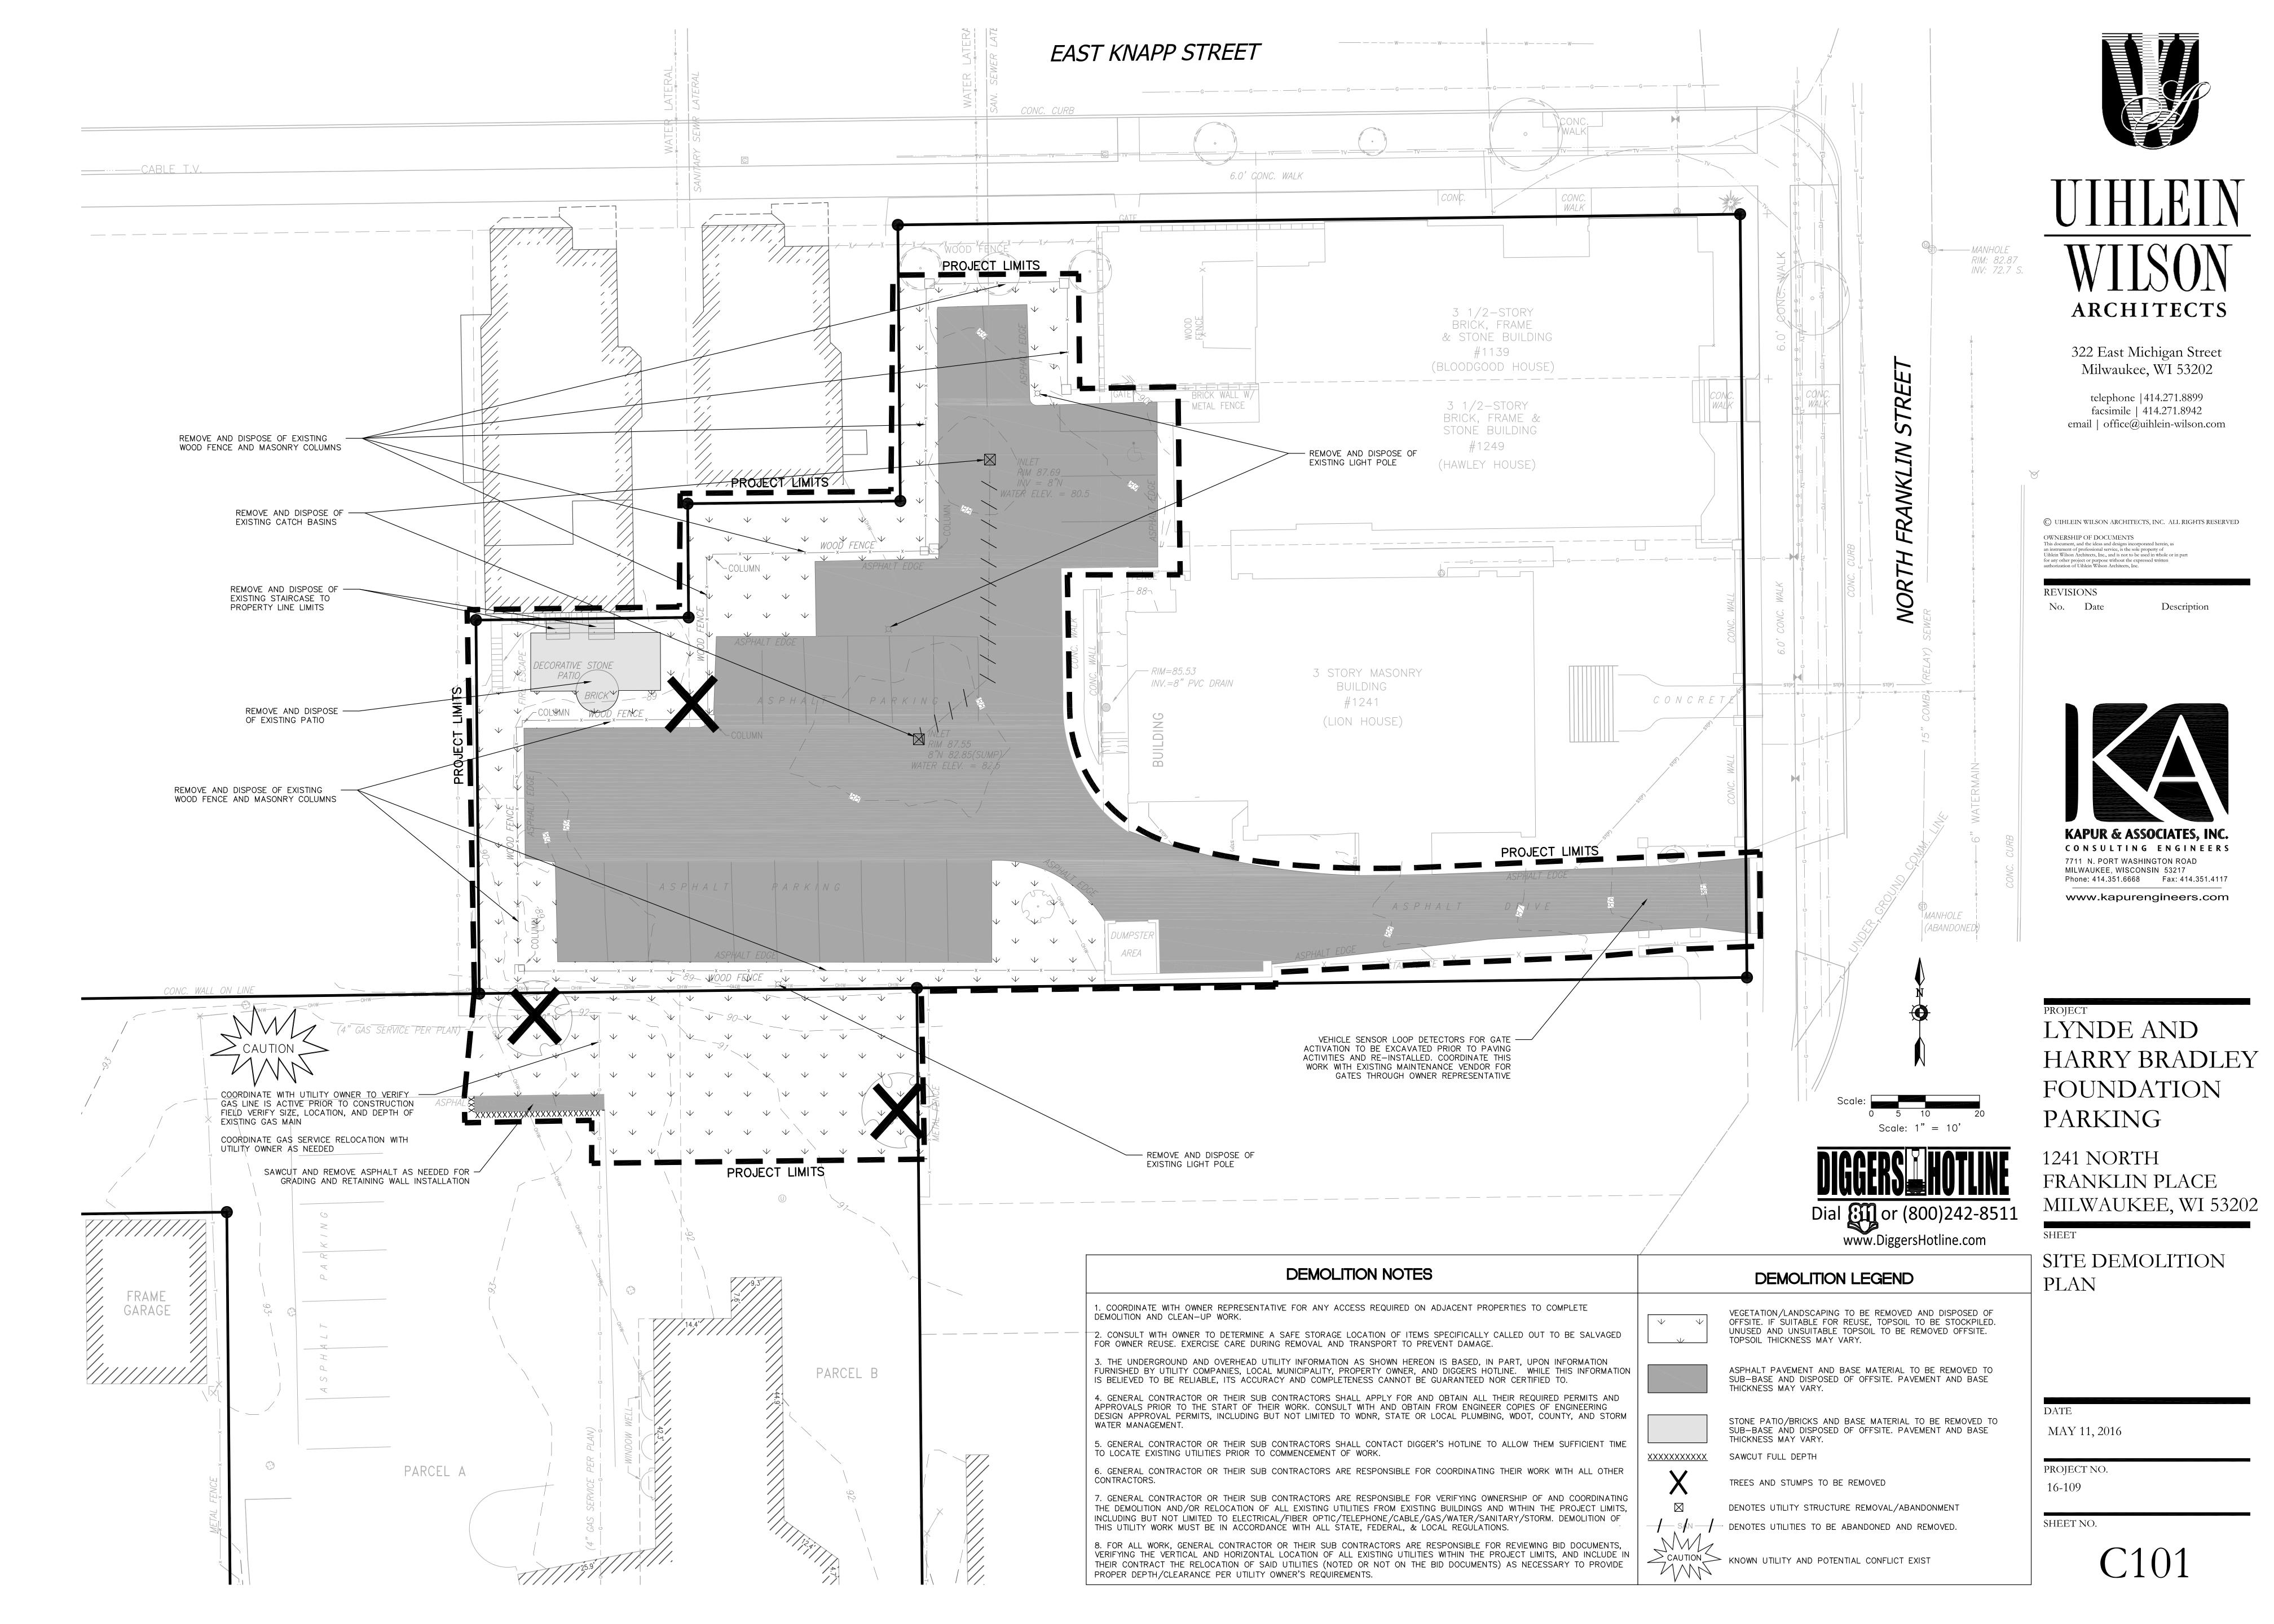
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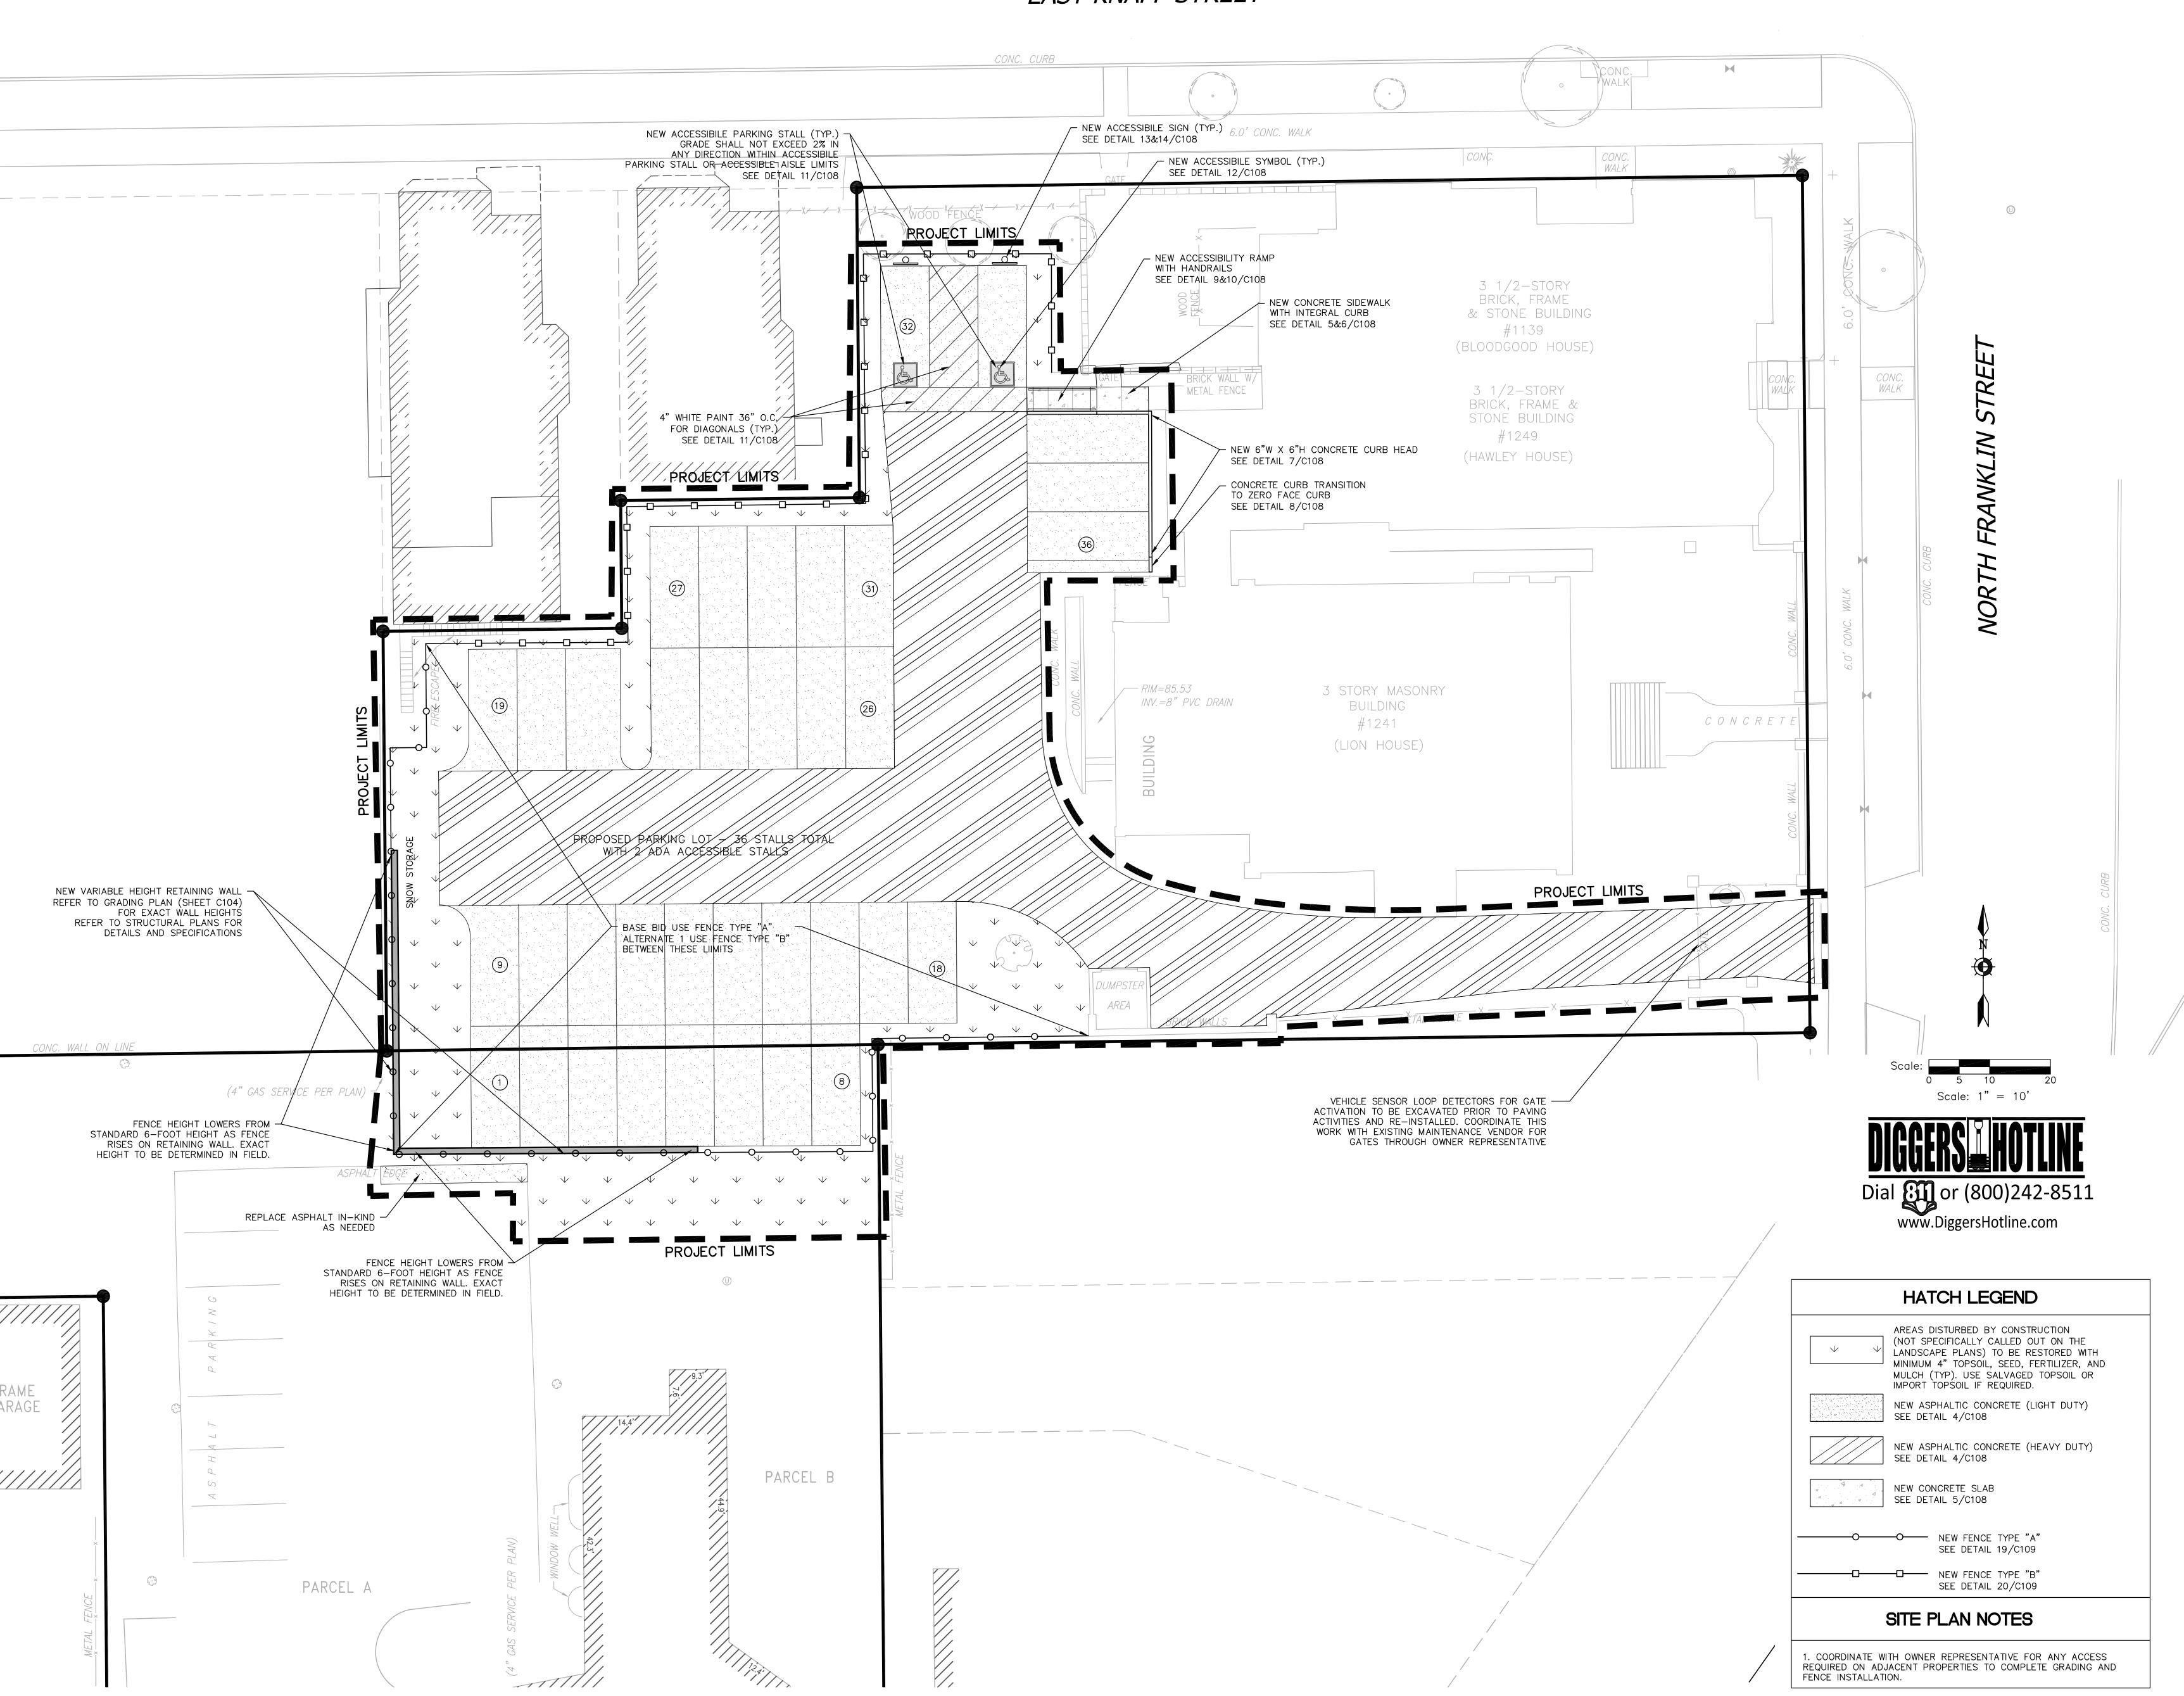
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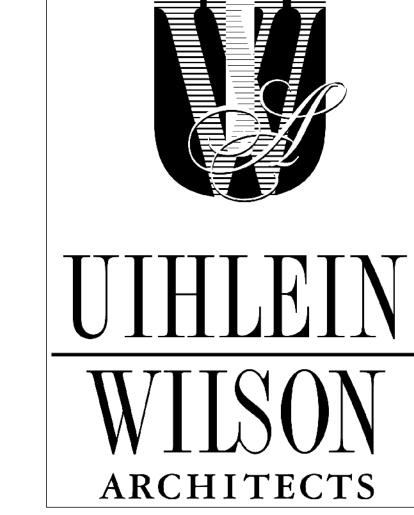
MAY 11, 2016

PROJECT NO. 16-109

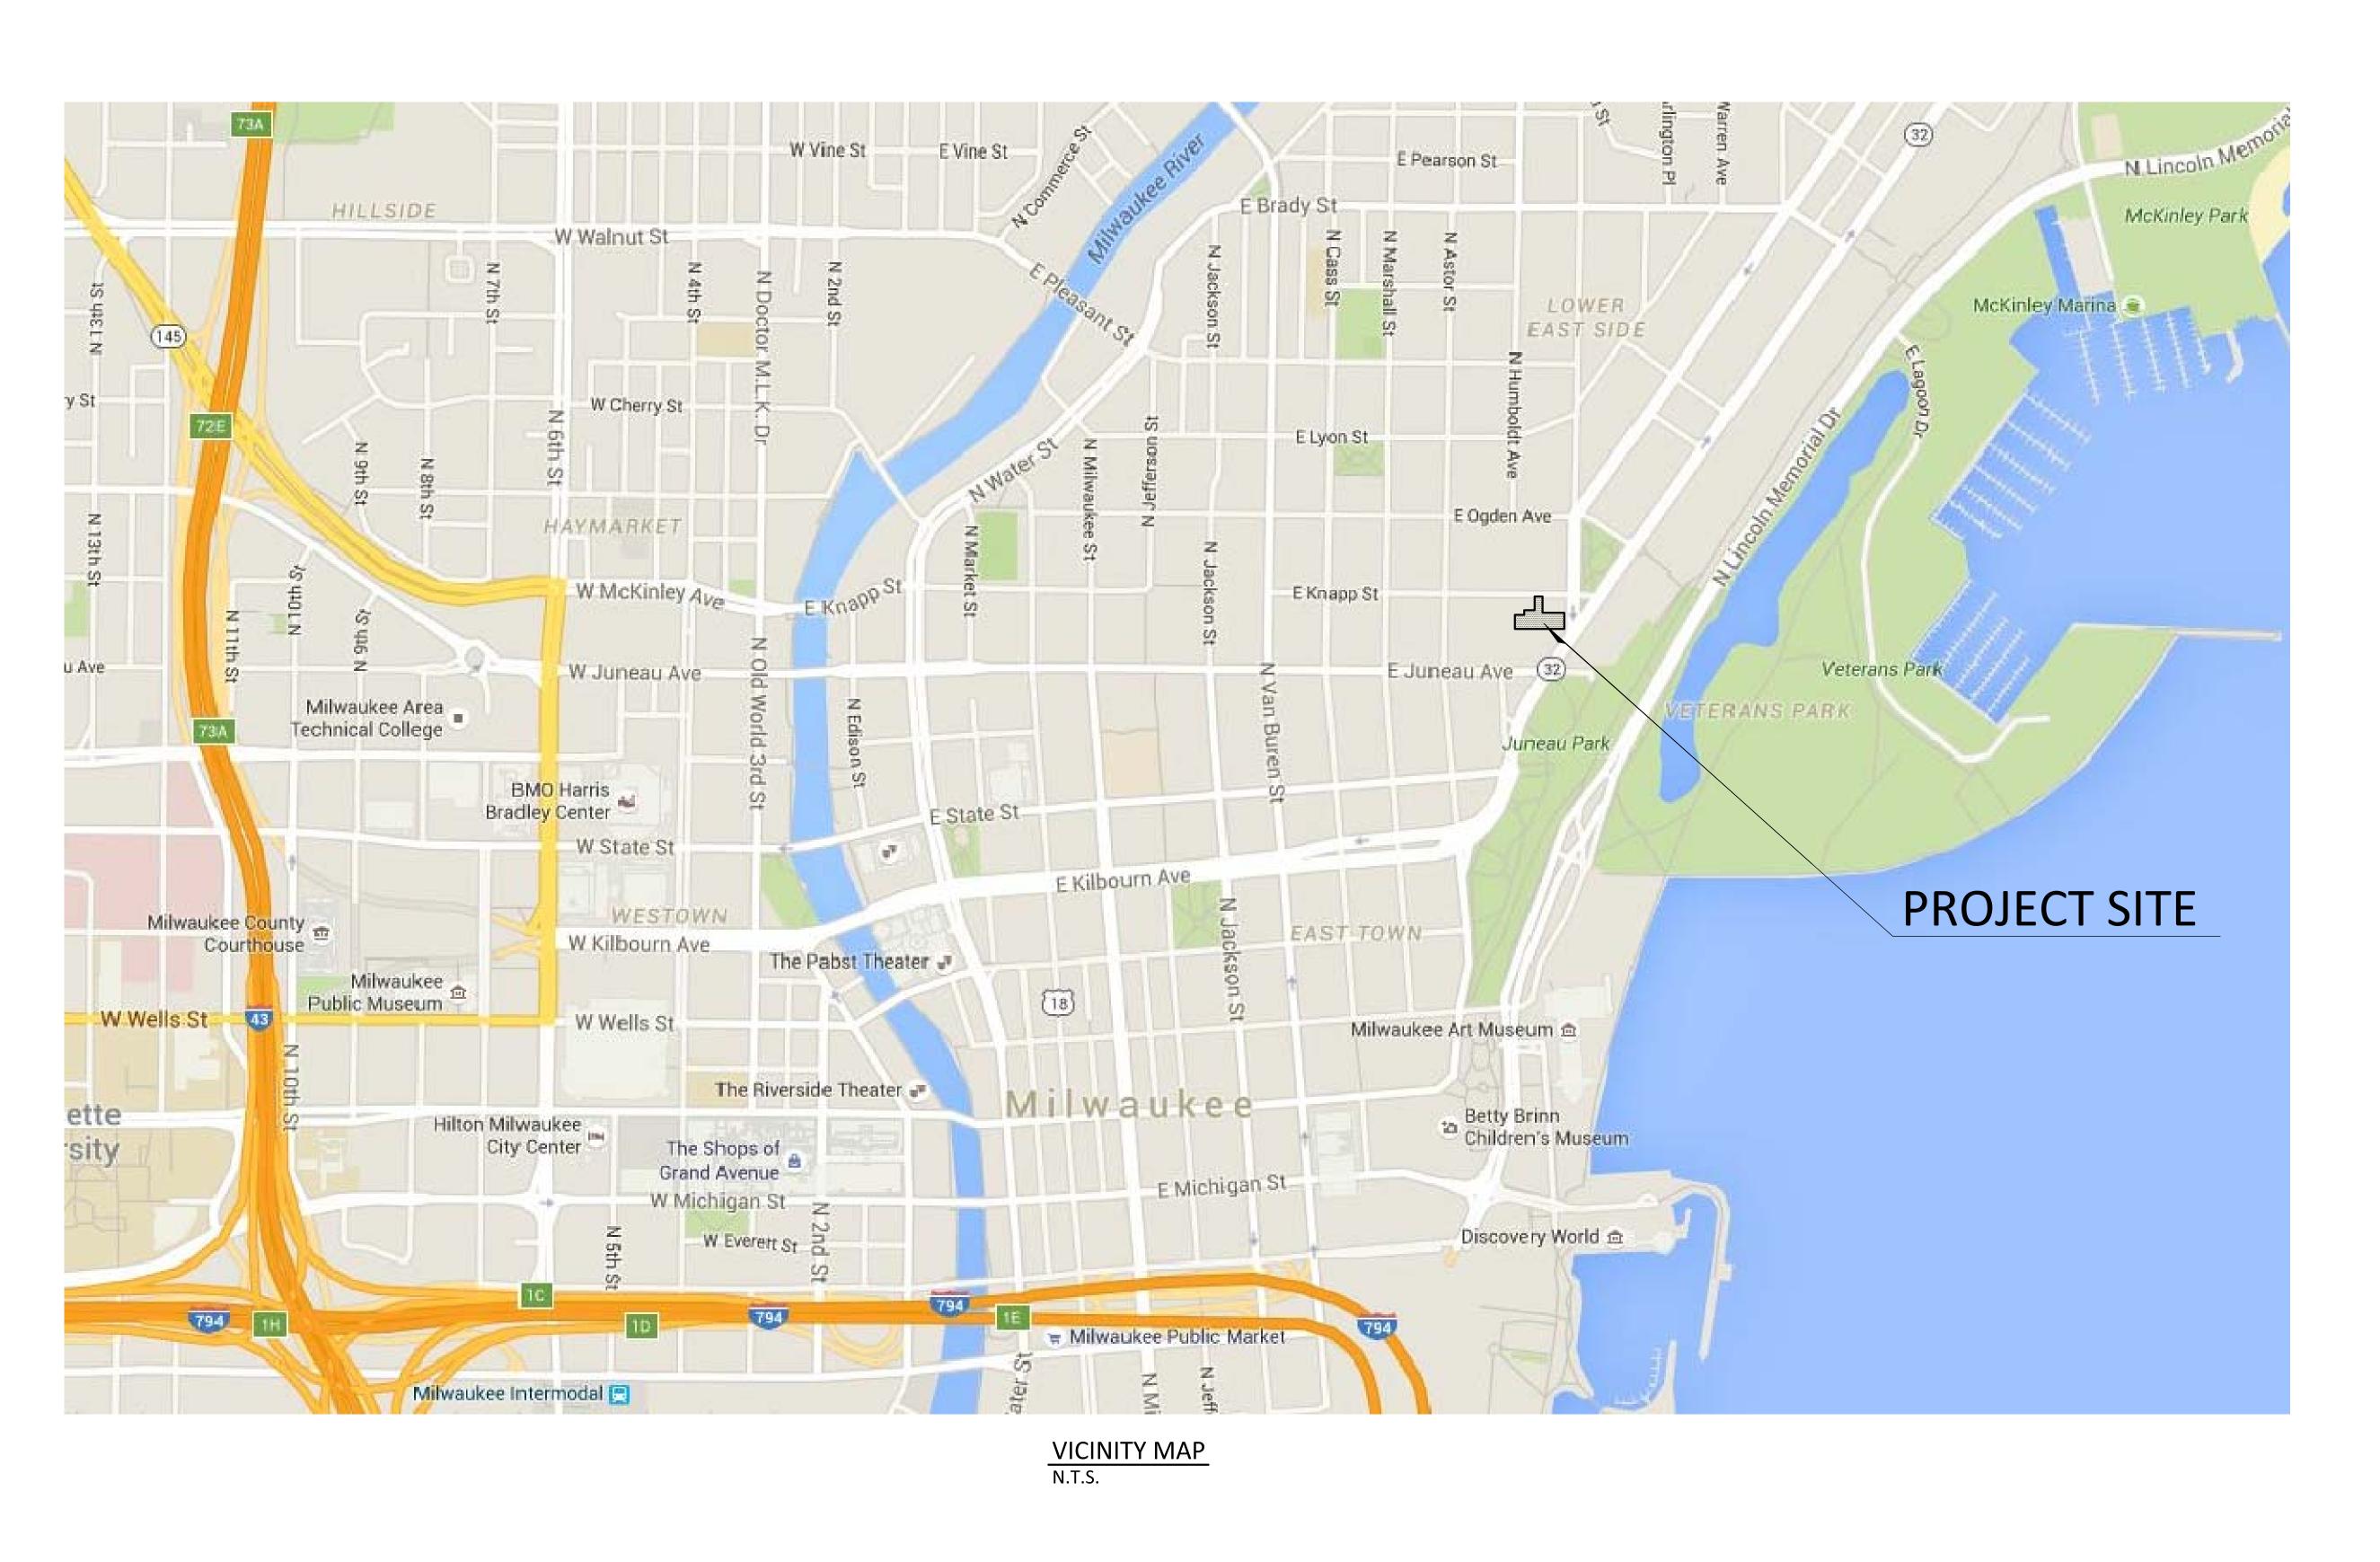

EAST KNAPP STREET





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LYNDE AND HARRY BRADLEY FOUNDATION PARKING

1241 NORTH FRANKLIN PLACE MILWAUKEE, WI 53202

SHEET

SITE PLAN

DATE MAY 11, 2016

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16-109



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LYNDE AND
HARRY BRADLEY
FOUNDATION
PARKING

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EET

SITE GEOMETRIC PLAN



Dial or (800)242-8511 www.DiggersHotline.com

PAVEMENT MARKING LEGEND


A PAVEMENT MARKING CROSSWALK,
LATEX PAVEMENT MARKING PAINT, WHITE,
4-INCH WIDE DIAGONAL STRIPING, 3' O.C.
SPACING


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MAY 11, 2016


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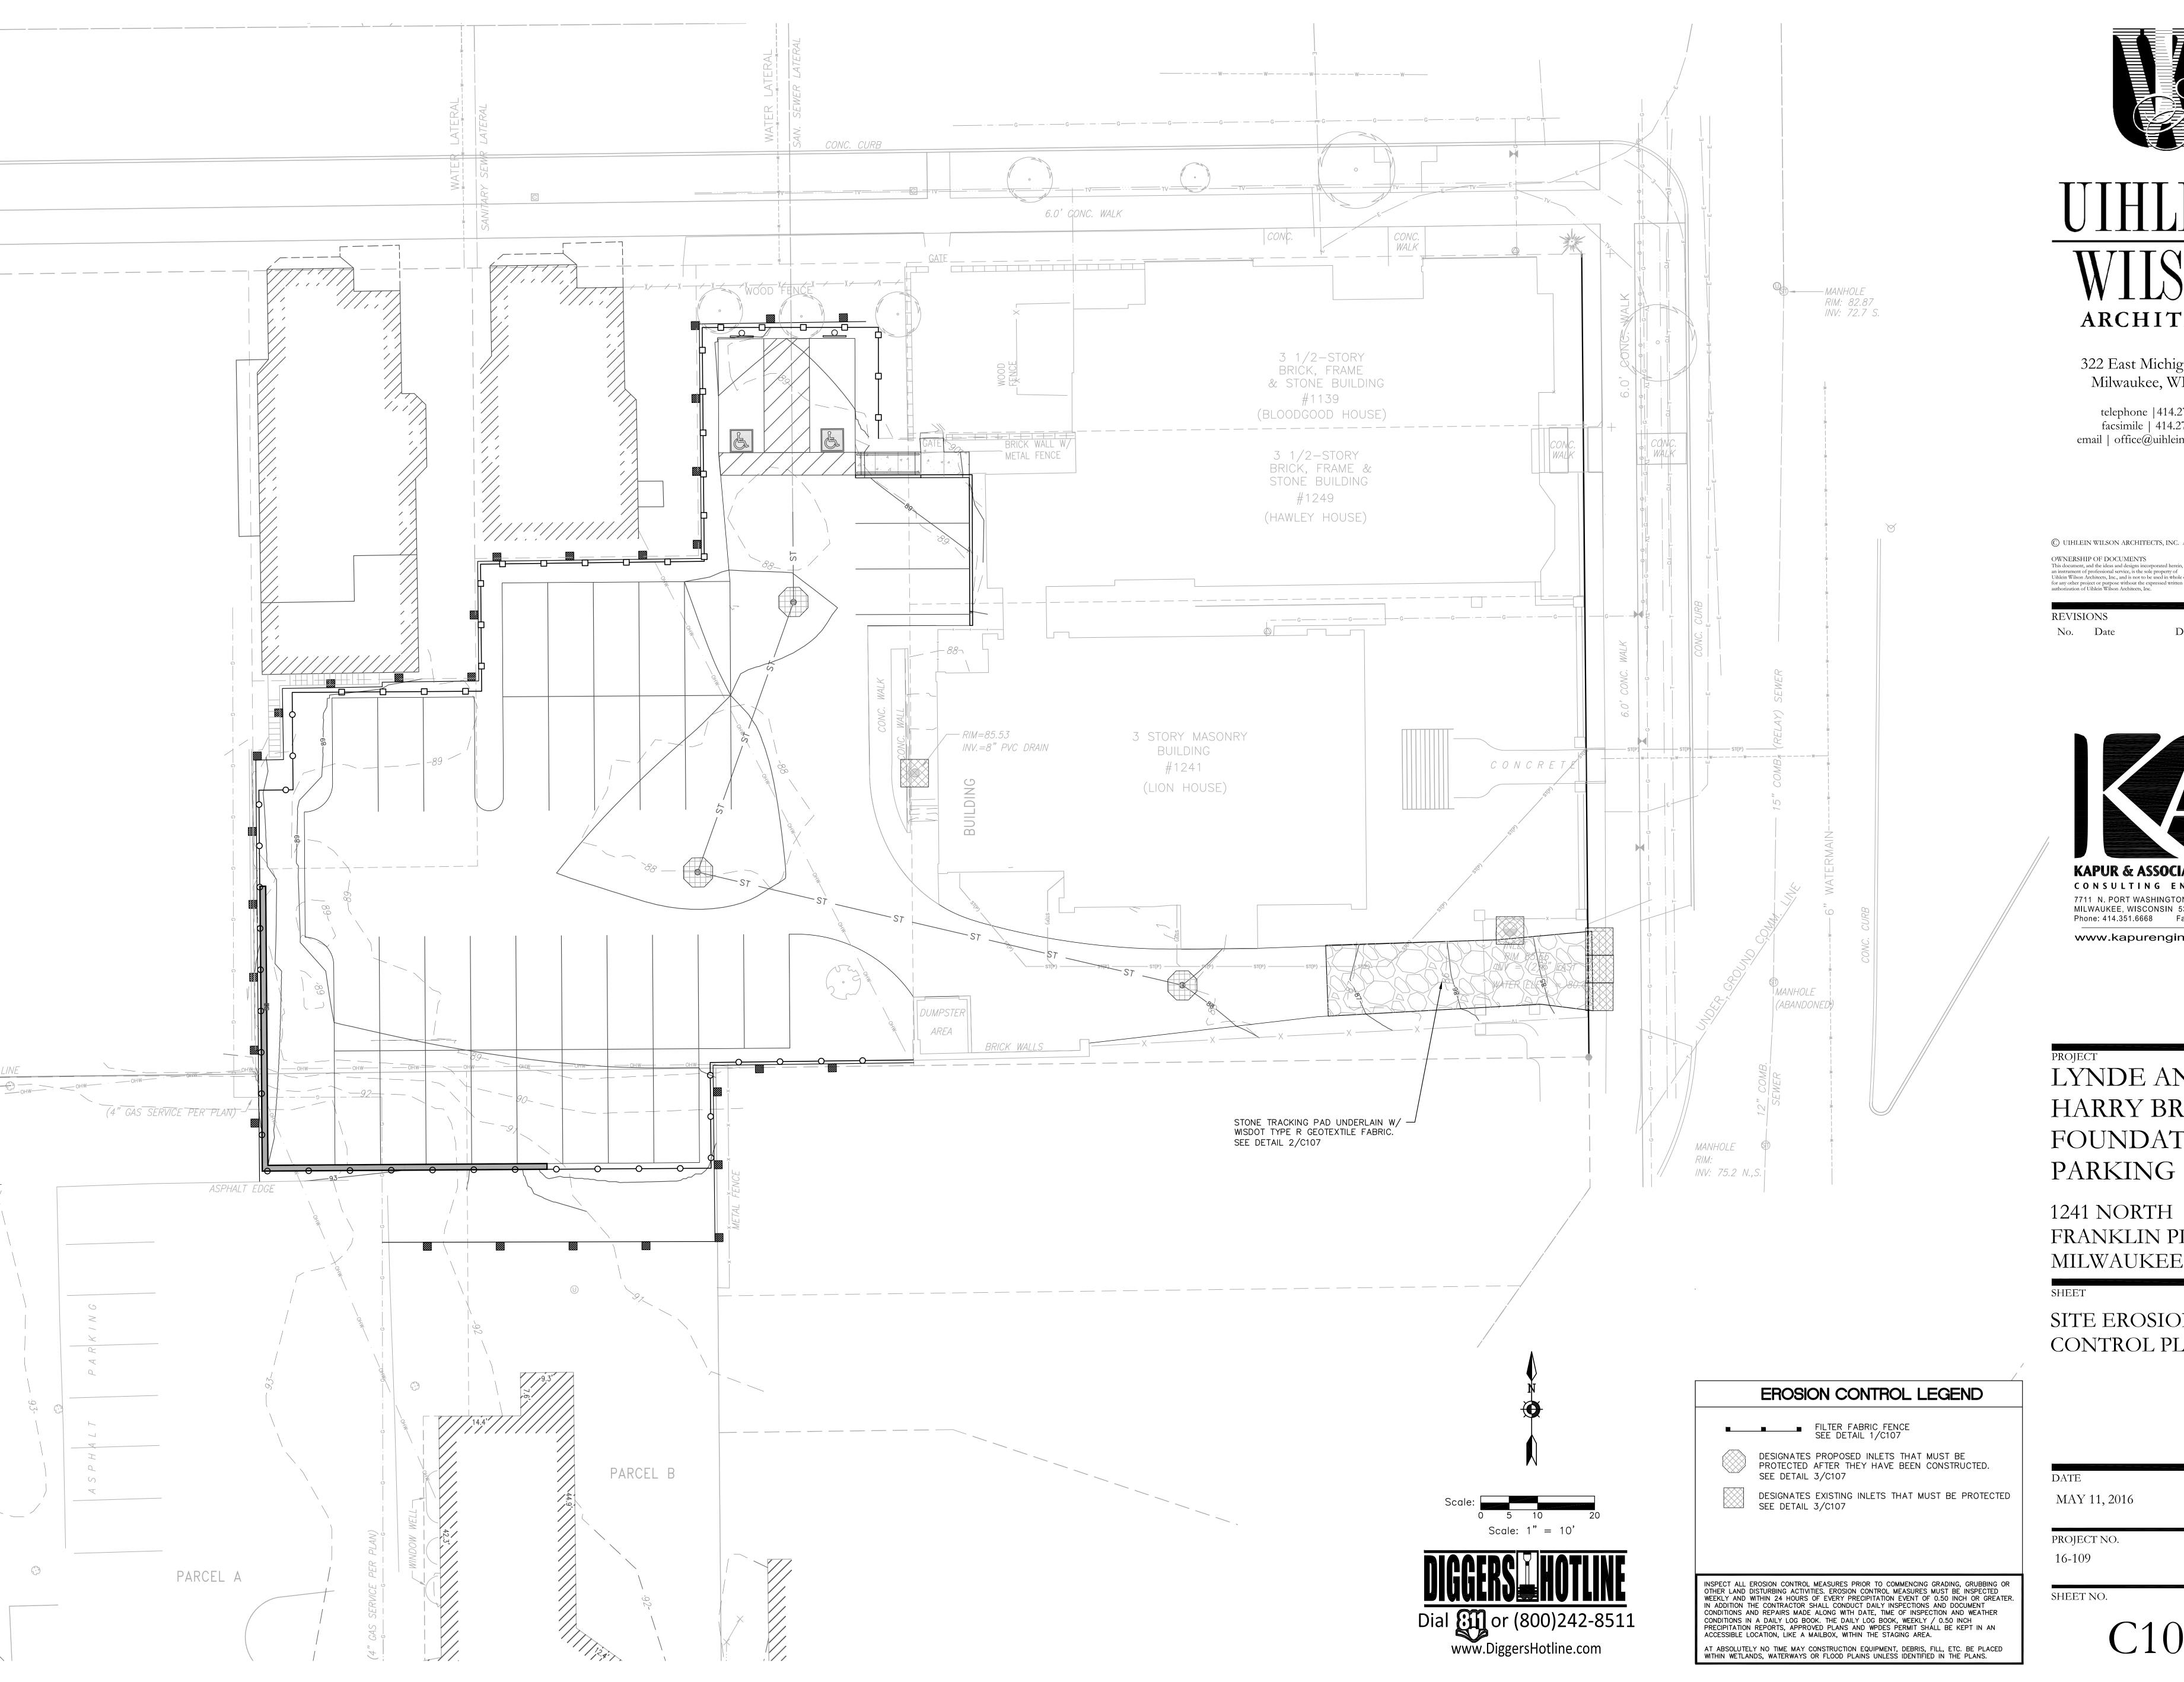
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LYNDE AND HARRY BRADLEY FOUNDATION

1241 NORTH FRANKLIN PLACE MILWAUKEE, WI 53202

SHEET

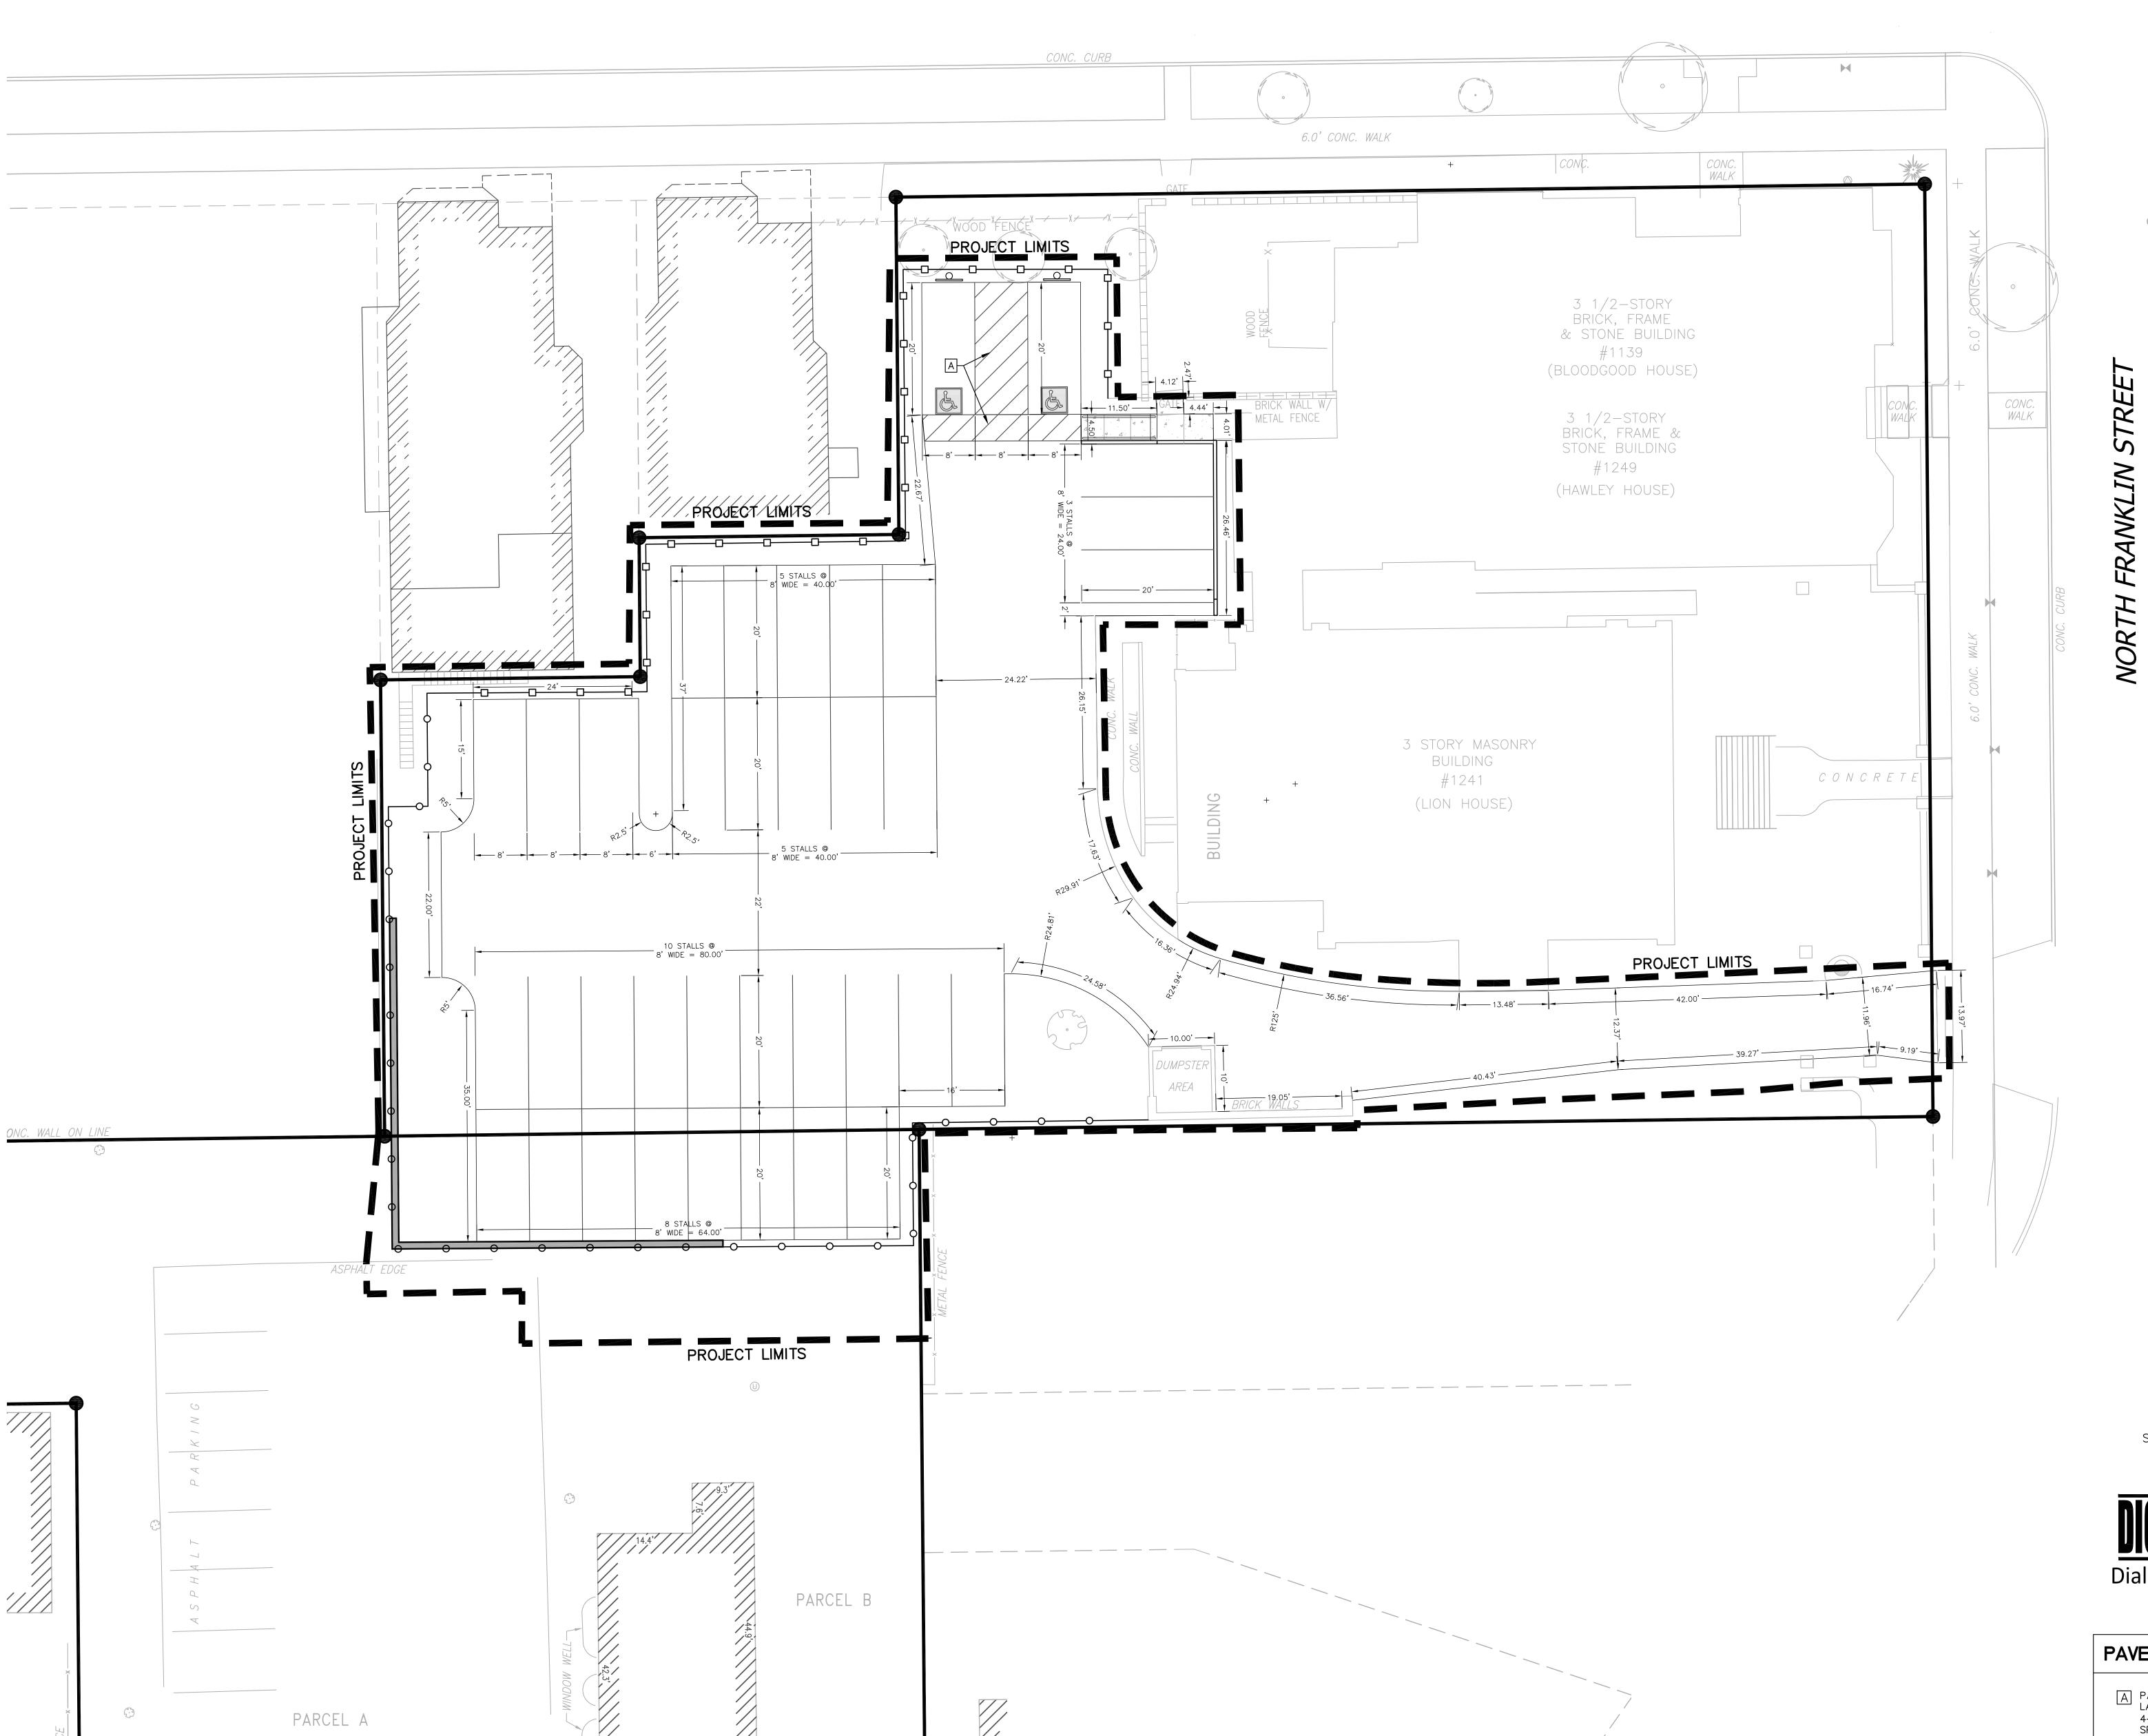SITE EROSION CONTROL PLAN

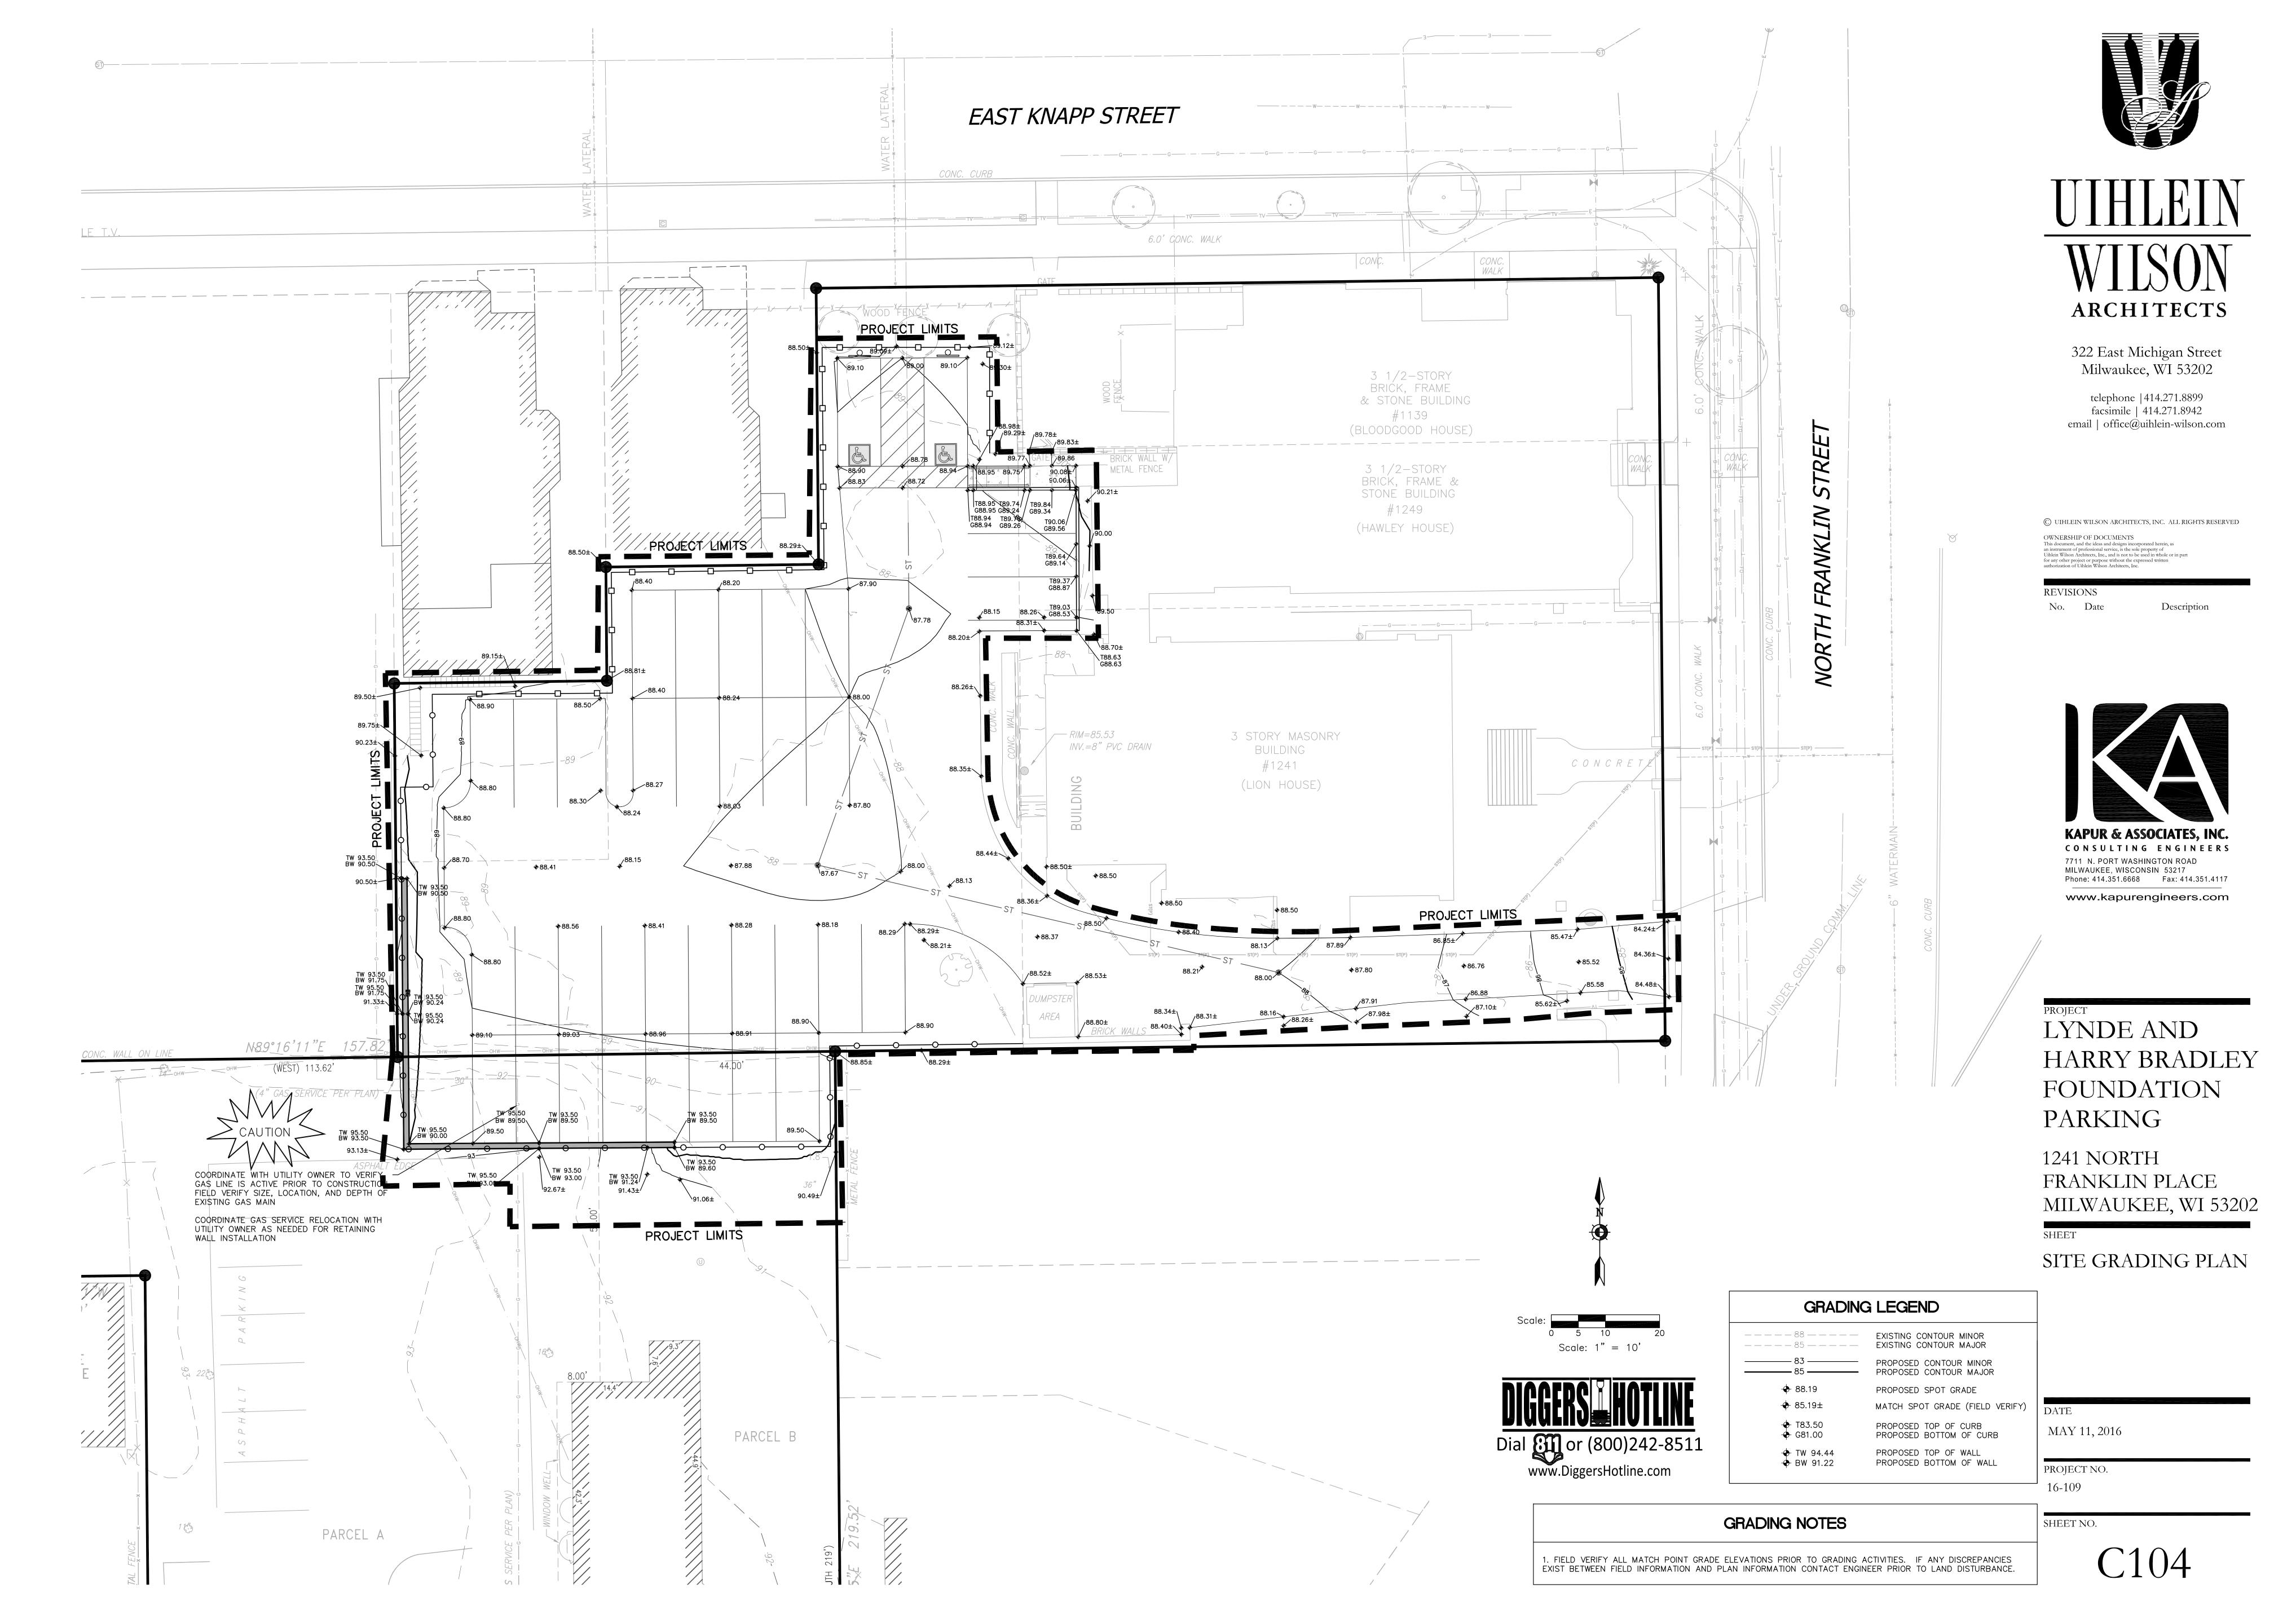DATE MAY 11, 2016

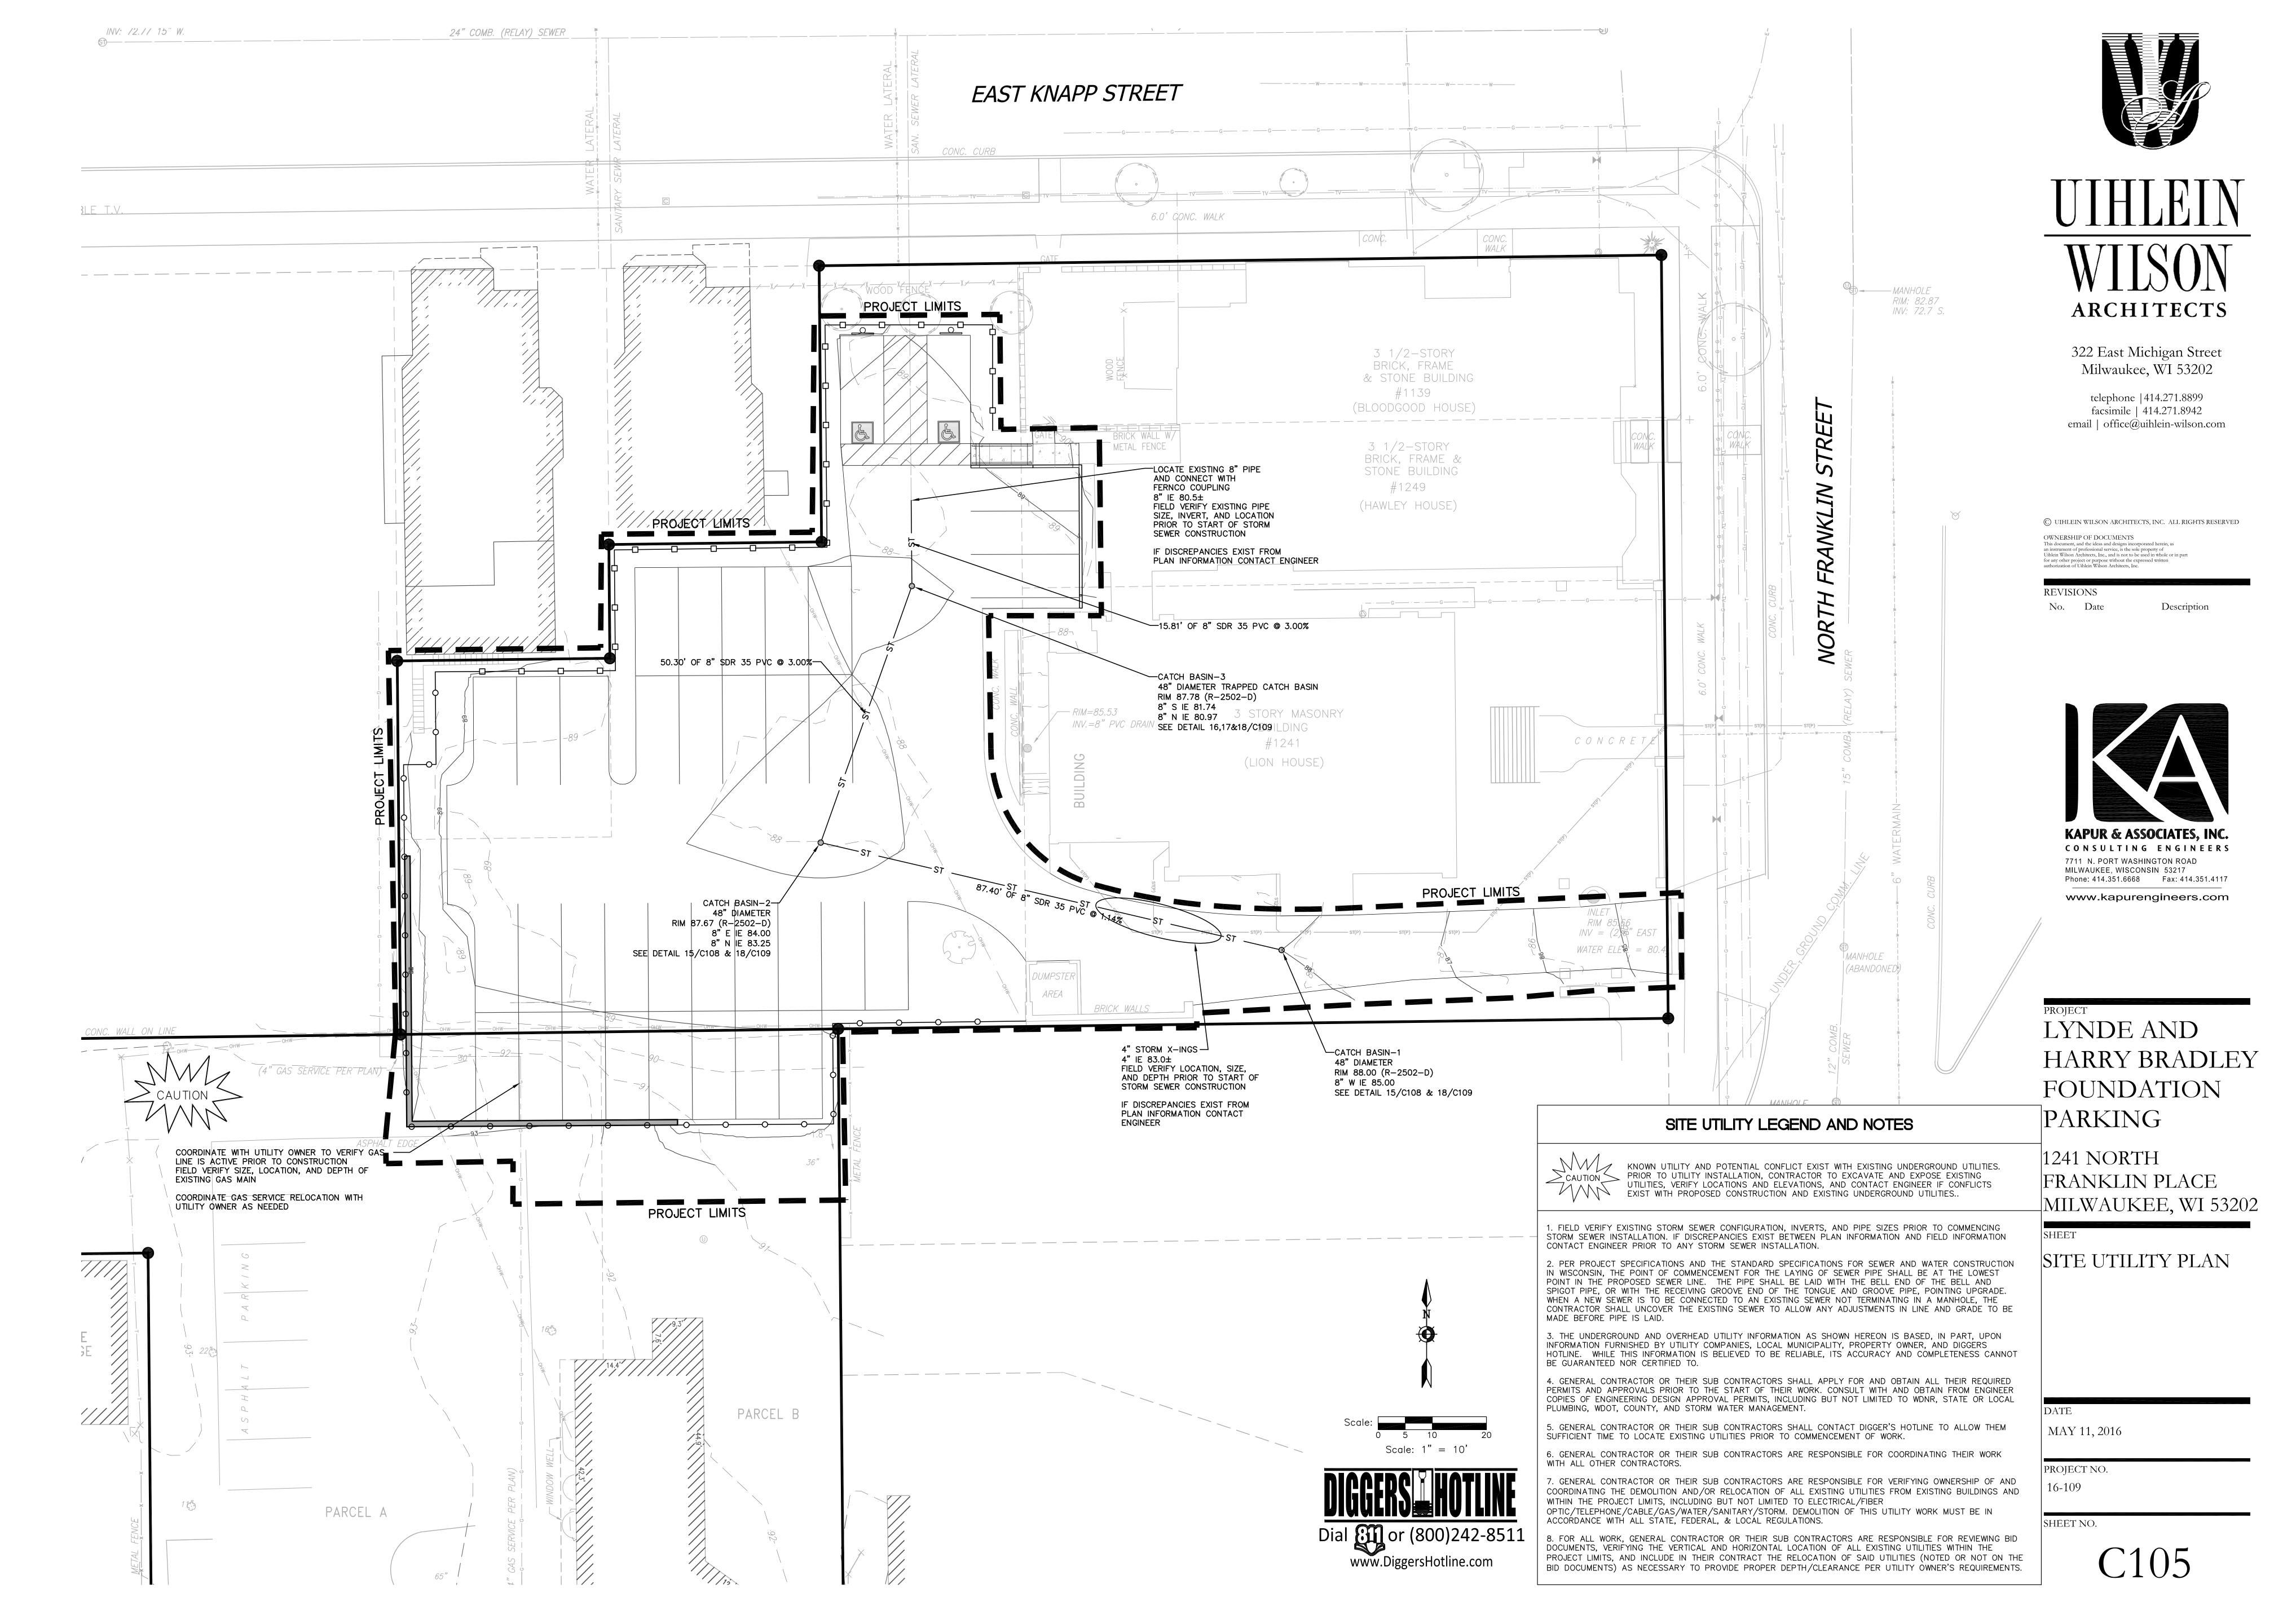PROJECT NO. 16-109

EROSION CONTROL MEASURES

- . CONTRACTOR TO INSTALL AND MAINTAIN EROSION CONTROL MEASURES AS INDICATED ON THIS PLAN AND PER THE LATEST WDNR TECHNICAL STANDARDS. TECHNICAL STANDARDS MAY BE VIEWED ONLINE AT: http://dnr.wi.gov/runoff/stormwater/techstds.htm
- . INLETS AND CATCH BASINS SHALL BE PROTECTED WITH INLET FILTERS THAT ARE PHASED IN WITH CONSTRUCTION TO REDUCE SEDIMENT FROM ENTERING THESE AREAS PER WDNR TECHNICAL STANDARD 1060 AS FOLLOWS:
- A. ALL FABRIC BARRIERS SELECTED FOR INLET/CATCH BASIN PROTECTION DEVICES SHALL BE SELECTED FROM THE LIST OF APPROVED FABRICS CERTIFIED FOR INLET PROTECTION. GEOTEXTILE FABRIC. TYPE FF IN THE CURRENT EDITION O THE WDOT PRODUCT ACCEPTABILITY LIST, TO OBTAIN THE PAL. PLEASE REFER TO THIS WEBSITE: http://www.dot.wisconsin.gov/business/engrserv/pal.htm
- B. INLET PROTECTION SHALL BE AT A MINIMUM INSPECTED WEEKLY AND WITHIN 24 HOURS AFTER EVERY PRECIPITATION EVENT OF 1/2 INCH OR GREATER DURING A 24-HOUR PERIOD.
- C. PLACEMENT OF SPOIL MATERIAL, DEBRIS, SOILS, ETC. ON TOP OF INLETS/CATCH BASINS, EVEN IF TEMPORARY, IS STRICTLY DISCOURAGED AND PROHIBITED.
- D. SEDIMENT DEPOSITS SHALL BE REMOVED AND THE INLET PROTECTION DEVICE RESTORED TO ITS ORIGINAL DIMENSIONS WHEN THE SEDIMENT HAS ACCUMULATED BETWEEN 1/3 TO 1 THE DESIGN DEPTH OF THE DEVICE, OR WHEN THE DEVICE IS NO LONGER FUNCTIONING PER MANUFACTURER'S SPECIFICATIONS. ALL SEDIMENT COLLECTED SHALL BE PROPERLY DISPOSED OF TO PREVENT DISCHARGE INTO AREA WATERWAYS AND WETLANDS.
- E. DUE CARE SHALL BE TAKEN TO ENSURE SEDIMENT DOES NOT FALL INTO THE INLETS/CATCH BASINS AND IMPEDE THE INTENDED FUNCTION OF THE DEVICE. ANY MATERIAL FALLING INTO THE INLET/CATCH BASIN SHALL BE REMOVED AND PROPERLY DISPOSED OF PER NOTE D ABOVE.
- F. INLET FILTERS MAY BE REMOVED AND PROPERLY DISPOSED OF UPON COMPLETION OF CONSTRUCTION, HAULING OR MOVEMENT OF CONSTRUCTION EQUIPMENT THROUGHOUT THE SITE, AND ONCE THE SITE IS ADEQUATELY STABILIZED,
- UNLESS AS OTHERWISE NOTIFIED BY THE WDNR. 3. A TRACKING PAD SHALL BE INSTALLED AS SHOWN ON THE PLAN SHEET PRIOR TO THE START OF CONSTRUCTION TO REDUCE OFF-SITE SEDIMENTATION BY ELIMINATING THE TRACKING OF SEDIMENT FROM THE SITE PER WDNR TECHNICAL STANDARD 1057

AS FOLLOWS:

- A. A WISDOT TYPE R GEOTEXTILE FABRIC SHALL BE USED TO PREVENT MIGRATION OF UNDERLYING SOIL INTO THE STONE.
- B. AGGREGATE USED FOR TRACKING PADS SHALL BE 3 TO 6 INCH CLEAR OR WASHED STONE. ALL MATERIAL TO BE RETAINED BY 3 INCH SIEVE.
- THE AGGREGATE SHALL BE PLACED IN A LAYER ON TOP OF THE TYPE R GEOTEXTILE FABRIC AT LEAST 12 INCHES THICK.
- D. THE TRACKING PAD SHALL BE THE FULL WIDTH OF THE EGRESS POINT AND BE AT LEAST 50 FEET LONG.
- E. VEHICLES TRAVELING ACROSS THE TRACKING PAD SHALL MAINTAIN A SLOW CONSTANT SPEED.
- ANY SEDIMENT OR ROCK ACCUMULATION ONTO LOCAL ROADWAYS SHALL BE REMOVED BY STREET CLEANING, NOT FLUSHING BEFORE THE END OF EACH WORKING DAY.
- THE TRACKING PAD SHALL, AT A MINIMUM BE INSPECTED WEEKLY AND WITHIN 24 HOURS AFTER EVERY PRECIPITATION EVENT OF 1/2 INCH OF RAIN OR MORE DURING A 24-HOUR
- H. THE TRACKING PAD PERFORMANCE SHALL BE MAINTAINED BY

SHALL TAKE PLACE WITH ALL RELEVANT PARTIES IN ATTENDANCE.

THE TIMING AND SEQUENCE OF CONSTRUCTION IS SCHEDULED AS FOLLOWS:

REMOVED AFTER CONSTRUCTION & SITE STABILIZATION IS COMPLETE.

MATTING AS PER APPROVED PLANS AND SPECIFICATIONS.

RESUBMITTED BY THE GENERAL CONTRACTOR TO THE CITY AND WDNR,

CONFORMING TO WDNR TECHNICAL STANDARD 1050 SHALL BE USED.

ASPHALTIC MATERIALS WILL BE APPLIED PER PROJECT SPECIFICATIONS.

SCRAPING OR TOP-DRESSING WITH ADDITIONAL AGGREGATE.

EROSION CONTROL OPERATION SEQUENCE + SCHEDULE

THE GENERAL CONTRACTOR IS RESPONSIBLE FOR INSTALLING AND MAINTAINING ALL SILT FENCES, SEEDING

EROSION MATTING, AND OTHER EROSION CONTROL MEASURES. GENERAL CONTRACTOR SHALL INSPECT ALL

EROSION CONTROL MEASURES PRIOR TO COMMENCING GRADING, GRUBBING, OR OTHER LAND DISTURBING

ACTIVITIES. EROSION CONTROL MEASURES MUST BE INSPECTED WEEKLY AND WITHIN 24 HOURS OF EVERY

PRECIPITATION EVENT OF ½ INCH OR GREATER. IN ADDITION, THE ACTIVE CONTRACTOR SHALL CONDUCT DAILY INSPECTIONS AND DOCUMENT CONDITIONS AND REPAIRS MADE, ALONG WITH DATE, TIME OF INSPECTION,

CONTRACTORS ARE TO MAINTAIN THE CONSTRUCTION SITE IN A NEAT AND TIDY MANNER FOR THE DURATION

2. CONSTRUCTION IS SCHEDULED TO BEGIN IN SUMMER 2016, DEPENDING ON WEATHER & GROUND CONDITIONS

3. A GRAVEL TRACKING PAD UNDERLAIN WITH WISDOT TYPE R GEOTEXTILE FABRIC, ALONG WITH A TEMPORARY

CULVERT IF NECESSARY, SHALL BE INSTALLED AS SHOWN ON THE PLANS. RE-GRADE EXISTING ROADWAY

4. SILT FENCE AND GRAVEL TRACKING PAD SHALL BE INSTALLED AS SHOWN ON THE PLANS, AND INSPECTED

I. OBTAIN PLAN APPROVAL FROM THE CITY OF MILWAUKEE, AND ALL APPLICABLE PERMITS, INCLUDING

DITCH AS NECESSARY. IF INSTALLED, THE TEMPORARY CULVERT SHALL BE REMOVED AT END OF

PRIOR TO COMMENCING OF ANY LAND DISTURBING ACTIVITIES PER PROJECT PLANS AND DETAILS.

5. EROSION CONTROL SHALL, AT A MINIMUM, BE INSPECTED WEEKLY AND WITHIN 24 HOURS AFTER EVERY

PRECIPITATION EVENT THAT PRODUCES ½ INCH OF RAIN OR MORE DURING A 24-HOUR PERIOD. SEDIMENT SHALL BE REMOVED TO MAINTAIN THE 2 FOOT DEPTH OF THE TREATMENT SURFACE AREA AS MEASURED

FROM THE INVERT OF THE PRINCIPAL OUTLET. SEDIMENT MAY NEED TO BE REMOVED MORE FREQUENTLY. I

THE OUTLET BECOMES CLOGGED IT SHALL BE CLEANED TO RESTORE FLOW CAPACITY. SEDIMENT TO BE

7. SITE DEMOLITION OF PAVEMENT, ETC. WILL OCCUR AFTER ALL EROSION CONTROL MEASURES ARE IN PLACE.

LANDSCAPE CONTRACTOR WILL COMPLETE SEEDING/SODDING/FERTILIZING/MULCHING AND INSTALL EROSION

12. FINAL SITE STABILIZATION IS ANTICIPATED FOLLOWING THE COMPLETION OF GRADING ACTIVITIES. IF SITE

STABILIZATION CANNOT BE COMPLETED BY OCTOBER 1, THEN THE USE OF ANIONIC POLYACRYLAMIDE

13. AFTER ALL TOPSOIL HAS BEEN REAPPLIED AND STABILIZATION IS UNDERWAY, PARKING LOT BASE AND

14. THE GENERAL CONTRACTOR WILL REQUEST A FINAL INSPECTION BY THE CITY. UPON APPROVAL, ALL SILT FENCES, INLET FILTER PROTECTION, AND OTHER EROSION CONTROL DEVICES SHALL BE REMOVED.

15. IF REQUIRED, FINAL "AS-BUILT" SURVEYS ARE TO BE CONDUCTED BY THE OWNER AND FINAL DOCUMENTS

16. BARE SOIL LEFT UNDISTURBED FOR 14 CALENDAR DAYS MUST BE TEMPORARILY STABILIZED PER WDNR TECHNICAL STANDARD 1059, OR TEMPORARY GRADING PRACTICES PER WDNR TECHNICAL STANDARD 1067

17. WE DO NOT ANTICIPATE THE NEED FOR WATERING WITH THIS CONSTRUCTION SCHEDULE, HOWEVER, IF

IF CONSTRUCTION SCHEDULES SHOULD CHANGE SIGNIFICANTLY, THIS PLAN NARRATIVE WILL BE UPDATED AND

DURING THE CONSTRUCTION PROCESS, WATER SHALL BE TRUCKED IN AND APPLIED ONCE PER WEEK.

MAY BE IMPLEMENTED. HOWEVER BY OCTOBER 1, THE SITE SHALL BE STABILIZED PER NOTE 12 ABOVE.

ADEQUATE RAIN IS NOT EXPERIENCED WITHIN ONE WEEK AFTER INITIAL SEED GERMINATION AT ANY POINT

9. TOPSOIL STRIPPING AND ROUGH GRADING WILL FOLLOW. GRAVEL AND TOPSOIL STOCKPILES WILL BE

LOCATED AS SHOWN ON THE PLANS. UNUSED STOCKPILES WILL BE REMOVED FROM THE SITE.

10. UTILITY INSTALLATION WILL OCCUR NEXT AND CONTINUE UNTIL ALL THE UTILITIES ARE INSTALLED.

11. AFTER ROUGH GRADING IS COMPLETE IN AREAS OUTSIDE OF PROPOSED ROADWAYS, PARKING LOTS,

BUILDINGS, AND ALL OTHER HARD SURFACE AREAS, THE TOPSOIL WILL BE REAPPLIED AND THE

ALL REGULATORY PERMITS, PROJECT PLANS, AND INSPECTION LOGS SHALL BE KEPT ON SITE IN AN

ACCESSIBLE LOCATION, SUCH AS A MAILBOX, AVAILABLE TO REGULATORY AGENCIES UPON REQUEST.

AFTER BIDS ARE RECEIVED AND A MASS GRADING CONTRACTOR IS SELECTED. A PRE-CONSTRUCTION MEETING

I. A MINIMUM 12-INCH THICK PAD SHALL BE MAINTAINED.

AND WEATHER CONDITIONS IN A DAILY LOG BOOK.

EROSION CONTROL PERMIT.

CONSTRUCTION ACTIVITIES.

FORWARDED TO THE CITY.

- 4. THE CONSTRUCTION SITE PERIMETER AND TOPSOIL STOCKPILE AREA SHALL BE PROTECTED WITH SILT FENCE AS SHOWN ON THE PLAN SHEET PRIOR TO THE START OF CONSTRUCTION TO INTERCEPT AND REDUCE THE FLOW OF SEDIMENT-LADEN SHEET FLOW RUNOFF FROM THE CONSTRUCTION SITE PER WDNR TECHNICAL STANDARD 1056 AS FOLLOWS:
- A. SILT FENCE ENDS SHALL BE EXTENDED UPSLOPE TO PREVENT WATER FROM FLOWING AROUND THE ENDS OF THE FENCE AS SHOWN ON THE PLAN
- B. INSTALLED SILT FENCE SHALL BE A MINIMUM 14 INCHES HIGH AND SHALL NOT EXCEED 28 INCHES IN HEIGHT MEASURED FROM THE INSTALLED GROUND ELEVATION.
- C. SILT FENCE SHALL BE SUPPORTED BY EITHER STEEL OR WOOD SUPPORT POSTS.
- D. THE MAXIMUM SPACING OF POSTS FOR NONWOVEN SILT FENCE SHALL BE 3 FEET OR FOR WOVEN FABRIC 8 FEET.
- E. SILT FENCE SHALL HAVE A SUPPORT CORD AT THE TOP OF THE FENCE.
- F. WHERE JOINTS ARE NEEDED, EACH END OF THE FABRIC SHALL BE SECURELY FASTENED TO A POST. THE POSTS SHALL BE WRAPPED AROUND EACH OTHER TO PRODUCE A STABLE AND SECURE JOINT OR SHALL BE OVERLAPPED THE DISTANCE BETWEEN TWO POSTS.
- G. A MINIMUM OF 20 INCHES OF THE POSTS SHALL EXTEND INTO THE GROUND AFTER INSTALLATION.
- H. SILT FENCE SHALL BE ANCHORED BY SPREADING AT LEAST 8 INCHES OF THE FABRIC IN A 4 INCH WIDE BY 6 INCH DEEP TRENCH, OR 6 INCH DEEP V-TRENCH ON THE UPSLOPE SIDE OF THE FENCE. THE TRENCH SHALL BE BACKFILLED AND COMPACTED. TRENCHES SHALL NOT BE EXCAVATED ANY WIDER OR DEEPER THAN NECESSARY FOR PROPER INSTALLATION.
- ON THE TERMINAL ENDS OF THE SILT FENCE THE ABRIC SHALL BE WRAPPED AROUND THE POST SUCH THAT THE STAPLES ARE NOT VISIBLE.
- J. GEOTEXTILE FABRIC SPECIFICATIONS SHALL MEET VALUES ESTABLISHED IN TECHNICAL STANDARD
- K. SILT FENCE SHALL BE REMOVED ONCE THE SITE
- L. WHEN PLACING SILT FENCE NEAR TREES, CARE SHALL BE TAKEN TO MINIMIZE DAMAGE TO THE ROOT SYSTEM BY AVOIDING COMPACTION AND ROOT CUTTING WITHIN 1.5 FEET MULTIPLIED BY THE INCH DIAMETER OF THE TREE.
- M. THE CONTRACTOR MAY FURTHER STRENGTHEN THE SILT FENCE BY USING HAY BALES ON THE DOWN SLOPE SIDE AS NEEDED.
- N. SILT FENCE SHALL AT A MINIMUM BE INSPECTED WEEKLY AND WITHIN 24 HOURS AFTER EVERY PRECIPITATION EVENT THAT PRODUCES 1/2 INCH OF RAIN OR MORE DURING A 24 HOUR PERIOD
- O. DAMAGED OR DECOMPOSED SILT FENCE. UNDERCUTTING, OR FLOW CHANNELS AROUND THE END OF BARRIERS SHALL BE REPAIRED OR

P. SEDIMENT SHALL BE PROPERLY DISPOSED OF

ONCE THE DEPOSITS REACH 1/2 THE HEIGHT OF THE FENCE TO PREVENT DISCHARGE INTO AREA WATERWAYS AND WETLANDS.

- 5. SEEDING AND MULCHING TECHNIQUES SHALL BE USED ON AREAS OF EXPOSED SOIL WHERE THE ESTABLISHMENT OF VEGETATION IS DESIRED. TEMPORARY SEEDING APPLIES TO DISTURBED AREAS THAT WILL NOT BE BROUGHT TO FINAL GRADE OR ON WHICH LAND-DISTURBING ACTIVITIES WILL NOT BE PERFORMED FOR A PERIOD GREATER THAN 14 CALENDAR DAYS, REQUIRING VEGETATIVE COVER FOR LESS THAN ONE YEAR. SEED AND MULCH SHALL BE UTILIZED THROUGHOUT HE DURATION OF CONSTRUCTION TO ESTABLISH TEMPORARY VEGETATION TO HELP REDUCE EROSION PER WDNR TECHNICAL STANDARDS 1059 AND 1058
- A. TEMPORARY SEEDING REQUIRES A SEEDBED OF LOOSE SOIL TO A MINIMUM DEPTH OF 2 INCHES.
- B. FERTILIZER APPLICATION IS NOT GENERALLY REQUIRED FOR TEMPORARY SEEDING. HOWEVER, ANY APPLICATION OF FERTILIZER OR LIME SHALL BE BASED ON SOIL TESTING.
- C. THE SOIL SHALL HAVE A PH RANGE OF 5.5 TO 8.0.

RESPECTIVELY AS FOLLOWS:

- D. ALL SEED SHALL CONFORM TO THE REQUIREMENTS OF THE WISCONSIN STATE STATUTES AND OF THE ADMINISTRATIVE CODE CHAPTER ATCP 20.01 REGARDING NOXIOUS WEED SEED CONTENT AND LABELING.
- E. SEED SHALL NOT BE USED LATER THAN ONE YEAR AFTER THE TEST DATE ON THE LABEL. F. IN THE SUMMER-SPRING, CONTRACTOR SHALL USE OATS APPLIED AT 131
- LBS/ACRE FOR TEMPORARY SEEDING PURPOSES. IN THE FALL THE CONTRACTOR SHALL USE ANNUAL RYEGRASS APPLIED AT 80 LBS/ACRE OR WINTER WHEAT APPLIED AT 131 LBS/ACRE. THE CONTRACTOR SHALL USE STRAW MULCH APPLIED AT 1.5 TONS/ACRE. DORMANT SEED SHALL BE USED WHEN SOIL TEMPERATURE IS CONSISTENTLY BELOW 53 DEGREES FAHRENHEIT (TYPICALLY NOV. 1 UNTIL SNOW COVER ANNUALLY). NEVER PLACE SEED ON TOP OF SNOW. IF COVER IS NEEDED AFTER SNOW FALL, CONTRACTOR MAY CHOOSE TO USE A DRY, NONTOXIC TYPE B SOIL STABILIZER PER MANUFACTURER'S SPECIFICATIONS AS REQUIRED BY THE
- G. SEEDING SHALL NOT TAKE PLACE WHEN THE SOIL IS TOO WET. H. CONTRACTOR MAY CONSIDER WATERING TO HELP ESTABLISH THE SEED. WATER APPLICATION RATES SHALL BE CONTROLLED TO HELP PREVENT
- DURING CONSTRUCTION, AREAS THAT HAVE BEEN SEEDED AND MULCHED SHALL AT A MINIMUM BE INSPECTED WEEKLY AND WITHIN 24 HOURS AFTER EVERY PRECIPITATION EVENT THAT PRODUCES 1/2 INCH OF RAIN OR MORE DURING A 24 HOUR PERIOD. INSPECT WEEKLY DURING THE GROWING SEASON UNTIL VEGETATION IS DENSELY ESTABLISHED OR THE SOD IS LAID. REPAIR AND RESEED AREAS THAT HAVE EROSION DAMAGE AS NECESSARY.
- J. CONTRACTOR IS TO LIMIT VEHICLE TRAFFIC AND OTHER FORMS OF COMPACTION IN AREAS THAT ARE SEEDED AS MUCH AS POSSIBLE. RE-SEED DRIVEN OVER AREAS AS NEEDED.
- K. MULCH SHOULD BE PLACED WITHIN 24 HOURS OF SEEDING.
- MULCHING OPERATIONS SHALL NOT TAKE PLACE DURING PERIODS OF EXCESSIVELY HIGH WINDS THAT WOULD PRECLUDE THE PROPER PLACEMENT
- M. MULCH THAT IS DISPLACED SHALL BE REAPPLIED AND PROPERLY ANCHORED. MAINTENANCE SHALL BE COMPLETED AS SOON AS POSSIBLE WITH CONSIDERATION TO SITE CONDITIONS.
- N. WHEN CHANNEL EROSION MAT IS USED WITHIN CONSTRUCTION SITE DIVERSION AREAS, TECHNICAL STANDARDS 1053 AND 1066 SHALL BE
- WHEN NON-CHANNEL EROSION MAT IS USED TECHNICAL STANDARD 1052
- P. DEPENDING ON DURATION OF CONSTRUCTION, THE CONTRACTOR MAY NEED TO RE-SEED AND RE-STABILIZE THE TOPSOIL STOCKPILE AS NECESSARY TO
- 6. A COPY OF EROSION CONTROL INSPECTION REPORTS AND THE APPROVED EROSION CONTROL PLANS SHALL BE KEPT ON SITE.
- 7. CONTRACTOR SHALL MAINTAIN ALL EROSION CONTROL PRACTICES BY THE END
- 8. LOCAL ROADS SHALL BE CLEAN BY THE END OF EACH WORKDAY. CONTRACTOR SHALL HAVE LOCAL ROADS SWEPT WHERE SEDIMENT ACCUMULATES.

TO FACILITATE CONSTRUCTION AT THE PROJECT SITE, DEWATERING MAY TAKE PLACE BY THE SELECTED CONTRACTOR. CONTRACTOR TO FOLLOW THESE INSTRUCTIONS WHILE PERFORMING DEWATERING ACTIVITIES ON-SITE.

DISCOURAGE SEDIMENT AND EROSION.

- KARST FEATURES OR WELL DEWATERING SYSTEMS. CONTRACTOR SHALL COORDINATE ACCORDINGLY FOR OTHER DEWATERING ACTIVITIES AS DEEMED NECESSARY WITH THE WDNR. THE CONTRACTOR SHALL ENSURE THAT THE DEWATERING PRACTICES CARRIED OUT MEET OR EXCEED
- 2. A PAN OR OTHER CONTAINMENT DEVICE SHALL BE PLACED UNDERNEATH THE PUMP TO CAPTURE ANY SPILLS. OILS, GASOLINE, ETC. SHALL NOT BE STORED WITHIN WETLANDS, NEAR THE STORMWATER POND, OR OTHER ON-SITE WATER AREAS.
- COMBINATION WITH THE DEWATERING BAG IF THE DEWATERING BAG IS NOT DOING AN ADEQUATE JOB ALONE OF FILTERING SEDIMENTS. THE CONTRACTOR SHALL SUPPLY TOXICITY TESTING DATA TO THE WDNR BEFORE USE ON-SITE FOR WDNR APPROVAL. POLYMER SHALL NOT BE DIRECTLY APPLIED TO SURFACE WATER. CONTRACTOR SHALL OBTAIN THE POLYMER MATERIAL SAFETY DATA SHEETS (MSDS) FOR THE SELECTED POLYMER, MANUFACTURER'S INFORMATION AND WDNR USE RESTRICTIONS (SEE NOT EXCEED THE WDNR USE RESTRICTION, EVEN IF THIS IS THE RECOMMENDED RATE BY THE
- 5. A TARP MAY BE UTILIZED UNDERNEATH THE TYPE 2 GEOTEXTILE BAG AND JUST DOWN SLOPE OF THE BAG TO DISCOURAGE EROSION AND SCOUR.
- AREA WITH STANDING WATER TO AVOID SUCKING SEDIMENT FROM GRADE. 7. IF TURBID WATER IS LEAVING THE GEOTEXTILE BAG, THE CONTRACTOR SHALL SHUT OFF THE PUMP TO ALLOW SEDIMENTS TO SETTLE INTO THE BAG. CONTRACTOR SHALL FOLLOW THE MANUFACTURER'S SPECIFICATIONS FOR DETERMINING THE SEDIMENT CAPACITY OF THE GEOTEXTILE BAG USING GOOD
- A. DISCHARGE DURATION AND SPECIFIED PUMPING RATE.
- MAINTENANCE ACTIVITIES
- D. NAME AND QUANTITY OF POLYMER USED. PRODUCT TYPE

GEOTEXTILE BAG IN A WASTE RECEPTACLE ONCE IT IS NO LONGER USED.

- E. APPLICATION RATE OF POLYMER IN POUNDS/ACRE FEET OF WATER.

- SHOULD BE KEPT IN THE CONTRACTOR'S MONITORING LOG AND MADE AVAILABLE UPON REQUEST.
- WDNR TECHNICAL STANDARD 1061 FOR DEWATERING -
- http://dnr.wi.gov/runoff/pdf/stormwater/techstds/erosion/Dewatering_1061.pdf
- http://dnr.wi.gov/runoff/pdf/stormwater/techstds/erosion/Dewatering_1061.pdf

INSPECT ALL EROSION CONTROL MEASURES PRIOR TO COMMENCING GRADING, GRUBBING OR OTHER LAND DISTURBING ACTIVITIES. EROSION CONTROL MEASURES MUST BE INSPECTED WEEKLY AND WITHIN 24 HOURS OF EVERY PRECIPITATION EVENT OF 0.50 INCH OR GREATER. IN ADDITION THE CONTRACTOR SHALL CONDUCT DAILY INSPECTIONS AND DOCUMENT CONDITIONS AND REPAIRS MADE, ALONG WITH DATE, TIME OF INSPECTION AND WEATHER CONDITIONS IN A DAILY LOG BOOK. THE DAILY LOG BOOK, WEEKLY , 0.50 INCH PRECIPITATION REPORTS, APPROVED PLANS WPDES PERMIT & CHAPTER 30 PERMIT SHALL BE KEPT IN AN ACCESSIBLE LOCATION, LIKE A MAILBOX, WITHIN THE STAGING AREA. AT ABSOLUTELY NO TIME MAY CONSTRUCTION EQUIPMENT, DEBRIS, FILL, ETC. BE PLACED WITHIN

WETLANDS, WATERWAYS OR FLOODPLAINS UNLESS IDENTIFIED IN THE PLANS & APPROVED BY DNR/


DEWATERING PLAN


- NOTE: THESE INSTRUCTIONS DO NOT APPLY TO WATER BEING DISCHARGED DIRECTLY TO GROUNDWATER OR
- WNDR TECHNICAL STANDARD NUMBER 1061.
- 3. A TYPE 2 GEOTEXTILE BAG THAT IS NO SMALLER THAN 100 SQUARE FEET; HAS A MAXIMUM APPARENT OPENING SIZE OF 0.212 mm; HAS A GRAB TENSILE STRENGTH OF 300 LBS; MULLEN BURST OF 580 PSI; PERMEABILITY OF 0.2 CM/SEC; FABRIC WEIGHT OF 12 OZ SHALL BE USED. THE GEOTEXTILE BAG AREA AND DOWNGRADE FLOW AREA SHALL CONSIST OF VEGETATED AND UNDISTURBED SOILS. 4. POLYMER APPROVED BY THE WDNR MEETING WDNR TECHNICAL STANDARD 1051 MAY BE USED IN
- TECHNICAL STANDARD 1051) AND KEEP ALL THIS INFORMATION ON-SITE. CONTRACTOR SHALL ADHERE TO MANUFACTURER AND WDNR'S APPLICATION RATES FOR THE POLYMER. THE APPLICATION RATE SHALL MANUFACTURER. THE CONTRACTOR SHALL TAKE STEPS TO ENSURE THAT THE POLYMER IS NOT SPILLED. THE MANUFACTURER'S RECOMMENDED CLEANUP PROCEDURES SHALL BE FOLLOWED IN THE EVENT OF A
- 6. A FLOATING SUCTION HOSE OR OTHER FLOTATION METHOD SHALL BE UTILIZED WHEN PUMPING FROM AN COMMON SENSE. SEDIMENT LEVELS CONTAINED IN THE BAG SHALL BE MONITORED TO MEASURE THE
- 8. DURING DEWATERING ACTIVITIES THE CONTRACTOR SHALL MONITOR DEWATERING PRACTICES AND KEEP A LOG OF THE FOLLOWING:

LOSS OF STORAGE CAPACITY OVER TIME. THE CONTRACTOR SHALL PROPERLY DISPOSE OF THE

- B. OBSERVED WATER TABLE AT TIME OF DEWATERING.

- F. DATE AND TIME APPLIED.
- G. WEATHER CONDITIONS DURING APPLICATION.
- H. METHOD OF APPLICATION.
- THIS LOG NEEDS TO BE KEPT ON SITE FOR WDNR REGULATORY REVIEW. COPIES OF THIS DOCUMENTATION REVIEW THE FOLLOWING FOR MORE INFORMATION:
- WDNR TECHNICAL STANDARD 1051 FOR POLYMER -

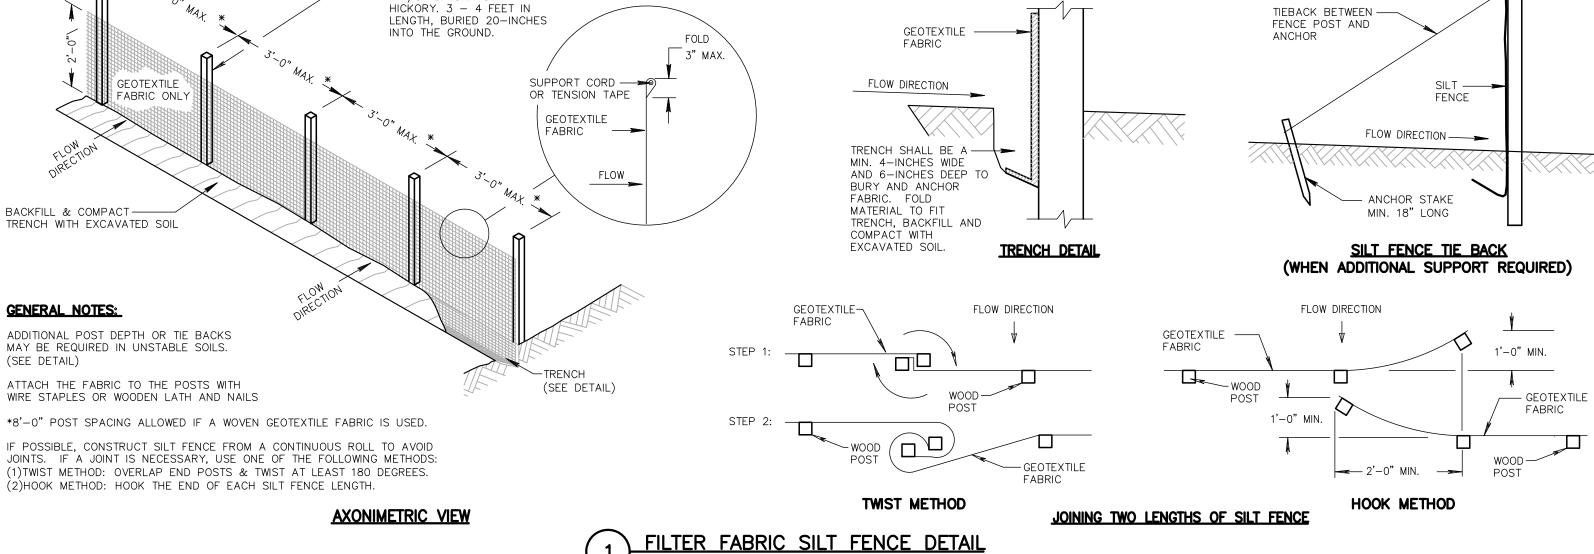

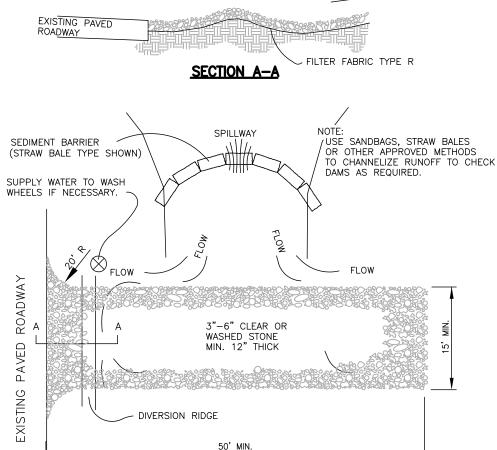

PLAN VIEW

WOOD POSTS SHALL BE A

MINIMUM SIZE OF 1 1/8" X 1 1/8" OF OAK OR

GENERAL NOTES:


THE AGGREGATE SIZE FOR CONSTRUCTION OF THE PAD SHALL BE 3- TO 6-INCH STONE. PLACE THE GRAVEL TO THE SPECIFIC GRADE & DIMENSIONS SHOWN ON THE PLANS & GRADE TO CREATE A SMOOTH SURFACE. THE THICKNESS OF THE PAD SHALL NOT BE LESS THAN 12 INCHES. USE GEOTEXTILE FABRICS, IF NECESSARY TO IMPROVE STABILITY OF THE FOUNDATION IN LOCATIONS SUBJECT TO SEEPAGE OR HIGH WATER

THE WIDTH OF THE PAD SHALL NOT BE LESS THAN THE FULL WIDTH OF ALL POINTS OF INGRESS OR EGRESS & IN ANY CASE SHALL NOT BE LESS THAN 15 FEET WIDE. THE LENGTH OF THE PAD SHALL BE AS REQUIRED, BUT NOT LESS THAN 50 FEET LOCATE CONSTRUCTION ENTRANCES & EXITS TO LIMIT SEDIMENT LEAVING THE SITE & TO PROVIDE FOR MAXIMUM UTILITY BY ALL CONSTRUCTION VEHICLES. AVOID ENTRANCES WHICH HAVE STEEP GRADES & ENTRANCES AT CURVES IN PUBLIC ROADS. THE ENTRANCE SHALL BE MAINTAINED IN A CONDITION THAT WILL PREVENT TRACKING OR FLOWING OF SEDIMENT PERIODIC TOP DRESSING WITH ADDITIONAL STONE AS CONDITIONS DEMAND, & REPAIR AND/OR CLEANOUT OF ANY MEASURES USED TO TRAP SEDIMENT. ALL SEDIMENT SPILLED, DROPPED, WASHED OR TRACKED ONTO PUBLIC RIGHTS-OF-WAY SHALL BE REMOVED PROVIDE DRAINAGE TO CARRY WATER TO A SEDIMENT TRAP OR OTHER SUITABLE OULET WHEN NECESSARY, WHEELS SHALL BE CLEANED TO REMOVE SEDIMENT PRIOR TO ENTRANCE ONTO PUBLIC RIGHTS-OF-WAY. WHEN WASHING IS REQUIRED. DESIGNATE AN AREA WITH CRUSHED STONE THA DRAINS INTO AN APPROVED SEDIMENT TRAP OR

- INLET SPECIFICATIONS AS PER THE PLAN

DIMENSION LENGTH AND WIDTH TO MATCH

STONE TRACKING CONSTRUCTION ENTRANCE

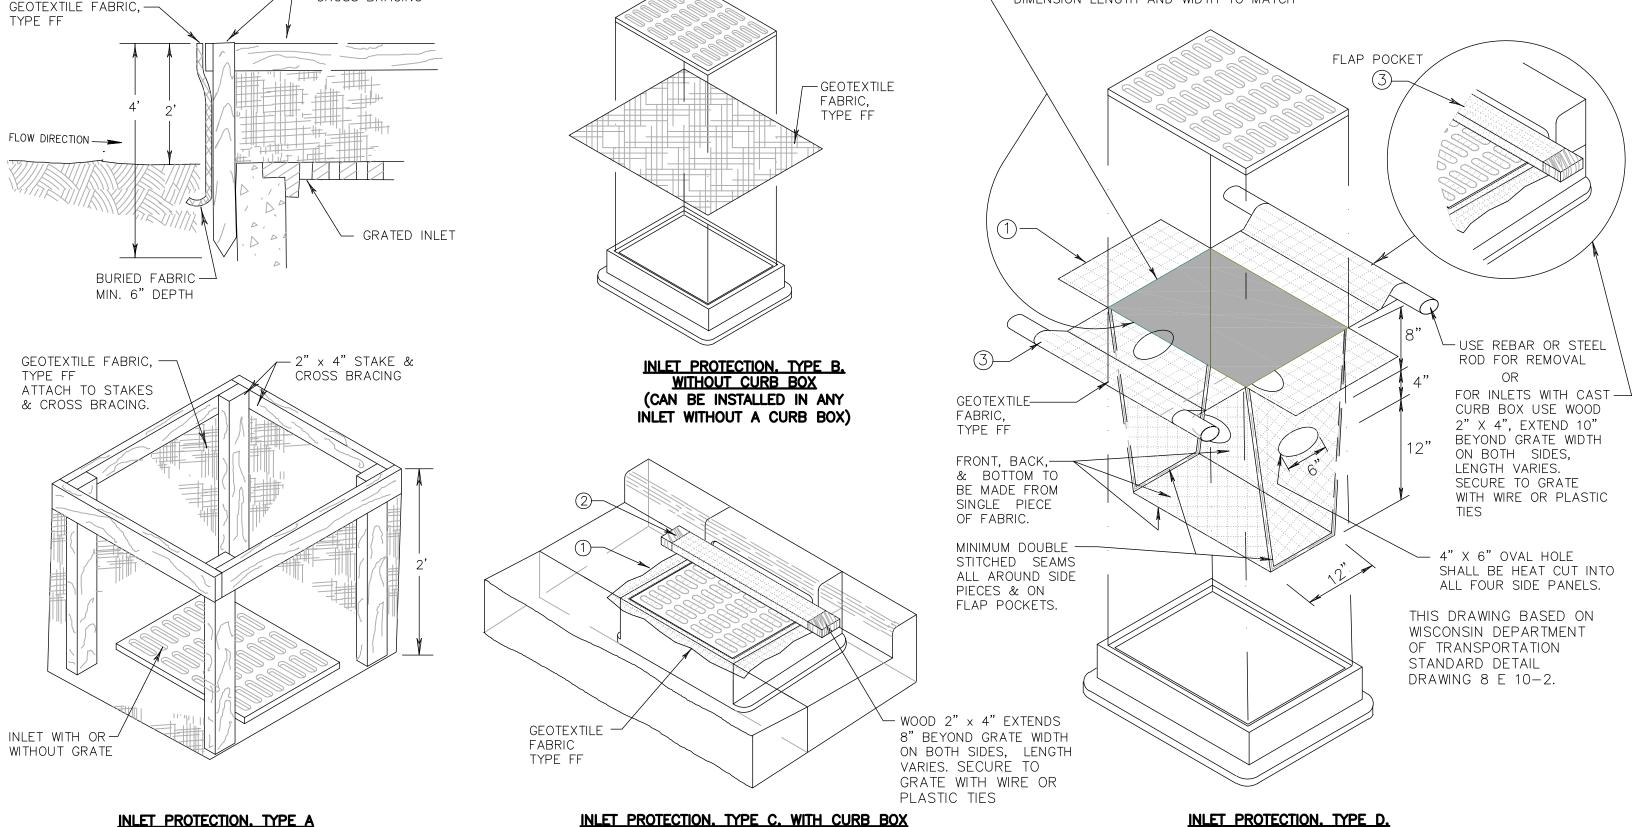

INLET PROTECTION, TYPE

GENERAL NOTES

MANUFACTURED ALTERNATIVES APPROVED AND LISTED ON THE DEPARTMENT'S EROSION CONTROL PRODUCT ACCEPTABILITY LIST MAY BE WHEN REMOVING OR MAINTAINING INLET PROTECTION, CARE SHALL BE TAKEN SO THAT THE SEDIMENT TRAPPED ON THE GEOTEXTILE FABRIC DOES NOT FALL INTO THE INLET. ANY MATERIAL FALLING INTO THE INLET SHALL BE REMOVED IMMEDIATELY.

- FINISHED SIZE, INCLUDING FLAP POCKETS WHERE REQUIRED, SHALL EXTEND A MINIMUM OF 10" AROUND THE PERIMETER TO FACILITATE FOR INLET PROTECTION, TYPE C (WITH CURB BOX), AN ADDITIONAL 18" OF FABRIC IS WRAPPED AROUND THE WOOD AND SECURED WITH STAPLES. THE WOOD SHALL NOT BLOCK THE ENTIRE HEIGHT OF THE CURB BOX OPENING.
- FLAP POCKETS SHALL BE LARGE ENOUGH TO ACCEPT WOOD 2X4.

 τ 2" x 4" STAKE AND

CROSS BRACING

TYPE B & C TRIM EXCESS FABRIC IN THE FLOW LINE TO WITHIN 3" OF THE GRATE. THE CONTRACTOR SHALL DEMONSTRATE A METHOD OF MAINTENANCE, USING A SEWN FLAP, HAND HOLDS OR OTHER METHOD TO PREVENT ACCUMULATED SEDIMENT FROM ENTERING THE

TYPE D DO NOT INSTALL INLET PROTECTION TYPE D IN INLETS SHALLOWER THAN 30", MEASURED FROM THE BOTTOM OF THE INLET TO THE TOP OF THE GRATE. TRIM EXCESS FABRIC IN THE FLOW LINE TO WITHIN 3" OF THE GRATE. THE INSTALLED BAG SHALL HAVE A MINIMUM SIDE CLEARANCE, BETWEEN THE INLET WALLS AND THE BAG, MEASURED AT THE BOTTOM OF THE OVERFLOW HOLES, OF 3". WHERE NECESSARY THE CONTRACTOR SHALL CINCH THE BAG, USING PLASTIC ZIP TIES, TO ACHIEVE THE 3" CLEARANCE. THE TIES SHALL BE PLACED AT A MAXIMUM OF 4" FROM THE BOTTOM OF THE BAG.

(CAN BE INSTALLED IN ANY INLET TYPE, WITH OR

WITHOUT A CURB BOX)



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www.kapurengineers.com

LYNDE AND HARRY BRADLEY FOUNDATION PARKING


1241 NORTH FRANKLIN PLACE MILWAUKEE, WI 53202

SITE DETAILS

SHEET

MAY 11, 2016

PROJECT NO. 16-109

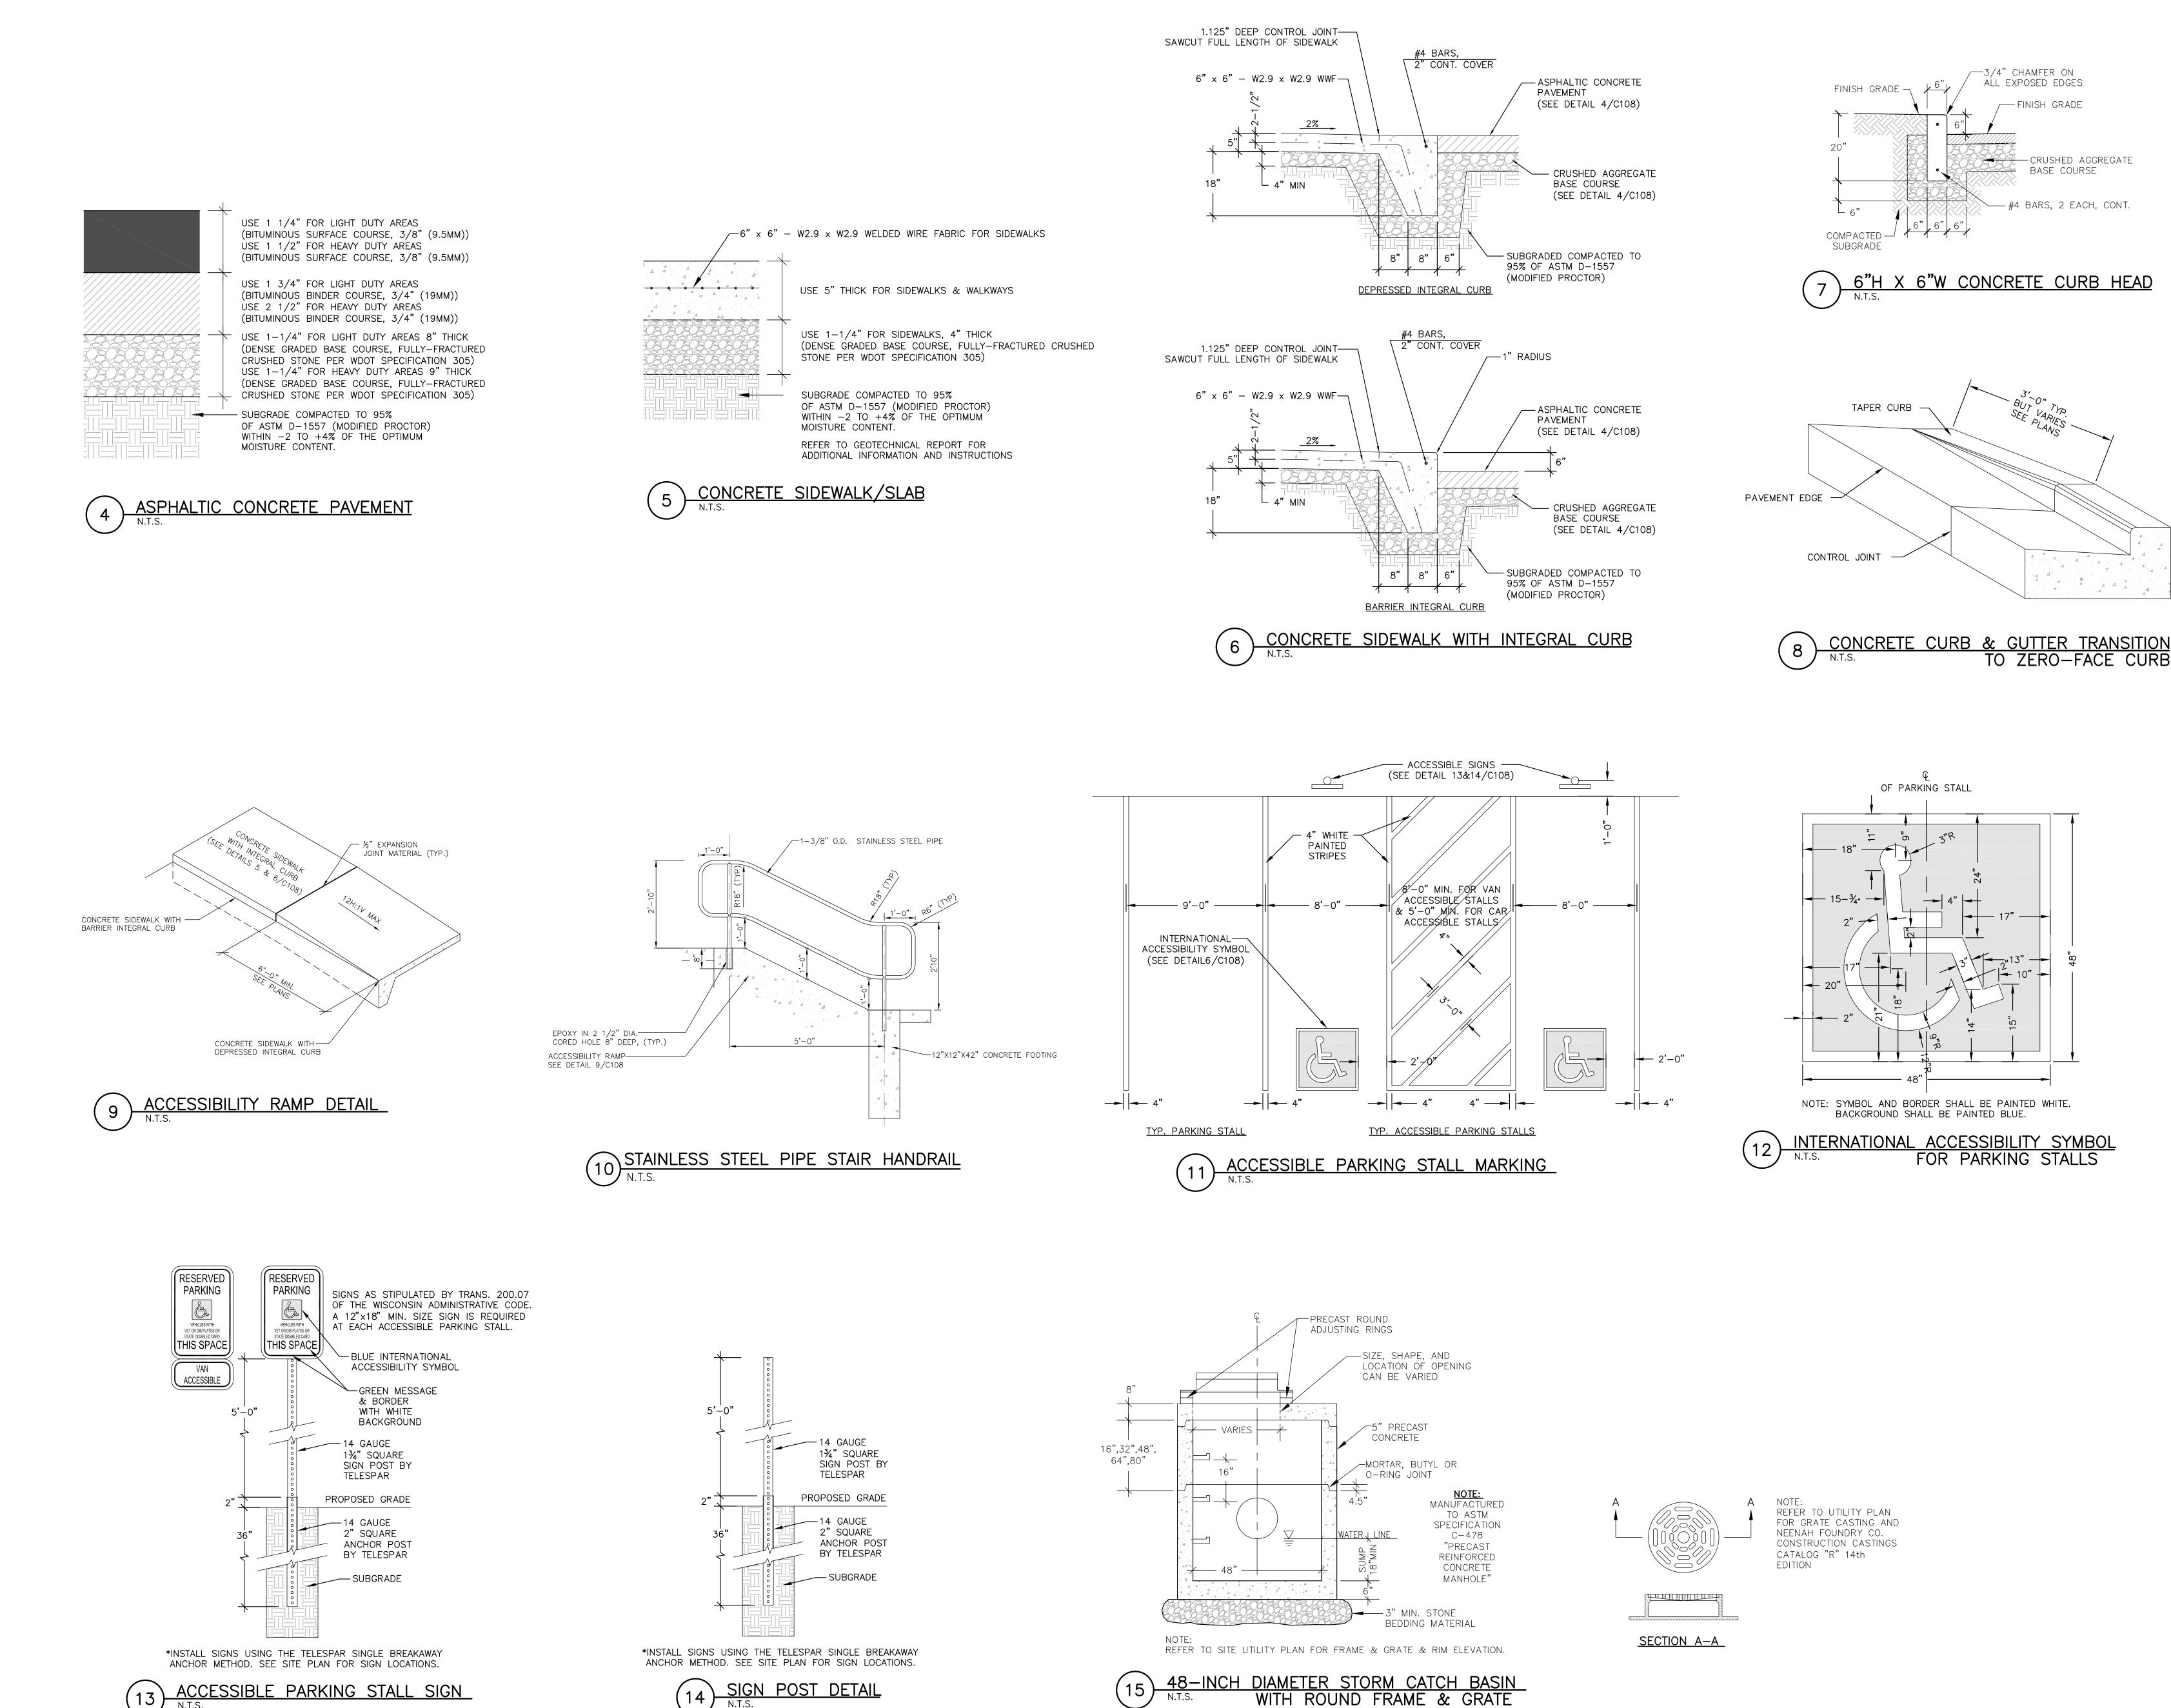

SIGN POST DETAIL



322 East Michigan Street Milwaukee, WI 53202

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KAPUR & ASSOCIATES, INC. CONSULTING ENGINEERS 7711 N. PORT WASHINGTON ROAD MILWAUKEE, WISCONSIN 53217 Phone: 414.351.6668 Fax: 414.351.4117

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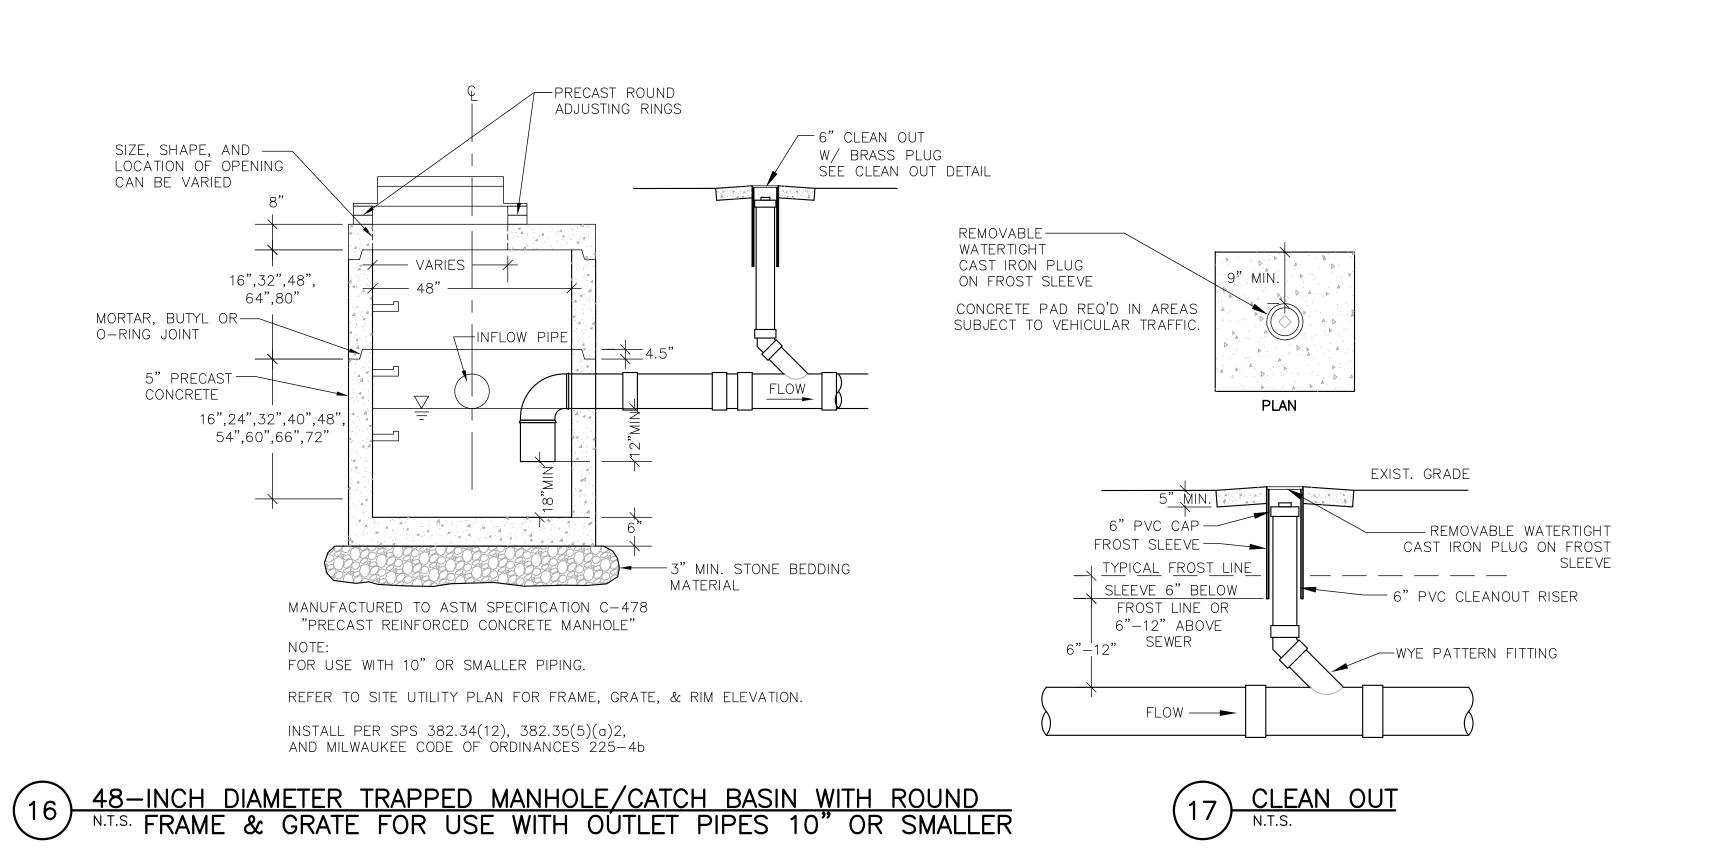
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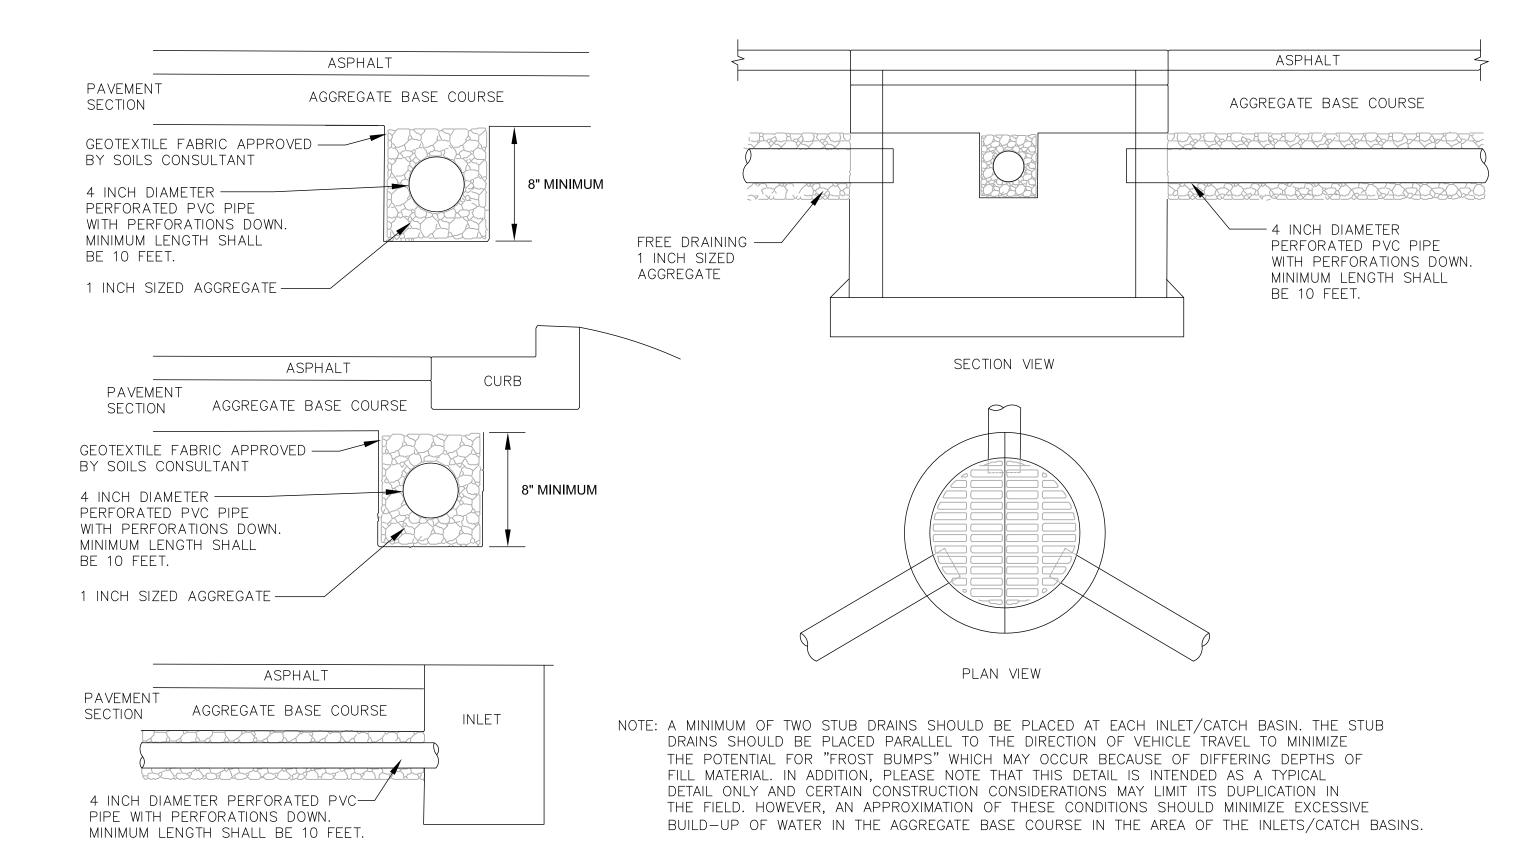
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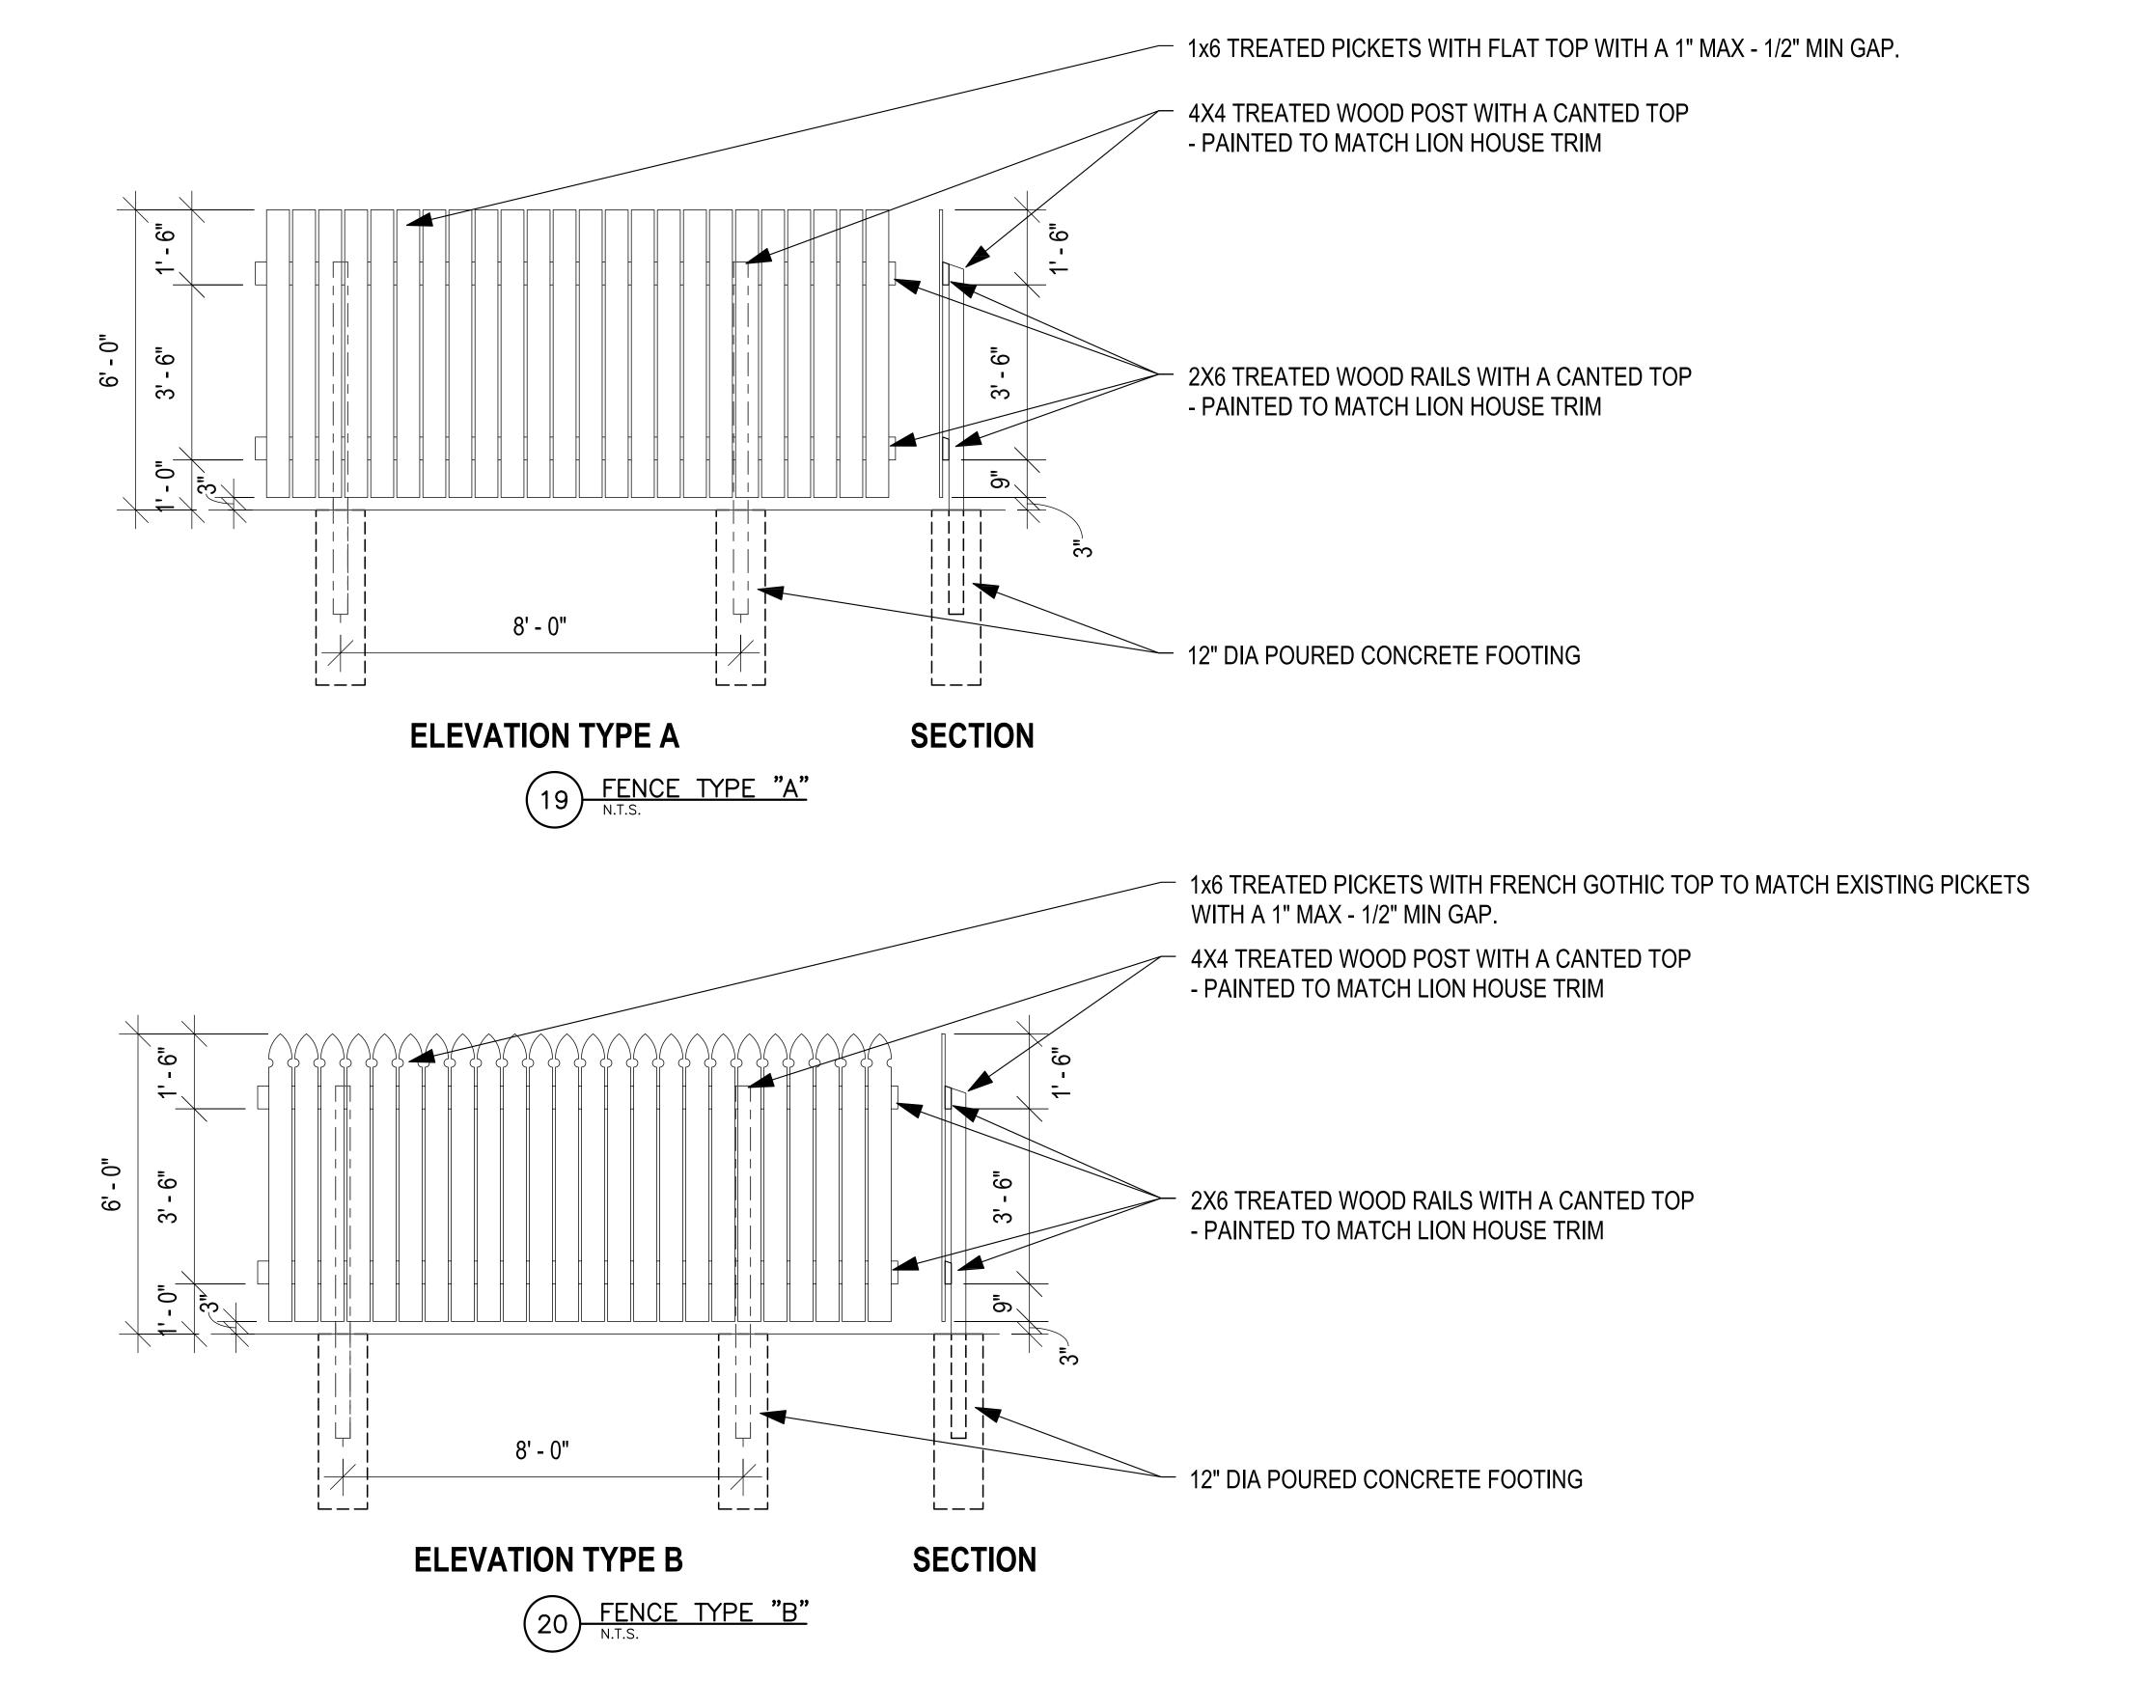
DATE MAY 11, 2016


PROJECT NO. 16-109





(18) PAVEMENT DRAINTILE SUBDRAINAGE SYSTEM
N.T.S.



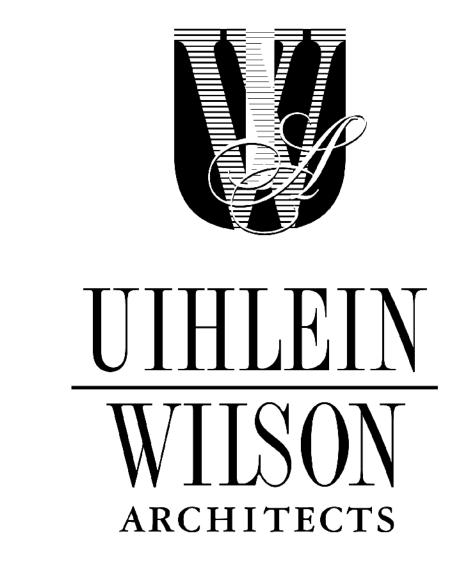

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LYNDE AND HARRY BRADLEY FOUNDATION PARKING

1241 NORTH FRANKLIN PLACE MILWAUKEE, WI 53202

SHEET

SITE DETAILS

DATE
MAY 11, 2016

PROJECT NO. 16-109

SHEET NO.

C109

24" COMB. (RELAY) SEWER	Pla
EAST KNAPP STREET	Decid AE
S CONC. CURB WAR SERVICE WAS ARRESTED TO THE SERVICE TO THE SERV	SV Decid
6.0' GONC. WALK	Peren MS NOTE
PROJECT LIMITS	
	2. ————————————————————————————————————
GATE OF METAL FENCE	4. 5. 6.
PROJECT LIMITS 9) MSG	7.
(1)ABM (1)GB (1)ABM	9.
1-2" MISSISSIPPI RIVER STONE OR EQUIVALENT, 3-INCHES DEEP OVER WEED FABRIC WITH ALUMINUM EDGING ALONG FENCE AND WHERE NOT ABUTTING ASPHALT.	13. 14. 15. 3 STORY N
STATE OF THE STATE	BUILDIN #124' 17. (LION HO 18.
Ballon See	19.
ST ST ST	ST(P)
(2)GB 1-2" MISSISSIPPI RIVER STONE OR EQUIVALENT, 3-INCHES DEEP OVER WEED FABRIC WITH ALUMINUM EDGING ALONG FENCE AND WHERE NOT ABUTTING ASPHALT. (1)ABM RRICK WALLS	
(1) ABS OHW	
ASPHALT EDGE (2)SWO	
PROJECT LIMITS	3
PARCEL B Scale: 0 5 10 Scale: 1" = 10	20
PARCEL A DIGGERS III DIGGERS	
Dial Sill or (800)24 www.DiggersHotline	42-8511 e.com 5

	Scientific Name	Common Name	Quantity	Spacing	Install Size	Size
						Maturity in ft. (Height/Spread)
eciduous	Trees					
ABM	Acer x freemanii 'Jeffersred'	Autumn Blaze Maple	2	Per Plan	2.5" caliper B&B	40-50'/40'
ABS	Amelanchier x grandiflora 'Autumn Brillance'	Autumn Brillance Serviceberry: multi-stem	1	Per Plan	6' tall B&B	20-25'/15-20'
GB	Ginkgo biloba	Ginkgo Tree: MALE ONLY	3	Per Plan	2.5" caliper B&B	50-80'/40'
SWO	Quercus bicolor	Swamp White Oak	2	Per Plan	5" Caliper B&B	75'/65'
eciduous	s Shrubs					
DBH	Diervilla Ionicera	Dwarf Bush Honeysuckle	24	Per Plan	#2 cont.	3-4'/4-5'
erennials)					
MSG	Panicum virgatum 'Heavy Metal'	Heavy Metal Switch Grass	29	Per Plan	4.5" pot	


REFER TO SPECIFICATIONS FOR ADDITIONAL INFORMATION


- ALL PLANT MATERIAL SHALL BE OBTAINED FROM A NURSERY LOCATED IN ZONE 5, CONFORM TO APPLICABLE REQUIREMENTS OF THE CURRENT EDITION OF THE AMERICAN STANDARD FOR NURSERY STOCK, AND BOTANICAL NAMES SHALL BE ACCORDING TO THE CURRENT EDITION OF "STANDARDIZED PLANT NAMES PREPARED BY THE AMERICAN JOINT COMMITTEE ON HORTICULTURE NOMENCLATURE.
- CONTRACTOR TO PROVIDE TO THE LANDSCAPE ARCHITECT SAMPLES OF ALL BARK AND MINERAL/STONE MULCHES, DECORATIVE GRAVELS, MAINTENANCE STRIP STONE, OR OTHER GROUND COVER MATERIALS FOR APPROVAL PRIOR TO INSTALLATION.
- BARK MULCH TO BE FRESHLY ACQUIRED HARDWOOD SHREDDED BARK MULCH. NOT DOUBLE MILLED, EXCESSIVE DIRT AND DUST LIKE MATERIAL OR OLD MATERIAL IS NOT ACCEPTABLE.
- ALL PLANTING AREAS TO RECEIVE A 3-INCH THICK LAYER OF MISSISSIPPI RIVER STONE OR EQUIVALENT OVER TYPAR WEED FABRIC WITH EDGING. EDGING TO BE INSTALLED BETWEEN DIFFERENT TYPES OF MULCHES, BETWEEN MULCHES AND TURF, AND/OR WHERE SPECIFICALLY NOTED ON THE PLAN. REFER TO SPECIFICATION 32 93 00 PLANTS FOR ADDITIONAL INFORMATION.
- INSTALL SHOVEL CUT EDGE AROUND ALL INDIVIDUAL TREES AND SHRUBS IN LAWN AREAS AND ALONG PAVEMENT WHERE PLANTING AREAS ABUT TO PREVENT HARDWOOD SHREDDED BARK MULCH FROM SPILLING OUT OF PLANTING AREA.
- CONTRACTOR RESPONSIBLE FOR MAINTENANCE OF PLANT MATERIAL FOR 90 DAYS FROM INSTALLATION, INCLUDING WATERING, WEEDING, ETC. CONTRACTOR IS RESPONSIBLE FOR MAINTENANCE OF SEEDED AREAS FOR 60 DAYS FROM INSTALLATION, INCLUDING WATERING, WEEDING, ETC. CONTRACTOR TO PROVIDE AND REVIEW MAINTENANCE INSTRUCTIONS WITH THE OWNER PRIOR TO THE COMPLETION OF THESE MAINTENANCE PERIODS. REFER TO SPECIFICATIONS FOR ADDITIONAL REQUIREMENTS.
- CLEANLY PRUNE AND REMOVE DAMAGED BRANCHES, DEAD WOOD, AND ROOTS IMMEDIATELY PRIOR TO PLANTING. DO NOT CUT LEADERS OR LEAVE "V" CROTCHES OR DOUBLE LEADERS UNLESS A MULTI-STEM TREE IS SPECIFIED.
- REMOVE BURLAP, WIRE BASKET, ROPE, TWINE, AND ALL SYNTHETIC MATERIAL FROM THE ROOTS, TRUNK, OR CROWN OF PLANT.

LANDSCAPE EDGING TO BE ALUMINUM EDGING. REFER TO SPECIFICATION 32 93 00 PLANTS FOR ADDITIONAL INFORMATION.


- 10. REMOVE EXCESS SOIL ABOVE ROOT COLLAR.
- 1. PLANT TREES AND SHRUBS SO THAT THE ROOT COLLAR IS 2" ABOVE FINISHED GRADE OR SEVERAL INCHES ABOVE GRADE IF PLANT IS INSTALLED IN POOR SOILS.
- 12. PLANT TREES AND SHRUBS WITH SAME ORIENTATION AS WHEN HARVESTED FROM THE NURSERY OR TO SHOWCASE THE MOST AESTHETIC VIEW.
- 13. PLANT ALL TREES WITH THREE SLOW RELEASE FERTILIZER PACKETS, SPACED EQUIDISTANT AROUND THE EDGE OF THE ROOT BALL.
- 14. PLANT ALL SHRUBS WITH ONE SLOW RELEASE FERTILIZER PACKET, PLACED BELOW THE ROOTING SYSTEM.
- 15. WATER AND TAMP BACKFILL AND ROOTS OF ALL NEWLY SET PLANT MATERIAL SO THE SOIL AND ROOTS ARE THOROUGHLY SOAKED AND AIR POCKETS ARE REMOVED.
- 16. FOR INDIVIDUAL TREES & SHRUBS PLANTED IN TURF AREAS, PROVIDE CONTINUOUS 3" SOIL SAUCER TO CONTAIN WATER & MULCH (TREES ON SLOPES SHALL BE SAUCERED ON THE DOWNHILL
- 17. INSTALL 3" THICK SHREDDED HARDWOOD BARK MULCH RING 3'-0" DIA. FOR DECIDUOUS TREES AND ALL INDIVIDUAL SHRUBS IN LAWN AREAS, 5'-0" DIA. FOR EVERGREEN TREES. KEEP MULCH 2" AWAY FROM TRUNKS.
- 18. STAKING ONLY STAKE EVERGREEN TREES 5'-0" OR GREATER IN HEIGHT OR TREES THAT ARE UNABLE TO REMAIN UPRIGHT AFTER PLANTING. TREES WILL BECOME STRONGER FASTER WHEN THE TOP 2/3 OF THE TREE IS FREE TO SWAY. DO NOT ATTACH WIRE DIRECTLY TO TREES OR THROUGH HOSES — UTILIZE GROMMETED, SYNTHETIC STRAPS AT LEAST 2" WIDE AROUND THE TREE, ATTACH STRAPPING TO STAKE WITH WIRE. STAKE ONLY WHEN NECESSARY. STAKES SHOULD BE DRIVEN DEEPLY INTO THE GROUND TO PREVENT DISLODGING. CHECK AT LEAST EVERY THREE MONTHS FOR BINDING OR OTHER PROBLEMS. STAKES AND TIES SHOULD BE REMOVED SIX MONTHS TO ONE YEAR AFTER PLANTING.
- 19. REFER TO SPECIFICATIONS 32 93 00 PLANTS AND 32 92 00 TURF AND GRASSES FOR ADDITIONAL INFORMATION.

REFER TO SPECIFICATIONS FOR ADDITIONAL INFORMATION

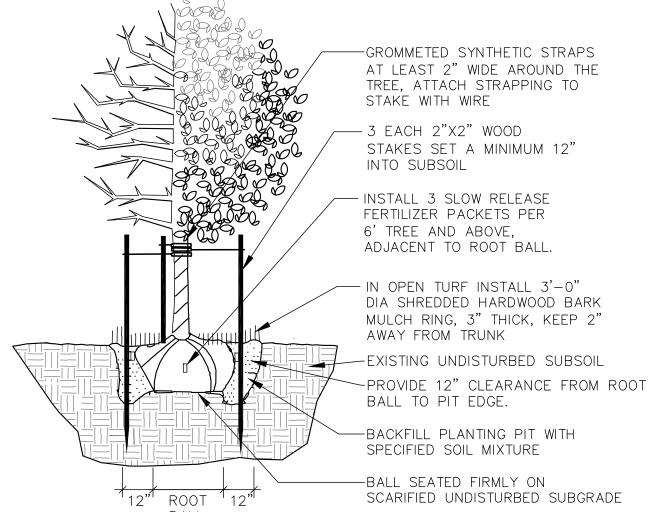

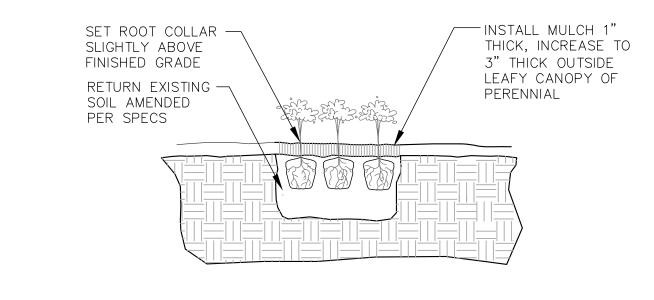

DECIDUOUS TREE PLANTING & STAKING

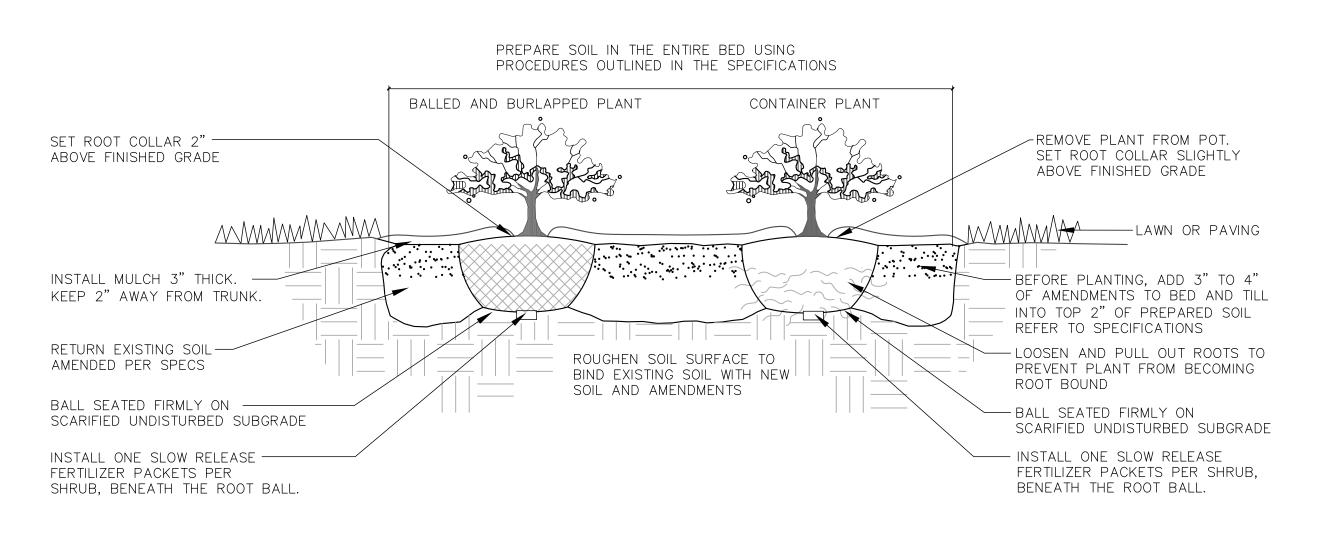

DECIDUOUS & EVERGREEN SHRUB PLANTING



ARCHITECTS

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PROJECT LYNDE AND HARRY BRADLEY FOUNDATION PARKING

1241 NORTH FRANKLIN PLACE MILWAUKEE, WI 53202

SHEET

SITE LANDSCAPE PLAN

DATE MAY 11, 2016

PROJECT NO.

16-109

			GHTING	FIX	KTU	RE SCH	EDULE		,	H A R E N G C O N 255 North 21st Street Ath 414,475,5554 414,773,9299	. W O O D I N E E R I N G S U L T A N T S waukse Wisconsin 53233 tox harwoodshieci.com	
DES.	DESCRIPTION		LAMP DATA	VOLT	DEPTH		LIGHTING FIXTURE		BALLAST	MTG.	MTG.	SEE NOTE
DES.	DESCRIPTION	NO.	TYPE	VOLI	DEPIN	MFR.	SERIES	OPTIONS/ACCESSORIES	TYPE	MIG.	SURF	LF
OA	21.75"Lx15.5"Wx4"H LUMINAIRE ON 15'H SQ POLE/2'H AFG BASE TYPE II DIST MOTION SENSOR FOR DIM. OPER.	_	LED(INCLUDED) 5272 LUMENS 56 WATTS 4000K, 70CRI	UNV	_	McGRAW EDISON	GLEON/AE/01/LED /E1/T2/MS/DIM/ L20/FSIR-100 SERIES	03,18,26 DIMMING OPERATION	DDRV	SURF	CONC BASE	4
ОВ	21.75"Lx15.5"Wx4"H LUMINAIRE ON 15'H SQ POLE/3'H AFG BASE TYPE III DISTRIBUTION MOTION SENSOR FOR DIM. OPER.	_	LED(INCLUDED) 5374 LUMENS 56 WATTS 4000K, 70CRĮ	UNV	_	McGRAW EDISON	GLEON/AE/01/LED /E1/T3/MS/DIM/ L20/FSIR-100 SERIES	03,18,26 DIMMING OPERATION	DDRV	SURF	CONC BASE	4
OC	21.75"Lx15.5"Wx4"H LUMINAIRE ON 15'H SQ POLE/3'H AFG BASE TYPE V NARROW DISTRIBUTION MOTION SENSOR FOR DIM. OPER.		LED(INCLUDED) 5542 LUMENS 56 WATTS 4000K, 70CRI	UNV	_	McGRAW EDISON	GLEON/AE/01/LED /E1/5NQ/MS/DIM /L20/FSIR-100 SERIES	03,18,26 DIMMING OPERATION	DDRV	SURF	CONC BASE	4
OD	21.75"Lx15.5"Wx4"H LUMINAIRE ON 15'H SQ POLE/3'H AFG BASE 90DEG SPILL LIGHT ELIM. LEFT MOTION SENSOR FOR DIM. OPER.	_	LED(INCLUDED) 4722 LUMENS 56 WATTS 4000K, 70CRI	UNV	_	McGRAW EDISON	GLEON/AE/01/LED /E1/SLL/MS/DIM/ /L20/FSIR-100 SERIES	03,18,26 DIMMING OPERATION	DDRV	SURF	CONC BASE	4
AR CONC. E EXP	VIATIONS: AS REQUIRED BASE CONCRETE BASE ELECTRONIC EXPOSED STRUCTURE NS/ACCESSORIES CODE LISTING:	GF GY LA LI(P. GYPSUM BOAR S LENGTH AS SH		NA PS PENI REC	NOT APPLICABLE PULSE START BA D PENDANT RECESSED		SPECIAL LA STANTION DE	AS LEI RV LEI	D DRIVE	S SHOWN R ABLE DR	
01. (02. (03. (04. (05. (06. (07. (08. (09. (09. (09. (09. (09. (09. (09. (09	D.125" PATTERN 12 ACRYLIC LENS HOLOPHANE 8246 LENS PAINT AFTER FABRICATION SPRING LOADED LATCHES FLUSH ALUMINUM DOOR FRAME ELECTRONIC BALLAST, TOTAL HARMO DISTORTION ≤ 10% FLUORESCENT DIMMING BALLAST WHITE TRIM RING SEMI-DIFFUSE, LOW-IRIDESCENT CL ALZAK REFLECTOR	ONIC	11. 12. 13. 14. 15. 16. 17. 18.	PENDAN SAFETY NEMA H WIRE GI EMERGE TOP AN TIME DE WET LO DAMP L FURNISI	IOOK, CO JARD NCY BAL D BOTTO ELAY CATION I OCATION	T DRD AND PLUG LAST M LENSING ABEL CONSTRUCTION UNIVERSAL ARROWS	22. 23. 24. 25. 26. 27. 28.	QUARTZ RESTRIKE EMERGENCY OPERATION INTEGRAL NICAD BAT LOCKING TYPE SOCKET SLOPE ADAPTER TWO BALLAST COVERS STANDARD FINISH TO ARCHITECT 277/24 VOLT TRANSFOLEAD—CALCIUM BATTER INCLUDE SELF—DIAGNO	ITERY IS BE SELE ORMER RY	CTED B	Y	

LIGHTING FIXTURE NOTES:


NOTES LF1 - LF24 ARE GENERAL NOTES APPLICABLE TO ENTIRE LIGHTING FIXTURE SCHEDULE WHERE APPROPRIATE.

LF1 - PROVIDE ALL NECESSARY COMPONENTS AND ACCESSORIES FOR A COMPLETE OPERATING INSTALLATION PER APPLICABLE CODES AND MANUFACTURER'S RECOMMENDATIONS.

LF2 — CONTRACTOR SHALL REVIEW THE ENTIRE LIGHTING FIXTURE SCHEDULE INCLUDING THE DESCRIPTION AND CATALOG NUMBER. CONTRACTOR SHALL NOTIFY THE A/E OF ANY DISCREPANCIES PRIOR TO BIDDING.

LF3 - VERIFY ALL FINISHES/COLORS OF FIXTURES WITH A/E PRIOR TO ORDERING.

LF4 - REFER TO DETAIL 3/E101.

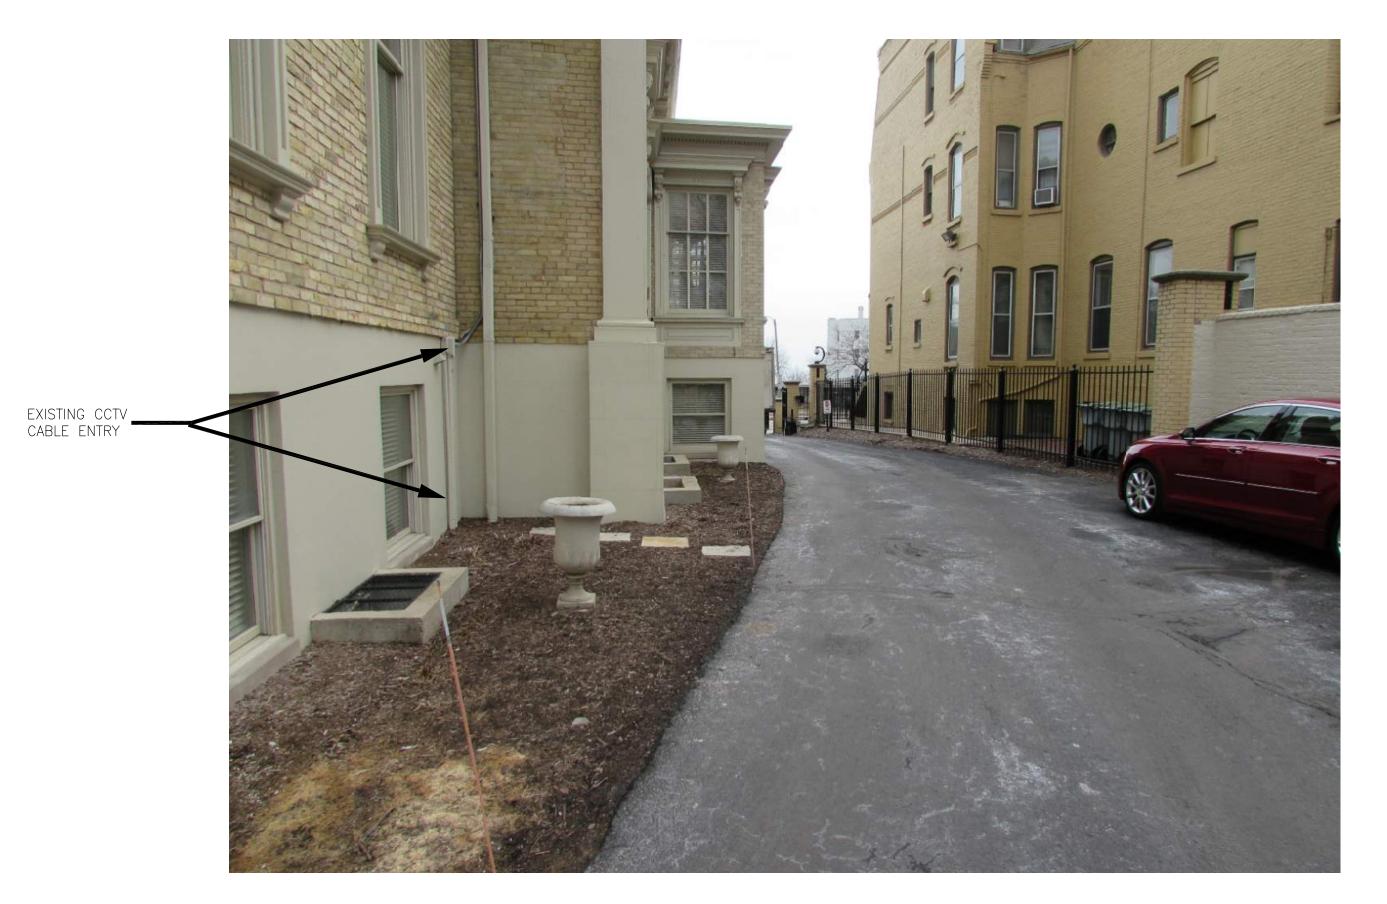

1 EXISTING CCTV CABLING
No Scale

Notes:

1. Possible entry location for new CCTV cabling.

2. Note basement ceiling is above grade level.

SYMBOLS LIST NOTE:

ANY SYMBOLS UTILIZED ON THE FLOOR PLANS NOT OTHERWISE ON THE SYMBOLS LIST SHALL BE BROUGHT TO THE ATTENTION OF THE ENGINEERS PRIOR TO BIDDING FOR CLARIFICATION.

POLE MOUNTED LIGHT FIXTURE — SIDE ARM

 ➡
 DUPLEX RECEPTACLE - WP, GFI

PULL BOX - 4"x4"X4" PVC

INDICATES DETAIL NUMBER

INDICATES SHEET NUMBER

SEE DETAIL

255 North 21st Street Milwaukee Wisconsin 53233 414.475.5554 414.773.9299 fax harwood@hecl.com

ENGINEERING

CONSULTANTS, LTD

ABBREVIATIONS:

A/E AF AFC AFF ARCH AFG AR AS B BKR BFG C CAB CB CCB CCD COMB CONC CP	ARCHITECT/ENGINEER AMP FUSE AVAILABLE FAULT CURRENT ABOVE FINISHED FLOOR ARCHITECT ABOVE FINAL GRADE AS REQUIRED AMP SWITCH JUNCTION BOX BREAKER BELOW FINAL GRADE MOUNTED 6" ABOVE COUNTER CABINET CIRCUIT BREAKER CANDELA CIRCUIT CEILING COMBINATION STARTER W/DISCONNECT SWITCH CONCRETE CONTROL PANEL	I IU KW LIG LOC LTG MAG MAN MC MCB MLO MSB MTD NU NIC O OC ORS OU P	MAIN CIRCUIT BREAKER MAIN LUGS ONLY MAIN SWITCHBOARD MOUNTED
DNLT EBC EWC E.C ELEV EMT ENT ER EXP EXR EX F	DOWN LIGHT ELECTRICAL BONDING CONDUCTOR ELECTRIC WATER COOLER ELECTRICAL CONTRACTOR ELEVATION ELECTRICAL METALLIC TUBING ELECTRICAL NON—METALLIC TUBING EXISTING TO BE REMOVED EXPOSED EXISTING IN NEW LOCATION EXISTING TO REMAIN FURNISHED FIXTURE	PNL PB R REC SS SURF SUSP SW TC TCC TGB TMGB	RECEPTACLE RECESSED SWITCH STATION SURFACE SUSPENDED SWITCH TEMECOMMUNICATION MOUNT GROUNDING BUSBAF TEMPERATURE CONTROL CONTRACTOR TELECOMMUNICATION GROUNDING BUSBAR
FLUOR G.C. GFI GRC GYP HOA HP HVAC	FLUORESCENT GENERAL CONTRACTOR GROUND FAULT INTERRUPTING GALVANIZED RIGID CONDUIT GYPSUM BOARD HAND-OFF-AUTO SELECTOR SWITCH HORSEPOWER HEATING, VENTILATING, AND AIR CONDITIONING CONTRACTOR HEAVYWALL	TBB TP TYP UM VER VFD W WP XFMR	TELECOMMUNICATION BONDING BACKBONE TAMPER PROOF TYPICAL UNIT MANUFACTURER VERIFY VARIABLE FREQUENCY DRIVE WIRED WEATHERPROOF TRANSFORMER

Sheet
SYMBOLS,
ABBREVIATIONS AND
NOTES



NORTH SCALE: NTS

Project
LYNDE AND HARRY
BRADLEY FOUNDATION
PARKING

SHEET INDEX

E001 SYMBOLS, ABBREVIATIONS, NOTES, SCHEDULES AND DETAILS
E101 SITE CALCULATION PLAN
E201 ELECTRICAL SITE PLAN


Date

MAY 11, 2016

Project No. 16-1077.00


Sheet No.

EAST KNAPP STREET

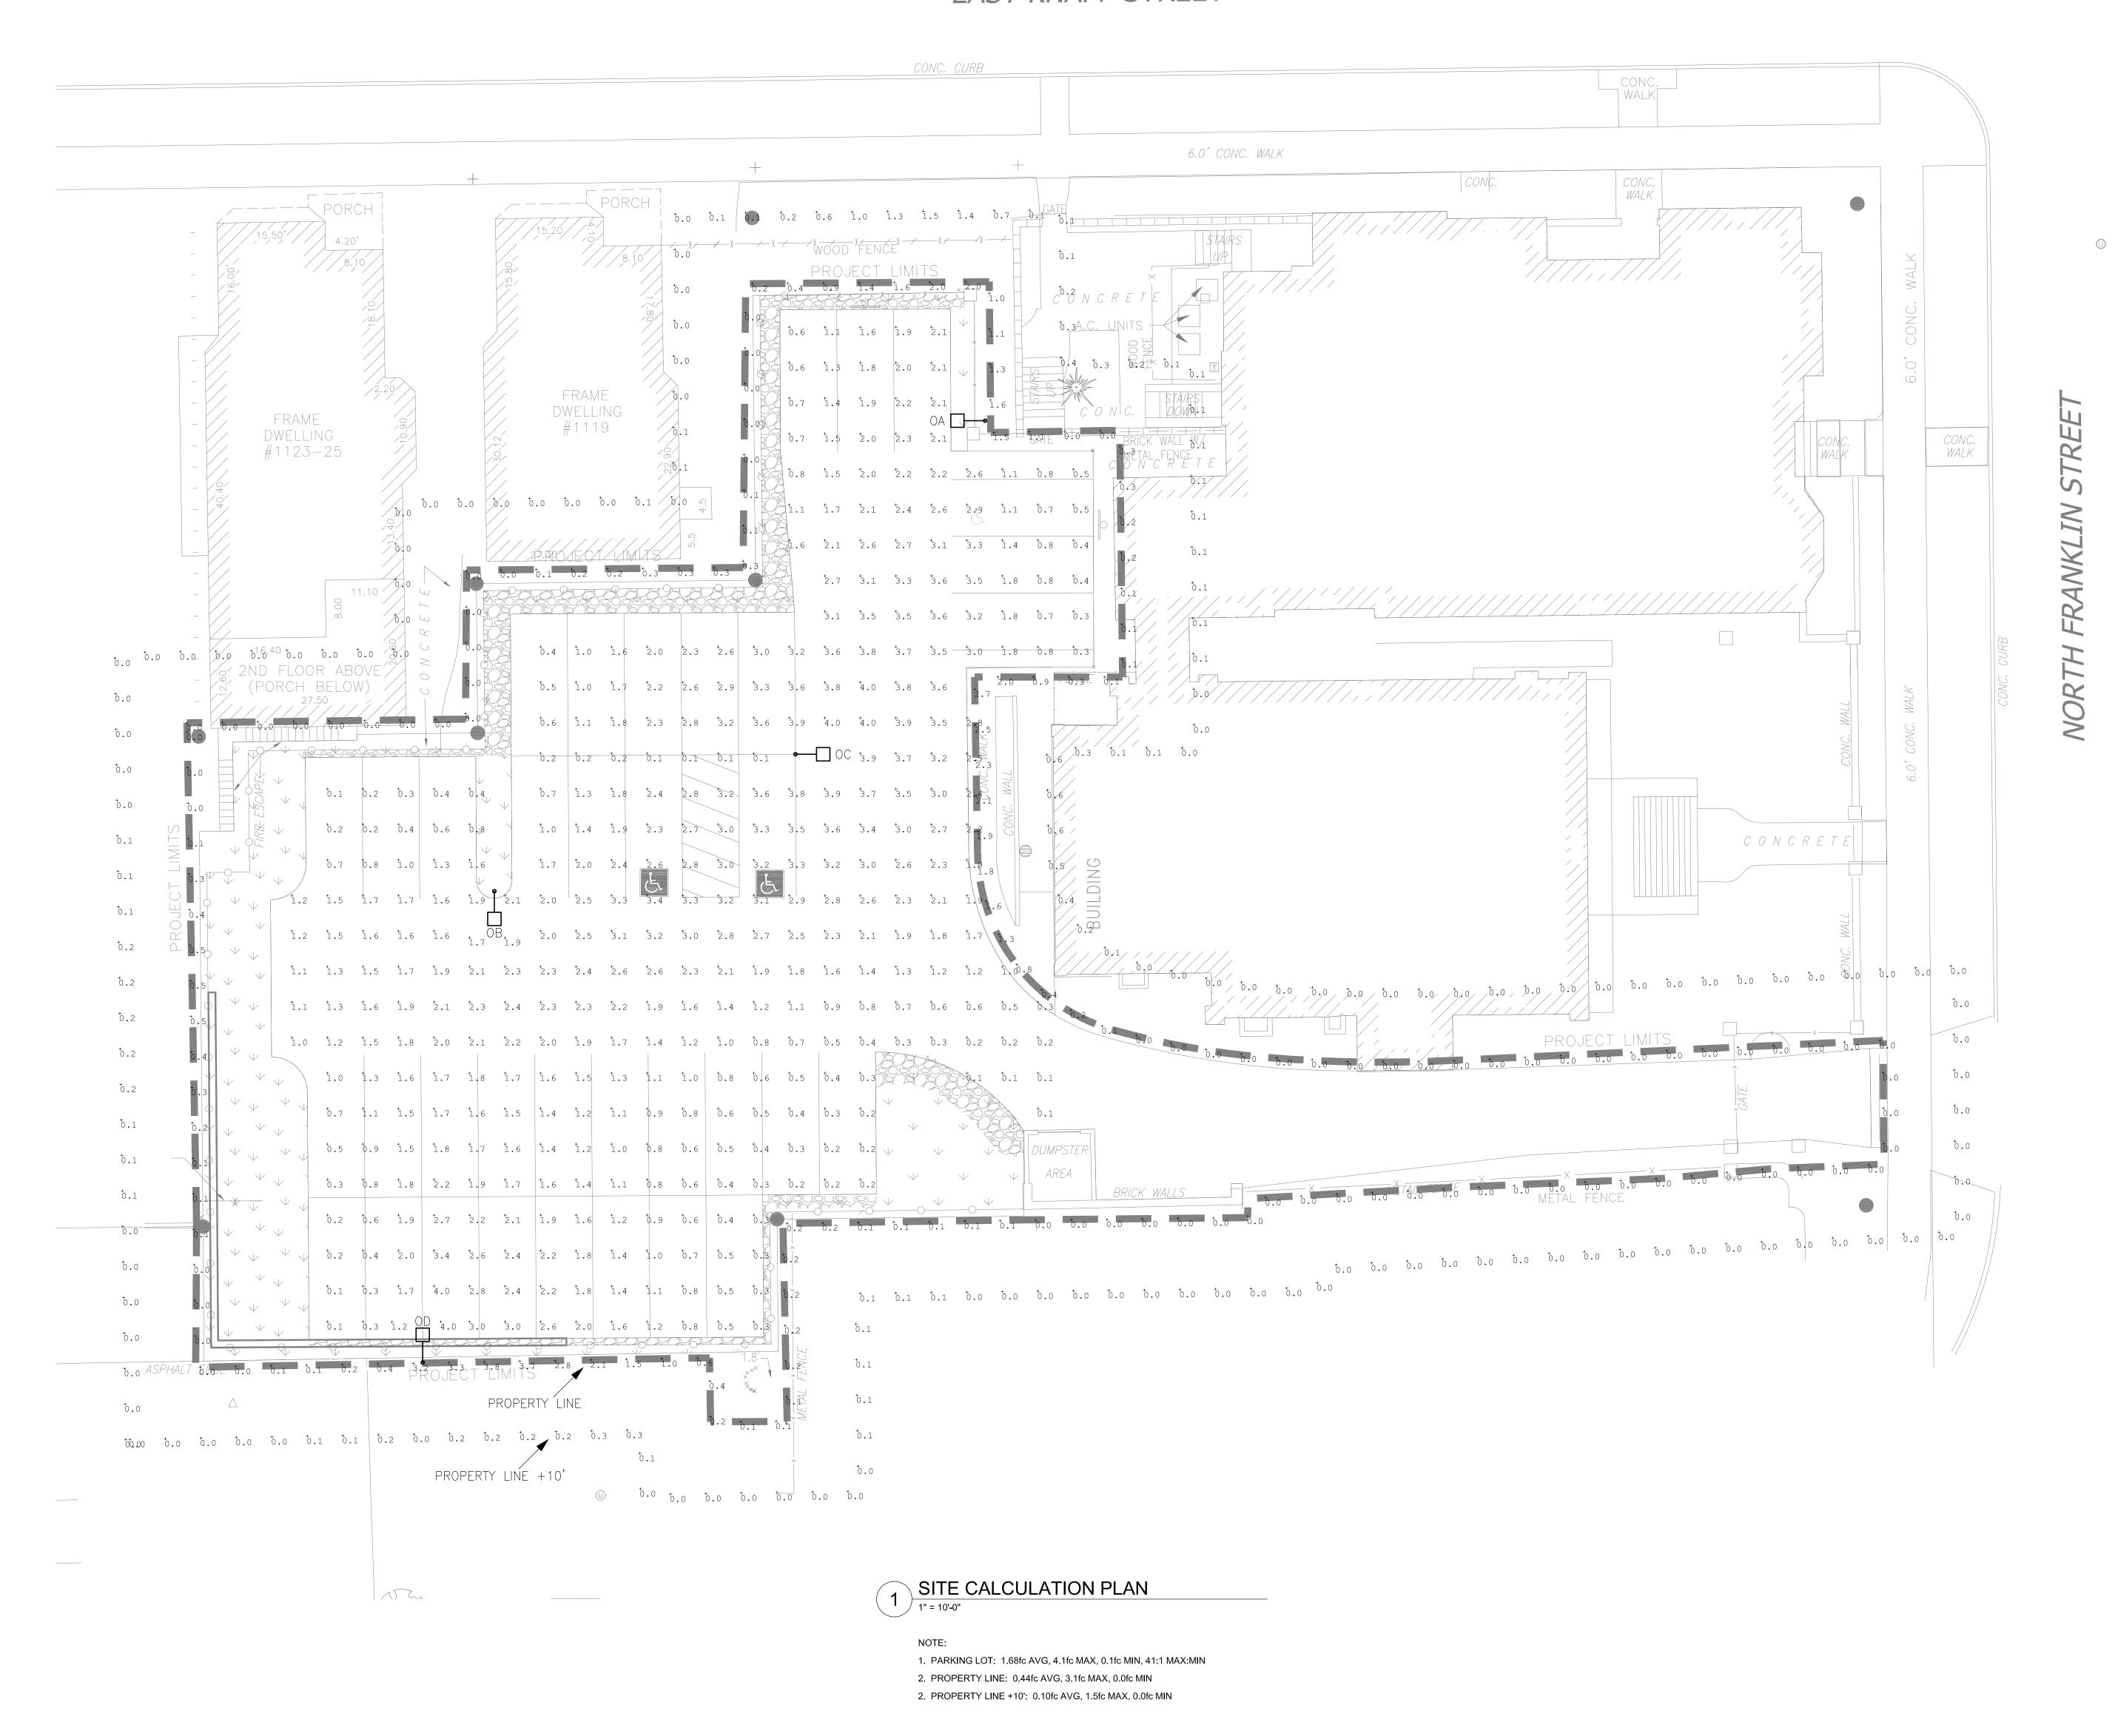



2 TYPE OA/OB/OC/OD POLE FIXTURES
NOT TO SCALE

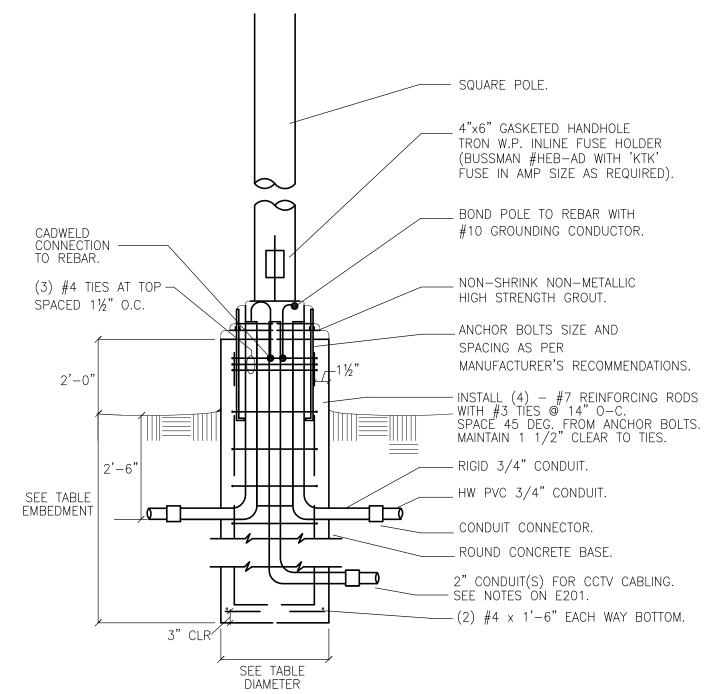

9 POLE BASE DETAIL NOT TO SCALE

NOTES:

1. DIMENSIONS GIVEN ARE MINIMUM. PROVIDE POLE BASE DIAMETER AND DEPTH AS REQUIRED IN ACCORDANCE WITH LOCAL SOIL AND WIND VELOCITY CONDITIONS.

2. ALL LIGHTING POLE CONCRETE BASES SHALL BE LOCATED A MINIMUM OF 12 INCHES OFF THE FACE OF THE CURBING EDGE OF SIDEWALK OR CENTERED WITHIN AN ISLAND. IN ALL CASES, HOWEVER, FINAL LOCATIONS OF LIGHTING POLES MUST BE VERIFIED WITH THE ARCHITECT/ENGINEER PRIOR TO INSTALLATION.


3. ALL POLE BASE DIMENSIONS ARE FOR BIDDING ONLY. POLE BASE SHALL MATCH THOSE AT EXISTING POLES, IF APPLICABLE.

POLE HEIGHT	B	BASE EMBEDMENT/DIAMETER					
TOLL TILIGITI	1 HEAD	2 HEAD	3 HEAD	4 HEAD			
15'-0"	6'-5"/2'-0"	6'-5"/2'-0"	6'-5"/2'-0"	6'-5"/2'-0"			
20'-0"	6'-5"/2'-0"	6'-5"/2'-0"	8'-0"/2'-0"	8'-0"/2'-0"			
25'-0"	6'-5"/2'-0"	8'-0"/2'-0"	9'-0"/2'-0"	10'-0"/2'-0"			
30'-0"	8'-0"/2'-6"	9'-0"/2'-6"	10'-0"/2'-6"	10'-0"/2'-6"			
NOTES: 1. TABLE IS BASED ON SOIL BEARING PRESSURE OF 3000 PSF. AND A LATERAL BEARING PRESSURE OF 200 PSF/FT.							



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Sheet
SITE CALC. PLAN

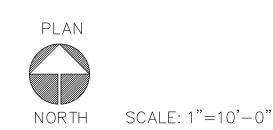


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BRADLEY FOUNDATION
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Sheet No.

EAST KNAPP STREET



1 ELECTRICAL SITE PLAN
1" = 10'-0"

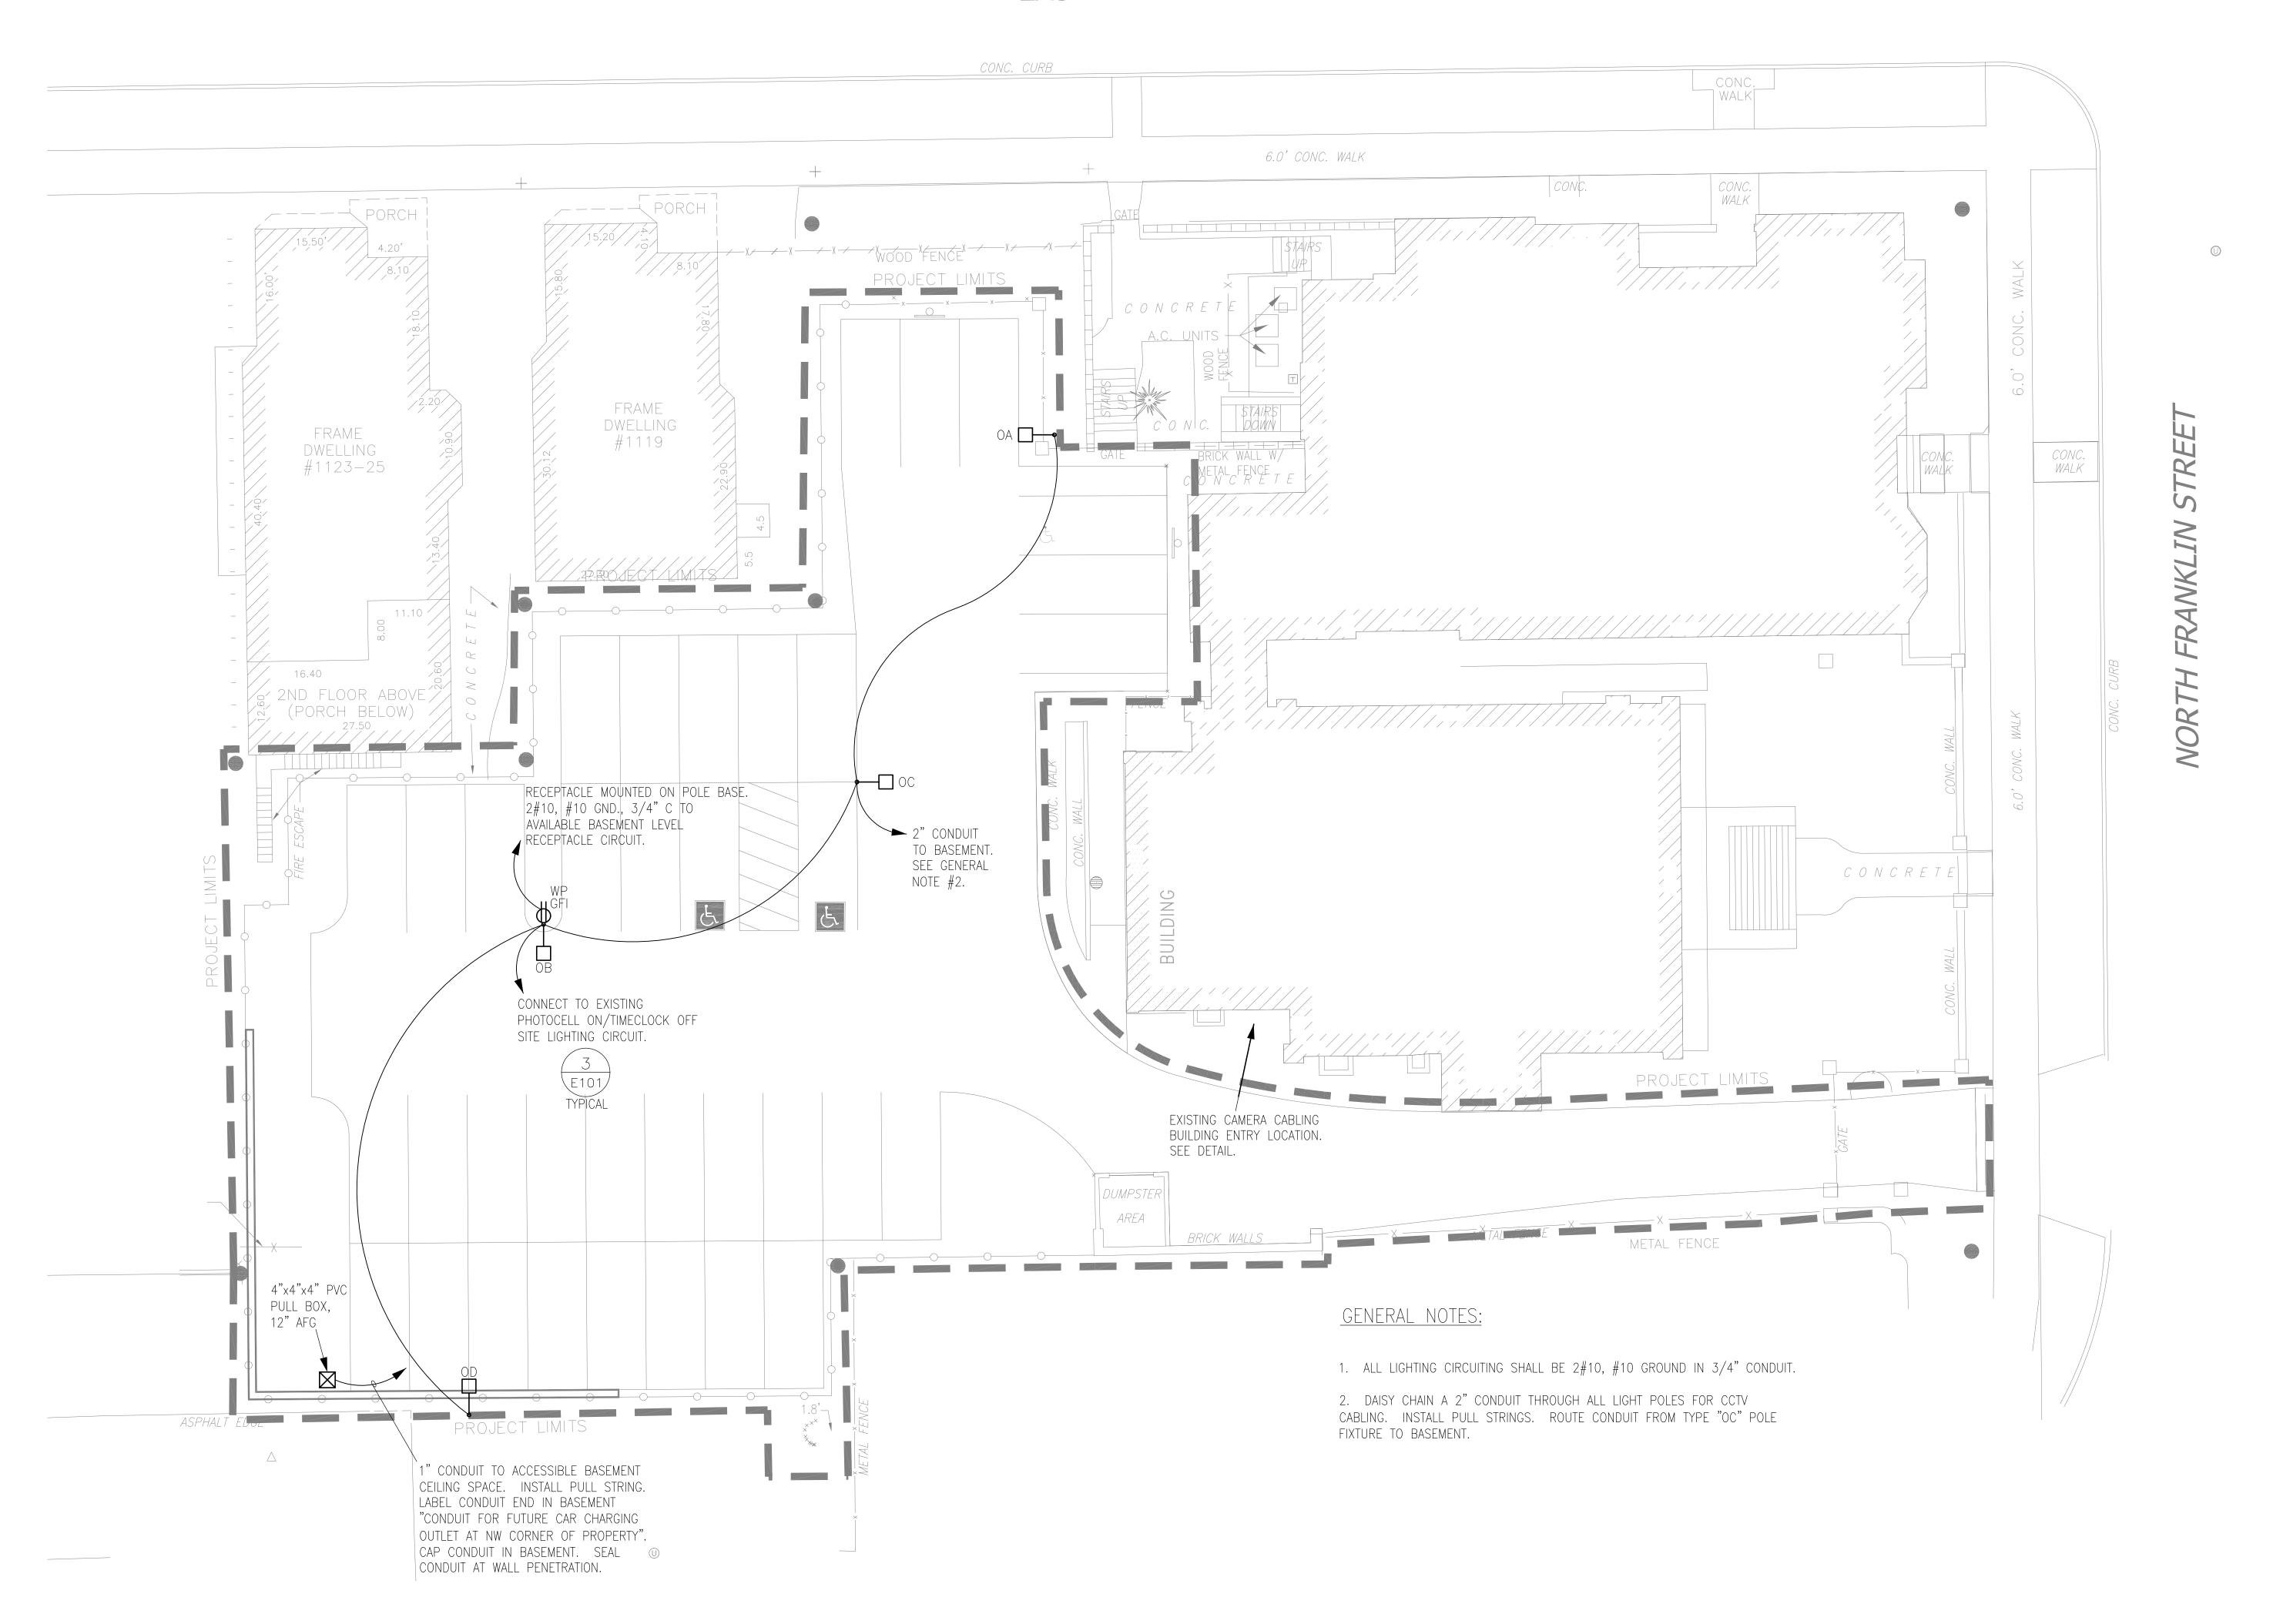

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Revisio

Sheet
ELECTRICAL SITE
PLAN



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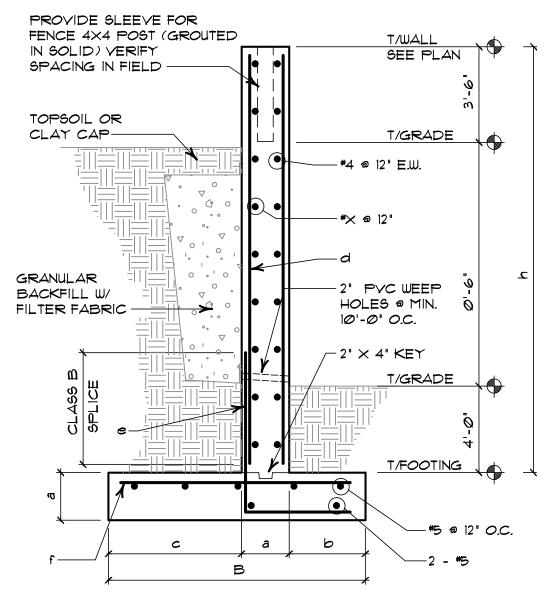
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Project No. 16-1077.00

Sheet No.


- - - - 1



h	В	а	Ь	O	YERT	ICAL B	4RS
1 1		a)	Т	U	f
8'-0"	4'-2"	1'-Ø"	1'-Ø"	2'-2"	#5@12"	#5a10"	# 5@12

RETAINING WALL


2 RETAININ SIDO SCALE: NONE

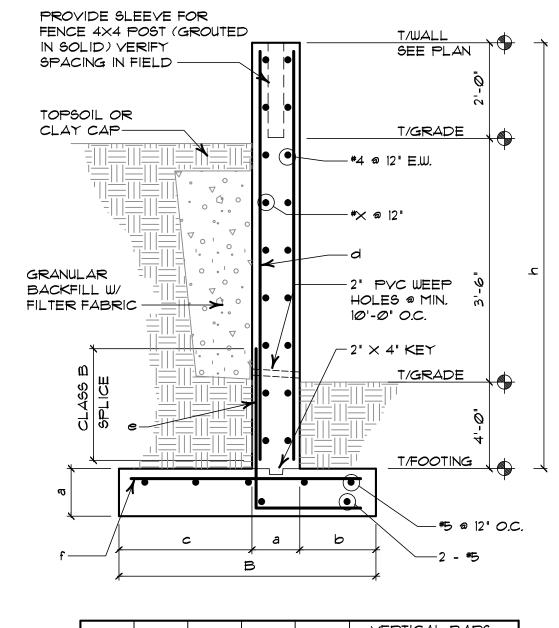

					VEST	ICAL B	AD6
h	В	а	Ь	c	d	ICAL B	f f
9'-6"	5'-8"	1'-Ø"	1'-Ø"	3'-8"	#5@12"	#5a1Ø"	# 5@12"

RETAINING WALL

SIDD SCALE: NONE

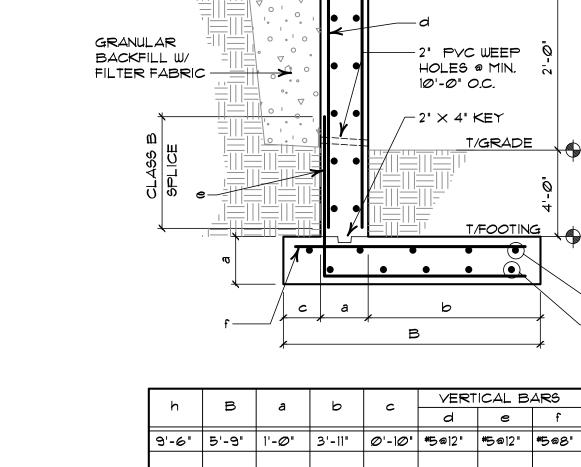

PROVIDE SLEEVE FOR FENCE 4X4 POST (GROUTED IN SOLID) VERIFY

SPACING IN FIELD -

TOPSOIL OR


CLAY CAP-

T/WALL SEE PLAN

T/GRADE

—**#**⊁ ⊘ 12"

4	RETAINING WALL	
\$100	SCALE: NONE	

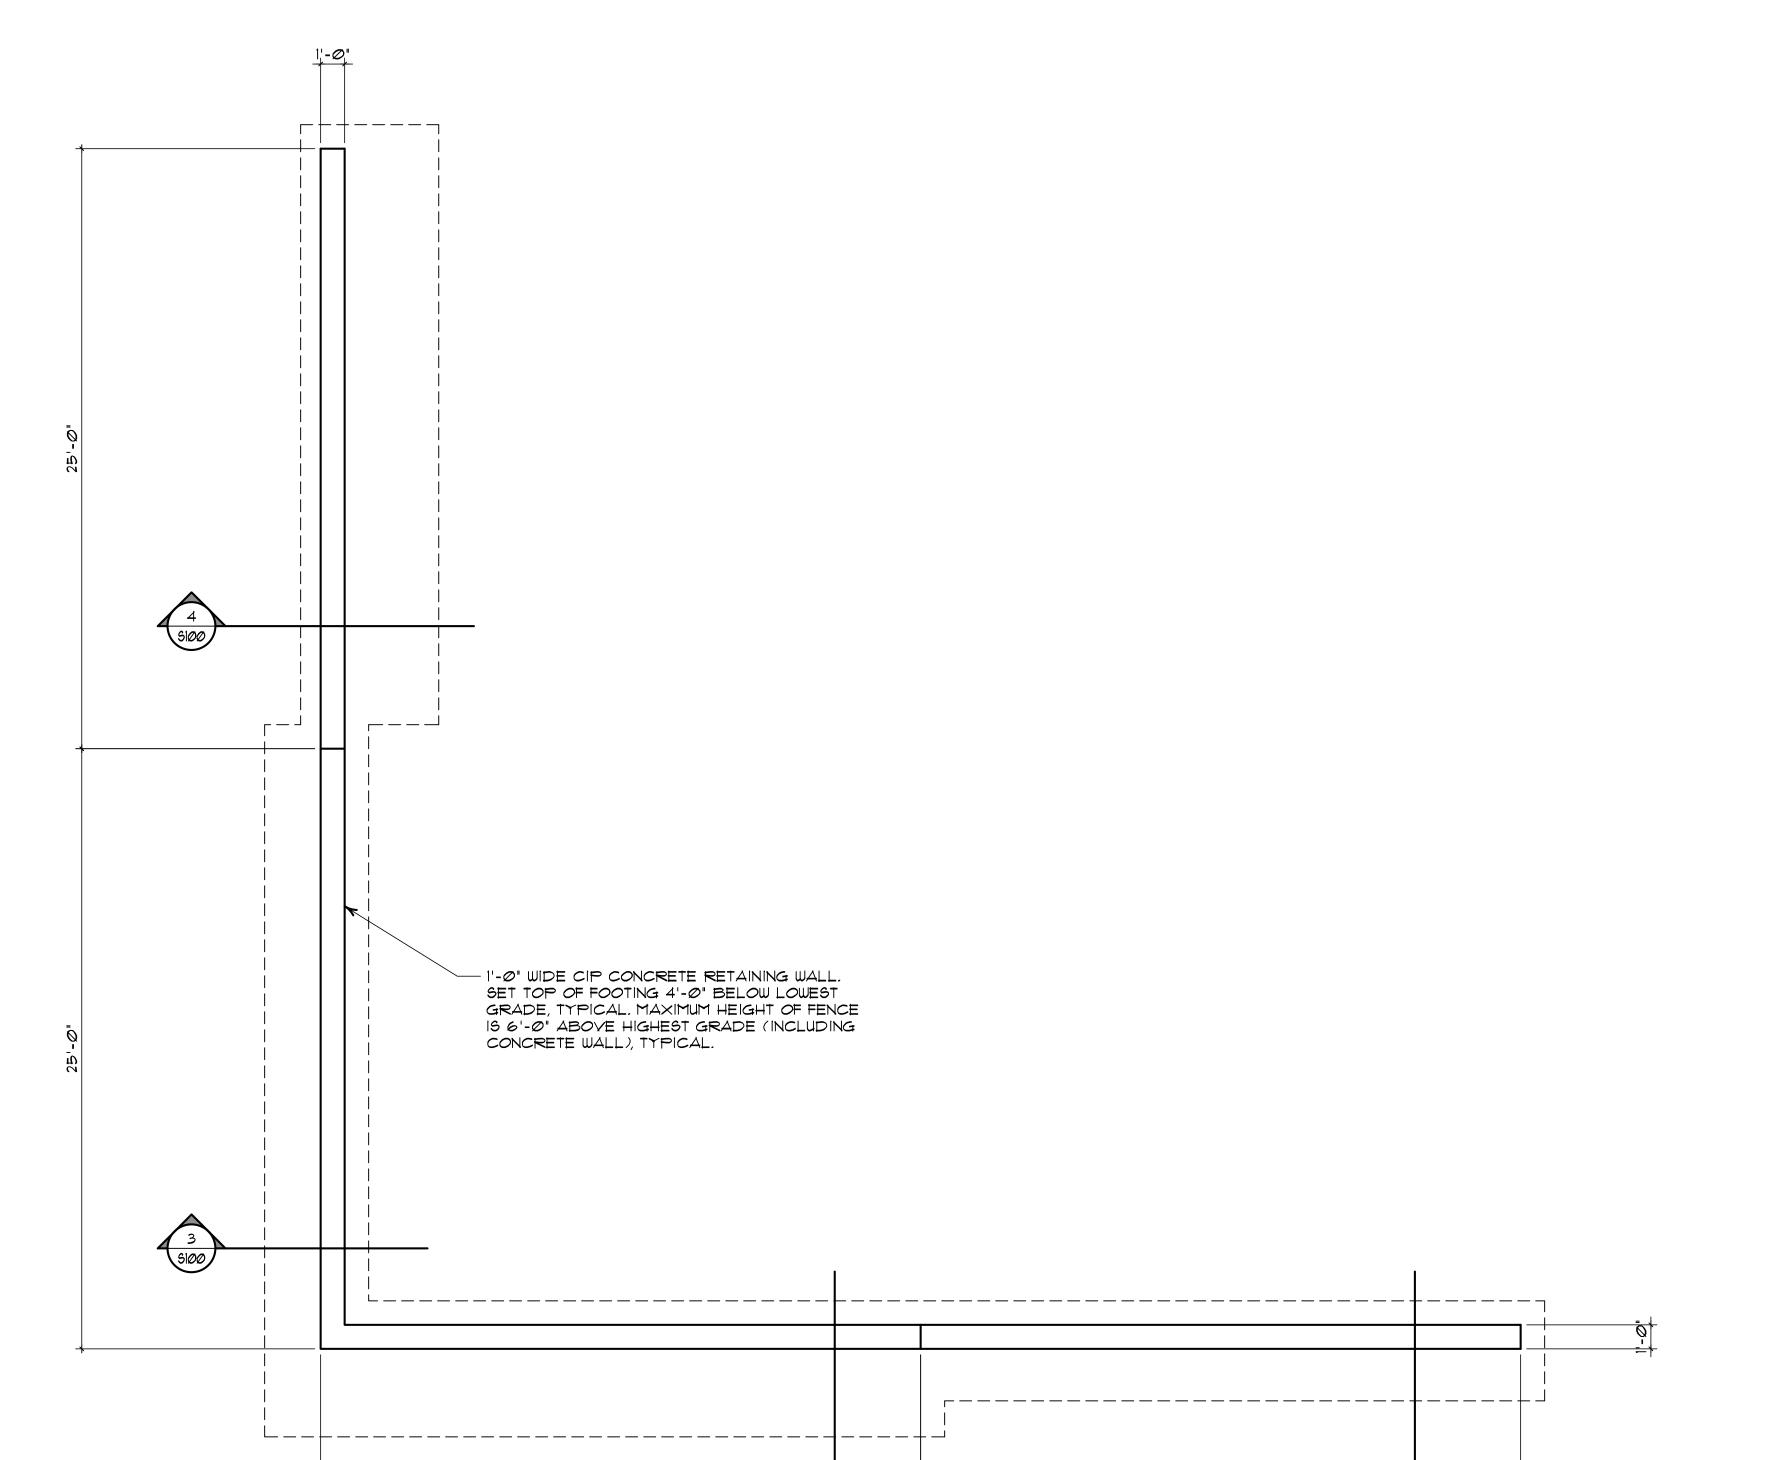



25'-Ø"

design live loads

LIVE LOADS 250 PSF	=
WIND LOADING BASIC WIND SPEED (3-SECOND GUST) 90 MF EXPOSURE CATEGORY C EXPOSURE FACTOR (Cw) 1.0 IMPORTANCE FACTOR (Iw) 1.0 NET LATERAL ON WALLS 20 PS	>H ⊁

DESIGN STRESSES

CAST-IN-PLACE CONCRETE f'c = 4,000 PSI
REINFORCEMENT — — — Fy = 60,000 PSI



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REVISIONS

No.

Date Description



Lynde and
Harry Bradley
Foundation Parking

RETAINING WALL PLAN

DATE

May 10, 2016

PROJECT NO.

16-109

SHEET NO.

25'-Ø"