

FN 151883

Kane Commons

EXHIBIT A as of

04-19-16

April 11, 2016

Revised April 18, 2016

## PROJECT DESCRIPTION AND STATEMENT OF INTENT

### Amendments to Detailed Plan Development Phase 2

Kane Commons

1142 through 1158 East Kane Place

*01/03/08 NOTE: ADDRESS RANGE REVISED TO 1146-1170 EAST KANE PLACE*

*PLEASE SEE ITEMS IN RED FOR AMENDMENTS TO THE DEVELOPMENT PLAN*

Milwaukee Wisconsin



The original Detailed Plan Development is being amended to allow for a single family home to be built at the 1168-1170 Address. Originally this was planned to be a duplex condominium. But with the economic down turn there has been no interest in construction that type of unit. In its place we are proposing a single family unit with the related changes to the Detailed Plan Development as listed below

Since the Detailed Plan was originally submitted, the East Village Conservation Overlay District has been removed and the project is no longer bound by its requirements.

#### EXECUTIVE SUMMARY OF REVISIONS

THE FOLLOWING IS THE LIST OF REVISIONS TO THE DETAILED PLAN DEVELOPMENT;

1. the units at 1168-1170 East Kane shall be reduced from 2 to 1 based on the lack of interest by potential buyers in constructing a duplex, a single family home has drawn more interest
2. The number of units will be reduced from 13 to 12 based on Item #1
3. Parking spots: the number of covered spots will be increased from 14 to 15 to address ongoing parking issues in the development. Even though we are reducing the number of units, we are increasing the number of parking spots.
4. The 1168-1170 unit will have a front setback for its overhangs and columns based on the average setback of the existing buildings directly to the West and East. Its garage wall will be set back from the face of the overhang an appropriate distance.
5. The eastside building setback for 1168-1170 will be 1'-6". This will match the set back on the west side of the development
6. 1170 East Kane will have a double garage door on the street. See attached drawings for style
7. The above changes are reflected in the density tables at the end of this letter

PROJECT SIZE	<b>NO CHANGE</b>
The size of the Project will be 29,098 square feet, (.67 acres).	

PROJECT DENSITY	<b>SEE BELOW</b>
The proposed density of the Project is consistent with the East Village, because its housing layout generally continues that of the street. The present configuration of the site consists of an existing four-unit apartment building that is being converted into (3) condominiums (1142), a duplex which will remain as rental property (1148), a new single family home (1152) and a new duplex condominium (1154). Plan and design for all four street buildings was approved in Phase 1 of this project.	

As part of the Phase work, 2 rear buildings in back of site were demolished.

Phase 2 of this project consists of two new single family buildings flanking a new courtyard in the middle of the site (1144 and 1156), and three new single family homes along the bluff edge (1146, 1150 and 1158).

In sum, the twelve pre-existing units will be replaced by 13 **12** new units, almost all of which have larger occupancy capacity than the previous units.

There is now only street parking with no on-site parking and the new development provides for 14 **15** covered parking stalls and 3 surface stalls.

SPACE BETWEEN STRUCTURES	<b>See Item 2</b>
The set backs approved in the General Plan are as follows:	

1. Front setback (Kane Place): ~~the buildings will be setback 4'6" from the property line. The front porches and stoops will have a 0' setback to match. The 1168-1170 unit will have a front setback for its overhangs and columns based on the average setback of the existing buildings directly to the West and East. Its garage wall will be set back from the face of the overhang an appropriate distance.~~
2. East Side setback: ~~the buildings will be setback 3'6" from the east property line. The eastside building setback for 1168-1170 will be 1'-6". This will match the set back on the west side of the development~~
3. West Side setback: New buildings will have a 1'-6" minimum set back from the west property line.
4. North Side Setback: the setback from the north property line is determined by the buildable area atop of the bluff and varies from building to building.

5. Internal set backs for the street structures is 5'-0" minimum.

Since the approval of the General Plan and the Detailed Plan Phase 1, the internal set backs for the bluff homes has been changed. Phase 2 of the Detail Plan sets these setbacks as 3'-6" minimum. (this change is due to the overhangs required for straw bale construction).

There are no business or industrial uses in Kane Commons, so no screening is required.

**COURTYARD AND COMMON OPEN SPACES      SEE BELOW**

**Paving**

Due to site contamination and bluff stability, the drive in the courtyard will be decorative concrete. Permeable paving will be used for the walks and center courtyard garden paths.

**Retaining Walls**

Retaining walls to be poured-in-place concrete with a stone veneer or landscaping block.

**Plantings**

Plantings will be generally native and low maintenance in accordance with principals of permaculture to aid in water retention, pollution remediation, bluff maintenance and light conditions. No sod will be planted. Courtyard will include trees and rain-gardens, with preference for native grasses, perennial and shrubs. Green roofs, trellis vines, integrated balcony planters and other plantings on structures are included..

**Lighting**

Lighting will be low level and architecturally integrated, and will emphasize walking surfaces, plantings and illumination for safety (no high level lighting or high color lamping, such as high pressure sodium).

**Utilities**

All utility lines will be underground and a transformer is not needed. NOTE: this was changed during construction of Phase 2. The transformer was place interior to the site and out of sight from the street

**Signs**

No signs, other than house numbers, are contemplated.

**SITE ACCESS AND CIRCULATION      NO CHANGE**

**Pedestrian**

The site can be approached by foot from East Kane Place. The street front houses will all have entries on or near the street facades, accessed from the public sidewalk. Some of the front houses will also have second entries from the side and/or the rear courtyard. 1142 Unit C and 1148 Upper will have access from the Courtyard. The remaining houses will be accessed through the drive and Courtyard.

**Vehicular**

Parking will be integrated into the interior of the site, and car access will be through a drive located between 1144 and 1148, the remaining two existing buildings. All ~~but one of the garage doors will be located on the courtyard elevations of the buildings (no garage doors to be on street facades or easily visible directly from the street). 1168-1170 will have a double garage door on Kane Place. This was done to accommodate the additional garage for the association.~~ The Master Plan will provide a minimum of one dedicated indoor parking space for 11 of the 13 dwelling units, with a majority of single home dwelling units will have two dedicated parking spaces.

**Garbage Collection**

Garbage storage generally to be located within garage units or in primary garbage storage structures, located at the south end of 1144 and the north end of 1148. These structures are easily accessible from the drive, but are located so not to be visible from the street. Structure will be enclosed and designed to be visually and materially harmonious with adjacent buildings.

### Snow Removal and Collection

Zones for snow storage to be designed into plan of courtyard areas.

#### PHASE 2 COURTYARD BUILDINGS      **NO CHANGE**

##### **Massing and height**

New buildings at courtyard shall be designed to take advantage of the sloping site, and will be positioned to reinforce the courtyard and establish gardens between the buildings. General scale of buildings to be similar to street-front buildings, with more articulation of entries, terraces, different floor levels and greater connections between interior and exterior spaces. Buildings on courtyard and bluff shall be no taller than the peak of the tallest building on the street front (1152), and may have a combination of sloped, low slope or flat roofs.

##### **Entries**

Entries of courtyard dwellings will be partially covered or recessed into façade to enhance scale and transition from public to private spaces.

##### **Balconies**

A minimum of one balcony or roof terrace will be provided for each living unit, in addition to garden and terrace spaces at grade.

##### **Materials**

Exteriors to be composed of a combination of materials, ranging from masonry, stuccoed straw bale, wood, concrete, cement panel and metal (no vinyl or aluminum siding). Changes in material will reflect massing, relationships between buildings, passive solar strategies, light, air currents and view orientations for interior spaces, and connections to the ground plane and retaining conditions. Foundation walls to be poured-in-place concrete, stone or stucco, and roof edges to be wood or metal with integrated wood soffits and venting (no corrugated perforated aluminum or vinyl soffits.).

**Green, Sustainable or Low Impact Features:** the courtyard buildings and garden will be the focal point of the green, sustainable, and low impact design of the project. The design guidelines that achieve these features are as follows:

---Use site layout, design, construction, and management techniques that achieve multiple storm water management objectives such as groundwater recharge, discharge rate control, runoff volume control, and water quality improvements.

----Increase the aesthetic value of the proposed development and storm water management facilities through design.

-----Integrate storm water management facilities into the natural environment through placement, landscaping, rain chains, raingardens and cisterns.

In accordance with these principles, rooftop runoff from all the buildings will be directed to various collection points throughout the courtyard where it can be stored or re-used through rain barrels or runoff cisterns. The project will take full advantage of this freedom to collect, convey, and treat rooftop runoff to minimize off-site discharges.

The collection of run off from the drive will be directed into the Milwaukee Metropolitan sewer system. While directing this run off to the river is an option, the WDNR is proposing a walleye spawning area along the south east river bank from Pleasant Street to the former North Avenue Dam. Contamination from the drive would have an adverse effect on this and should therefore be avoided.

Some flat roofs may be green or living roofs, which help to collect water and decrease runoff. Other roofs may combine solar and/or green roof technology and water collection, Japanese rain chains and storage, such as rain barrels, cisterns, rain gardens and grey water system. Geothermal heat pumps and solar panels will be used where feasible.

We will use on-site infiltration and storage facilities will handle as much of this runoff as practicable. The discharge of roof runoff onto "hard" or impervious surfaces will be avoided because we want to (i) reduce the discharge peaks draining to the sewers, and (ii) prevent channelized flows that can cause bluff erosion.

The project seeks to handle the most frequent rainfalls (up to 1. inches) on-site through the use of a series of Best Management Practices (BMPs) such as rain barrels, green roofs, and runoff cisterns. These BMPs will reduce the total runoff discharge from the property, which in turn will reduce discharge into City sewers as well as down the bluff during the most common rainfalls.

#### **Construction and Building Code**

The following are construction parameters for the Phase 2 buildings:

Buildings with walls 2 feet or closer to property lines or adjacent buildings will have those walls constructed with a 1-hour fire separation rating. Openings in rated walls shall have glass block infill.

Exits from 3rd floor (above grade) living spaces may have exterior spiral stairs connecting decks at the third level to decks on the second level.

Straw bale construction shall have a timber frame with straw infill to provide weather enclosure and insulation.


Grey water systems may be developed to provide for landscape watering needs.

Solar Thermal panels may be placed on roofs of homes to provide additional energy efficiency.

Exterior walls of all buildings may be panelize construction using environmentally sound construction practices from renewable sources.

**IMAGE OF GARAGE DOOR**

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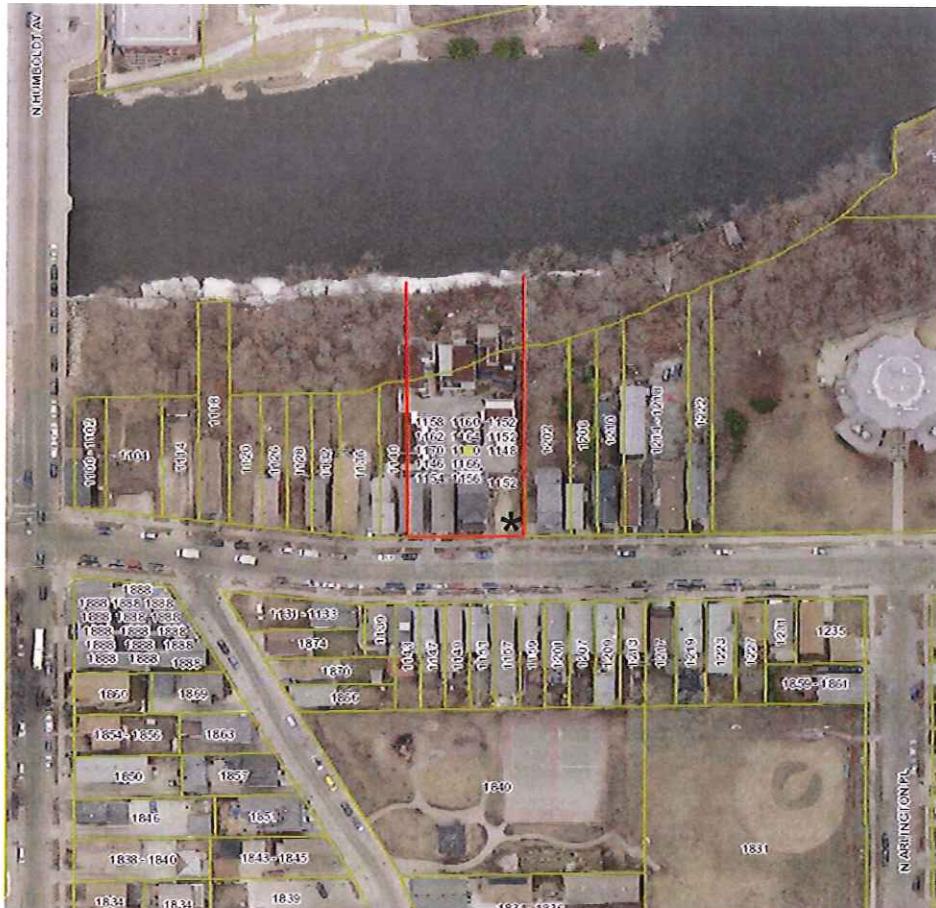
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Item		Phase 1	Phase 2	Total	Comments
Gross Land Area		9272 SF	19826 SF	29098 SF	Measurements for Phase 2 and total taken to dock line
Maximum land covered by principal buildings	1142 <b>1146-1150</b>	1150 SF			
New addresses In red	1144 <b>1152</b>		1128 SF		
	1146 <b>1154</b>		1430 SF		
	1148 <b>1162-1164</b>	920 SF			
	1150 <b>1156</b>		1462 SF		
	1152 <b>1166</b>	1008 SF			
	1154 <b>1168-1170</b>	1464 SF			
	1156 <b>1160</b>		1084 SF		
	1158		1550 SF		
	<b>TOTAL</b>	4542 SF	6654 SF	11196 SF	
Maximum land for parking, drives		3015 SF	3258 SF	6273 SF	
Minimum amount of landscaped open space		1715 SF	9914 SF	11629 SF	Includes possible development of dock line
Maximum proposed dwelling unit density		8 units	5 units	13 units	
		0.21 acre	0.46 acre	0.67 acre	
		38 units/acre	11 units/acre	19 units/acre	
Number of buildings		4 buildings	5 buildings	9 buildings	1142 and 1148 East Kane are existing.
Maximum land covered by principal buildings	1142 <b>1146-1150</b>	3 units			
	1144 <b>1152</b>		1 units		
	1146 <b>1154</b>		1 units		
	1148 <b>1162-1164</b>	2 units			
	1150 <b>1156</b>		1 units		
	1152 <b>1166</b>	1 units			
	1154 <b>1168-1170</b>	2 units <b>1 unit</b>			
	1156 <b>1160</b>		1 units		
	1158		1 units		
	<b>TOTAL</b>	8 <b>7</b> units	5 units	43 <b>12</b> units	

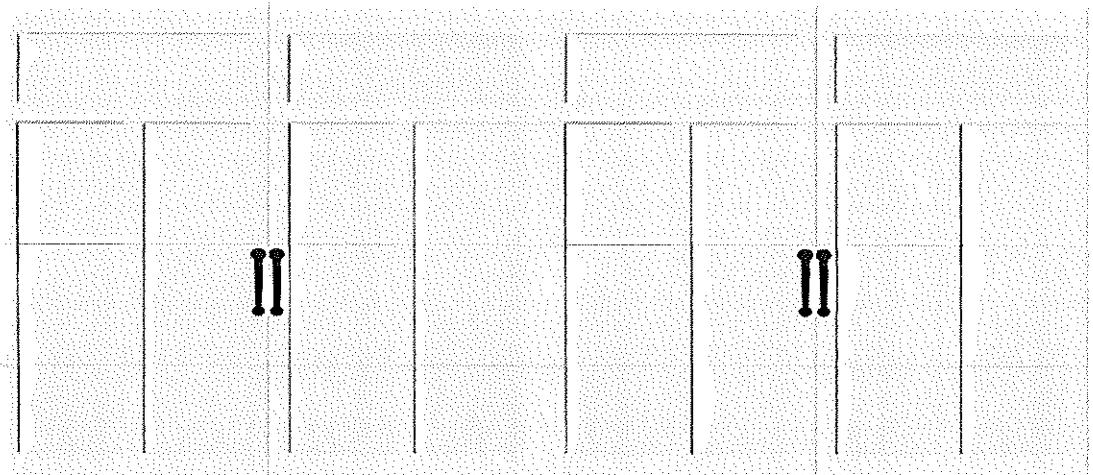Number of Bedrooms per Unit	1142		3		
	1146-				
	1150				
	1144			2	
	1152				
	1146			3	
	1154				
	1148		2		
	1162-				
	1164				
	1150			3	
	1156				
	1152		2		
	1166				
	1154			2	
	1168-				
	1170				
	1156			2	
	1160				
	1158			3	
	TOTAL	9 bedrooms	13 bedrooms	21 bedrooms	
Parking spaces provide		6 Stalls	12 Stalls	18 Stalls	Phase 1: 5 covered, 2 surface Phase 2: 10 covered 1 surface
Parking/Unit Ratio		0.85 Stall/unit	2.4 Stall/unit	1.5 Stall/unit	

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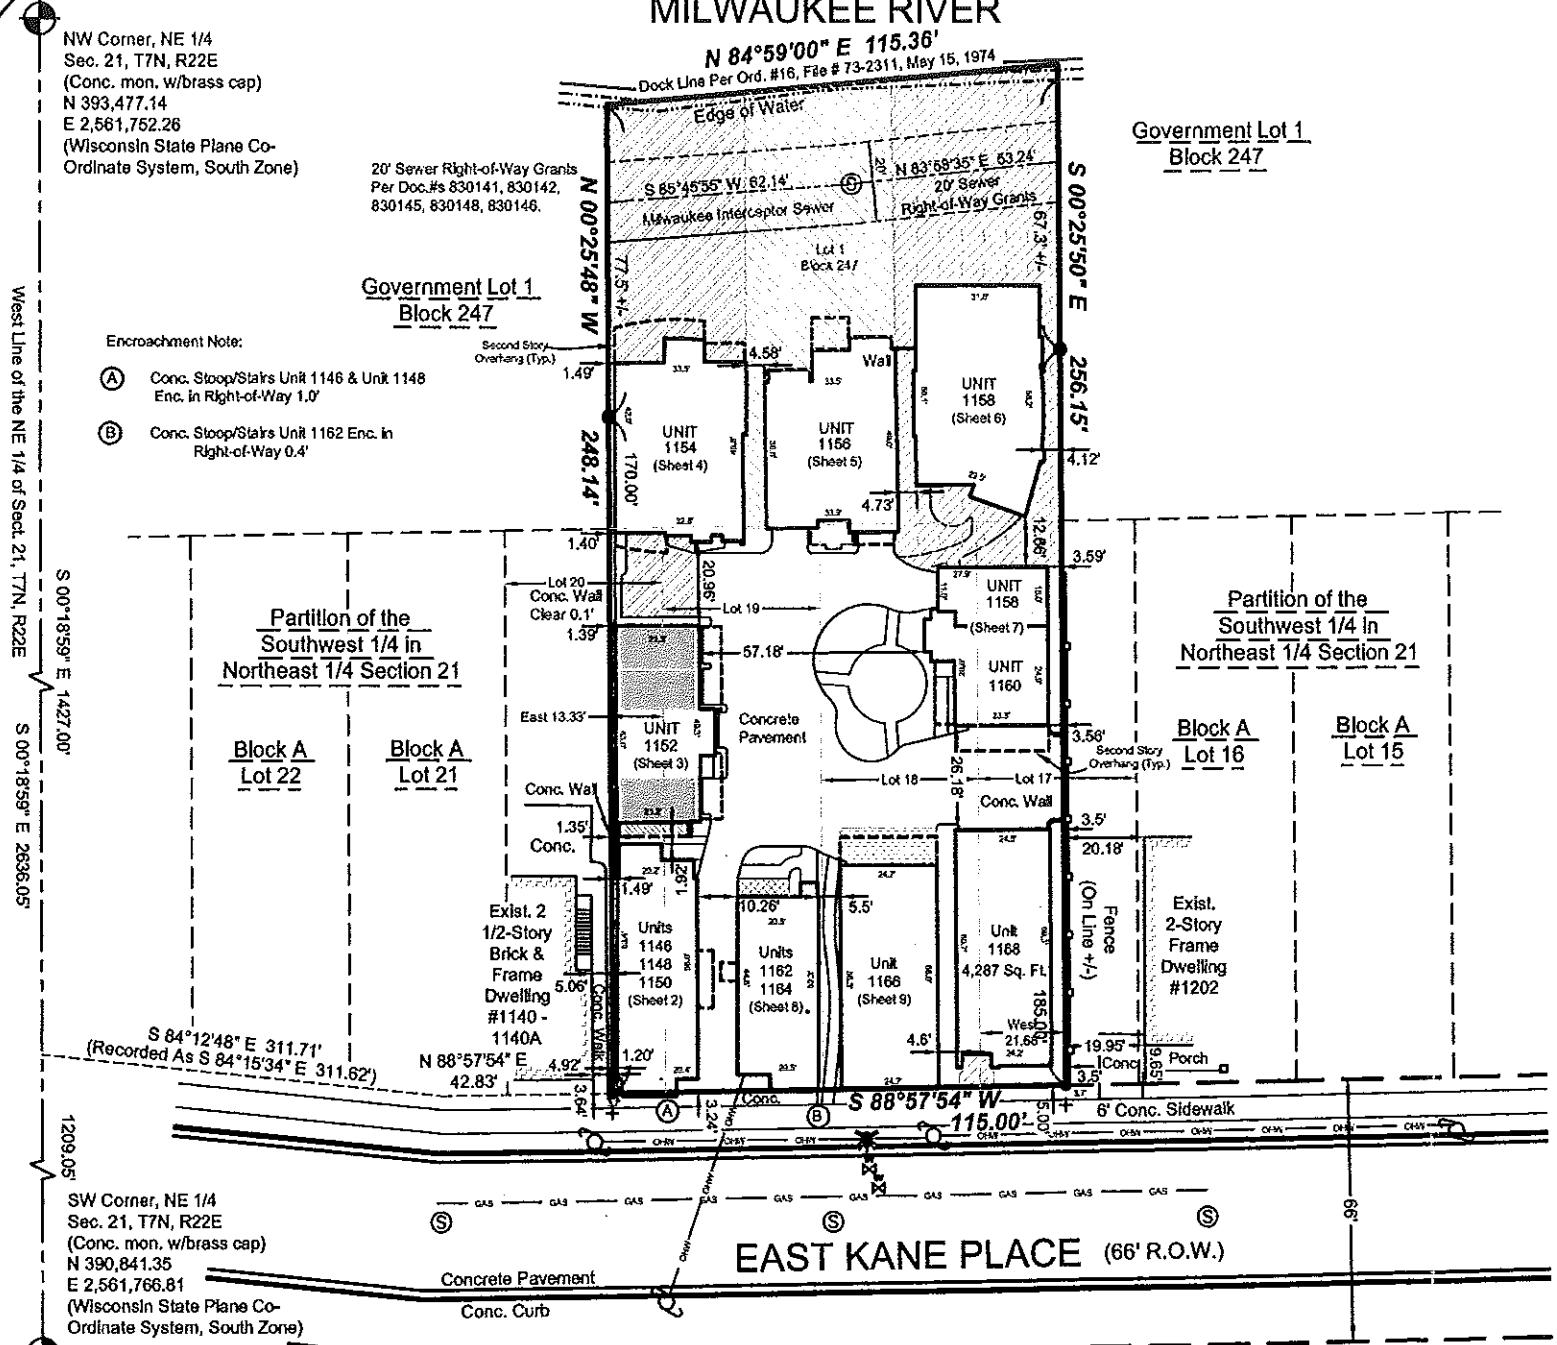
VICINITY MAP



# KANE COMMONS CONDOMINIUMS

The West 21.67 feet of Lot 17, all of Lot 18 and Lot 19, and the East 13.33 feet Lot 20, all in Block A of the **PARTITION OF THE SOUTHWEST 1/4 OF THE NORTHEAST 1/4 SECTION 21** and the West 115 feet of the East 800 feet of Part of **GOVERNMENT LOT 1** which lies between and North of the North line of said Lots and the Southerly Bank of the Milwaukee River, being a part of the Northwest 1/4 of the Northeast 1/4 Section 21, Township 7 North, Range 22 East, in the City of Milwaukee, Milwaukee County, Wisconsin, better described as follows: Commencing at the Northwest corner of said Northeast 1/4, run thence S 00°18'59" E along the West line of the Northeast 1/4, 1427.00 feet; thence S 84°12'48" E, 311.71 feet; thence N 88°57'54" E, 42.83 feet to the point of beginning; thence N 00°25'48" W, 248.14 feet to a point; thence N 84°59'00" E, 115.36 feet along the DOCK LINE per Ordinance # 16, File No. 73-2311 dated May 15, 1974; thence S 00°25'50" E, 256.15 feet; thence S 88°57'54" W, 115.00 feet to the Point of Beginning.

Said land containing: 28,995 Sq.Ft. (0.6656 Acres).



## NOTES:

- Some limited common elements are indicated by cross hatching (see legend). Those limited common elements are described below along with other limited common elements which could not be graphically shown in a feasible manner on sheets 2, 3, 4, 5, 6, 7, 8 and 9.
  - The driveway, patio, porches, stoops, trash enclosures, all attic space above each unit and/or sidewalks adjacent and/or contiguous to that unit are intended to service that unit.
- All dimensions are exterior dimensions, per building plan, and must be adjusted for interior dimensions.
- Dimensions may vary due to construction materials and methods used.
- Underground utility information as shown is obtained from the records of the municipality, local utility companies and/or field locations.
- Square footage per unit calculated from exterior walls, basements, and garages. These numbers will vary depending on how measurements are taken.

Map Prepared by: William R. Henrichs, RLS S-2419

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INFO@LANDCRAFTSE.COM


Prepared For:

Jillily Kohler  
Kane Place, LLC.  
1224 E. Brady Street  
Milwaukee, WI 53202


## GRAPHIC SCALE




Bearings refer to Grid North of the Wisconsin State Plane Coordinate System Grid, South Zone per N.A.D. 1927. The West line of the Northeast 1/4 of Section 21, Township 7 North, Range 22 East has a reference bearing of S 0°18'59" E.

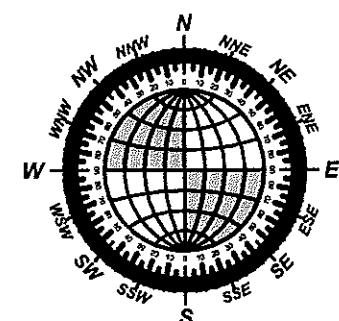

## EAST KANE PLACE

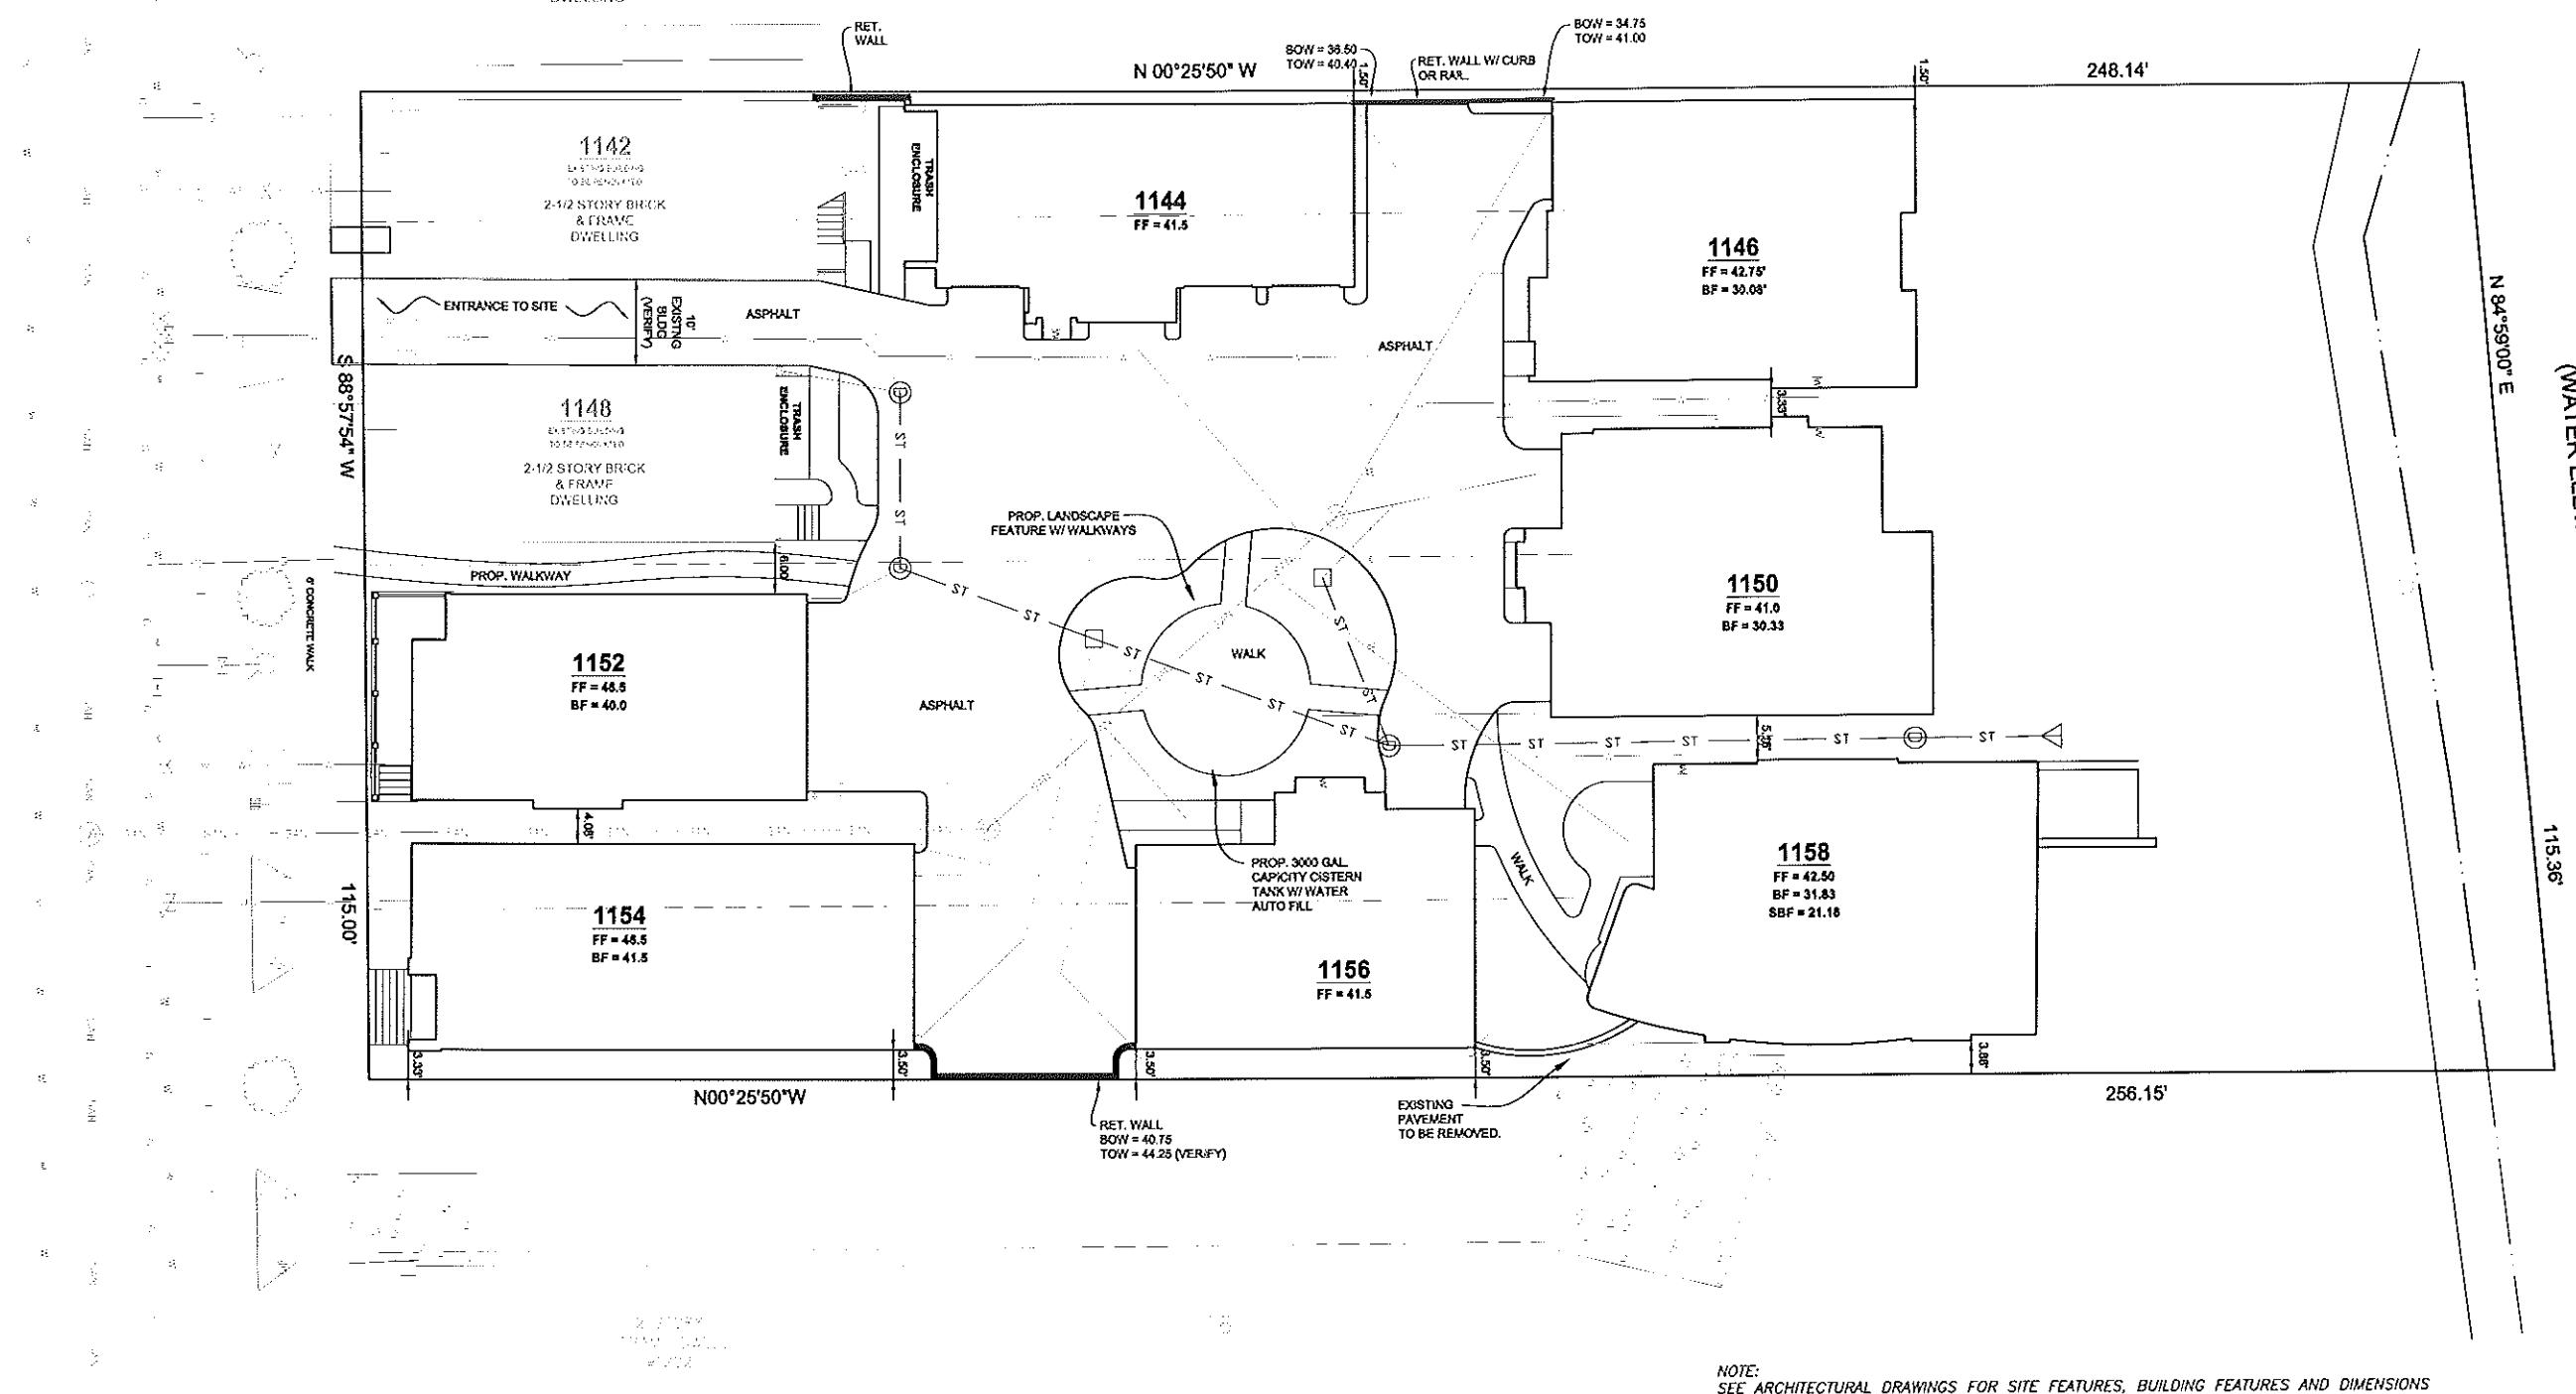

## EAST KANE PLACE

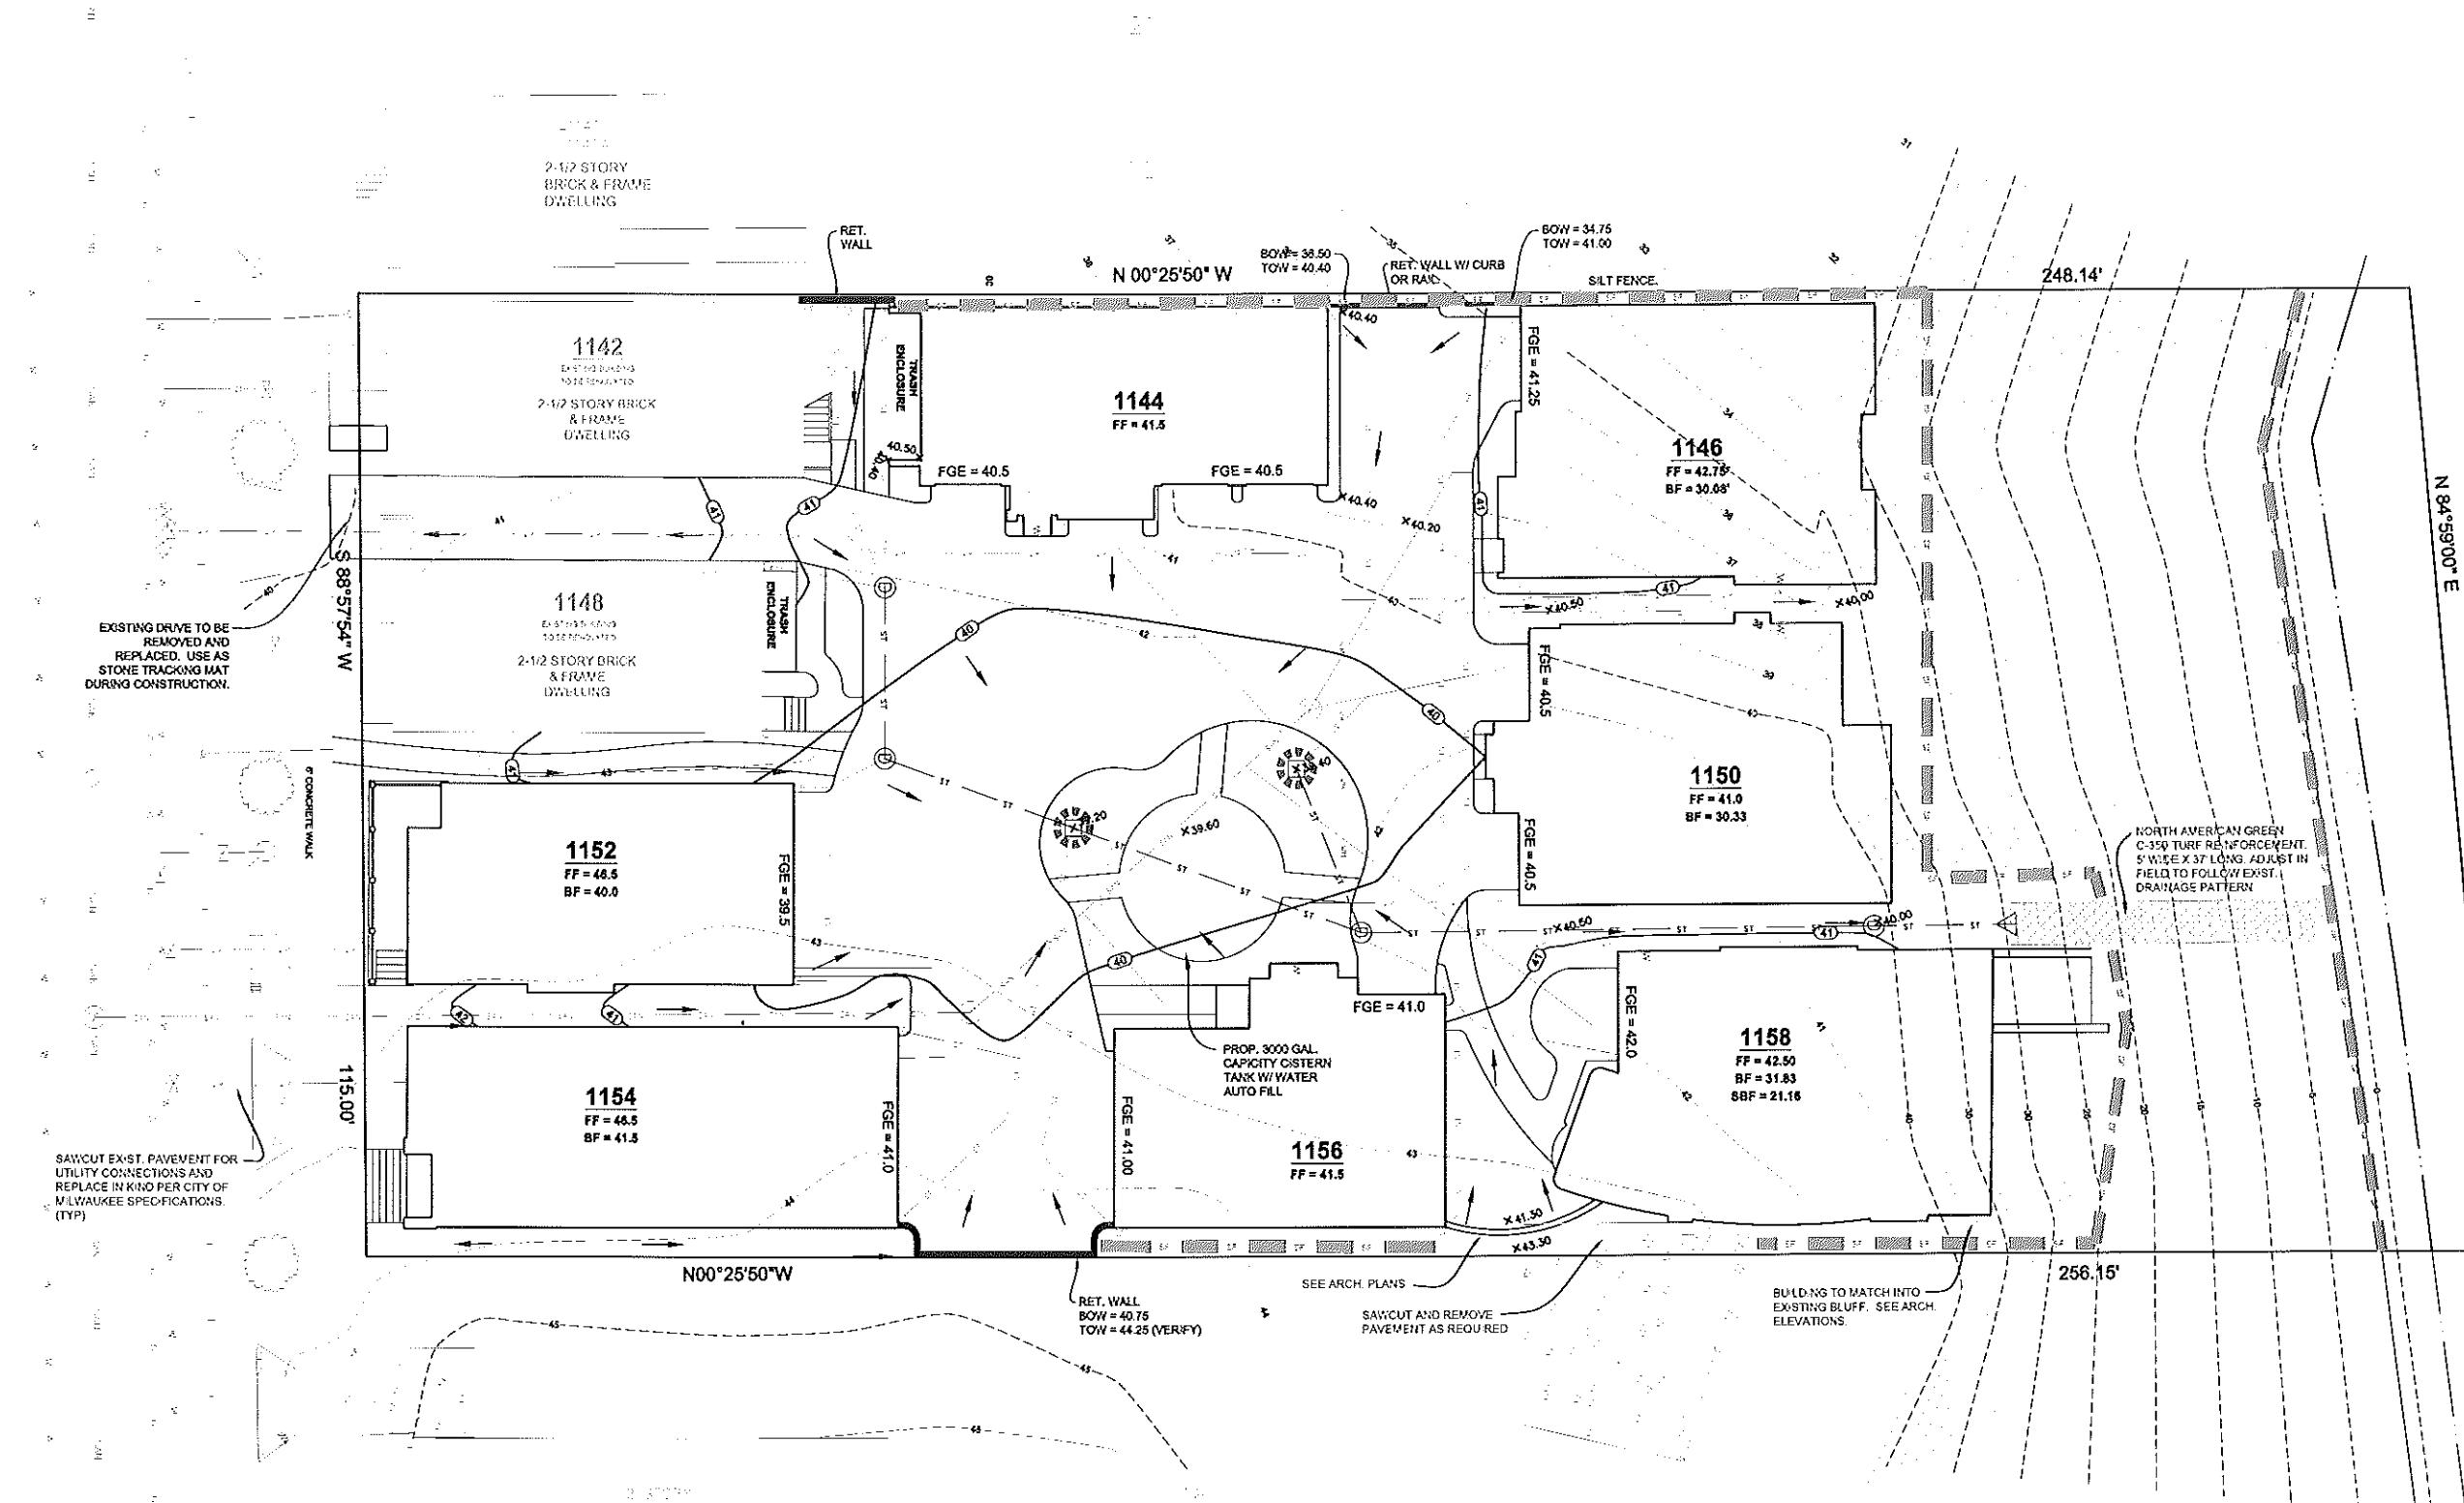

**NOTE:**  
SEE ARCHITECTURAL DRAWINGS FOR SITE FEATURES, BUILDING FEATURES AND DIMENSIONS NOT INDICATED ON THIS PLAN.

**SURVEY AND BOUNDARY INFORMATION PROVIDED BY BLOOM CONSULTANTS, LLC**

**SEE SHEET 7 FOR SITE DETAILS**




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INFO@LANDCRAFT.COM	
<b>DESIGNED BY:</b> A. KOCH, P.E.	
<b>CHECKED BY:</b> A. KOCH, P.E.	
<b>APPROVED BY:</b>	
TO: CITY ENGINEER DATE:	
PROJECT NO.: 050376 - REV. DATE: Feb 07, 2007	
HOR. SCALE: 1" = 10'	

**GRADING AND EROSION CONTROL**  
**KANE COMMONS**

CITY OF MILWAUKEE, MILWAUKEE COUNTY, WISCONSIN

**SHEET 2 OF 7**

## EAST KANE PLACE

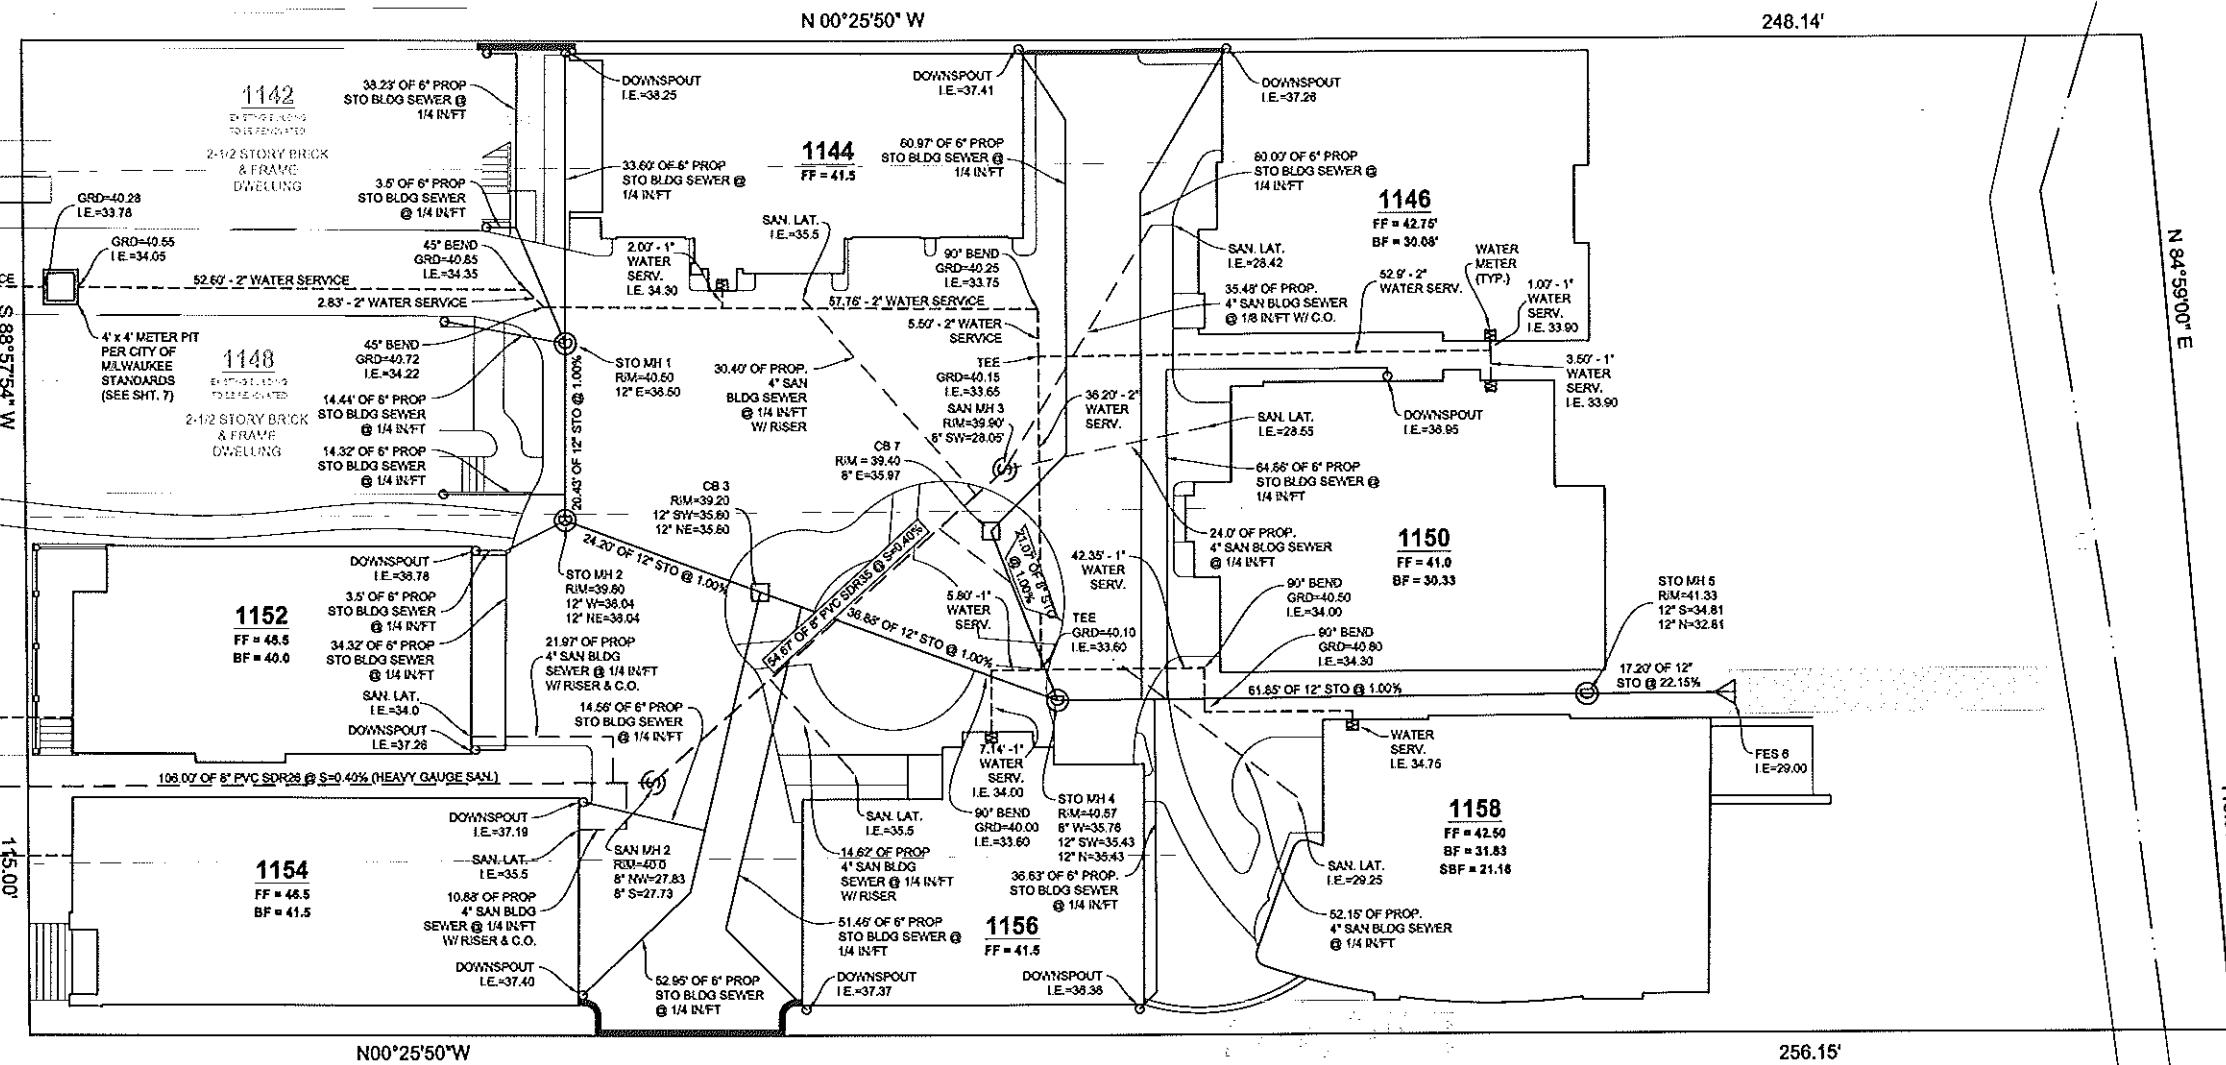

**DIGGERS HOTLINE**  
WISCONSIN STATE STATUTE 182.0173 REQUIRES  
THREE WORK DAYS NOTICE BEFORE YOU EXCAVATE  
CALL DIGGERS HOTLINE 1-800-242-8511


LEGEND	
PROP. STORM SEWER	—
PROP. STORM SEWER LATERAL	— — —
PROP. STORM SEWER LATERAL TO CISTERN	— — — — —
PROP. SANITARY SEWER	— — — — — —
PROP. SANITARY SEWER LATERAL	— — — — — — —
PROP. WATER SERVICE	— — — — — — — —

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APPROVED BY: TOWN/CITY ENGINEER DATE
PROJECT NO.: 050376 - REV. DATE: Feb 07, 2007
HOR. SCALE: 1"= 10'

**UTILITY PLAN**  
**KANE COMMONS**  
CITY OF MILWAUKEE, MILWAUKEE COUNTY, WISCONSIN

SHEET 3 OF 7

## EAST KANE PLACE

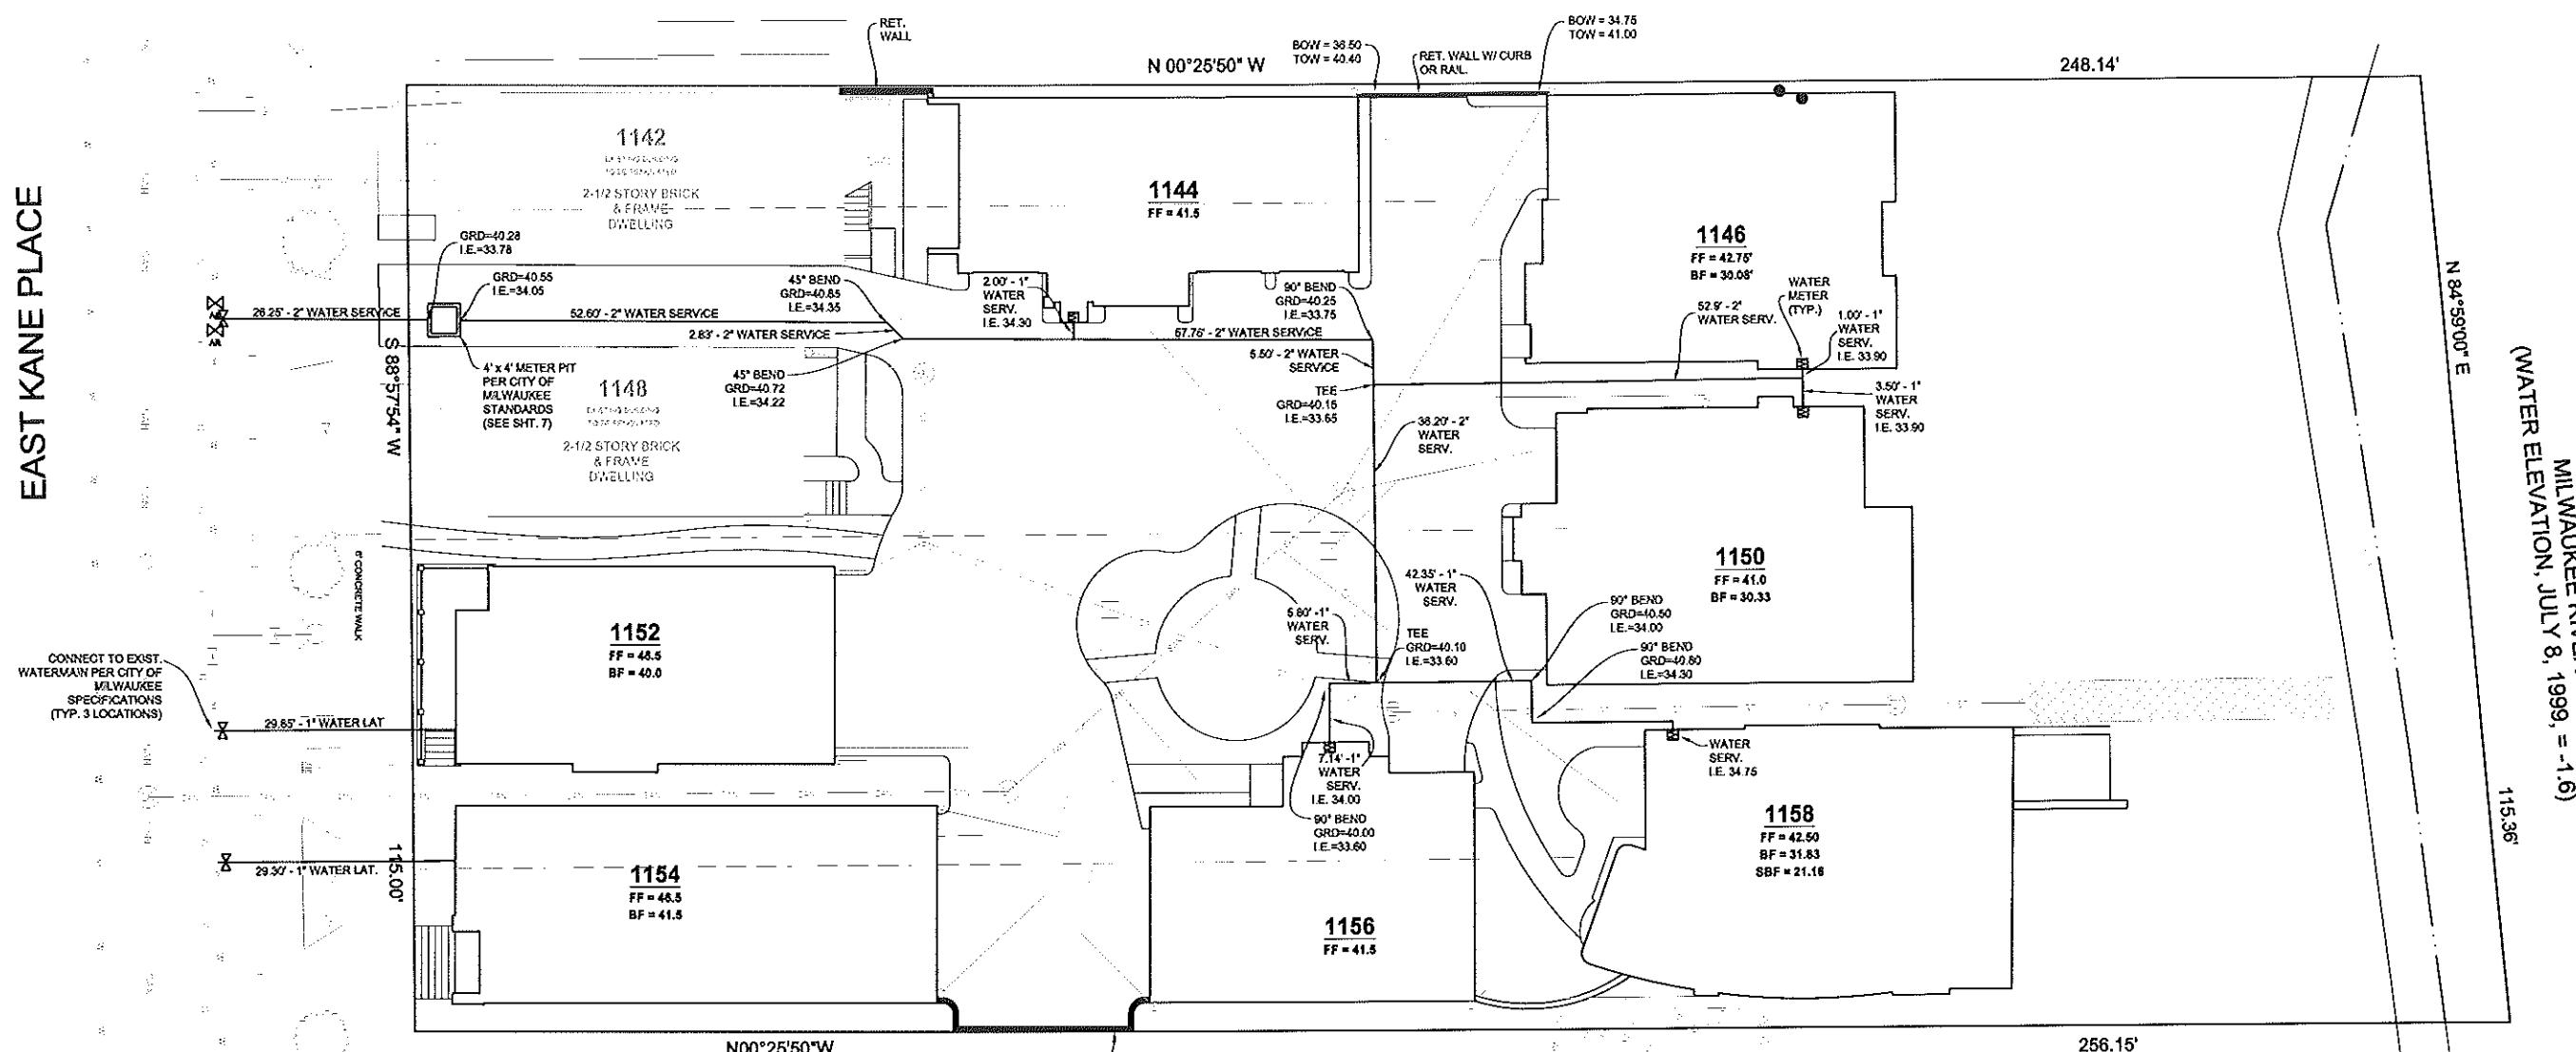

**NOTES:**

1. THE LOCATION AND SIZE OF UNDERGROUND STRUCTURES AND UTILITIES SHOWN HEREON HAVE BEEN LOCATED TO A REASONABLE DEGREE OF ACCURACY, BUT THE ENGINEER DOES NOT GUARANTEE THEIR EXACT LOCATION OR THE LOCATION OF OTHERS NOT SHOWN. CONTACT DIGGERS HOTLINE.
2. ALL SITE GRADING ACTIVITY AND EROSION CONTROL MEASURES SHALL COMPLY WITH THE WISCONSIN DEPARTMENT OF NATURAL RESOURCES CONSTRUCTION SITE EROSION AND SEDIMENT CONTROL TECHNICAL STANDARDS (1000-1070). ALL EROSION CONTROL MEASURES MUST BE IN PLACE BEFORE CONSTRUCTION BEGINS AND SHALL BE MAINTAINED DURING CONSTRUCTION.




WISCONSIN STATE STATUTE 192.0175 REQUIRES THREE WORK DAYS NOTICE BEFORE YOU EXCAVATE CALL DIGGERS HOTLINE 1-800-242-6511




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APPROVED BY:	TOWN/CITY ENGINEER DATE
PROJECT NO.: 050376 - REV. DATE: Feb 07, 2007	
HOR. SCALE: 1" = 10'	

**WATER MAIN PLAN**  
**KANE COMMONS**  
CITY OF MILWAUKEE, MILWAUKEE COUNTY, WISCONSIN  
**SHEET 4 OF 7**

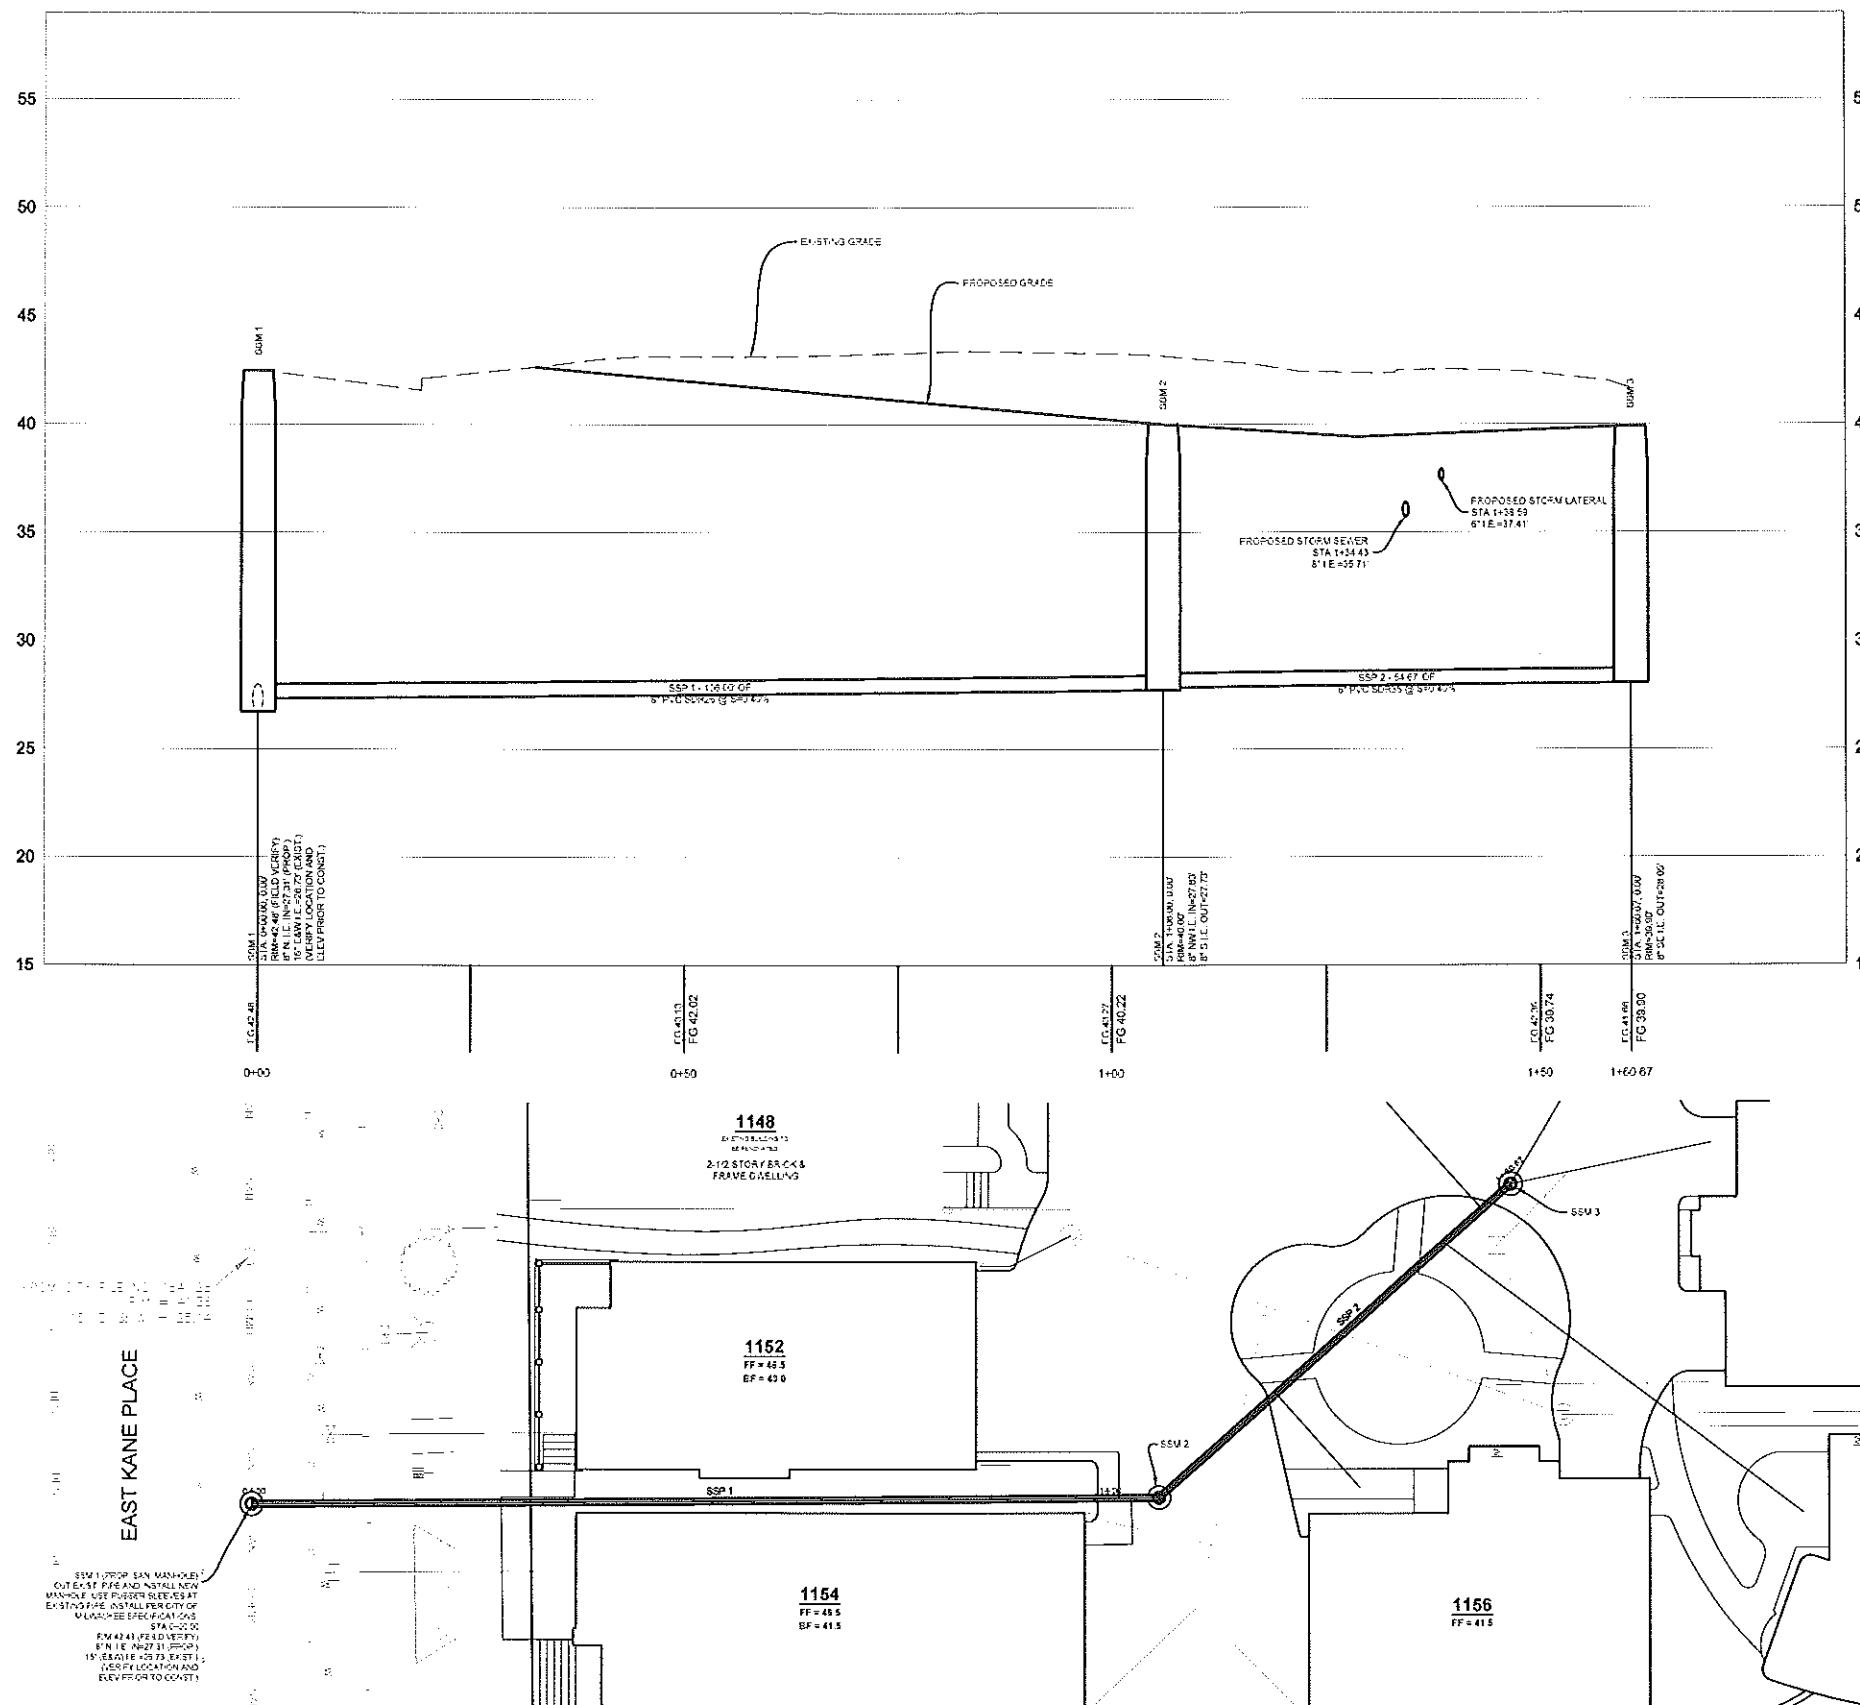

**SANITARY SEWER PLAN**  
**KANE COMMONS**  
CITY OF MILWAUKEE, MILWAUKEE COUNTY, WISCONSIN  
**SHEET 5 OF 7**

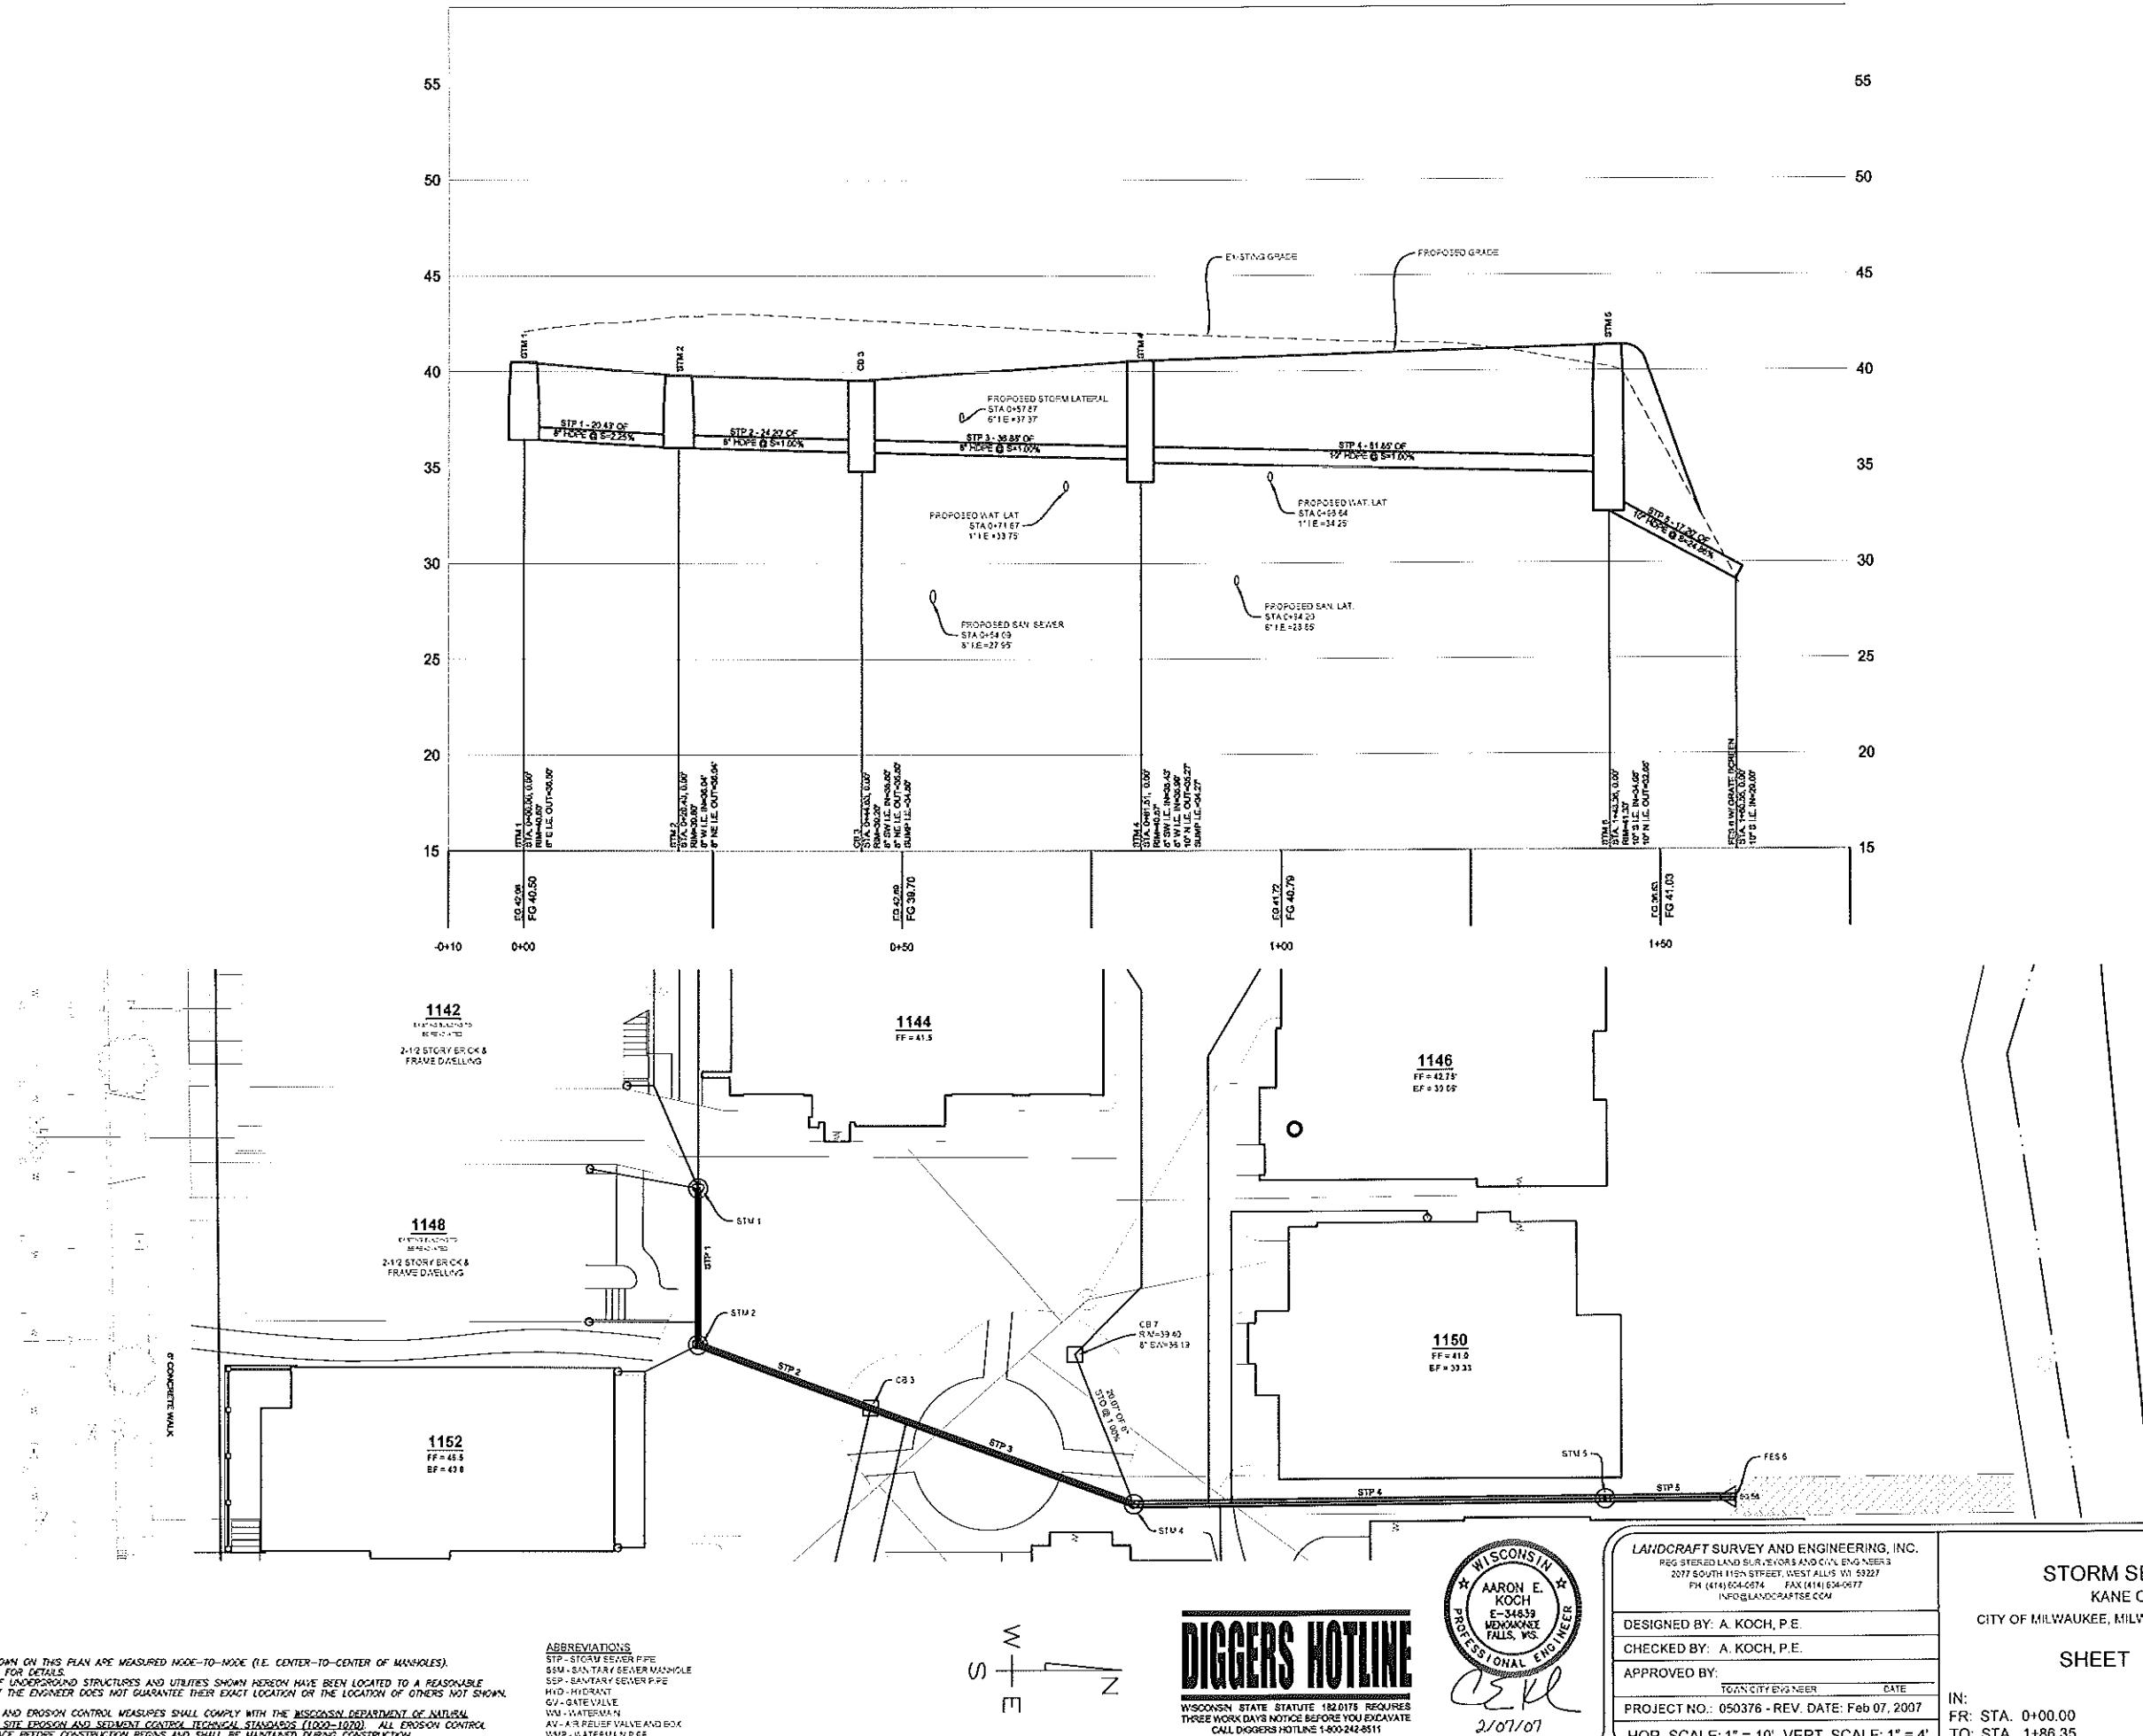

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**NOTES:**

1. PIPE RUN LENGTHS AS SHOWN ON THIS PLAN ARE MEASURED NODE-TO-NODE (I.E. CENTER-TO-CENTER OF MANHOLES).
2. SEE SHEET 7 OF THIS SET FOR DETAILS.
3. THE LOCATION AND SIZE OF UNDERGROUND STRUCTURES AND UTILITIES SHOWN HEREON HAVE BEEN LOCATED TO A REASONABLE DEGREE OF ACCURACY, BUT THE ENGINEER DOES NOT GUARANTEE THEIR EXACT LOCATION OR THE LOCATION OF OTHERS NOT SHOWN. CONTACT DODGERS HOTLINE.
4. ALL EROSION AND SEDIMENT CONTROL MEASURES SHALL COMPLY WITH THE ILLINOIS DEPARTMENT OF NATURAL RESOURCES' COASTAL/SHORELINE EROSION AND SEDIMENT CONTROL TECHNICAL STANDARDS (102A-102B). ALL EROSION CONTROL MEASURES MUST BE IN PLACE PRIOR TO CONSTRUCTION BEGINS AND SHALL BE MAINTAINED DURING CONSTRUCTION.

**ABBREVIATIONS**

STP - STORM SEWER PPE
SSM - SANITARY SEWER MAN
SEP - SANITARY SEWER P.P.
HVD - HYDRANT
GV - GATE VALVE
WU - WATERMAN
AV - AIR RELIEF VALVE AND
VAMP - VACUUM AND PUMP

**Abbreviations**

STP - STORM SEWER PIPE  
SM - SANITARY SEWER MANHOLE  
SEP - SANITARY SEWER PIPE  
HYD - HYDRANT  
GV - GATE VALVE  
VAL - VALVE  
AV - AIR RELIEF VALVE AND BOX  
VMP - VACUUM METER


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**DIGGERS HOTLINE**

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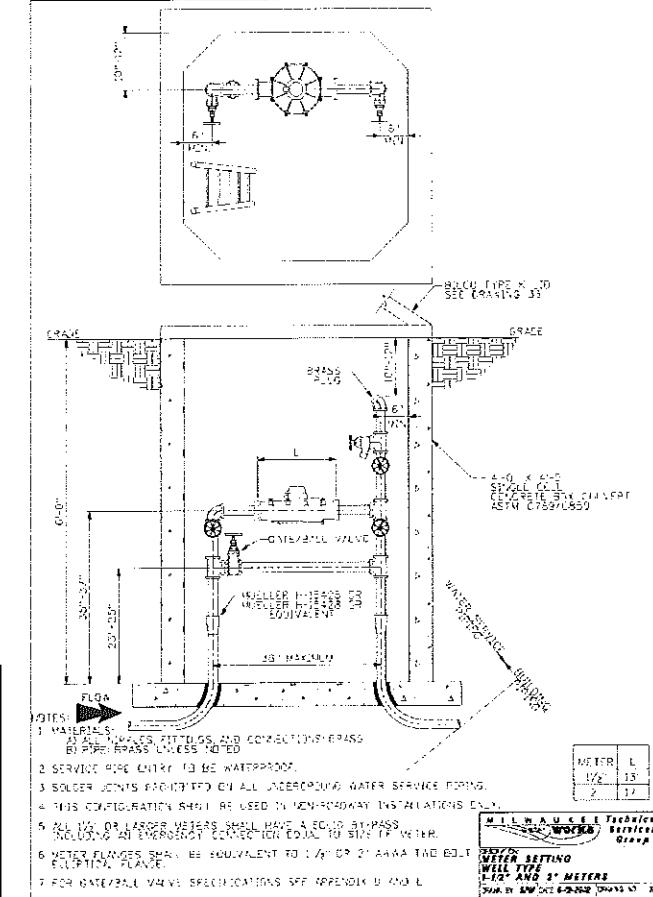
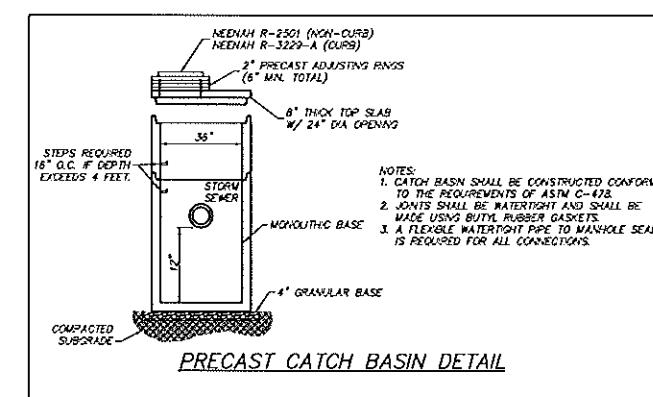
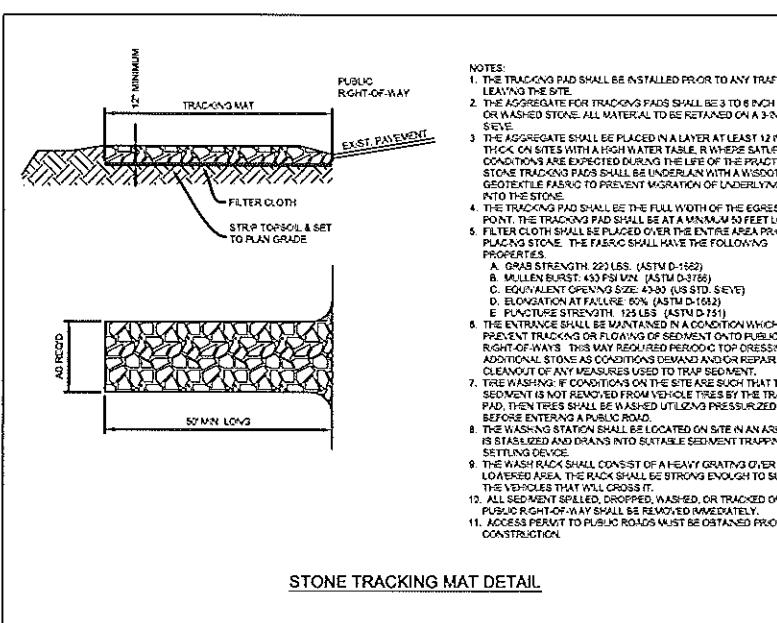
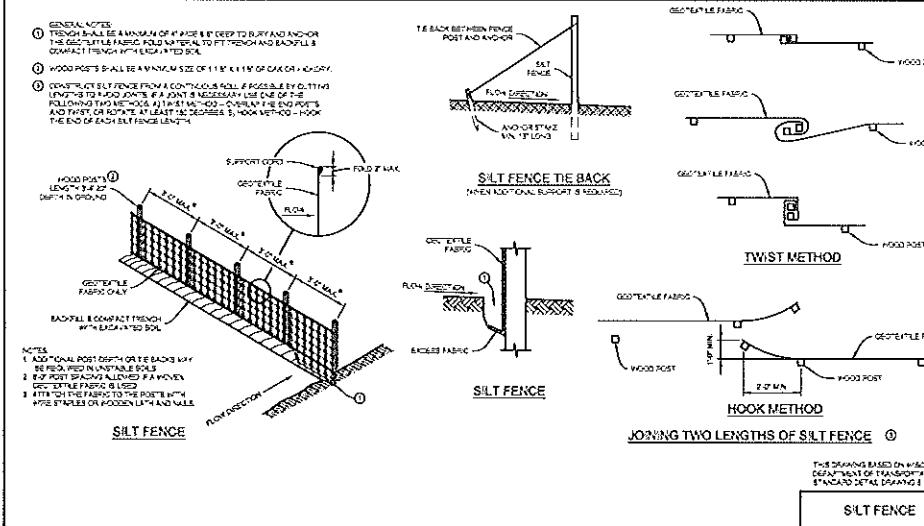
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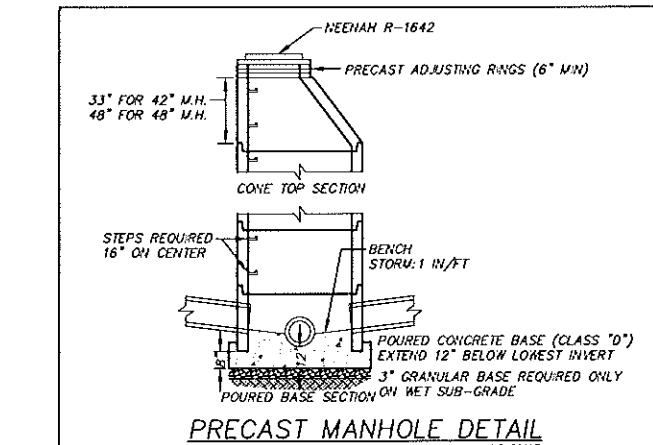
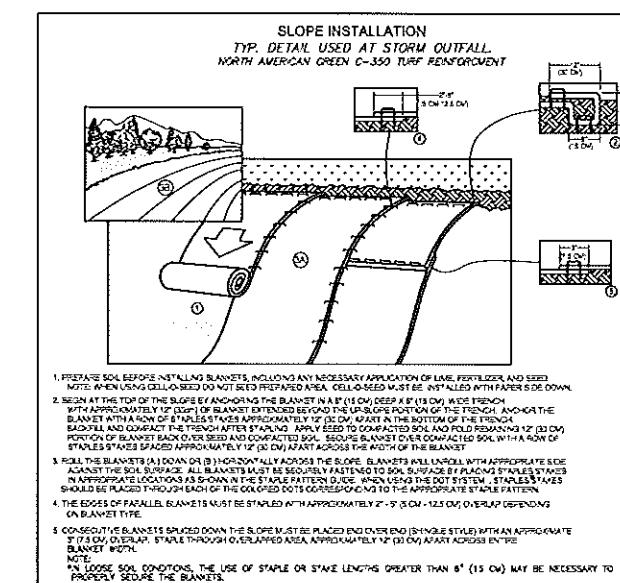
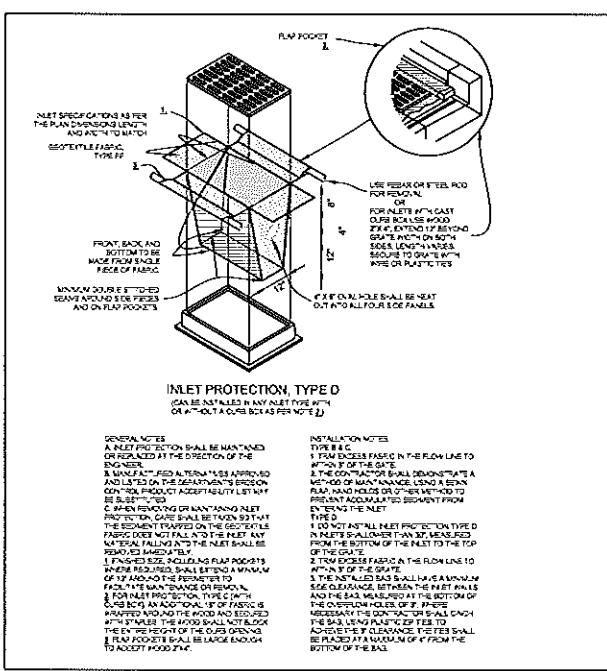
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 CHECKED BY: A. KOCH, P.E.		
 APPROVED BY: TOWN/CITY/ENGINEER DATE		
 PROJECT NO.: 050376 - REV. DATE: Feb 07, 2007		
 HOR. SCALE: 1" = 10' VERT. SCALE: 1" = 4'		

STORM SEWER PLAN  
KANE COMMONS  
OF MILWAUKEE, MILWAUKEE COUNTY, WI



**SPECIFICATIONS FOR PRIVATE UTILITIES**

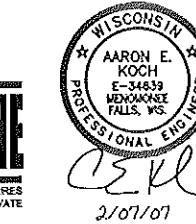- THE PROPOSED IMPROVEMENTS SHALL BE CONSTRUCTED ACCORDING TO WISCONSIN ADMINISTRATIVE CODE, SECTION COA 82-87, LATEST EDITION, THE STANDARD SPECIFICATIONS FOR SEWER AND WATER CONSTRUCTION IN WISCONSIN, LATEST EDITION, AND THE LOCAL ORDINANCES AND SPECIFICATIONS.
- THE CONTRACTOR SHALL NOTIFY THE OWNER AND THE MUNICIPALITY FORTY-EIGHT (48) HOURS PRIOR TO START OF CONSTRUCTION. THE MUNICIPALITY SHALL HAVE THE AUTHORITY TO INSPECT, APPROVE, AND REJECT THE WORK AS IT IS BEING CONSTRUCTED.
- THE CONTRACTOR SHALL INDEMNIFY THE OWNER, THE ENGINEER, AND THE MUNICIPALITY, THEIR AGENTS, ETC., FROM ALL LIABILITY INVOLVED WITH THE CONSTRUCTION, INSTALLATION, AND TESTING OF THE WORK SHOWN.
- THE CONTRACTOR ASSUMES SOLE RESPONSIBILITY FOR SITE SAFETY.
- THE CONTRACTOR SHALL SOLELY QUANTIFY THE COSTS OF EXISTING UTILITIES AND SHALL STATE SUCH QUANTITIES IN THE PROPOSAL. BIDS SHALL BE BASED ON THE BIDDER'S OWN ESTIMATE OF THE WORK REQUIRED AND SHALL NOT RELY ON THE ENGINEER'S ESTIMATE.
- THE CONTRACTOR IS RESPONSIBLE FOR VERIFYING SOIL CONDITIONS PRIOR TO COMMENCEMENT OF CONSTRUCTION. A GEOTECHNICAL REPORT MAY BE MADE AVAILABLE BY THE CONTRACTOR. CONTRACTOR SHALL ADOPT BY THE RECOMMENDATIONS OF THE GEOTECHNICAL ENGINEER.
- THE CONTRACTOR IS RESPONSIBLE FOR EXAMINING ALL SITE CONDITIONS PRIOR TO COMMENCEMENT OF CONSTRUCTION AND SHALL CORRECT FIELD CONDITIONS WITH DRAWINGS.
- THE CONTRACTOR SHALL OBTAIN AND PAY FOR ALL PERMITS REQUIRED FOR THE EXECUTION OF THE WORK. THE CONTRACTOR SHALL CONDUCT HIS WORK IN ACCORDANCE WITH THE REQUIREMENTS OF THE PERMITS.
- THE CONTRACTOR IS RESPONSIBLE TO FIELD VERIFY ALL UTILITY INFORMATION SHOWN ON THE PLANS PRIOR TO CONSTRUCTION. THE CONTRACTOR IS ADVISED TO CALL THE DODGER'S HOT LINE AT 1-800-442-5511 TO VERIFY THE UTILITIES OF HIS INTENTIONS, AND TO REQUIRED FILE STAKING OF EXISTING UTILITIES.
- BEFORE PROCEEDING WITH ANY UTILITY CONSTRUCTION, THE CONTRACTOR SHALL EXCAVATE EACH EXISTING LATEROAD OR POINT OF CONNECTION AND VERIFY THE LOCATION AND ELEVATION OF ALL UTILITY. ANY EXISTING UTILITIES ARE NOT TO BE CUT ON THE DRAWINGS. THE CONTRACTOR SHALL NOTIFY THE ENGINEER IMMEDIATELY FOR POSSIBLE REDESIGN.
- ALL CONNECTIONS TO EXISTING PIPES AND MANHOLES SHALL BE COPPED CONNECTIONS.
- PROPOSED SANITARY SEWER, WATER MAIN, AND INTERNALLY CONNECTED STORM SEWER LINES SHALL BE PLACED 5 FEET FROM THE EXTERIOR BUILDING WALL. STORM SEWER CONNECTING TO EXTERIOR DOWN SPOUTS SHALL BE PER DETAILS ON THE ARCHITECTURAL PLANS. THE EXACT LOCATION OF ALL DOWN SPOUTS SHALL BE PER THE ARCHITECTURAL PLANS.
- MATERIALS FOR STORM SEWER SHALL BE AS FOLLOWS:  
STORM SEWER LATERALS & SIDE-SITE SHALL BE HIGH DENSITY POLYETHYLENE (HDPE) COUPLED PIPE WITH AN INTEGRALLY FORGED SMOOTH KATKAWAY SUCH AS ADS N-12.  
TRENCH SECTION SHALL BE CLASS "C" FOR CONCRETE AND CLASS "B" FOR ALL OTHER MATERIALS.  
PIPE SHALL BE SCAFFOLD CONCRETE BLOCK OR PRE-CAST Poured CONCRETE BLOCK N-74.
- MATERIALS FOR SANITARY SEWER SHALL BE AS FOLLOWS:  
SANITARY SEWER PIPE SHALL BE PVC ASTM D-3034, SRW-35 WITH RUBBER GASKET JOINTS, CONFORMING TO ASTM D-3121 UNLESS NOTED OTHERWISE. TRENCH SECTION SHALL BE CLASS "B" BEDDING: CRUSHED STONE CHIPS SHALL BE USED FOR BEDDING.
- SADDLE PIPE CONNECTIONS ARE REQUIRED FOR SANITARY LATERALS.
- MATERIALS FOR WATER SERVICE SHALL BE TYPE "K" COPPER, ASTM B88. ALL WATER SERVICE CONSTRUCTION SHALL CONFORM TO CITY OF MILWAUKEE STANDARD SPECIFICATIONS SAND OR STONE CHIP BEDDING MATERIAL IS REQUIRED.
- DO NOT COMPACT MUST BE FOLLOWED REGARDING THE COMPACTION OF ALL UTILITY TRENCHES. MECHANICALLY COMPACTED GRANULAR BACKFILL IS REQUIRED UNDER & WITHIN 5 FEET OF ALL PAVEMENT INCLUDING SIDEWALKS. FLOODING OF BACKFILL MATERIAL IS NOT ALLOWED. THE COST OF THIS GRANULAR MATERIAL AND ITS COMPACTION IS CONSIDERED AN ADDITIONAL ITEM AND SHALL BE INCLUDED IN THE COST OF THE CONTRACTED UTILITY.
- UPON COMPLETION OF FINAL PAVING OPERATIONS, THE UTILITY CONTRACTOR SHALL ADJUST ALL MANHOLE AND INLET RMS AND VALVE BOXES TO FINISHED GRADE.
- CONTRACTOR IS ADVISED THAT ALL MUD AND DEBRIS MUST NOT BE DISCHARGED INTO THE ADJACENT ROADS. ANY SUCH MUD OR DEBRIS SHALL BE REMOVED FROM THE ROADWAY IMMEDIATELY.
- ANY ADJACENT PROPERTIES OR ROAD RIGHT-OF-WAYS WHICH ARE DAMAGED DURING CONSTRUCTION MUST BE RESTORED BY THE CONTRACTOR. THE COST OF RESTORATION IS CONSIDERED AN ADDITIONAL ITEM AND SHALL BE INCLUDED IN THE COST OF THE CONTRACTED UTILITY.
- THE CONTRACTOR IS RESPONSIBLE FOR PROVIDING THE OWNER WITH A SET OF MARKED-UP PLANTS SHOWING ALL CHANGES MADE DURING THE CONSTRUCTION PROCESS. ANY CHANGES TO THE DRAWINGS OR ADDITIONAL ITEMS MUST BE REPORTED TO THE OWNER.



**SEQUENCE OF CONSTRUCTION**

- PLACE SILT FENCE, DELINEATE CONSTRUCTION LIMITS AND PLACE TRACKING MAT AS SHOWN ON THE DRAWINGS.
- CONSTRUCT OVERSIDE SKALES IF NECESSARY TO CARRY RUNOFF FROM DISTURBED AREAS.
- STRIP TOPSOIL IN ROADS AND FILL AREAS. STOCKPILE TOPSOIL FOR REUSE. SURROUND THE DOWNHILL SIDE OF THIS PILE WITH SILT FENCE. IF THE STOCKPILE IS TO REMAIN IN PLACE FOR MORE THAN 7 DAYS, THEN IT MUST BE SEDED.
- ROLL GRANULAR SUBGRADE TO A DENSITY OF 95% OF SUBGRADE. NOTIFY GAS, CABLE UTILITY, AND UNDERGROUND CONTRACTOR THAT SITE IS READY FOR INSTALLATION.
- ALL DISTURBED AREAS MUST BE STABILIZED WITH PAVING, SEEDING, MULCHING, SODDING OR EROSION MAT INSTALLATION WITHIN 7 DAYS AFTER GRAVING IS COMPLETED.
- INSTALL GAS MAIN, SANITARY SEWER, WATERMAIN, STORM SEWER AND CABLE UTILITIES.
- NOTICE TO EXCAVATE ALL STORM SEWER INLETS AS THEY ARE CONSTRUCTED.
- FLAT GRADE ALL ROAD SUBGRADE TO WITHIN 10 TO 12 FEET OF DISTURBED AREAS LOW ENOUGH TO ACCEPT 4" (MIN) OF TOPSOIL.
- PLACE STONE SUBGRADE IN PAVED AREAS AND PAVER BINDER COURSE.
- RESEED TOPSOIL TO A DEPTH OF 4" (MIN) ON ALL DISTURBED AREAS, SEED, FERTILIZE AND MULCH AS SPECIFIED. RESTORE UTILITY TRENCHES AFTER CABLE UTILITY INSTALLATION.
- LANDSCAPE PLANTING AND MAINTENANCE REPORT WILL BE FILED WITH THE CITY OF MILWAUKEE.

**EROSION CONTROL INSPECTION AND GENERAL MAINTENANCE NOTES:**

- ALL EROSION CONTROLS MUST BE INSPECTED WEEKLY AND AFTER EACH RAINFALL OF 0.5" OR MORE. REPORTS SHALL BE FILED WITH THE ENGINEER.
- FOLLOWING CONSTRUCTION, CATCH BASIN Sumps shall be cleaned once (1) time per year.
- CONTRACTOR IS RESPONSIBLE FOR REMOVAL OF ALL SILT FENCE, TEMPORARY SKALES, AND SEDIMENT TRAPS.



LANDCRAFT SURVEY AND ENGINEERING, INC.
REG-STERED LAND SURVEYORS AND CIVL ENGRNS
2177 SOUTH 115TH STREET, WEST ALLIS, WI 53227
PH: (414) 654-0874, FAX: (414) 654-6577
INFO@LANDCRAFTSE.COM
DESIGNED BY: A. KOCH, P.E.
CHECKED BY: A. KOCH, P.E.
APPROVED BY:
VILLAGE/CITY ENGINEER DATE
PROJECT NO.: 050376 - REV. DATE: Feb 08, 2007
HOR. SCALE: 1" = 1' VERT. SCALE: 1" = 1'

**DETAILS**  
KANE COMMONS  
CITY OF MILWAUKEE, MILWAUKEE COUNTY, WISCONSIN

SHEET 7 OF 7



(A)

(B)

8" SANITARY PVC, ASTM D-3034,  
SDR-26 CLASS "C" BEDDING8" SANITARY PVC, ASTM D-3034,  
SDR-35 CLASS "C" BEDDING

## BACKFILL KEY

CBP GRANULAR MATERIAL

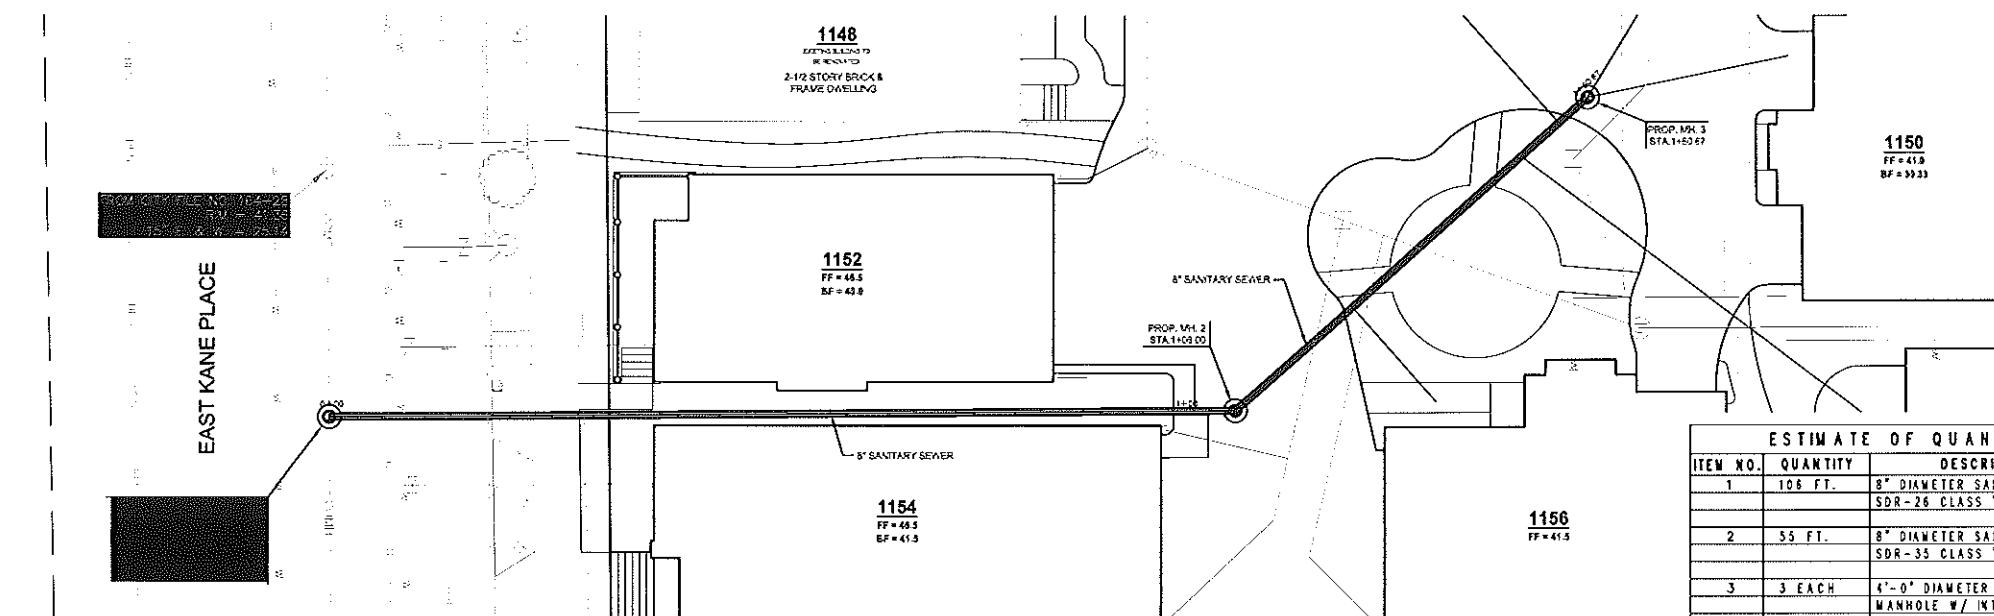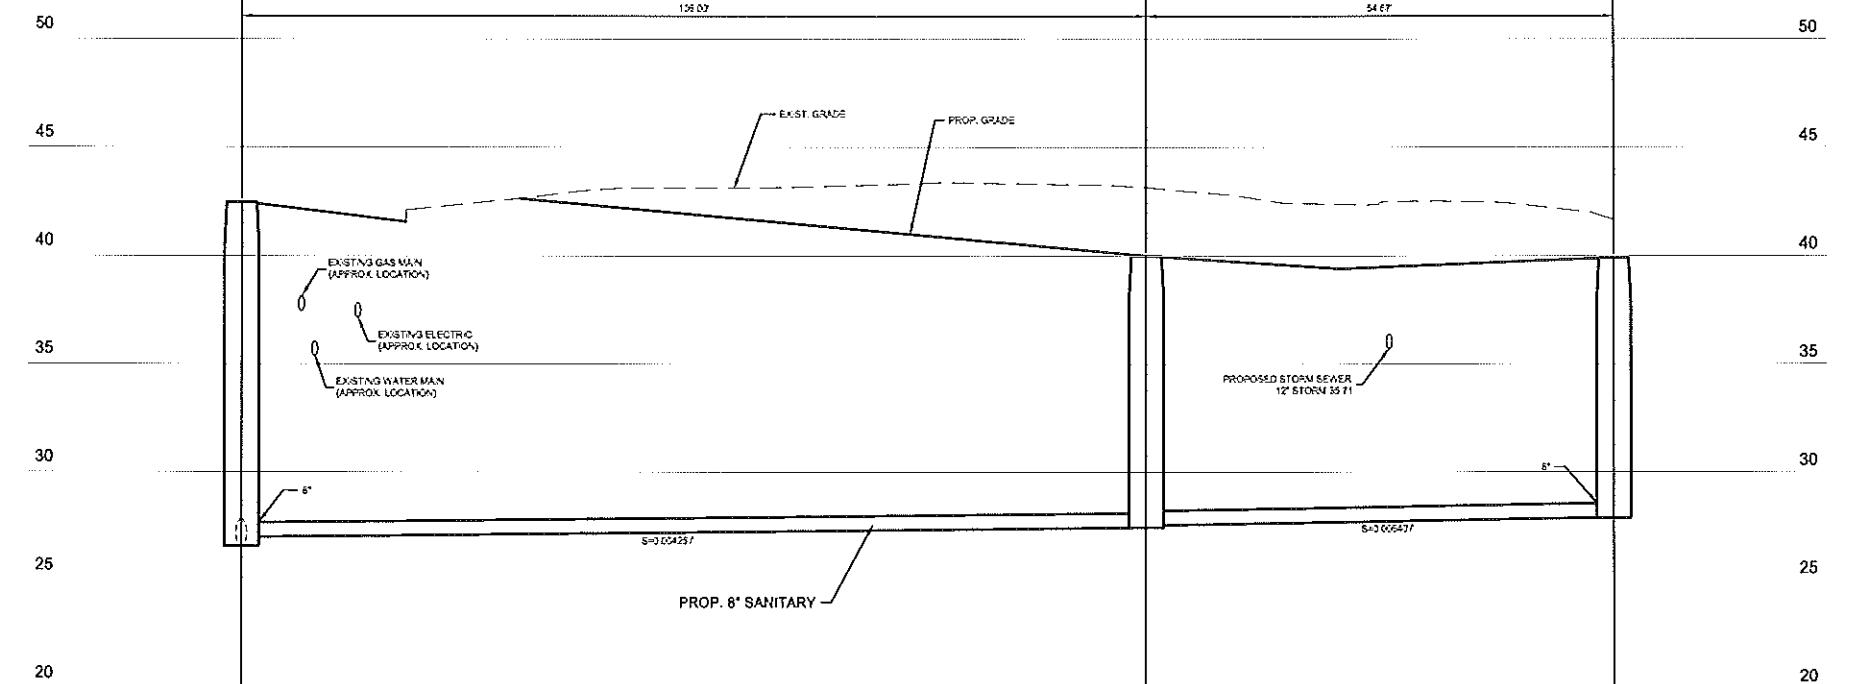

LANDCRAFT SURVEY AND ENGINEERING, INC.  
REGISTERED LAND SURVEYORS AND CIVIL ENGINEERS  
2077 SOUTH 115TH STREET, WEST ALLIS, WI 53227  
PH. (414) 634-0674 FAX (414) 634-0677  
INFO@LANDCRAFTSE.COM

LINE CODE LEGEND	
GAS	C
ELECTRIC	C
TELEPHONE	T
CABLE TELEVISION	T
FIBER OPTICS	T
CITY UNDERGROUND CONDUIT	UC
SANITARY SEWER	SAN
STORM SEWER	STO
COMBINED SEWER	PSD
SEWAGE DISTRICT SEWER	PDS
WATER MAIN	W
SEWER/WATER OVER 24"	SWO
STREET LIGHTING	X
PAVING UNITS	X
STRUCTURE / BUILDING	X
FENCE	X

CALL DIGGERS HOTLINE  
1-800-242-8511  
TOLL FREE TO GET LOCATION OF UNDERGROUND  
BEFORE YOU DO. WISCONSIN STATE REGULATIONS  
REQUIRIES 3 WORK DAYS NOTICE BEFORE YOU DIGAWAY

△	△	△	△
NO. BY	REVISION	DATE	
AS BUILT CONTRACT NO.			
DATE ENT'D.	ENT'D. BY		

## SPECIAL PROVISIONS FOR STORM &amp; SANITARY SEWER

- This project has been submitted to the Milwaukee Metropolitan Sewerage District (MMSD) and the Department of Natural Resources (DNR) for approvals. No work shall be performed on this contract until MMSD and DNR approvals have been obtained. The construction engineer shall contact Mr. Jason Schmitz (MMSD) at 215-2113 or contact Mr. Tim Appel (DNR) at 215-4141, prior to February 06, 2006 or later if inspection documents are not yet available. All work shall be performed in accordance with the "Standard Specifications for Sewer and Water Construction in Wisconsin" 6th edition and addenda thereto unless otherwise specified in the contract documents and under the inspection of the Department of Natural Resources.
- Notice of inspection shall be given by the Contractor to the Superintendent Planning Inspection Division Department of Building Inspection (telephone number 215-3551) forty-eight (48) hours before commencing work on the project.
- The Owner shall provide access to the project for the inspection of the work on a daily basis.
- A public works inspector will be assigned by the owner. No work shall be started on the private main sewer until the necessary inspection has been completed by the public works inspector.
- The public works inspector will be通知 by the owner. All work shall be started on the private main sewer until the necessary inspection has been completed by the public works inspector.
- The Owner shall provide access to be prepared as "as-built" of the private main sewer.
- Any changes in location, elevation, or materials from those shown on the original plans shall be approved by the owner engineering division and must be put up "as-built" prints shall be furnished upon completion of the sewer work for record purposes.
- All changes shall be supplied by the Owner. The contractor shall be responsible for all costs of inspection and removal of any changes made by the Owner.
- The "Proposed Storm Sewer" plan is located at 115 ft from the proposed location of the vertical lead and a horizontal pull out of 450 ft. section 413 110 of the City of Milwaukee sewer and water service specifications is revised using 1/4 inch diameter reinforcing bar.
- The backfill of the trench shall be compacted to the density of the original soil to the top of the trench.
- The minimum vertical distance from the top of the trench to the top of the worked surface or flat slab top shall be 22 inches.
- The worked surface shall meet the requirement of chapter 200 of the Milwaukee code of ordinance.
- All trenchable pipe used on the contract shall be capable of withstanding a minimum design vertical load of 450 lbs with a maximum percentage of 10% both when positioned in the vertical lead and a horizontal pull out of 450 ft. section 413 110 of the City of Milwaukee sewer and water service specifications is revised using 1/4 inch diameter reinforcing bar.
- The backfill of the trench shall be compacted to the density of the original soil to the top of the trench.
- The Owner shall perform a testing laboratory designated by the City of Milwaukee.
- The Contractor shall comply with the City of Milwaukee, Department of Public Works booklet "Traffic Control and Maintenance Work and Job IV of the State of Wisconsin "Manual on Uniform Traffic Control Devices".
- The Contractor shall comply with all Federal, State, and Local Laws and regulations regarding protection of the environment, including zoning and permits issued by the City of Milwaukee, the State of Wisconsin, and the U.S. Environmental Protection Agency. It is the responsibility of the Contractor to obtain all required permits and approvals for the project. All permits and approvals shall conform to the requirements associated with existing laws requirements shall be held for a maximum of two years from the date of issuance with the "Code Plus Rule" for future work.
- The said environmental plan - land reuse plan (John Evans, 41-4621, issued May 13, 1999) is part of this contract.
- Land reuse plan - land reuse plan (John Evans, 41-4621, issued May 13, 1999).
- The Contractor shall furnish an internal inspection seal, such as from Cross Company or Adeptor, or equal for each sanitary manhole. The cost of providing and installing the seal shall be included in the unit price bid for the sanitary sewer.
- The Contractor shall perform vacuum testing on each new sanitary manhole built on this project in accordance with section 37.6 of the "Standard Specifications for Sewer and Water Construction in Wisconsin" 6th edition and addenda thereto unless otherwise specified in the contract documents. The cost of vacuum testing shall be included in the unit price bid for the sanitary manhole.
- Gravel backfill is required.
- Compaction of backfill shall be done in accordance with the standard specifications for sewer and water construction in Wisconsin section 2.6.37. Trench maintenance is the responsibility of the Contractor.
- Contractors shall remove all loose material from the trench bottom before backfilling.
- Contractors shall be responsible for not disturbing existing sanitary sewer. Should a disturbance from the trench occur, the street shall be removed by trench cleaning subcontractor before the end of each workday.
- High-density polyethylene (HDPE) pipe may be used for the sanitary sewer on this project. HDPE pipe manufactured for the specification shall be used and must meet the requirements for the specific type of HDPE pipe and pipe size and shall be ASTM D-3354 and AASHTO M-252. All HDPE pipe shall be supplied by HDPE Pipe Company. HDPE pipe shall conform to the requirements of table 435.00 in the latest version of ASTM D-3354. A manufacturer's certificate that the pipe provided meets these requirements shall accompany the first shipment of pipe for a given project. The certificate shall explicitly certify that it applies to all elements of pipe for the given project.
- Normal items for HDPE used on this project are as defined in ASTM D-3341 and ASTM D-3342 as HDPE circular cross-section pipe. HDPE pipe shall be supplied by HDPE Pipe Company. Pipe connections shall be HDPE.
- Plastic pipe shall be straight and consist of either integral bell and spigot with rubber gasket or meet specification requirements of ASTM F-477. Bell and spigot or other types of connections. Water tight pipe joints shall meet a laboratory pressure test of least 10.8 PSI following ASTM D-3211.
- Plastic pipe shall be supplied by HDPE Pipe Company in function of the project and shall meet the requirements of ASTM D-3341 and ASTM D-3342. Only fittings listed are recommended by the Manufacturer shall be used. Pipe to manhole connection shall conform to section 3.7 of the standard specifications for sewer and water construction in the state of Wisconsin, 6th edition for flexible or plastic pipe.
- The Contractor is required to perform a deflection test on the entire length of installed main line pipe at no additional cost to the City of Milwaukee. The test shall be conducted after the main line has been placed and backfilled but before paving is completed. All sections of main line pipe less than 50 ft. shall be tested. All sections of main line pipe greater than 50 ft. the objective being on the 50 ft. increments. Deflection testing on the remaining 50 ft. sections shall be conducted by Manual. For 33-inches or larger, the deflection test may be accomplished by physical measurement or by other methods approved by the engineer.

WISCONSIN  
PROFESSIONAL ENGINEER  
*Aaron E. Koch*  
E-14459  
MONROVIA  
Falls, WI  
12/07/06

0 10 20

SHEET 2 OF 2 IS PLAN FILE NO. PM-275

ESTIMATE OF QUANTITIES		ENVIRONMENTAL ENGINEERING SECTION	
ITEM NO.	QUANTITY	DESCRIPTION	INFRASTRUCTURE SERVICES DIVISION
1	106 FT.	8" DIAMETER SANITARY SEWER SDR-26 CLASS "C" BEDDING	DEPARTMENT OF PUBLIC WORKS MILWAUKEE, WISCONSIN
2	55 FT.	8" DIAMETER SANITARY SEWER SDR-35 CLASS "C" BEDDING	SANITARY SEWER MAIN PLAN
3	3 EACH	4'-0" DIAMETER SANITARY SEWER MANHOLE w/ INTERNAL SEALS	IN KANE COMMONS
4	3 EACH	SANITARY MANHOLE VACUUM TESTING	FROM --
5	161 FT.	SANITARY AIR TESTING	TO --
			HORIZONTAL 1" = 4' VERTICAL 1" = 10'
			APPROVED DATE
			1/4 SEC. NO. 355
			DESIGN ENGINEER
			PLAN RATE
			DRAWN BY
			CHECKED BY
			DESIGNED BY
			SYSTEM NO. 3019
			EASEMENT NO.
			PROJECT NO. 050376 C.C. FILE NO.
			CONTRACT NO.
			PERIOD D. 07. NOTICE NO. RATE ADDED
			SHEET NO. 1 OF 2 PLAN FILE NO. PM-274



INCORPORATED

A

12" STORM HDPE

### BACKFILL KEY

**GBF GRANULAR MATERIAL**

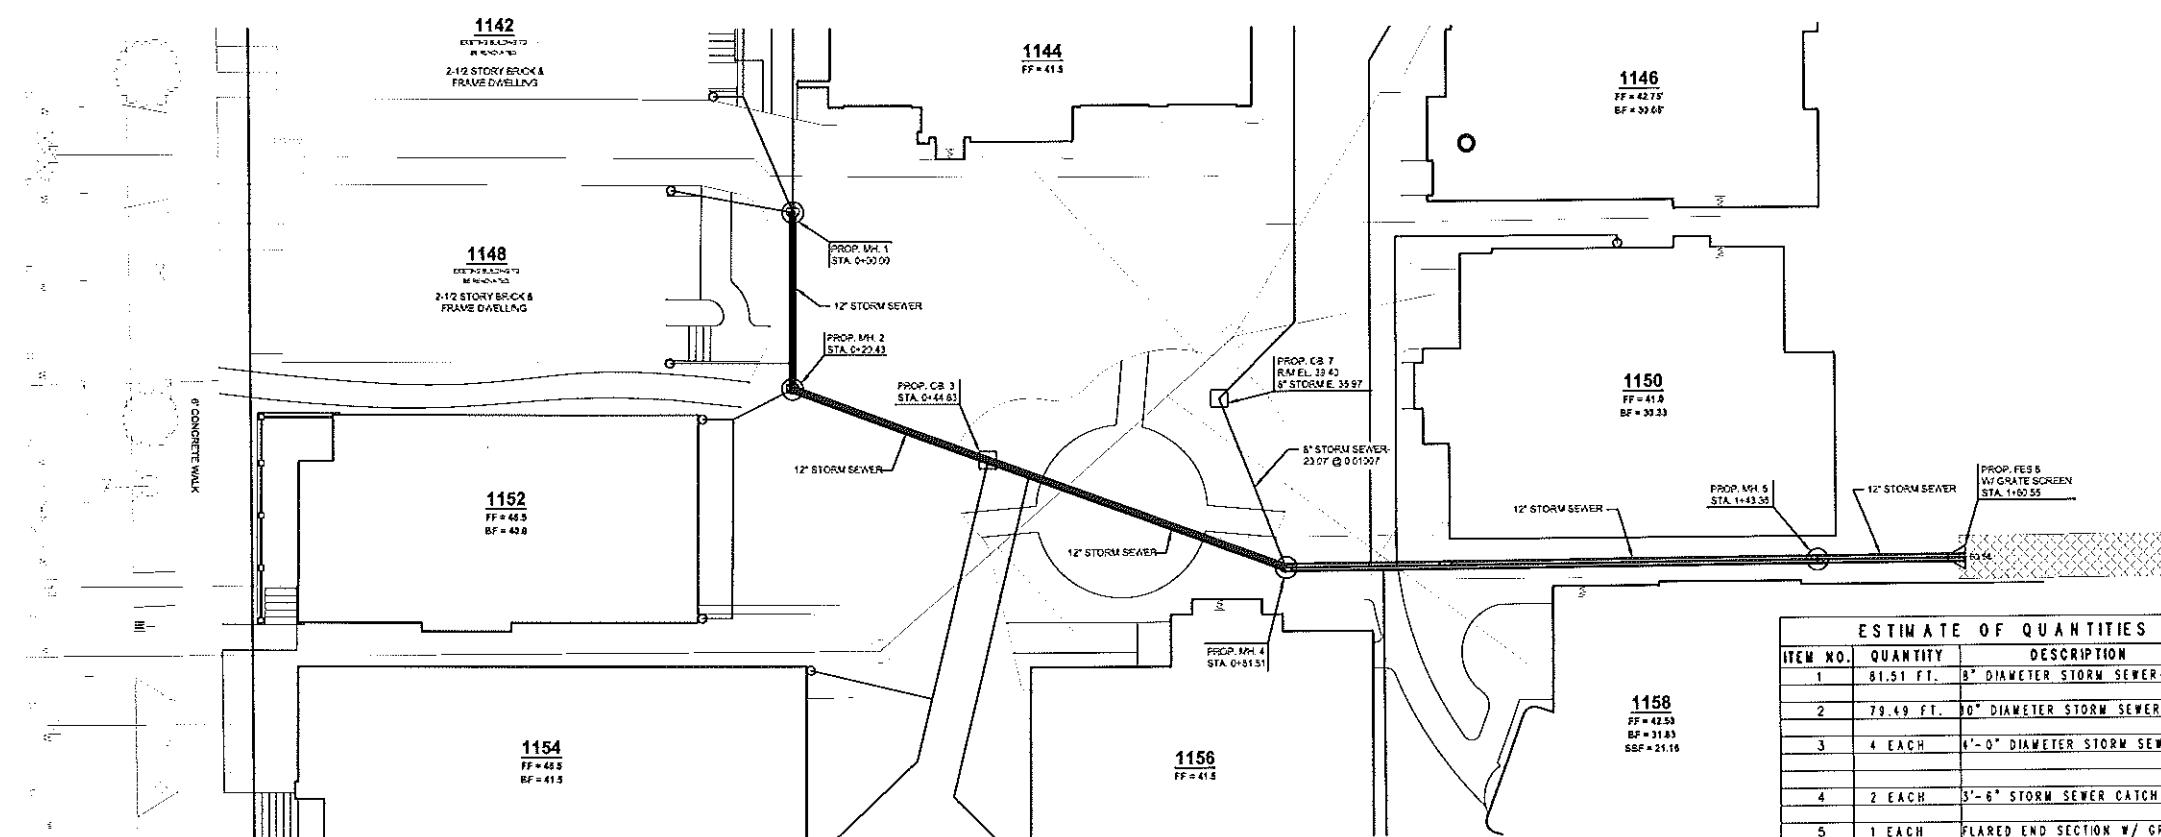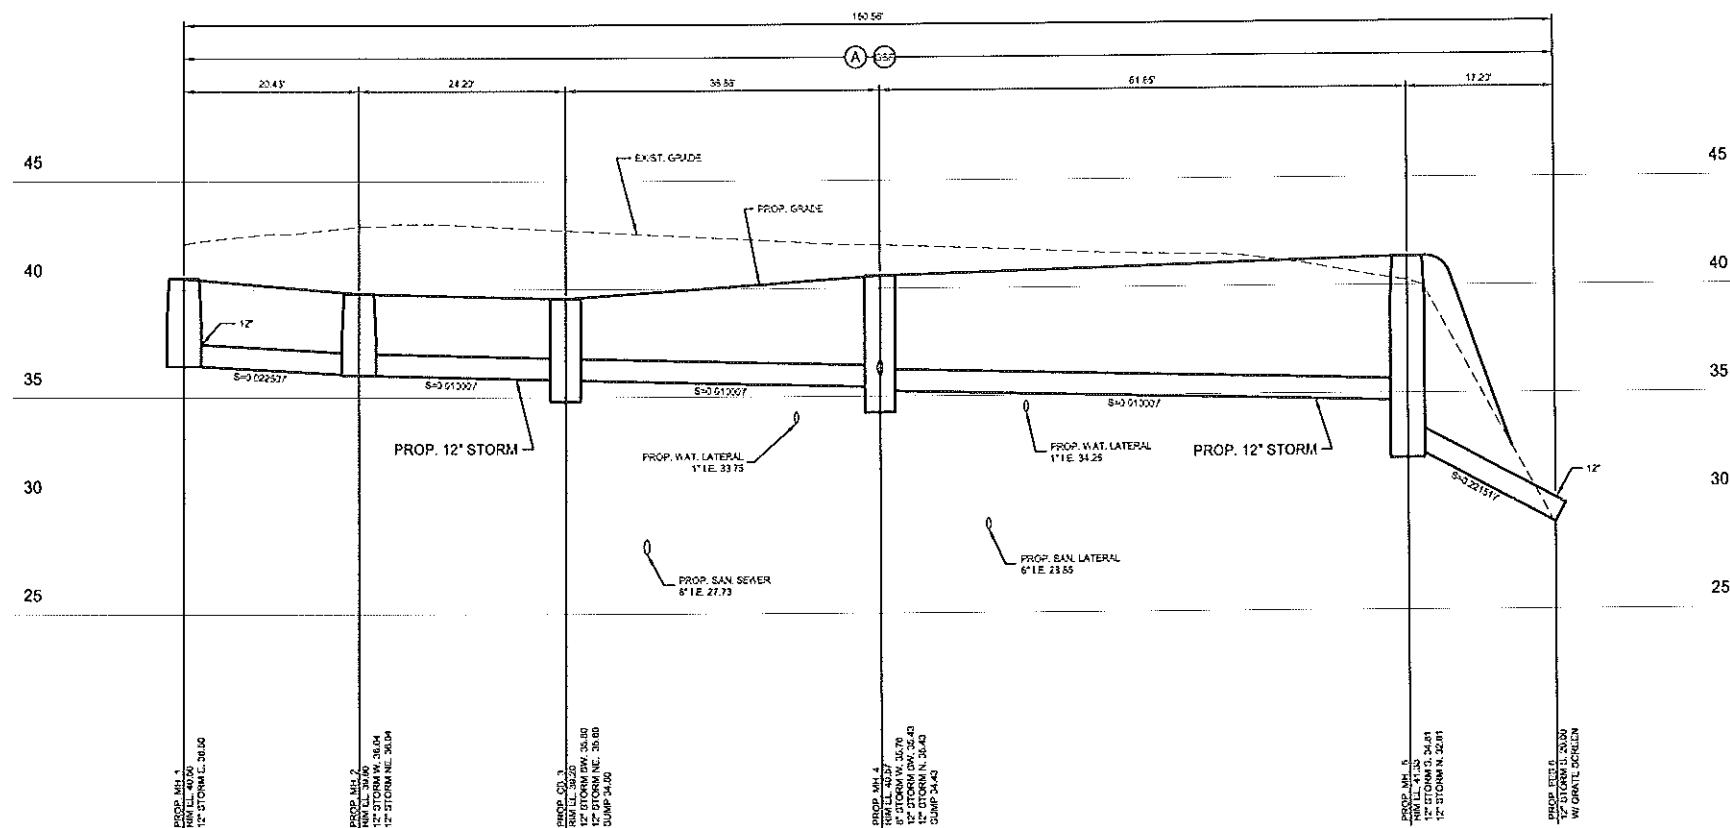

**LANDCRAFT SURVEY AND ENGINEERING, INC.**  
REGISTERED LAND SURVEYORS AND CIVIL ENGINEERS  
2077 SOUTH 11th STREET, WEST ALLIS, WI 53227  
PH. (414) 604-0674 FAX (414) 604-0677  
[INFO@LANDCRAFTWI.COM](http://INFO@LANDCRAFTWI.COM)

LINE CODE LEGEND					
GAS	G	SANITARY SEWER	SAN	STREET LIGHTING	
ELECTRIC	E	STORM SEWER	STD	PAVING LIMITS	X X X X
TELEPHONE	T	COMBINED SEWER	CWB	STRUCTURE / BUILDING	/ / / /
CABLE TELEVISION	TV	SEWDISTRICT SEWER	KWSO	FENCE	X
FIBER OPTICS	FO	WATER MAIN	W		
CITY UNDERGROUND CONDUIT	UC	SEWER/WATER OVER 24"			



**CALL DIGGERS HOTLINE  
1-800-242-8511**  
**FILL FREE TO GET AN LOCATION OF UNDERGROUND  
BEFORE YOU DIG. HEDDISH STATION 182-D-5 RE  
MIL OF 3 WORK DAYS NOTICE BEFORE YOU EXC**

		-----
<b>NO.</b>	<b>BY</b>	<b>REVISION</b>
AS BUILT CONTRACT NO. -----		
DATE ENT'D. -----		ENT'D. BY -----

SHEET 1 OF 2 IS PLAN FILE NO. PM-274

**ENVIRONMENTAL ENGINEERING SECTION  
INFRASTRUCTURE SERVICES DIVISION  
DEPARTMENT OF PUBLIC WORKS**

**MILWAUKEE, WISCONSIN**  
**STORM SEWER MAIN PLAN**

KANE COMMONS

Digitized by srujanika@gmail.com

HORIZONTAL 1° = 4'  
VERTICAL 1° = 10'

4 SEC. B0. 355 DESIGN ENGINEER

**CAREER DESIGN ENGINEER**


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ITEM NO. 3019

PROJECT NO. 050376 C.C. FILE NO. \_\_\_\_\_


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SHEET NO. 2 OF 2 PLAN FILE NO. PM-275




EAST KANE PLACE

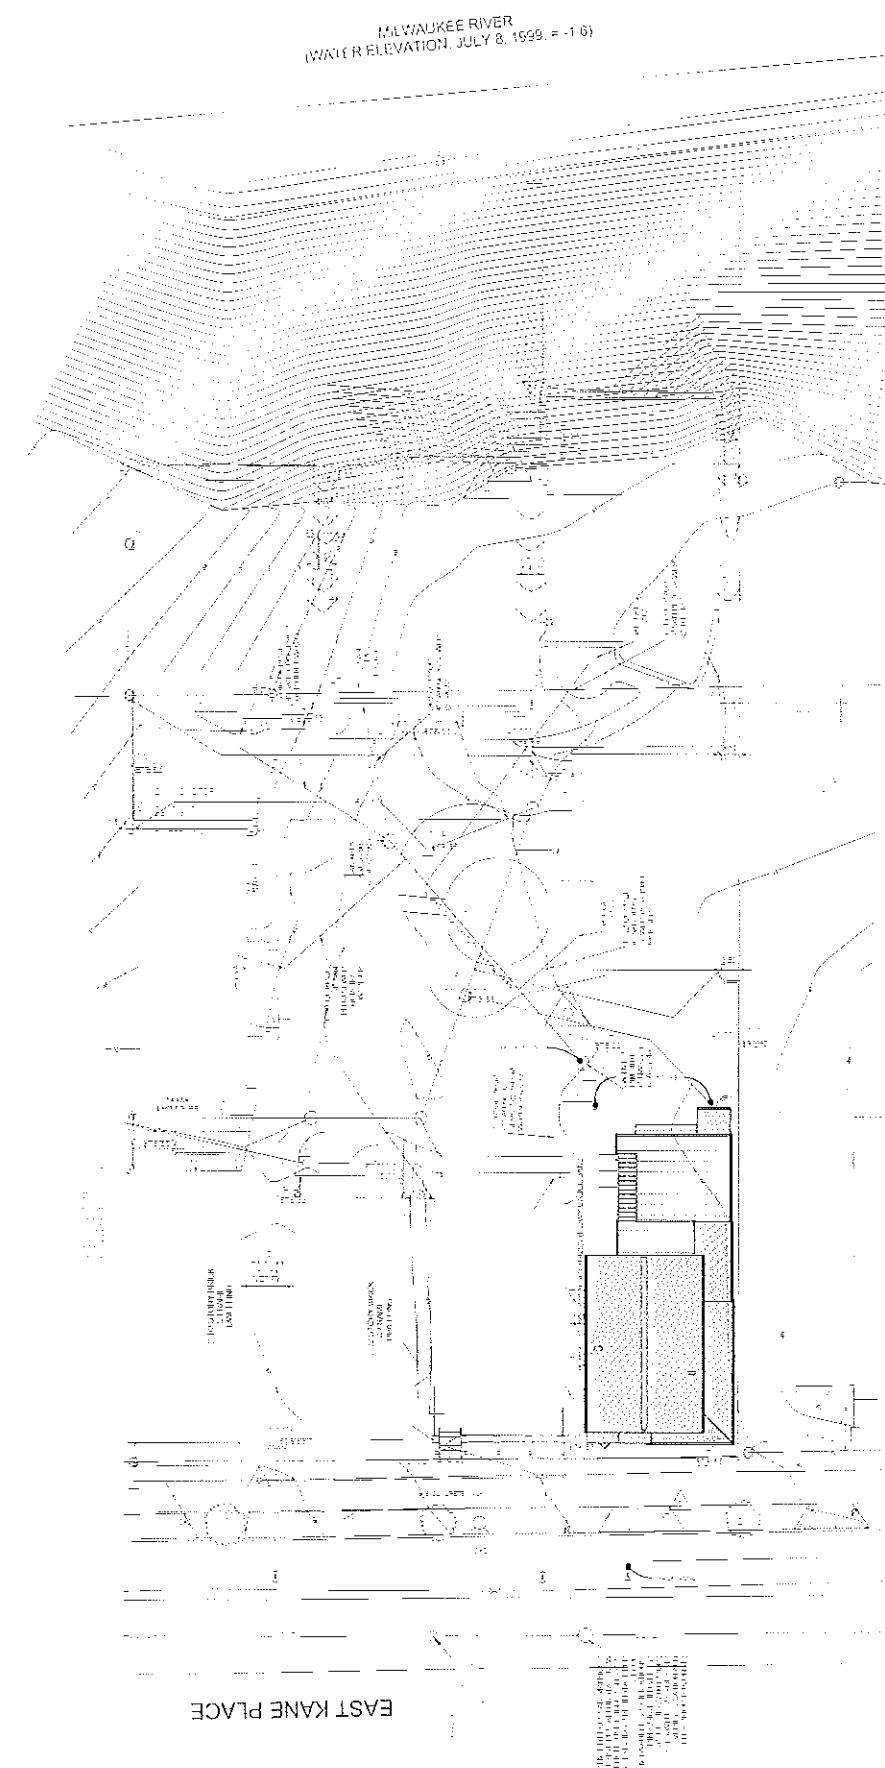
1 PROPOSED OVERALL SITE PLAN

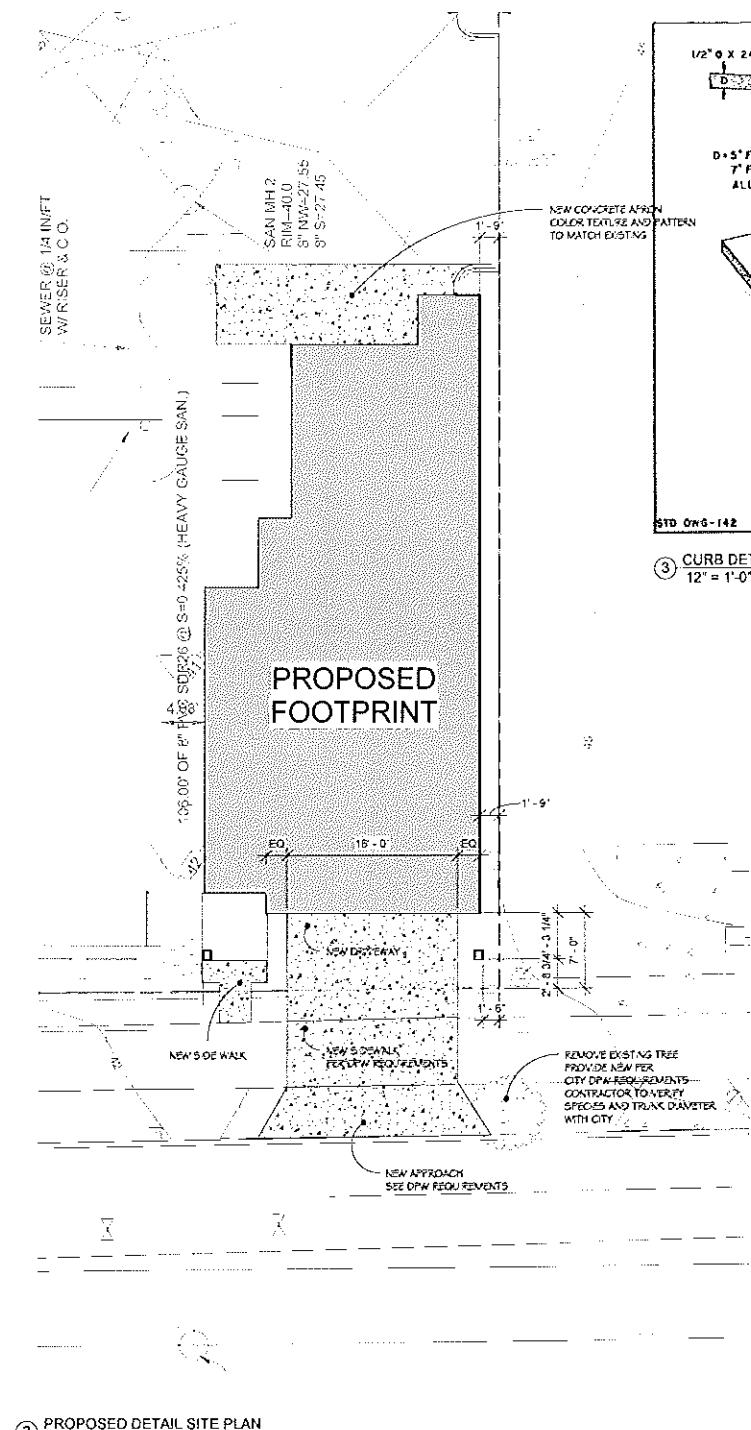

② PROPOSED DETAIL SITE PLAN  
1/8" = 1'-0"

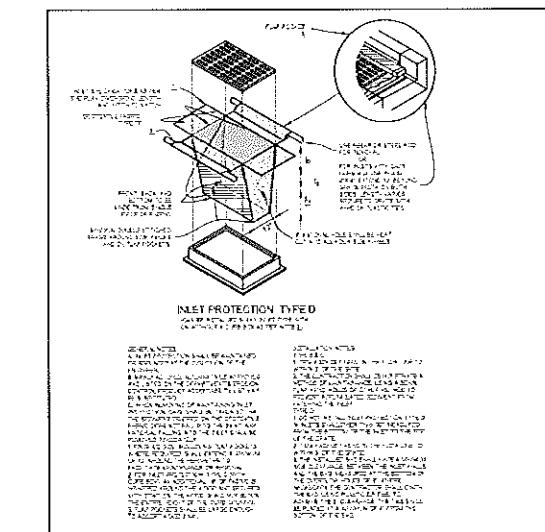

**4 INLET DETAIL**

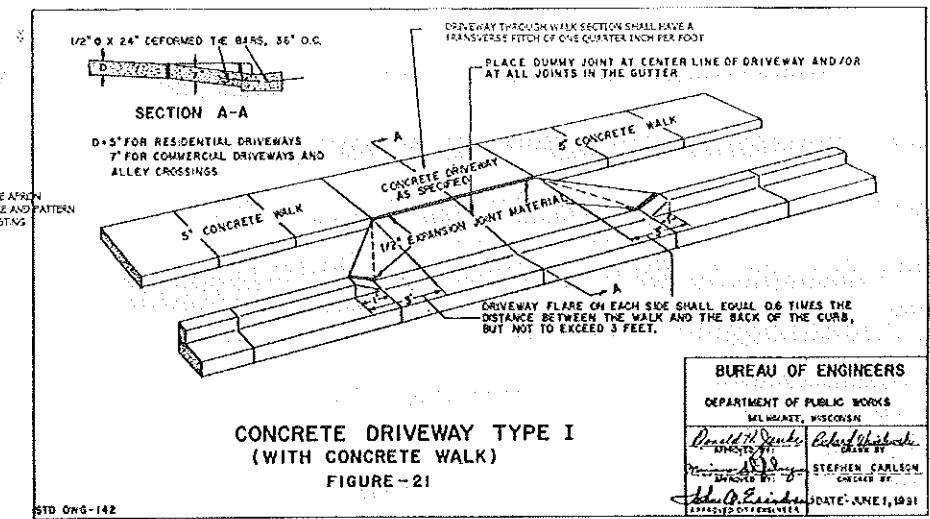

**CONCRETE DRIVEWAY TYPE I  
(WITH CONCRETE WALK)**

**FIGURE - 2**

New Residence for  
**JON HANSEN**  
Kane Commons  
1170 East Kane Place  
Milwaukee, Wisconsin



russell e. lafrombois, aia architect, llc  
229 east wisconsin avenue  
suite 701  
milwaukee wisconsin 53202  
phone 414-727-1141  
fax 414-727-1142  
email russ@rel-3.com  
web www.rel-3.com

Sheet Number  
SITE PLAN AND  
DETAILS

C1

## **DIGGERS HOTLINE**

Date 03-10-16  
Project Number: 158001

New Residence for  
**JON HANSEN**

Kane Commons  
1170 East Kane Place  
Milwaukee, Wisconsin



russell e. lafrombois, architect, llc  
229 east wisconsin avenue  
suite 701  
milwaukee wisconsin 53202  
phone 414-727-1141  
fax 414-727-1142  
email russel@rel-3.com  
web www.rel-3.com

WINDOW SCHEDULE							
Type Mark	Level	Height	Width	Head Height	Manufacturer	Product Name	Model
8	ENTRY LEVEL	3' - 0"	1' - 9 3/8"	7' - 0"	JELD-WEN		TCD2136
1	SECOND FLOOR	4' - 8"	2' - 1 3/8"	7' - 0"	JELD-WEN		TCD2556
1	SECOND FLOOR	4' - 8"	2' - 1 3/8"	7' - 0"	JELD-WEN		TCD2556
1	SECOND FLOOR	4' - 8"	2' - 1 3/8"	7' - 0"	JELD-WEN		TCD2556
2	SECOND FLOOR	6' - 0"	2' - 9 3/8"	8' - 6"	JELD-WEN		TCD3372
2	SECOND FLOOR	6' - 0"	2' - 9 3/8"	8' - 6"	JELD-WEN		TCD3372
2	SECOND FLOOR	6' - 0"	2' - 9 3/8"	8' - 6"	JELD-WEN		TCD3372
2	SECOND FLOOR	6' - 0"	2' - 9 3/8"	8' - 6"	JELD-WEN		TCD3372
3	SECOND FLOOR	3' - 4"	1' - 9 3/8"	8' - 6"	JELD-WEN		TCD2140
3	SECOND FLOOR	3' - 4"	1' - 9 3/8"	8' - 6"	JELD-WEN		TCD2140
3	SECOND FLOOR	3' - 4"	1' - 9 3/8"	8' - 6"	JELD-WEN		TCD2140
3	SECOND FLOOR	3' - 4"	1' - 9 3/8"	8' - 6"	JELD-WEN		TCD2140
4	SECOND FLOOR	2' - 8"	2' - 6"	8' - 6"	JELD-WEN		TCC3032
4	SECOND FLOOR	2' - 8"	2' - 6"	8' - 6"	JELD-WEN		TCC3032
4	SECOND FLOOR	2' - 8"	2' - 6"	8' - 6"	JELD-WEN		TCC3032
4	SECOND FLOOR	2' - 8"	2' - 6"	8' - 6"	JELD-WEN		TCC3032
4	SECOND FLOOR	2' - 8"	2' - 6"	8' - 6"	JELD-WEN		TCC3032
6	SECOND FLOOR	0' - 11 1/2"	3' - 2 1/2"	8' - 1 27/32"	Kobe & Kobe M/work Co., Inc.	Ultra Series Entrance Doors	GAUT3310
6	SECOND FLOOR	0' - 11 1/2"	3' - 2 1/2"	8' - 1 27/32"	Kobe & Kobe M/work Co., Inc.	Ultra Series Entrance Doors	GAUT3310
6	SECOND FLOOR	0' - 11 1/2"	3' - 2 1/2"	8' - 1 27/32"	Kobe & Kobe M/work Co., Inc.	Ultra Series Entrance Doors	GAUT3310
9	SECOND FLOOR	5' - 4"	2' - 1 3/8"	8' - 6"	JELD-WEN		TCD2564
9	SECOND FLOOR	5' - 4"	2' - 1 3/8"	8' - 6"	JELD-WEN		TCD2564
2	THIRD FLOOR	6' - 0"	2' - 9 3/8"	7' - 0"	JELD-WEN		TCD3372
2	THIRD FLOOR	6' - 0"	2' - 9 3/8"	7' - 0"	JELD-WEN		TCD3372
7	THIRD FLOOR	2' - 0"	2' - 8"	5' - 9 1/2"	JELD-WEN		TCA3224
7	THIRD FLOOR	2' - 0"	2' - 8"	5' - 9 1/2"	JELD-WEN		TCA3224
7	THIRD FLOOR	2' - 0"	2' - 8"	5' - 9 1/2"	JELD-WEN		TCA3224
7	THIRD FLOOR	2' - 0"	2' - 8"	5' - 9 1/2"	JELD-WEN		TCA3224
7	THIRD FLOOR	2' - 0"	2' - 8"	5' - 9 1/2"	JELD-WEN		TCA3224
7	THIRD FLOOR	2' - 0"	2' - 8"	5' - 9 1/2"	JELD-WEN		TCA3224
7	THIRD FLOOR	2' - 0"	2' - 8"	5' - 9 1/2"	JELD-WEN		TCA3224
8	THIRD FLOOR	3' - 0"	1' - 9 3/8"	12' - 0"	JELD-WEN		TCD2136
8	THIRD FLOOR	3' - 0"	1' - 9 3/8"	12' - 0"	JELD-WEN		TCD2136

INTERIOR FINISHES AND EQUIPMENT	
Key Value	Keynote Text
CT-1	WALL TILE: FIREPLACE
EQ-1	VANITY MIRROR- PROVIDED BY OWNER INSTALLED BY CONTRACTOR
EQ-2A	CABINET: VANITY 1 DRAWER NOM 19DX24WX33T
EQ-2B	CABINET: KITCHEN 2 DOOR SINK NOM 24DX45WX34.5T
EQ-2C	CABINET: KITCHEN 4 DRAWER NOM 24DX12WX34.5T
EQ-2D	CABINET: KITCHEN 2 DOOR/2 DRAWER NOM 24DX30WX34.5T
EQ-2E	CABINET: KITCHEN 4 DRAWER NOM 24DX15WX34.5T
EQ-2F	CABINET: KITCHEN 4 DRAWER NOM 24DX18WX34.5T
EQ-2G	CABINET: KITCHEN 2 DOOR/2 DRAWER NOM 24DX27WX34.5T
EQ-2H	CABINET: KITCHEN 2 DOOR UPPER NOM 18DXW36WX18T
EQ-2I	CABINET: KITCHEN 2 DOOR UPPER NOM 18DX30WX30T
EQ-2J	CABINET: KITCHEN 2 DOOR UPPER NOM 18DX30WX12T
EQ-2K	CABINET: KITCHEN 1 DOOR UPPER NOM 18DX18WX30T
EQ-2L	CABINET: KITCHEN 1 DOOR TRASH NOM 24DX15WX34.5T
EQ-3	DISHWASHER
EQ-4	DROP IN RANGE
EQ-5	MICROWAVE/EXHAUST FAN
EQ-6	REFRIGERATOR
EQ-7	TV
EQ-8	FIREPLACE
EQ-9	STACKABLE WASHER AND DRYER
L-1	EXTERIOR RECESSED LIGHT:
L-2	DECORATIVE PENDANT:
L-3	FLUOR UTILITY LIGHT
L-4	SMALL PENDANT
L-5	DINING ROOM PENDANT
L-6	DECORATIVE WALL SCONCE
L-7	CEILING FAN W/LIGHT
L-8	SURFACE MOUNTED CEILING LIGHT
L-9	INTERIOR RECESSED LIGHT
L-10	TRACK LIGHTING
L-11	UNDERCABINET LIGHT
L-12	WALL MOUNTED UTILITY LIGHT MOUNT ABOVE DOOR
L-13	STAIR PENDANT
P-1	VANITY SINK
P-2	VANITY FAUCET
P-3	TOILET:
P-4	KITCHEN SINK:
P-5	KITCHEN FAUCET
P-6	DROP IN TUB ENCLOSURE
P-7	TUB FAUCET AND SHOWER CONTROLS
P-8	DROP IN SHOWER ENCLOSURE
P-9	SHOWER ASSEMBLY AND CONTROLS
OZ-1	QUARTZ COUNTER
WD-1	WOOD BASE 1X3 POPAR PAINTED

EXTERIOR FINISHES	
MARK	DESCRIPTION
EX-1	COMPOSITE TRIM BOARD
EX-2	COMPOSITE PANEL
EX-3	4" EXPOSED LAP SIDING
EX-4	FIBERGLASS SHINGLES
EX-5	COMPOSITE BRACKET
EX-6	ALUM GUTTER
EX-7	DOWNSPOUT
EX-8	RIDGE VENT
EX-9	COMPOSITE GUARDRAIL
EX-10	COMPOSITE DECKING
EX-11	COMPOSITE CLAD COLUMN





**Sheet Number  
SCHEDULES**

A0

New Residence for  
**JON HANSEN**  
Kane Commons  
1170 East Kane Place  
Milwaukee, Wisconsin



russell e. lafombais, architect, llc  
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Sheet Number  
**FLOOR PLANS**

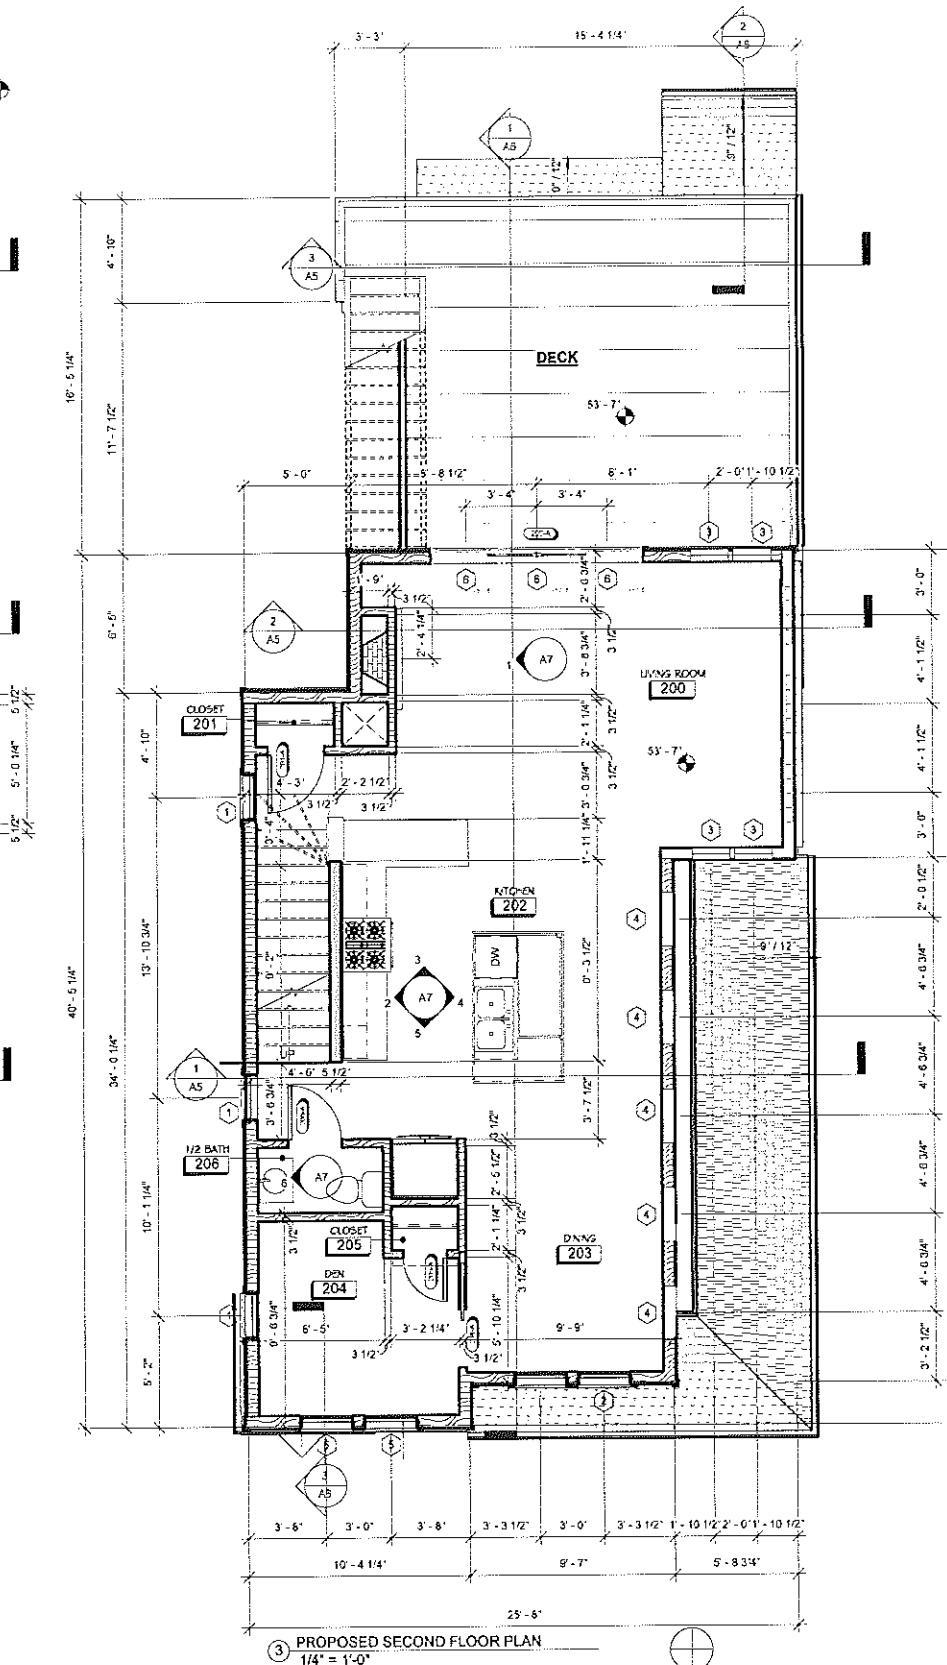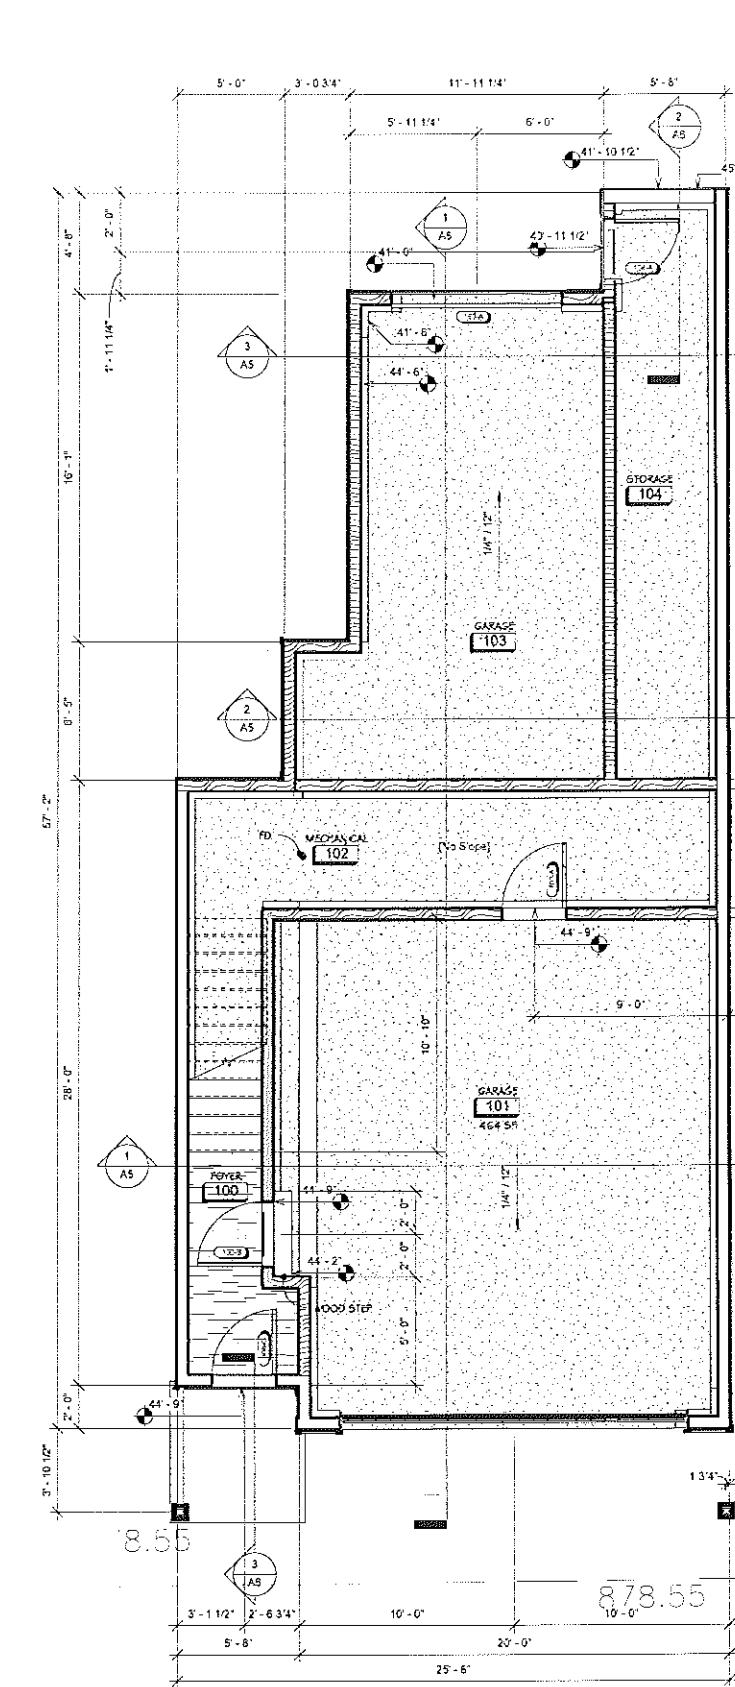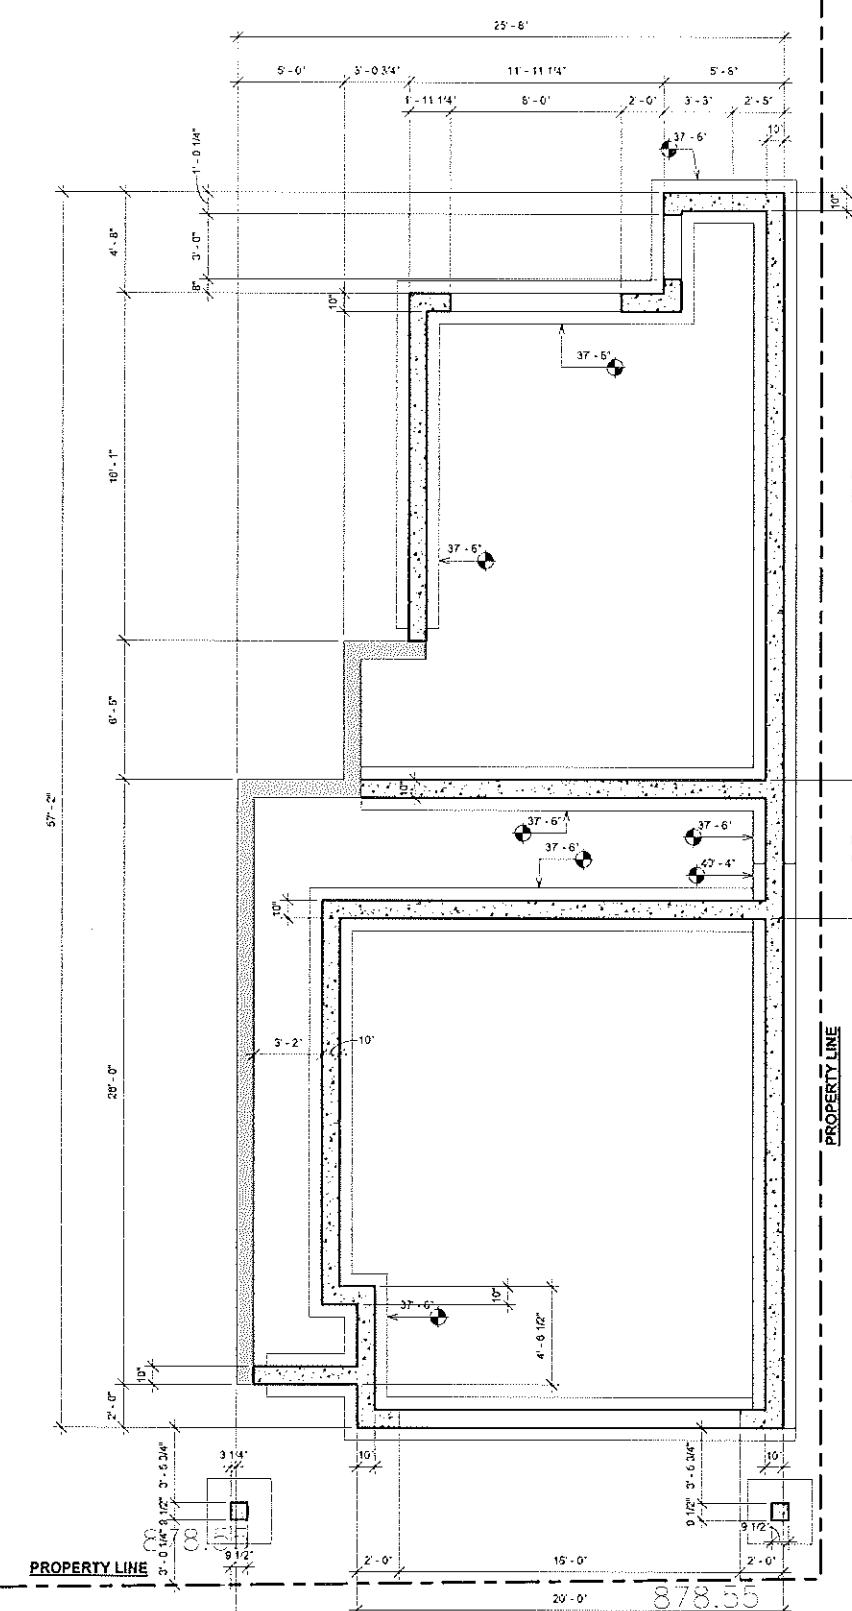
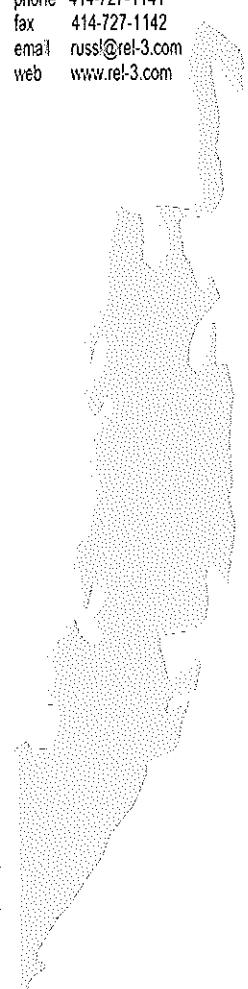
**A1**

Date 03-10-16  
Project Number: 158001


New Residence for  
**JON HANSEN**  
 Kane Commons  
 1170 East Kane Place  
 Milwaukee, Wisconsin



russell e. lafrenbois, architect, llc  
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 suite 701  
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① PROPOSED THIRD FLOOR PLAN  
 $1/4'' = 1'-0''$

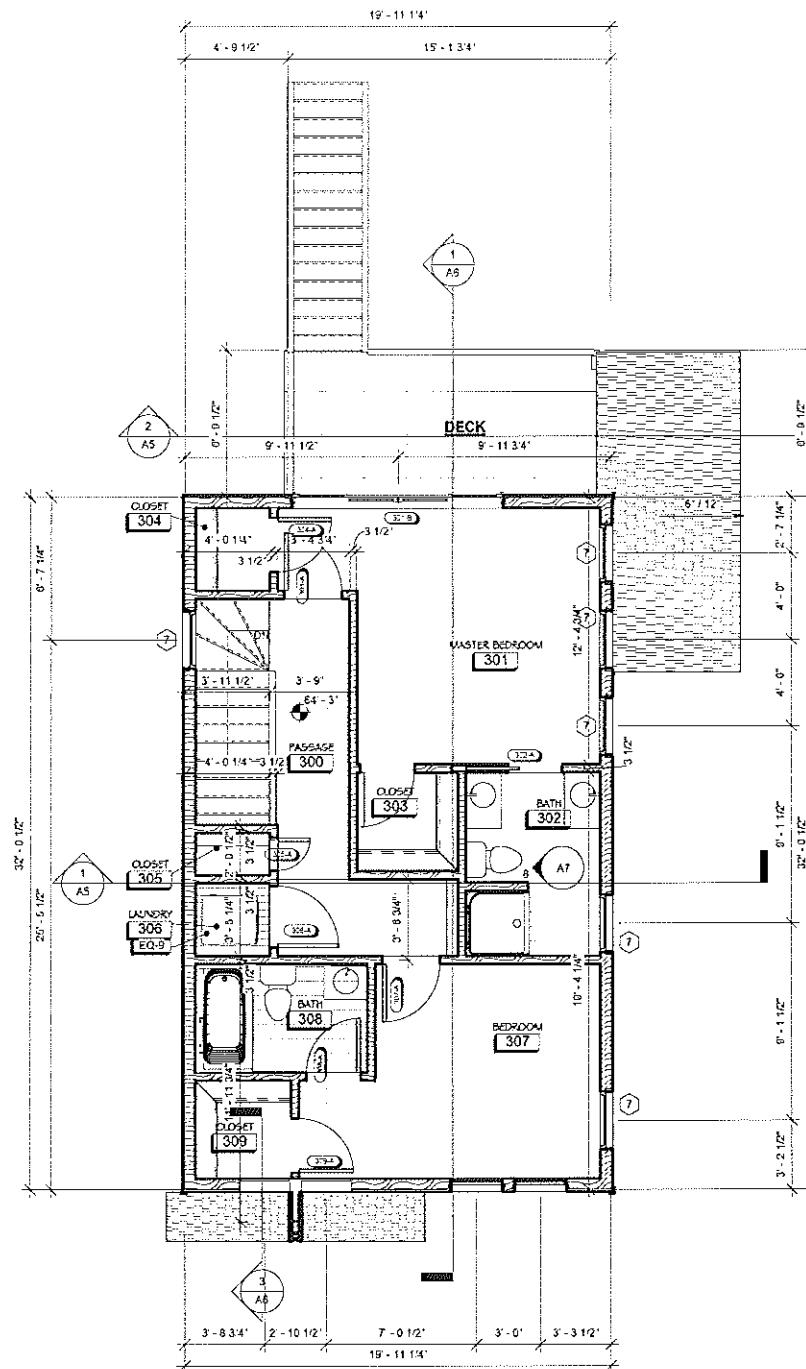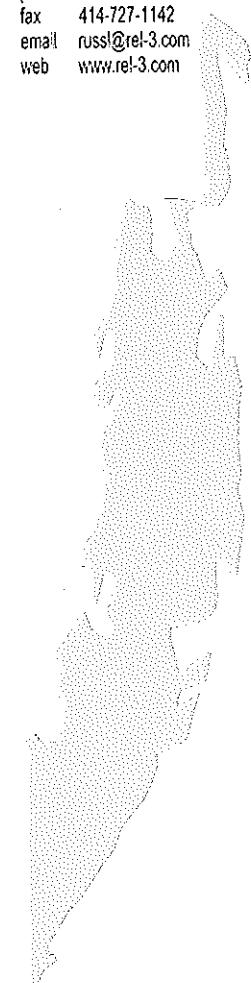

② PROPOSED ROOF PLAN  
 $1/4'' = 1'-0''$

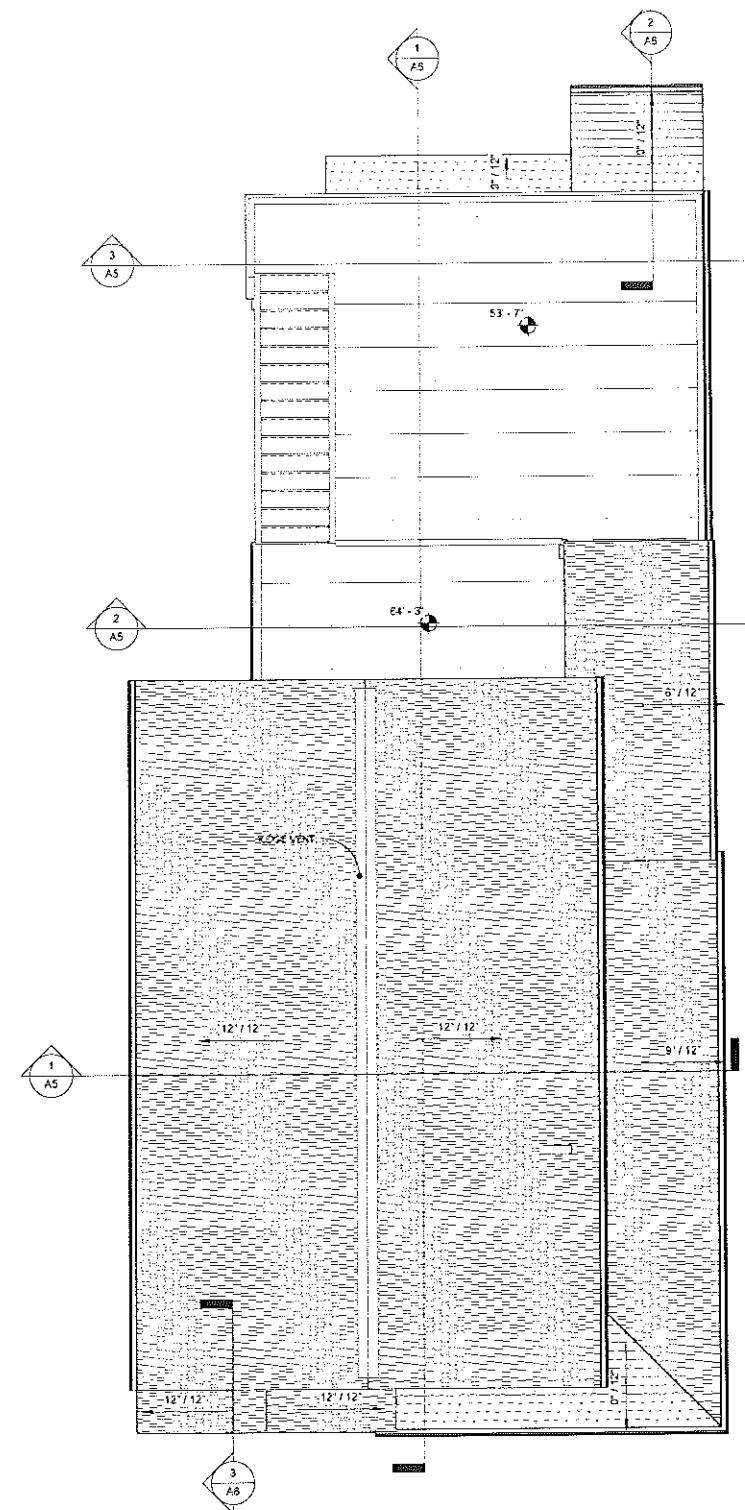Sheet Number  
 FLOOR PLANS

A2


Date 03-10-16  
 Project Number: 158001

New Residence for  
**JON HANSEN**


Kane Commons  
1170 East Kane Place  
Milwaukee, Wisconsin




russell e. lafrombok, architect, lc  
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PROPOSED FIRST FLOOR REFLECTED  
CEILING PLAN  
① 1/4" = 1'-0"

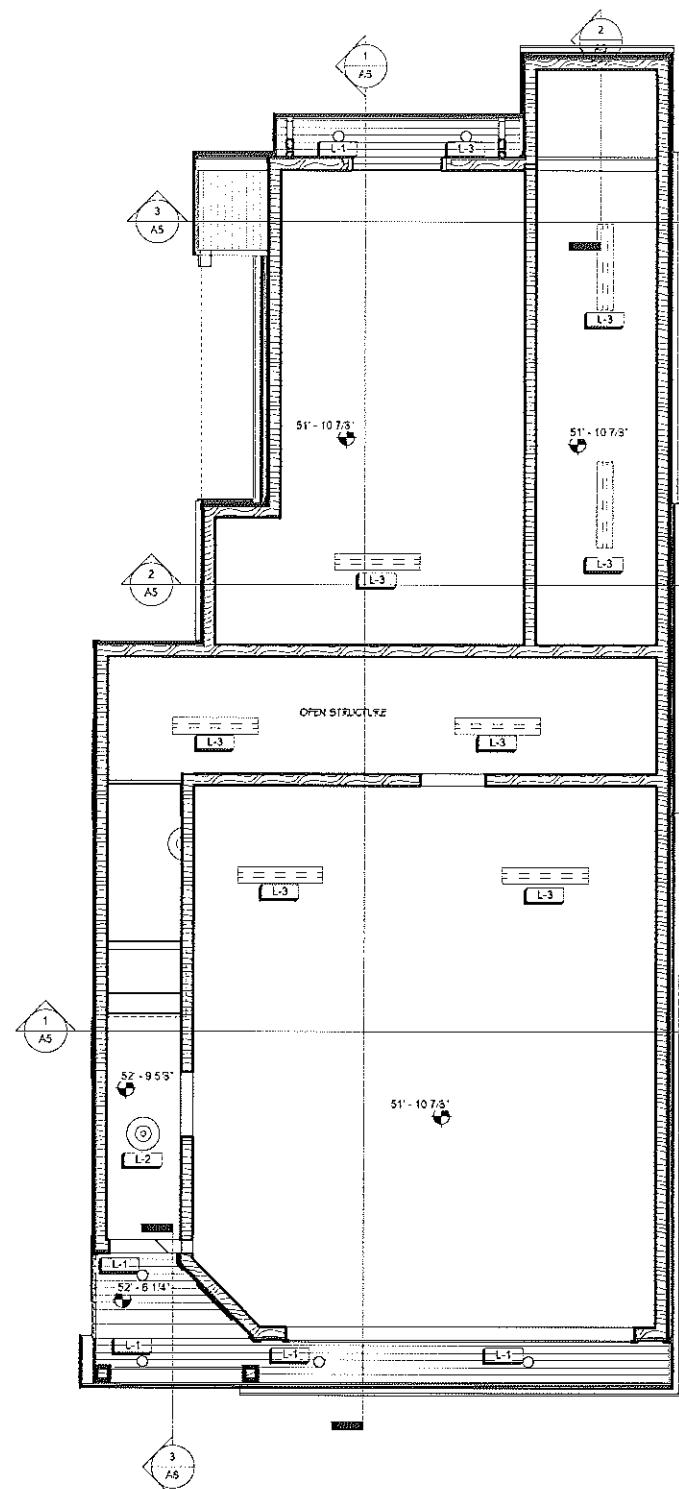

PROPOSED SECOND FLOOR REFLECTED  
CEILING PLAN  
② 1/4" = 1'-0"

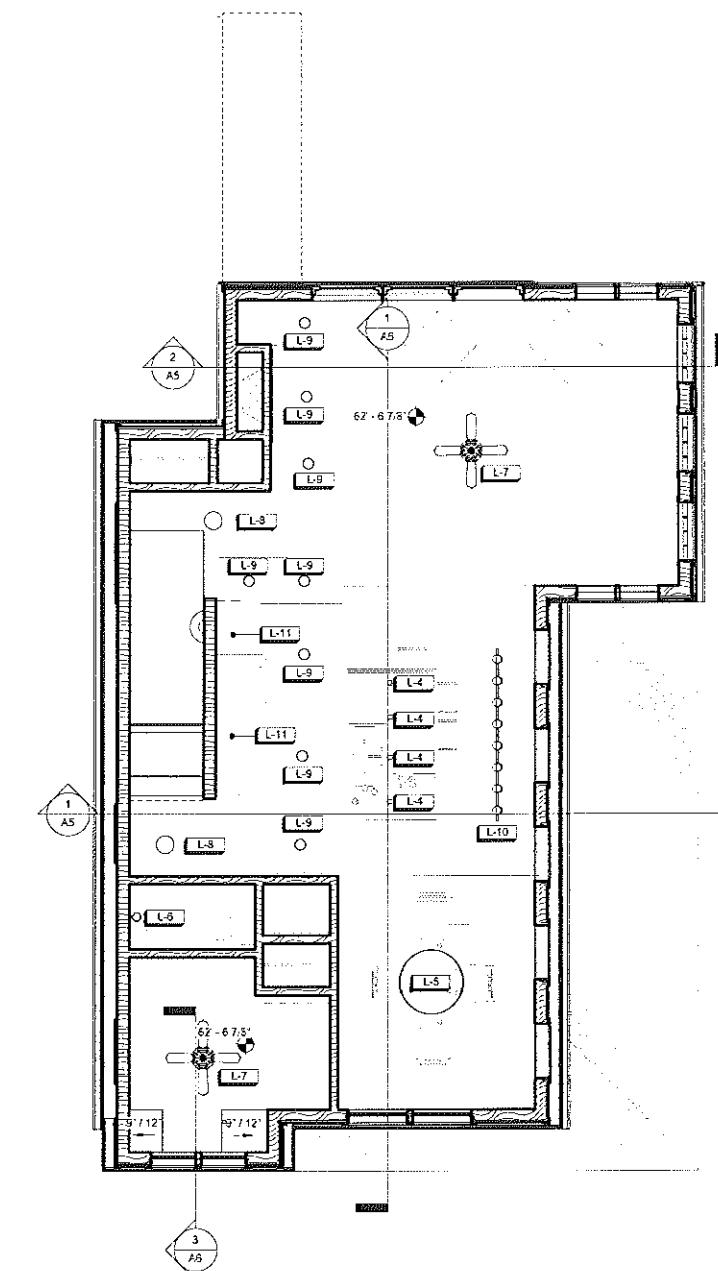

PROPOSED THIRD FLOOR REFLECTED  
CEILING PLAN  
③ 1/4" = 1'-0"

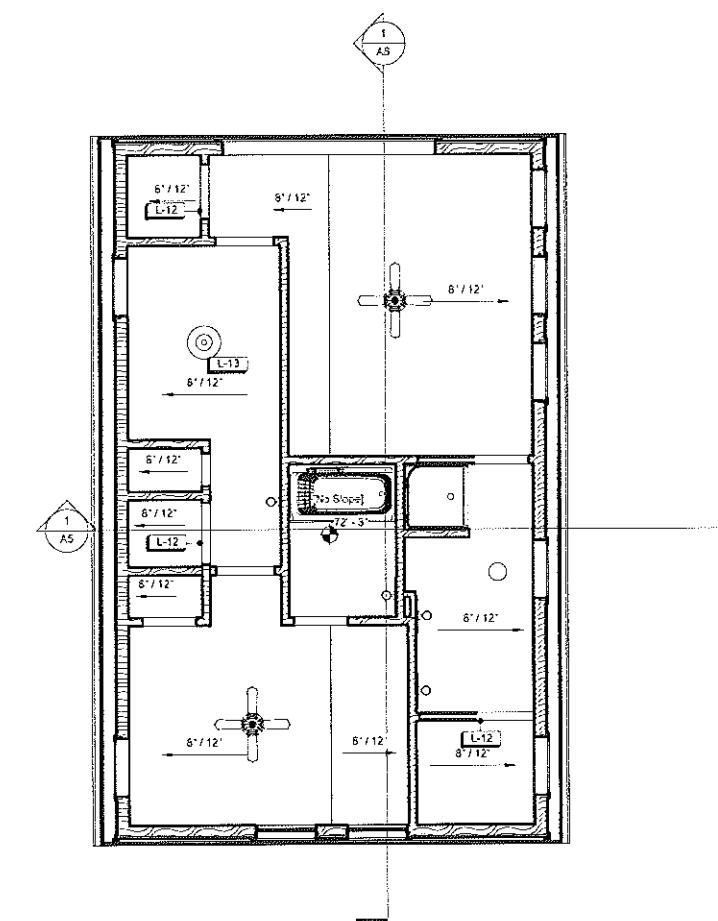Sheet Number  
REFLECTED CEILING  
PLANS

A3

Date 03-10-16  
Project Number: 158001




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Sheet Number  
**EXTERIOR  
ELEVATIONS**

**A4**


Date 03-10-16  
Project Number 158001

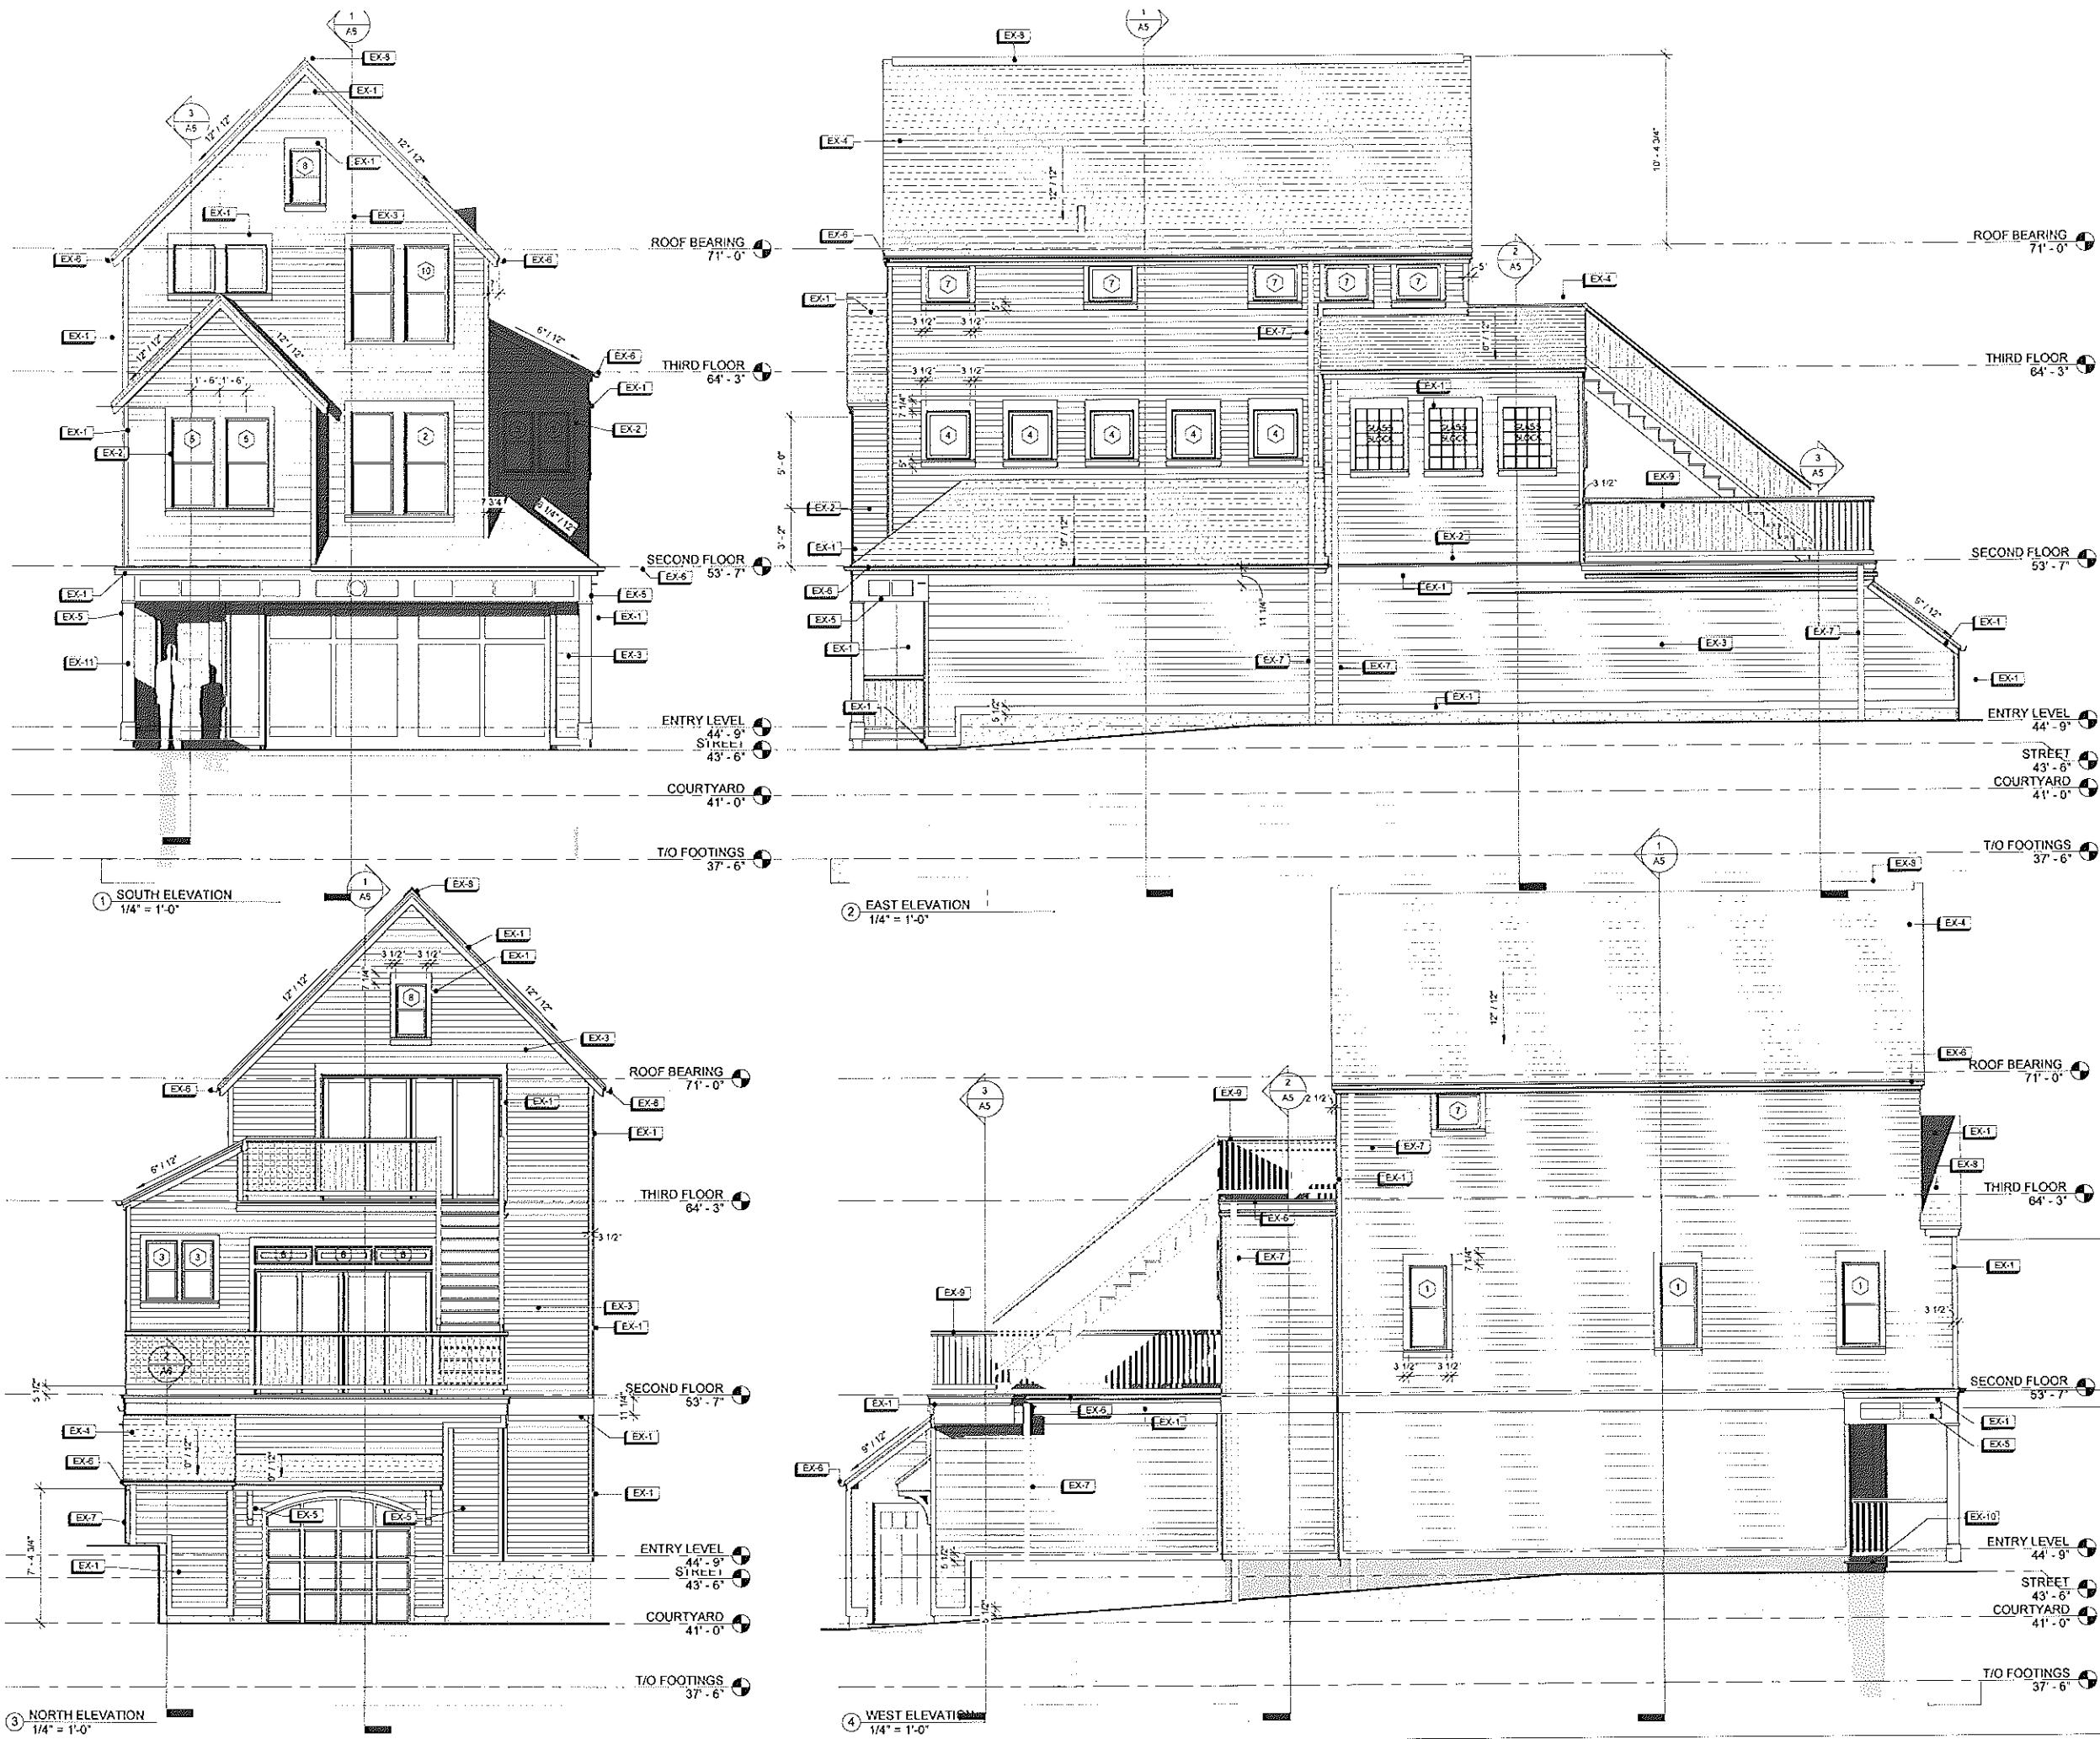

New Residence for  
**JON HANSEN**  
Kane Commons  
1170 East Kane Place  
Milwaukee, Wisconsin





russell e. lafondbois, llc architect, llc  
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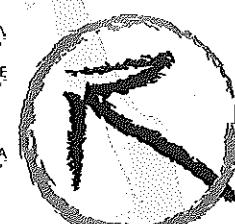
Sheet Number  
SECTIONS

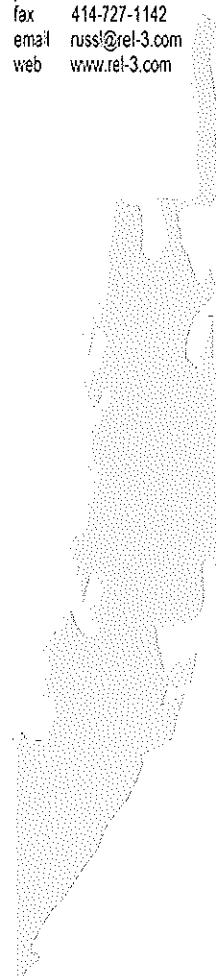A5


Date 03-10-16  
Project Number: 158001




SECOND FLOOR New Residence for  
53'-7" JON HANSEN  
Kane Commons  
1170 East Kane Place  
Milwaukee, Wisconsin

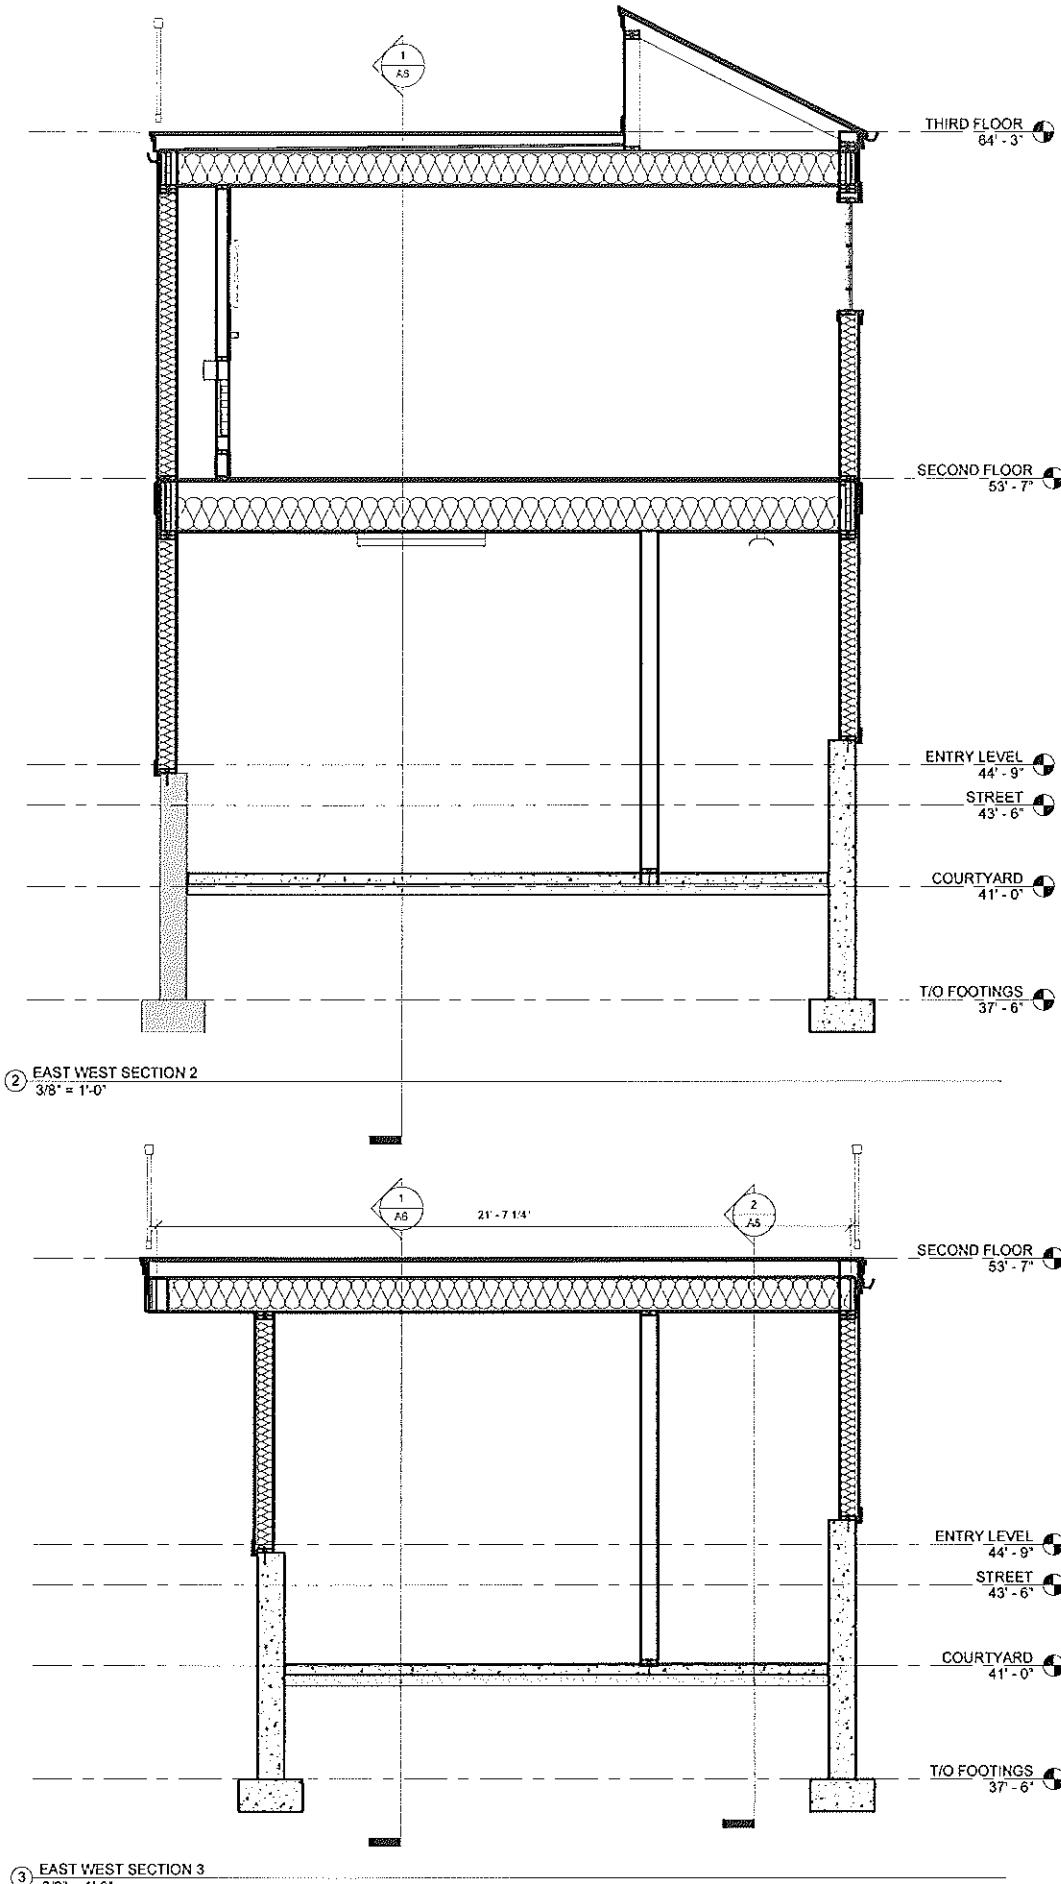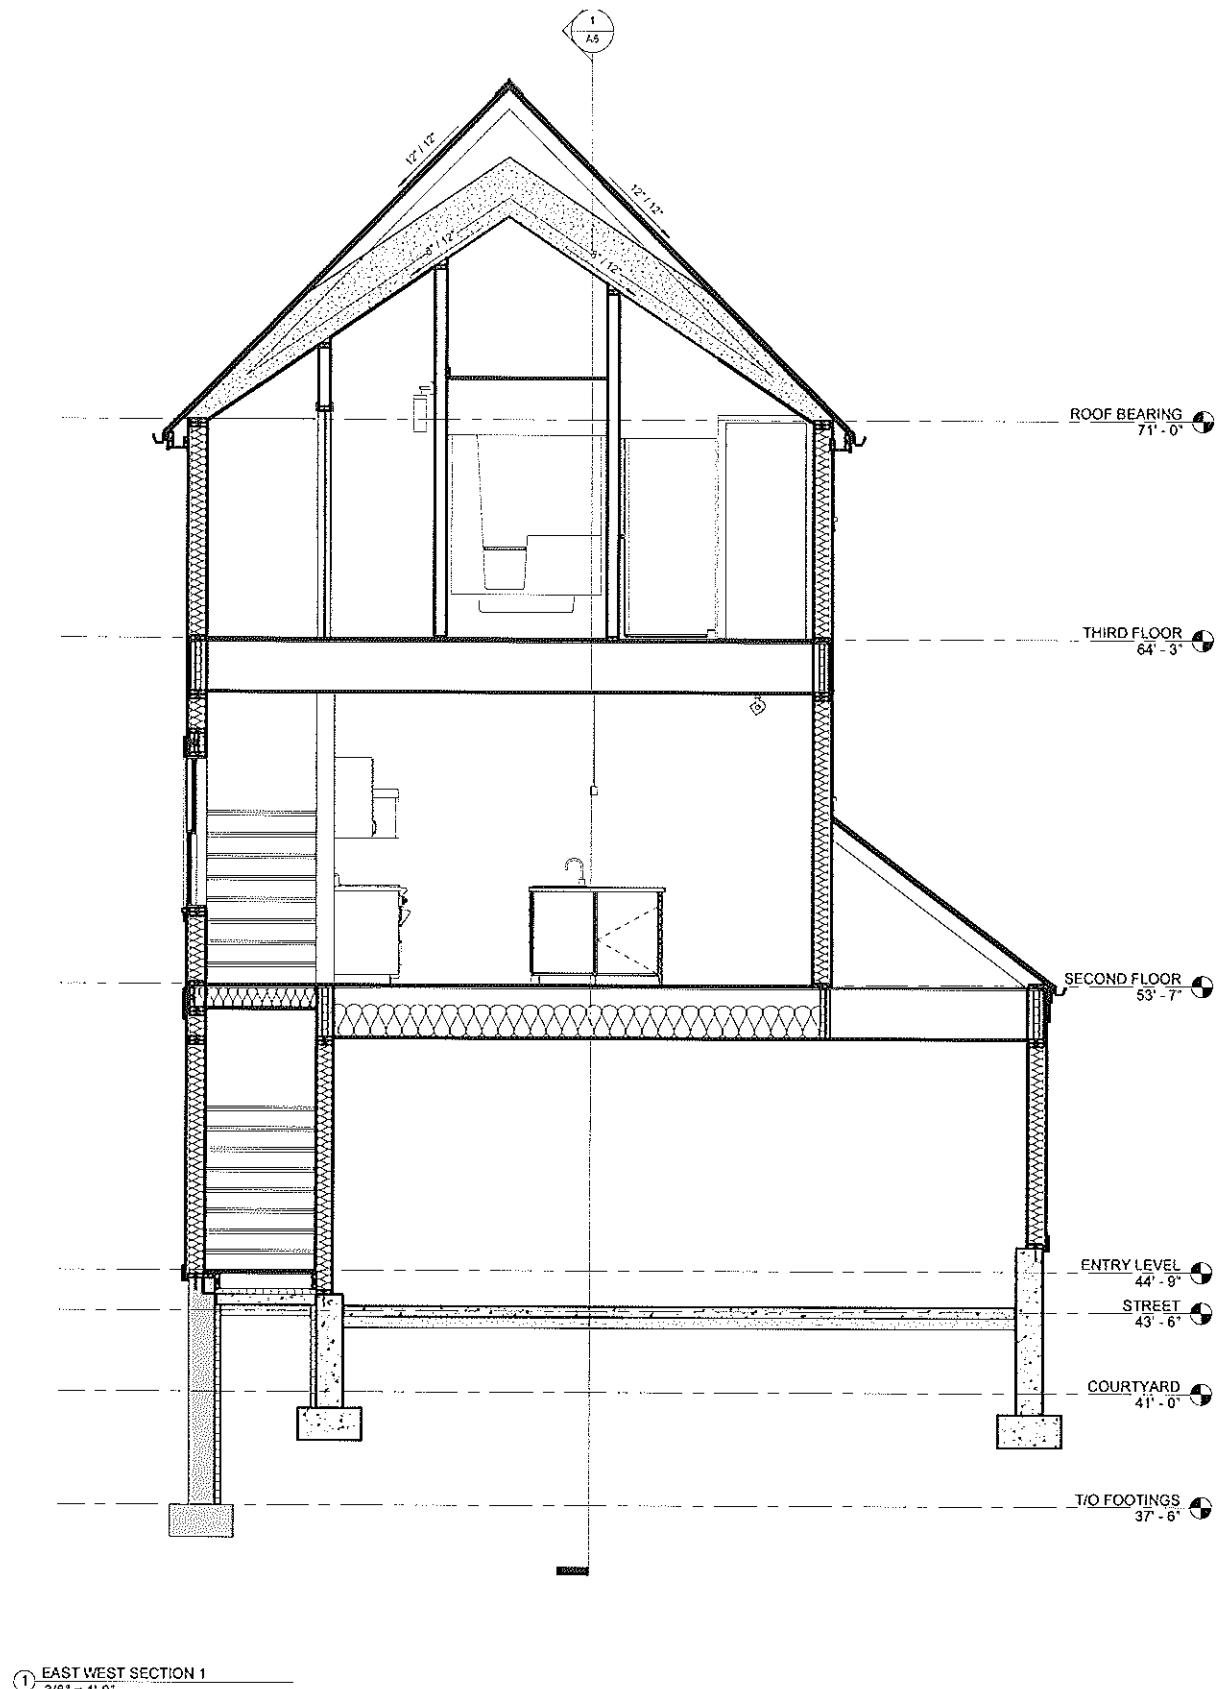

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① NORTH SOUTH SECTION 1  
3/8" = 1'-0"

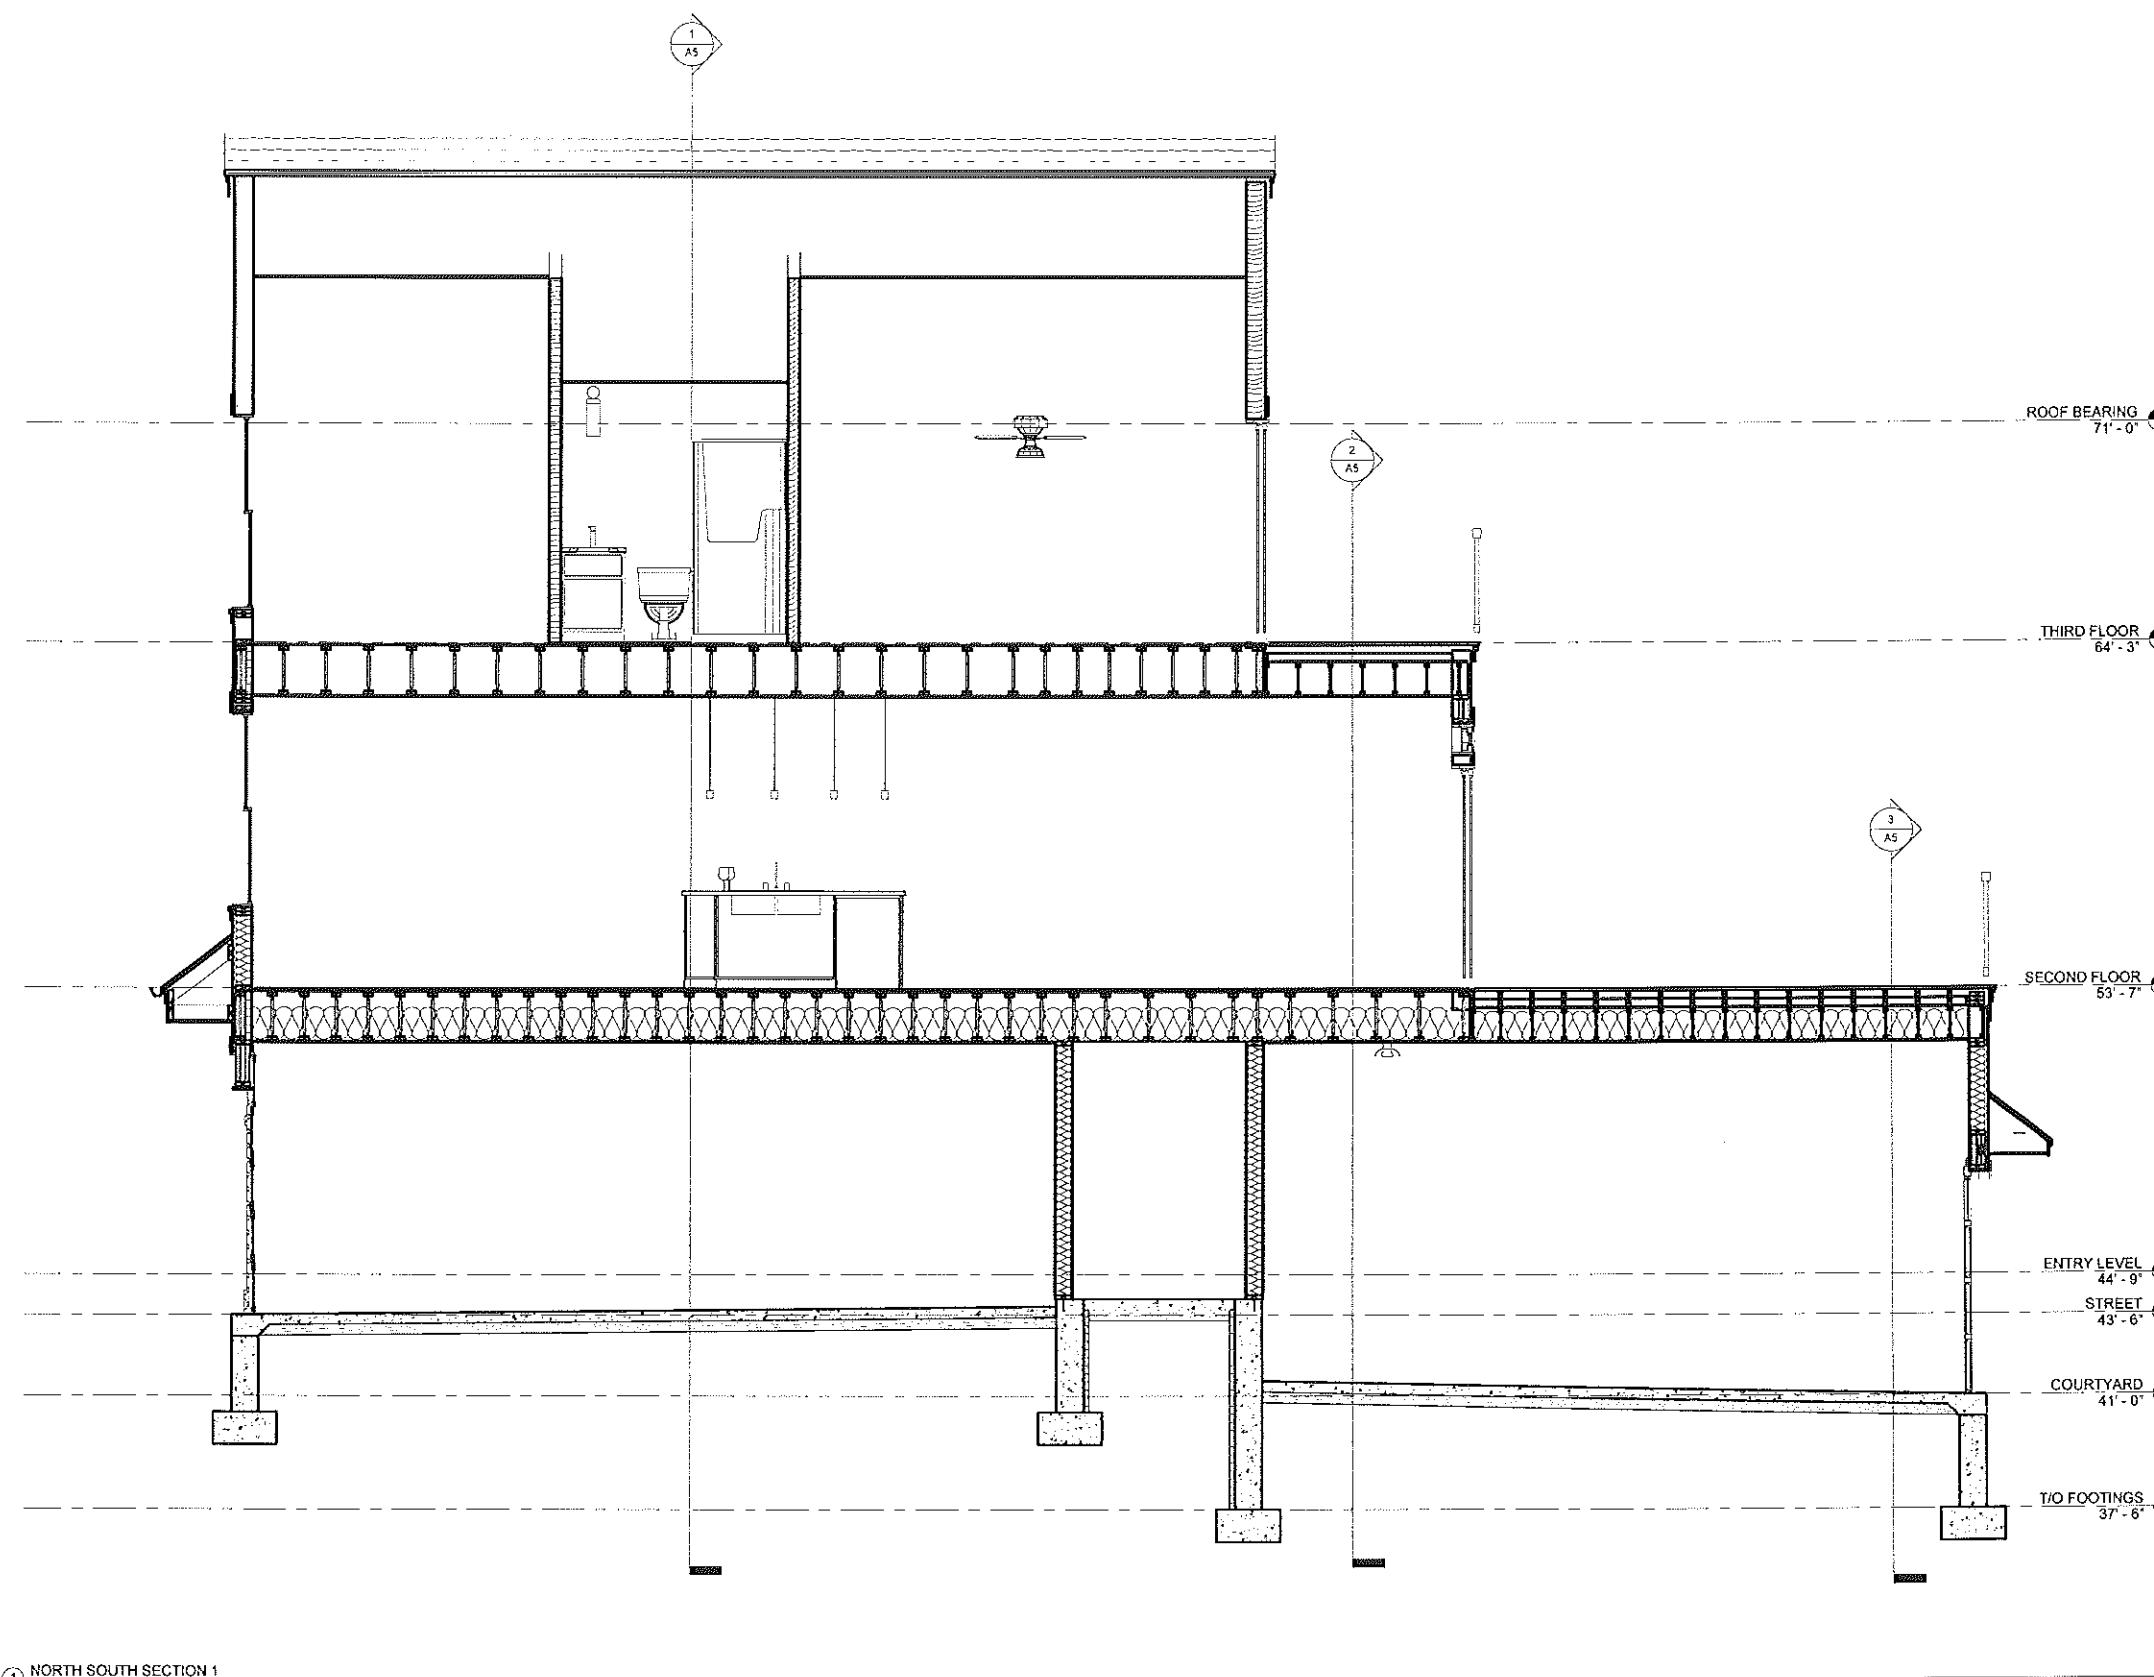

Sheet Number  
SECTIONS


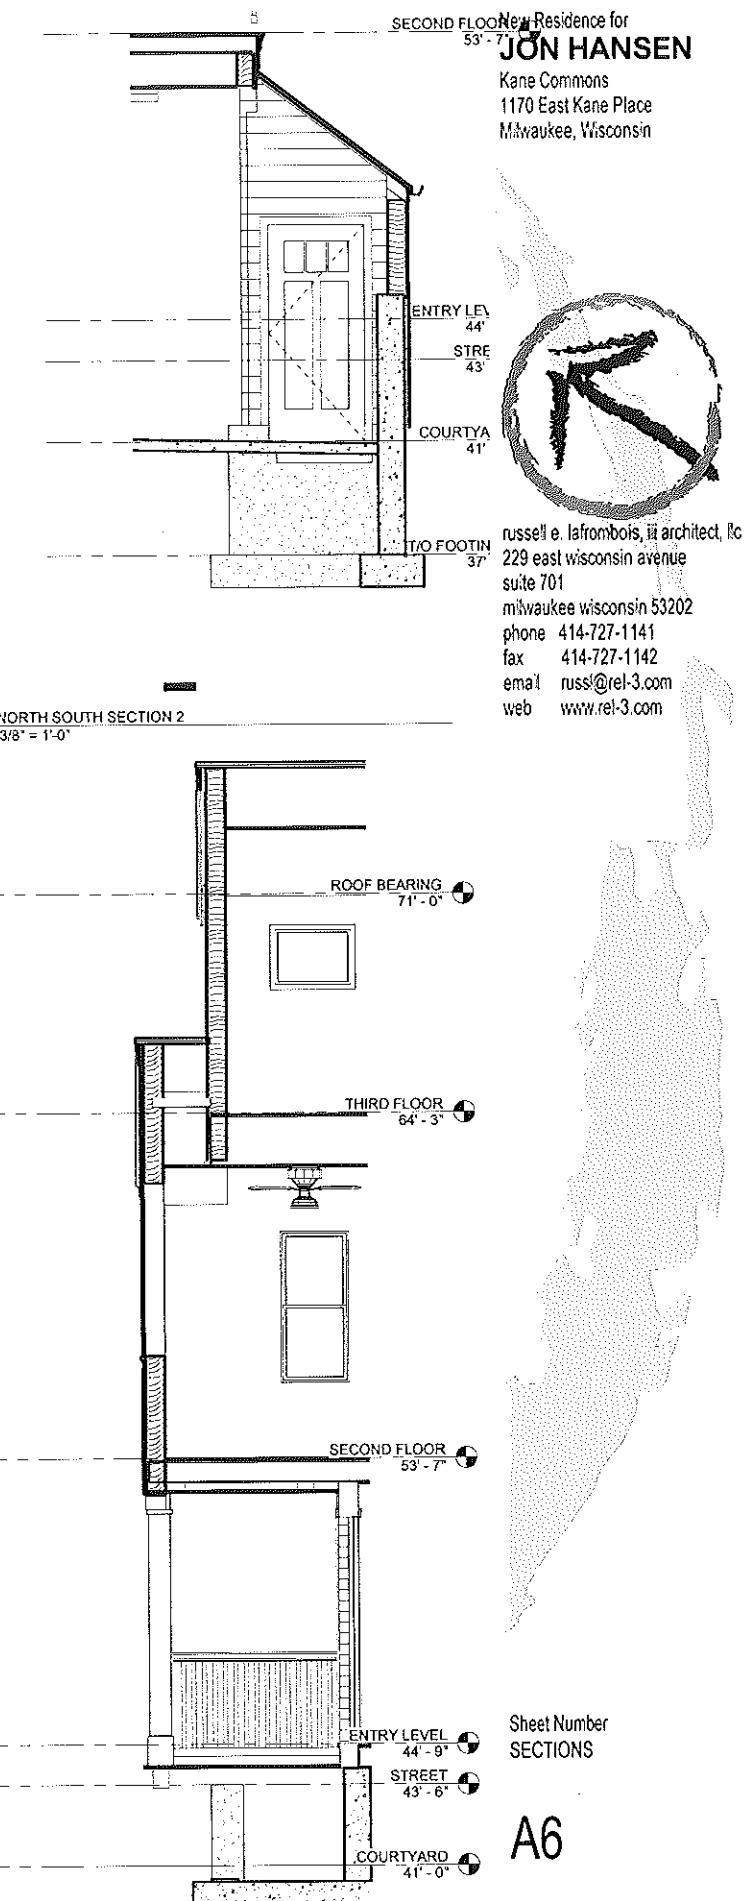
A6

Date 03-10-16  
Project Number: 158001

③ NORTH SOUTH SECTION 3  
3/8" = 1'-0"




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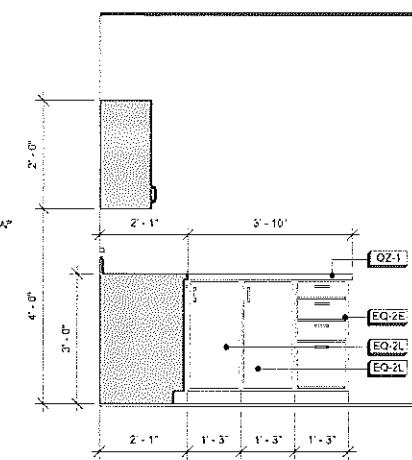
① LIVING ROOM WEST ELEVATION

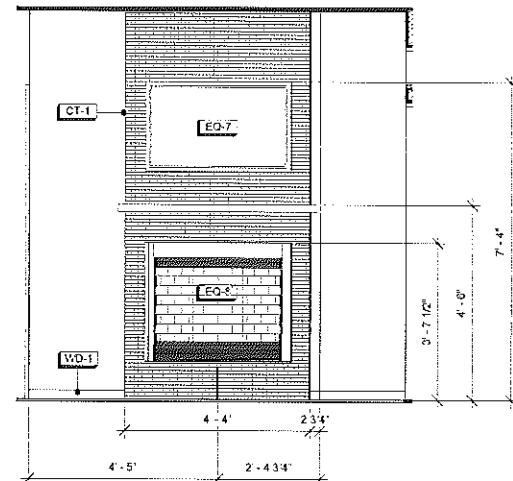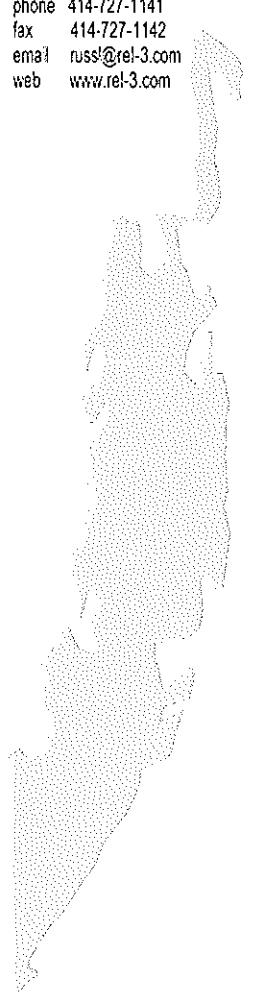1/2' = 1'-0"




② KITCHEN WEST ELEVATION

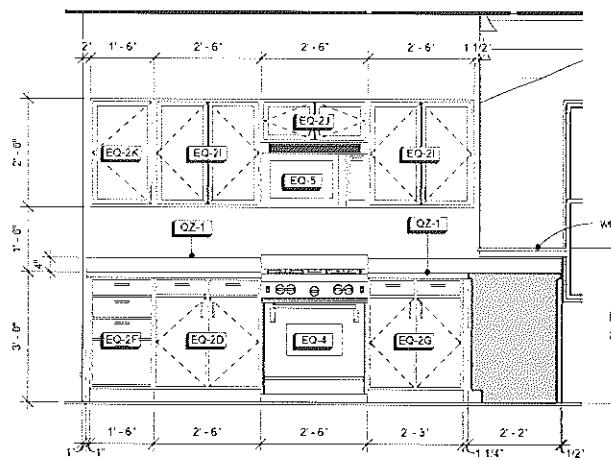1/2' = 1'-0"




③ KITCHEN NORTH ELEVATION

1/2' = 1'-0"

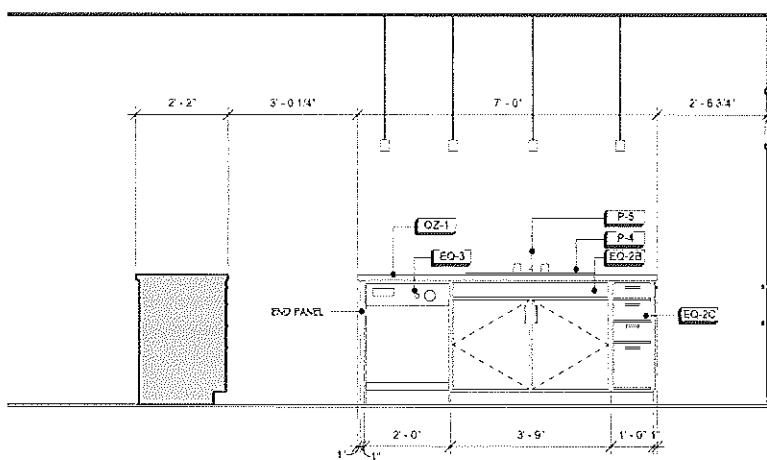


④ KITCHEN EAST ELEVATION

1/2' = 1'-0"

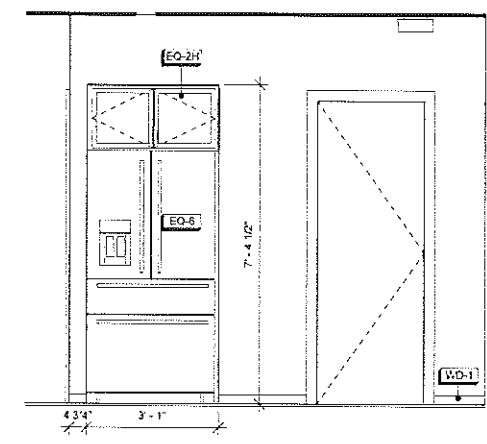


⑤ KITCHEN SOUTH ELEVATION

1/2' = 1'-0"

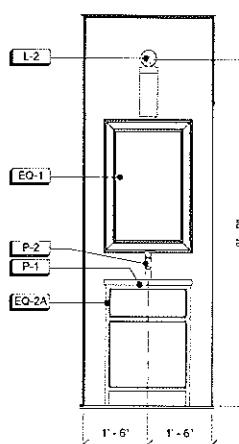


⑥ 1/2 BATH WEST ELEVATION

1/2' = 1'-0"

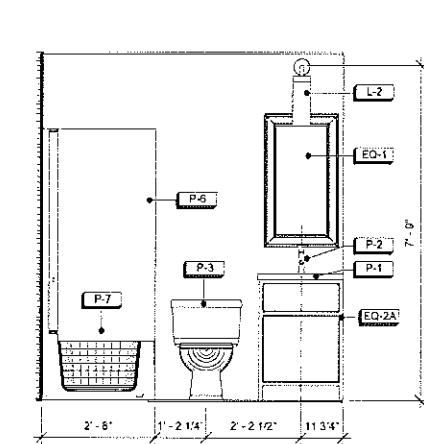

⑦ BATH EAST ELEVATION

1/2' = 1'-0"

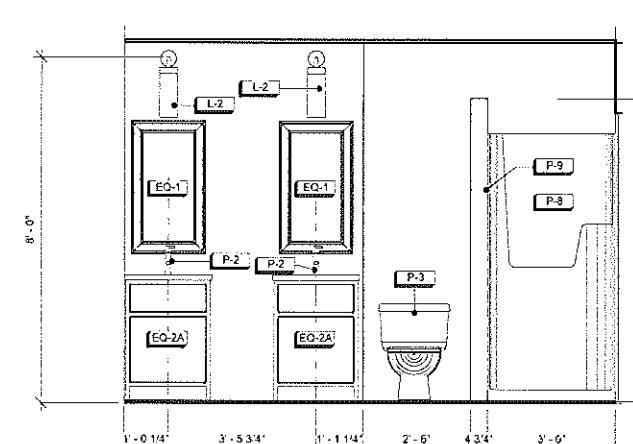

⑧ MASTER BATH WEST ELEVATION

1/2' = 1'-0"

Sheet Number  
 INTERIOR  
 ELEVATIONS

A7

Date 03-10-16  
 Project Number: 158001






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Sheet Number  
**STRUCTURAL PLANS**

**S1**

Date 03-10-16  
 Project Number 158001



- TRUSS NOTES**
1. TRUSS MANUFACTURER SHALL VERIFY ALL DIMENSIONS WITH THE ARCHITECT'S DRAWING AND IN THE FIELD.
  2. LOCATIONS OF ALL JOIST CLEARS AND H.F. TRUSSES SHALL BE REVIEWED BY THE ARCHITECT PRIOR TO FABRICATION OF ANY MATERIAL.
  3. TRUSS DESIGNER SHALL VERIFY ADDEDUCY OF ALL TRUSS AND GIRDERS TRUSS BEARING AREAS. TRUSS DESIGNER SHALL NOTIFY THE ARCHITECT IF INSUFFICIENT AREA IS CALLED FOR.
  4. SUBMIT TRUSS DESIGN SHOP DRAWINGS FOR ARCHITECT'S REVIEW PRIOR TO FABRICATION ANY MATERIAL.
  5. UNLESS NOTED OTHERWISE ALL FLOOR TRUSSES SHALL BE BOTTOM CHORD BEARING.
  6. ALL TRUSSES SHALL BE MANUFACTURED WITH GRADE A21 1950F 1.7E KRS OR EQUIVALENT.
- JOIST NOTES**
1. JOIST MANUFACTURER SHALL VERIFY ALL DIMENSIONS WITH THE ARCHITECT'S DRAWING AND IN THE FIELD.
  2. DESIGN IS BASED ON WEYERHAUSER TP.
  3. LOAD CALCULATIONS ARE BASED ON L480.
  4. TRUSS DESIGNER SHALL VERIFY ADDEDUCY OF ALL JOISTS BEARING AREAS. DESIGNER SHALL NOTIFY THE ARCHITECT IF INSUFFICIENT AREA IS CALLED FOR.

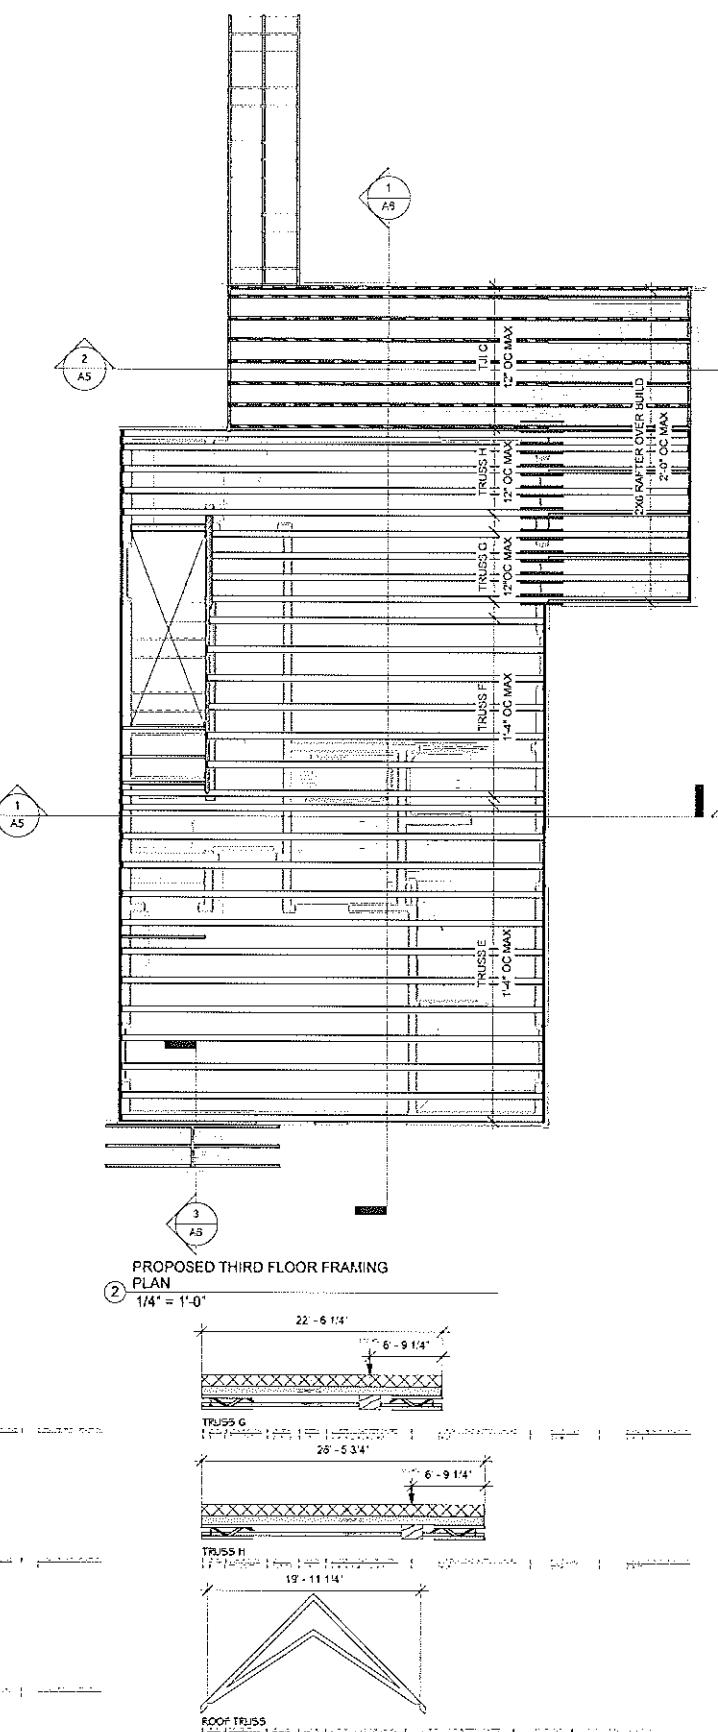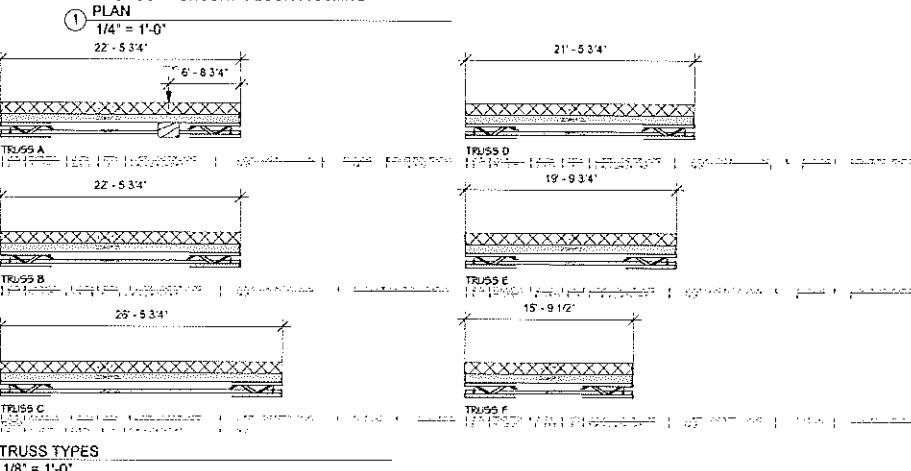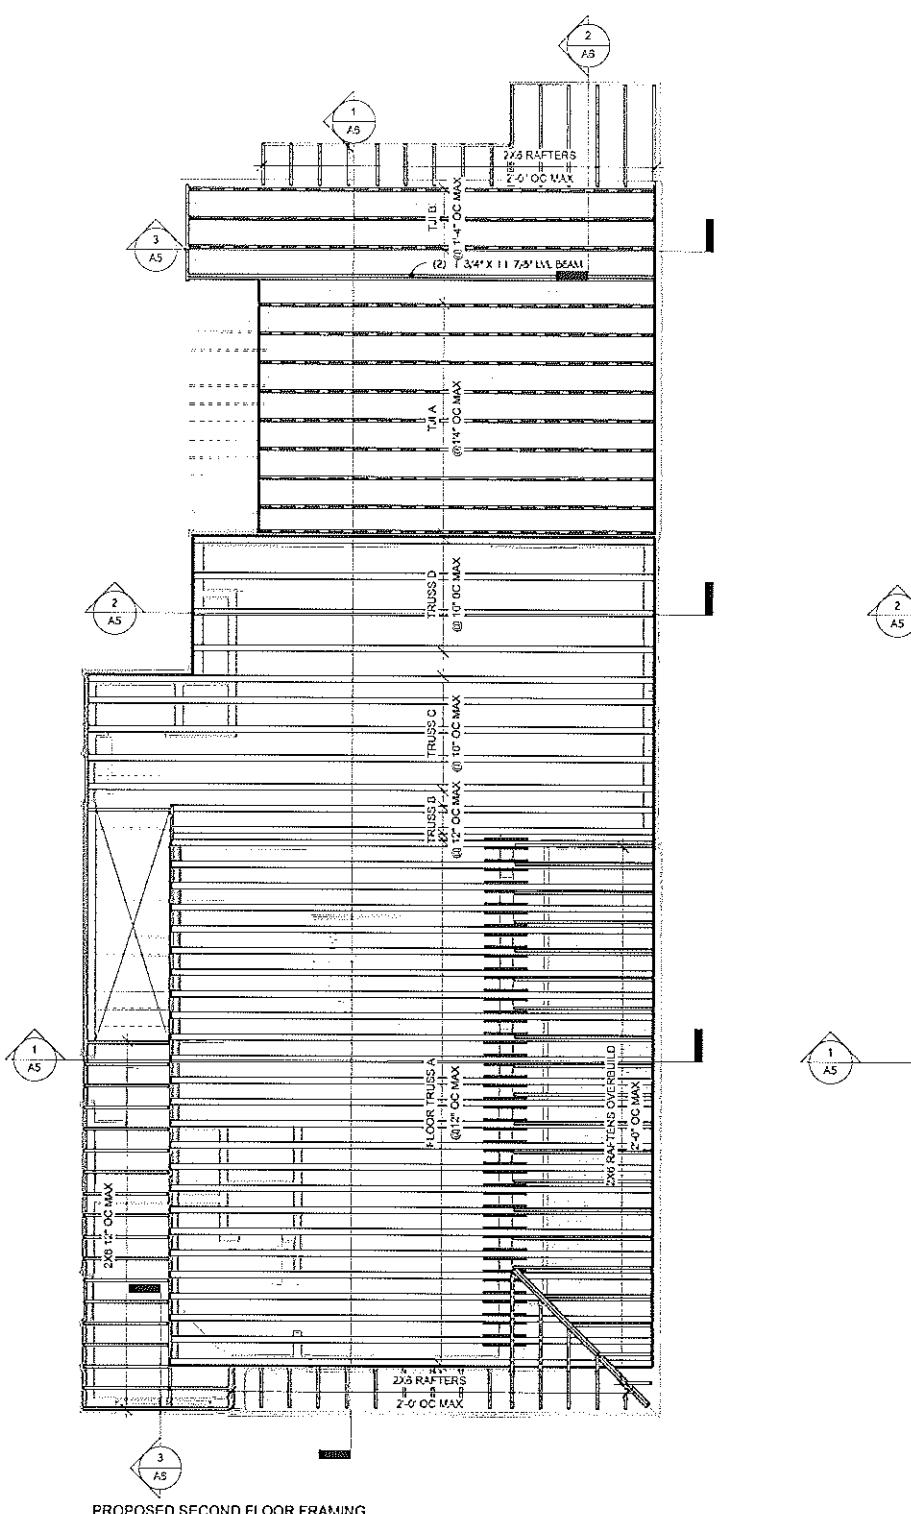




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## DIVISION 7 THERMAL PROTECTION


### SECTION 07320 - JOINT SEALANTS

- 1. General
- 2. Joint Sealants
- 3. Polyurethane Joint Sealant: Type 1, 2, 3, 215, 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HOUSE DOWN THE BLOCK




HOMES EAST OF SITE

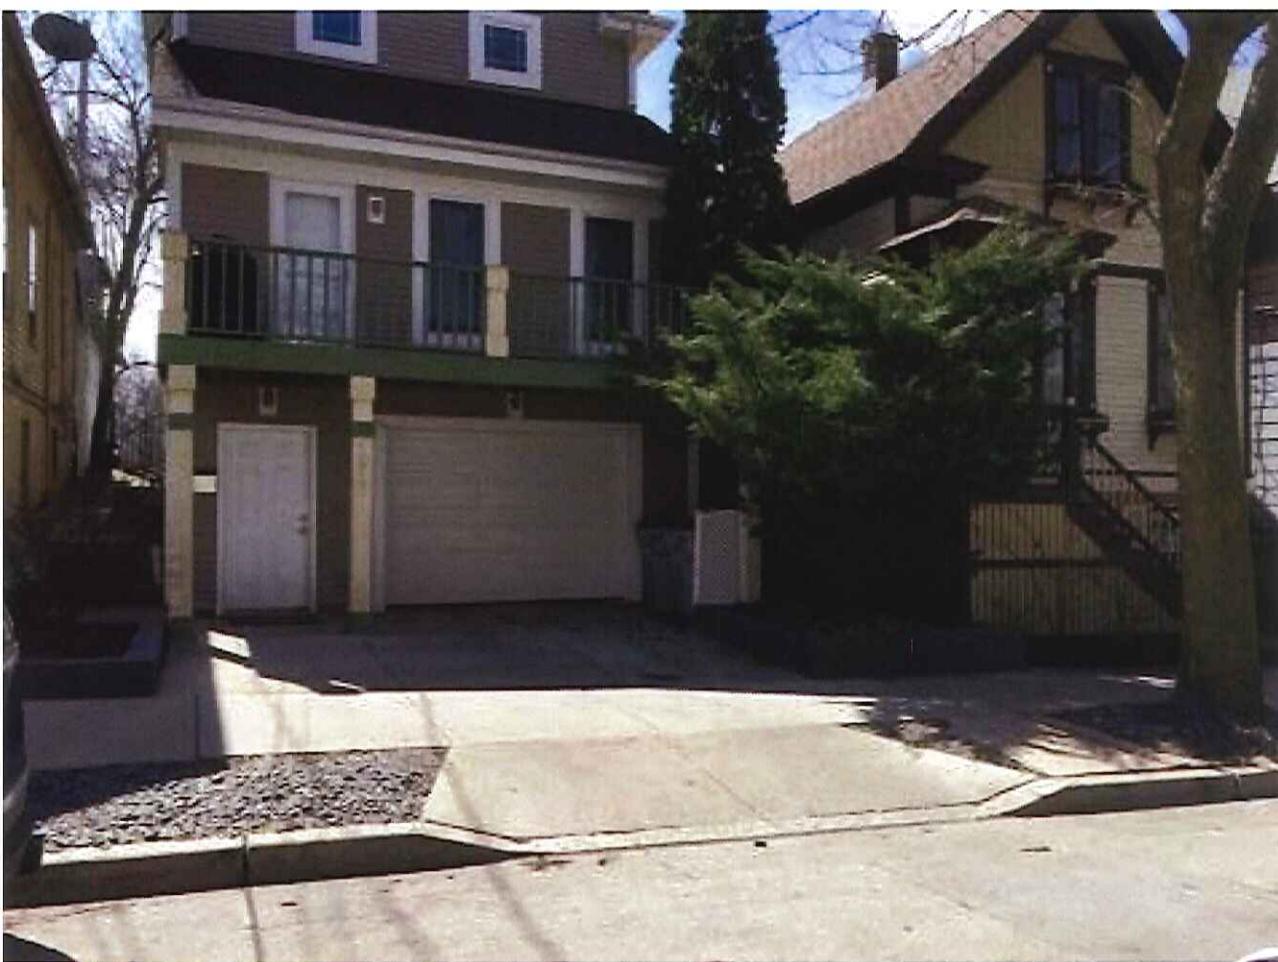

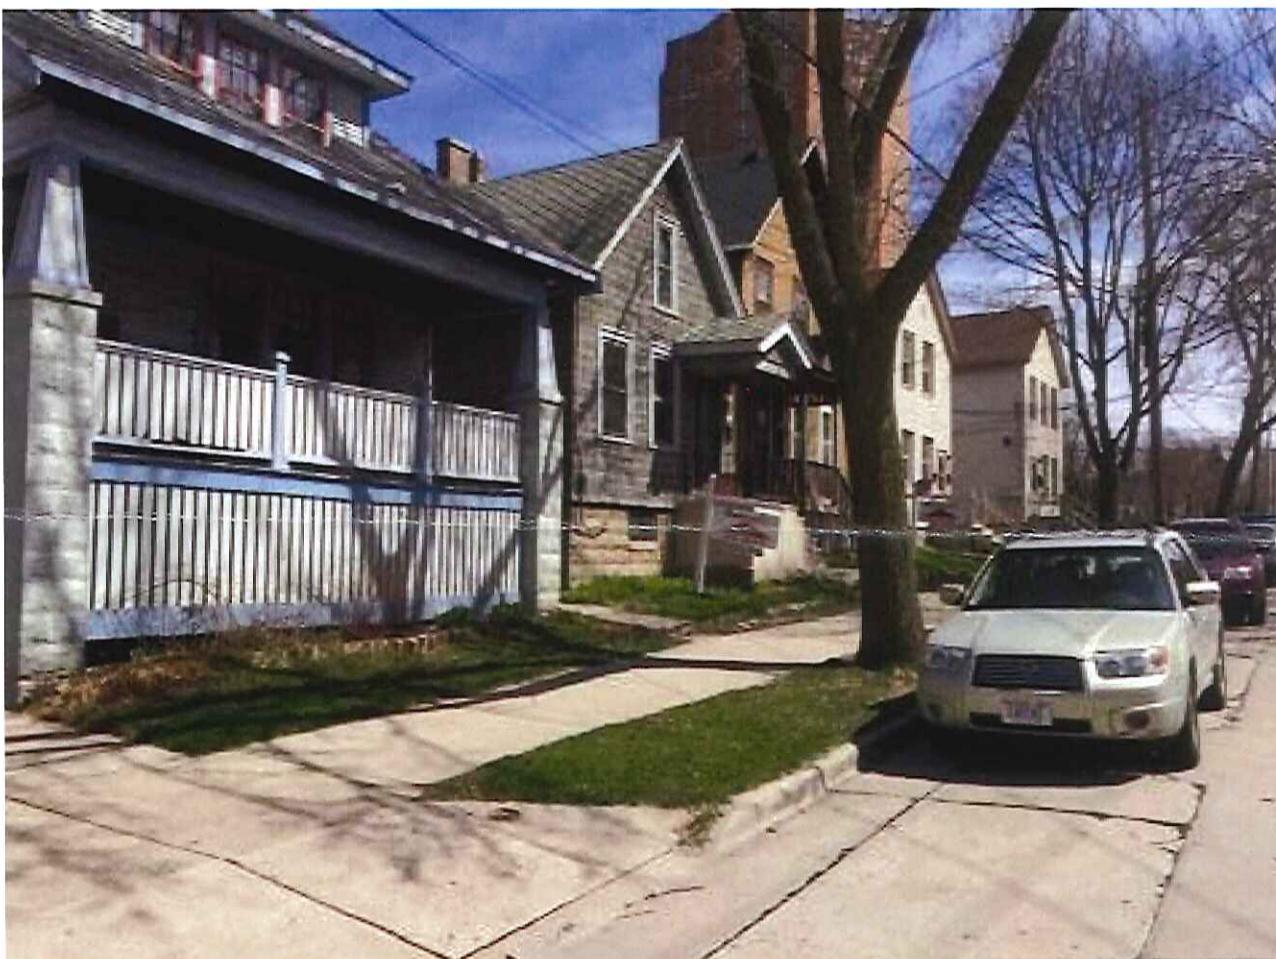HOMES ACROSS THE  
STREET FROM SITE



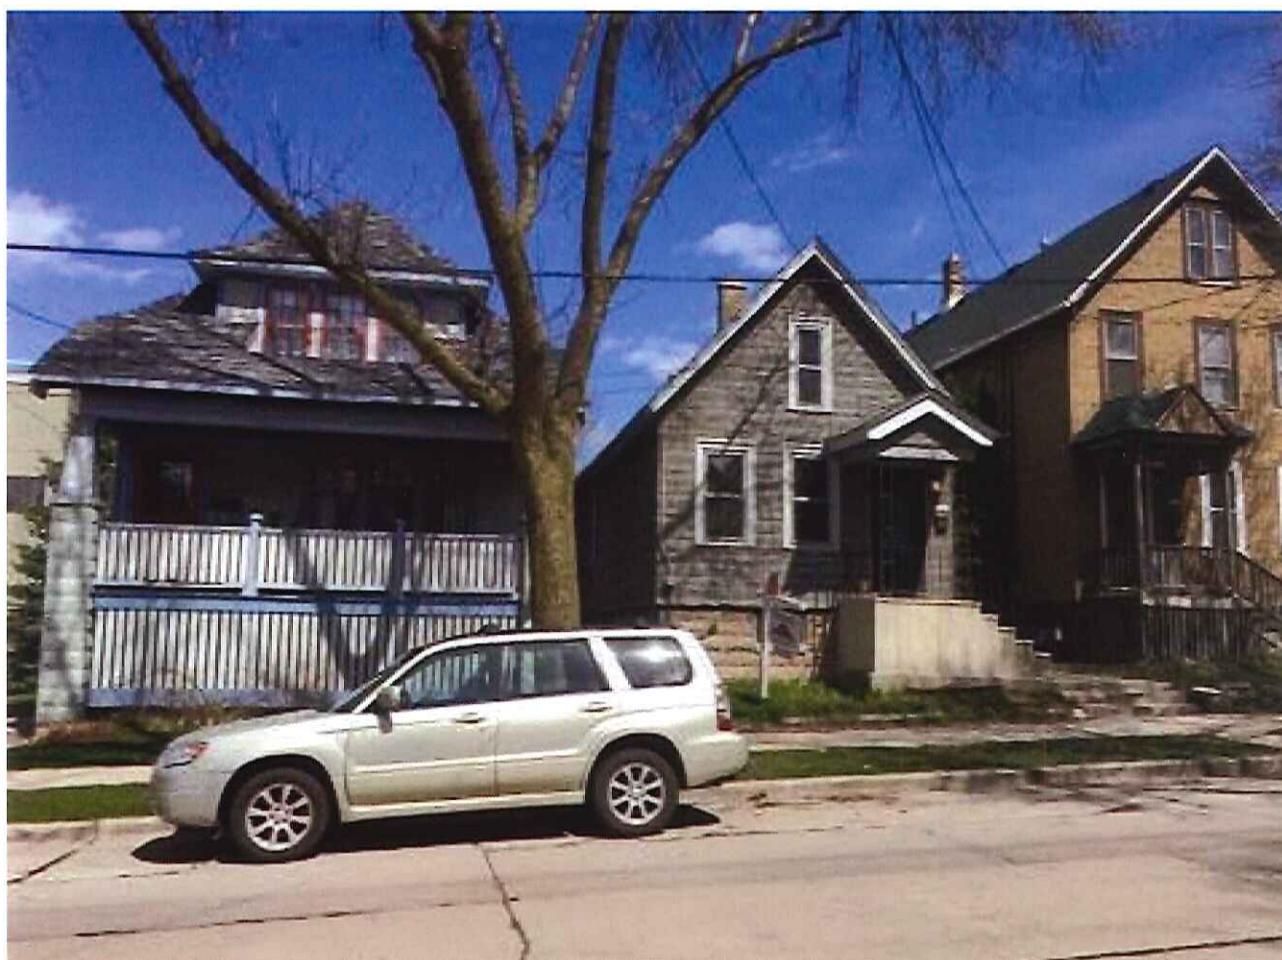

HOMES EAST OF SITE



HOMES EAST OF ISTE



HOMES ACROSS THE  
STREET FROM SITE




New Residence for  
**JON HANSEN**  
1170 East Kane Place, Milwaukee Wisconsin

**PH-2**

04/11/16

russell e lafrombois iii architect 229 east wisconsin ave milwaukee, wisconsin 414-727-1141 russl@rel-3.com

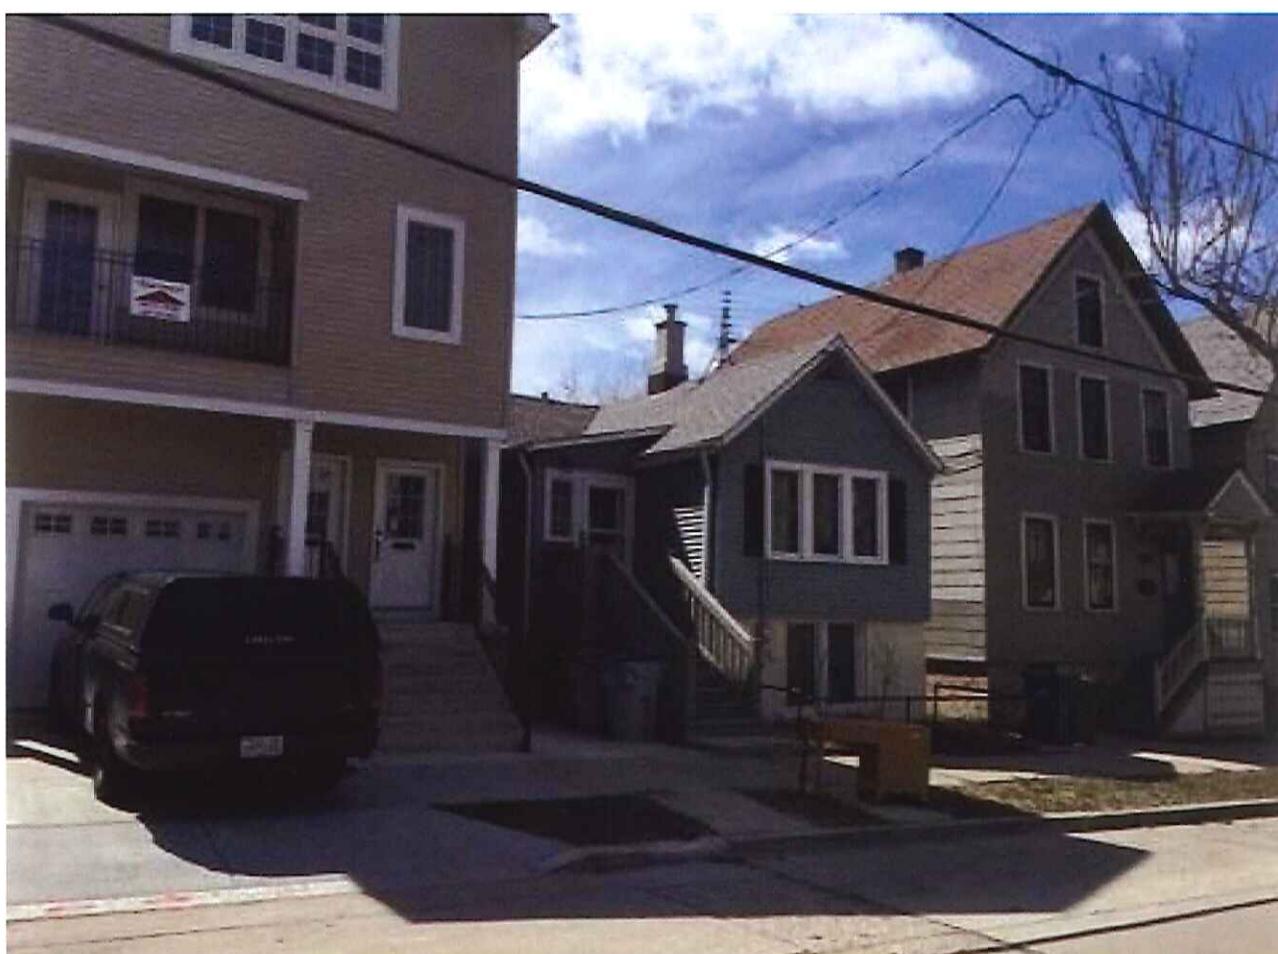


HOMES ACROSS THE STREET  
LOOKING WEST FROM SITE



HOMES ACROSS THE  
STREET TO THE WEST  
OF SITE



KANE COMMONS  
HOMES

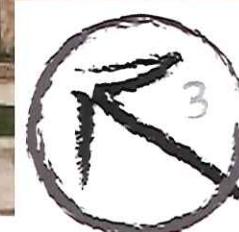

New Residence for  
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**PH-3**

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KANE COMMONS HOMES  
LOOKING WEST



PROPOSED NEW HOME

