


HILLS BUILDING RENOVATION

906 W. MITCHELL STREET MILWAUKEE, WI 53208

City of Milwaukee HPC COA Submission

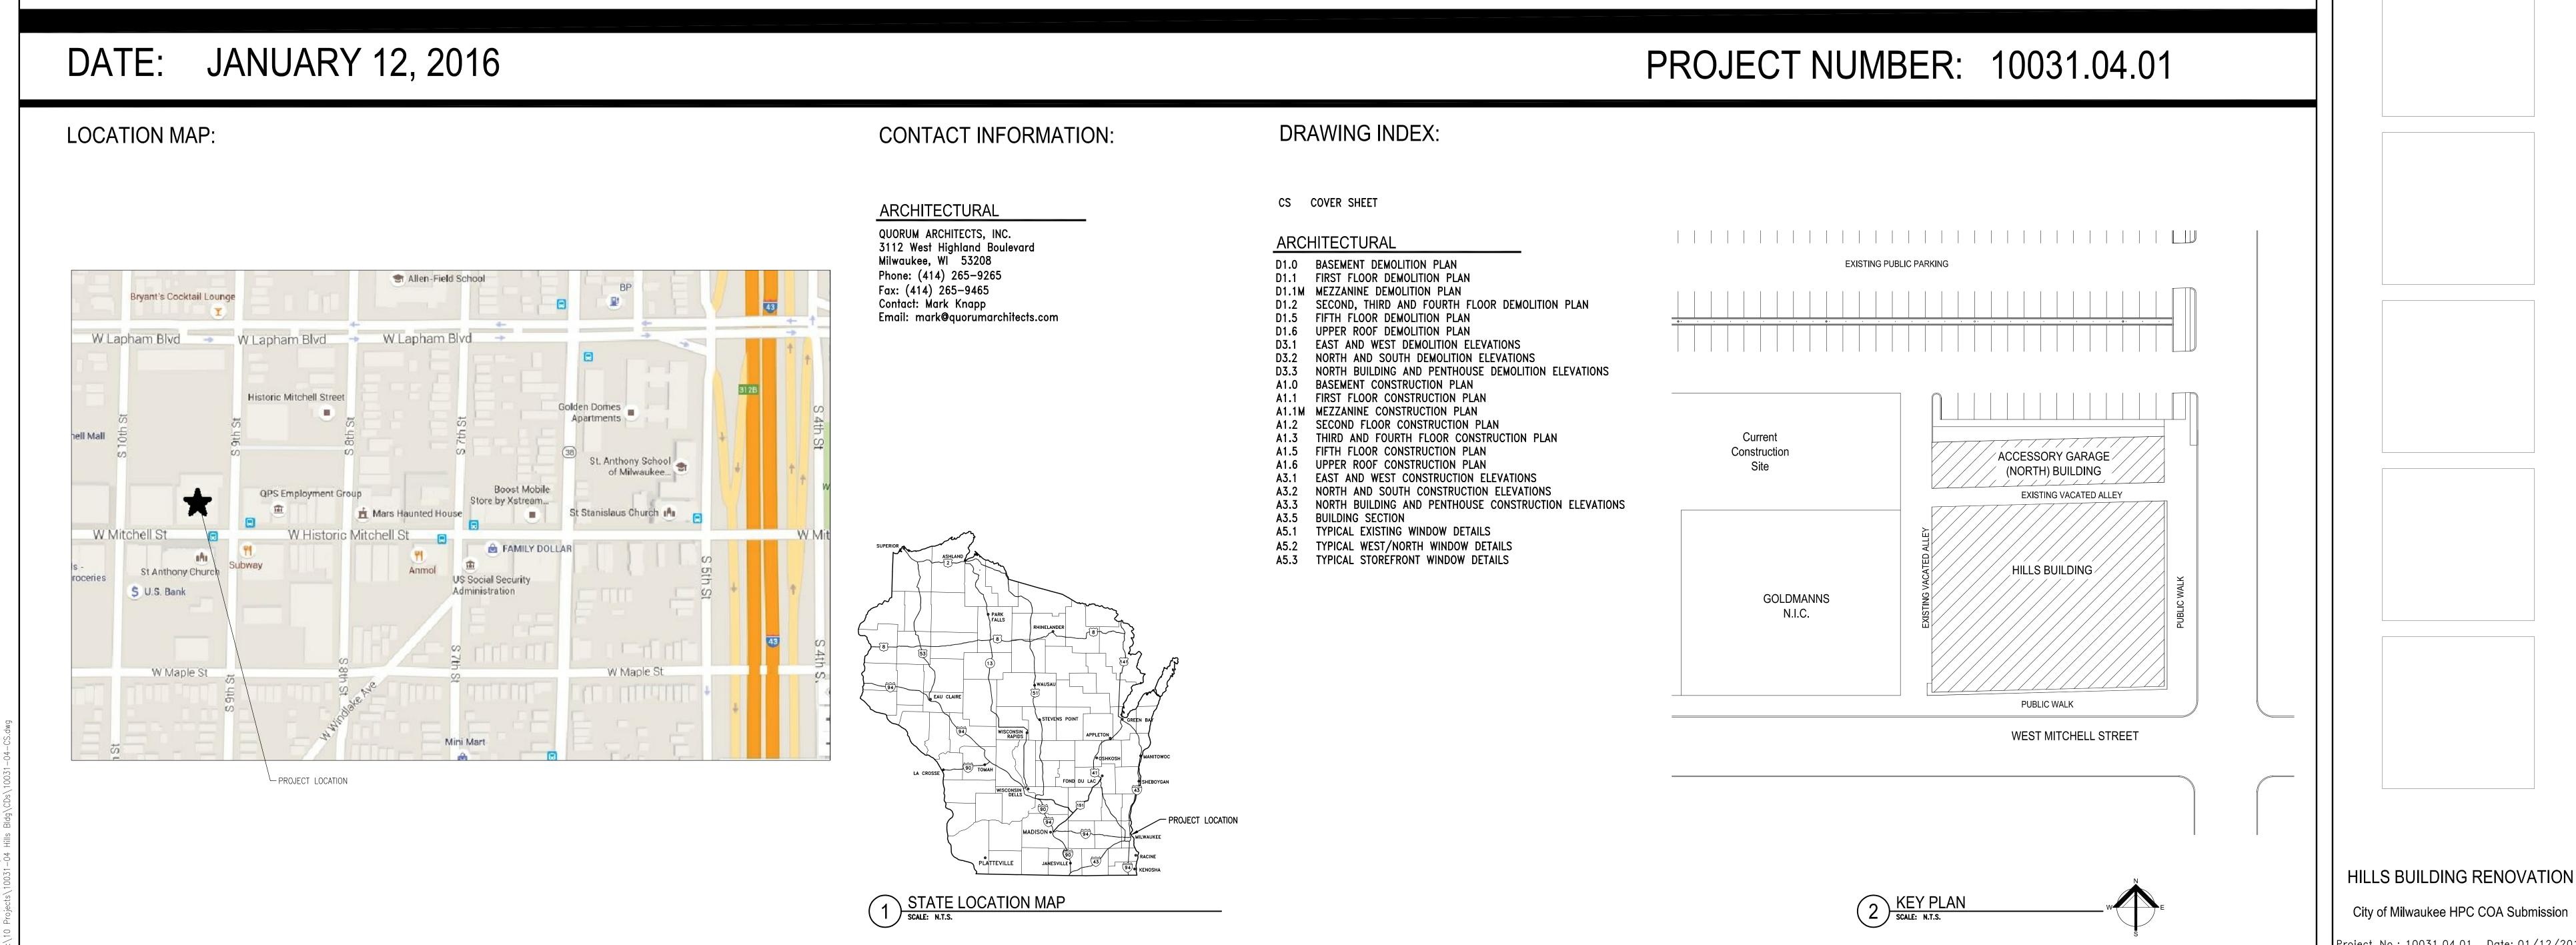

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City of Milwaukee HPC COA Submission

Project No.: 10031.04.01 Date: 01/12/2016

BASEMENT DEMOLITION PLAN

SCALE: 1/8" = 1'-0"

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GENERAL DEMOLITION NOTES

- REMOVE ALL EXISTING FLOOR COVERING
- REMOVE ALL EXISTING SUSPENDED CEILINGS
- REMOVE ALL EXISTING ABOVE—CEILING MECHANICAL

REMOVE ALL EXISTING ABOVE—CEILING PLUMBING

ALL CONCRETE COLUMNS TO REMAIN EXPOSED.

LATERALS - WASTE & SUPPLY.

EXISTING WALLS TO REMAIN

= = = Existing walls to be removed

EXISTING DOORS TO REMAIN

EXISTING DOOR TO BE REMOVED

LEGEND

• REMOVE ALL EXISTING WINDOW TREATMENTS.

- DUCTWORK. REMOVE ALL EXISTING ABOVE—CEILING ELECTRICAL
- REMOVE EXISTING NON-HISTORIC PLUMBING FIXTURES AND CAP AS REQUIRED. 4) REMOVE EXISTING NON-HISTORIC MILLWORK.

DEMOLITION NOTES

REMOVE EXISTING WALLS AND ALL ASSOCIATED ELECTRICAL.

REMOVE EXISTING NON-HISTORIC DOOR, FRAME AND HARDWARE.

- FREMOVE EXISTING NON-HISTORIC TOILET PARTITIONS.
- 6 REMOVE EXISTING MASONRY INFILL AT HISTORIC WINDOW OPENING. MAINTAIN EXISTING SILLS AND MASONRY WALL BELOW WHERE PRESENT. PREP OPENING FOR NEW WINDOW/DOOR. SEE PLANS AND ELEVATIONS.
- 7) EXISTING ELEVATOR TO REMAIN.
- (8) EXISTING FREIGHT ELEVATOR TO BE REMOVED.
- (9) EXISTING STAIR TO REMAIN. (10) EXISTING STAIR TO BE REMOVED.
- 11) VERIFY CONDITION OF EXISTING DECORATIVE
- HANDRAIL.
- REMOVE EXISTING FLOOR STRUCTURE AS REQUIRED FOR NEW PASSENGER ELEVATOR.
- REMOVE EXISTING HOLLOW METAL DOORS TO FIRE ESCAPE.
- REMOVE EXISTING FIRE ESCAPE TO THE EXTENT INDICATED. CUT ALL MOUNTING BRACKETS FLUSH WITH MOUNTING PLATE OF FACE OF MASONRY

WHERE EMBEDDED. — SEE ELEVATIONS.

- (15) REMOVE EXISTING ENTRY RAMP AND GUARDRAIL.
- REMOVE EXISTING ALUMINUM STOREFRONT SEE ELEVATIONS FOR EXTENTS.
- (17) REMOVE EXISTING ALUMINUM WINDOWS.

ELEVATIONS.

- REMOVE EXISTING LOUVER AND ADJACENT MASONRY FOR INSTALLATION OF NEW WINDOW SEE
- (19) REMOVE PORTION OF EXISTING MASONRY WALL AND PREP FOR NEW WINDOW/DOOR/LOUVER. SEE
- PLANS AND ELEVATIONS. 20) REMOVE EXISTING OVERHEAD COILING DOOR AND
- PREPARE FOR MASONRY INFILL. 21) REMOVE EXISTING WINDOW AND ADJACENT MASONRY FOR INSTALLATION OF NEW WINDOW - SEE ELEVATIONS.
- 22) EXISTING HISTORIC STAIR TO REMAIN. REPAIR AS REQUIRED.
- 23) REMOVE EXISTING ROOFING AND WOOD FRAMED ATTIC DOWN TO CONCRETE DECK - SEE BUILDING SECTION.
- $\widehat{(24)}$ REMOVE EXISTING A/C CONDENSER.
- 25) EXISTING ROOF ACCESS LADDER TO REMAIN.
- EXISTING CHILLERS TO BE REMOVED. STEEL MOUNTING STRUCTURE TO REMAIN.
- 27) REMOVE EXISTING STEEL WATER TANKS, PIPING AND MOUNTING STRUCTURE.
- REMOVE EXISTING OVERHEAD COILING DOOR. EXISTING OPENING TO REMAIN.
- EXISTING BOILER TO BE REMOVED.
- EXISTING AIR HANDLING UNIT AND ASSOCIATED DUCTWORK TO BE REMOVED.
- REMOVE EXISTING ROOFING DOWN TO SUB-STRUCTURE PREPARE FOR RE-ROOFING.
- (32) Existing electrical gear to remain.
- (33) REUSE OR RECONFIGURE EXISTING WALL LOUVER.
- (34) EXISTING CHIMNEY TO REMAIN.
- (35) REMOVE EXISTING CHIMNEY
- REMOVE EXISTING ELEVATOR, EQUIPMENT, PENTHOUSE SUBFLOOR AND ACCESS STAIR.
- (37) REMOVE EXISTING SHEET METAL GRAVEL STOP -PREPARE FOR INSTALLATION OF NEW PARAPET CAP.
- (38) EXISTING FLAGPOLE TO REMAIN.
- (39) REMOVE EXISTING ATTIC ACCESS.
- (40) EXISTING HARP LIGHT AND POST TO REMAIN.
- REMOVE EXISTING CURVED PLEXIGLASS GLAZING. FRAMING TO REMAIN.
- REMOVE EXISTING PLYWOOD COVER AT CURVED GLASS GLAZING.

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PRELIMINARY NOT FOR CONSTRUCTION QUORUM ARCHITECTS, INC.

Revisions:

Sheet Name: **BASEMENT DEMOLITION**

01/12/2016 Drawn By: CLR/EJL

Project No.: 10031.04

D1.0

1 FIRST FLOOR DEMOLITION PLAN

SCALE: 1/8" = 1'-0"

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GENERAL DEMOLITION NOTES

- REMOVE ALL EXISTING FLOOR COVERING
- REMOVE ALL EXISTING SUSPENDED CEILINGS
- REMOVE ALL EXISTING ABOVE—CEILING MECHANICAL

REMOVE ALL EXISTING ABOVE—CEILING PLUMBING

ALL CONCRETE COLUMNS TO REMAIN EXPOSED.

LATERALS — WASTE & SUPPLY.

EXISTING WALLS TO REMAIN

= = = Existing walls to be removed

EXISTING DOORS TO REMAIN

EXISTING DOOR TO BE REMOVED

LEGEND

REMOVE ALL EXISTING WINDOW TREATMENTS.

- DUCTWORK.
 REMOVE ALL EXISTING ABOVE—CEILING ELECTRICAL
- 4 REMOVE EXISTING NON-HISTORIC MILLWORK.
- FREMOVE EXISTING NON-HISTORIC TOILET PARTITIONS.

DEMOLITION NOTES

REMOVE EXISTING WALLS AND ALL ASSOCIATED ELECTRICAL.

2 REMOVE EXISTING NON-HISTORIC DOOR, FRAME AND HARDWARE.

REMOVE EXISTING NON-HISTORIC PLUMBING FIXTURES AND CAP AS REQUIRED.

REMOVE EXISTING MASONRY INFILL AT HISTORIC WINDOW OPENING. MAINTAIN EXISTING SILLS AND MASONRY WALL BELOW WHERE PRESENT. PREP

OPENING FOR NEW WINDOW/DOOR. SEE PLANS AND

(7) Existing elevator to remain.

ELEVATIONS.

HANDRAIL.

- 8 EXISTING FREIGHT ELEVATOR TO BE REMOVED.
- 9 EXISTING STAIR TO REMAIN.

 10 EXISTING STAIR TO BE REMOVED.
- VERIFY CONDITION OF EXISTING DECORATIVE
- REMOVE EXISTING FLOOR STRUCTURE AS REQUIRED FOR NEW PASSENGER ELEVATOR.
- FOR NEW PASSENGER ELEVATOR.
- REMOVE EXISTING HOLLOW METAL DOORS TO FIRE ESCAPE.
- REMOVE EXISTING FIRE ESCAPE TO THE EXTENT INDICATED. CUT ALL MOUNTING BRACKETS FLUSH WITH MOUNTING PLATE OF FACE OF MASONRY WHERE EMBEDDED. SEE ELEVATIONS.
- REMOVE EXISTING ENTRY RAMP AND GUARDRAIL.
- REMOVE EXISTING ALUMINUM STOREFRONT SEE ELEVATIONS FOR EXTENTS.
- 17) REMOVE EXISTING ALUMINUM WINDOWS.

ELEVATIONS.

- REMOVE EXISTING ALOMINOM WINDOWS.

 18) REMOVE EXISTING LOUVER AND ADJACENT MASONRY FOR INSTALLATION OF NEW WINDOW SEE
- REMOVE PORTION OF EXISTING MASONRY WALL AND PREP FOR NEW WINDOW/DOOR/LOUVER. SEE
- PLANS AND ELEVATIONS.

 (20) REMOVE EXISTING OVERHEAD COILING DOOR AND
- PREPARE FOR MASONRY INFILL.

 REMOVE EXISTING WINDOW AND ADJACENT MASONRY FOR INSTALLATION OF NEW WINDOW SEE ELEVATIONS.
- EXISTING HISTORIC STAIR TO REMAIN. REPAIR AS REQUIRED.
- REMOVE EXISTING ROOFING AND WOOD FRAMED ATTIC DOWN TO CONCRETE DECK SEE BUILDING
- 24) REMOVE EXISTING A/C CONDENSER.
- 25) EXISTING ROOF ACCESS LADDER TO REMAIN.
- EXISTING CHILLERS TO BE REMOVED. STEEL MOUNTING STRUCTURE TO REMAIN.
- REMOVE EXISTING STEEL WATER TANKS, PIPING AND MOUNTING STRUCTURE.
- REMOVE EXISTING OVERHEAD COILING DOOR. EXISTING OPENING TO REMAIN.
- EXISTING BOILER TO BE REMOVED.
- EXISTING AIR HANDLING UNIT AND ASSOCIATED DUCTWORK TO BE REMOVED.
- REMOVE EXISTING ROOFING DOWN TO SUB-STRUCTURE PREPARE FOR RE-ROOFING.
- 32) EXISTING ELECTRICAL GEAR TO REMAIN.
- REUSE OR RECONFIGURE EXISTING WALL LOUVER.
- (34) EXISTING CHIMNEY TO REMAIN.
 (35) REMOVE EXISTING CHIMNEY
- REMOVE EXISTING FLEVATOR, FOU
- REMOVE EXISTING ELEVATOR, EQUIPMENT, PENTHOUSE SUBFLOOR AND ACCESS STAIR.
- REMOVE EXISTING SHEET METAL GRAVEL STOP PREPARE FOR INSTALLATION OF NEW PARAPET CAP.
- 38) EXISTING FLAGPOLE TO REMAIN.
- 39) REMOVE EXISTING ATTIC ACCESS.
- (40) EXISTING HARP LIGHT AND POST TO REMAIN.

 (41) REMOVE EXISTING CURVED PLEXIGLASS GLAZIN
- REMOVE EXISTING CURVED PLEXIGLASS GLAZING. FRAMING TO REMAIN.
- REMOVE EXISTING PLYWOOD COVER AT CURVED GLASS GLAZING.

PRELIMINARY

NOT FOR

CONSTRUCTION

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DING RENOVATIC

Revisions:

Sheet Name: FIRST FLOOR DEMOLITION

Date: 01/12/2016

Drawn By: CLR/EJL

Project No.: 10031.04

No.

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01/12/2016 Drawn By: CLR/EJL Project No.: 10031.04

Sheet No.



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TENANT ENTRY BELOW

-SEE FIRST FLOOR

GENERAL DEMOLITION NOTES

- REMOVE ALL EXISTING FLOOR COVERING
- REMOVE ALL EXISTING SUSPENDED CEILINGS
- REMOVE ALL EXISTING ABOVE—CEILING MECHANICAL DUCTWORK.

REMOVE ALL EXISTING ABOVE—CEILING ELECTRICAL

REMOVE ALL EXISTING ABOVE—CEILING PLUMBING

ALL CONCRETE COLUMNS TO REMAIN EXPOSED.

LATERALS — WASTE & SUPPLY.

EXISTING WALLS TO REMAIN

====== EXISTING WALLS TO BE REMOVED

EXISTING DOORS TO REMAIN

EXISTING DOOR TO BE REMOVED

LEGEND

REMOVE ALL EXISTING WINDOW TREATMENTS.

- REMOVE EXISTING NON-HISTORIC DOOR, FRAME AND HARDWARE. REMOVE EXISTING NON—HISTORIC PLUMBING FIXTURES AND CAP AS REQUIRED.
 - 4) REMOVE EXISTING NON-HISTORIC MILLWORK.

DEMOLITION NOTES

- FREMOVE EXISTING NON-HISTORIC TOILET PARTITIONS.

REMOVE EXISTING WALLS AND ALL ASSOCIATED ELECTRICAL.

- 6 REMOVE EXISTING MASONRY INFILL AT HISTORIC WINDOW OPENING. MAINTAIN EXISTING SILLS AND MASONRY WALL BELOW WHERE PRESENT. PREP OPENING FOR NEW WINDOW/DOOR. SEE PLANS AND ELEVATIONS.
- 7) EXISTING ELEVATOR TO REMAIN.
- (8) EXISTING FREIGHT ELEVATOR TO BE REMOVED.
- (9) EXISTING STAIR TO REMAIN. (10) EXISTING STAIR TO BE REMOVED.
- 11) VERIFY CONDITION OF EXISTING DECORATIVE HANDRAIL.
- REMOVE EXISTING FLOOR STRUCTURE AS REQUIRED FOR NEW PASSENGER ELEVATOR.
- REMOVE EXISTING HOLLOW METAL DOORS TO FIRE ESCAPE. REMOVE EXISTING FIRE ESCAPE TO THE EXTENT INDICATED. CUT ALL MOUNTING BRACKETS FLUSH
- (15) REMOVE EXISTING ENTRY RAMP AND GUARDRAIL.
- REMOVE EXISTING ALUMINUM STOREFRONT SEE ELEVATIONS FOR EXTENTS.
- (17) REMOVE EXISTING ALUMINUM WINDOWS. REMOVE EXISTING LOUVER AND ADJACENT MASONRY FOR INSTALLATION OF NEW WINDOW — SEE
- ELEVATIONS. (19) REMOVE PORTION OF EXISTING MASONRY WALL AND
- PLANS AND ELEVATIONS. 20) REMOVE EXISTING OVERHEAD COILING DOOR AND
- 21) REMOVE EXISTING WINDOW AND ADJACENT MASONRY FOR INSTALLATION OF NEW WINDOW — SEE ELEVATIONS.
- 22) EXISTING HISTORIC STAIR TO REMAIN. REPAIR AS REQUIRED.
- REMOVE EXISTING ROOFING AND WOOD FRAMED ATTIC DOWN TO CONCRETE DECK SEE BUILDING
- (24) REMOVE EXISTING A/C CONDENSER.
- 25) EXISTING ROOF ACCESS LADDER TO REMAIN.
- EXISTING CHILLERS TO BE REMOVED. STEEL MOUNTING STRUCTURE TO REMAIN.
- REMOVE EXISTING STEEL WATER TANKS, PIPING AND MOUNTING STRUCTURE.
- REMOVE EXISTING OVERHEAD COILING DOOR. EXISTING OPENING TO REMAIN.
- EXISTING BOILER TO BE REMOVED.
- 30) EXISTING AIR HANDLING UNIT AND ASSOCIATED DUCTWORK TO BE REMOVED.
- REMOVE EXISTING ROOFING DOWN TO SUB-STRUCTURE PREPARE FOR RE-ROOFING.
- (32) EXISTING ELECTRICAL GEAR TO REMAIN.
- (33) REUSE OR RECONFIGURE EXISTING WALL LOUVER.
- (34) EXISTING CHIMNEY TO REMAIN.
- 35) REMOVE EXISTING CHIMNEY
- REMOVE EXISTING ELEVATOR, EQUIPMENT, PENTHOUSE SUBFLOOR AND ACCESS STAIR.
- REMOVE EXISTING SHEET METAL GRAVEL STOP PREPARE FOR INSTALLATION OF NEW PARAPET CAP.
- (38) EXISTING FLAGPOLE TO REMAIN.
- (39) REMOVE EXISTING ATTIC ACCESS. (40) EXISTING HARP LIGHT AND POST TO REMAIN.
- REMOVE EXISTING CURVED PLEXIGLASS GLAZING. FRAMING TO REMAIN.
- REMOVE EXISTING PLYWOOD COVER AT CURVED GLASS GLAZING.

1) MEZZANINE DEMOLITION PLAN

SCALE: 1/8" = 1'-0"

LIBRARY ENTRY BELOW -SEE

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GENERAL DEMOLITION NOTES

REMOVE ALL EXISTING FLOOR COVERING

DUCTWORK.

LEGEND

- REMOVE ALL EXISTING SUSPENDED CEILINGS
- REMOVE ALL EXISTING ABOVE—CEILING MECHANICAL

REMOVE ALL EXISTING ABOVE—CEILING ELECTRICAL

REMOVE ALL EXISTING ABOVE—CEILING PLUMBING

ALL CONCRETE COLUMNS TO REMAIN EXPOSED.

LATERALS — WASTE & SUPPLY.

EXISTING WALLS TO REMAIN

= = = Existing walls to be removed

EXISTING DOORS TO REMAIN

EXISTING DOOR TO BE REMOVED

• REMOVE ALL EXISTING WINDOW TREATMENTS.

- REMOVE EXISTING NON-HISTORIC DOOR, FRAME AND HARDWARE.
 - REMOVE EXISTING NON-HISTORIC PLUMBING FIXTURES AND CAP AS REQUIRED.

REMOVE EXISTING WALLS AND ALL ASSOCIATED ELECTRICAL.

DEMOLITION NOTES

- 4) REMOVE EXISTING NON-HISTORIC MILLWORK.
- FARTITIONS.
- 6 REMOVE EXISTING MASONRY INFILL AT HISTORIC WINDOW OPENING. MAINTAIN EXISTING SILLS AND MASONRY WALL BELOW WHERE PRESENT. PREP OPENING FOR NEW WINDOW/DOOR. SEE PLANS AND ELEVATIONS.
- 7) EXISTING ELEVATOR TO REMAIN.
- (8) EXISTING FREIGHT ELEVATOR TO BE REMOVED.
- (9) EXISTING STAIR TO REMAIN. (10) EXISTING STAIR TO BE REMOVED.
- 11) VERIFY CONDITION OF EXISTING DECORATIVE
- HANDRAIL.
- REMOVE EXISTING FLOOR STRUCTURE AS REQUIRED FOR NEW PASSENGER ELEVATOR.
- REMOVE EXISTING HOLLOW METAL DOORS TO FIRE ESCAPE. REMOVE EXISTING FIRE ESCAPE TO THE EXTENT INDICATED. CUT ALL MOUNTING BRACKETS FLUSH

WITH MOUNTING PLATE OF FACE OF MASONRY

- WHERE EMBEDDED. SEE ELEVATIONS. (15) REMOVE EXISTING ENTRY RAMP AND GUARDRAIL.
- REMOVE EXISTING ALUMINUM STOREFRONT SEE ELEVATIONS FOR EXTENTS.
- (17) REMOVE EXISTING ALUMINUM WINDOWS. REMOVE EXISTING LOUVER AND ADJACENT MASONRY FOR INSTALLATION OF NEW WINDOW — SEE
- ELEVATIONS. 19) REMOVE PORTION OF EXISTING MASONRY WALL AND
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- PREPARE FOR MASONRY INFILL. 21) REMOVE EXISTING WINDOW AND ADJACENT MASONRY FOR INSTALLATION OF NEW WINDOW - SEE
- 22) EXISTING HISTORIC STAIR TO REMAIN. REPAIR AS REQUIRED.
- REMOVE EXISTING ROOFING AND WOOD FRAMED ATTIC DOWN TO CONCRETE DECK SEE BUILDING SECTION.
- (24) REMOVE EXISTING A/C CONDENSER.

ELEVATIONS.

- 25) EXISTING ROOF ACCESS LADDER TO REMAIN.
- EXISTING CHILLERS TO BE REMOVED. STEEL MOUNTING STRUCTURE TO REMAIN.
- REMOVE EXISTING STEEL WATER TANKS, PIPING AND MOUNTING STRUCTURE.
- REMOVE EXISTING OVERHEAD COILING DOOR. EXISTING OPENING TO REMAIN.
- EXISTING BOILER TO BE REMOVED.
- EXISTING AIR HANDLING UNIT AND ASSOCIATED DUCTWORK TO BE REMOVED.
- REMOVE EXISTING ROOFING DOWN TO SUB-STRUCTURE PREPARE FOR RE-ROOFING.
- $\widehat{32}$ Existing electrical gear to remain.
- 33) REUSE OR RECONFIGURE EXISTING WALL LOUVER. (34) EXISTING CHIMNEY TO REMAIN.
- 35) REMOVE EXISTING CHIMNEY
- REMOVE EXISTING ELEVATOR, EQUIPMENT, PENTHOUSE SUBFLOOR AND ACCESS STAIR.
- REMOVE EXISTING SHEET METAL GRAVEL STOP PREPARE FOR INSTALLATION OF NEW PARAPET CAP.
- (38) EXISTING FLAGPOLE TO REMAIN.
- (39) REMOVE EXISTING ATTIC ACCESS.
- (40) EXISTING HARP LIGHT AND POST TO REMAIN.
- REMOVE EXISTING CURVED PLEXIGLASS GLAZING. FRAMING TO REMAIN.
- REMOVE EXISTING PLYWOOD COVER AT CURVED GLASS GLAZING.

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Revisions:

Sheet Name: SECOND, THIRD AND FOURTH

FLOOR DEMOLITION PLAN

Date: 01/12/2016 Drawn By: CLR/EJL Project No.: 10031.04

D1.2

SECOND, THIRD AND FOURTH FLOOR DEMOLITION PLAN

SCALE: 1/8" = 1'-0"

1) FIFTH FLOOR DEMOLITION PLAN

SCALE: 1/8" = 1'-0"

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GENERAL DEMOLITION NOTES

REMOVE ALL EXISTING FLOOR COVERING

LATERALS - WASTE & SUPPLY.

EXISTING WALLS TO REMAIN

= = = Existing walls to be removed

EXISTING DOORS TO REMAIN

EXISTING DOOR TO BE REMOVED

LEGEND

• REMOVE ALL EXISTING WINDOW TREATMENTS.

ALL CONCRETE COLUMNS TO REMAIN EXPOSED.

- REMOVE ALL EXISTING SUSPENDED CEILINGS
- REMOVE ALL EXISTING ABOVE—CEILING MECHANICAL
- DUCTWORK. REMOVE ALL EXISTING ABOVE—CEILING ELECTRICAL
- 4) REMOVE EXISTING NON-HISTORIC MILLWORK. REMOVE ALL EXISTING ABOVE—CEILING PLUMBING
 - - FREMOVE EXISTING NON-HISTORIC TOILET PARTITIONS.

DEMOLITION NOTES

REMOVE EXISTING WALLS AND ALL ASSOCIATED ELECTRICAL.

REMOVE EXISTING NON-HISTORIC DOOR, FRAME AND HARDWARE.

REMOVE EXISTING NON-HISTORIC PLUMBING FIXTURES AND CAP AS REQUIRED.

- 6 REMOVE EXISTING MASONRY INFILL AT HISTORIC WINDOW OPENING. MAINTAIN EXISTING SILLS AND MASONRY WALL BELOW WHERE PRESENT. PREP OPENING FOR NEW WINDOW/DOOR. SEE PLANS AND ELEVATIONS.
- 7) EXISTING ELEVATOR TO REMAIN.
- (8) EXISTING FREIGHT ELEVATOR TO BE REMOVED.
- (9) EXISTING STAIR TO REMAIN. (10) EXISTING STAIR TO BE REMOVED.

HANDRAIL.

- 11) VERIFY CONDITION OF EXISTING DECORATIVE
- REMOVE EXISTING FLOOR STRUCTURE AS REQUIRED FOR NEW PASSENGER ELEVATOR.
- REMOVE EXISTING HOLLOW METAL DOORS TO FIRE ESCAPE.
- REMOVE EXISTING FIRE ESCAPE TO THE EXTENT INDICATED. CUT ALL MOUNTING BRACKETS FLUSH WITH MOUNTING PLATE OF FACE OF MASONRY

WHERE EMBEDDED. — SEE ELEVATIONS.

- (15) REMOVE EXISTING ENTRY RAMP AND GUARDRAIL.
- REMOVE EXISTING ALUMINUM STOREFRONT SEE ELEVATIONS FOR EXTENTS.
- (17) REMOVE EXISTING ALUMINUM WINDOWS.

PREPARE FOR MASONRY INFILL.

ELEVATIONS.

ELEVATIONS.

- REMOVE EXISTING LOUVER AND ADJACENT MASONRY FOR INSTALLATION OF NEW WINDOW SEE
- 19) REMOVE PORTION OF EXISTING MASONRY WALL AND PREP FOR NEW WINDOW/DOOR/LOUVER. SEE
- PLANS AND ELEVATIONS. 20) REMOVE EXISTING OVERHEAD COILING DOOR AND
- 21) REMOVE EXISTING WINDOW AND ADJACENT MASONRY FOR INSTALLATION OF NEW WINDOW - SEE
- 22) EXISTING HISTORIC STAIR TO REMAIN. REPAIR AS REQUIRED.
- REMOVE EXISTING ROOFING AND WOOD FRAMED ATTIC DOWN TO CONCRETE DECK SEE BUILDING SECTION.
- (24) REMOVE EXISTING A/C CONDENSER.
- 25) EXISTING ROOF ACCESS LADDER TO REMAIN.
- EXISTING CHILLERS TO BE REMOVED. STEEL MOUNTING STRUCTURE TO REMAIN.
- REMOVE EXISTING STEEL WATER TANKS, PIPING AND MOUNTING STRUCTURE.
- REMOVE EXISTING OVERHEAD COILING DOOR. EXISTING OPENING TO REMAIN.
- EXISTING BOILER TO BE REMOVED.
- EXISTING AIR HANDLING UNIT AND ASSOCIATED DUCTWORK TO BE REMOVED.
- REMOVE EXISTING ROOFING DOWN TO SUB-STRUCTURE PREPARE FOR RE-ROOFING.
- (32) EXISTING ELECTRICAL GEAR TO REMAIN.
- (33) REUSE OR RECONFIGURE EXISTING WALL LOUVER.
- (34) EXISTING CHIMNEY TO REMAIN. 35) REMOVE EXISTING CHIMNEY
- REMOVE EXISTING ELEVATOR, EQUIPMENT, PENTHOUSE SUBFLOOR AND ACCESS STAIR.
- REMOVE EXISTING SHEET METAL GRAVEL STOP PREPARE FOR INSTALLATION OF NEW PARAPET CAP.
- (38) EXISTING FLAGPOLE TO REMAIN.
- (39) REMOVE EXISTING ATTIC ACCESS.
- (40) EXISTING HARP LIGHT AND POST TO REMAIN.
- REMOVE EXISTING CURVED PLEXIGLASS GLAZING. FRAMING TO REMAIN.
- REMOVE EXISTING PLYWOOD COVER AT CURVED GLASS GLAZING.

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Revisions:

Sheet Name: FIFTH FLOOR DEMOLITION

01/12/2016 Drawn By: CLR/EJL Project No.: 10031.04

REMOVE ALL EXISTING FLOOR COVERING

DUCTWORK.

LEGEND

REMOVE ALL EXISTING SUSPENDED CEILINGS

REMOVE ALL EXISTING ABOVE—CEILING MECHANICAL

REMOVE ALL EXISTING ABOVE—CEILING ELECTRICAL

REMOVE ALL EXISTING ABOVE—CEILING PLUMBING

LATERALS - WASTE & SUPPLY.

EXISTING WALLS TO REMAIN

= = = Existing walls to be removed

EXISTING DOORS TO REMAIN

EXISTING DOOR TO BE REMOVED

REMOVE ALL EXISTING WINDOW TREATMENTS.

ALL CONCRETE COLUMNS TO REMAIN EXPOSED.

REMOVE EXISTING NON-HISTORIC DOOR, FRAME AND HARDWARE.

REMOVE EXISTING NON-HISTORIC PLUMBING FIXTURES AND CAP AS REQUIRED.

4) REMOVE EXISTING NON-HISTORIC MILLWORK.

FARTITIONS. 6 REMOVE EXISTING MASONRY INFILL AT HISTORIC WINDOW OPENING. MAINTAIN EXISTING SILLS AND MASONRY WALL BELOW WHERE PRESENT. PREP

OPENING FOR NEW WINDOW/DOOR. SEE PLANS AND

7) EXISTING ELEVATOR TO REMAIN.

ELEVATIONS.

(8) EXISTING FREIGHT ELEVATOR TO BE REMOVED.

(9) EXISTING STAIR TO REMAIN. (10) EXISTING STAIR TO BE REMOVED.

VERIFY CONDITION OF EXISTING DECORATIVE HANDRAIL.

REMOVE EXISTING FLOOR STRUCTURE AS REQUIRED FOR NEW PASSENGER ELEVATOR.

WITH MOUNTING PLATE OF FACE OF MASONRY WHERE EMBEDDED. — SEE ELEVATIONS.

REMOVE EXISTING HOLLOW METAL DOORS TO FIRE ESCAPE. REMOVE EXISTING FIRE ESCAPE TO THE EXTENT INDICATED. CUT ALL MOUNTING BRACKETS FLUSH

(15) REMOVE EXISTING ENTRY RAMP AND GUARDRAIL.

REMOVE EXISTING ALUMINUM STOREFRONT — SEE ELEVATIONS FOR EXTENTS.

(17) REMOVE EXISTING ALUMINUM WINDOWS.

REMOVE EXISTING LOUVER AND ADJACENT MASONRY FOR INSTALLATION OF NEW WINDOW — SEE ELEVATIONS.

REMOVE PORTION OF EXISTING MASONRY WALL AND PREP FOR NEW WINDOW/DOOR/LOUVER. SEE PLANS AND ELEVATIONS.

REMOVE EXISTING OVERHEAD COILING DOOR AND PREPARE FOR MASONRY INFILE PREPARE FOR MASONRY INFILL.

21) REMOVE EXISTING WINDOW AND ADJACENT MASONRY FOR INSTALLATION OF NEW WINDOW - SEE ELEVATIONS.

22) EXISTING HISTORIC STAIR TO REMAIN. REPAIR AS REQUIRED.

REMOVE EXISTING ROOFING AND WOOD FRAMED ATTIC DOWN TO CONCRETE DECK — SEE BUILDING SECTION.

(24) REMOVE EXISTING A/C CONDENSER. 25) EXISTING ROOF ACCESS LADDER TO REMAIN.

EXISTING CHILLERS TO BE REMOVED. STEEL MOUNTING STRUCTURE TO REMAIN.

REMOVE EXISTING STEEL WATER TANKS, PIPING AND MOUNTING STRUCTURE.

REMOVE EXISTING OVERHEAD COILING DOOR. EXISTING OPENING TO REMAIN.

EXISTING BOILER TO BE REMOVED.

(30) EXISTING AIR HANDLING UNIT AND ASSOCIATED DUCTWORK TO BE REMOVED.

REMOVE EXISTING ROOFING DOWN TO SUB-STRUCTURE - PREPARE FOR RE-ROOFING.

 $\widehat{32}$) Existing electrical gear to remain.

(33) REUSE OR RECONFIGURE EXISTING WALL LOUVER.

(34) EXISTING CHIMNEY TO REMAIN.

35) REMOVE EXISTING CHIMNEY

REMOVE EXISTING ELEVATOR, EQUIPMENT, PENTHOUSE SUBFLOOR AND ACCESS STAIR.

REMOVE EXISTING SHEET METAL GRAVEL STOP - PREPARE FOR INSTALLATION OF NEW PARAPET CAP.

(38) EXISTING FLAGPOLE TO REMAIN.

(39) REMOVE EXISTING ATTIC ACCESS. (40) EXISTING HARP LIGHT AND POST TO REMAIN.

REMOVE EXISTING CURVED PLEXIGLASS GLAZING. FRAMING TO REMAIN.

REMOVE EXISTING PLYWOOD COVER AT CURVED GLASS GLAZING.

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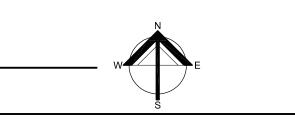
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Revisions:

Sheet Name: **UPPER ROOF DEMOLITION PLAN**

01/12/2016 Drawn By: CLR/EJL Project No.: 10031.04



NORTH BUILDING ROOF — SEE SHEET D1.2 FOR PLAN FELEVATOR 7 EQUIPMENT **└** # ╮ ROOF BELOW — SEE A1.5 FOR ROOF DEMOLITION 0 ° "----

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ELEVATION DEMOLITION NOTES

EXISTING NON-HISTORIC WOOD WINDOWS TO REMAIN. REPAIR FRAME AS REQUIRED.

NEW WINDOWS.

2) EXISTING WOOD STOREFRONT ENTRY TO REMAIN.

REMOVE EXISTING NON-HISTORIC WINDOW SASHES, JAMBS, SILLS AND CASINGS. PREP OPENING FOR

EXISTING NON-HISTORIC STEEL SAFETY BARS TO REMAIN.

(5) EXISTING METAL CORNICE TO REMAIN.

6 EXISTING LIMESTONE PILASTER TO REMAIN.

8 EXISTING LIMESTONE CAP AND TRIM AT BRICK PILASTER.

9 EXISTING CERAMIC COPING TILE TO REMAIN.

(10) EXISTING METAL COPING CAP/ROOF EDGE.

(11) EXISTING UN-PAINTED BRICK MASONRY.

(14) EXISTING PAINTED SIGNAGE TO REMAIN.

REMOVE EXISTING NON-HISTORIC HOLLOW METAL DOOR AND FRAME.

(16) EXISTING NON-HISTORIC HOLLOW METAL DOOR AND FRAME TO REMAIN.

EXISTING NON-HISTORIC TERRAZZO STEP AND RAMP TO REMAIN.

20) EXISTING STEEL GUARD RAIL TO REMAIN AND BE

REMOVE EXISTING STEEL FIRE ESCAPE MOVABLE STAIR RUN TO SECOND FLOOR PLATFORM.

EXISTING BRICK INFILL AT HISTORIC DOOR/WINDOW OPENING TO REMAIN.

22) REMOVE EXISTING STEEL LADDER TO ROOF.

EXISTING FIRE DEPARTMENT SIAMESE HOSE CONNECTION.

EXISTING UN-PAINTED EXPOSED CONCRETE STRUCTURE. RUB, ROUTE AND SEAL EXISTING

CUT EXISTING STONE SILL AND MASONRY WALL BELOW AS REQUIRED FOR NEW DOOR OPENING.

27) CUT NEW DOOR/WINDOW OPENING IN EXISTING

REMOVE EXISTING MASONRY INFILL AT ORIGINAL WINDOW OPENING. EXISTING SILLS AND LINTELS TO

EXISTING NON-HISTORIC CANOPY AND SUPPORT BRACKETS TO REMAIN.

REMOVE EXISTING PLYWOOD COVER AT CURVED GLASS GLAZING.

REMOVE EXISTING CURVED PLEXIGLASS GLAZING. FRAMING TO REMAIN.

(35) EXISTING ROOF ACCESS LADDER TO REMAIN.

(36) EXISTING NON-HISTORIC ALUMINUM STOREFRONT TO BE REMOVED.

(37) REMOVE EXISTING SECURITY GRILLES AT WINDOW.

REMOVE EXISTING BRICK AND SALVAGE FOR REINSTALLATION.

REMOVE EXISTING OVERHEAD GARAGE DOOR. EXISTING OPENING TO REMAIN.

(40) REMOVE ROOF ACCESS DOOR AND FRAME.

REMOVE EXISTING NON-HISTORIC ALUMINUM STOREFRONT FRAMING AND GLAZING AT CLERESTORY TRANSOM.

REMOVE EXISTING NON-HISTORIC ALUMINUM STOREFRONT AND GLAZING FROM SILL AT BULKHEAD TO TRANSOM BAR ABOVE.

(47) EXISTING NON-HISTORIC WINDOW TO REMAIN.

EXISTING BRICK MASONRY. REMOVE EXISTING PAINT PER NPS GUIDELINES.

REMOVE EXISTING BRICK CHIMNEY TO BELOW ROOF.

EXISTING PAINTED BRICK. CLEAN AS REQUIRED FOR TUCKPOINTING AND REPAINTING.

(46) EXISTING LIMESTONE CAP TO REMAIN.

(49) EXISTING FIRE ESCAPE TO REMAIN.

(52) REMOVE EXISTING MECHANICAL GRILLE.

EXISTING TERRAZZO FINISH BELOW STOREFRONT TO REMAIN.

EXISTING NON-HISTORIC METAL TRANSOM BAR TO REMAIN.

(41) REMOVE EXISTING SIGN.

(34) EXISTING FLAGPOLE TO REMAIN.

(31) EXISTING HARP LIGHT AND POST TO REMAIN.

ANGLE LINTEL AS REQUIRED.

(28) REMOVE EXISTING COILING SHUTTER.

MASONRY WALL AND PROVIDE NEW STEEL BEAM OR

CRACKS AS REQUIRED. PARGE OR RE-PARGE EXISTING AREAS OF SCALED CONCRETE TO MATCH

(18) EXISTING SECURITY CAMERA(S) LOCATION.

(19) EXISTING MECHANICAL DUCT TO REMAIN.

REPAIRED.

EXISTING.

(12) EXISTING UN-PAINTED STONE SILL.

(13) EXISTING SIGNAGE TO REMAIN.

7 EXISTING LIMESTONE BELT TO REMAIN.

BUILDING RENOVATION

Revisions:

NPS PART 2 - AMENDMENT #1

10/09/2015


EAST AND WEST
DEMOLITION ELEVATIONS


Date: 01/12/2016

Date: 01/12/20
Drawn By: AJD
Project No.: 10031.04

Sheet Name:

Sheet No.

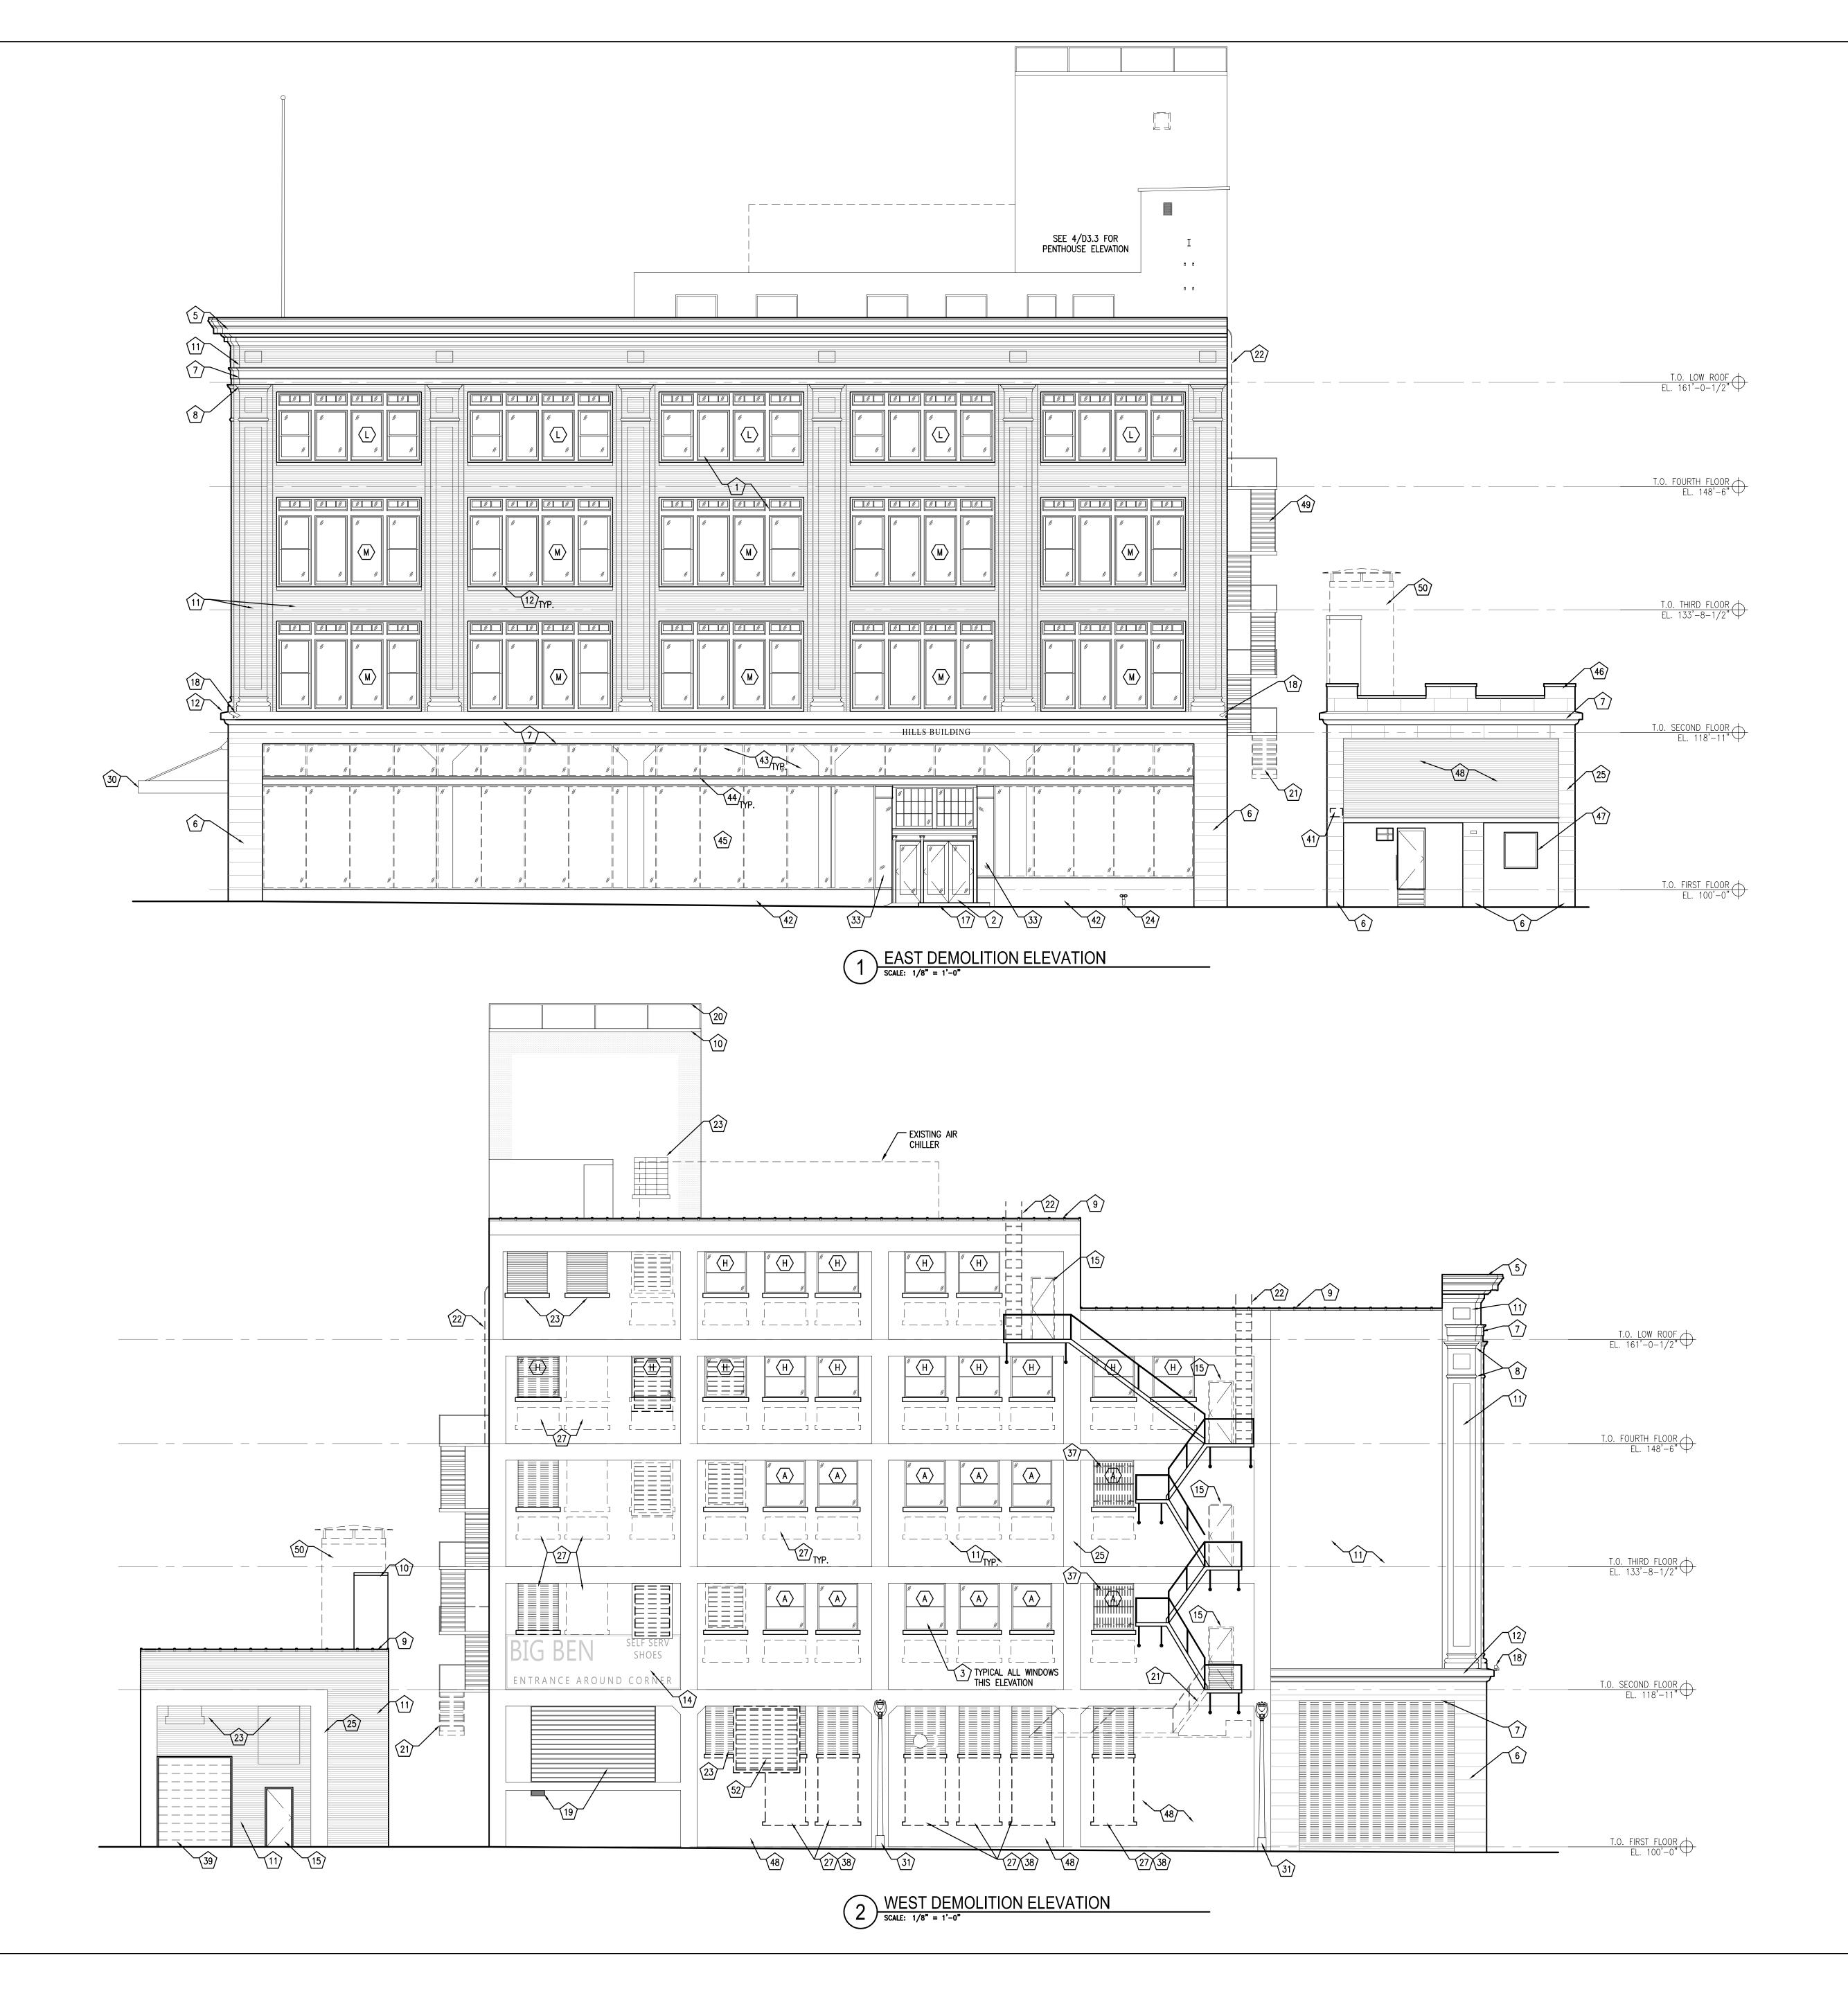

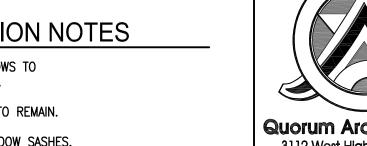

NEW WINDOWS.

REPAIRED.

EXISTING.

ANGLE LINTEL AS REQUIRED.

CLERESTORY TRANSOM.

REMAIN.



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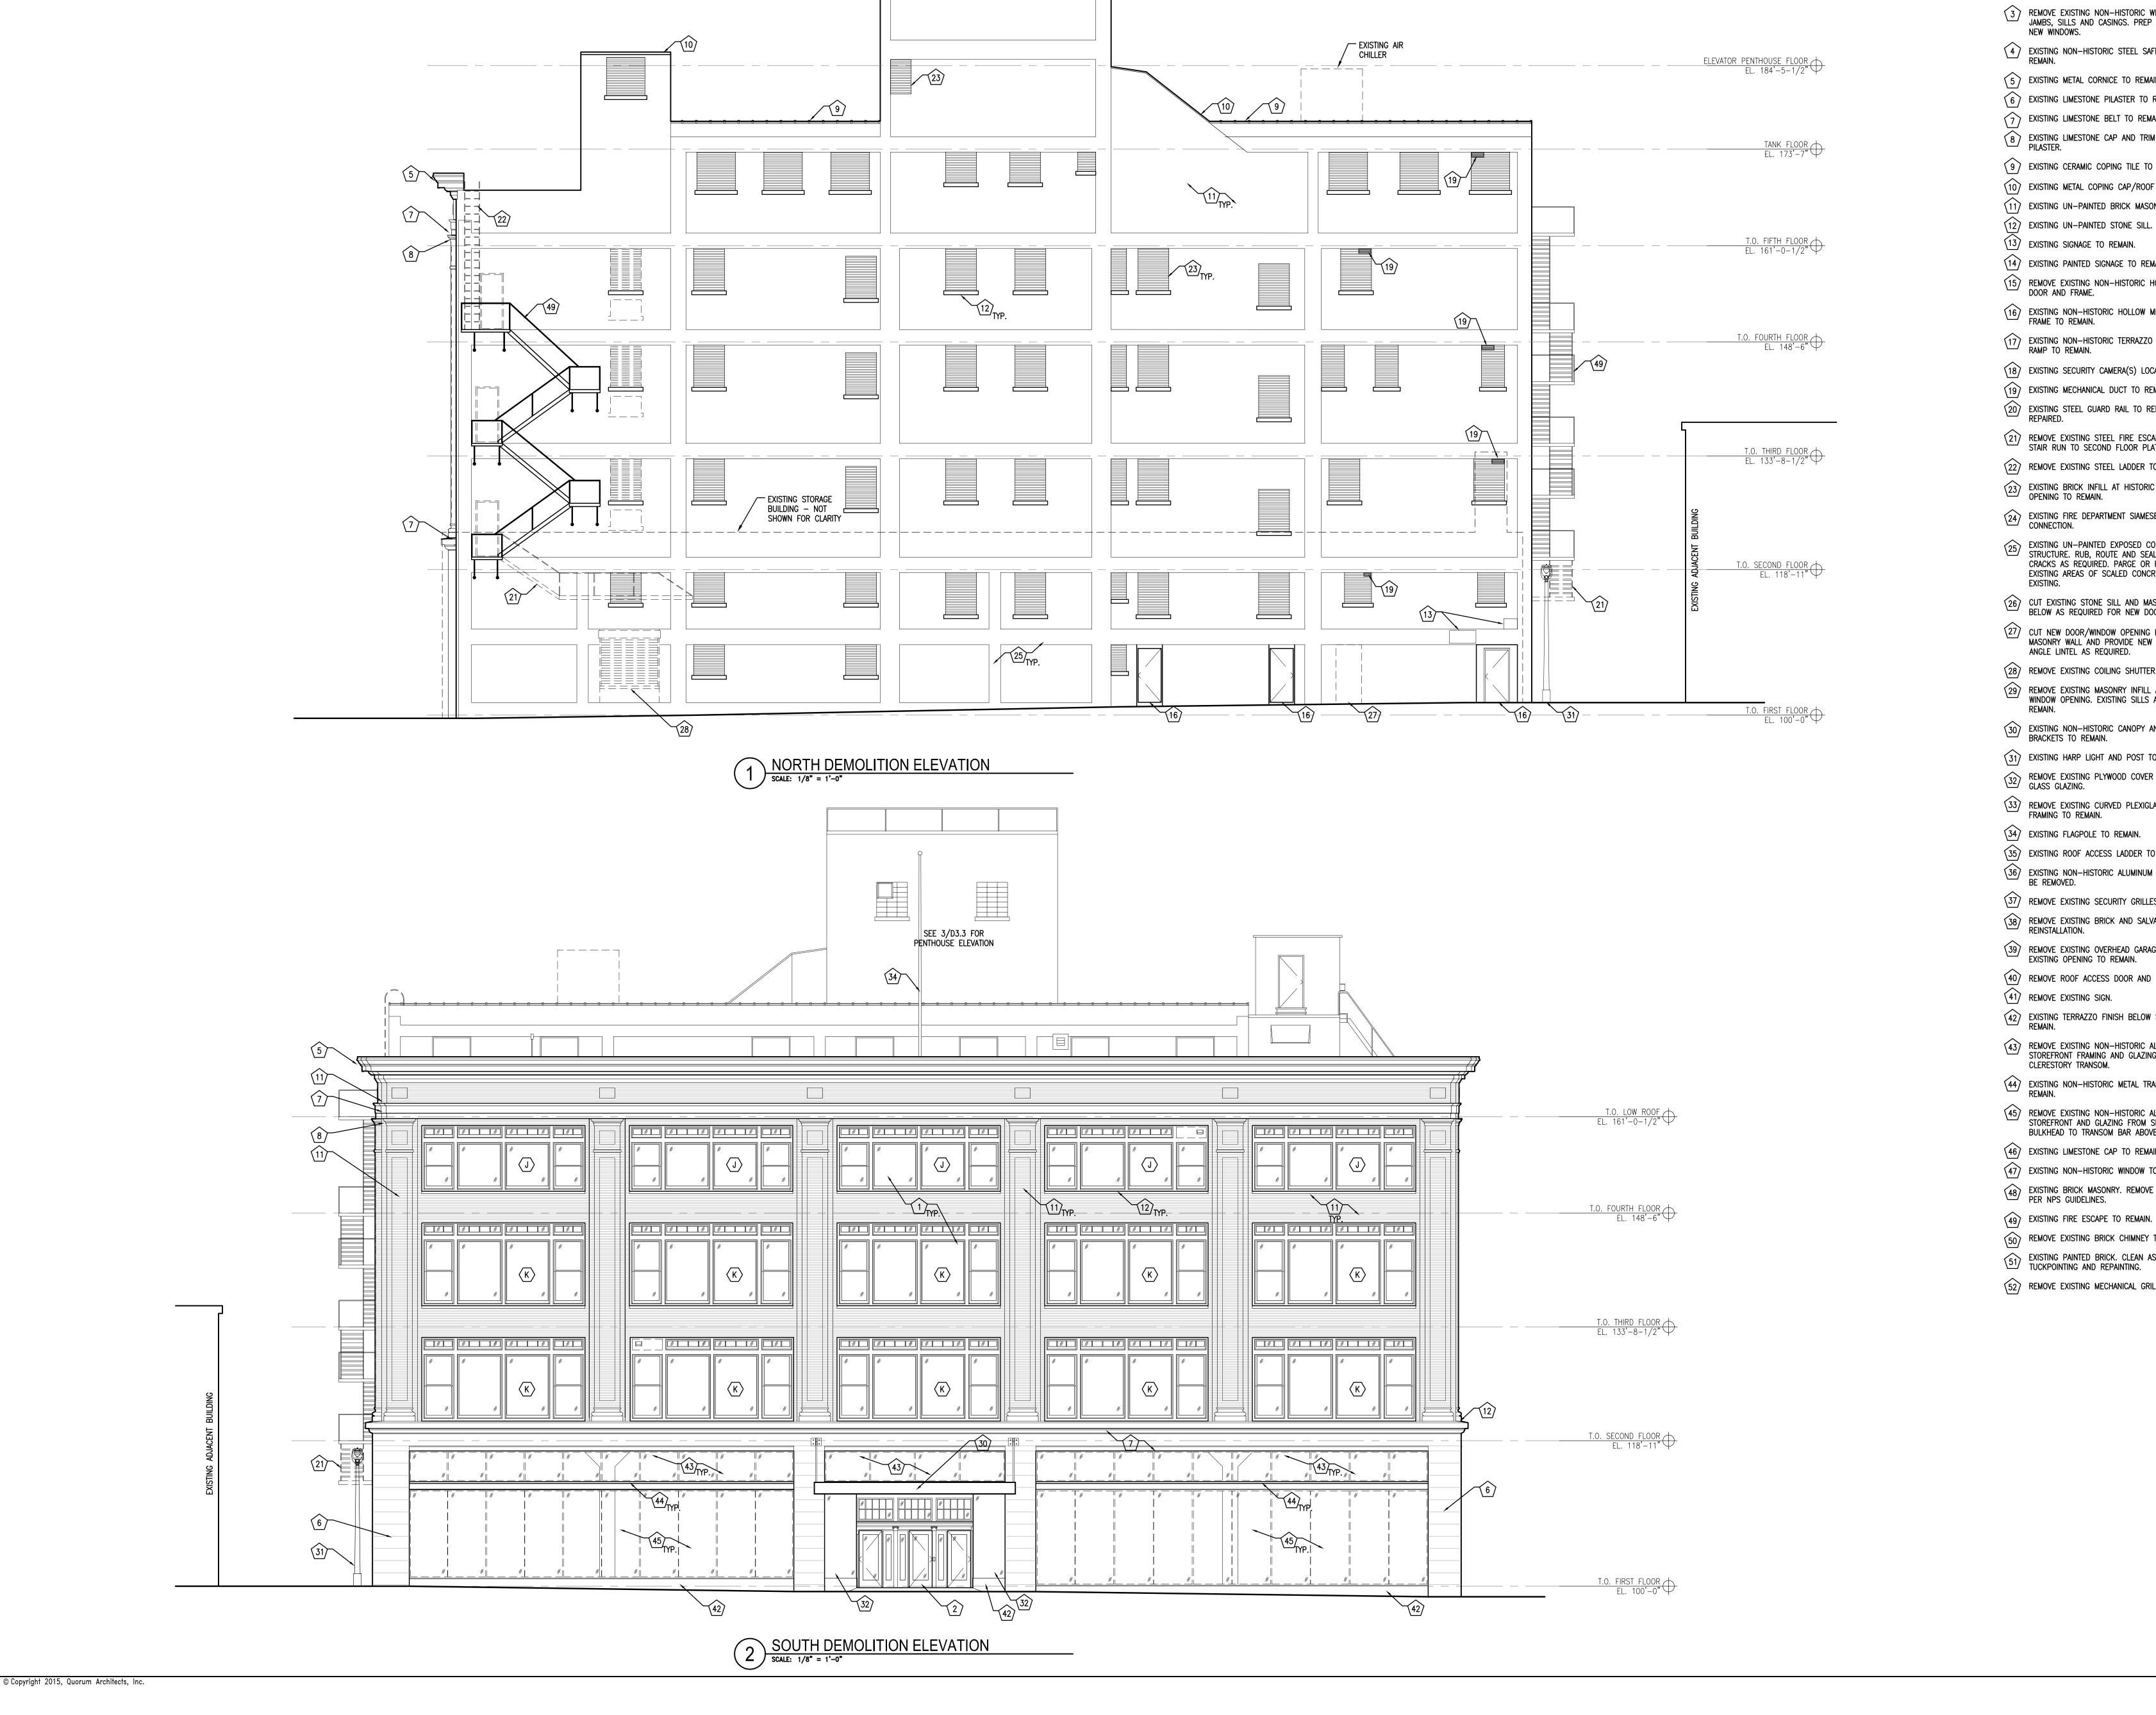
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Date: 01/12/2016 Drawn By: AJD

D3.2

Project No.: 10031.04





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DING. \Box

Revisions: NPS PART 2 - AMENDMENT #1 10/09/2015

Sheet Name: NORTH BUILDING AND

PENTHOUSE DEMOLITION

Date: 01/12/2016 Drawn By: AJD


D3.3


ELEVATIONS

Project No.: 10031.04


NEW WINDOWS. 4) EXISTING NON-HISTORIC STEEL SAFETY BARS TO 5) EXISTING METAL CORNICE TO REMAIN. (6) EXISTING LIMESTONE PILASTER TO REMAIN. 7 EXISTING LIMESTONE BELT TO REMAIN. 8 EXISTING LIMESTONE CAP AND TRIM AT BRICK PILASTER. 9) EXISTING CERAMIC COPING TILE TO REMAIN. (10) EXISTING METAL COPING CAP/ROOF EDGE. (11) EXISTING UN-PAINTED BRICK MASONRY. (12) EXISTING UN-PAINTED STONE SILL. (13) EXISTING SIGNAGE TO REMAIN. (14) EXISTING PAINTED SIGNAGE TO REMAIN. REMOVE EXISTING NON—HISTORIC HOLLOW METAL DOOR AND FRAME. EXISTING NON-HISTORIC HOLLOW METAL DOOR AND FRAME TO REMAIN. EXISTING NON-HISTORIC TERRAZZO STEP AND RAMP TO REMAIN. (18) EXISTING SECURITY CAMERA(S) LOCATION. (19) EXISTING MECHANICAL DUCT TO REMAIN. EXISTING STEEL GUARD RAIL TO REMAIN AND BE REPAIRED. REMOVE EXISTING STEEL FIRE ESCAPE MOVABLE STAIR RUN TO SECOND FLOOR PLATFORM. 22) REMOVE EXISTING STEEL LADDER TO ROOF. EXISTING BRICK INFILL AT HISTORIC DOOR/WINDOW OPENING TO REMAIN. EXISTING FIRE DEPARTMENT SIAMESE HOSE CONNECTION. EXISTING UN-PAINTED EXPOSED CONCRETE STRUCTURE. RUB, ROUTE AND SEAL EXISTING CRACKS AS REQUIRED. PARGE OR RE-PARGE EXISTING AREAS OF SCALED CONCRETE TO MATCH EXISTING. CUT EXISTING STONE SILL AND MASONRY WALL BELOW AS REQUIRED FOR NEW DOOR OPENING. (27) CUT NEW DOOR/WINDOW OPENING IN EXISTING MASONRY WALL AND PROVIDE NEW STEEL BEAM OR ANGLE LINTEL AS REQUIRED. (28) REMOVE EXISTING COILING SHUTTER. REMOVE EXISTING MASONRY INFILL AT ORIGINAL WINDOW OPENING. EXISTING SILLS AND LINTELS TO EXISTING NON-HISTORIC CANOPY AND SUPPORT BRACKETS TO REMAIN. (31) EXISTING HARP LIGHT AND POST TO REMAIN. REMOVE EXISTING PLYWOOD COVER AT CURVED GLASS GLAZING. REMOVE EXISTING CURVED PLEXIGLASS GLAZING. FRAMING TO REMAIN. (34) EXISTING FLAGPOLE TO REMAIN. (35) EXISTING ROOF ACCESS LADDER TO REMAIN. (36) EXISTING NON-HISTORIC ALUMINUM STOREFRONT TO BE REMOVED. (37) REMOVE EXISTING SECURITY GRILLES AT WINDOW. REMOVE EXISTING BRICK AND SALVAGE FOR REINSTALLATION. REMOVE EXISTING OVERHEAD GARAGE DOOR. EXISTING OPENING TO REMAIN. (40) REMOVE ROOF ACCESS DOOR AND FRAME. (41) REMOVE EXISTING SIGN. EXISTING TERRAZZO FINISH BELOW STOREFRONT TO REMAIN. REMOVE EXISTING NON—HISTORIC ALUMINUM STOREFRONT FRAMING AND GLAZING AT STOREFRONT FRAMING AND GLAZING AT CLERESTORY TRANSOM. EXISTING NON-HISTORIC METAL TRANSOM BAR TO REMOVE EXISTING NON-HISTORIC ALUMINUM STOREFRONT AND GLAZING FROM SILL AT BULKHEAD TO TRANSOM BAR ABOVE. (46) EXISTING LIMESTONE CAP TO REMAIN. (47) EXISTING NON-HISTORIC WINDOW TO REMAIN. EXISTING BRICK MASONRY. REMOVE EXISTING PAINT PER NPS GUIDELINES. 49) EXISTING FIRE ESCAPE TO REMAIN. \$\frac{1}{50}\$ REMOVE EXISTING BRICK CHIMNEY TO BELOW ROOF. EXISTING PAINTED BRICK. CLEAN AS REQUIRED FOR TUCKPOINTING AND REPAINTING. (52) REMOVE EXISTING MECHANICAL GRILLE.

T.O. SECOND FLOOR EL. 118'-11" NORTH BUILDING NORTH DEMOLITION ELEVATION 7======

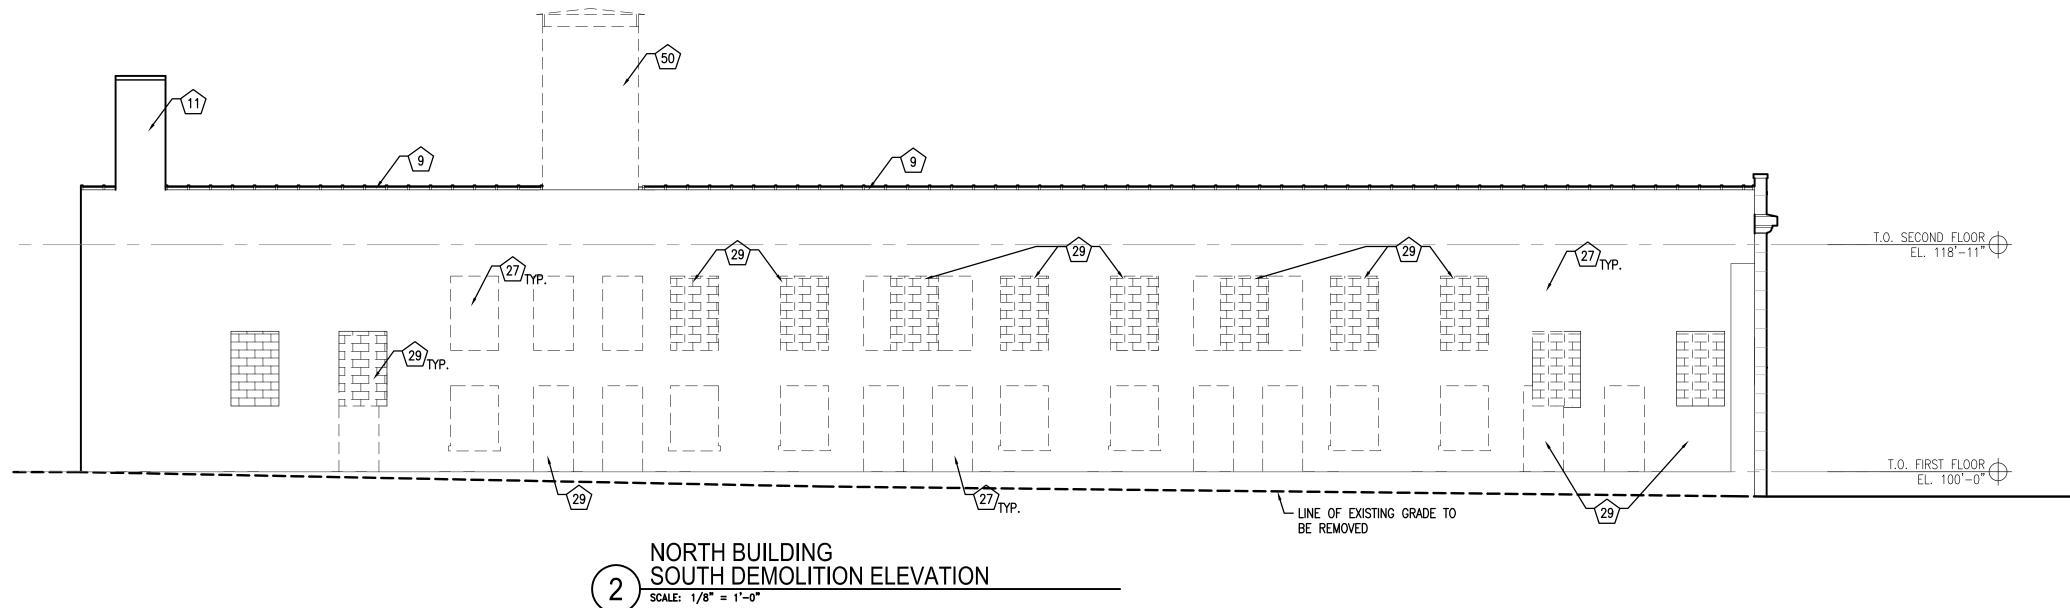

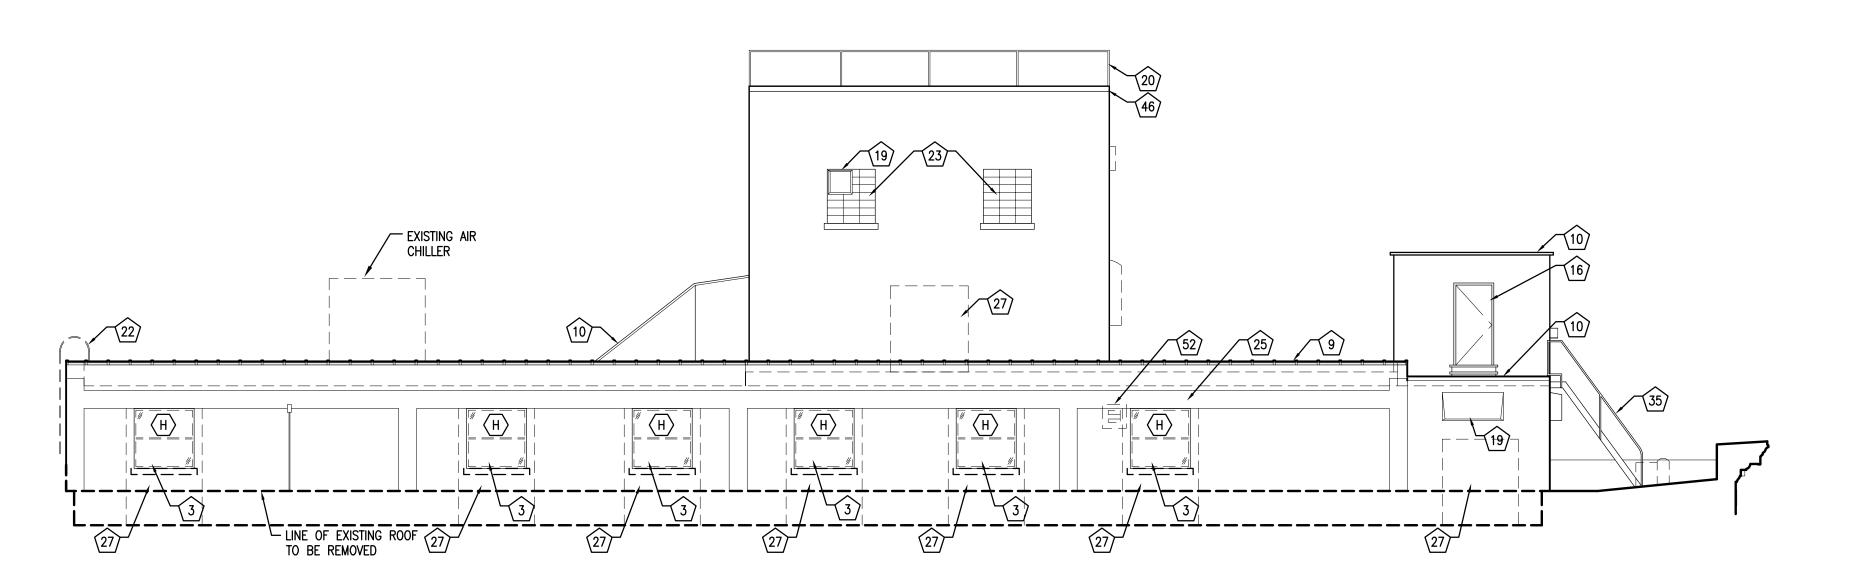




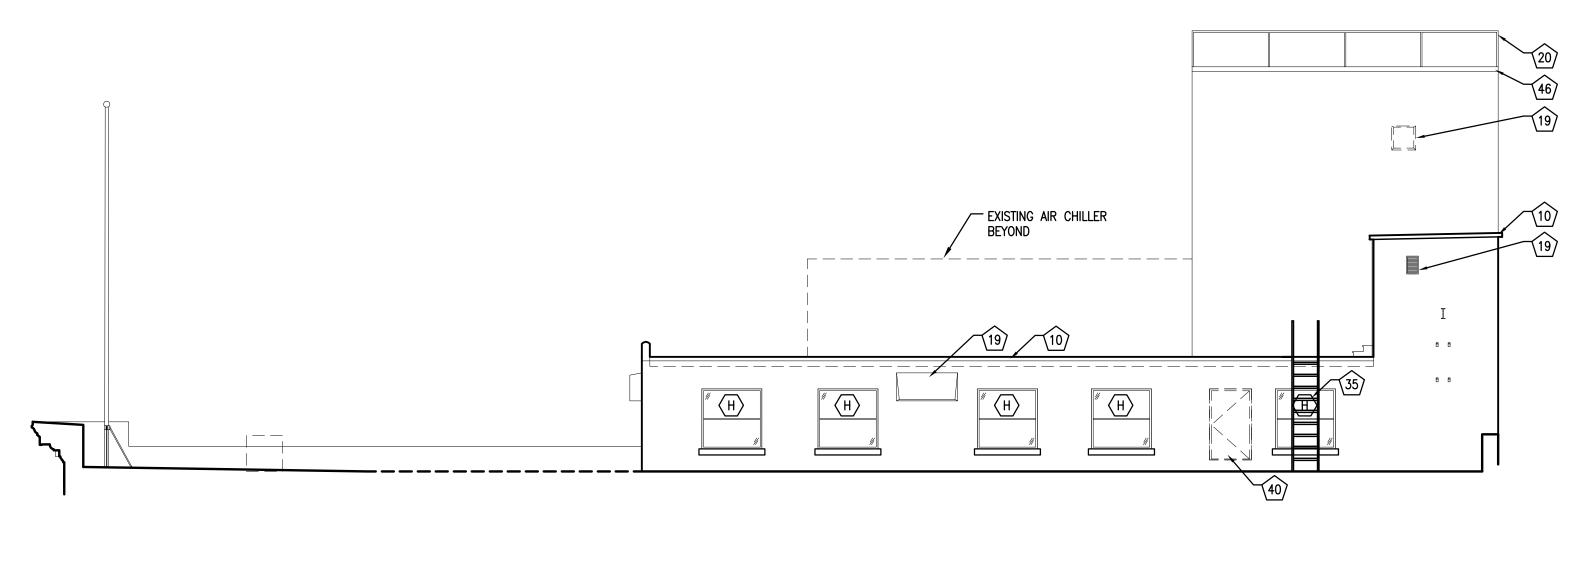

PENTHOUSE

LEAST DEMOLITION ELEVATION

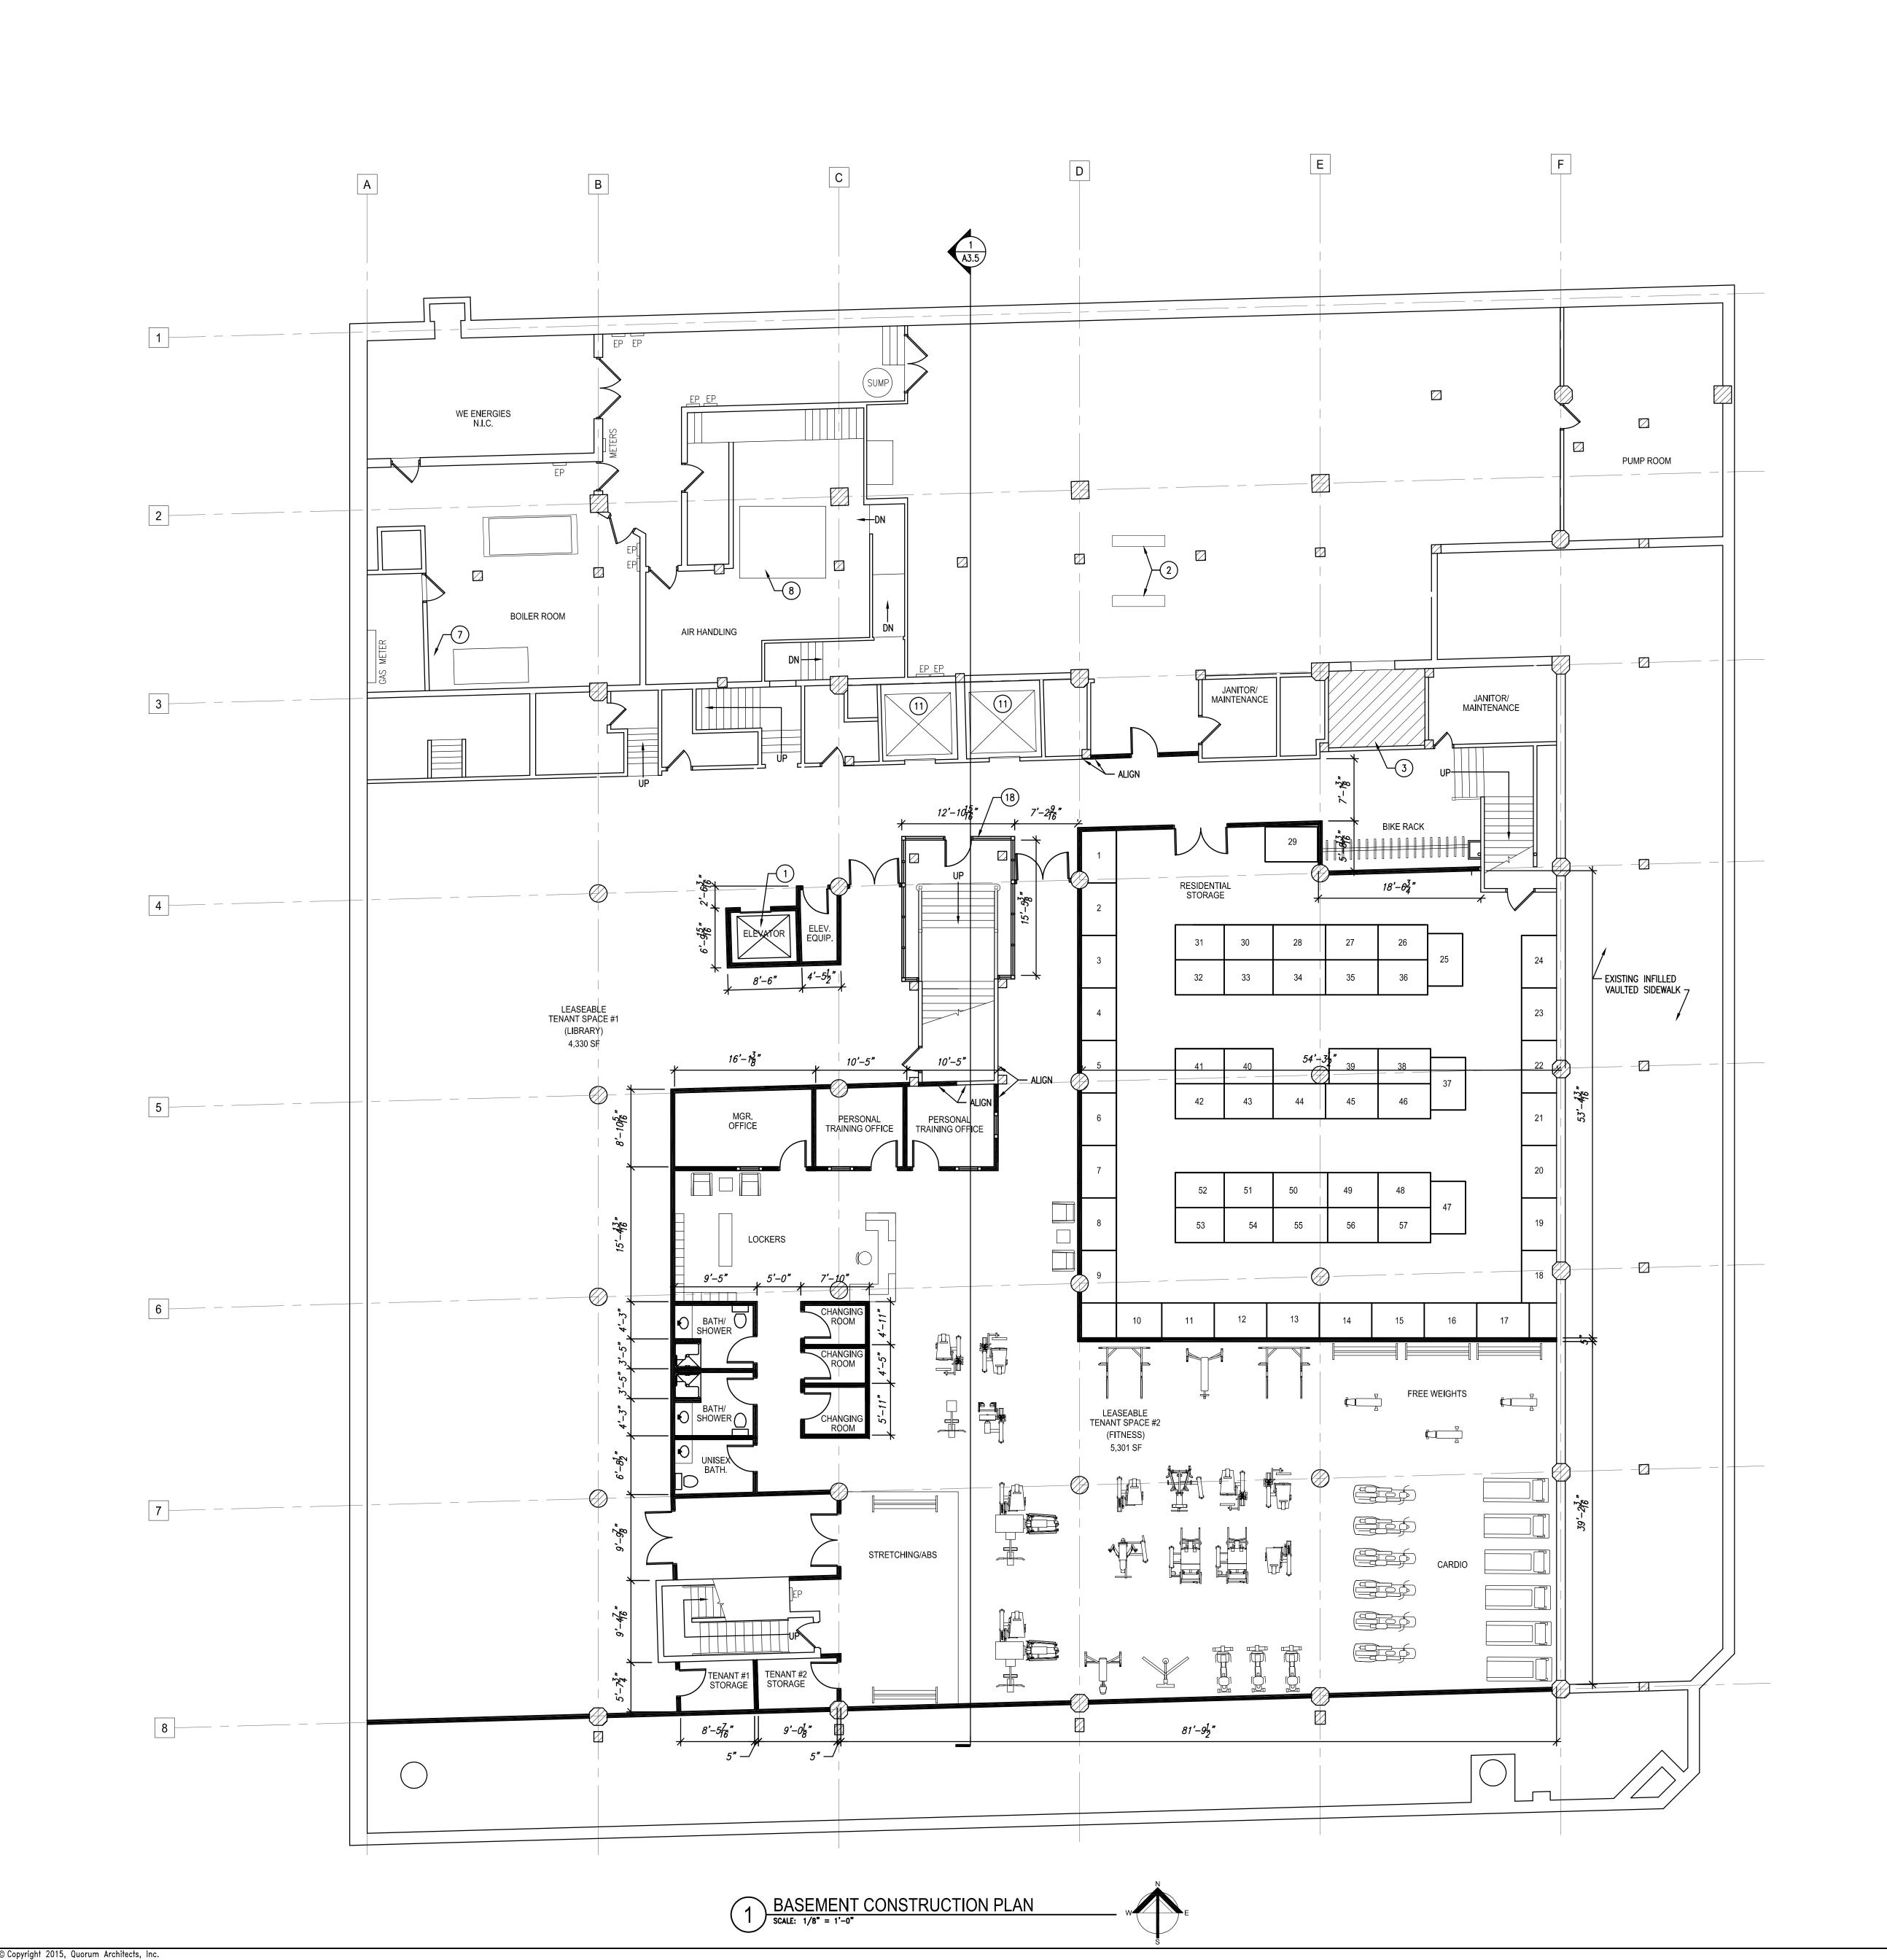

CONSTRUCTION NOTES

- NEW PASSENGER ELEVATOR THREE-STOP: BASEMENT, FIRST FLOOR, MEZZANINE.
- (2) PATCH FLOOR AT LOCATION OF REMOVED STAIR.
- 3 INFILL FLOOR OPENING AT REMOVED STAIR/AIR-SHAFT/ELEVATOR TO MATCH EXISTING FLOOR STRUCTURE.
- (4) NEW CONCRETE RAMP.
- (5) REINSTALL SALVAGED HISTORIC RAILING.
- 6 NEW ALUMINUM STOREFRONT TO MATCH EXISTING, WITH INSULATED GLAZING SEE ELEVATIONS.
- (7) NEW BOILERS TO REPLACE EXISTING IN KIND.
- 8 NEW AIR HANDLING UNIT TO REPLACE EXISTING IN KIND.
- 9 NEW ELEVATOR SHAFT OVERRUN PER NEW PASSENGER ELEVATOR SPECIFICATIONS.
- PROVIDE NEW PUSH BUTTON AUTOMATIC DOOR OPERATOR AT EXISTING DOOR.
- 11) EXISTING PASSENGER ELEVATOR:
 RECONFIGURE CONTROLS TO LOCK-OUT
- MEZZANINE LEVEL. EXTEND TRAVEL OF WEST ELEVATOR ONLY TO SIXTH FLOOR ROOF LEVEL.
- (12) NEW ALUMINUM WINDOW SEE ELEVATIONS
- (13) NEW ENTRY DOOR SEE ELEVATIONS
- (14) NEW OVERHEAD COILING DOOR SEE ELEVATIONS
- (15) MASONRY INFILL AT EXISTING OPENING
- (16) DECORATIVE METAL FENCE SEE ELEVATIONS.
- (17) EXISTING ENTRANCE SYSTEM TO REMAIN.
- (18) NEW ALUMINUM/GLASS ENTRY SYSTEM NEW CONCRETE PLAZA DECK OVER WATERPROOFING MEMBRANE ON EXISTING STRUCTURAL DECK.
- (20) NEW CONCRETE STAIR TO NEW PLAZA DECK LEVEL.
- EXISTING DECORATIVE COLUMN CAPITALS TO REMAIN EXPOSED CLEAN AND REPAIR AS REQUIRED.
- 22) EXISTING DECORATIVE RAILING TO REMAIN CLEAN AND REPAIR AS REQUIRED.
- 23 EXISTING FIRE ESCAPE TO REMAIN SEE ELEVATIONS.
- (24) NOT USED.
- EXISTING ALUMINUM CLAD WOOD WINDOWS TO REMAIN CLEAN AND REPAIR AS REQUIRED.
- NEW WALL LOUVER FOR MECHANICAL ROOM LOCATIONS SEE ELEVATIONS.
- (27) NEW INTERIOR STAIR TO FIFTH FLOOR ROOF.
- NEW CMU PARAPET WALL ROOF PATIO ENCLOSURE
 SEE BUILDING SECTION.
- 29 CONCRETE PAVER & PEDESTAL DECK SYSTEM ON SHEET WATERPROOFING MEMBRANE OVER TAPERED SHEET WATERPROOFING MEMBRANE OVER TAPERED RIGID INSULATION ON EXISTING CONCRETE ROOF DECK - SEE BUILDING SECTION.
- (30) NEW PLANTER BOX AND PATIO DIVIDER.
- (31) EXISTING ROOF ACCESS SHIP'S LADDER TO REMAIN.
- NEW SHEET WATERPROOFING MEMBRANE ROOFING OVER RIGID INSULATION ON EXISTING WOOD-FRAMED ATTIC DECK.
- (33) ROOF ACCESS STAIR.
- (34) EXISTING FLAGPOLE TO REMAIN.
- (35) NEW ATTIC ACCESS DOOR.
- (36) NEW SHEET METAL PARAPET COPING.
- (37) 48" DECORATIVE METAL/GLASS GUARD RAIL.
- (38) NEW CHILLERS ON EXISTING STEEL STRUCTURE. (39) EXISTING HARP LIGHT AND POST TO REMAIN.
- (40) INSTALL SALVAGED HARP LIGHT AND POST.
- (41) NEW CURVED GLASS GLAZING.
- (42) NEW PREFINISHED METAL PANEL SIDING OVER EXISTING PARGED MASONRY

- **GENERAL NOTES**
 - 1. ALL PARTITIONS TO BE TYPE 1 UNLESS NOTED OTHERWISE. ALL WALLS TO BE CONSTRUCTED ON COLUMN
 - CENTERLINES UNLESS OTHERWISE NOTED. 2. DO NOT SCALE DRAWINGS. USE WRITTEN DIMENSIONS ONLY. IF CLARIFICATION OR ADDITIONAL DIMENSIONS ARE REQUIRED THE CONTRACTOR SHOULD VERIFY WITH QUORUM

ARCHITECTS.

3. GENERAL CONTRACTOR SHALL VERIFY ALL CONDITIONS AND DIMENSIONS AT THE JOB SITE AND REPORT ANY DISCREPANCIES AND/OR UNUSUAL CONDITIONS TO QUORUM ARCHITECTS PRIOR TO COMMENCEMENT OF ANY CONSTRUCTION. NO ALLOWANCES WILL BE MADE DUE TO THE CONTRACTORS UNFAMILIARITY WITH THE JOB SITE

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- 4. PARTITIONS ARE DIMENSIONED FROM FINISH FACE TO FINISH FACE, UNLESS OTHERWISE NOTED. MAINTAIN DIMENSIONS MARKED "CLEAR" OR "HOLD". ALLOW FOR
- THICKNESS OF FINISHES.
- 5. COORDINATE AND PROVIDE BACKING FOR MILLWORK AND ITEMS ATTACHED OR MOUNTED TO WALLS OR CEILINGS. 6. CONTRACTORS SHALL SUBMIT (4) SETS OF SHOP

DRAWINGS, SAMPLES, INTERIOR AND EXTERIOR FINISHES,

RELEVANT TECHNICAL DATA AND APPLICABLE CUT SHEETS TO THE ARCHITECTS FOR REVIEW PRIOR TO THE


7. VOICE AND DATA CABLING BY TENANT.

COMMENCEMENT OF WORK.

- 8. FURNITURE IS SHOWN FOR REFERENCE ONLY.
- 9. ALL NEWLY CONSTRUCTED ROOMS OR OFFICES SHALL INCLUDE PROVISIONS FOR ADEQUATE POWER AND VOICE/DATA OUTLETS.
- 10. THE GENERAL CONTRACTOR AND ALL SUB-CONTRACTORS SHALL OBTAIN A COPY OF ANY CITY, STATE OR FEDERAL CODES OR REGULATIONS WHICH HAVE JURISDICTION OVER THIS WORK AND AS CALLED OUT IN THESE PLANS. NO ALLOWANCES WILL BE MADE DUE TO THE CONTRACTOR'S UNFAMILIARITY WITH THESE REGULATIONS AND CODES.
- 11. ALL WORK SHALL COMPLY WITH APPLICABLE LOCAL, STATE AND FEDERAL CODES, LAWS, ORDINANCES, RULES AND REGULATIONS OF PUBLIC AUTHORITIES GOVERNING THE
- 12. ALL CONTRACTORS SHALL SECURE AND PAY FOR ALL REQUIRED APPROVALS, PERMITS, FEES AND LICENSES AS IT APPLIES TO HIS/HER DISCIPLINE PRIOR TO ANY EXECUTION OF WORK.
- 13. THE DESIGN OF THE HEATING/VENTILATION & AIR CONDITIONING, AS WELL AS ANY DRAWINGS OR SUBMITTALS REQUIRED FOR DESIGN AND INSTALLATION OF THE HVAC SYSTEM, IS THE RESPONSIBILITY OF THE HVAC CONTRACTOR. ALL COORDINATION OF THIS WORK IS THE RESPONSIBILITY OF THE GENERAL CONTRACTOR.
- 14. THE DESIGN OF ALL ELECTRICAL WORK, AS WELL AS ANY DRAWINGS OR SUBMITTALS REQUIRED FOR DESIGN AND INSTALLATION OF THE ELECTRICAL / LIGHTING WORK, IS THE RESPONSIBILITY OF THE ELECTRICAL CONTRACTOR. ALL COORDINATION OF THIS WORK IS THE RESPONSIBILITY OF THE GENERAL CONTRACTOR.
- 15. THE DESIGN OF ALL PLUMBING WORK, AS WELL AS ANY DRAWINGS OR SUBMITTALS REQUIRED FOR DESIGN AND INSTALLATION OF THE PLUMBING, IS THE RESPONSIBILITY OF THE PLUMBING CONTRACTOR. ALL COORDINATION OF THIS WORK IS THE RESPONSIBILITY OF THE GENERAL CONTRACTOR.
- 16. THE DESIGN OF ALL FIRE PROTECTION WORK, AS WELL AS ANY DRAWINGS OR SUBMITTALS REQUIRED FOR DESIGN AND INSTALLATION OF THE FIRE PROTECTION SYSTEM, IS THE RESPONSIBILITY OF THE FIRE PROTECTION CONTRACTOR. ALL COORDINATION OF THIS WORK IS THE RESPONSIBILITY OF THE GENERAL CONTRACTOR.
- 17. ALL WORK IS TO BE COMPLETED USING ACCEPTABLE CONSTRUCTION PRACTICES AND QUALITY MATERIALS. IF QUESTIONS ARISE AS TO THE SPECIFIC MATERIALS TO BE USED, THE CONTRACTOR MAY PRESENT SUBSTITUTIONS TO THE OWNER AND ARCHITECT FOR THEIR REVIEW AND APPROVAL. ANY SUBSTITUTIONS MUST BE APPROVED BY THE OWNER AND ARCHITECT.
- 18. WORK INVOLVING SHUTDOWN ON ANY PRESENTLY OPERATING SERVICES SHALL BE DONE AT SUCH A TIME THAT WILL MINIMIZE ANY INCONVENIENCE TO THE OWNER AND TENANTS. THIS CONTRACTOR WILL BE REQUIRED TO DO SUCH WORK AS DIRECTED BY AND VERIFIED WITH
- 19. EACH CONTRACTOR IS RESPONSIBLE FOR PATCHING AND REPAIRING ANY CONSTRUCTION OR DAMAGE THAT RESULTS FROM THEIR CONTRACTED PORTION OR TRADE. PROVIDE A "LIKE NEW FINISH" AS REQUIRED.
- 20. EACH CONTRACTOR SHALL PROVIDE ADEQUATE, NECESSARY AND REQUIRED BARRICADES, FENCES AND SAFETY PRECAUTIONS FOR THE GENERAL PUBLIC'S SAFETY NEAR THE SITE. GENERAL CONTRACTOR SHALL PROVIDE ANY AND ALL TEMPORARY BARRICADES AND DUST BARRIERS AS REQUESTED BY THE OWNER.
- 21. FIRE EXTINGUISHERS ARE TO BE PROVIDED AND LOCATED BY GENERAL CONTRACTOR AS REQUIRED BY CODE.

LEGEND

EXISTING WALLS TO REMAIN NEW PARTIAL HEIGHT WALL

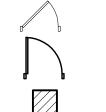

EXISTING DOORS TO REMAIN NEW DOORS

FURNITURE BY TENANT SHOWN FOR REFERENCE ONLY Revisions:

Sheet Name: BASEMENT CONSTRUCTION

01/12/2016 Drawn By: CLR/EJL Project No.: 10031.04

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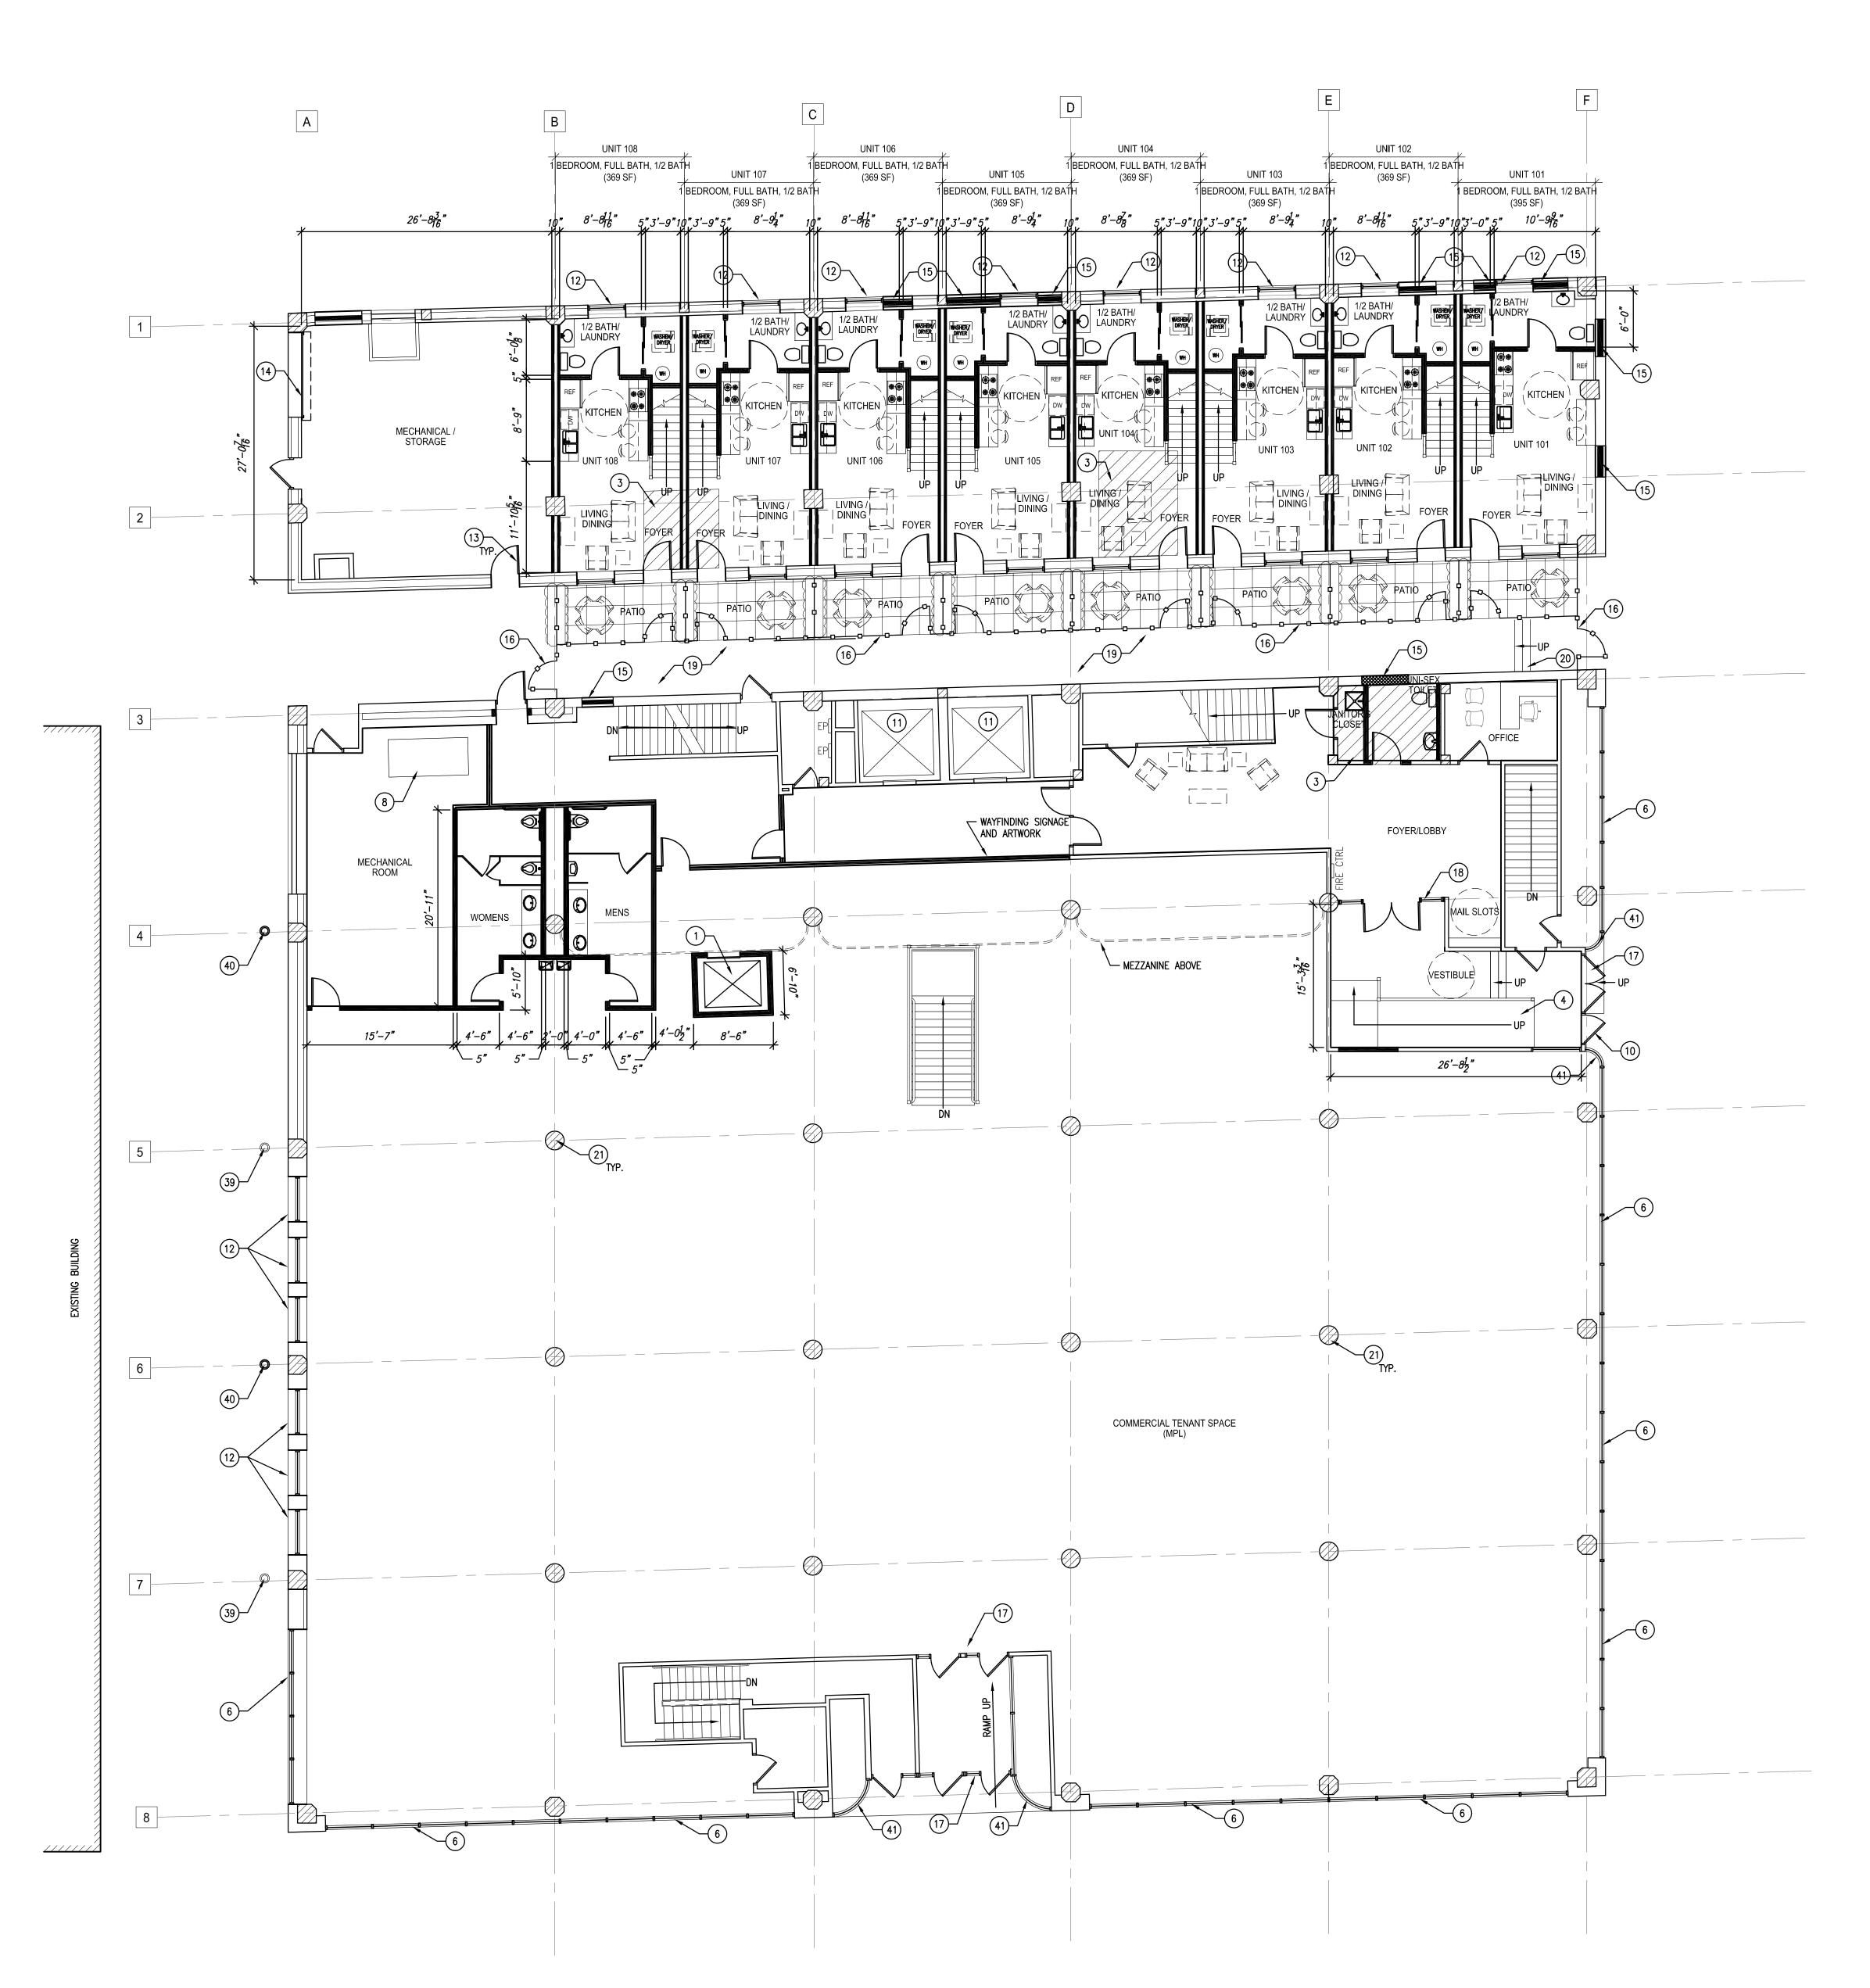
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1) FIRST FLOOR CONSTRUCTION PLAN

SCALE: 1/8" = 1'-0"

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CONSTRUCTION NOTES

- NEW PASSENGER ELEVATOR THREE-STOP: BASEMENT, FIRST FLOOR, MEZZANINE.
- (2) PATCH FLOOR AT LOCATION OF REMOVED STAIR.
- 3 INFILL FLOOR OPENING AT REMOVED STAIR/AIR-SHAFT/ELEVATOR TO MATCH EXISTING
- FLOOR STRUCTURE.
- (4) NEW CONCRETE RAMP.
- (5) REINSTALL SALVAGED HISTORIC RAILING.
- 6 NEW ALUMINUM STOREFRONT TO MATCH EXISTING, WITH INSULATED GLAZING SEE ELEVATIONS.
- (7) NEW BOILERS TO REPLACE EXISTING IN KIND.
- 8 NEW AIR HANDLING UNIT TO REPLACE EXISTING IN KIND.
- 9 NEW ELEVATOR SHAFT OVERRUN PER NEW PASSENGER ELEVATOR SPECIFICATIONS.
- PROVIDE NEW PUSH BUTTON AUTOMATIC DOOR OPERATOR AT EXISTING DOOR.
- 11) EXISTING PASSENGER ELEVATOR:
 RECONFIGURE CONTROLS TO LOCK-OUT MEZZANINE LEVEL. EXTEND TRAVEL OF WEST ELEVATOR ONLY TO
- (12) NEW ALUMINUM WINDOW SEE ELEVATIONS
- (13) NEW ENTRY DOOR SEE ELEVATIONS

SIXTH FLOOR ROOF LEVEL.

- (14) NEW OVERHEAD COILING DOOR SEE ELEVATIONS
- (15) MASONRY INFILL AT EXISTING OPENING
- (16) DECORATIVE METAL FENCE SEE ELEVATIONS.
- (17) EXISTING ENTRANCE SYSTEM TO REMAIN.
- (18) NEW ALUMINUM/GLASS ENTRY SYSTEM 19 NEW CONCRETE PLAZA DECK OVER WATERPROOFING MEMBRANE ON EXISTING STRUCTURAL DECK.
- (20) NEW CONCRETE STAIR TO NEW PLAZA DECK LEVEL.
- EXISTING DECORATIVE COLUMN CAPITALS TO REMAIN EXPOSED CLEAN AND REPAIR AS REQUIRED.
- 22) EXISTING DECORATIVE RAILING TO REMAIN CLEAN AND REPAIR AS REQUIRED.
- 23 EXISTING FIRE ESCAPE TO REMAIN SEE ELEVATIONS.
- (24) NOT USED.
- EXISTING ALUMINUM CLAD WOOD WINDOWS TO REMAIN CLEAN AND REPAIR AS REQUIRED.
- NEW WALL LOUVER FOR MECHANICAL ROOM LOCATIONS SEE ELEVATIONS.
- (27) NEW INTERIOR STAIR TO FIFTH FLOOR ROOF.
- NEW CMU PARAPET WALL ROOF PATIO ENCLOSURE
 SEE BUILDING SECTION.
- CONCRETE PAVER & PEDESTAL DECK SYSTEM ON SHEET WATERPROOFING MEMBRANE OVER TAPERED SHEET WATERPROOFING MEMBRANE OVER TAPERED RIGID INSULATION ON EXISTING CONCRETE ROOF DECK - SEE BUILDING SECTION.
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- (35) NEW ATTIC ACCESS DOOR.
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- (37) 48" DECORATIVE METAL/GLASS GUARD RAIL. (38) NEW CHILLERS ON EXISTING STEEL STRUCTURE.
- (39) EXISTING HARP LIGHT AND POST TO REMAIN.
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- (41) NEW CURVED GLASS GLAZING.
- (42) NEW PREFINISHED METAL PANEL SIDING OVER EXISTING PARGED MASONRY


GENERAL NOTES

ARCHITECTS.

- 1. ALL PARTITIONS TO BE TYPE 1 UNLESS NOTED OTHERWISE. ALL WALLS TO BE CONSTRUCTED ON COLUMN CENTERLINES UNLESS OTHERWISE NOTED.
- 2. DO NOT SCALE DRAWINGS. USE WRITTEN DIMENSIONS ONLY. IF CLARIFICATION OR ADDITIONAL DIMENSIONS ARE REQUIRED THE CONTRACTOR SHOULD VERIFY WITH QUORUM
- 3. GENERAL CONTRACTOR SHALL VERIFY ALL CONDITIONS AND DIMENSIONS AT THE JOB SITE AND REPORT ANY DISCREPANCIES AND/OR UNUSUAL CONDITIONS TO QUORUM ARCHITECTS PRIOR TO COMMENCEMENT OF ANY CONSTRUCTION. NO ALLOWANCES WILL BE MADE DUE TO THE CONTRACTORS UNFAMILIARITY WITH THE JOB SITE
- 4. PARTITIONS ARE DIMENSIONED FROM FINISH FACE TO FINISH FACE, UNLESS OTHERWISE NOTED. MAINTAIN DIMENSIONS MARKED "CLEAR" OR "HOLD". ALLOW FOR
- THICKNESS OF FINISHES. 5. COORDINATE AND PROVIDE BACKING FOR MILLWORK AND
- ITEMS ATTACHED OR MOUNTED TO WALLS OR CEILINGS.
- 6. CONTRACTORS SHALL SUBMIT (4) SETS OF SHOP DRAWINGS, SAMPLES, INTERIOR AND EXTERIOR FINISHES, RELEVANT TECHNICAL DATA AND APPLICABLE CUT SHEETS TO THE ARCHITECTS FOR REVIEW PRIOR TO THE COMMENCEMENT OF WORK.
- 7. VOICE AND DATA CABLING BY TENANT.
- 8. FURNITURE IS SHOWN FOR REFERENCE ONLY.
- 9. ALL NEWLY CONSTRUCTED ROOMS OR OFFICES SHALL INCLUDE PROVISIONS FOR ADEQUATE POWER AND VOICE/DATA OUTLETS.
- 10. THE GENERAL CONTRACTOR AND ALL SUB-CONTRACTORS SHALL OBTAIN A COPY OF ANY CITY, STATE OR FEDERAL CODES OR REGULATIONS WHICH HAVE JURISDICTION OVER THIS WORK AND AS CALLED OUT IN THESE PLANS. NO ALLOWANCES WILL BE MADE DUE TO THE CONTRACTOR'S UNFAMILIARITY WITH THESE REGULATIONS AND CODES.
- 11. ALL WORK SHALL COMPLY WITH APPLICABLE LOCAL, STATE AND FEDERAL CODES, LAWS, ORDINANCES, RULES AND REGULATIONS OF PUBLIC AUTHORITIES GOVERNING THE
- 12. ALL CONTRACTORS SHALL SECURE AND PAY FOR ALL REQUIRED APPROVALS, PERMITS, FEES AND LICENSES AS IT APPLIES TO HIS/HER DISCIPLINE PRIOR TO ANY EXECUTION OF WORK.
- 13. THE DESIGN OF THE HEATING/VENTILATION & AIR CONDITIONING, AS WELL AS ANY DRAWINGS OR SUBMITTALS REQUIRED FOR DESIGN AND INSTALLATION OF THE HVAC SYSTEM, IS THE RESPONSIBILITY OF THE HVAC CONTRACTOR. ALL COORDINATION OF THIS WORK IS THE RESPONSIBILITY OF THE GENERAL CONTRACTOR.
- 14. THE DESIGN OF ALL ELECTRICAL WORK, AS WELL AS ANY DRAWINGS OR SUBMITTALS REQUIRED FOR DESIGN AND INSTALLATION OF THE ELECTRICAL / LIGHTING WORK, IS THE RESPONSIBILITY OF THE ELECTRICAL CONTRACTOR. ALL COORDINATION OF THIS WORK IS THE RESPONSIBILITY OF THE GENERAL CONTRACTOR.
- 15. THE DESIGN OF ALL PLUMBING WORK, AS WELL AS ANY DRAWINGS OR SUBMITTALS REQUIRED FOR DESIGN AND INSTALLATION OF THE PLUMBING, IS THE RESPONSIBILITY OF THE PLUMBING CONTRACTOR. ALL COORDINATION OF THIS WORK IS THE RESPONSIBILITY OF THE GENERAL CONTRACTOR.
- 16. THE DESIGN OF ALL FIRE PROTECTION WORK, AS WELL AS ANY DRAWINGS OR SUBMITTALS REQUIRED FOR DESIGN AND INSTALLATION OF THE FIRE PROTECTION SYSTEM, IS THE RESPONSIBILITY OF THE FIRE PROTECTION CONTRACTOR. ALL COORDINATION OF THIS WORK IS THE RESPONSIBILITY OF THE GENERAL CONTRACTOR.
- 17. ALL WORK IS TO BE COMPLETED USING ACCEPTABLE CONSTRUCTION PRACTICES AND QUALITY MATERIALS. IF QUESTIONS ARISE AS TO THE SPECIFIC MATERIALS TO BE USED, THE CONTRACTOR MAY PRESENT SUBSTITUTIONS TO THE OWNER AND ARCHITECT FOR THEIR REVIEW AND APPROVAL. ANY SUBSTITUTIONS MUST BE APPROVED BY THE OWNER AND ARCHITECT.
- 18. WORK INVOLVING SHUTDOWN ON ANY PRESENTLY OPERATING SERVICES SHALL BE DONE AT SUCH A TIME THAT WILL MINIMIZE ANY INCONVENIENCE TO THE OWNER AND TENANTS. THIS CONTRACTOR WILL BE REQUIRED TO DO SUCH WORK AS DIRECTED BY AND VERIFIED WITH
- 19. EACH CONTRACTOR IS RESPONSIBLE FOR PATCHING AND REPAIRING ANY CONSTRUCTION OR DAMAGE THAT RESULTS FROM THEIR CONTRACTED PORTION OR TRADE. PROVIDE A "LIKE NEW FINISH" AS REQUIRED.
- 20. EACH CONTRACTOR SHALL PROVIDE ADEQUATE, NECESSARY AND REQUIRED BARRICADES, FENCES AND SAFETY PRECAUTIONS FOR THE GENERAL PUBLIC'S SAFETY NEAR THE SITE. GENERAL CONTRACTOR SHALL PROVIDE ANY AND ALL TEMPORARY BARRICADES AND DUST BARRIERS AS REQUESTED BY THE OWNER.
- 21. FIRE EXTINGUISHERS ARE TO BE PROVIDED AND LOCATED BY GENERAL CONTRACTOR AS REQUIRED BY CODE.

LEGEND

EXISTING WALLS TO REMAIN

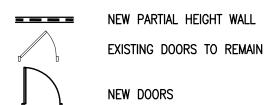

NEW DOORS

FURNITURE BY TENANT SHOWN FOR REFERENCE ONLY

> Sheet Name: FIRST FLOOR CONSTRUCTION PLAN

Revisions:

01/12/2016 Drawn By: CLR/EJL Project No.: 10031.04

Sheet No.



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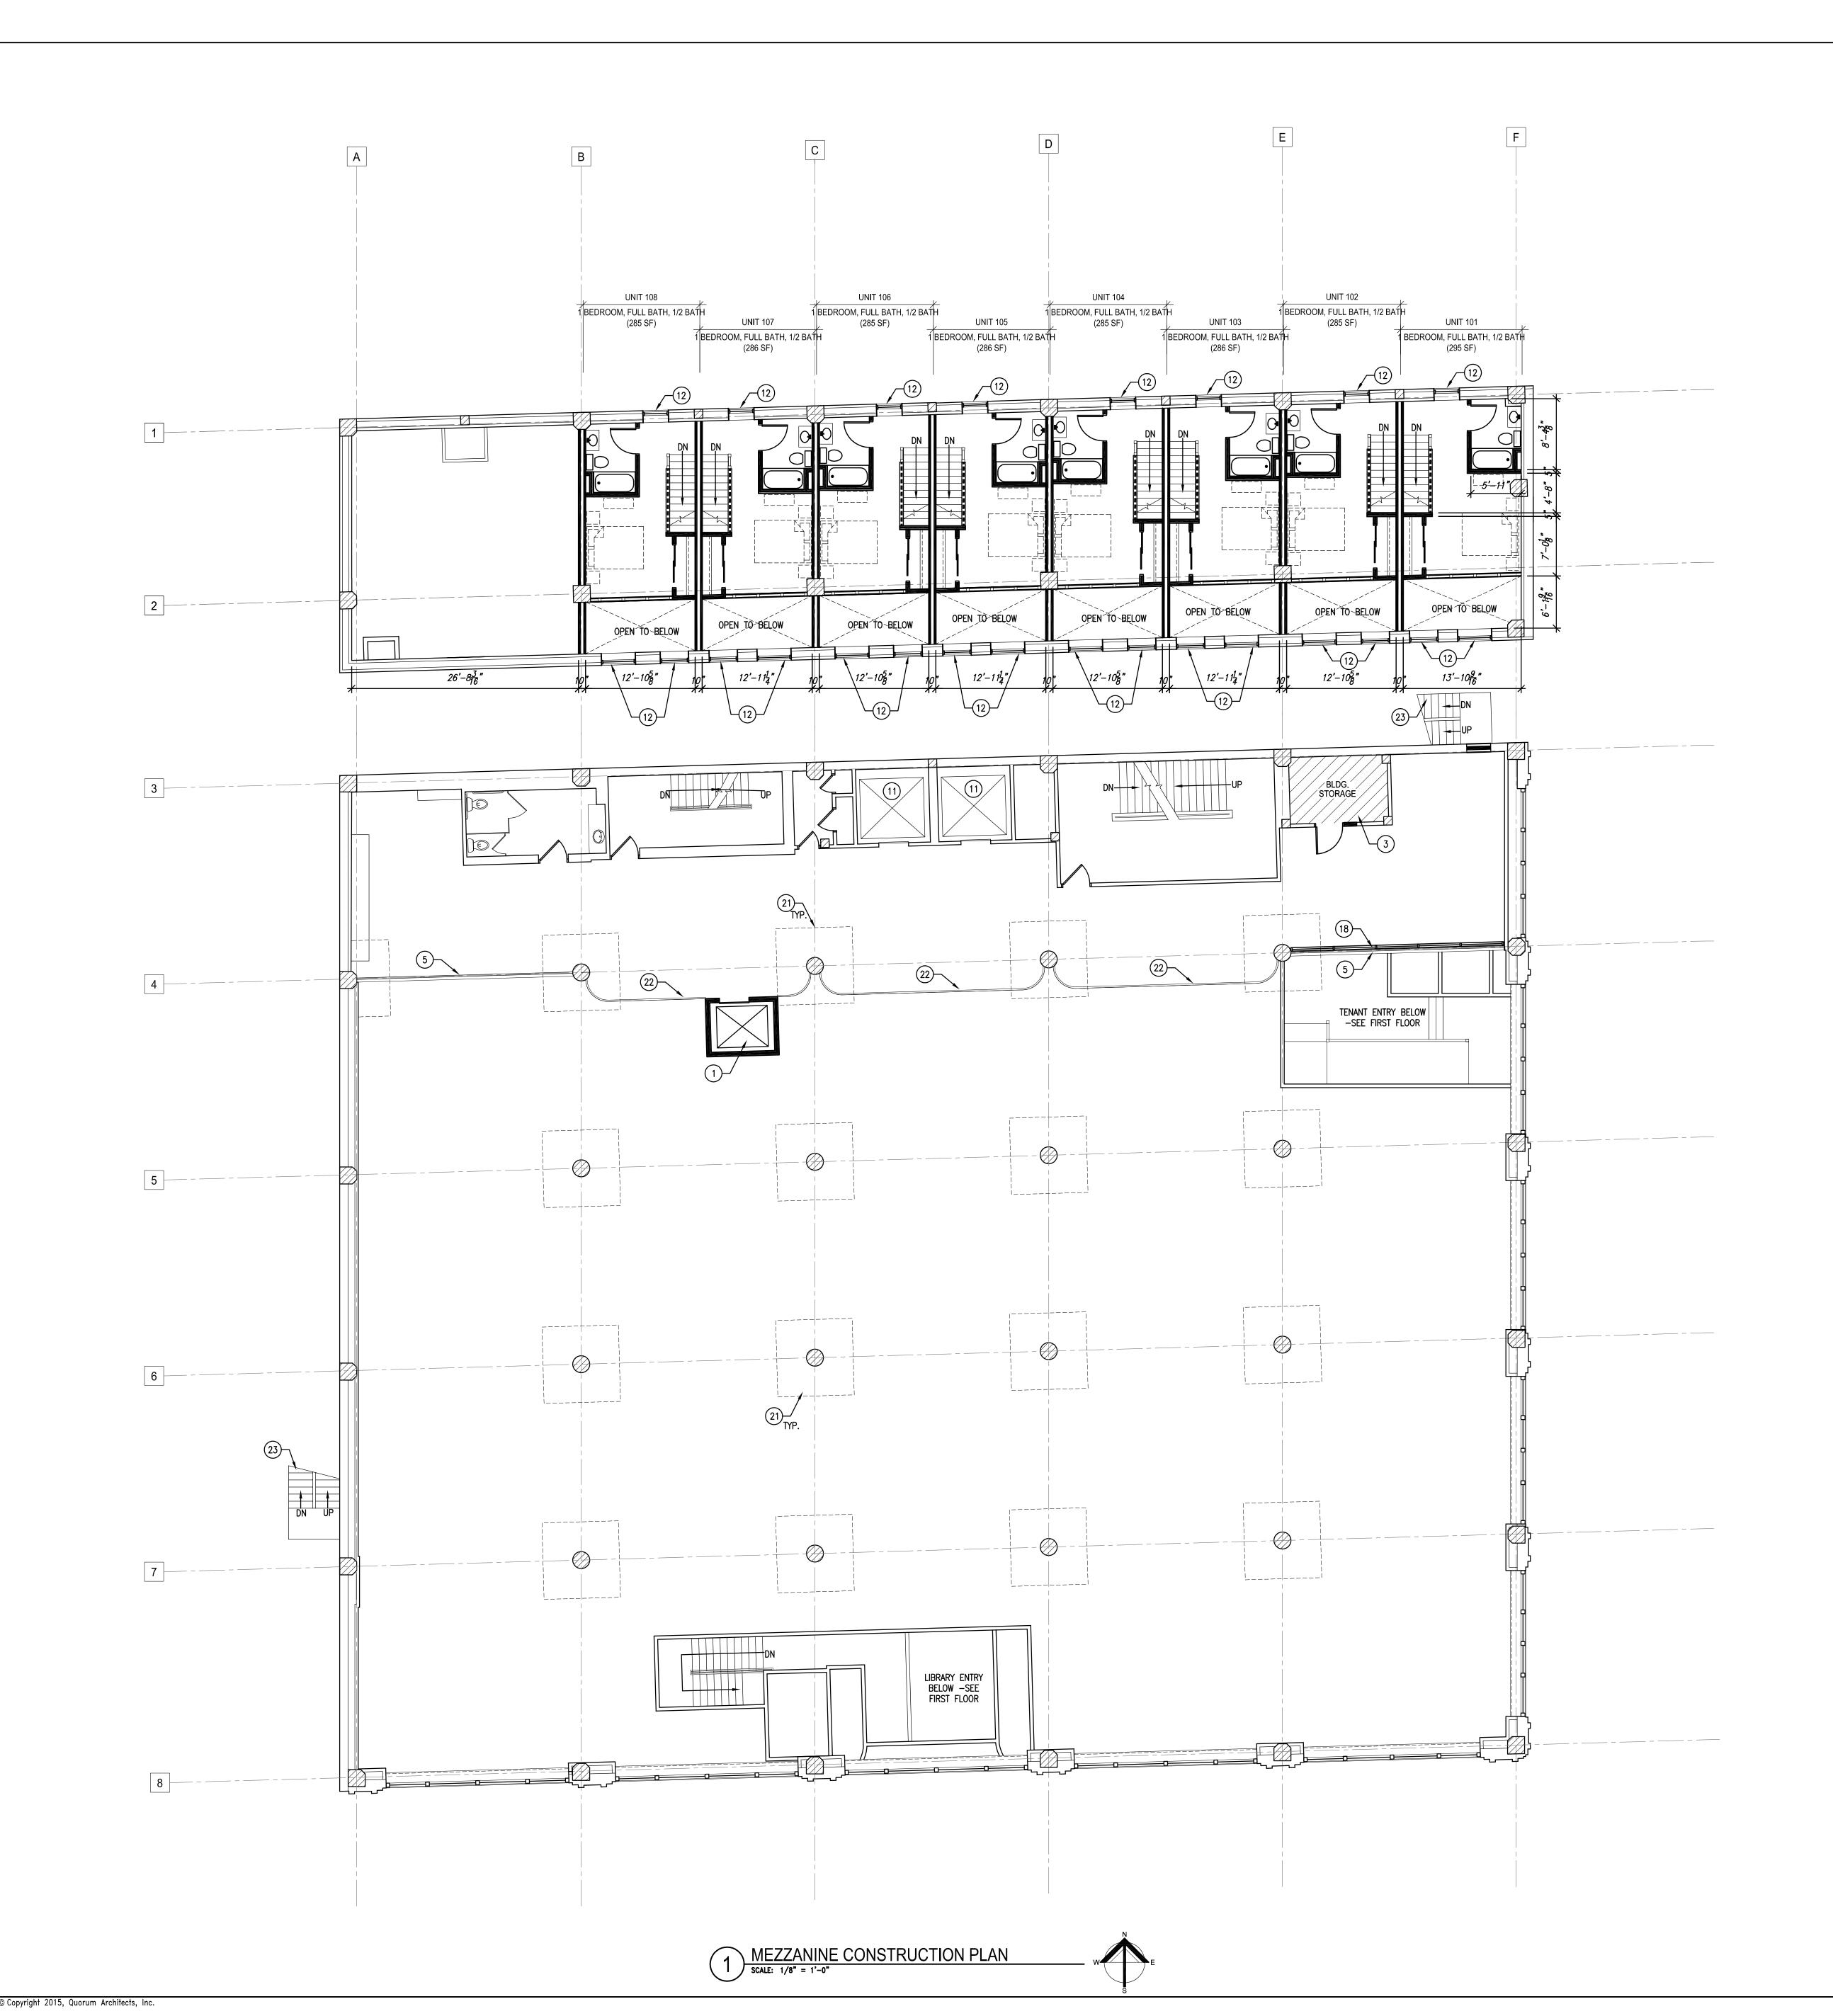
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CONSTRUCTION

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CONSTRUCTION NOTES

- NEW PASSENGER ELEVATOR THREE-STOP: BASEMENT, FIRST FLOOR, MEZZANINE.
- (2) PATCH FLOOR AT LOCATION OF REMOVED STAIR.
- 3 INFILL FLOOR OPENING AT REMOVED STAIR/AIR-SHAFT/ELEVATOR TO MATCH EXISTING FLOOR STRUCTURE.
- (4) NEW CONCRETE RAMP.
- (5) REINSTALL SALVAGED HISTORIC RAILING.
- 6 NEW ALUMINUM STOREFRONT TO MATCH EXISTING, WITH INSULATED GLAZING SEE ELEVATIONS.
- (7) NEW BOILERS TO REPLACE EXISTING IN KIND.
- 8 NEW AIR HANDLING UNIT TO REPLACE EXISTING IN KIND.
- 9 NEW ELEVATOR SHAFT OVERRUN PER NEW PASSENGER ELEVATOR SPECIFICATIONS.
- PROVIDE NEW PUSH BUTTON AUTOMATIC DOOR OPERATOR AT EXISTING DOOR.
- 11) EXISTING PASSENGER ELEVATOR:
 RECONFIGURE CONTROLS TO LOCK-OUT MEZZANINE LEVEL. EXTEND TRAVEL OF WEST ELEVATOR ONLY TO
- (12) NEW ALUMINUM WINDOW SEE ELEVATIONS

SIXTH FLOOR ROOF LEVEL.

- (13) NEW ENTRY DOOR SEE ELEVATIONS
- (14) NEW OVERHEAD COILING DOOR SEE ELEVATIONS
- (15) MASONRY INFILL AT EXISTING OPENING
- (16) DECORATIVE METAL FENCE SEE ELEVATIONS.
- (17) EXISTING ENTRANCE SYSTEM TO REMAIN.
- (18) NEW ALUMINUM/GLASS ENTRY SYSTEM
- 19 NEW CONCRETE PLAZA DECK OVER WATERPROOFING MEMBRANE ON EXISTING STRUCTURAL DECK.
- (20) NEW CONCRETE STAIR TO NEW PLAZA DECK LEVEL.
- EXISTING DECORATIVE COLUMN CAPITALS TO REMAIN EXPOSED CLEAN AND REPAIR AS REQUIRED.
- 22) EXISTING DECORATIVE RAILING TO REMAIN CLEAN AND REPAIR AS REQUIRED.
- 23 EXISTING FIRE ESCAPE TO REMAIN SEE ELEVATIONS.
- (24) NOT USED.
- EXISTING ALUMINUM CLAD WOOD WINDOWS TO REMAIN CLEAN AND REPAIR AS REQUIRED.
- NEW WALL LOUVER FOR MECHANICAL ROOM LOCATIONS SEE ELEVATIONS.
- (27) NEW INTERIOR STAIR TO FIFTH FLOOR ROOF.
- NEW CMU PARAPET WALL ROOF PATIO ENCLOSURE
 SEE BUILDING SECTION.
- CONCRETE PAVER & PEDESTAL DECK SYSTEM ON SHEET WATERPROOFING MEMBRANE OVER TAPERED SHEET WATERPROOFING MEMBRANE OVER TAPERED RIGID INSULATION ON EXISTING CONCRETE ROOF DECK - SEE BUILDING SECTION.
- (30) NEW PLANTER BOX AND PATIO DIVIDER.
- (31) EXISTING ROOF ACCESS SHIP'S LADDER TO REMAIN.
- NEW SHEET WATERPROOFING MEMBRANE ROOFING OVER RIGID INSULATION ON EXISTING WOOD-FRAMED ATTIC DECK.
- (33) ROOF ACCESS STAIR.
- (34) EXISTING FLAGPOLE TO REMAIN.
- (35) NEW ATTIC ACCESS DOOR.
- (36) NEW SHEET METAL PARAPET COPING.
- (37) 48" DECORATIVE METAL/GLASS GUARD RAIL.
- (38) NEW CHILLERS ON EXISTING STEEL STRUCTURE. (39) EXISTING HARP LIGHT AND POST TO REMAIN.
- (40) INSTALL SALVAGED HARP LIGHT AND POST.
- (41) NEW CURVED GLASS GLAZING.
- (42) NEW PREFINISHED METAL PANEL SIDING OVER EXISTING PARGED MASONRY

GENERAL NOTES

ARCHITECTS.

- 1. ALL PARTITIONS TO BE TYPE 1 UNLESS NOTED OTHERWISE. ALL WALLS TO BE CONSTRUCTED ON COLUMN CENTERLINES UNLESS OTHERWISE NOTED.
- 2. DO NOT SCALE DRAWINGS. USE WRITTEN DIMENSIONS ONLY. IF CLARIFICATION OR ADDITIONAL DIMENSIONS ARE REQUIRED THE CONTRACTOR SHOULD VERIFY WITH QUORUM
- 3. GENERAL CONTRACTOR SHALL VERIFY ALL CONDITIONS AND DIMENSIONS AT THE JOB SITE AND REPORT ANY DISCREPANCIES AND/OR UNUSUAL CONDITIONS TO QUORUM ARCHITECTS PRIOR TO COMMENCEMENT OF ANY CONSTRUCTION. NO ALLOWANCES WILL BE MADE DUE TO THE CONTRACTORS UNFAMILIARITY WITH THE JOB SITE
- 4. PARTITIONS ARE DIMENSIONED FROM FINISH FACE TO FINISH FACE, UNLESS OTHERWISE NOTED. MAINTAIN DIMENSIONS MARKED "CLEAR" OR "HOLD". ALLOW FOR
- THICKNESS OF FINISHES. 5. COORDINATE AND PROVIDE BACKING FOR MILLWORK AND

RELEVANT TECHNICAL DATA AND APPLICABLE CUT SHEETS TO THE ARCHITECTS FOR REVIEW PRIOR TO THE


- ITEMS ATTACHED OR MOUNTED TO WALLS OR CEILINGS. 6. CONTRACTORS SHALL SUBMIT (4) SETS OF SHOP DRAWINGS, SAMPLES, INTERIOR AND EXTERIOR FINISHES,
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- 9. ALL NEWLY CONSTRUCTED ROOMS OR OFFICES SHALL INCLUDE PROVISIONS FOR ADEQUATE POWER AND VOICE/DATA OUTLETS.
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- 11. ALL WORK SHALL COMPLY WITH APPLICABLE LOCAL, STATE AND FEDERAL CODES, LAWS, ORDINANCES, RULES AND REGULATIONS OF PUBLIC AUTHORITIES GOVERNING THE
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- 13. THE DESIGN OF THE HEATING/VENTILATION & AIR CONDITIONING, AS WELL AS ANY DRAWINGS OR SUBMITTALS REQUIRED FOR DESIGN AND INSTALLATION OF THE HVAC SYSTEM, IS THE RESPONSIBILITY OF THE HVAC CONTRACTOR. ALL COORDINATION OF THIS WORK IS THE RESPONSIBILITY OF THE GENERAL CONTRACTOR.
- 14. THE DESIGN OF ALL ELECTRICAL WORK, AS WELL AS ANY DRAWINGS OR SUBMITTALS REQUIRED FOR DESIGN AND INSTALLATION OF THE ELECTRICAL / LIGHTING WORK, IS THE RESPONSIBILITY OF THE ELECTRICAL CONTRACTOR. ALL COORDINATION OF THIS WORK IS THE RESPONSIBILITY OF THE GENERAL CONTRACTOR.
- 15. THE DESIGN OF ALL PLUMBING WORK, AS WELL AS ANY DRAWINGS OR SUBMITTALS REQUIRED FOR DESIGN AND INSTALLATION OF THE PLUMBING, IS THE RESPONSIBILITY OF THE PLUMBING CONTRACTOR. ALL COORDINATION OF THIS WORK IS THE RESPONSIBILITY OF THE GENERAL CONTRACTOR.
- ANY DRAWINGS OR SUBMITTALS REQUIRED FOR DESIGN AND INSTALLATION OF THE FIRE PROTECTION SYSTEM, IS THE RESPONSIBILITY OF THE FIRE PROTECTION CONTRACTOR. ALL COORDINATION OF THIS WORK IS THE RESPONSIBILITY OF THE GENERAL CONTRACTOR.

16. THE DESIGN OF ALL FIRE PROTECTION WORK, AS WELL AS

- 17. ALL WORK IS TO BE COMPLETED USING ACCEPTABLE CONSTRUCTION PRACTICES AND QUALITY MATERIALS. IF QUESTIONS ARISE AS TO THE SPECIFIC MATERIALS TO BE USED, THE CONTRACTOR MAY PRESENT SUBSTITUTIONS TO THE OWNER AND ARCHITECT FOR THEIR REVIEW AND APPROVAL. ANY SUBSTITUTIONS MUST BE APPROVED BY THE OWNER AND ARCHITECT.
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- 21. FIRE EXTINGUISHERS ARE TO BE PROVIDED AND LOCATED BY GENERAL CONTRACTOR AS REQUIRED BY CODE.

LEGEND

EXISTING WALLS TO REMAIN NEW PARTIAL HEIGHT WALL

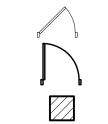

EXISTING DOORS TO REMAIN NEW DOORS

FURNITURE BY TENANT SHOWN FOR REFERENCE ONLY

Revisions:

Sheet Name: MEZZANINE CONSTRUCTION

01/12/2016 Drawn By: CLR/EJL Project No.: 10031.04

SECOND FLOOR CONSTRUCTION PLAN

SCALE: 1/8" = 1'-0"

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CONSTRUCTION NOTES

- NEW PASSENGER ELEVATOR THREE-STOP: BASEMENT, FIRST FLOOR, MEZZANINE.
- (2) PATCH FLOOR AT LOCATION OF REMOVED STAIR.
- 3 INFILL FLOOR OPENING AT REMOVED STAIR/AIR-SHAFT/ELEVATOR TO MATCH EXISTING FLOOR STRUCTURE.
- (4) NEW CONCRETE RAMP.
- (5) REINSTALL SALVAGED HISTORIC RAILING.
- 6 NEW ALUMINUM STOREFRONT TO MATCH EXISTING, WITH INSULATED GLAZING SEE ELEVATIONS.
- (7) NEW BOILERS TO REPLACE EXISTING IN KIND.
- 8 NEW AIR HANDLING UNIT TO REPLACE EXISTING IN KIND.
- 9 NEW ELEVATOR SHAFT OVERRUN PER NEW PASSENGER ELEVATOR SPECIFICATIONS.
- PROVIDE NEW PUSH BUTTON AUTOMATIC DOOR OPERATOR AT EXISTING DOOR.
- EXISTING PASSENGER ELEVATOR:
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- (12) NEW ALUMINUM WINDOW SEE ELEVATIONS
- (13) NEW ENTRY DOOR SEE ELEVATIONS
- (14) NEW OVERHEAD COILING DOOR SEE ELEVATIONS
- (15) MASONRY INFILL AT EXISTING OPENING
- (16) DECORATIVE METAL FENCE SEE ELEVATIONS.
- (17) EXISTING ENTRANCE SYSTEM TO REMAIN.
- (18) NEW ALUMINUM/GLASS ENTRY SYSTEM
- (20) NEW CONCRETE STAIR TO NEW PLAZA DECK LEVEL.
- EXISTING DECORATIVE COLUMN CAPITALS TO REMAIN EXPOSED CLEAN AND REPAIR AS REQUIRED.

19 NEW CONCRETE PLAZA DECK OVER WATERPROOFING MEMBRANE ON EXISTING STRUCTURAL DECK.

- 22) EXISTING DECORATIVE RAILING TO REMAIN CLEAN AND REPAIR AS REQUIRED.
- 23 EXISTING FIRE ESCAPE TO REMAIN SEE ELEVATIONS.
- (24) NOT USED.
- EXISTING ALUMINUM CLAD WOOD WINDOWS TO REMAIN CLEAN AND REPAIR AS REQUIRED.
- NEW WALL LOUVER FOR MECHANICAL ROOM LOCATIONS SEE ELEVATIONS.
- (27) NEW INTERIOR STAIR TO FIFTH FLOOR ROOF.
- NEW CMU PARAPET WALL ROOF PATIO ENCLOSURE
 SEE BUILDING SECTION. CONCRETE PAVER & PEDESTAL DECK SYSTEM ON SHEET WATERPROOFING MEMBRANE OVER TAPERED
- SHEET WATERPROOFING MEMBRANE OVER TAPERED RIGID INSULATION ON EXISTING CONCRETE ROOF DECK - SEE BUILDING SECTION.
- (30) NEW PLANTER BOX AND PATIO DIVIDER.
- (31) EXISTING ROOF ACCESS SHIP'S LADDER TO REMAIN.
- NEW SHEET WATERPROOFING MEMBRANE ROOFING OVER RIGID INSULATION ON EXISTING WOOD-FRAMED ATTIC DECK.
- (33) ROOF ACCESS STAIR.
- (34) EXISTING FLAGPOLE TO REMAIN.
- (35) NEW ATTIC ACCESS DOOR.
- (36) NEW SHEET METAL PARAPET COPING.
- (37) 48" DECORATIVE METAL/GLASS GUARD RAIL.
- (38) NEW CHILLERS ON EXISTING STEEL STRUCTURE. (39) EXISTING HARP LIGHT AND POST TO REMAIN.
- (40) INSTALL SALVAGED HARP LIGHT AND POST.
- (41) NEW CURVED GLASS GLAZING.
- (42) NEW PREFINISHED METAL PANEL SIDING OVER EXISTING PARGED MASONRY

GENERAL NOTES

ARCHITECTS.

- 1. ALL PARTITIONS TO BE TYPE 1 UNLESS NOTED OTHERWISE. ALL WALLS TO BE CONSTRUCTED ON COLUMN CENTERLINES UNLESS OTHERWISE NOTED.
- 2. DO NOT SCALE DRAWINGS. USE WRITTEN DIMENSIONS ONLY. IF CLARIFICATION OR ADDITIONAL DIMENSIONS ARE REQUIRED THE CONTRACTOR SHOULD VERIFY WITH QUORUM
- 3. GENERAL CONTRACTOR SHALL VERIFY ALL CONDITIONS AND DIMENSIONS AT THE JOB SITE AND REPORT ANY DISCREPANCIES AND/OR UNUSUAL CONDITIONS TO QUORUM ARCHITECTS PRIOR TO COMMENCEMENT OF ANY CONSTRUCTION. NO ALLOWANCES WILL BE MADE DUE TO THE CONTRACTORS UNFAMILIARITY WITH THE JOB SITE

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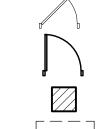
CONSTRUCTION

QUORUM ARCHITECTS, INC.

- 4. PARTITIONS ARE DIMENSIONED FROM FINISH FACE TO FINISH FACE, UNLESS OTHERWISE NOTED. MAINTAIN DIMENSIONS MARKED "CLEAR" OR "HOLD". ALLOW FOR
- THICKNESS OF FINISHES. 5. COORDINATE AND PROVIDE BACKING FOR MILLWORK AND ITEMS ATTACHED OR MOUNTED TO WALLS OR CEILINGS.
- 6. CONTRACTORS SHALL SUBMIT (4) SETS OF SHOP DRAWINGS, SAMPLES, INTERIOR AND EXTERIOR FINISHES, RELEVANT TECHNICAL DATA AND APPLICABLE CUT SHEETS TO THE ARCHITECTS FOR REVIEW PRIOR TO THE COMMENCEMENT OF WORK.
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- 12. ALL CONTRACTORS SHALL SECURE AND PAY FOR ALL REQUIRED APPROVALS, PERMITS, FEES AND LICENSES AS IT APPLIES TO HIS/HER DISCIPLINE PRIOR TO ANY EXECUTION OF WORK.
- 13. THE DESIGN OF THE HEATING/VENTILATION & AIR CONDITIONING, AS WELL AS ANY DRAWINGS OR SUBMITTALS REQUIRED FOR DESIGN AND INSTALLATION OF THE HVAC SYSTEM, IS THE RESPONSIBILITY OF THE HVAC CONTRACTOR. ALL COORDINATION OF THIS WORK IS THE RESPONSIBILITY OF THE GENERAL CONTRACTOR.
- 14. THE DESIGN OF ALL ELECTRICAL WORK, AS WELL AS ANY DRAWINGS OR SUBMITTALS REQUIRED FOR DESIGN AND INSTALLATION OF THE ELECTRICAL / LIGHTING WORK, IS THE RESPONSIBILITY OF THE ELECTRICAL CONTRACTOR. ALL COORDINATION OF THIS WORK IS THE RESPONSIBILITY OF THE GENERAL CONTRACTOR.
- 15. THE DESIGN OF ALL PLUMBING WORK, AS WELL AS ANY DRAWINGS OR SUBMITTALS REQUIRED FOR DESIGN AND INSTALLATION OF THE PLUMBING, IS THE RESPONSIBILITY OF THE PLUMBING CONTRACTOR. ALL COORDINATION OF THIS WORK IS THE RESPONSIBILITY OF THE GENERAL CONTRACTOR.
- 16. THE DESIGN OF ALL FIRE PROTECTION WORK, AS WELL AS ANY DRAWINGS OR SUBMITTALS REQUIRED FOR DESIGN AND INSTALLATION OF THE FIRE PROTECTION SYSTEM, IS THE RESPONSIBILITY OF THE FIRE PROTECTION CONTRACTOR. ALL COORDINATION OF THIS WORK IS THE RESPONSIBILITY OF THE GENERAL CONTRACTOR.
- 17. ALL WORK IS TO BE COMPLETED USING ACCEPTABLE CONSTRUCTION PRACTICES AND QUALITY MATERIALS. IF QUESTIONS ARISE AS TO THE SPECIFIC MATERIALS TO BE USED, THE CONTRACTOR MAY PRESENT SUBSTITUTIONS TO THE OWNER AND ARCHITECT FOR THEIR REVIEW AND APPROVAL. ANY SUBSTITUTIONS MUST BE APPROVED BY THE OWNER AND ARCHITECT.
- 18. WORK INVOLVING SHUTDOWN ON ANY PRESENTLY OPERATING SERVICES SHALL BE DONE AT SUCH A TIME THAT WILL MINIMIZE ANY INCONVENIENCE TO THE OWNER AND TENANTS. THIS CONTRACTOR WILL BE REQUIRED TO DO SUCH WORK AS DIRECTED BY AND VERIFIED WITH
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- 20. EACH CONTRACTOR SHALL PROVIDE ADEQUATE, NECESSARY AND REQUIRED BARRICADES, FENCES AND SAFETY PRECAUTIONS FOR THE GENERAL PUBLIC'S SAFETY NEAR THE SITE. GENERAL CONTRACTOR SHALL PROVIDE ANY AND ALL TEMPORARY BARRICADES AND DUST BARRIERS AS REQUESTED BY THE OWNER.
- 21. FIRE EXTINGUISHERS ARE TO BE PROVIDED AND LOCATED BY GENERAL CONTRACTOR AS REQUIRED BY CODE.

LEGEND

EXISTING WALLS TO REMAIN NEW PARTIAL HEIGHT WALL



NEW DOORS FURNITURE BY TENANT

SHOWN FOR REFERENCE ONLY

EXISTING DOORS TO REMAIN

Revisions:

Sheet Name: SECOND FLOOR CONSTRUCTION PLAN

01/12/2016 Drawn By: CLR/EJL Project No.: 10031.04


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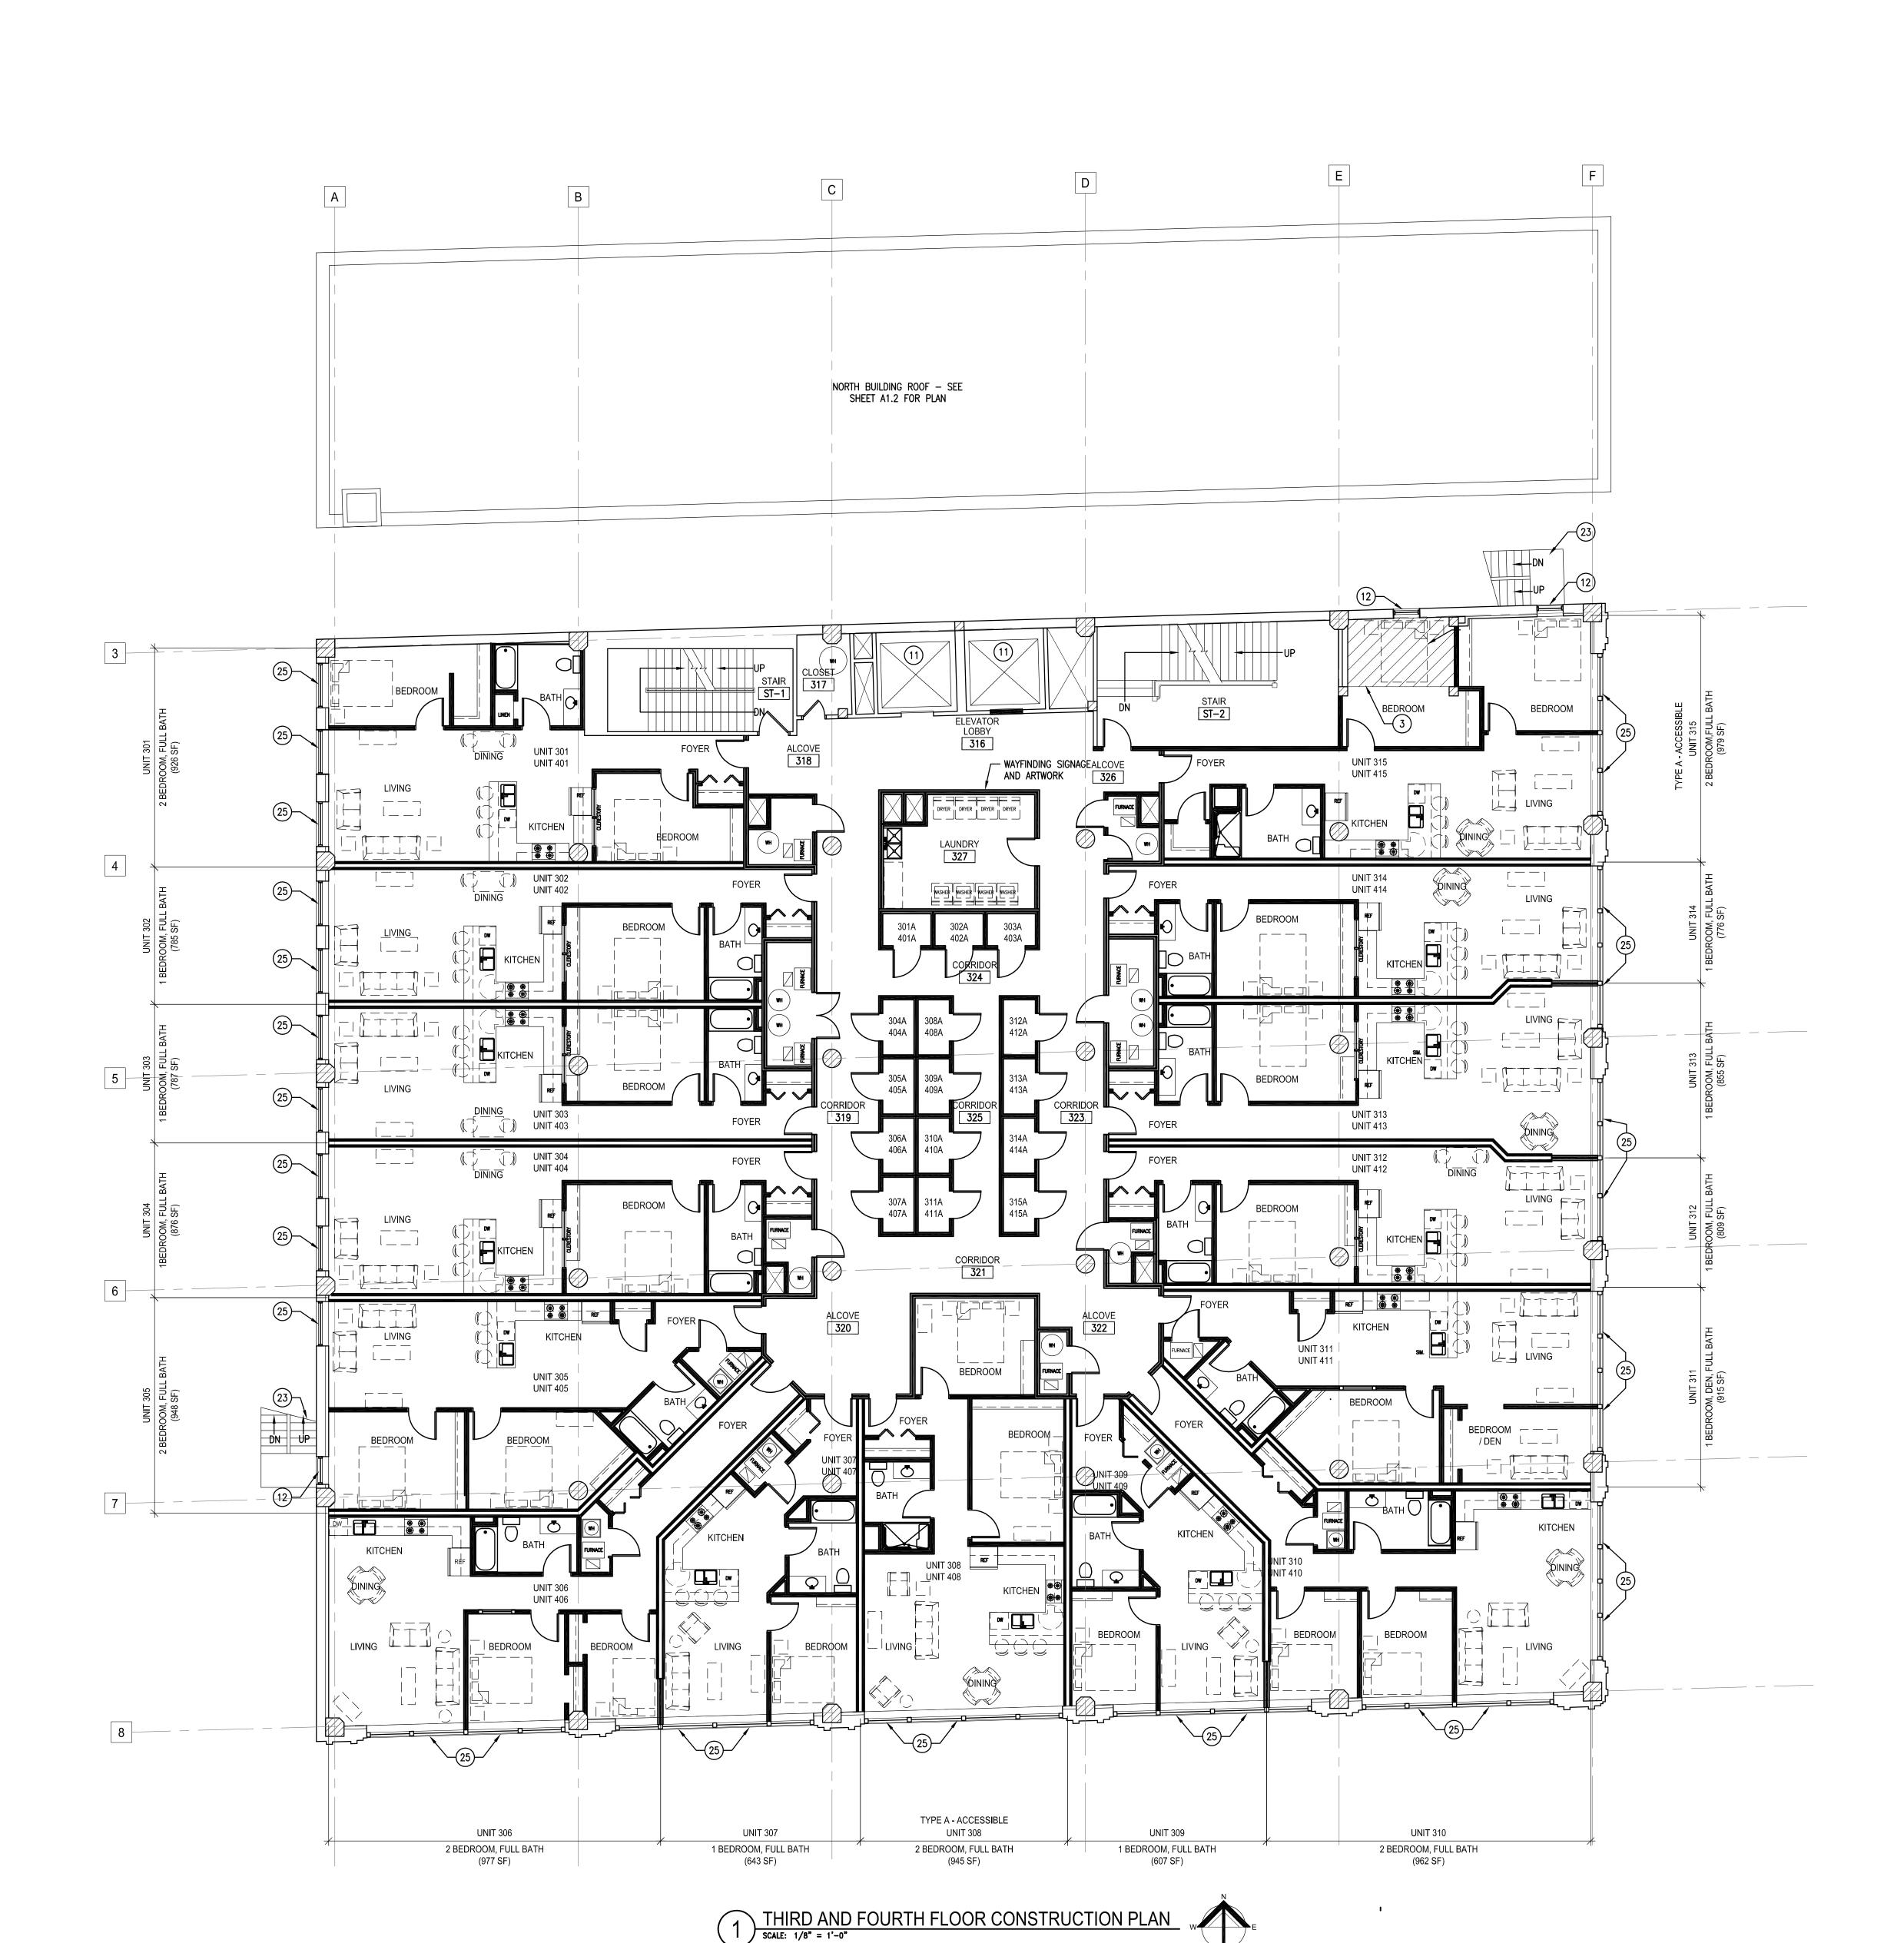


NPS PART 2 - AMENDMENT #1 10/09/2015

Sheet Name: THIRD AND FOURTH FLOOR CONSTRUCTION PLAN

Drawn By: CLR/EJL Project No.: 10031.04



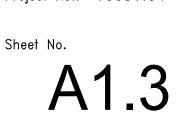

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CONSTRUCTION NOTES

- NEW PASSENGER ELEVATOR THREE-STOP: BASEMENT, FIRST FLOOR, MEZZANINE.
- (2) PATCH FLOOR AT LOCATION OF REMOVED STAIR.
- 3 INFILL FLOOR OPENING AT REMOVED STAIR/AIR-SHAFT/ELEVATOR TO MATCH EXISTING
- FLOOR STRUCTURE.
- (4) NEW CONCRETE RAMP.
- (5) REINSTALL SALVAGED HISTORIC RAILING.
- 6 NEW ALUMINUM STOREFRONT TO MATCH EXISTING, WITH INSULATED GLAZING SEE ELEVATIONS.
- (7) NEW BOILERS TO REPLACE EXISTING IN KIND.
- 8 NEW AIR HANDLING UNIT TO REPLACE EXISTING IN KIND.
- 9 NEW ELEVATOR SHAFT OVERRUN PER NEW PASSENGER ELEVATOR SPECIFICATIONS.
- PROVIDE NEW PUSH BUTTON AUTOMATIC DOOR OPERATOR AT EXISTING DOOR.
- EXISTING PASSENGER ELEVATOR:
 RECONFIGURE CONTROLS TO LOCK-OUT MEZZANINE LEVEL. EXTEND TRAVEL OF WEST ELEVATOR ONLY TO SIXTH FLOOR ROOF LEVEL.
- (12) NEW ALUMINUM WINDOW SEE ELEVATIONS
- (13) NEW ENTRY DOOR SEE ELEVATIONS
- (14) NEW OVERHEAD COILING DOOR SEE ELEVATIONS
- (15) MASONRY INFILL AT EXISTING OPENING
- (16) DECORATIVE METAL FENCE SEE ELEVATIONS.
- (17) EXISTING ENTRANCE SYSTEM TO REMAIN.
- (18) NEW ALUMINUM/GLASS ENTRY SYSTEM
- 19 NEW CONCRETE PLAZA DECK OVER WATERPROOFING MEMBRANE ON EXISTING STRUCTURAL DECK. (20) NEW CONCRETE STAIR TO NEW PLAZA DECK LEVEL.
- EXISTING DECORATIVE COLUMN CAPITALS TO REMAIN EXPOSED CLEAN AND REPAIR AS REQUIRED.
- 22 EXISTING DECORATIVE RAILING TO REMAIN CLEAN AND REPAIR AS REQUIRED.
- 23 EXISTING FIRE ESCAPE TO REMAIN SEE ELEVATIONS.
- (24) NOT USED.
- EXISTING ALUMINUM CLAD WOOD WINDOWS TO REMAIN CLEAN AND REPAIR AS REQUIRED.
- NEW WALL LOUVER FOR MECHANICAL ROOM LOCATIONS SEE ELEVATIONS.
- (27) NEW INTERIOR STAIR TO FIFTH FLOOR ROOF.
- NEW CMU PARAPET WALL ROOF PATIO ENCLOSURE
 SEE BUILDING SECTION.
- CONCRETE PAVER & PEDESTAL DECK SYSTEM ON SHEET WATERPROOFING MEMBRANE OVER TAPERED SHEET WATERPROOFING MEMBRANE OVER TAPERED RIGID INSULATION ON EXISTING CONCRETE ROOF DECK - SEE BUILDING SECTION.
- (30) NEW PLANTER BOX AND PATIO DIVIDER.
- (31) EXISTING ROOF ACCESS SHIP'S LADDER TO REMAIN.
- NEW SHEET WATERPROOFING MEMBRANE ROOFING OVER RIGID INSULATION ON EXISTING WOOD-FRAMED ATTIC DECK.
- (33) ROOF ACCESS STAIR.
- (34) EXISTING FLAGPOLE TO REMAIN.
- (35) NEW ATTIC ACCESS DOOR.
- (36) NEW SHEET METAL PARAPET COPING.
- (37) 48" DECORATIVE METAL/GLASS GUARD RAIL.
- (38) NEW CHILLERS ON EXISTING STEEL STRUCTURE. (39) EXISTING HARP LIGHT AND POST TO REMAIN.
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GENERAL NOTES

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CONSTRUCTION

QUORUM ARCHITECTS, INC.


- 4. PARTITIONS ARE DIMENSIONED FROM FINISH FACE TO FINISH FACE, UNLESS OTHERWISE NOTED. MAINTAIN DIMENSIONS MARKED "CLEAR" OR "HOLD". ALLOW FOR THICKNESS OF FINISHES.
- 5. COORDINATE AND PROVIDE BACKING FOR MILLWORK AND ITEMS ATTACHED OR MOUNTED TO WALLS OR CEILINGS.
- 6. CONTRACTORS SHALL SUBMIT (4) SETS OF SHOP DRAWINGS, SAMPLES, INTERIOR AND EXTERIOR FINISHES, RELEVANT TECHNICAL DATA AND APPLICABLE CUT SHEETS TO THE ARCHITECTS FOR REVIEW PRIOR TO THE COMMENCEMENT OF WORK.
- 7. VOICE AND DATA CABLING BY TENANT.
- 8. FURNITURE IS SHOWN FOR REFERENCE ONLY.
- 9. ALL NEWLY CONSTRUCTED ROOMS OR OFFICES SHALL INCLUDE PROVISIONS FOR ADEQUATE POWER AND VOICE/DATA OUTLETS.
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- 11. ALL WORK SHALL COMPLY WITH APPLICABLE LOCAL, STATE AND FEDERAL CODES, LAWS, ORDINANCES, RULES AND REGULATIONS OF PUBLIC AUTHORITIES GOVERNING THE
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- 13. THE DESIGN OF THE HEATING/VENTILATION & AIR CONDITIONING, AS WELL AS ANY DRAWINGS OR SUBMITTALS REQUIRED FOR DESIGN AND INSTALLATION OF THE HVAC SYSTEM, IS THE RESPONSIBILITY OF THE HVAC CONTRACTOR. ALL COORDINATION OF THIS WORK IS THE
- 14. THE DESIGN OF ALL ELECTRICAL WORK, AS WELL AS ANY DRAWINGS OR SUBMITTALS REQUIRED FOR DESIGN AND INSTALLATION OF THE ELECTRICAL / LIGHTING WORK, IS THE RESPONSIBILITY OF THE ELECTRICAL CONTRACTOR. ALL COORDINATION OF THIS WORK IS THE RESPONSIBILITY OF THE GENERAL CONTRACTOR.

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- 15. THE DESIGN OF ALL PLUMBING WORK, AS WELL AS ANY DRAWINGS OR SUBMITTALS REQUIRED FOR DESIGN AND INSTALLATION OF THE PLUMBING, IS THE RESPONSIBILITY OF THE PLUMBING CONTRACTOR. ALL COORDINATION OF THIS WORK IS THE RESPONSIBILITY OF THE GENERAL CONTRACTOR.
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LEGEND

EXISTING WALLS TO REMAIN NEW PARTIAL HEIGHT WALL



EXISTING DOORS TO REMAIN NEW DOORS

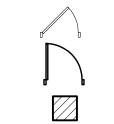Revisions: FURNITURE BY TENANT SHOWN FOR REFERENCE ONLY

01/12/2016

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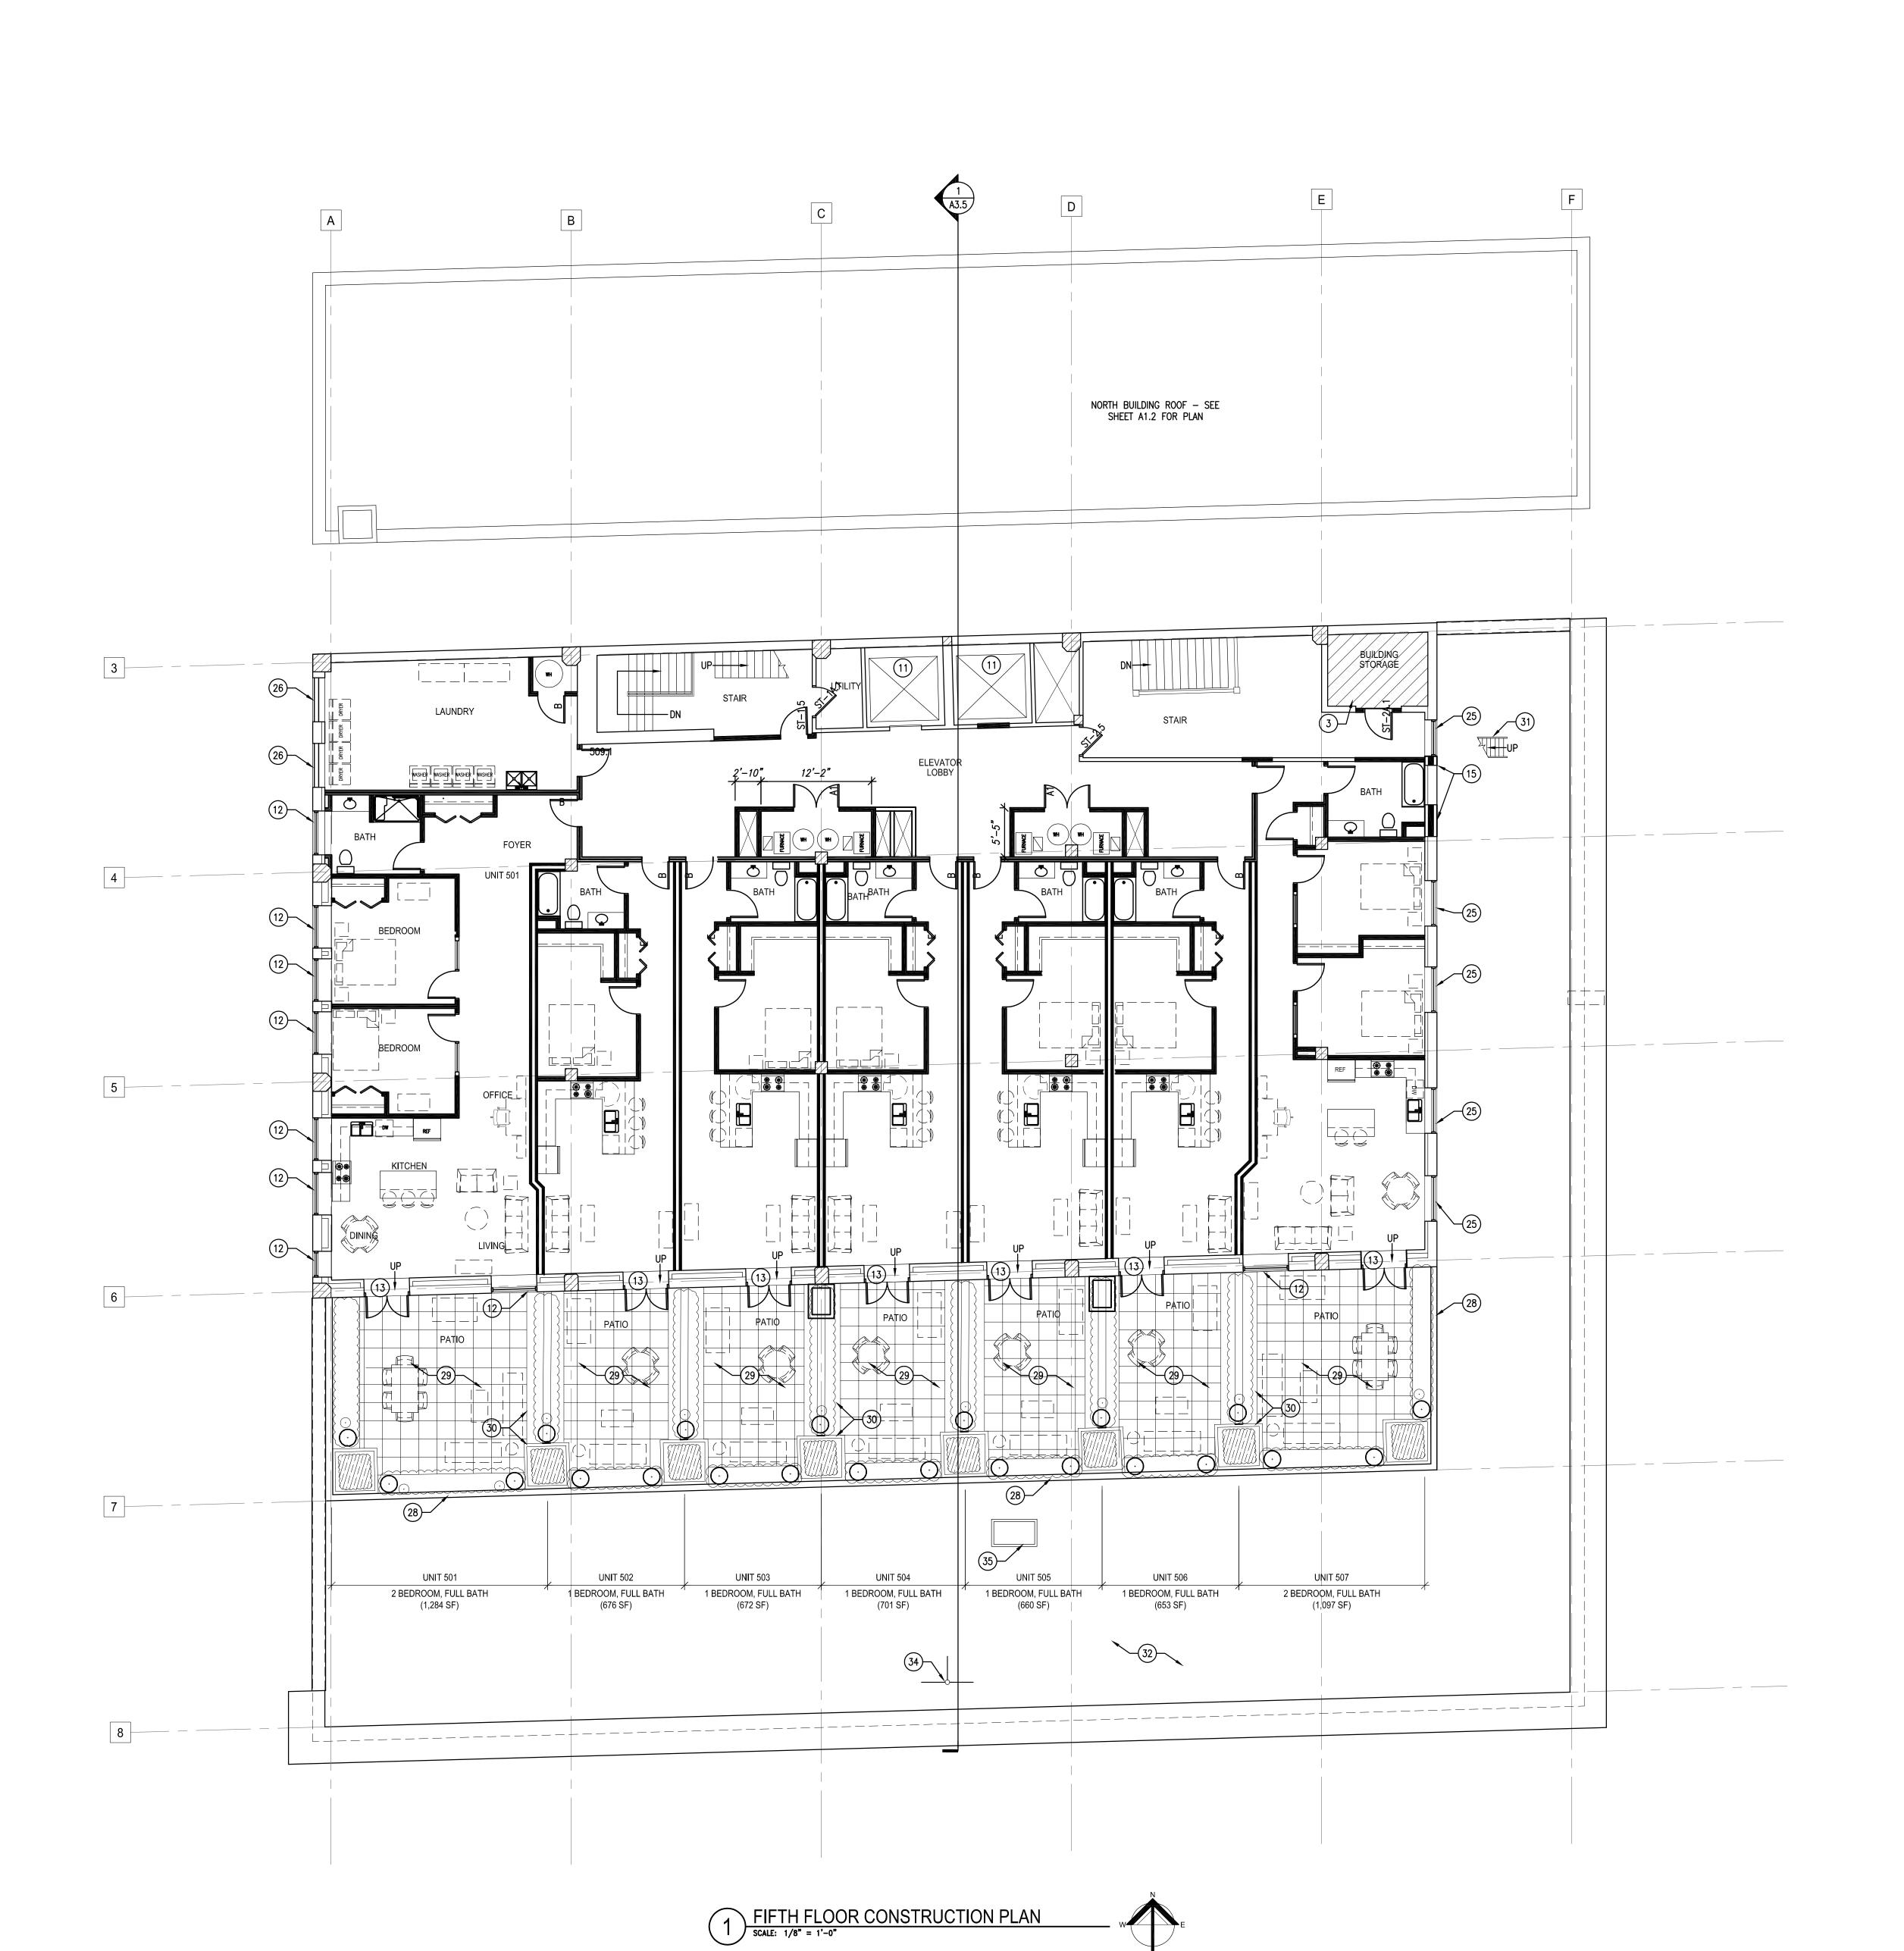
www.quorumarchitects.com

PRELIMINARY

NOT FOR

CONSTRUCTION

QUORUM ARCHITECTS, INC.



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- NEW PASSENGER ELEVATOR THREE-STOP: BASEMENT, FIRST FLOOR, MEZZANINE.
- (2) PATCH FLOOR AT LOCATION OF REMOVED STAIR.
- 3 INFILL FLOOR OPENING AT REMOVED STAIR/AIR-SHAFT/ELEVATOR TO MATCH EXISTING
- FLOOR STRUCTURE.
- (4) NEW CONCRETE RAMP.
- (5) REINSTALL SALVAGED HISTORIC RAILING.
- 6 NEW ALUMINUM STOREFRONT TO MATCH EXISTING, WITH INSULATED GLAZING SEE ELEVATIONS.
- (7) NEW BOILERS TO REPLACE EXISTING IN KIND.
- 8 NEW AIR HANDLING UNIT TO REPLACE EXISTING IN KIND.
- 9 NEW ELEVATOR SHAFT OVERRUN PER NEW PASSENGER ELEVATOR SPECIFICATIONS.
- PROVIDE NEW PUSH BUTTON AUTOMATIC DOOR OPERATOR AT EXISTING DOOR.
- EXISTING PASSENGER ELEVATOR:
 RECONFIGURE CONTROLS TO LOCK-OUT MEZZANINE LEVEL.
- SIXTH FLOOR ROOF LEVEL.

EXTEND TRAVEL OF WEST ELEVATOR ONLY TO

- (12) NEW ALUMINUM WINDOW SEE ELEVATIONS
- (13) NEW ENTRY DOOR SEE ELEVATIONS (14) NEW OVERHEAD COILING DOOR - SEE ELEVATIONS
- (15) MASONRY INFILL AT EXISTING OPENING (16) DECORATIVE METAL FENCE — SEE ELEVATIONS.
- (17) EXISTING ENTRANCE SYSTEM TO REMAIN.
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- NEW CMU PARAPET WALL ROOF PATIO ENCLOSURE
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- (40) INSTALL SALVAGED HARP LIGHT AND POST.
- (41) NEW CURVED GLASS GLAZING.
- (42) NEW PREFINISHED METAL PANEL SIDING OVER EXISTING PARGED MASONRY

GENERAL NOTES


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EXISTING WALLS TO REMAIN



EXISTING DOORS TO REMAIN NEW DOORS

FURNITURE BY TENANT SHOWN FOR REFERENCE ONLY

NEW PARTIAL HEIGHT WALL

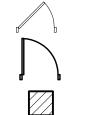Revisions:

Sheet Name: FIFTH FLOOR CONSTRUCTION PLAN

01/12/2016 Drawn By: CLR/EJL Project No.: 10031.04

3112 West Highland Boulevard

Milwaukee, Wisconsin 53208 Phone: 414.265.9265 Fax: 414.265.9465


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PRELIMINARY

NOT FOR

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QUORUM ARCHITECTS, INC.



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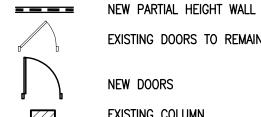
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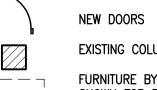
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LEGEND
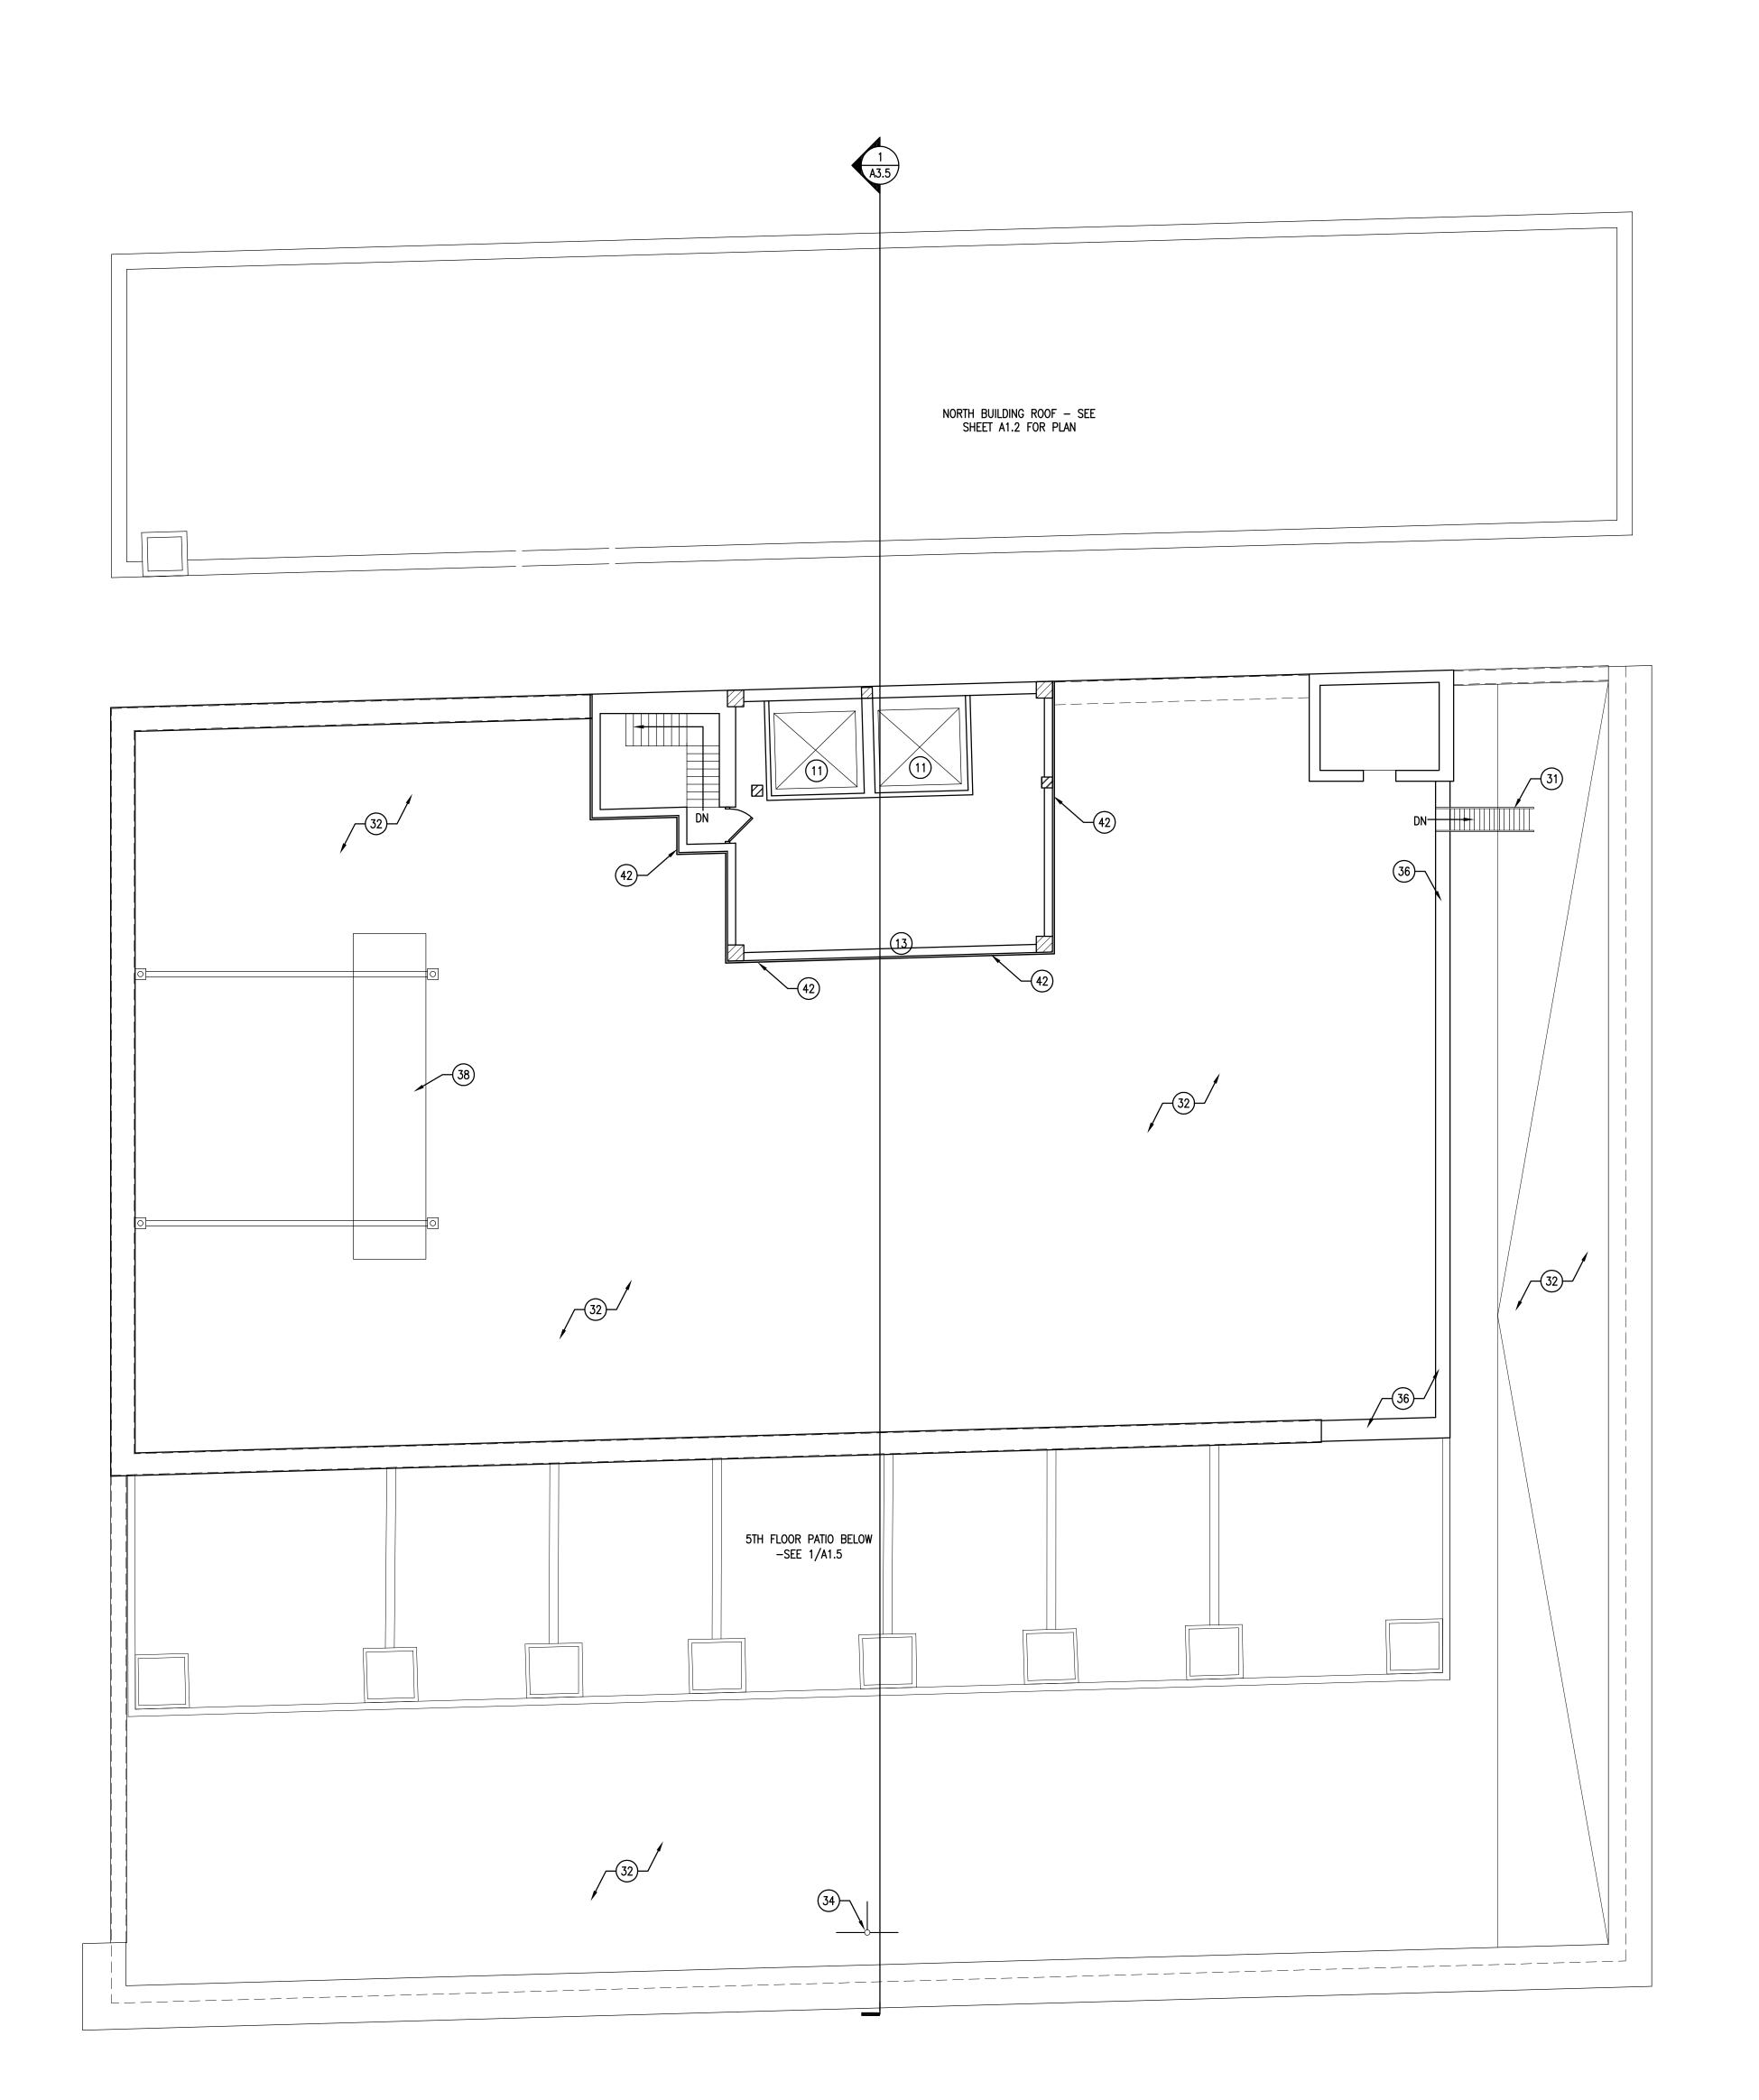
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EXISTING DOORS TO REMAIN





FURNITURE BY TENANT SHOWN FOR REFERENCE ONLY

> Sheet Name: **UPPER ROOF** CONSTRUCTION PLAN

Revisions:

01/12/2016 Drawn By: CLR/EJL Project No.: 10031.04

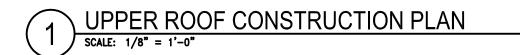

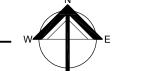

ELEVATION CONSTRUCTION NOTES

1 CLEAN AND REPOINT EXISTING UNPAINTED FACE BRICK AS REQUIRED.

2 CLEAN AND REPOINT EXISTING STONE TRIM AND

3 CLEAN EXISTING EXPOSED CONCRETE STRUCTURE.
ROUT AND POINT EXISTING CRACKS AND OLD
REPAIRS AS REQUIRED. PATCH SPALLED AREAS AND

RUB SURFACE TO MATCH ADJACENT.

4 MAINTAIN EXISTING CERAMIC COPING TILE CAP. PATCH MISSING OR DAMAGED TILES TO MATCH.

BETWEEN HILLS BUILDING AND NORTH BUILDING

8 EXISTING EXTERIOR DOOR TO REMAIN. REPAINT AND MODIFY DOOR HARDWARE AS SCHEDULED.

NEW EXTERIOR ALUMINUM CLAD WOOD DOOR WITH GLAZED LITE AND TRANSOM ABOVE BY WINDOW

EXISTING WOOD WINDOW TO REMAIN. REPAINT AND REGLAZE AS REQUIRED.

RECLAIMED BRICK INFILL AT EXISTING ABANDONED WINDOW/DOOR.

EXPOSED STEEL I—BEAM REMNANT. CLEAN, PRIME, AND PAINT.

EXISTING CLAD WOOD WINDOWS TO REMAIN. REPAIR OR REPLACE IN KIND AT DAMAGED WINDOWS. SEE

NEW EXTERIOR PREFINISHED METAL PANEL SIDING OVER EXISTING PARGED MASONRY.

NEW AT-GRADE PAINTED METAL ENTRY DOORS IN NEW MASONRY OPENING.

NEW DOUBLE-HUNG ALUMINUM CLAD WOOD WINDOWS IN NEW MASONRY OPENING.

NEW INSULATED STEEL OVERHEAD DOOR AT EXISTING GARAGE DOOR LOCATION.

(23) INSTALL SALVAGED HARP LIGHT AND POST.

REPAIR OR REPLACE AND PAINT EXISTING METAL GUARDRAIL.

PRIME AND PAINT EXISTING FLAGPOLE. REPAIR AS REQUIRED.

NEW PAINTED ALUMINUM—CLAD WOOD DOUBLE—HUNG WINDOW WITH NEW LINTEL AND NEW

STONE SILL TO MATCH EXISTING.

29 NEW STEEL LINTEL SPANNING NEW MASONRY OPENING OVER DOOR/WINDOW.

NEW MECHANICAL DUCT LOUVER FOR NEW MECHANICAL ROOM—SEE SPACE PLANS.

OPENINGS WITH DROPPED SILLS.

(34) NEW CONCRETE STEPS AT NEW GRADE.

NEW PAINTED METAL GUARDRAIL WITH CLEAR TEMPERED GLAZING GUARDS AT ROOF DECK.

EXISTING METAL RAISED LETTER BUILDING SIGNAGE TO REMAIN.

EXISTING ROOFED CANOPY WITH STEEL SUPPORTING STRUCTURE. REPAINT EXPOSED STEEL AND FASCIA.

REFURBISH AND REPAINT EXISTING WOOD STOREFRONT ENTRY AND GLAZED TRANSOM ABOVE.

EXISTING GROUND-FACED TERRAZZO BULKHEAD BELOW SUPPORT.

EXISTING METAL TRANSOM TO REMAIN. PATCH AS REQUIRED.

NEW STOREFRONT CLERESTORY WITH TRANSLUCENT REEDED GLAZING TO MATCH EXISTING IN KIND. SEE

EXISTING MECHANICAL LOUVER TO BE REUSED OR RECONFIGURED AS REQUIRED.

(42) REPAINT EXISTING METAL CORNICE.

SHEET A5.3 FOR DETAILS.

(45) EXISTING CONCRETE COLUMN AT INTERIOR.

(47) EXISTING HARP LAMP AND POST TO REMAIN.

CLEAN, REPOINT AND REPAINT EXISTING PAINTED COMMON BRICK MASONRY.

71 REMOVE EXISTING PAINT FROM FACE OF BRICK, CLEAN AND REPOINT AS REQUIRED.

EXISTING METAL DOOR AND LADDER TO REMAIN.
DOOR TO BE FIXED IN PLACE.

NEW CLAD WOOD DOUBLE-HUNG WINDOW IN NEW MASONRY OPENING.

NEW DOUBLE-HUNG ALUMINUM CLAD WOOD WINDOWS IN RE-OPENED WINDOW OPENINGS.

(53) NOT USED.

54) NOT USED.

55) NOT USED.

CLEAN AND REPOINT EXISTING UN-PAINTED COMMON BRICK.

(48) EXISTING GHOST SIGNAGE TO REMAIN.

(39) NEW AUTOMATIC DOOR OPERATOR BUTTON.

(35) NEW CURVED GLASS GLAZING.

(30) PRIME AND PAINT EXISTING ROOF ACCESS LADDER.

32) NEW PAINTED ALUMINUM FRAMED WINDOWS WITH CLEAR INSULATED GLAZING IN EXISTING MASONRY

33) NEW STOREFRONT WITH CLEAR GLAZING TO MATCH EXISTING IN KIND. SEE SHEET A5.3 FOR DETAILS.

(14) EXISTING FIRE ESCAPE TO REMAIN. REPAINT.

NEW 42" HIGH PAINTED DECORATIVE METAL PRIVACY FENCE AND GATE.

SHEET A5.1 FOR DETAILS.

(21) REPAINT EXISTING CMU INFILL.

(25) NEW 8" MASONRY BLOCK WALL.

(27) NOT USED.

REPAINT EXISTING FIRE DEPARTMENT SIAMESE CONNECTION.

5) NEW 8' DECORATIVE PAINTED METAL FENCE

VENEER AS REQUIRED.

WITH SWINGING GATE.

(6) EXISTING SIGNAGE TO REMAIN.

MANUFACTURER.

9 EXISTING SECURITY CAMERA LOCATION.

7 NOT USED.

LDING RENOVATION

Revisions:

NPS PART 2 - AMENDMENT #1

10/09/2015

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Sheet Name:

CONSTRUCTION ELEVATIONS

Date: 01/12/2016


EAST AND WEST

Date: 01/12/201

Drawn By: AJD

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VENEER AS REQUIRED.

WITH SWINGING GATE.

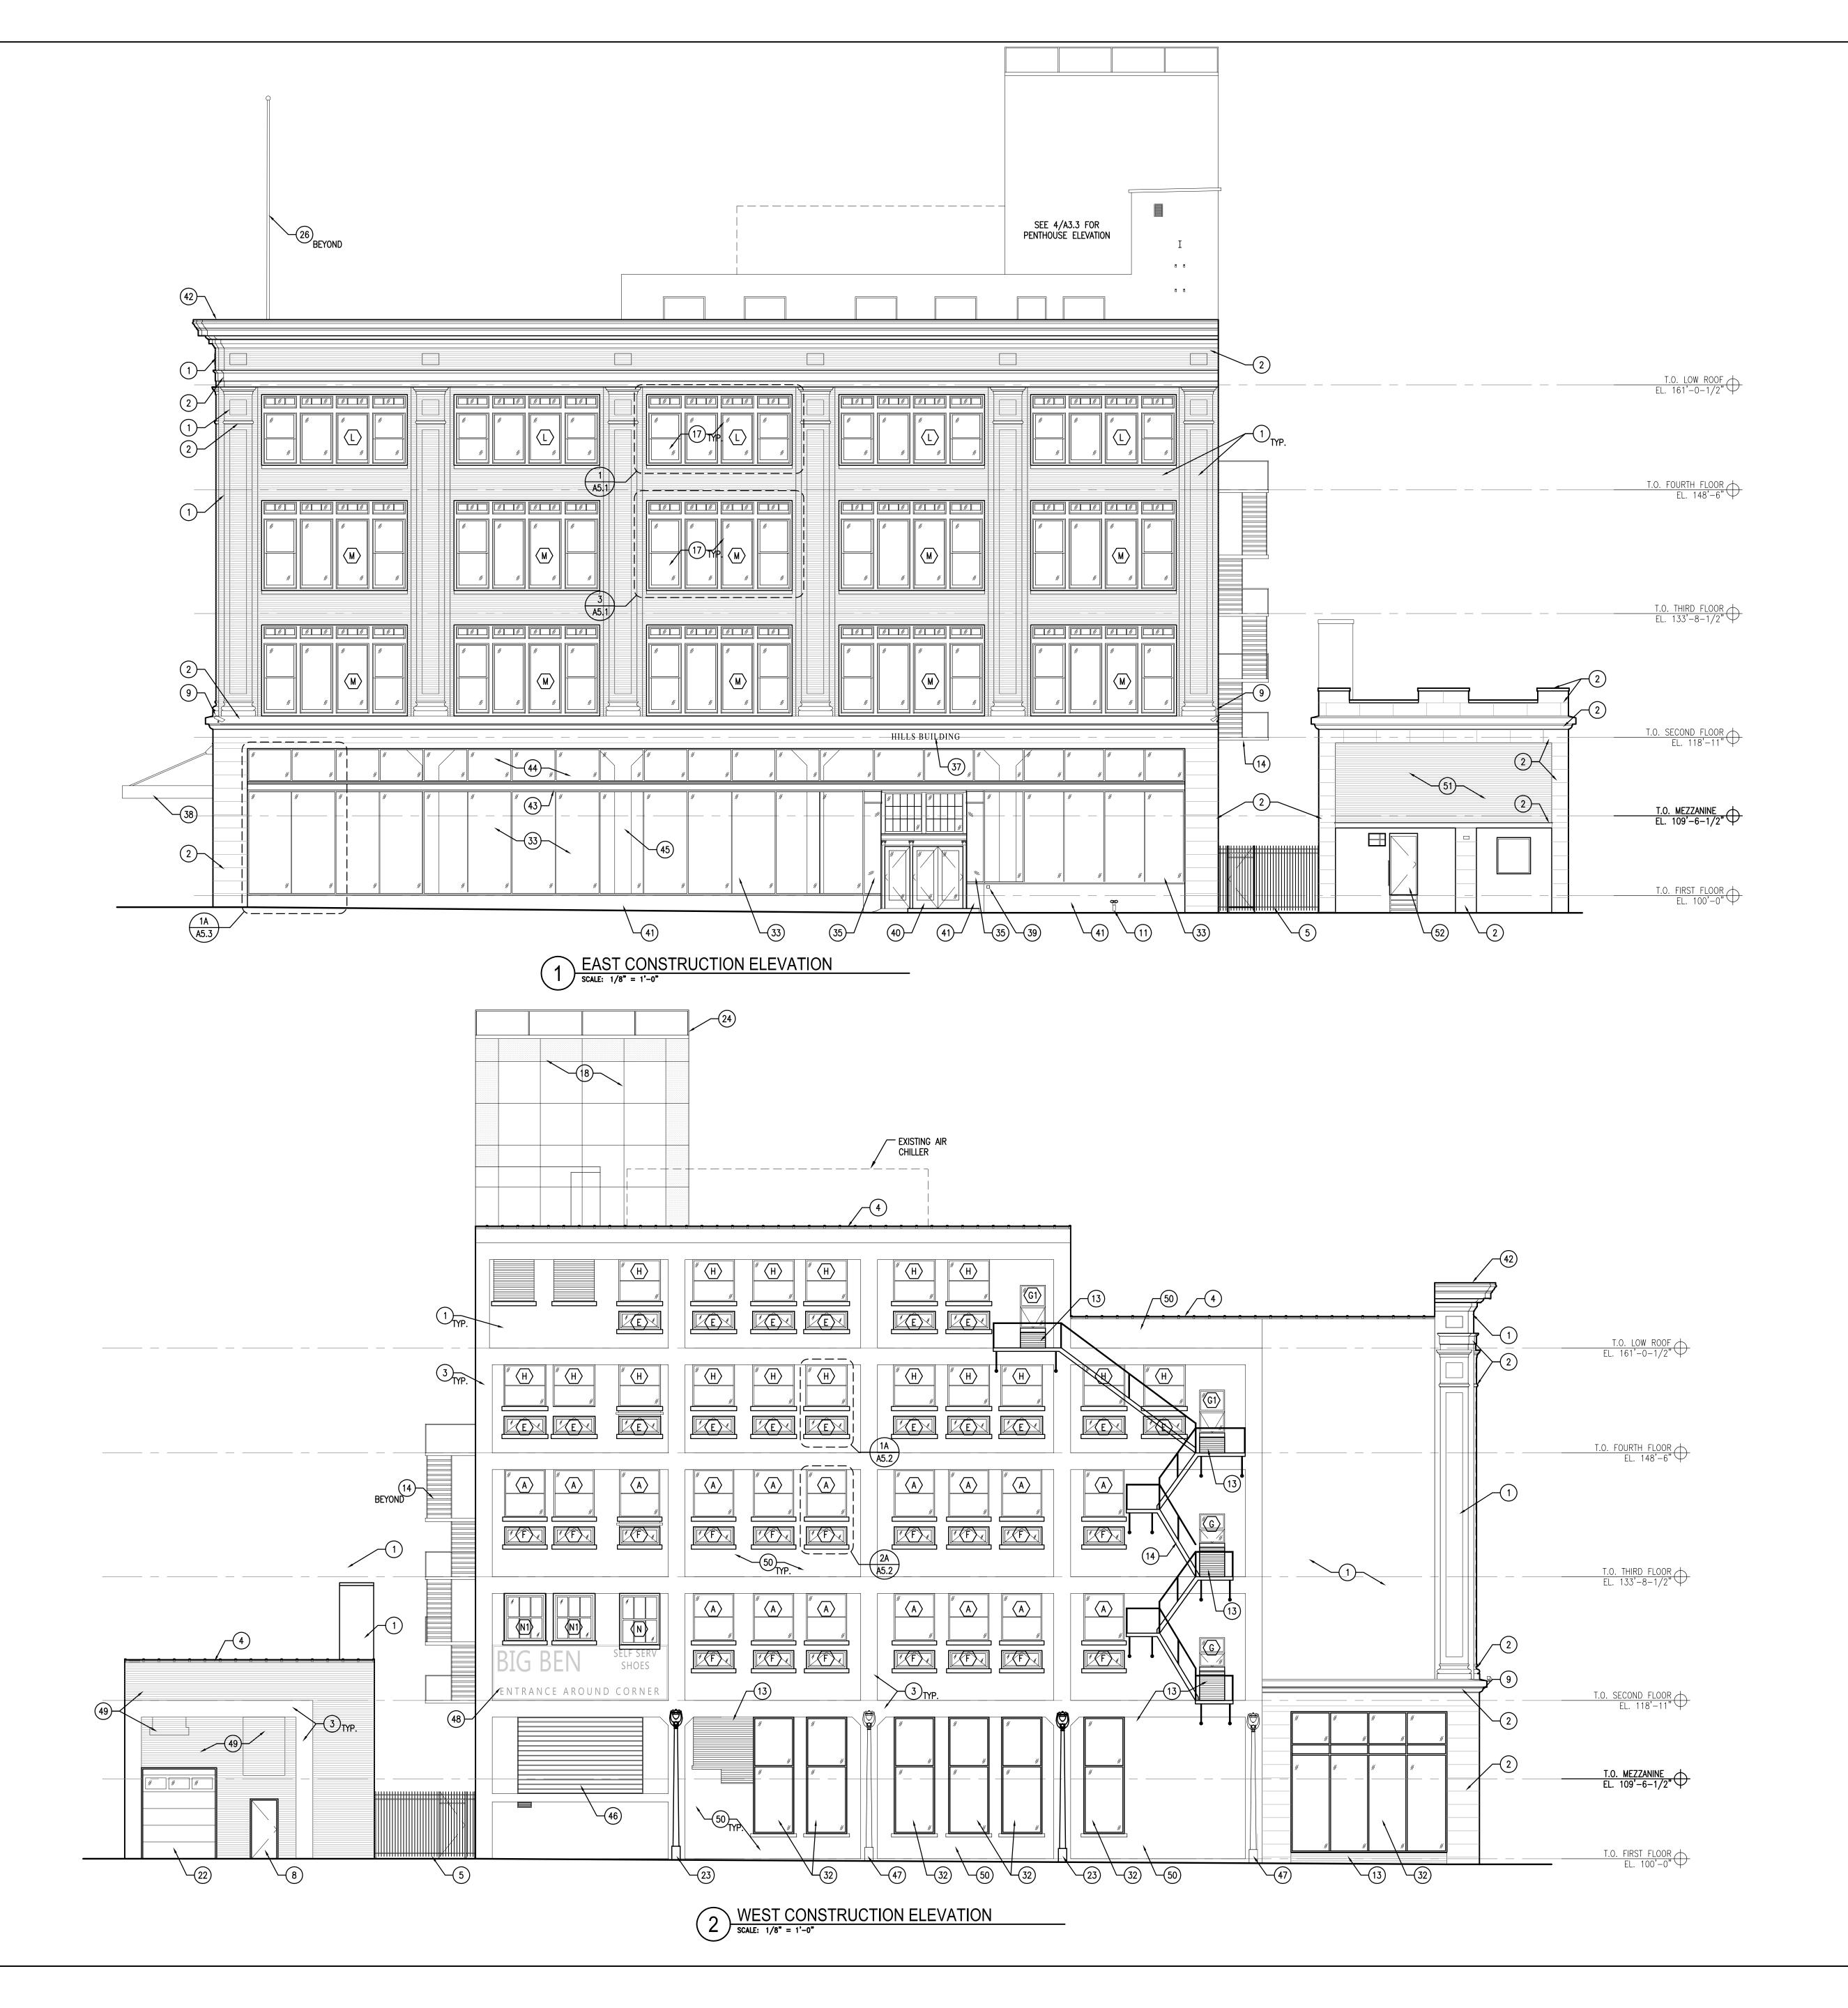MANUFACTURER.

SHEET A5.1 FOR DETAILS.

STONE SILL TO MATCH EXISTING.

OPENINGS WITH DROPPED SILLS.

SHEET A5.3 FOR DETAILS.

ROUT AND POINT EXISTING CRACKS AND OLD REPAIRS AS REQUIRED. PATCH SPALLED AREAS AND

BETWEEN HILLS BUILDING AND NORTH BUILDING

RUB SURFACE TO MATCH ADJACENT.



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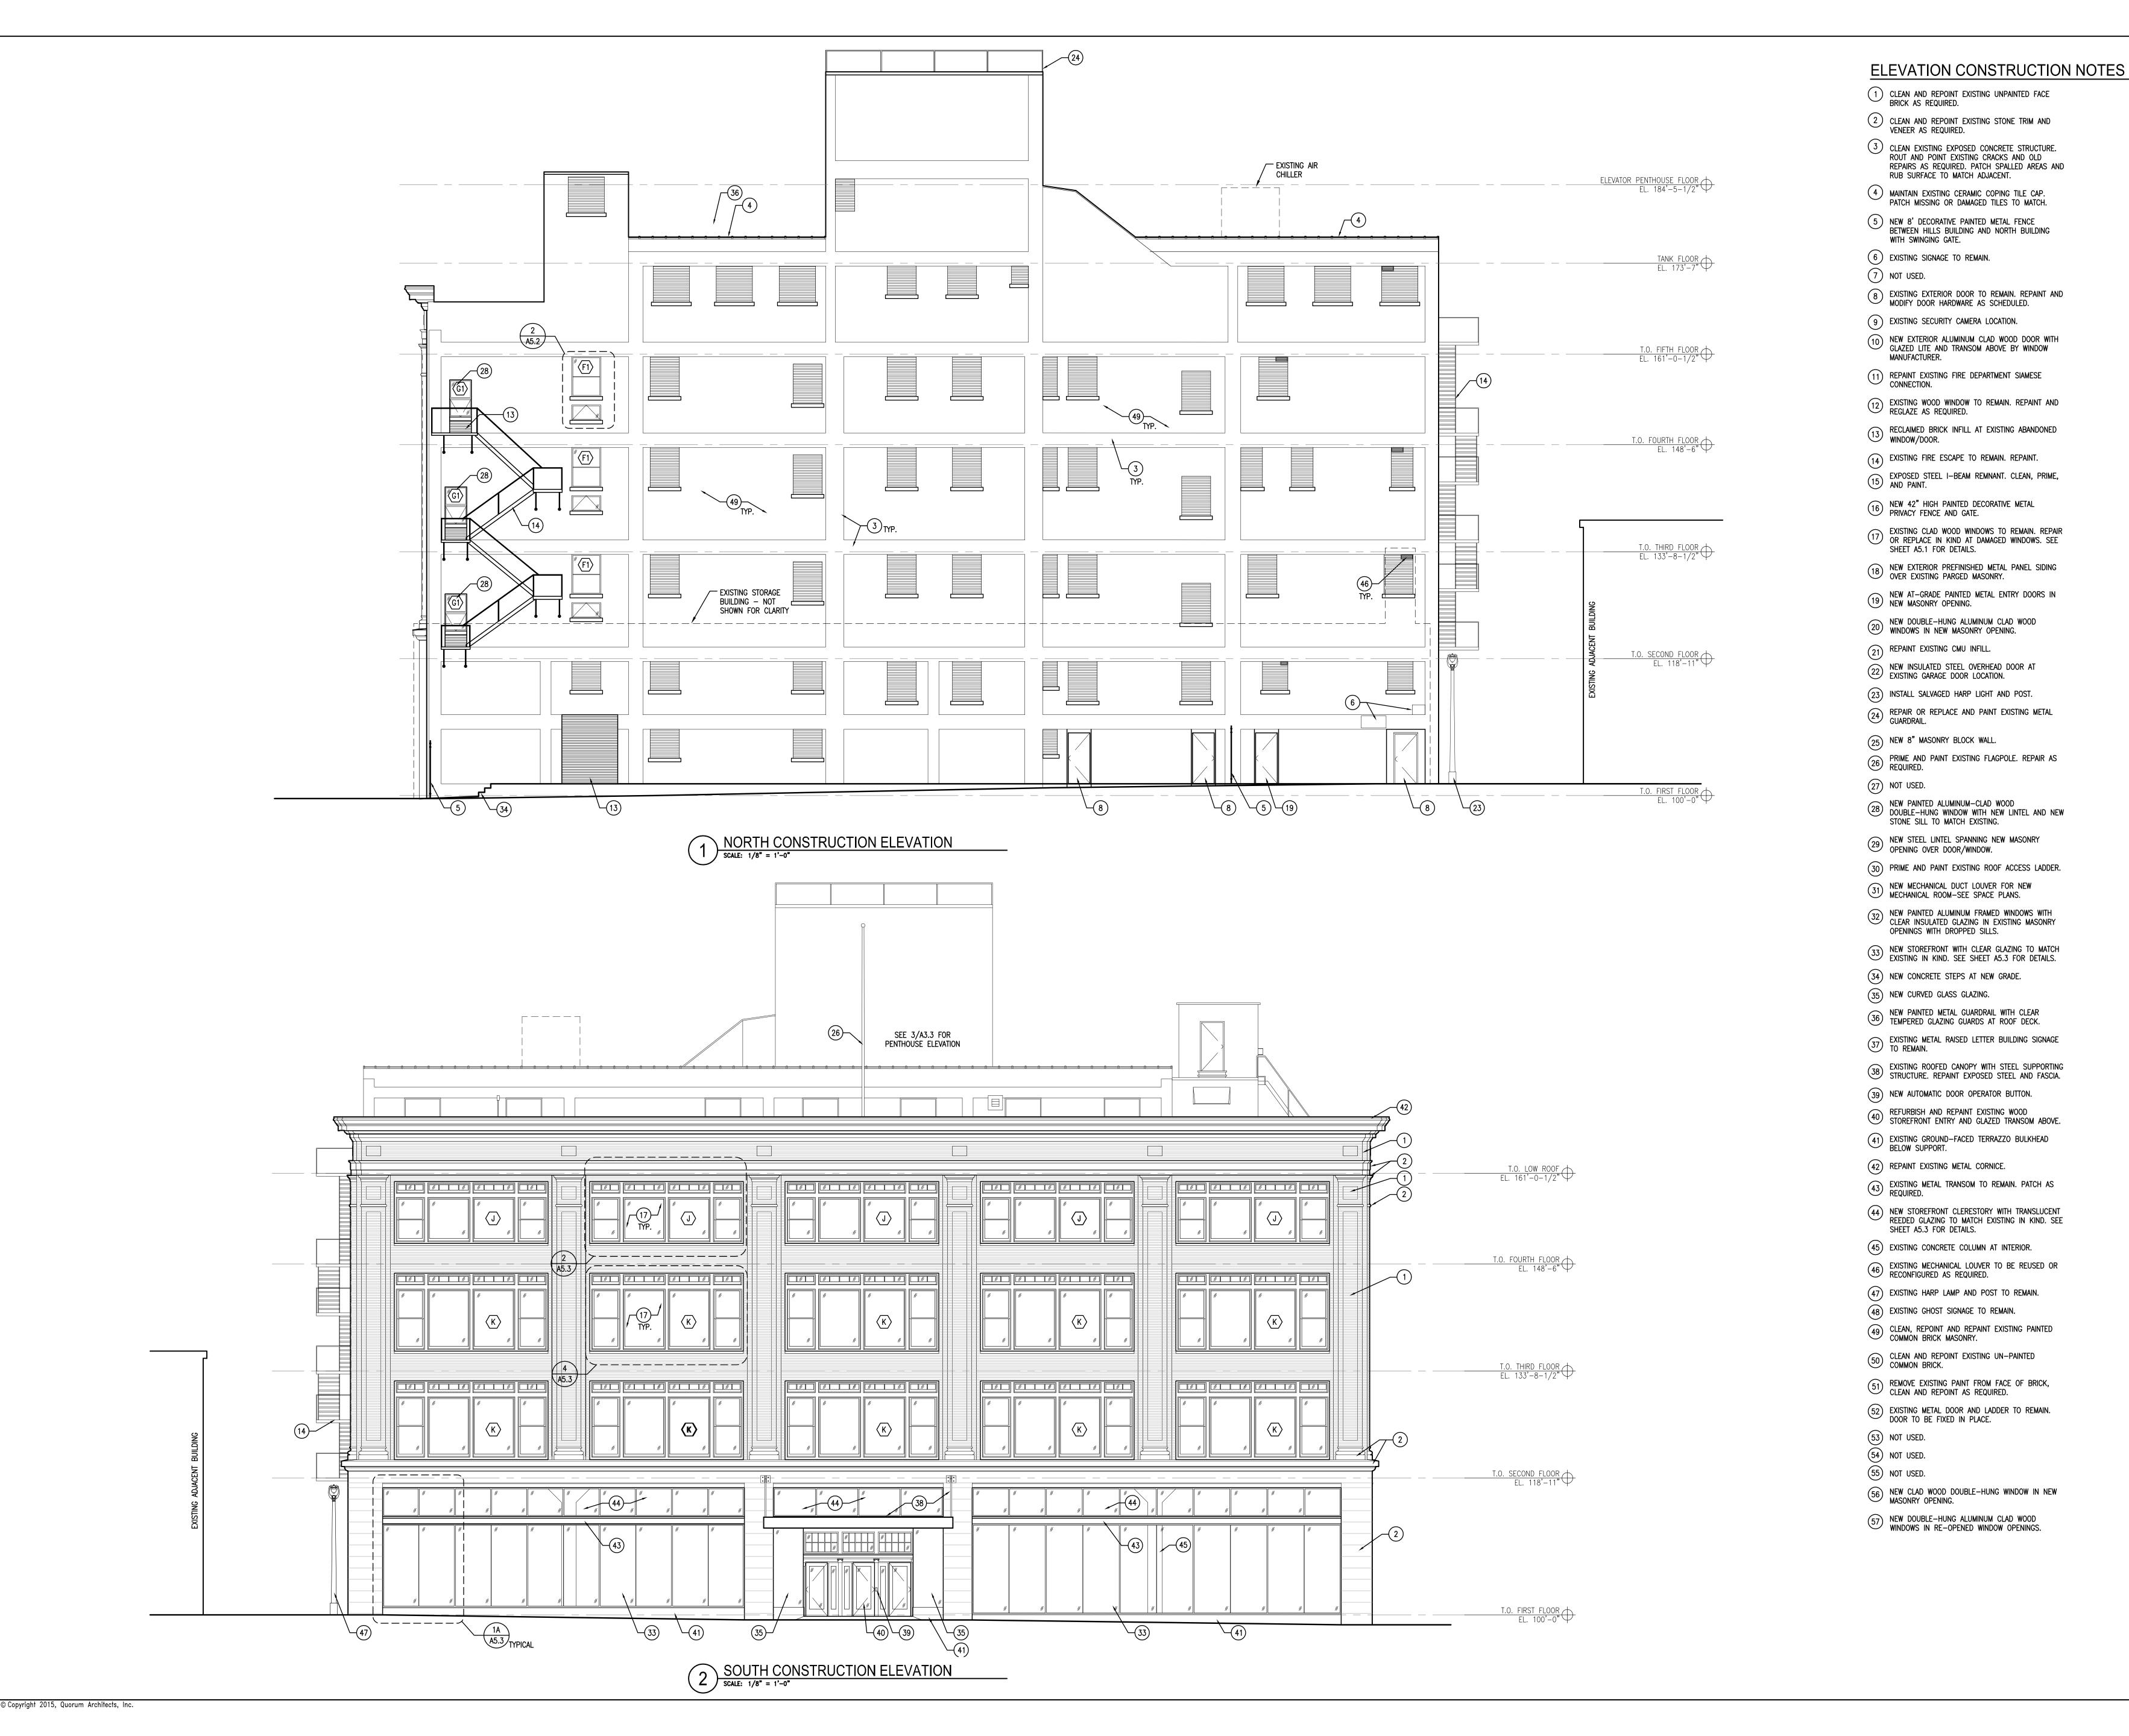
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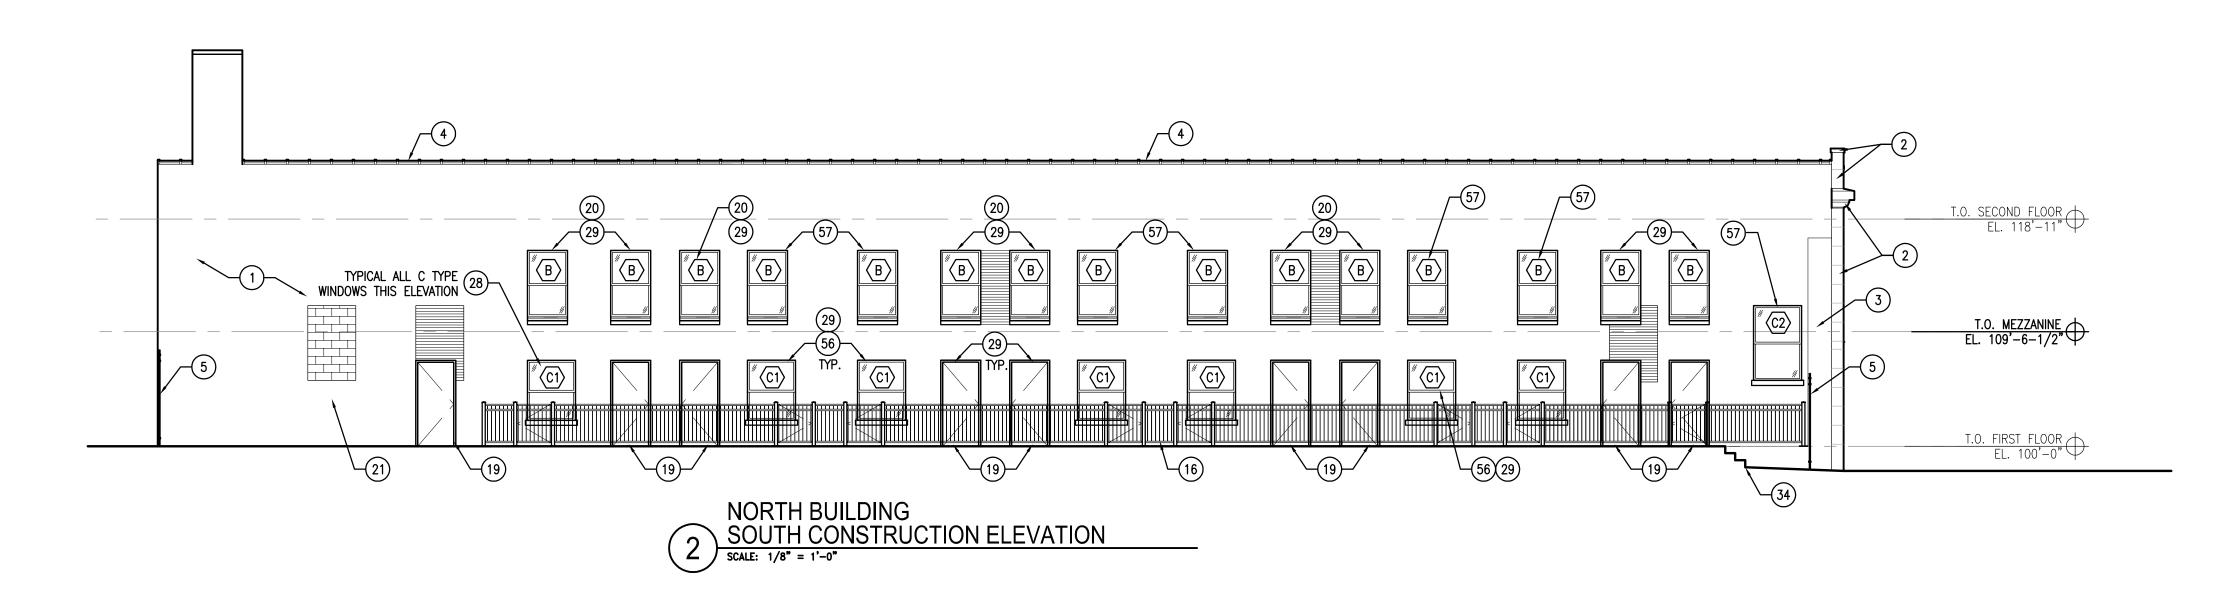
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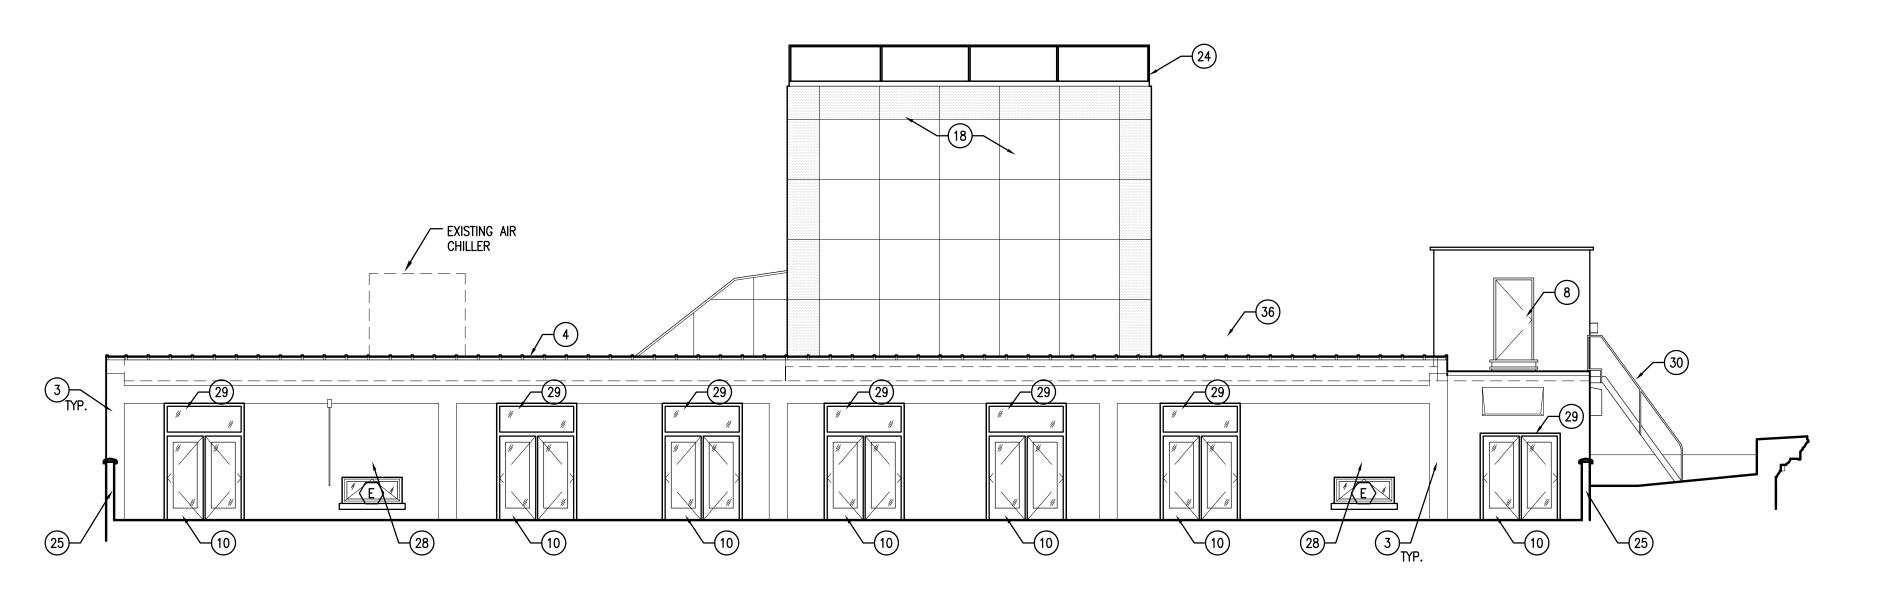
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Project No.: 10031.04


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ELEVATION CONSTRUCTION NOTES

- 1) CLEAN AND REPOINT EXISTING UNPAINTED FACE BRICK AS REQUIRED.
- 2 CLEAN AND REPOINT EXISTING STONE TRIM AND VENEER AS REQUIRED.
- CLEAN EXISTING EXPOSED CONCRETE STRUCTURE.
 ROUT AND POINT EXISTING CRACKS AND OLD
 REPAIRS AS REQUIRED. PATCH SPALLED AREAS AND
 RUB SURFACE TO MATCH ADJACENT.
- MAINTAIN EXISTING CERAMIC COPING TILE CAP. PATCH MISSING OR DAMAGED TILES TO MATCH.
- 5 NEW 8' DECORATIVE PAINTED METAL FENCE BETWEEN HILLS BUILDING AND NORTH BUILDING WITH SWINGING GATE.
- 6 EXISTING SIGNAGE TO REMAIN.
- 7) NOT USED.
- 8 EXISTING EXTERIOR DOOR TO REMAIN. REPAINT AND MODIFY DOOR HARDWARE AS SCHEDULED.
- 9 EXISTING SECURITY CAMERA LOCATION.
- 10) NEW EXTERIOR ALUMINUM CLAD WOOD DOOR WITH GLAZED LITE AND TRANSOM ABOVE BY WINDOW MANUFACTURER.
- 11) REPAINT EXISTING FIRE DEPARTMENT SIAMESE CONNECTION.
- EXISTING WOOD WINDOW TO REMAIN. REPAINT AND REGLAZE AS REQUIRED.
- RECLAIMED BRICK INFILL AT EXISTING ABANDONED WINDOW/DOOR.
- (14) EXISTING FIRE ESCAPE TO REMAIN. REPAINT.
- EXPOSED STEEL I—BEAM REMNANT. CLEAN, PRIME, AND PAINT.
- 16 NEW 42" HIGH PAINTED DECORATIVE METAL PRIVACY FENCE AND GATE.
- EXISTING CLAD WOOD WINDOWS TO REMAIN. REPAIR OR REPLACE IN KIND AT DAMAGED WINDOWS. SEE SHEET A5.1 FOR DETAILS.
- NEW EXTERIOR PREFINISHED METAL PANEL SIDING OVER EXISTING PARGED MASONRY.
- NEW AT-GRADE PAINTED METAL ENTRY DOORS IN NEW MASONRY OPENING.
- NEW DOUBLE-HUNG ALUMINUM CLAD WOOD WINDOWS IN NEW MASONRY OPENING.
- (21) REPAINT EXISTING CMU INFILL.
- NEW INSULATED STEEL OVERHEAD DOOR AT EXISTING GARAGE DOOR LOCATION.
- (23) INSTALL SALVAGED HARP LIGHT AND POST.
- REPAIR OR REPLACE AND PAINT EXISTING METAL GUARDRAIL.
- 25) NEW 8" MASONRY BLOCK WALL.
- PRIME AND PAINT EXISTING FLAGPOLE. REPAIR AS REQUIRED.
- 27) NOT USED.
- NEW PAINTED ALUMINUM—CLAD WOOD DOUBLE—HUNG WINDOW WITH NEW LINTEL AND NEW STONE SILL TO MATCH EXISTING.
- 29 NEW STEEL LINTEL SPANNING NEW MASONRY OPENING OVER DOOR/WINDOW.
- (30) PRIME AND PAINT EXISTING ROOF ACCESS LADDER.
- NEW MECHANICAL DUCT LOUVER FOR NEW MECHANICAL ROOM—SEE SPACE PLANS.
- 32) NEW PAINTED ALUMINUM FRAMED WINDOWS WITH CLEAR INSULATED GLAZING IN EXISTING MASONRY OPENINGS WITH DROPPED SILLS.
- 33) NEW STOREFRONT WITH CLEAR GLAZING TO MATCH EXISTING IN KIND. SEE SHEET A5.3 FOR DETAILS.
- (34) NEW CONCRETE STEPS AT NEW GRADE.
- 35) NEW CURVED GLASS GLAZING.
- NEW PAINTED METAL GUARDRAIL WITH CLEAR TEMPERED GLAZING GUARDS AT ROOF DECK.
- EXISTING METAL RAISED LETTER BUILDING SIGNAGE TO REMAIN.
- EXISTING ROOFED CANOPY WITH STEEL SUPPORTING STRUCTURE. REPAINT EXPOSED STEEL AND FASCIA.
- (39) NEW AUTOMATIC DOOR OPERATOR BUTTON.
- REFURBISH AND REPAINT EXISTING WOOD STOREFRONT ENTRY AND GLAZED TRANSOM ABOVE.
- EXISTING GROUND-FACED TERRAZZO BULKHEAD BELOW SUPPORT.
- (42) REPAINT EXISTING METAL CORNICE.
- EXISTING METAL TRANSOM TO REMAIN. PATCH AS REQUIRED.
- NEW STOREFRONT CLERESTORY WITH TRANSLUCENT REEDED GLAZING TO MATCH EXISTING IN KIND. SEE SHEET A5.3 FOR DETAILS.
- 45) EXISTING CONCRETE COLUMN AT INTERIOR.
- EXISTING MECHANICAL LOUVER TO BE REUSED OR RECONFIGURED AS REQUIRED.
- (47) EXISTING HARP LAMP AND POST TO REMAIN.
- (48) EXISTING GHOST SIGNAGE TO REMAIN.
- CLEAN, REPOINT AND REPAINT EXISTING PAINTED COMMON BRICK MASONRY.
- CLEAN AND REPOINT EXISTING UN-PAINTED COMMON BRICK.
- 61) REMOVE EXISTING PAINT FROM FACE OF BRICK, CLEAN AND REPOINT AS REQUIRED.
- EXISTING METAL DOOR AND LADDER TO REMAIN.
 DOOR TO BE FIXED IN PLACE.
- (53) NOT USED.
- 54) NOT USED.
- 55) NOT USED.
- NEW CLAD WOOD DOUBLE-HUNG WINDOW IN NEW MASONRY OPENING.
- NEW DOUBLE-HUNG ALUMINUM CLAD WOOD WINDOWS IN RE-OPENED WINDOW OPENINGS.

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> **NILDING** \Box

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NORTH BUILDING AND PENTHOUSE CONSTRUCTION **ELEVATIONS**


Date: 01/12/2016 Drawn By: AJD
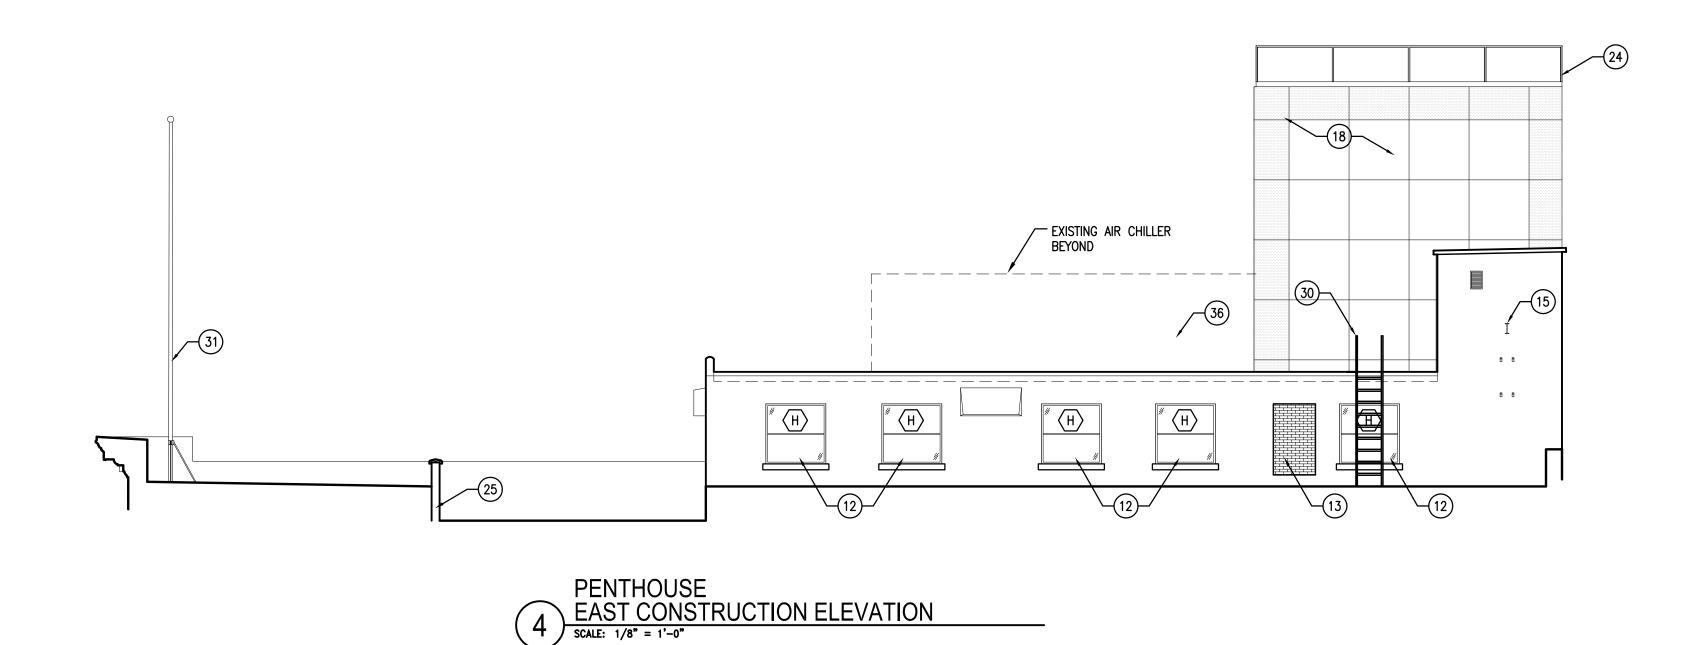
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A3.3

Project No.: 10031.04



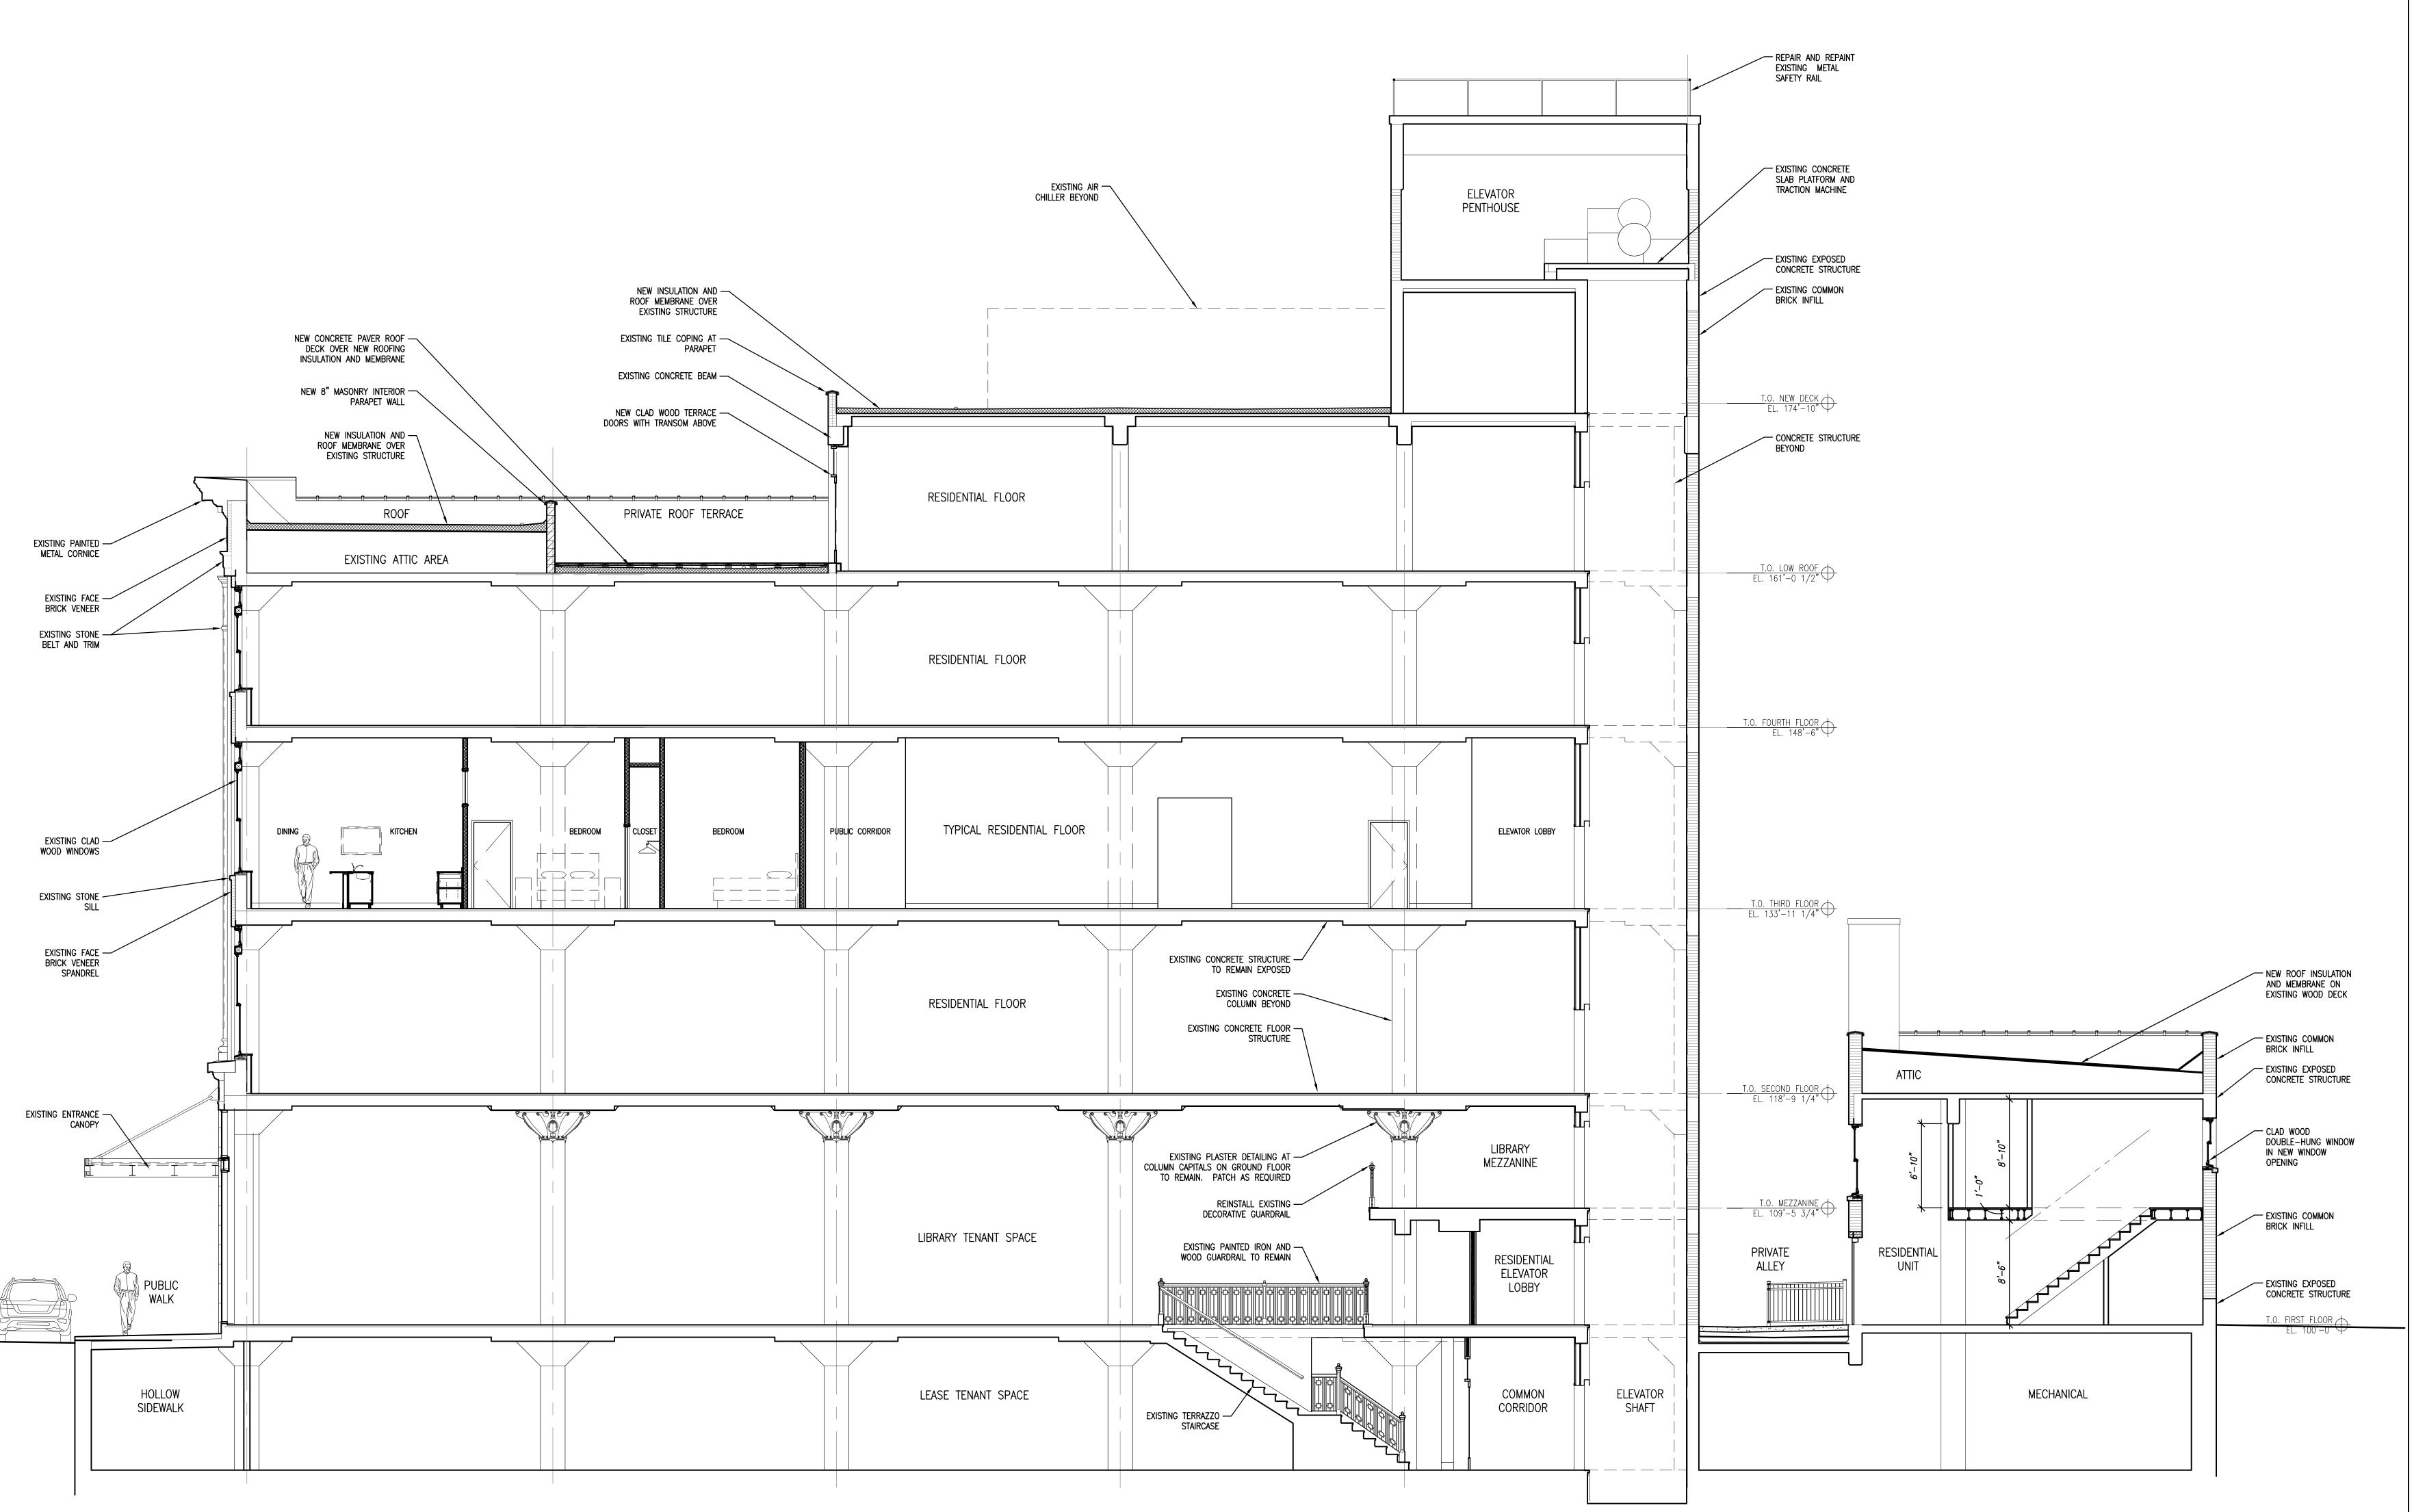

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HILLS BUILDING RENOVATION
OF WEST MITCHELL STREET

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10/09/2015

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BUILDING SECTION


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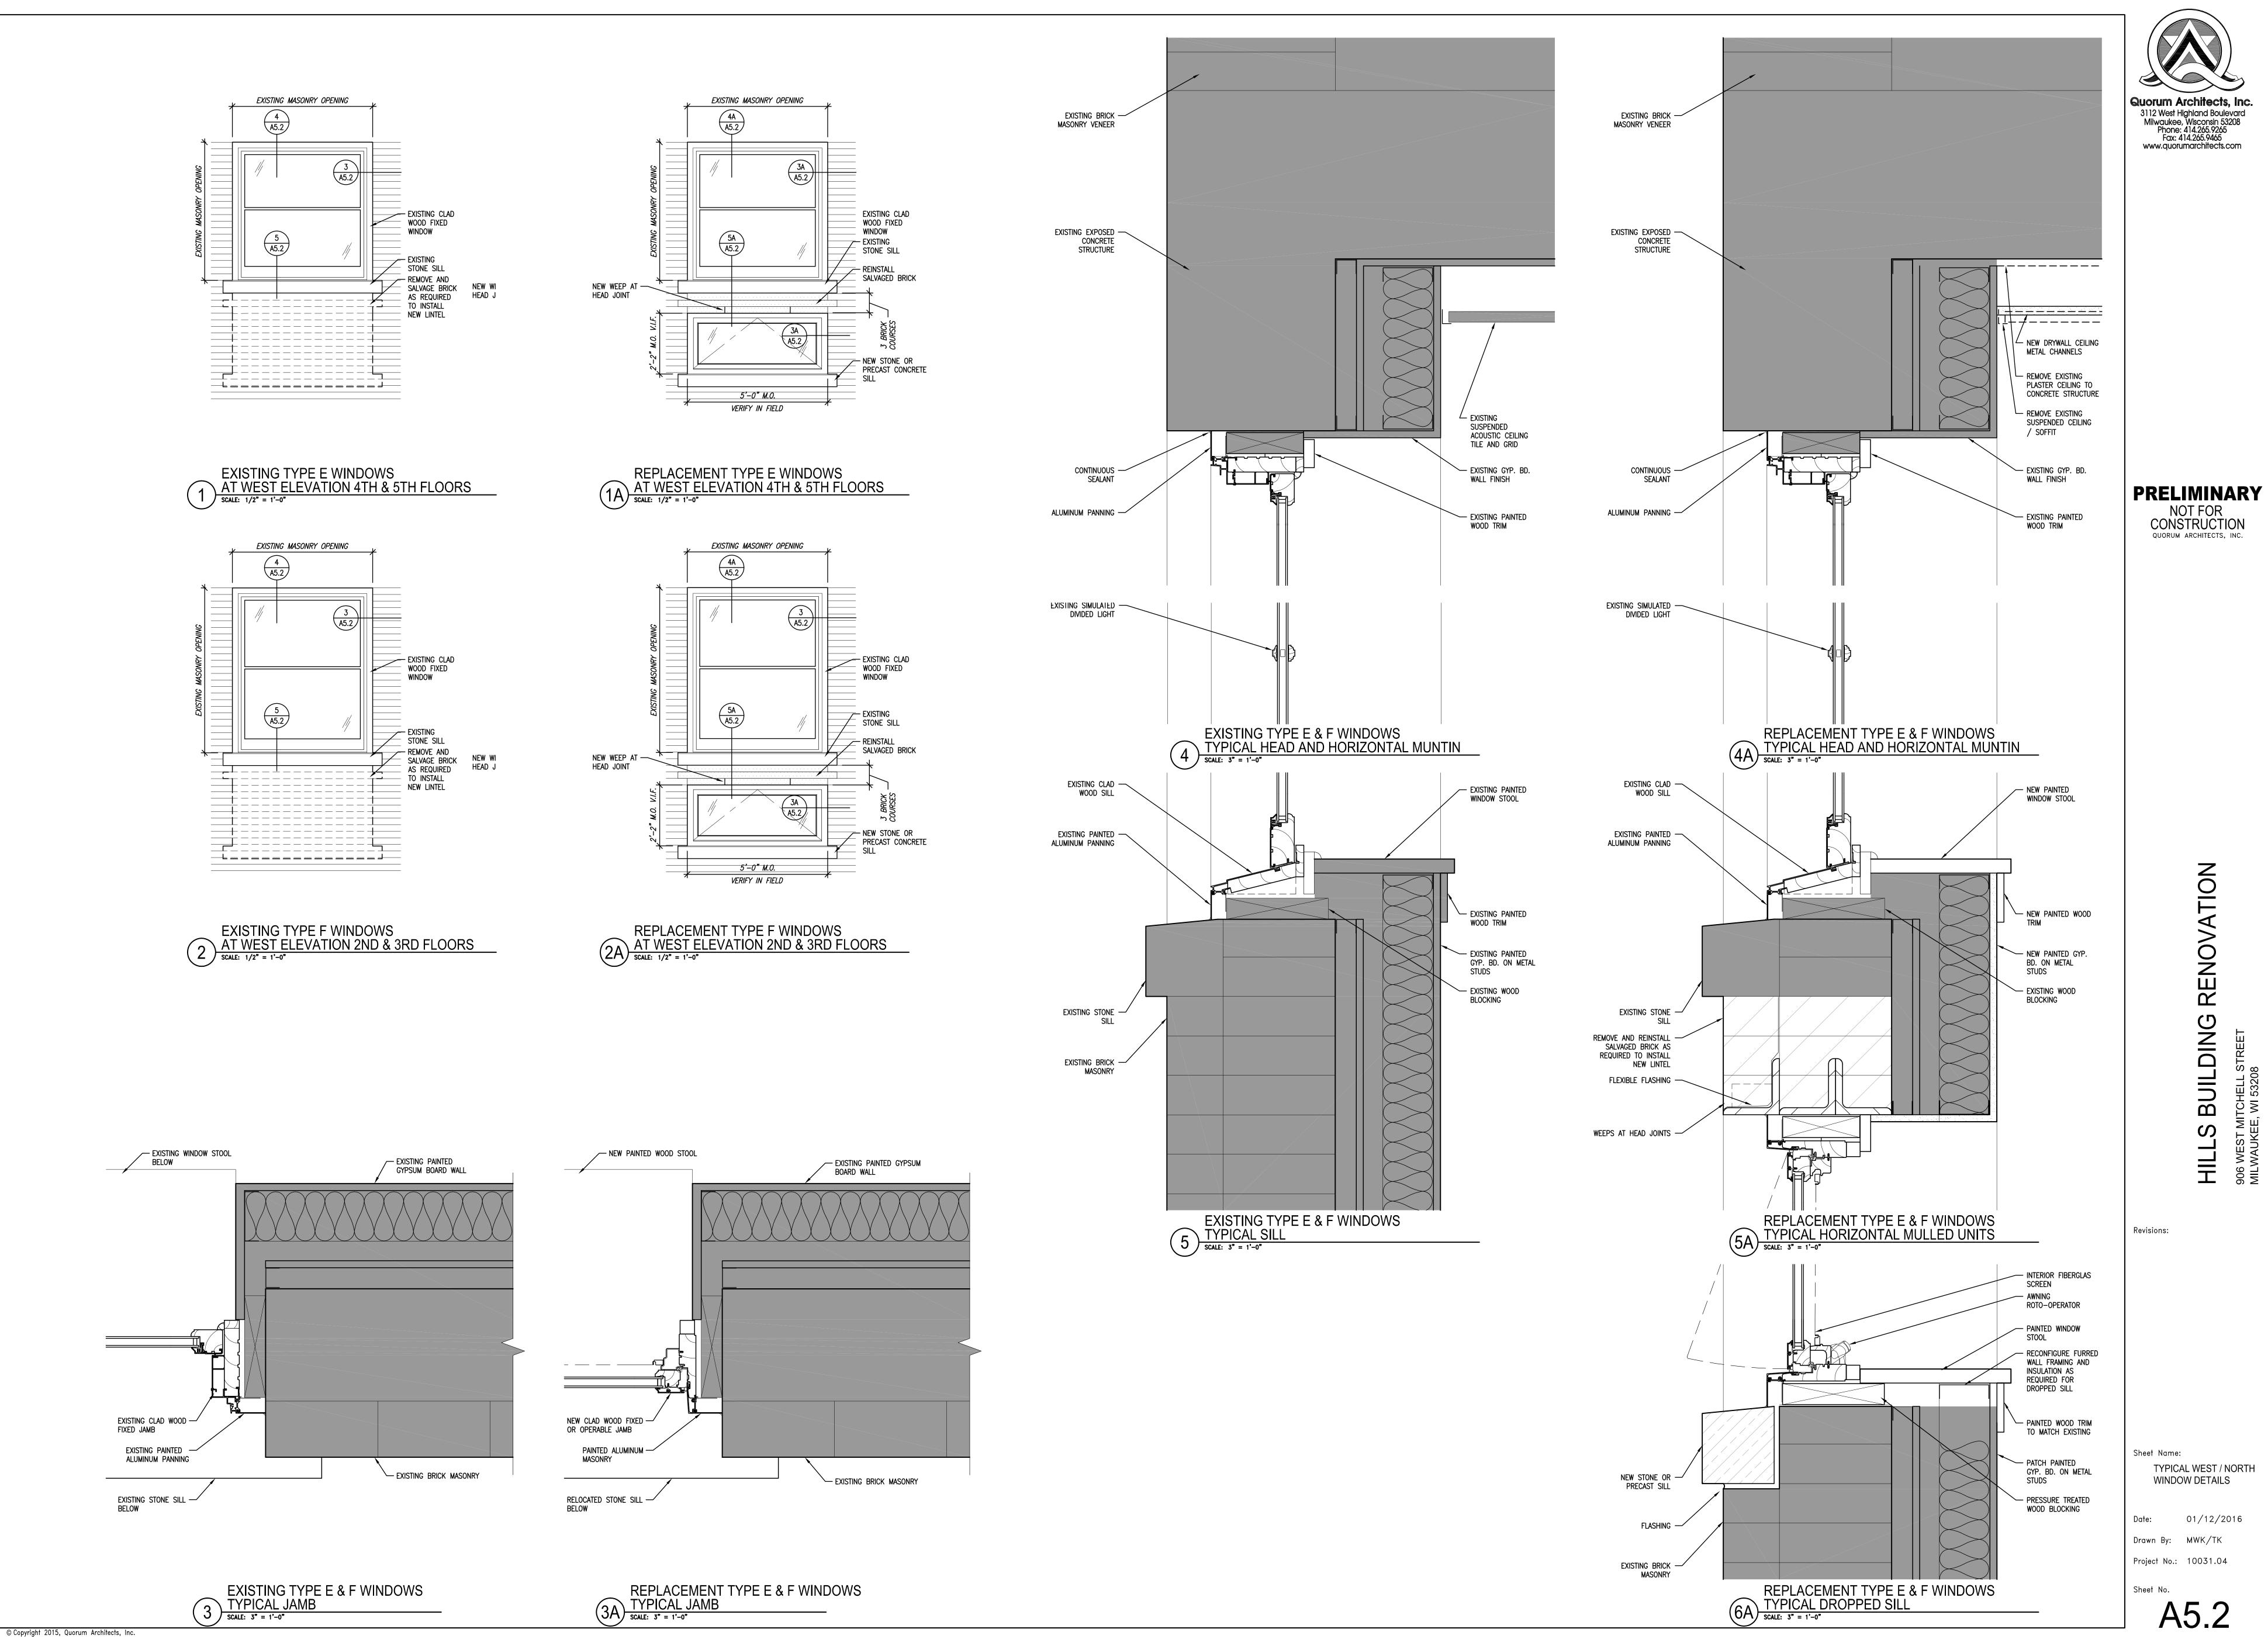
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A3.5

BUILDING SECTION LOOKING WEST





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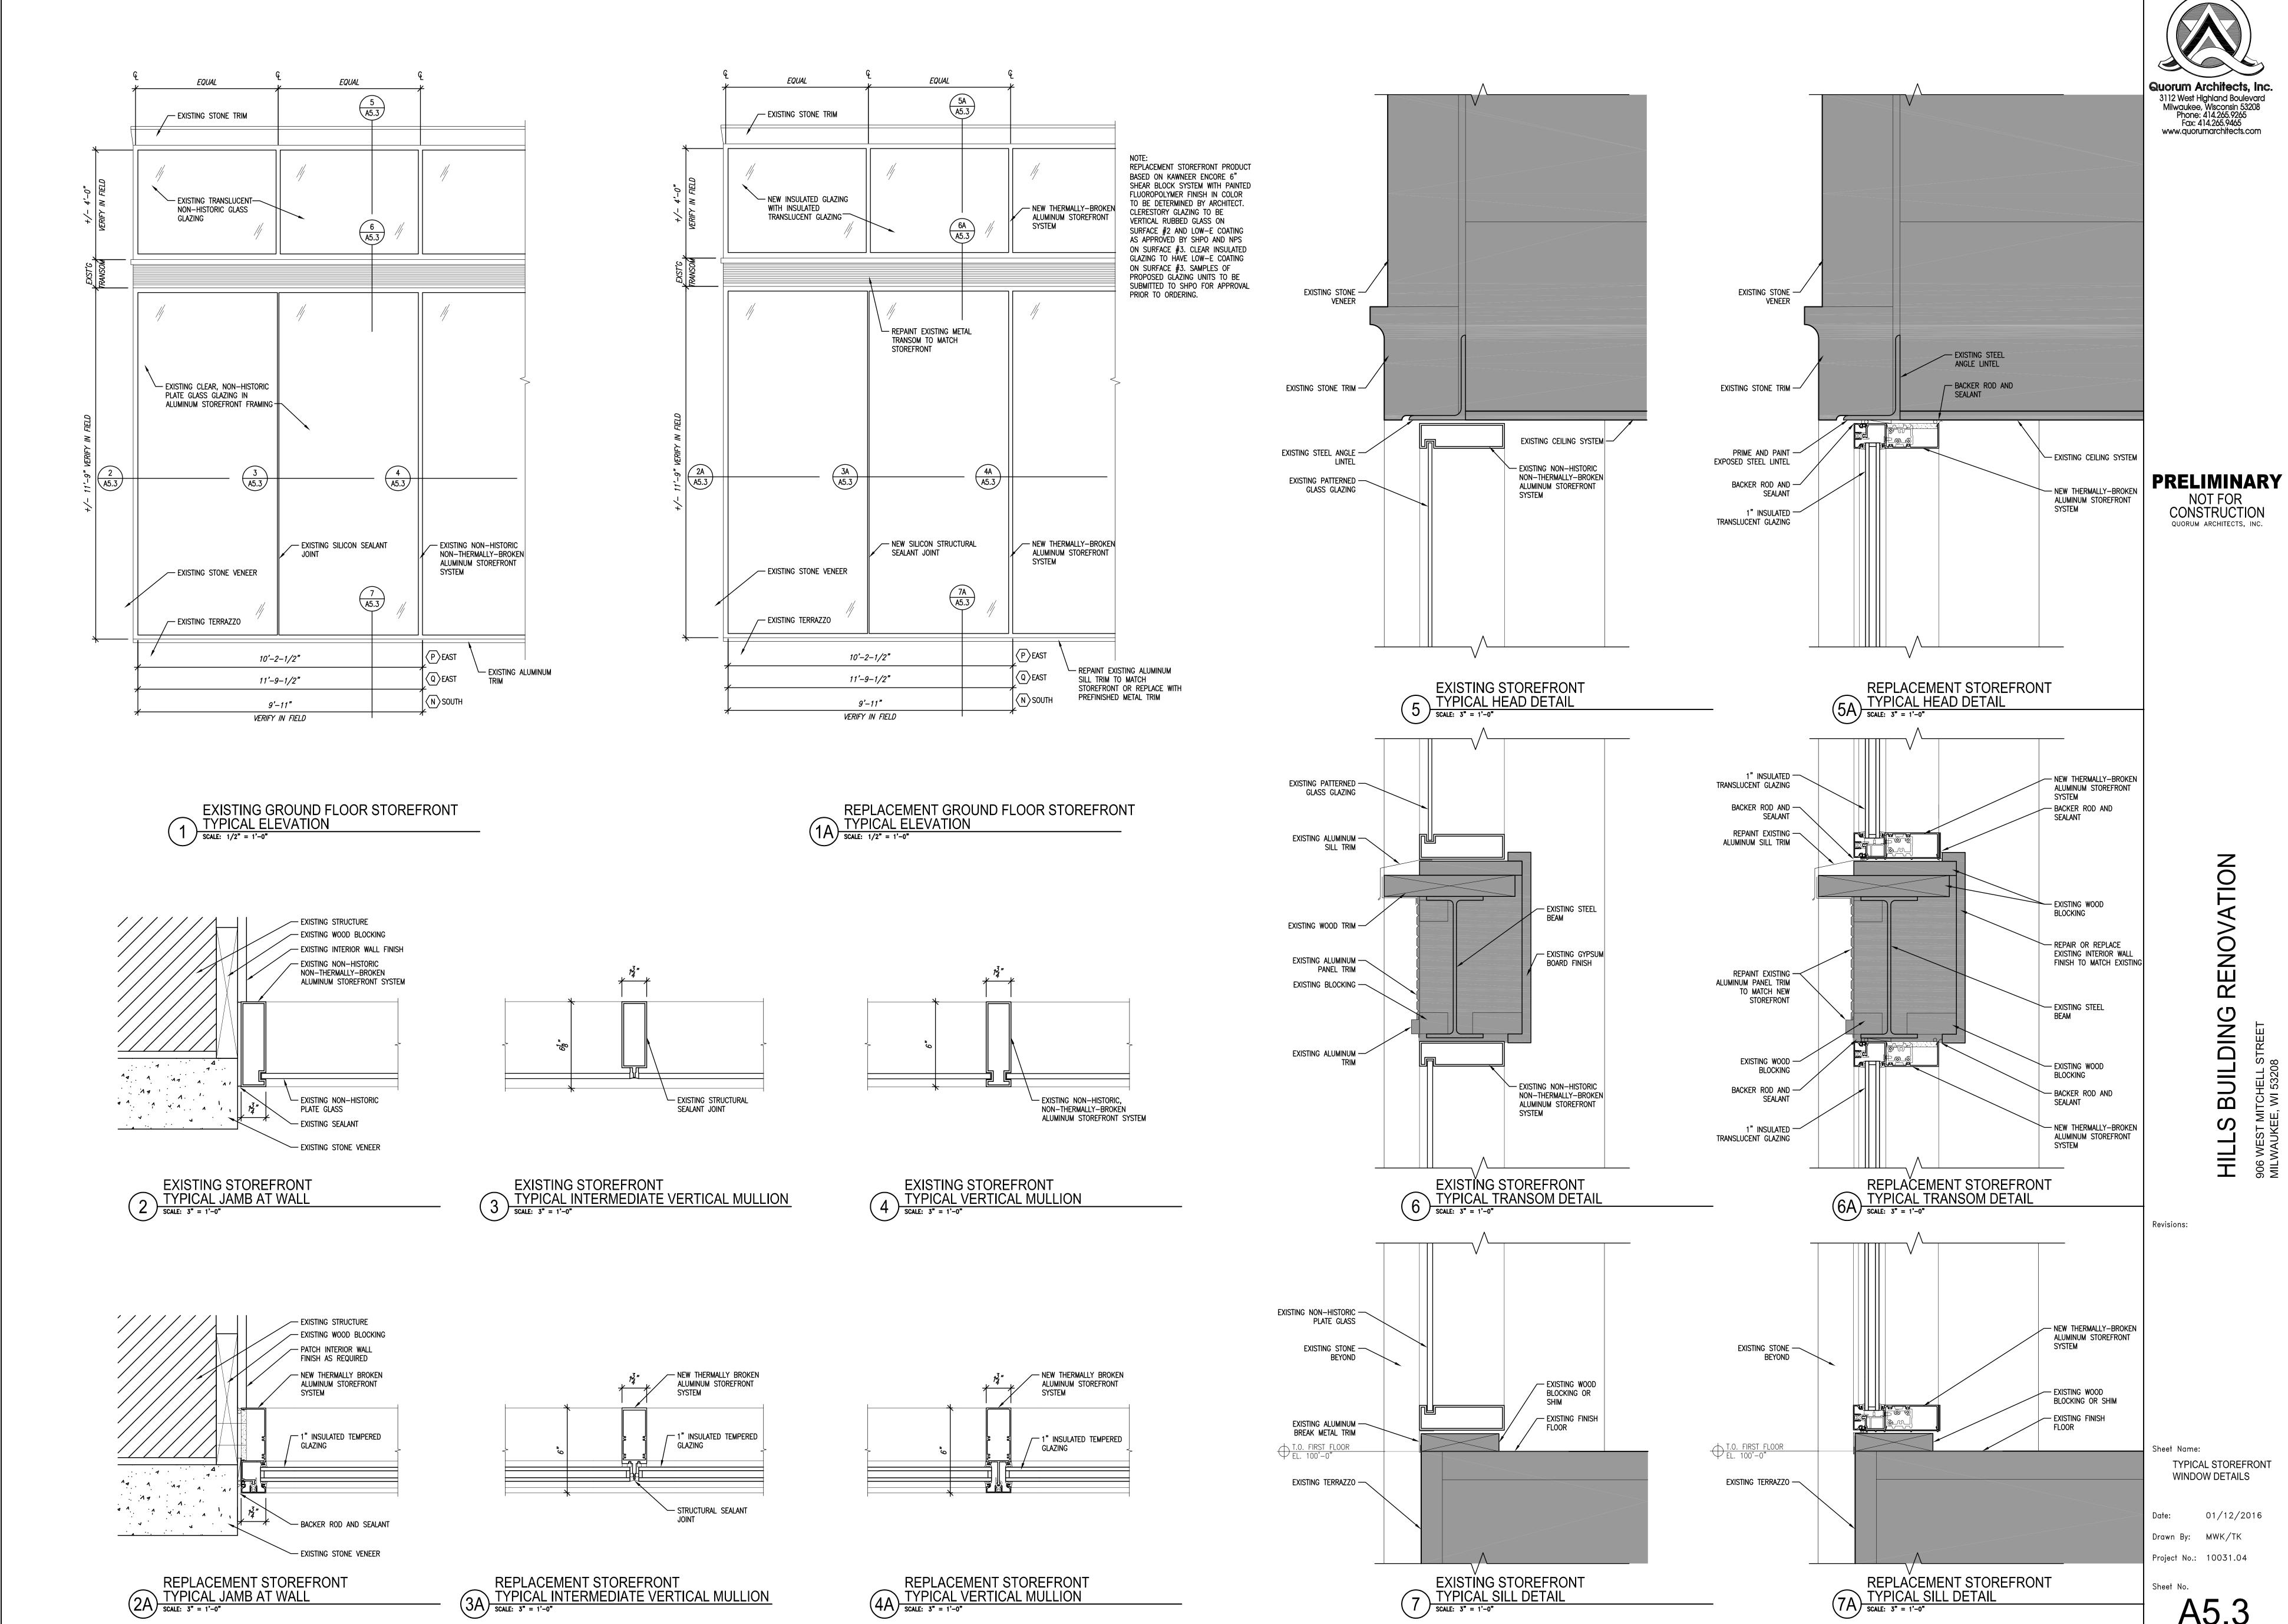
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WINDOW DETAILS

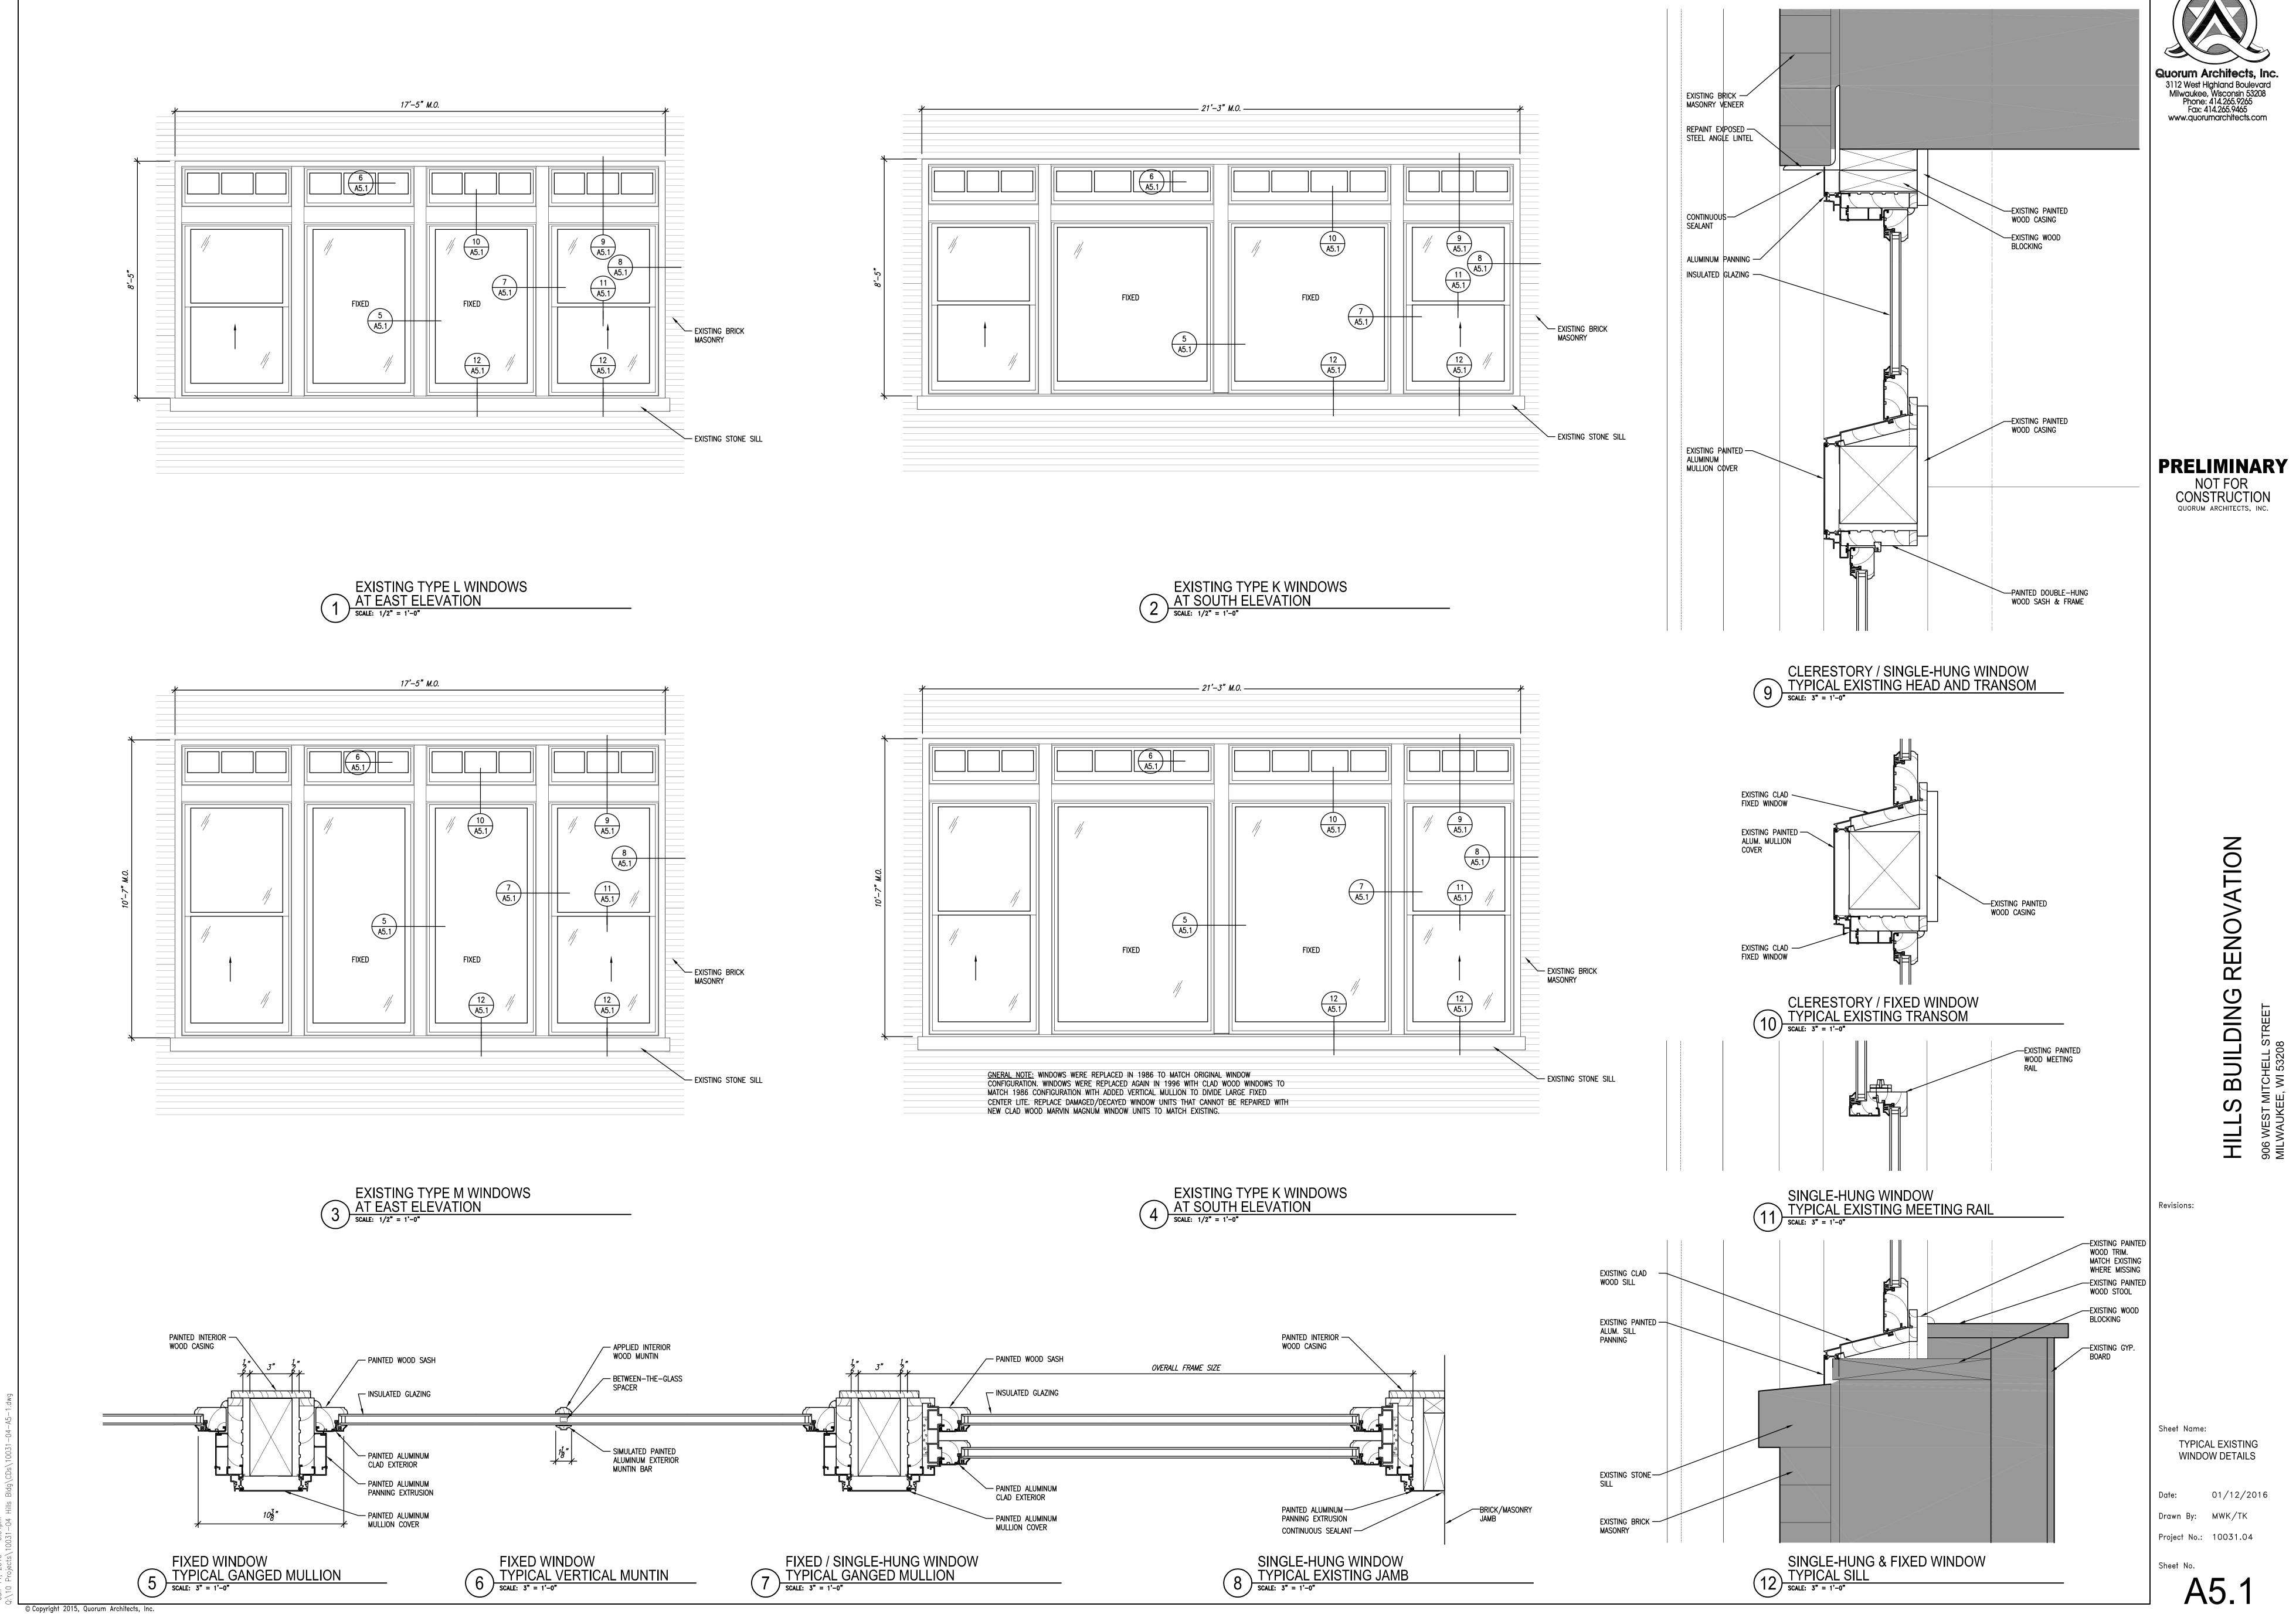Sheet No.

A5.2



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A5.3