

1.	GENERAL NOTES AND SPECIFICATIONS THE EXISTING SITE INFORMATION ON THIS PLAN WAS TAKEN FROM A SITE SURVE PROVIDED BY CAPITOL SURVEY ENTERPRISES. THE ENGINEER MAKES NO WARF
	OR REPRESENTATION WITH REFERENCE TO THE ACCURACY AND COMPLETENES THE EXISTING CONDITIONS INDICATED OR NOT INDICATED ON THE ENGINEERING PLANS PROVIDED. THE CONTRACTOR SHALL VERIFY THE LOCATION OF ALL EXIS SITE CONDITIONS INCLUDING UNDERGROUND UTILITIES, UNDERGROUND UTILITY ELEVATIONS, BUILDING SETBACKS AND EXISTING BUILDING LOCATIONS. THE CONTRACTOR SHALL INFORM THE OWNER AND ENGINEER OF ANY DISCREPANCE PRIOR TO COMMENCING WITH WORK. QUESTIONS REGARDING THE EXISTING SU
2.	SHALL BE DIRECTED TO THE PARTIES LISTED ABOVE. BEFORE PROCEEDING WITH ANY UTILITY CONSTRUCTION, CONTRACTOR SHALL EXCAVATE EACH EXISTING LATERAL TO BE CONNECTED TO (VERIFYING ELEVATI LOCATION AND SIZE). SHOULD THE EXISTING UTILITY NOT BE AS INDICATED ON PLAN, THE ENGINEER SHALL BE NOTIFIED IMMEDIATELY FOR EVALUATION.
3.	ALL UTILITY CONSTRUCTION SHALL ADHERE TO THE STANDARD SPECIFICATIONS SEWER AND WATER CONSTRUCTION IN WISCONSIN (2003), AS WELL AS, THE CITY MILWAUKEE CONSTRUCTION STANDARDS AND THE DEPT. OF COMMERCE SEC. 8
4.	ALL UTILITY PERMITS MUST BE RECEIVED FROM THE CITY OF MILWAUKEE PRIOR THE START OF CONSTRUCTION.
5.	NOTIFY THE PUBLIC WORKS INSPECTION DEPT. AT LEAST 48 HOURS BEFORE STACONSTRUCTION.
6.	BACKFILL REQUIREMENTS AND ROADWAY/SIDEWALK RESTORATION SHALL ADHE LOCAL STANDARDS (GRANULAR BACKFILL UNDER OR WITHIN 5' OF CURBS, SIDE OR PAVEMENT. SPOIL MAY BE USED ELSEWHERE. SLURRY BACKFILL WILL BE REQUIRED IN PUBLIC ROADWAYS.)
7.	ALL BUILDING UTILITIES SHALL BE VERIFIED WITH THE ARCHITECTURAL PLANS P TO CONSTRUCTION.
8.	ALL PROPOSED WATERMAIN SHALL BE PVC SDR 18, CLASS 150, AWWA C900 WIT ELASTOMERIC JOINTS.
9.	PROPOSED SANITARY SEWER PIPE SHALL BE PVC, ASTM D-3034, SDR 35 WITH RUGASKETED JOINTS CONFORMING TO ASTM D-3212.
10.	PROPOSED STORM SEWER SHALL BE PVC, ASTM D-3034, SDR 35 WITH RUBBER ELASTOMERIC JOINTS CONFORMING TO ASTM D-3212 (UNLESS OTHERWISE NOT
11.	UTILITY TRENCHES SHALL BE MECHANICALLY COMPACTED IN ACCORDANCE WIT STANDARD SPECIFICATIONS FOR SEWER AND WATER CONSTRUCTION IN WISCO
12.	SILT FENCE AND ALL OTHER EROSION CONTROL METHODS MUST BE INSTALLED TO COMMENCEMENT OF CONSTRUCTION. ALSO, CONTRACTOR IS RESPONSIBLE REMOVING EROSION CONTROL METHODS ONCE THE SITE IS STABILIZED.
13.	THE PROPOSED SITE LOCATION AND SURROUNDING STREETS MUST BE KEPT DE FREE. SWEEP STREETS AS NEEDED TO MAINTAIN CLEAN STREETS.
14.	ALL EXCAVATED OR STRIPPED MATERIALS NOT BEING REPLACED IN UTILITY TRE OR BEING USED FOR FILL SHALL BE REMOVED FROM THE SITE, UNLESS OTHERW DIRECTED BY THE OWNER.
15.	ALL DISTURBED GRASS AREAS SHALL BE STABILIZED (PER DNR TECHNICAL STANDARDS) WITHIN 7 DAYS OF COMPLETION. DISTURBED GRASS AREAS SHALL TOPSOILED (6"), RESEEDED AND STABILIZED. AREAS WITH A SLOPE OF 3H:1V OF STEEPER SHALL BE COVERED WITH A CLASS 1 - TYPE A EROSION FABRIC. (SEE SPECIFICATIONS)
16.	SEE ARCHITECTURAL PLANS FOR EXACT BUILDING & FOUNDATION DETAILS AND ORIENTATION.
17.	ALL ON-SITE CONCRETE CURB AND GUTTER TO BE 18" WIDE VERTICAL FACE, UN OTHERWISE NOTED. REVERSE OR REGULAR STYLE CURB DENOTED ON PLANS.
18.	ALL CURB ELEVATIONS ARE EDGE OF PAVEMENT UNLESS OTHERWISE NOTED. S CURB DETAIL FOR TOP OF CURB ELEVATIONS.
	ALL CURB RADII ARE MEASURED TO THE FACE OF CURB UNLESS OTHERWISE NO
	CONTRACTOR SHALL MATCH PROPOSED CONCRETE CURB AND GUTTER, SIDEW. AND PAVEMENT TO EXISTING IN ELEVATION AND ALIGNMENT.
	REMOVAL OF CURB AND GUTTER, SIDEWALK AND PAVEMENT SHALL BE IN ACCORDANCE WITH THE STANDARD SPECIFICATIONS OF THE WISCONSIN D.O.T.
22.	ALL CONCRETE FOR CURB AND GUTTER, ROADWAY AND SIDEWALKS MUST CON TO THE STANDARD SPECIFICATIONS FOR READY MIXED CONCRETE. MINIMUM 28 COMPRESSIVE STRENGTH TEST MUST EQUAL 4000 PSI.
	CONTRACTOR IS RESPONSIBLE FOR PROTECTING ALL PROPERTY CORNERS.
24.	CONTRACTOR IS RESPONSIBLE FOR REPAIRING ANY DAMAGE TO EXISTING UTILI OR SITE IMPROVEMENTS. CONTRACTOR SHALL DOCUMENT ALL EXISTING DAMA PRIOR TO START OF CONSTRUCTION AND NOTIFY CONSTRUCTION MANAGER OF FINDINGS.
25.	PROJECT SAFETY ON-SITE SHALL BE THE SOLE RESPONSIBILITY OF THE CONTRA
26.	CONTRACTOR IS RESPONSIBLE FOR VERIFYING EXISTING SOIL CONDITIONS, CONSTRUCTION MANAGER MAY HAVE SOILS REPORT FOR MORE INFO.
27.	CONTRACTOR IS RESPONSIBLE FOR PROVIDING THE OWNER WITH A SET OF MANUP PLANS (AS-BUILTS) SHOWING ANY CHANGES DURING CONSTRUCTION.

EXISTING WATER MAIN
PROPOSED WATER SERVICE
EXISTING ELECTRICAL LINE
PROPOSED ELECTRICAL LINE
EXISTING GAS MAIN
PROPOSED GAS MAIN
EXISTING SANITARY SEWER
PROPOSED SANITARY SEWER
EXISTING STORM SEWER
PROPOSED STORM SEWER
OVERHEAD WIRES
EXISTING POWER POLES
EXISTING LIGHT POLES
SANITARY MANHOLE
FIRE HYDRANT
EXISTING WATER VALVE
PROPOSED WATER VALVE
EXISTING STORM STRUCTURE
PROPOSED STORM STRUCTURE
DENOTES EMERGENCY OVERFLOW ROUTE / DRAINAGE PATH
PROPOSED & EXISTING SPOT GRADE
1

4 44 PROPOSED REGULAR DUTY ASPHALT PAVEMENT PROPOSED HEAVY DUTY ASPHALT PAVEMENT PROPOSED DEPRESSED CURB PROPOSED TAPER CURB PROPOSED REVERSE CURB



IN ACCORDANCE WITH WISCONSIN STATUTE 182.0175, DAMAGE TO TRANSMISSION FACILITIES, EXCAVATOR SHALL BE SOLELY RESPONSIBLE TO PROVIDE ADVANCE NOTICE TO THE DESIGNATED "ONE CALL SYSTEM" NOT LESS THAN THREE WORKING DAYS PRIOR TO COMMENCEMENT OF ANY EXCAVATION REQUIRED TO PERFORM WORK CONTAINED ON THESE DRAWINGS, AND FURTHER, EXCAVATOR SHALL COMPLY WITH ALL OTHER REQUIREMENTS OF THIS STATUTE RELATIVE TO EXCAVATOR'S WORK.

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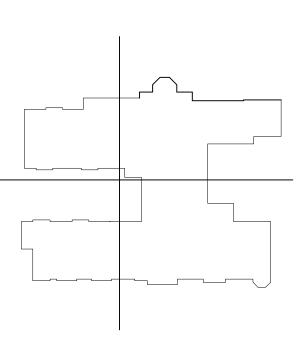
HARWOOD ENGINEERING CONSULTANTS, LTI

255 North 21st Street, Milwaukee Wisconsin 53233 414.475.5554 414.773.9299 fax harwood@hecl.com HEC Project Number: 12-0054.00

ST ANN CENTER FOR INTERGENERATIONAL CARE

Location: 25th St. and North Ave Milwaukee, WI

Key Plan:



Sheet: Site Plan

North

Scale: SCALE: 1" = 30'

North \bigcirc

No.	Date:	Description:
\bigwedge	04/08/14	BID PACKAGE #1 - ADD #1
$\sqrt{2}$	08/25/14	BID PACKAGE #1 - ADD #2
	09/17/14	BID PACKAGE #2

Date: March 31, 2014 Project No

120054.00 Sheet No .:


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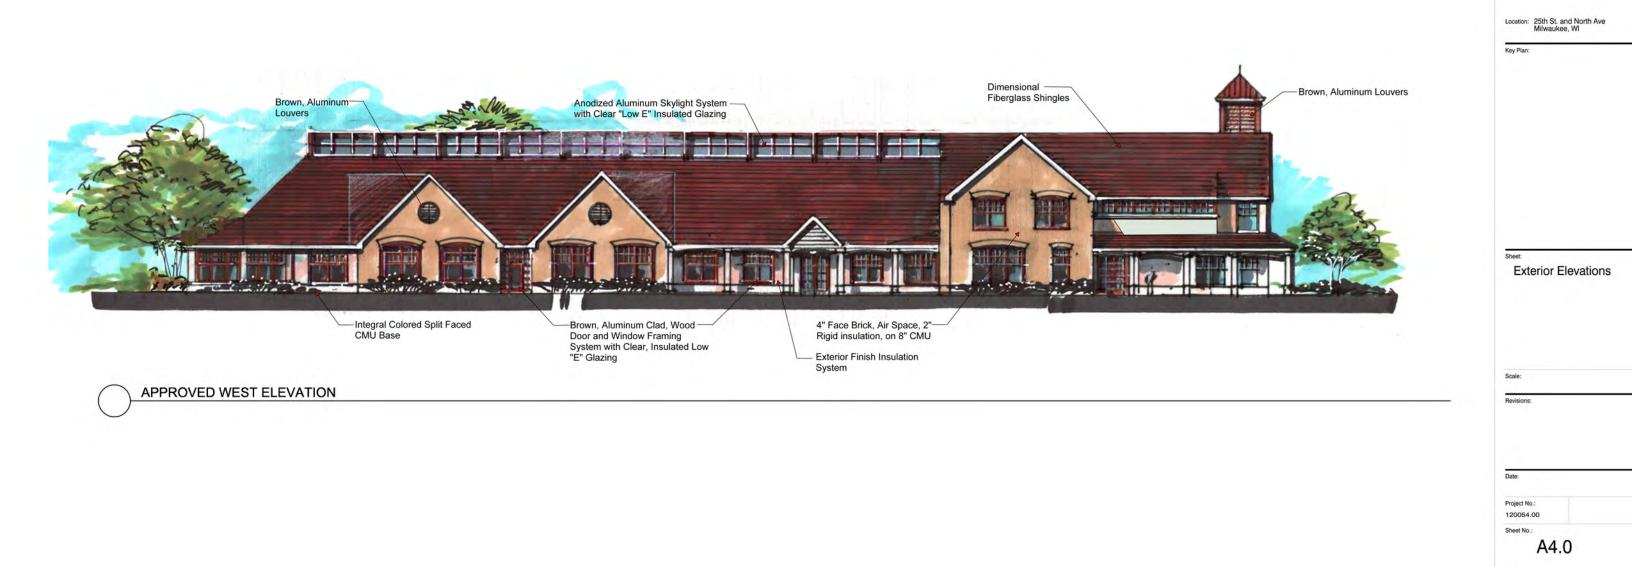
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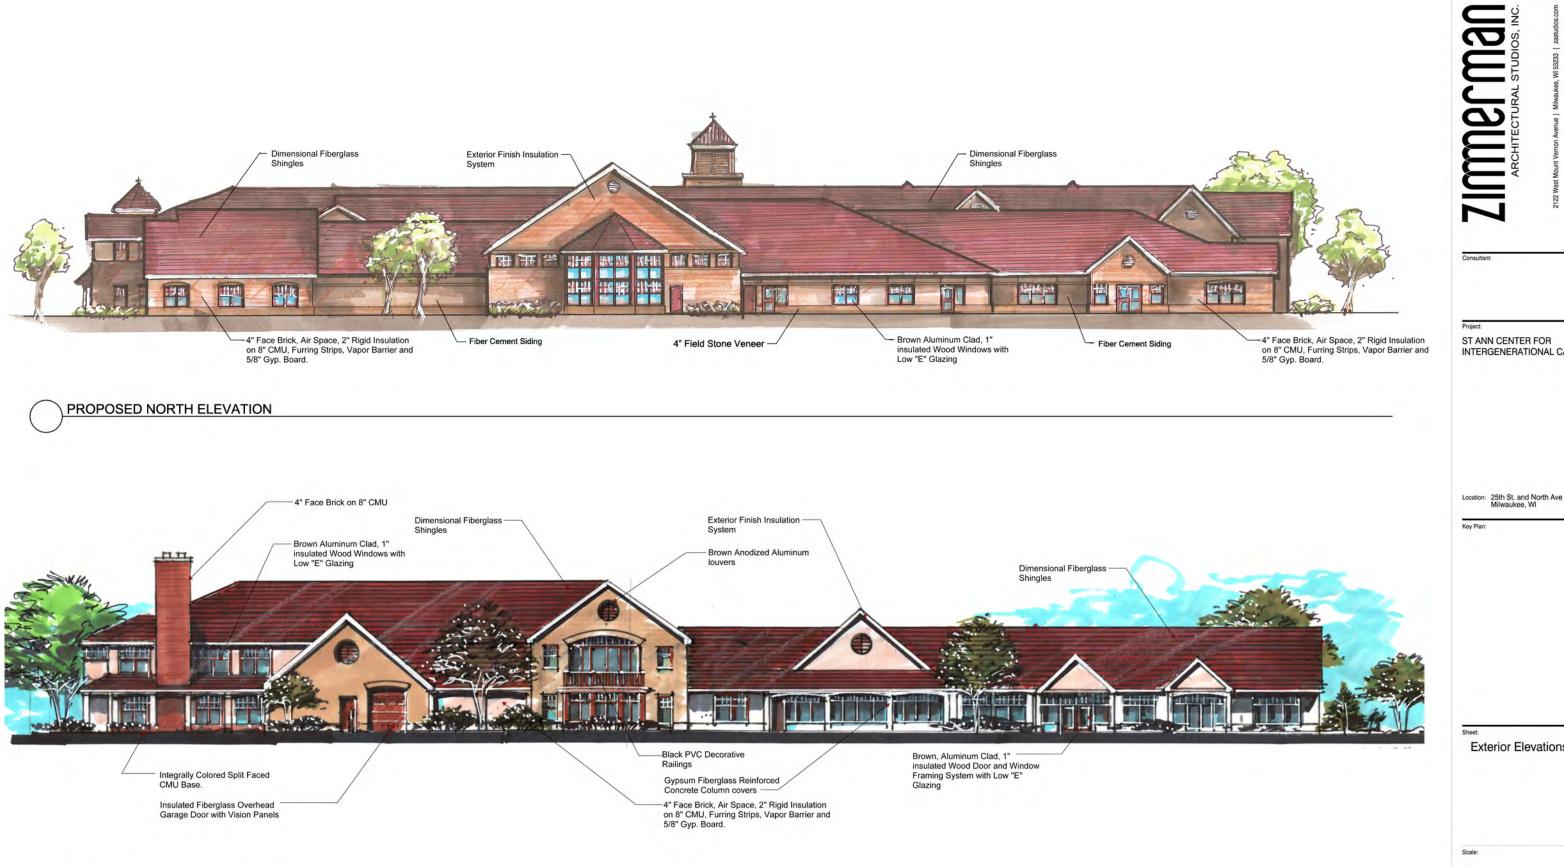
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nensional erglass Shingles	Location: 25th St. and North Ave Milwaukee, WI Key Plan:
	Sheet: Exterior Elevations
	Scale: Revisions:
	Date: Project No.: 120054.00 Sheet No.: A4.0







Project: ST ANN CENTER FOR INTERGENERATIONAL CARE

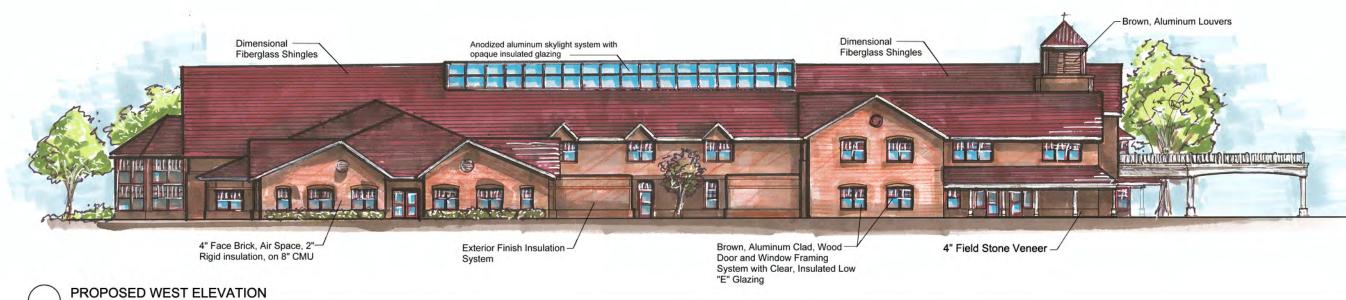

APPROVED NORTH ELEVATION

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INTERGENERATIONAL CARE

Exterior Elevations

Date: Project No.: 120054.00 Sheet No. A4.0

Revisions:

