







0' 75' 150' 300' 450'

**VICINITY MAP**Scale: 1" = 300'-0"
<sub>5/19/14</sub>

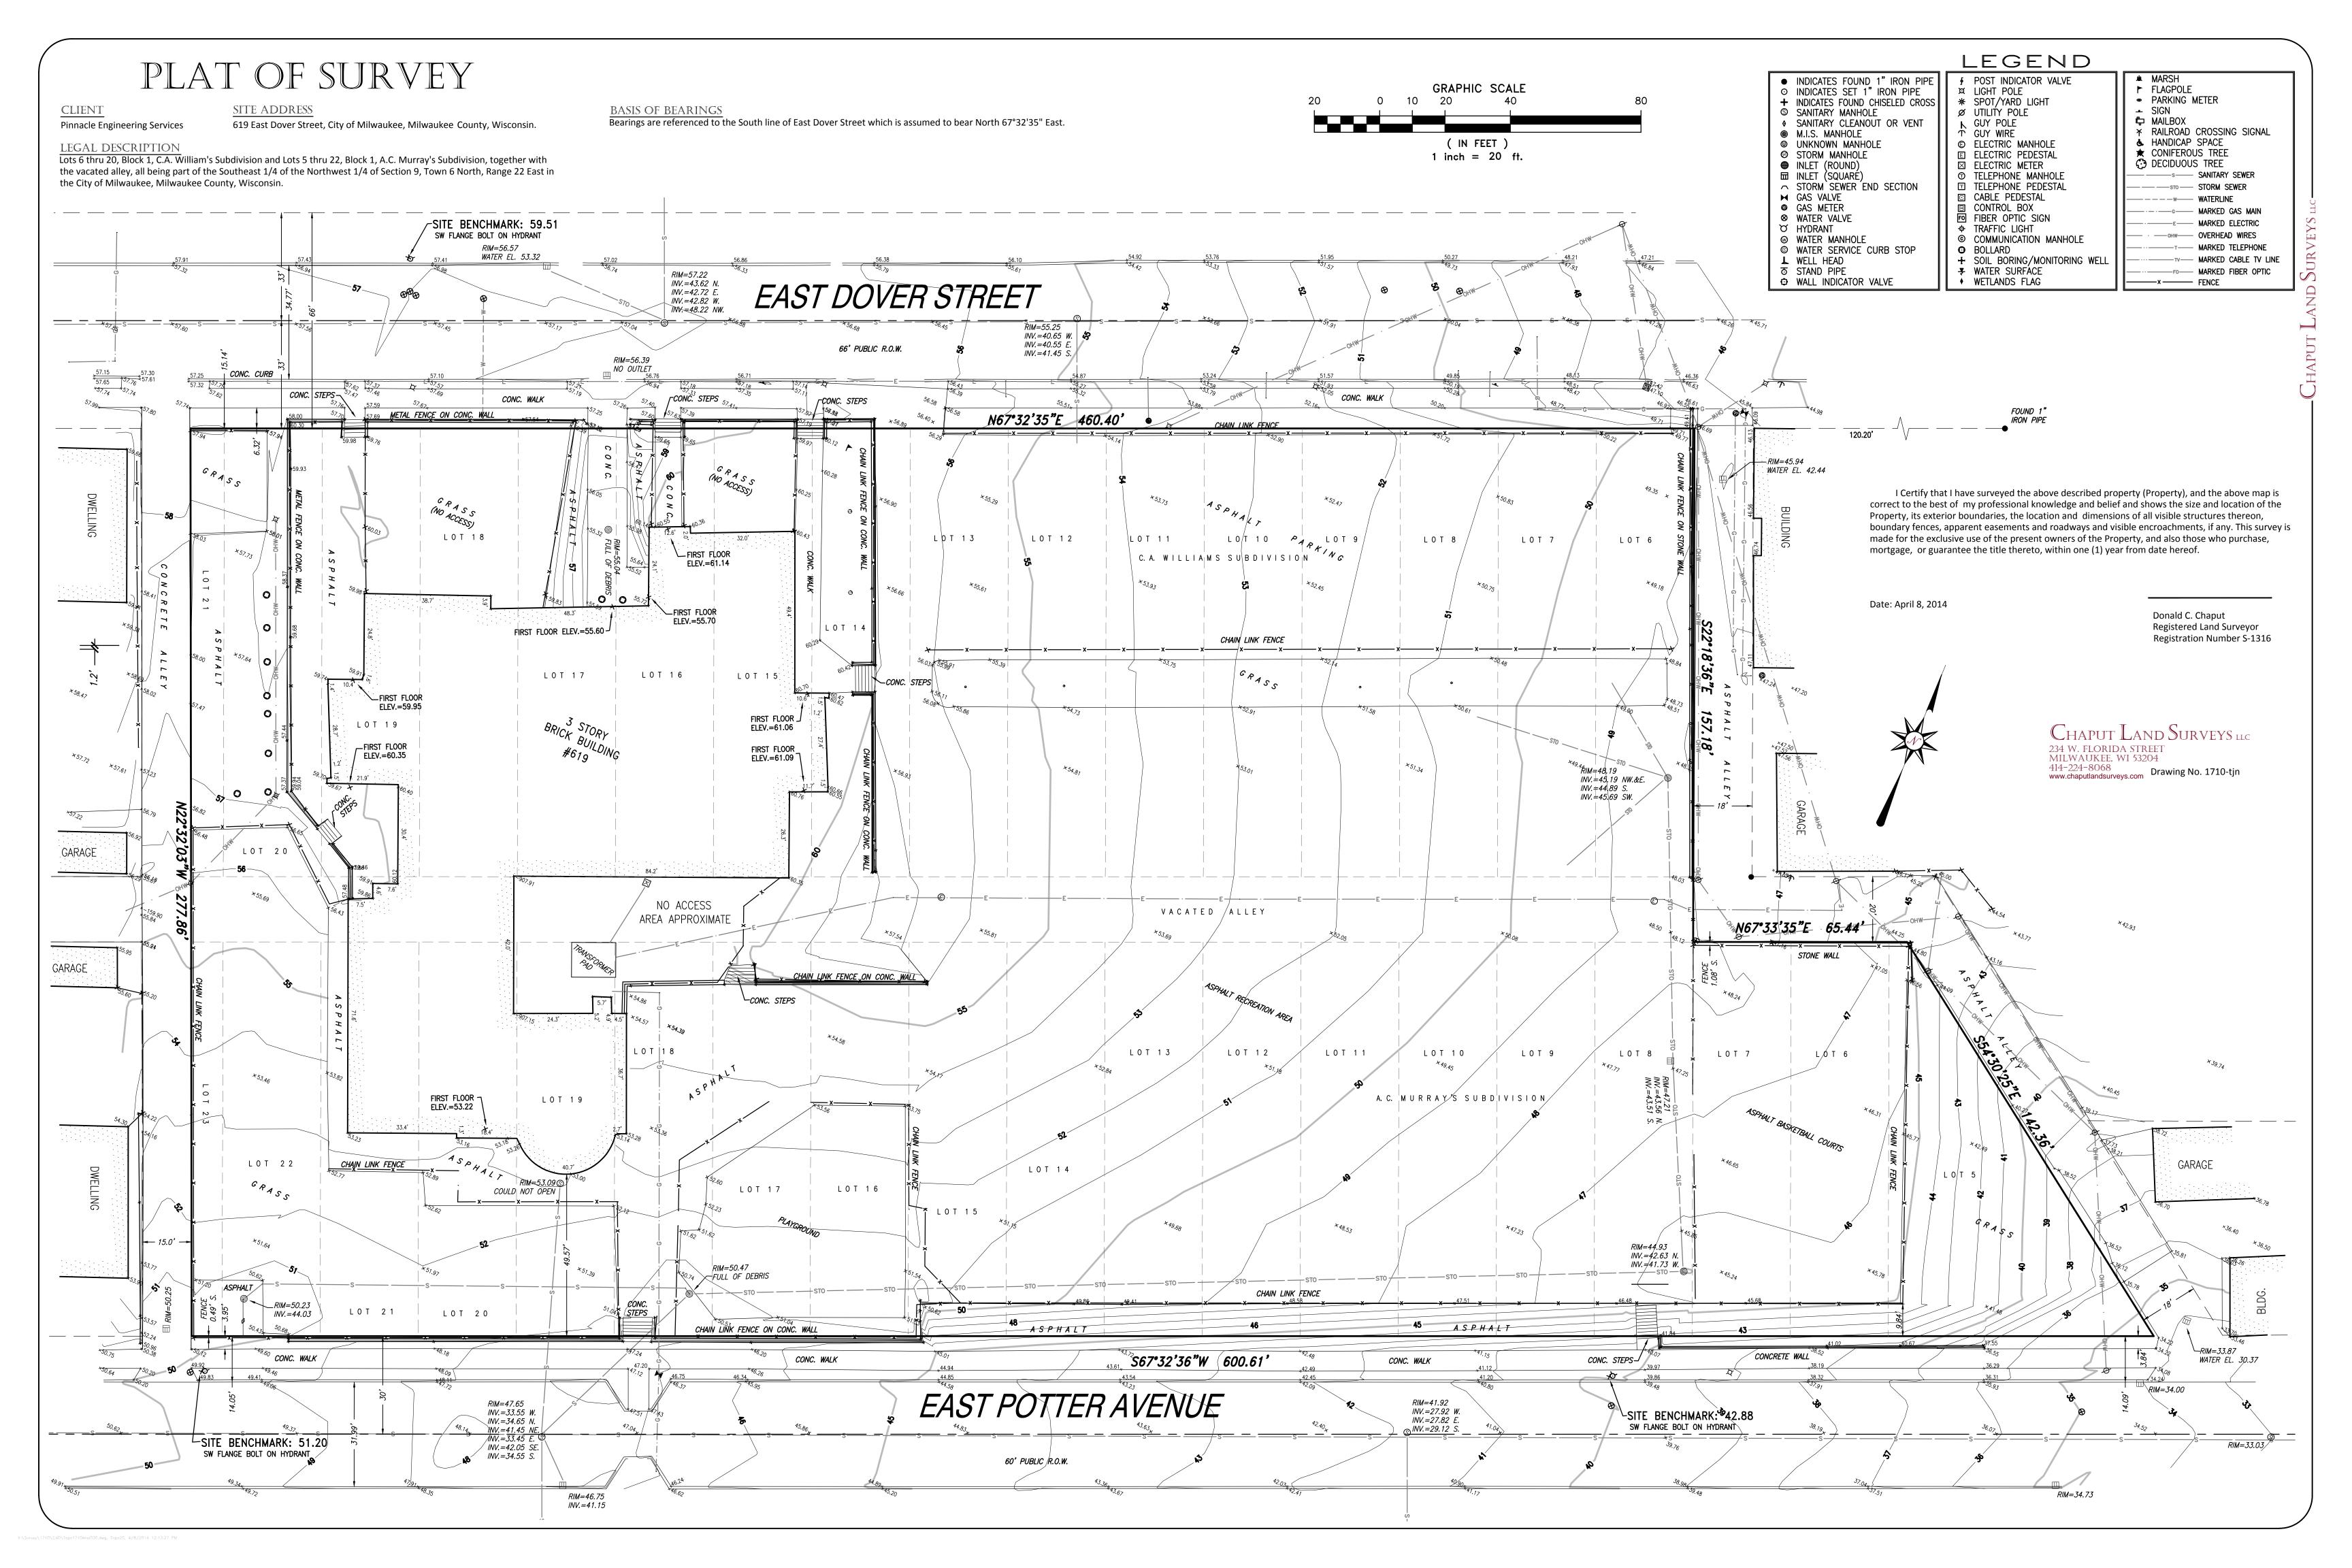


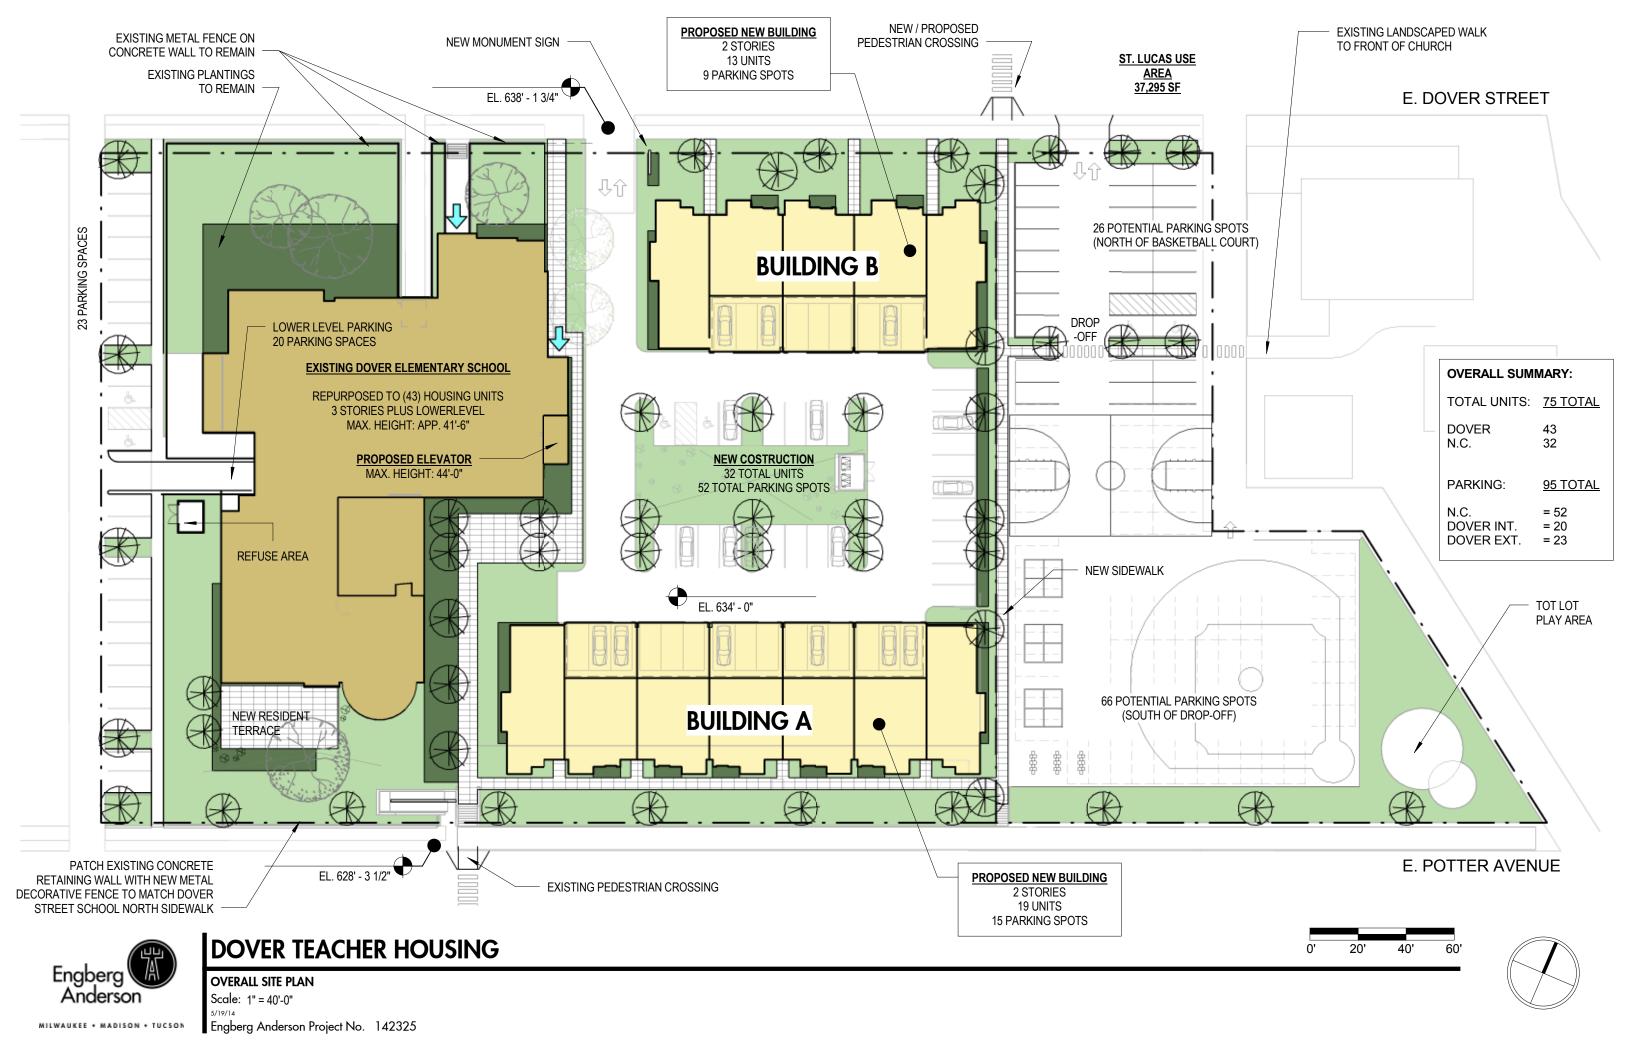

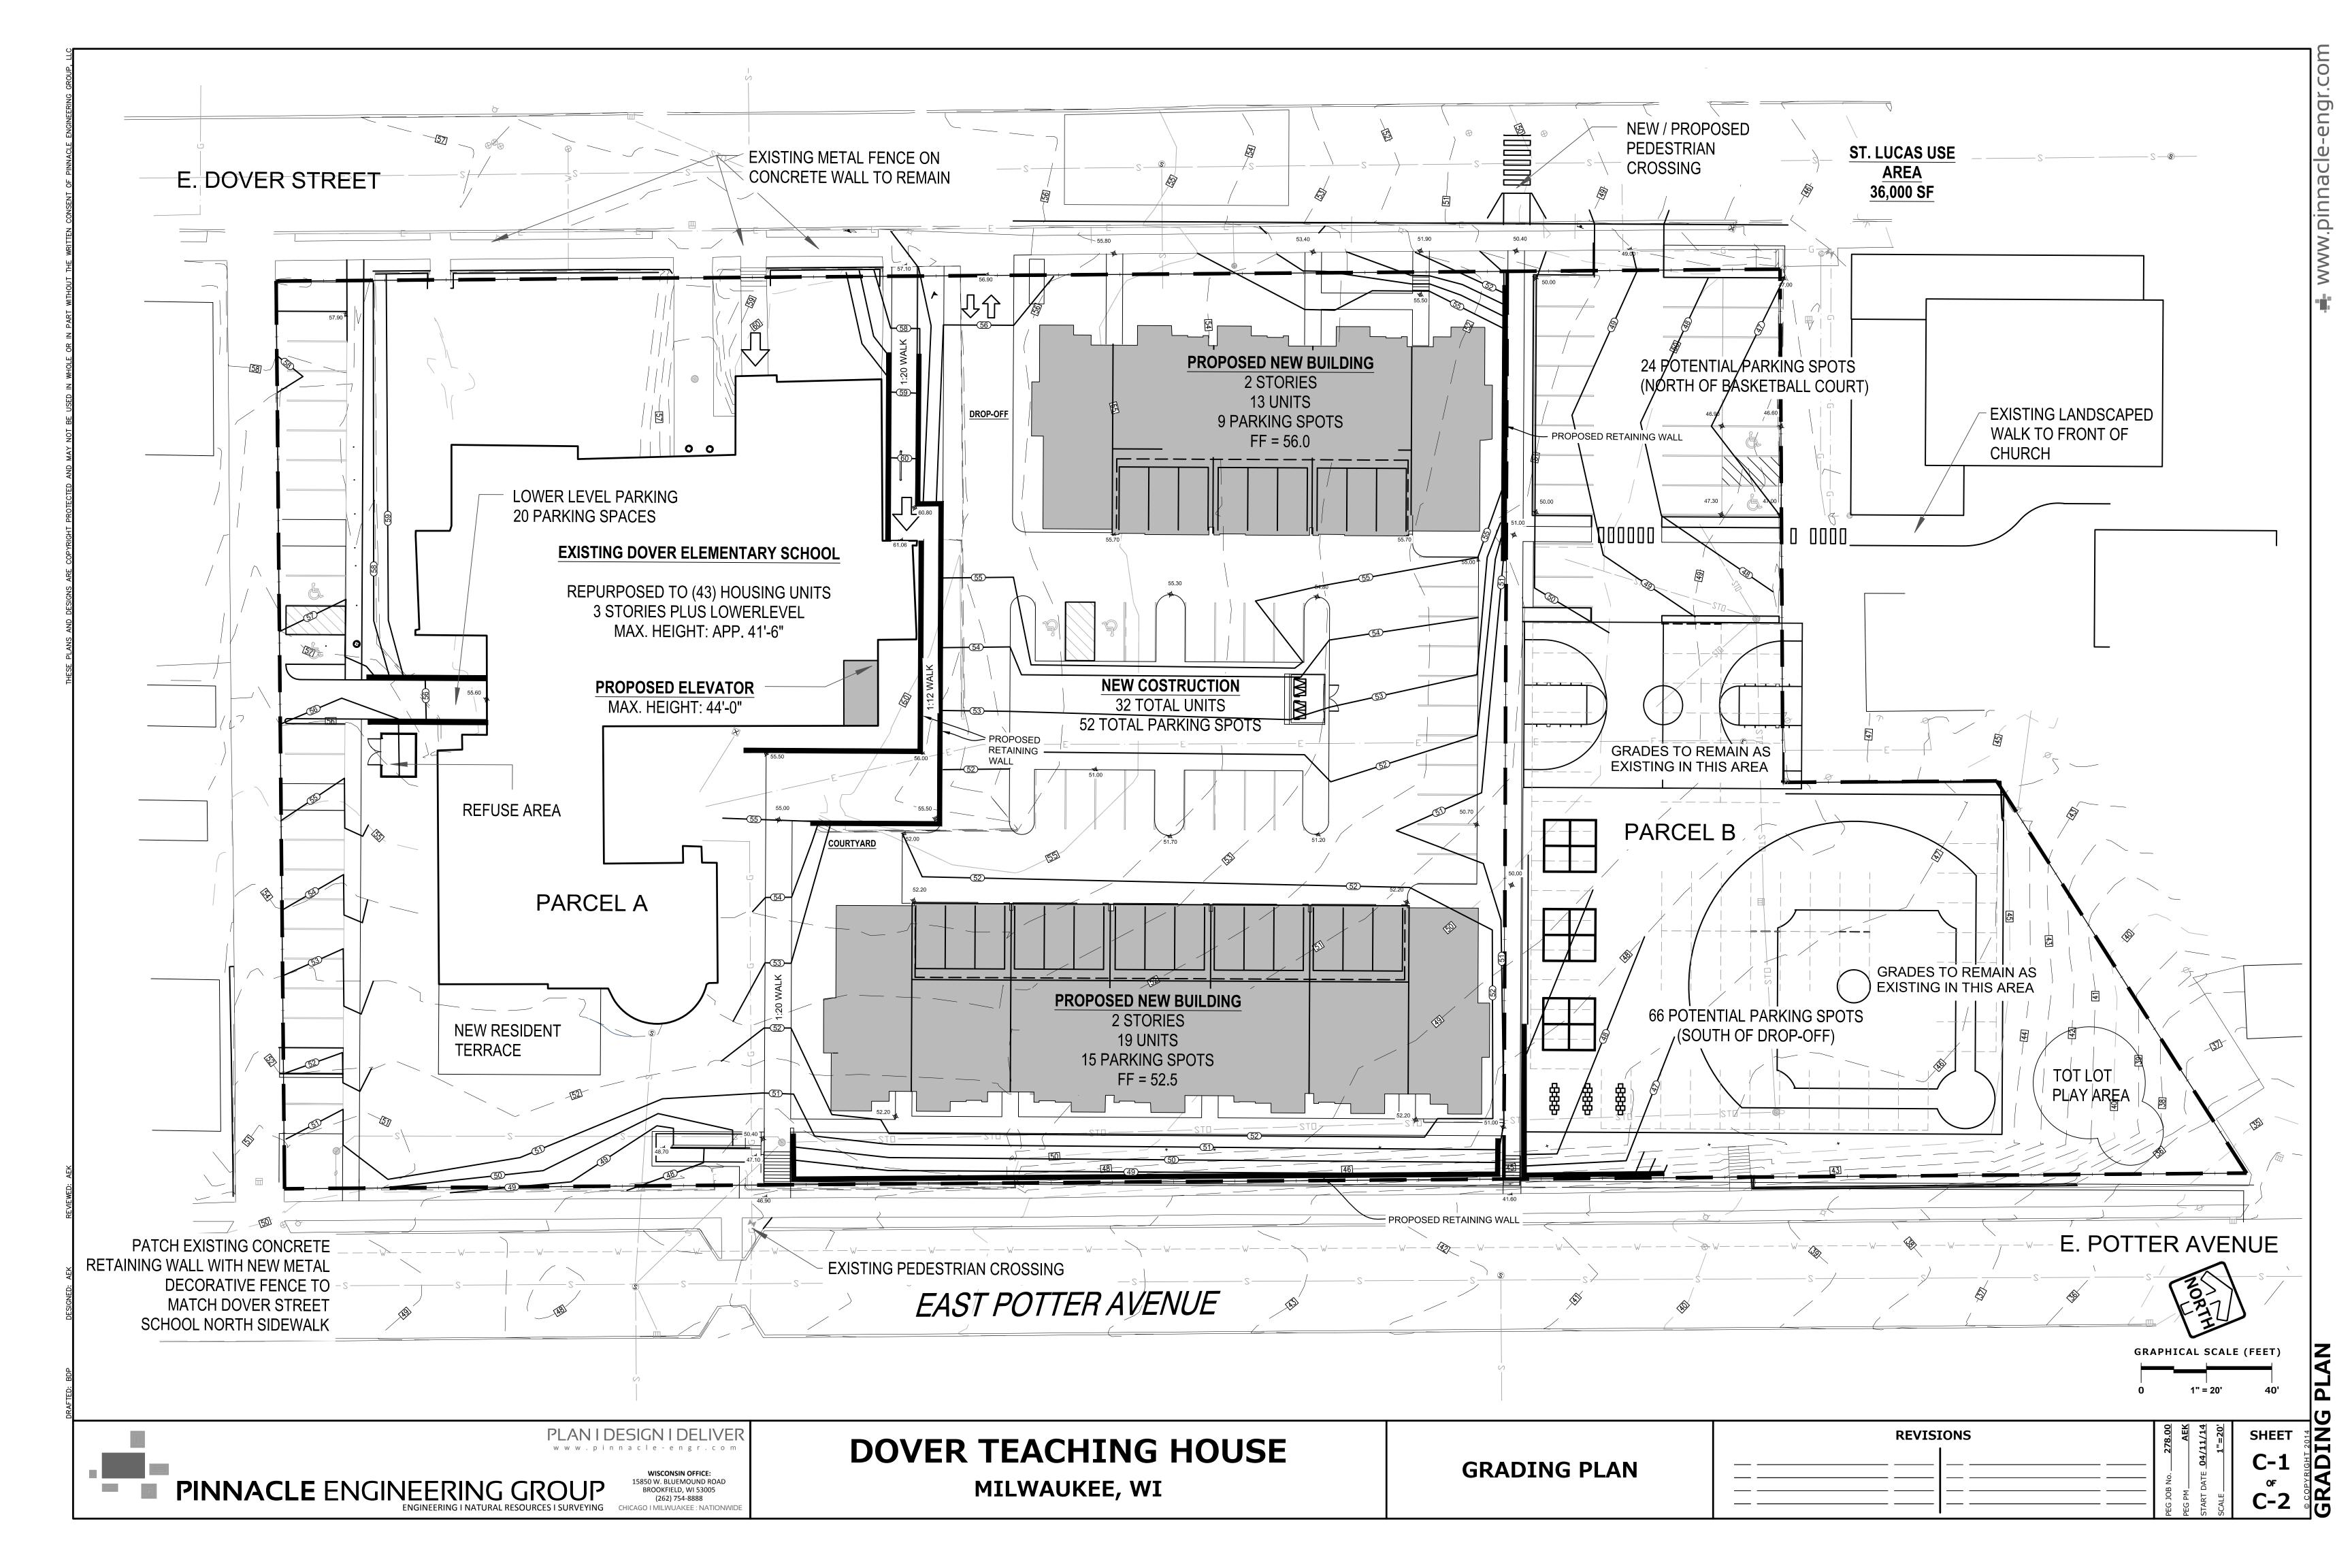


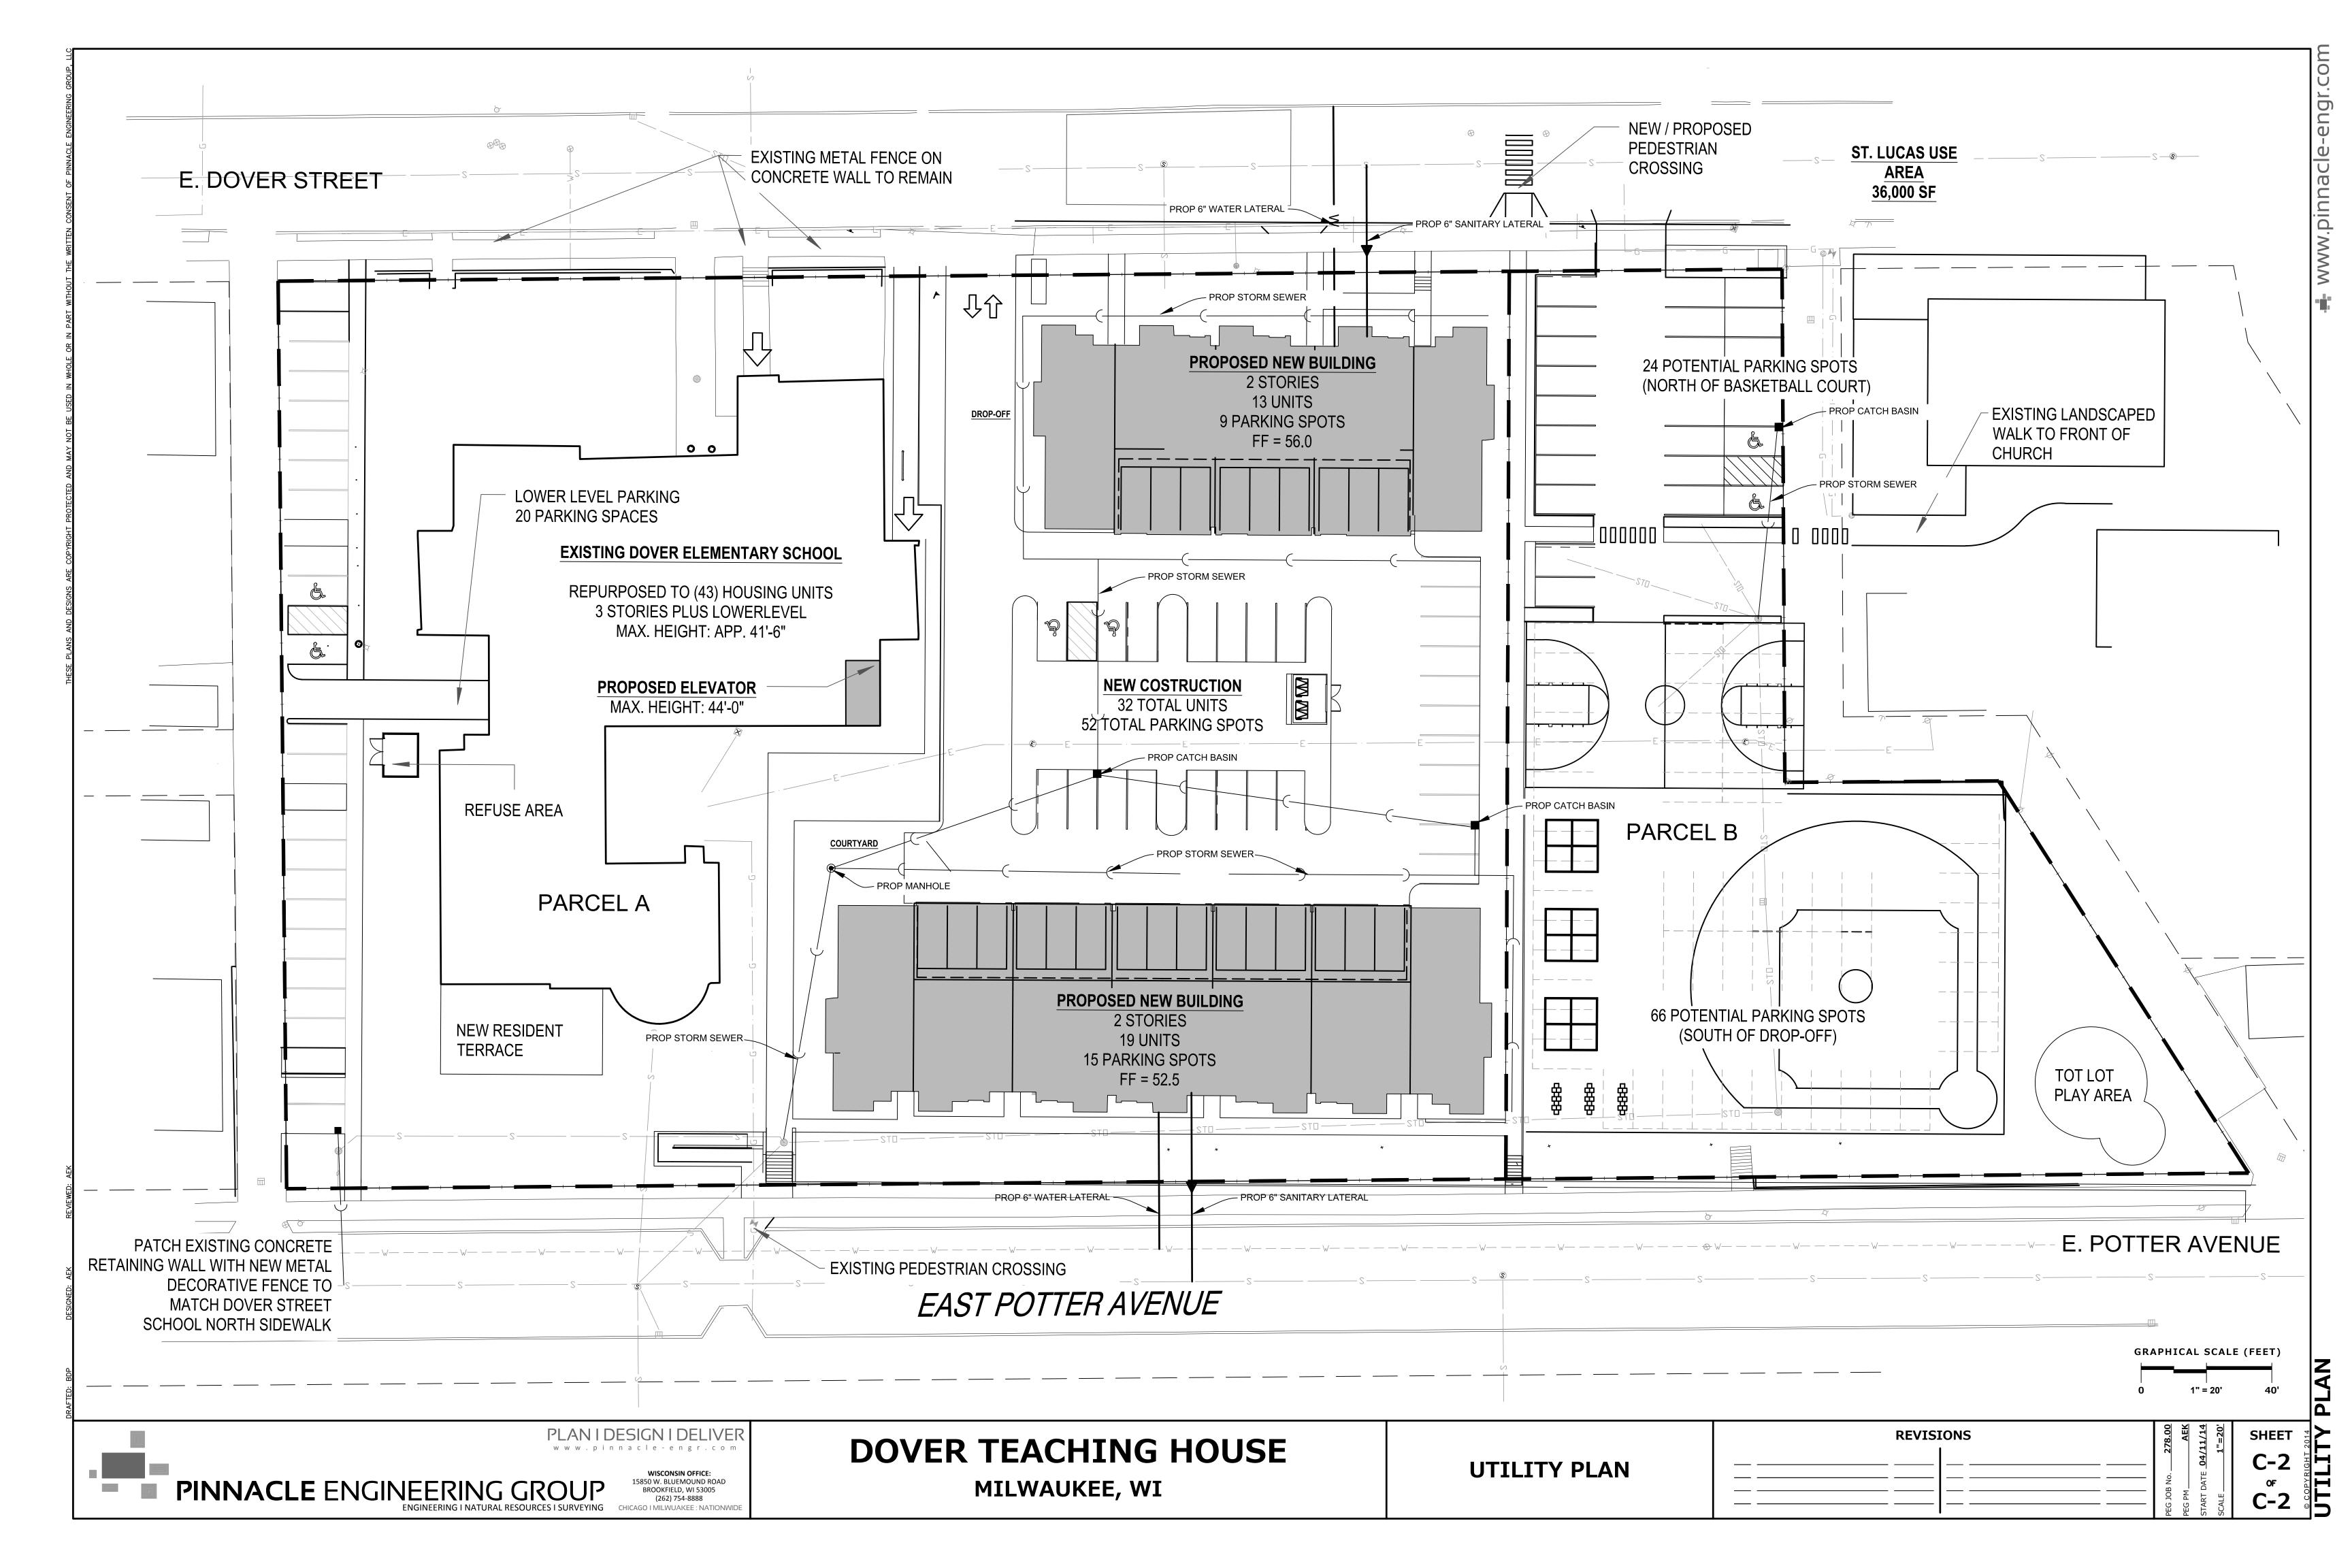




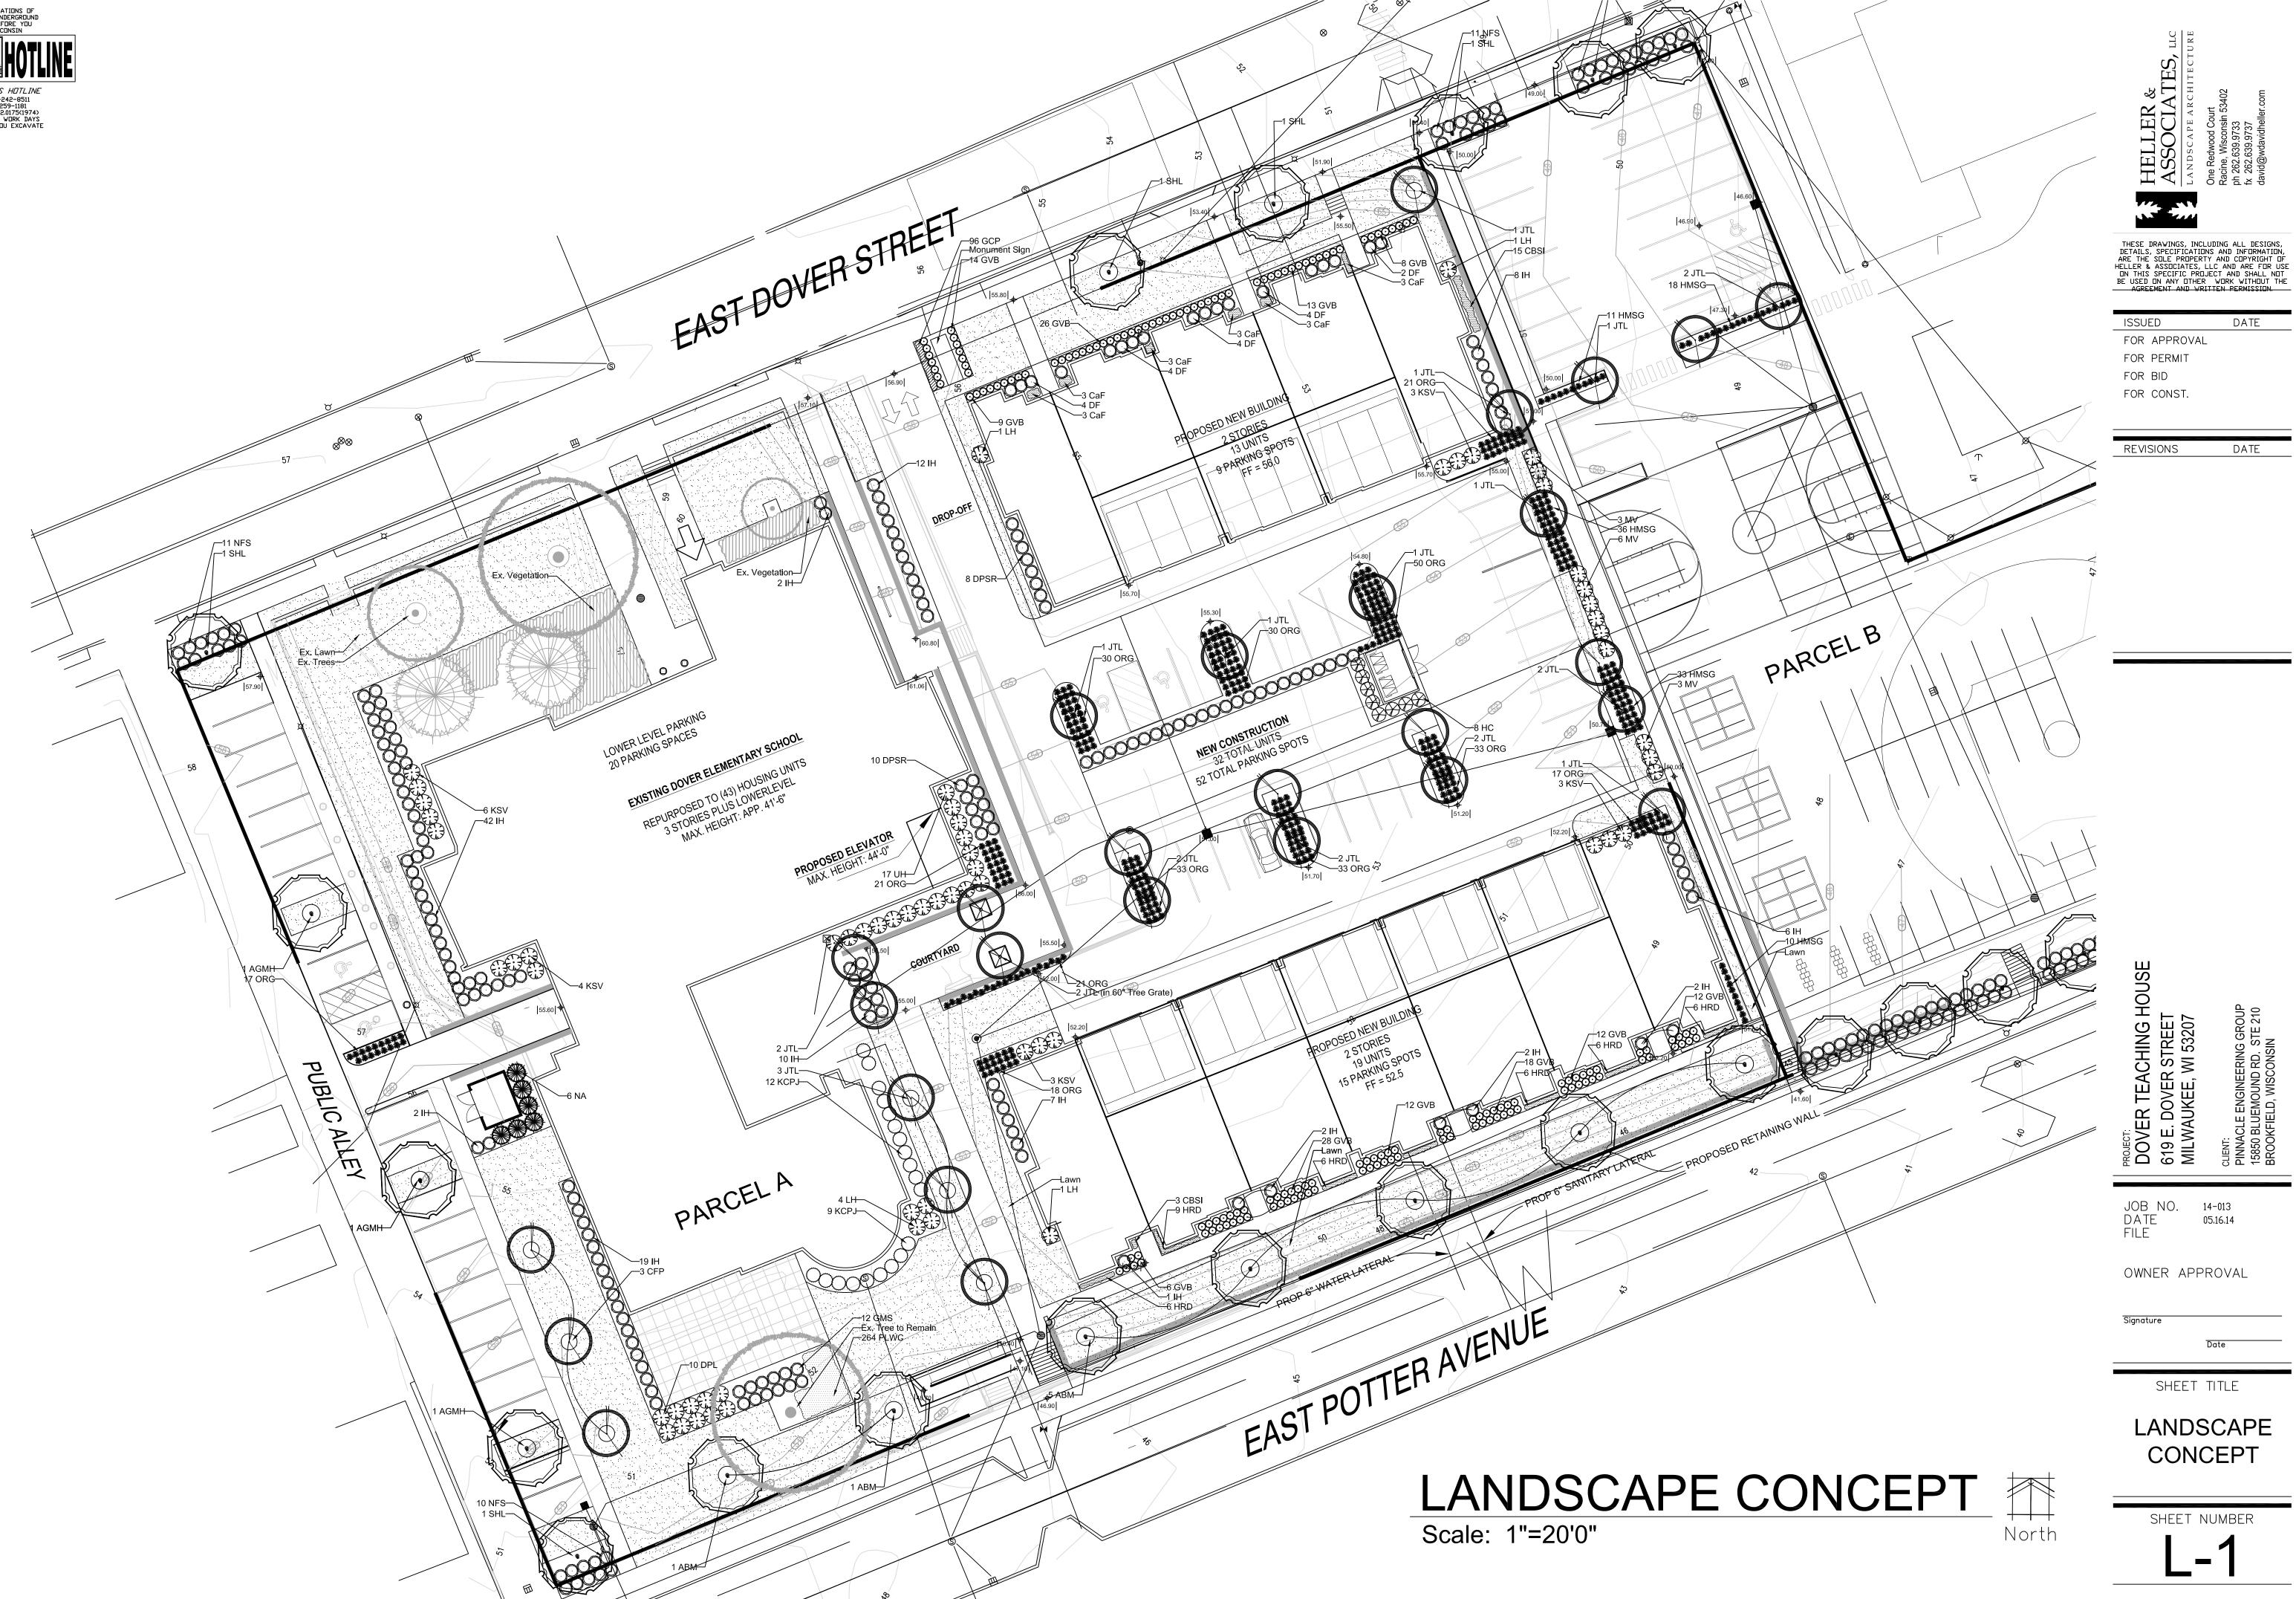




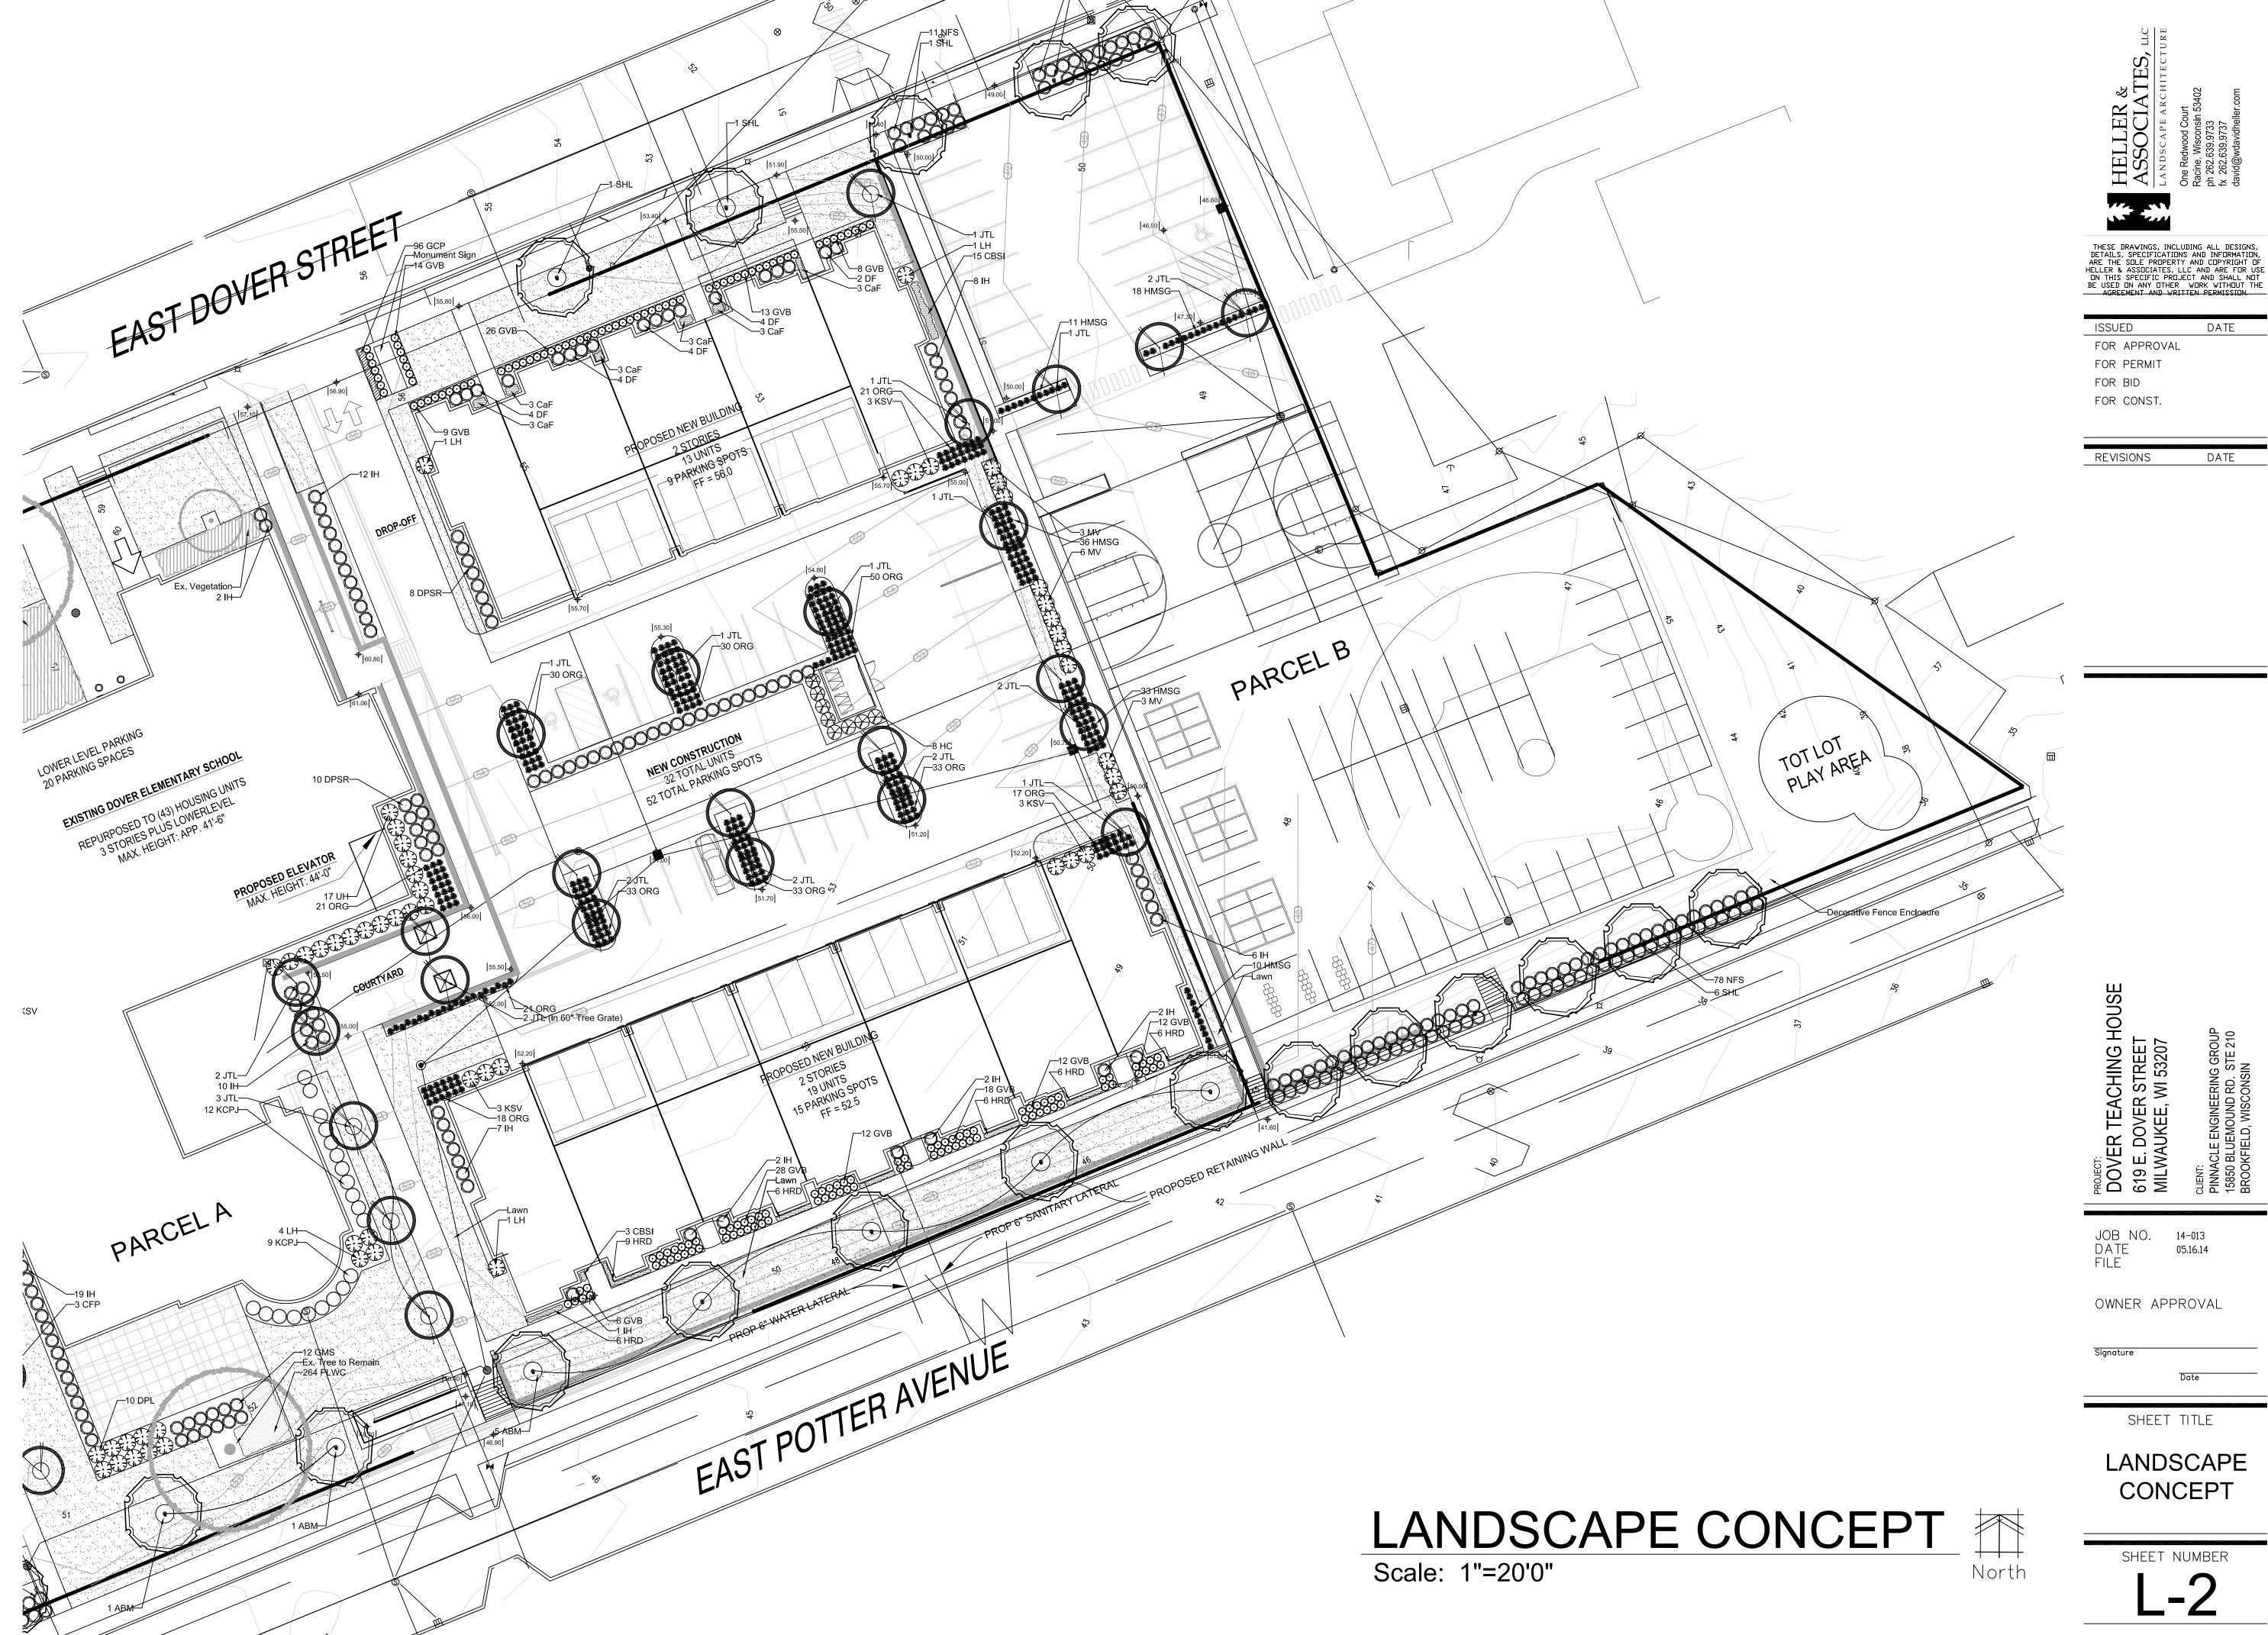





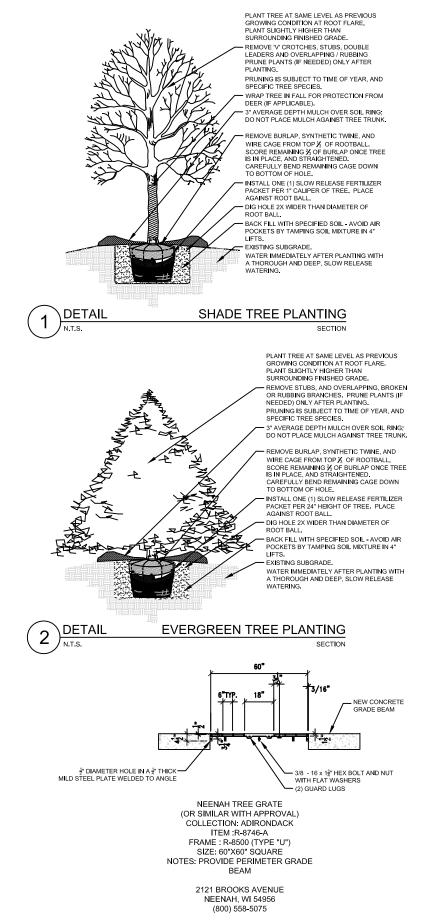


TREE GRATE INSTALLATION

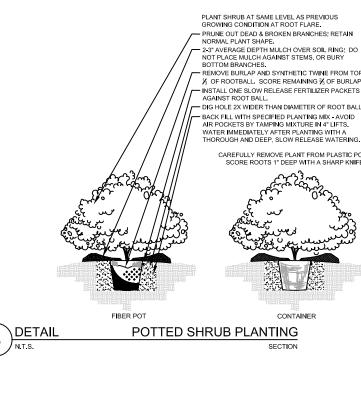


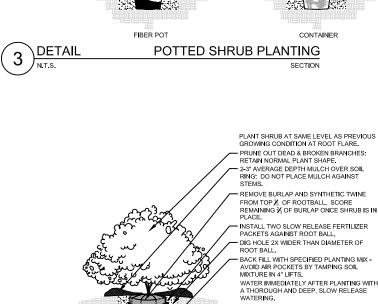

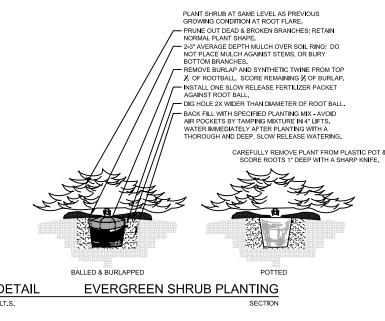

Scale: None

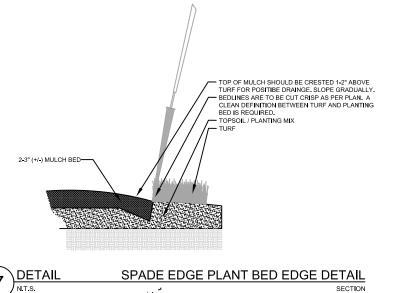

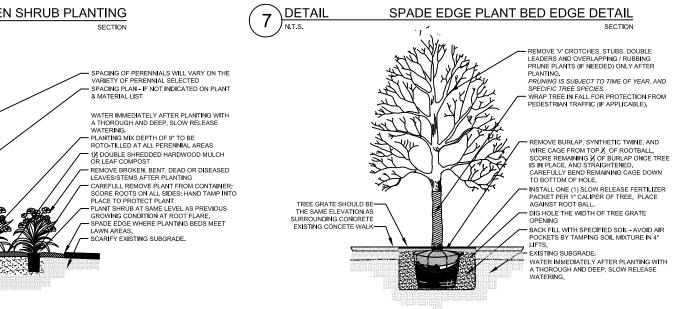

# PLANTING & HARDSCAPE DETAILS

PLANT MATERIAL PROPOSED ROOT KEY QUANTITY BOTANICAL NAME **COMMON NAME** SPECIFICATION / NOTES **Proposed Landscape Materials** ABM Acer xfreemanii 'Autumn Blaze Autumn Blaze Maple B&B Straight central leader, full and even crown. Prune only after planting Gleditsia triacanthos 'Skyline' Skyline Honeylocust 2.5" B&B Straight central leader, full and even crown. Prune only after planting Ginkgo biloba 'Autumn Gold Autumn Gold Maidenhair (Male) 2.5" B&B Straight central leader, full and even crown. Prune only after planting ORNAMENTAL TREES (DECIDUOUS) B&B Straight central leader, full and even crown. Prune only after planting Pyrus calleryana 'Chanticlee Chanticleer Flowering Pear B&B Straight central leader, full and even crown. Prune only after planting Syringa reticulata 'Ivory Silk' Ivory Silk Japanese Tree Lilad **EVERGREEN TREES** B&B Evenly shaped tree with branching to the ground NA Thuja occidentalis 'Nigra' Nigra Arborvitae **EVERGREEN SHURBS** GVB 144 Buxus x 'Green Velvet' Green Velvet Boxwood B&B Full rounded well branched shrub KCPJ Juniperus chinensis 'Kallay's Compact' Kallay's Compact Pfitzer Juniper 20-24" Cont. Full rounded well branched shrub DECIDUOUS SHRUB Cont. Full, well rooted plant, evenly shaped Cotoneaster acutifolia Peking (Hedge) Cotoneaster Fothergilla gardenii Dwarf Fothergilla Cont. Full, well rooted plant, evenly shaped Hydrangea arborescens 'Abetwo' Incrediball Hydrangea Cont. Full, well rooted plant, evenly shaped Cont. Full, well rooted plant, evenly shaped Hydrangea paniculata 'Limelight' Limelight Hydrangea Hydrangea paniculata 'Unique Cont. Full, well rooted plant, evenly shaped Unique Hydrangea DPSR Rosa rugosa 'Dwarf Pavement' Dwarf Pavement Shrub Rose Cont. Full, well rooted plant, evenly shaped GMS Goldmound Spirea Cont. Full, well rooted plant, evenly shaped Spirea xbumalda 'Goldmound Neon Flash Spirea Spirea xbumalda 'Neon Flash DPL Syringa meyeri 'Palabin' Palabin Dwarf Lilac Cont. Full, well rooted plant, evenly shaped B&B Full, well rounded plant with moist rootball and healthy appearance KSV Viburnum carlesii Koreanspice Vibunrum Viburnum lantana 'Mohican' Mohican Viburnum B&B Full, well rounded plant with moist rootball and healthy appearance ORNAMENTAL GRASSES 324 Calamagrostis acutiflora 'Karl Foerster Overdam Feather Reed Grass Cont. Full, well rooted plant 108 Panicum virgatum 'Heavy Metal' Heavy Metal Switch Grass Cont. Full, well rooted plant Hemercallis 'Happy Returns' Happy Returns Daylilly Cont. Full, well rooted plant, evenly shaped Iris sibirica 'Caesars' Brother' Cont. Full, well rooted plant, evenly shaped Caesars' Brother Siperian Iris Cardinal Flower Cont. Full, well rooted plant, evenly shaped Euonymus fortunei 'Coloratus' Pupleleaf Wintercreeper Pot Full, well rooted plant, evenly shaped LAWN & TURFGRASSES awn Establishment Area / Grading Area SY Cedar Creek Premium Blue Tag Seed Mix (Ph: 888-313-6807) Erosion Matting for sloped seeded areas see plan for area delineation SY American Excelsior Company Curlex Net Free (or approved equal) SY Fresh cut, weed free; Bluegrass Blend Sod; Water immediately after installation Sodded Areas (identified on plan) see plan for area delineation Neenah 60" Sqaure Tree Grates see plan for location 60"x60" Shredded Hardwood Mulch (3" depth) 18,500 SF Soil Amendments (2" depth) 18,500 SF Pulverized Topsoil (Lawn Area) 21,000 SF Pulverized Topsoil (2" over bed areas) 18,500 SF 2" PVC Sleeve irrigation / lighting access Schedule 40 PVC Downspout Extentions determine at time of installation Downspout Adapters determine at time of installation \*Landscape counts & quantities are provided as a service to the Landscape Contractor; Landscape Contractor is responsible for verifying these counts and quantities in order to provide a complete landscape installation as outlined on this Landscape Master Plan. In the event that a discrepancy occurs between this schedule and the Landscape Master Plan, the Landscape Master Plan including the graphics

Seed Compositions: Cedar Creek Premium Blue Tag (Ph: 888-313-6807): 10% Mid Atlantic Kentucky Bluegrass 20% Merit Kentucky Bluegrass 20% Boreal Red Fescue 20% Pennant Fine Perennial Ryegrass

10% Atlantis Kentucky Bluegrass 10% Dragon Kentucky Bluegrass 10% Palmer III Fine Perennial Ryegrass Seed at rate of 3# per 1000 SF

# PLANT & MATERIAL SCHEDULE

Scale: None

1. Contractor responsible for contacting Diggers Hotline (811 or 800-242-8511) to have site marked prior to excavation or planting.

2. Contractor to verify all plant quantities shown on Plant & Material List and landscape planting symbols and report any discrepancies to Landscape Architect or General Contractor.

3. All plantings shall comply with standards as described in American Standard of Nursery Stock - Z60.1 ANSI (latest version). Landscape Architect reserves the right to inspect, and potentially reject any plants that are inferior, compromised, undersized, diseased, improperly transported, installed incorrectly or damaged. No sub-standard "B Grade" or "Park Grade" plant material shall be accepted. Plant material shall originate from nursery(ies) with a similar climate as the planting site.

4. Any potential plant substitutions must be approved by Landscape Architect or Owner. All plants must be installed as per sizes indicated on Plant & Material Schedule, unless approved by Landscape Architect. Any changes to sizes shown on plan must be submitted in writing to the Landscape Architect prior to

5. Topspoil in Parking Lot Islands (if applicable): All parking lot islands to be backfilled with topsoil to a minimum depth of 18" to insure long-term plant health. Topsoil should be placed within 3" of finish grade by General Contractor / Excavation Contractor during rough grading operations/activity. The landscape contractor shall be responsible for the fine grading of all disturbed areas, planting bed areas, and lawn areas. Crown all parking lot islands a minimum of 6" to provide proper drainage, unless otherwise specified.

6. Tree Planting: Plant all trees slightly higher than finished grade at the root flare. Remove excess soil from the top of the root ball, if needed. Remove and discard non-biodegradable ball wrapping and support wire. Removed biodegradable burlap and wire cage (if present) from the top  $\frac{1}{3}$  of the rootball and carefully bend remaining wire down to the bottom of the hole. Once the tree has been placed into the hole and will no longer be moved, score the remaining  $\frac{2}{3}$  of the burlap and remove the twine. Provide three slow release fertilizer for each tree planted.

7. Tree Planting: Backfill tree planting holes 80% existing soils removed from excavation and 20% plant starter mix. Avoid air pockets and do not tamp soil down. Discard any gravel, rocks, heavy clay, or concrete pieces. When hole is  $\frac{2}{3}$  full, trees shall be watered thoroughly, and water left to soak in before proceeding to fill the remainder of the hole. Water again to full soak in the new planting. Each tree shall receive a 3" deep, 4-5' diameter (see planting details or planting plan) shredded hardwood bark mulch ring around all trees planted in lawn areas. Do not build up any mulch onto the trunk of any tree. Trees that are installed incorrectly will be replaced at the time and expense of the Landscape Contractor.

8. Shrub Planting: All shrubs to be planted in groupings as indicated on the Landscape Plan. Install with the planting of shrubs a  $\frac{50}{50}$  mix of plant starter with topsoil. Install topsoil into all plant beds as needed to achieve proper grade and displace undesirable soil (see planting detail). Remove all excessive gravel, clay and stones from plant beds prior to planting. When hole(s) are  $\frac{2}{3}$  full, shrubs shall be watered thoroughly, and water left to soak in before proceeding. Provide slow-release fertilizer packets at the rater of 1 per 24" height/diamter of shrub at planting.

9. Mulching: All tree and shrub planting beds to receive a 3" deep layer of high quality shredded hardwood bark mulch (not pigment dyed or enviro-mulch). All perennial planting areas (groupings) shall receive a 2" layer of shredded hardwood bark mulch, and groundcover areas a 1-2" layer of the same mulch. Do not mulch annual flower beds (if applicable). Do not allow mulch to contact plant stems and tree trunks.

10. Edging: All planting beds shall be edged with a 4" deep spade edge using a flat landscape spade or a mechanical edger. Bedlines are to be cut crisp, smooth as per plan. A clean definition between landscape beds and lawn is required. Pack mulch against lawn edge to hold in place.

11. Plant bed preparation: All perennial, groundcover and annual areas (if applicable) are required to receive a blend of organic soil (Soil Amendments) amendments prior to installation. Roto-till the following materials at the following ratio, into existing soil beds or installed topsoil beds to a depth of approximately 8"-10"

Per 100 SF of bed area:

3/4 CY Peat Moss or Mushroom Compost 3/4 CY blended/pulverized Topsoil

2 pounds starter fertilizer

1/4 CY composted manure

12. Installation preparation for all seeded areas: remove/kill off any existing unwanted vegetation prior to seeding. Prepare the topsoil (if adequate or provide as in item #6 above) and seed bed by removing all surface stones 1" or larger. Apply a starter fertilizer and specified seed uniformly at the specified rate, and provide mulch covering suitable to germinate and establish turf. Provide seed and fertilizer specifications to Landscape Architect and Owner prior to installation. Erosion control measures are to be used in swales and on slopes in excess of 1:3 and where applicable (see Civil Engineering Drawings). Methods of installation may vary are the discretion of the Landscape Contractor on his/her responsibility to establish and guarantee a smooth, uniform, quality turf. A minimum of 2" of blended, prepared and non-compacted topsoil is required for all lawn areas. If straw mulch is used as a mulch covering, a tackifier may be necessary to avoid wind dispersal of mulch covering. Marsh hay containing reed canary grass is NOT acceptable as a mulch covering.

An acceptable quality seed installation is defined as having: No bare spots larger than one (1) square foot

No more than 10% of the total area with bare areas larger than one (1) square foot

A uniform coverage through all turf areas


13. Warranty and Replacements: All plantings are to be watered thoroughly at the time of planting, through construction and upon completion of project as required. Trees, Evergreens, and Shrubs (deciduous and evergreen) shall be guaranteed (100% replacement) for a minimum of one (1) year from the date of project completion. Perennials, groundcovers, and ornamental grasses shall be guaranteed for a minimum of one (1) growing season. Perennials, groundcovers, and ornamental grasses planted after September 15th shall be guaranteed through May 31st of the following year. Only one replacement per plant will be required during the warranty period, except for losses or replacements due to failure to comply with specified requirements. Watering and general ongoing maintenance instructions are to be supplied by the Landscape Contractor to the Owner upon completion of the project.

14. The Landscape Contractor is responsible for the watering and maintenance of all landscape areas for a period of 45 days after the substantial completion of the landscape installation. This shall include all trees, shrubs, evergreens, perennials, ornamental grasses, turf grass, no-mow grass, and native prairie seed mix / stormwater seed mix. Work also includes weeding, edging, mulching (only if required), fertilizing, trimming, sweeping up grass clippings, pruning and

15. Project Completion: Landscape Contractor is responsible to conduct a final review of the project, upon completion, with the Landscape Architect, Client or Owner / Client Representative, and the General Contractor to answer questions, provide written care instructions for new plantings and turf, and insure that all

# LANDSCAPE GENERAL NOTES

Scale: None

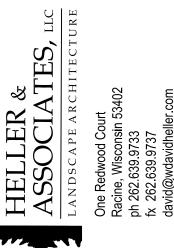

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ISSUED	DATE	
FOR APPROVAL		
FOR PERMIT		
FOR BID		
FOR CONST.		

REVISIONS	DATE
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JOB NO. 14-013 DATE 05.16.14 FILE

OWNER APPROVAL

SHEET TITLE

LANDSCAPE DETAILS, NOTES & SCHEDULES

SHEET NUMBER



#### **BUILDING A - SOUTH ELEVATION**



#### **BUILDING A - NORTH ELEVATION**



#### **DOVER TEACHER HOUSING**

**BUILDING A - ELEVATIONS** 

Scale: 1/16" = 1'-0"





#### **BUILDING B - NORTH ELEVATION**



## **DOVER TEACHER HOUSING**

**BUILDING B - ELEVATIONS** 

Scale: 1/16" = 1'-0"

Engberg Anderson Project No. 142325

Anderson MILWAUKEE + MADISON + TUCSON

Engberg V



PLEASE NOTE:
BUILDING B EAST AND WEST
ELEVATIONS ARE SIM.

#### **BUILDING A - EAST ELEVATION**



#### **BUILDING A - WEST ELEVATION**




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0' 4' 8' 16'


**BUILDING A - ELEVATIONS** 

Scale: 1/16" = 1'-0"

5/19/1

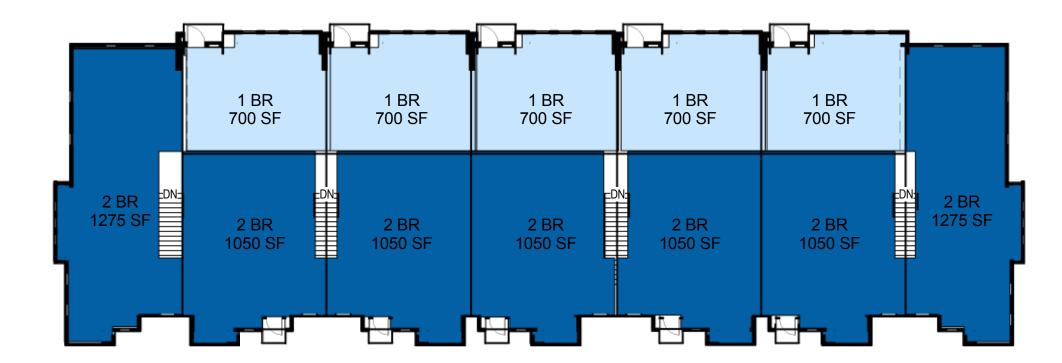

#### **BUILDING A - LEVEL TWO PLAN**

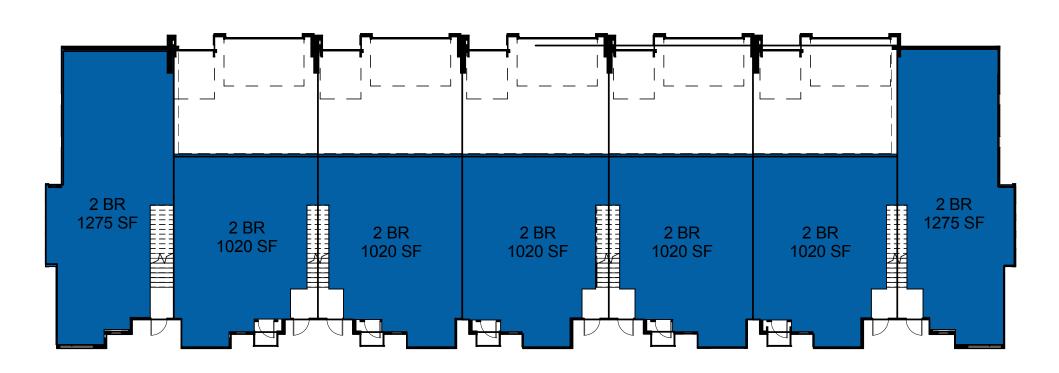


#### **BUILDING A - LEVEL ONE PLAN**




**DOVER TEACHER HOUSING** 


0' 10' 20'

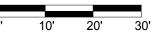



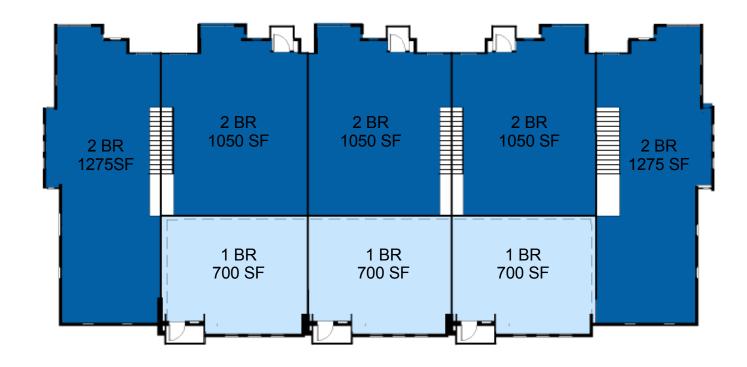

**BUILDING B - LEVEL TWO PLAN** 

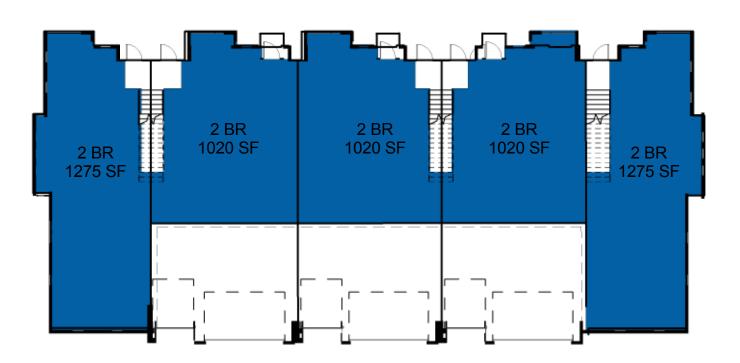


#### **BUILDING B - LEVEL ONE PLAN**



#### **DOVER TEACHER HOUSING**

0' 10' 20'

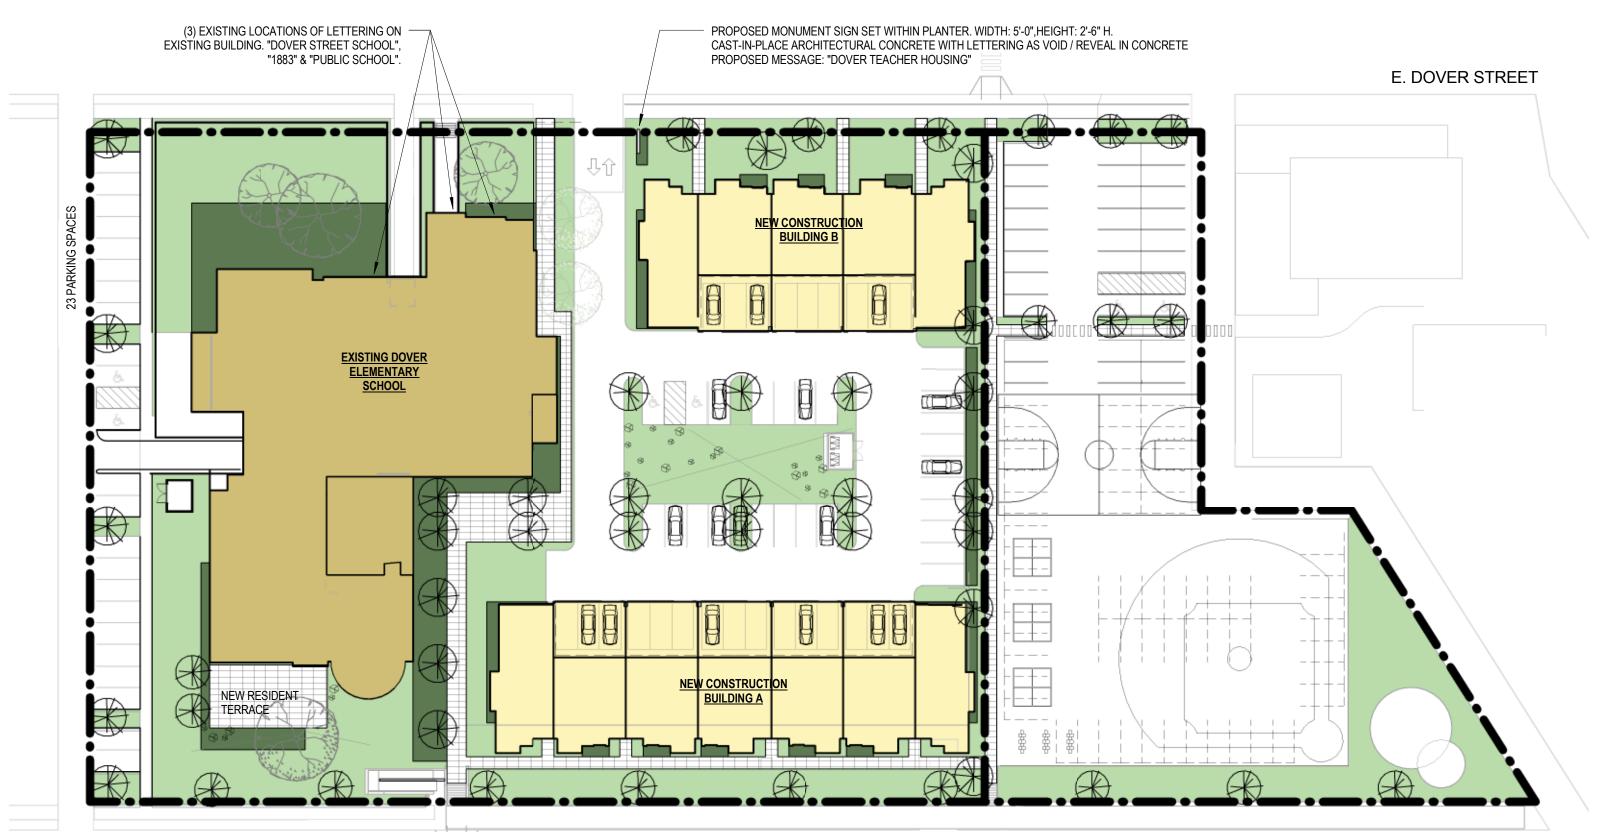

E. POTTER AVENUE




MILWAUKEE + MADISON + TUCSON

#### **DOVER TEACHER HOUSING**

SIGNAGE PLAN

Scale: 1" = 40'-0"

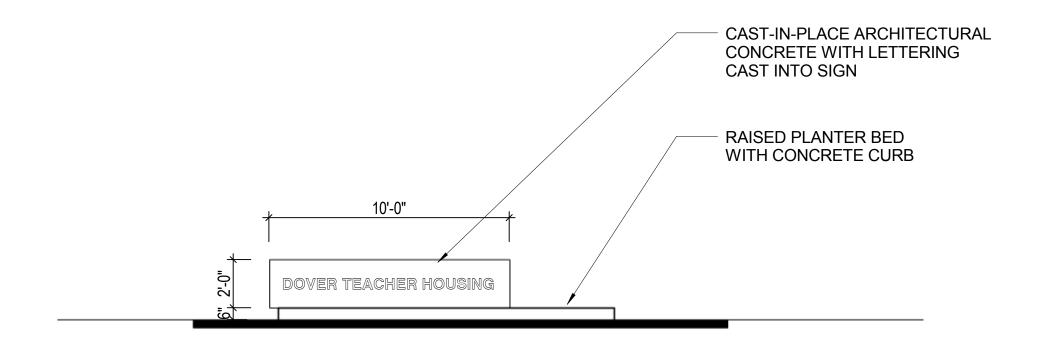



PROPOSED MONUMENT SIGN ELEVATION

Scale: 1/4" = 1'-0"

MILWAUKEE + MADISON + TUCSON





MILWAUKEE + MADISON + TUCSON

## DOVER TEACHER HOUSING

PERSPECTIVE
Scale:
5/19/14
Engberg Anderson Project No. 142325





MILWAUKEE + MADISON + TUCSON

## DOVER TEACHER HOUSING

Unnamed

Scale



E. DOVER STREET LOOKING WEST AT EXISTING DOVER STREET SCHOOL.



SITE PHOTOGRAPHS



E. DOVER STREET AT DOVER STREET SCHOOL ENTRANCE.



SITE PHOTOGRAPHS



E. DOVER STREET LOOKING WEST AT ST. LUCAS LUTHERAN CHURCH



MILWAUKEE + MADISON + TUCSON

## DOVER TEACHER HOUSING

SITE PHOTOGRAPHS