

CERTIFICATE OF APPROPRIATENESS APPLICATION FORM

Incomplete applications will not be processed for Commission review.

Please print legibly.

www.nerm.neem.gr	RESS OF PROPERTY:	J ARLINGTON PLACE	MILW WI 53202
ŅAM	E AND ADDRESS OF	OWNER:	۸۸
Name	e(s): 5077 3	DHNSON/LESLIE MONTE	MURRO Oran oran memorial come i se a sum come con al come nonemporal al come come come come come come come come
Addre	ess: 1622 N	J ASTOR 57	partition of sometime and the electric management of the control description and the discovered control description and the control of the co
City:	MIW	State: WI EME. CUM	ZIP: 53202
Email	1: 5077 FUEL	EME. CUM	and the state of t
Telep	phone number (area cod	le & number) Daytime: <u>뉘넥 경</u>	5-3081 Evening: 5AME
APPI	LICANT, AGENT OR CO	ONTRACTOR: (if different from ow	ner)
Name	e(s):	and the second s	минист такжа сумана баран жаты байы жаты Баланда байында байы байында байында байында байында байында байында б
City:		State:	ZIP Code:
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Telep ATTA at 414	ohone number (area cod	le & number) Daytime: projects can vary in size and scope I requirements)	Evening:
Telep ATTA at 414	ohone number (area cod ACHMENTS: (Because 4-286-5712 for submitta REQUIRED FOR MA	le & number) Daytime: projects can vary in size and scope I requirements)	Evening: e, please call the HPC Office
ATTA at 414	ACHMENTS: (Because 4-286-5712 for submitta REQUIRED FOR MA Photographs of affect Sketches and Elevation of the control of the	projects can vary in size and scope of the building for Drawings (1 full size and 1 reduited and	Evening: e, please call the HPC Office (annotated photos recommended to 11" x 17" or 8 ½" x 11")
ATTA at 414	ACHMENTS: (Because 4-286-5712 for submitta REQUIRED FOR MA Photographs of affect Sketches and Elevation of the control of the	le & number) Daytime: projects can vary in size and scope I requirements) AJOR PROJECTS: ted areas & all sides of the building	Evening: e, please call the HPC Office (annotated photos recommended to 11" x 17" or 8 ½" x 11")
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PLEASE NOTE: YOUR APPLICATION CANNOT BE PROCESSED UNLESS
BOTH PAGES OF THIS FORM ARE PROPERLY COMPLETED
AND SIGNED.

5. DESCRIPTION OF PROJECT:

Tell us what you want to do. Describe all proposed work including materials, design, and dimensions. Additional pages may be attached.

BREAK THROUGH EXISTING CMU WALL +
INSTALL BI-FOLD ALUMINUM+ GLASS BOORS,
TO CONNECT PATIO TO INSIDE OF BAR/RESTAURANT.
THANKS SCOTT

6. SIGNATURE OF APPLICANT:

Signature

5 CO77 M JOHN

Please print or type name

3/6/14

Date

This form and all supporting documentation **MUST** arrive by 12:00 noon on the deadline date established to be considered at the next Historic Preservation Commission Meeting. Any information not provided to staff in advance of the meeting will not be considered by the Commission during their deliberation. Please call if you have any questions and staff will assist you.

Hand Deliver or Mail Form to: Historic Preservation Commission City Clerk's Office 200 E. Wells St. Room B-4 Milwaukee, WI 53202

PHONE: (414) 286-5722

FAX: (414) 286-3004

www.milwaukee.gov/hpc

6/22/12

SUBMIT

HI HAT LOUNGE HE GARAGE ALTERATIONS

INTERIOR ALTERATIONS

arcint architecture

arcint architecture. Ic 35:8 west pierce street milwaukoe, wisconsin 53215 arcint-architecture.com

PROJECT TEAH

CODE SUMMARY PLAN GENERAL NOTES

APPLICABLE CODES
WISCONSIN COMMERCIAL BUILDING CODE 2009 IBC

CHAPTER 3 - USE AND OCCUPANCY CLASSIFICATION OCCUPANCY CLASSIFICATION: ASSEMBLY GROUP "A-Z"

CHAPTER 5 - GENERAL BUILDING HEIGHTS AND AREAS EXISTING AREA: 2,175 SQUARE FEET,

CHAPTER 4 - TYPES OF CONSTRUCTION EXISTING

CHAPTER 10 - MEANS OF EGRESS DESIGN OCCUPANT LOAD (TABLE 1004.1.1) 15 NET:

COMMON PATH OF EGRESS TRAVEL ISECTION 1014.31; EXIT ACCESS TRAVEL DISTANCE (TABLE 1016.11; DEAD END CORRIDOR LIM!); EXIT CONTINUATION PATH (VESTIBULE)

CHAPTER 29 - EXISTING PLUMBING SYSTEMS
NUMBER OF REQUIRED PLUMBING FIXTURES (TABLE 2902.1):
WATERCLOSETS [MALE] REQUIRED: 2
WATERCLOSETS [FEMALE] REQUIRED: 2
LAVATORIES REQUIRED: 2

145 OCCUPANTS

SHEET INDEX

ARCHITECTURAL DRAWINGS TITLE SHEET

AZDO DEMOLITION, FLOOR AND REFLECTED CEILING PLAN, ELEVATION AND DETAIL.

A410 BAR LAYOUT AND ELEVATIONS

S100 STRUCTURAL PLANS AND DETAILS

PROJECT NAME HI HAT LOUNGE GARAGE ALTERATIONS 1709 N ARLINGTON PL MILWAUKEE, WI 53202

DRAWING ISSUE HISTORY CR 02-10-2014 Owner Review 80 02-14-2014 Issued for Bidding

SET TYPE


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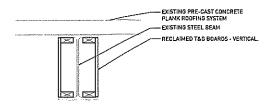
AA PROJECT HUMBER 13016

DATE 02-14-2014

SHEET TITLE

SHEET NUMBER




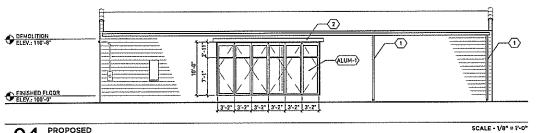

04 PROPOSED NORTH ELEVATION

O5 EXISTING STEEL BEAM WOOD IN-FILL

SCALE - 1" = 1'-0"

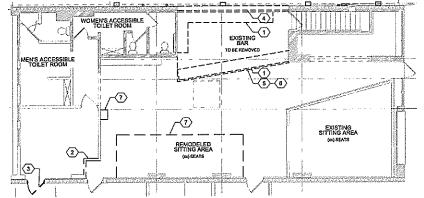


WOMEN'S ACCESSIBLE TOILET ROOM PROPOSED BAR MEN'S ACCESSIBLE TOILET ROOM 3 لن EXISTING SITTING AREA RUTCHEN 2 REMODELED SITTING AREA

02 DEMOLITION FLOOR PLAN

03 REFLECTED CEILING PLAN ENTRY LEVEL

SCALE - 1/6" = 1'-0"

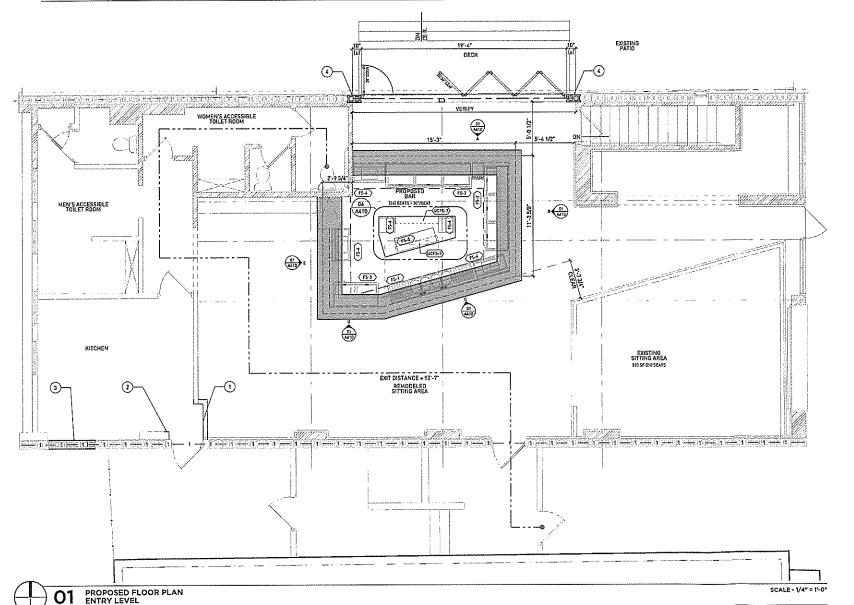

SCALE - 1/8" = 1'-0"

DEMOLITION PLAN GENERAL NOTES

A. VERIFY ALL DIMENSIONS AND CONDITIONS AT JOB SITE. PORTIONS OF EXISTING CONSTRUCTION MAY HAVE BEER REMOVED BY OWNER.

VERIFY CHACT COMPOSITION OF EXISTING WALLS TO BE REMOVED.

REFER TO PLUMBING, HYAC AND ELECTRICAL PLANS FOR ADDITIONAL DEMOLITION ITEMS AND NOTES. COORDINATE WORK WITH PLUMBING, HYAC AND ELECTRICAL PLANS FOR ADDITIONAL DEMOLITION TEMS.

COORDINATE BERMOLITION OF LOAD BEARING WALL WITH STRUCTURAL PLANS.

DEMOLITION PLAN KEYED NOTES $\langle \mathbf{x} \rangle$

REMOVE EXISTING BAR AND ASSOCIATED ITEMS,
REMOVE EXISTING WALL CONSTRUCTION,
REMOVE EXISTING WALL CONSTRUCTION,
REMOVE EXISTING DOR AND ASSOCIATED HARDWARE.
REMOVE EXISTING WALL CONSTRUCTION, REFER TO STRUCTURAL PLANS, SALVAGE BLOCK
FOR REUSE.
REMOVE AND SAVE EXISTING DROPPED WOOD FINISH CEILING.
SALVAGE EXISTING WOOD CEILING FRAMING AND ATTACHMENTS.
REMOVE BOOTH AND PLATFORM.

CEILING PLAN KEYED NOTES

EXISTING PRE-CAST CONCRETE PLANK ROOFING SYSTEM - EXPOSED.
 EXISTING STEEL ROOF SUPPORT BEAM.
 PORTION OF NEWLY EXPOSED BEAM DUE TO REMOVAL OF EXISTING DROPPED CEILING CONSTRUCTION.

4. PROVIDE WOOD IN-FILL AT STEEL BEAM WEB OVER PROPOSED BAR (BELOW) PER DETAIL

92/A210.

5. EXISTING WALL CONSTRUCTION REMAINS FOR PROPOSED OPENING HEADER.

6. EXISTING SKYLIGHT.

FLOOR PLAN GENERAL NOTES

A. DIMENSIONS ON FLOOR PLAN ARE BASED ON FACE OF FINISHED WALL TO FACE OF FINISHED

WALL (NOMINAL).

9. VERIEY ALL DIMENSIONS AND CONDITIONS AT JOB SITE. PORTIONS OF EXISTING CONSTRUCTION MAY HAVE REEN REMOVED BY DWIFE.

FLOOR PLAN

MATCH EXISTING WALL CONSTRUCTION.
 REPAIR EXISTING WALL WITH SALVAGED BLOCK.
 IN-FILL OPENING WITH ENISTING ADJACENT WALL CONSTRUCTION. PATCH AND REPAIR WALL FINISH AS NEEDED.
 REFER TO STRUCTURAL WALL AND SUPPORT CONDITIONS.

EXTERIOR ELEVATIONS
MATERIAL IDENTIFICATION KEYNOTES

(XXX-1)

X

➂

ALUM-1 CUSTOM FABRICATED. CRL MONTEREY 580 SERIES SYSTEM BI-FOLDING GLASS WALL. WITH FLUSH SILL CLEAR INSULATED BLAZING. CLEAR ANODIZED FINISH, PROVIDE OUTWARD SWING PEDESTRIAN DOOR.


EXTERIOR ELEVATIONS
MATERIAL IDENTIFICATION KEYNOTES X

EXISTING GUTTER WITH DOWNSPOUT,
 EXPOSED STEEL LINTEL.

NO.	QTY.	EQUIPMENT	WIOTH	DEPTH	HEIGHT	MANUFACTURER	POWER		
FS+1	1	BAR SINK	96"	21*	35"	KRONE METAL 21-84C-H-200	-	-	
FS-2	2	TOP LOAD BAR COOLER	95 3/81	26 5/8"	33 3/8**	TURE: TD-95-38	120v	9.2A	7" CORD
FS-3	i	TOP LOAD BAR COOLER	49 5/8"	26 5/8"	33 3/8"	TRUE: TD-5018	120v	8,8A	7° CORD
FS-4	3	ICE BIN	34"	21"	34 1/2*	KRONE METAL: 21-36	-	-	
FS-5	ĭ	TAPPER TRAY	45"	16"	18*	VERIFY	•		-
F5-6	ż	POINT OF SALE MACHINE	16*	18"	14"	VERIFY	VERIFY 1		
F5-7**	2	DOUBLE TIER BOTTLE RAIL	34"	8"	6"	KROWN METAL: 0-24	-		-

ADD ADDITIONAL 2½° FOR CASTERS IF NEEDED,
 VERIFY SELECTIONS WITH OWNER, PURCHASED EQUIPMENT MAY YARY.

SCALE - 1/2" = 1'-0"

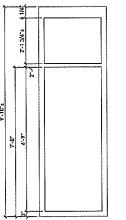

06 TYPICAL DOOR PANEL

PROJECT TEAM

arcint

architecture

arcint architecture, I.c. 3518 west pierce street milwaukee, wisconsin 53215 arcint architecture.com

PROJECT HAME HI HAT LOUNGE GARAGE ALTERATIONS 1709 N ARLINGTON PL MILWAUKEE, WI 53202

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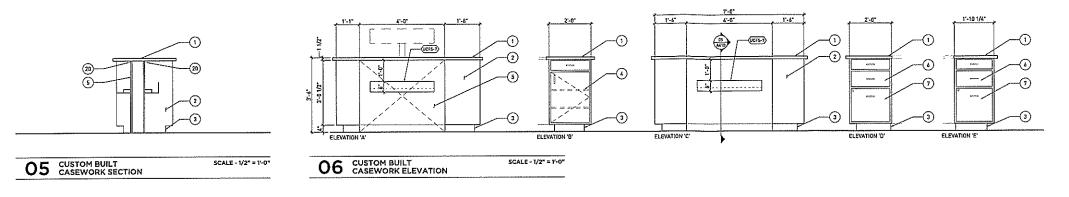
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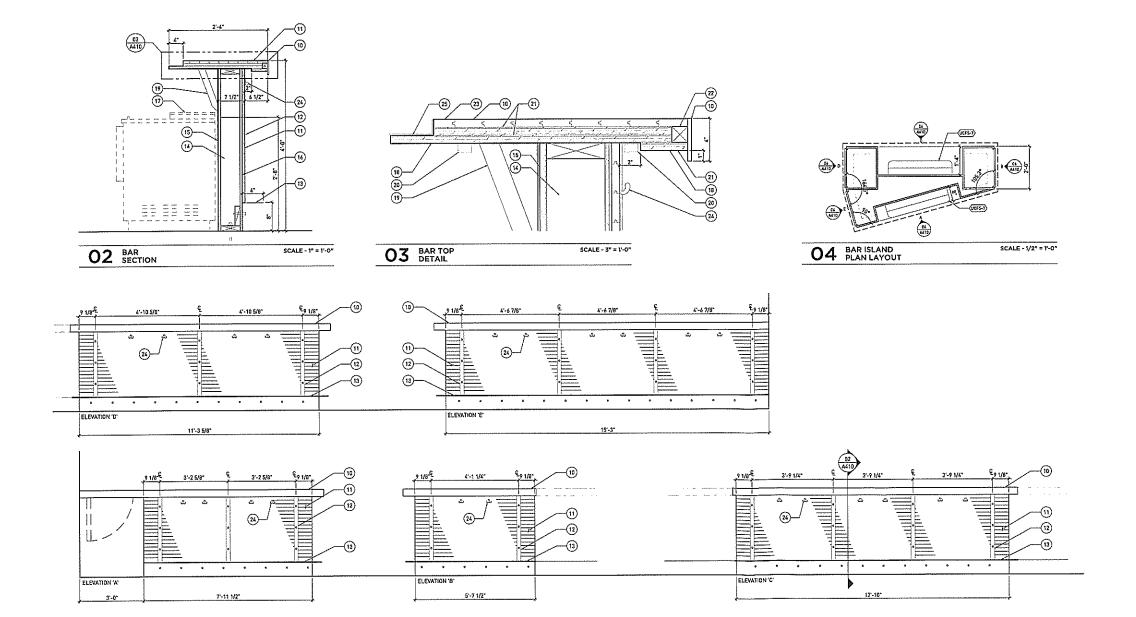
AA PROJECT NUMBER 13016

02-14-2014

SHEET TITLE FLOOR PLANS AND ELEVATIONS

A200





O1 BAR OUTSIDE FACE ELEVATION

SCALE - 1/2" = 1'-0"

INTERIOR ELEVATIONS GENERAL NOTES

A. COORDINATE ALL SERVICES. (PLUMBING, BAR, ELECTRICAL, ETC.) WITH OWNER.

INTERIOR ELEVATIONS KEYED NOTES

- 1. ZINC WRAPPED COUNTER TOP.
 2. A GRADE BIRCH PLYWOOD, FINISH; NON-GRAIN RAISING ANILINE DYE. 2nd COAT POLYURETHANE VARNISH ISATIN).
 3. "A "WINT, BASE.
 4. ADJUSTABLE SHELVES WITH HOLD DOWNS.
 5. ACCESS PAREL.
 6. WOODD DRAWERS ON FULL EXTENSION GLIDES.
 7. SINIGLE DEEP DRAWER WITH LOCK.
 8. NOT USED.
 10. "X" A" STEEL EDGE BENT AROUND CORNERS. FINISH; PRESTO BLACK GEL COATING AND POLYURETHANE VARNISH.
 11. RECLAIMED TAG BOARDS, FINISH; ANILINE DYE. 2nd COAT POLYURETHANE VARNISH (SATIN).
 2. 2½" X" 2" STEEL BAR WITH APPLIED RIVETS VERTICAL, FINISH; PRESTO BLACK GEL COATING AND POLYURETHANE VARNISH.
 11. RECLAIMED TAG BOARDS, FINISH; ANILINE DYE. 2nd COAT POLYURETHANE VARNISH (SATIN).
 2. 2½" X" 2" STEEL BAR WITH APPLIED RIVETS VERTICAL, FINISH; PRESTO BLACK GEL COATING AND POLYURETHANE VARNISH STEEL.
 3. FOOT RAIL CONTINUOUS BENT ½" DIAMOND PLATE BOLTED AT 12" CC. WITH MITERED
- 12. 20; "X." X" STEEL BAR WITH APPLIED RIVETS VERTICAL. FINISH: PRESTO BLACK COLL COATIS AND POLYURETHAN'S WARNISH.

 13. FOOT RAIL CONTINUOUS BENT X;" DIAMOND PLATE BOLTED AT 12" OC. WITH MITERED CORNERS.

 14. 2x 5 STUD WAS.

 15. FAP PANIEL FACE OVER X;" CEMENT BACKER BOARD.

 16. Y;" PLYWOOD SHEATHING.

 17. RIFERT TO EQUIPMENT SCHEDULE FOR EQUIPMENT CALL OUTS.

 18. PROVIDE POLYURETHANE VARNISH AT UNDER SIDE OF BAR TOP.

 19. BAR TOP SUPPORT BRACKET @ 24" OC. [HAFFLE 505.14.956 OR SIMILAR]

 20. LEO STRIP LIGHTING.

 21. X;" PLYWOOD.

 22. ZAZ BLOCKING.

 23. POURED EPOXY FINISH.

 24. PURSE HOOK.

 25. BENT ZINC METAL TRIM.

PROJECT TEAM

arcint architecture

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PROJECT NAME HI HAT LOUNGE GARAGE ALTERATIONS

1709 N ARLINGTON PL MILWAUKEE, WI 53202

DRAWING ISSUE HISTORY CR 02-10-2014 Owner Review 80 02-14-2014 Issued for Bidding

SET TYPE

BID DOCUMENTS

AA PROJECT NUMBER 13016

02-14-2014

SHEET TITLE CUSTOM BUILT BAR DETAILS

THEET NUMBER


A410

-- EXISTING ROOF EXISTING CMU WALL REMOVE EXISTING CMU AS REQ'D AND INFILL EXTERIOR FACE SHELL NEW 12'x6'x1'-0" BEARING PLATE, CENTERED BELOW EXIST GROER WEB, WI (2) - EXISTING SLOPED STEEL GIRDER, FIELD VERIFY SIZE AND ELEVATION TO BOLTS TOP OF STEEL EL %" FITTED STIFFENER W/X" FILLET WELD ALL AROUND - NEW \$152" STIFFENER PLATES, EACH SIDE FIELD COPE EXIST GIRDER AROUND NEW LINTEL 5/16" \ TYP --)('55'x1'-0' CAP PLATE W/(2) }''0' BOLTS TOP & BOT > 1/4" V - NEW COLUMN, SEE PLAN - CUT FLOOR AS REC'D TO INSTALL COLUMN: PATCH W/ SOLID CONCRETE NEW ALUMINUM DOOR SYSTEM, SEE ARCH EXISTING FLOOR EL 1/1x71x11-01 BASE PLATE WI (2) 1/9 EXPANSION ANCHORS (31/7 EMBED) SHIM UP TO 3" FOR ERECTION TOLERANCE - EXISTING FOUNDATION WALL, AND FLOOR SYSTEM, FIELD VERIFY THICKNESS #4 DOWEL EACH SIDE OF BASE PLATE DRILL & EPOXY INTO EXISTING WALL (4" EMBED) NOTE. FIELD VERIFY EXISTING CONDITIONS AND IMMEDIATELY REPORT ANY DISCREPANCIES TO THE STRUCTURAL ENGINEER FOR RESOLUTION.

3 \$100

NEW COLUMN

SCALE NTS

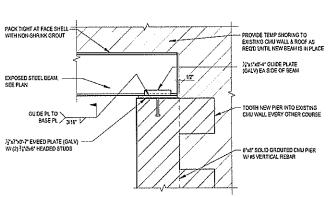

2 \$100 LINTEL END BEARING SCALE NTS

DESIGN DATA

DESIGN CODE.

2009 INTERNATIONAL BUILDING CODE W VISCONSIN AMMENDMENTS

SHOW LOAD INFORMATION:
GROWING SHOW LOAD (Pg)
SHOW EXPOSURE FACTOR (Cs)
SHOW LOAD IMPORTANCE FACTOR (Is)
THERMAL FACTOR (C)
FLAT ROOF SHOW LOAD (Pg)
DESIGNAL AND FROM I OAD (Pg) 30 psf 1 00 1 00 1 00 21 0 psf 25 psf

MATERIAL DESIGN PROPERTIES

MISCELLANEOUS INFILL

REINFORCING STEEL STRENGTHS BARS (ASTM A 515, grade 50) Fy = 60,000 psl

STRUCTURAL MASONRY STRENGTHS: CONCRETE MASONRY UNITS (ASTM C90) fcmu = 3275 psi
TYPE M (BELOW GRADE)
TYPE S (ABOVE GRADE)
fg = 2250 psi
fm = 2250 psi (NET AREA
COMPRESSIVE STRENGTI MORTAR (ASTM C270)

Fy = 50,000 psi Fy = 36,000 psi Fy = 46,000 psi

WF SHAPES (ASTM ASS2)
ANGLES, CHARNELS, PLATES, A BARS (ASTM ASE)
SOUARE & RECTANGULAR TS OR HSS SECTIONS
(ASTM ASS0, grade 8)
HIGH STERKOTH BOLTS (ASTM AS25)
ANCHOR ROOS (ASTM F1554) Fy = 36,000 psi

STRUCTURAL STEEL NOTES

- 1 FABRICATION AND ERECTION OF STRUCTURAL STEEL SHALL CONFORM WITH THE AISC (AMERICAN INSTITUTE OF STEEL CONSTRUCTION), "MANUAL OF STEEL CONSTRUCTION", LATEST EDITION
- 2 ALL STEEL DETAILS AND CONNECTIONS SHALL BE IN ACCORDANCE WITH THE REQUIREMENTS OF THE AISC "SPECIFICATIONS FOR STRUCTURAL STEEL BUILDINGS, LATEST EDITION.
- 3. USE A325N BOLTS UNLESS NOTED OTHERWISE.
- OVERSIZED OR SLOTTED HOLES SHALL NOT BE USED FOR ANY CONNECTIONS UNLESS SPECIFICALLY INDICATED ON THE DRAYINGS OR APPROVED BY THE ENGINEER.
- CUTS, HOLES, COPING, ETC. REQUIRED FOR WORK OF OTHER TRADES SHALL BE SHOWN ON THE SHOP DRAWINGS AND MADE IN THE SHOP. CUTS OR BURNING OF HOLES IN STRUCTURAL STEEL MEMBERS IN THE FIELD WILL NOT BE PERMITTED.
- THE FOLLOWING INFORMATION SHALL BE SUBJECTED TO THE ARCHITECT AND STRUCTURAL ENGINEER FOR REVIEW ONE ELECTRONIC (POP) OR THREE HARD COPIES SHALL BE SUBJECTED IN A THREE HARD COPIES SHALL BE SUBJECTED IN A THREE HARD COPIES SHALL BE SUBJECTED IN THREE HARD COPIES SHALL BE SUBJECTED IN THREE HARD COPIES SHALL BE SUBJECTED OR A MAINTAIN PERIOD OF TEN WORKING DAYS FOR REVIEW 1 TYPE OF STEEL LOCATION AND IDENTIFICATION MARK OF EACH MEMBER 1 DAMENSONS, SIZE AND WEIGHT OF MEMBERS 1 LOCATION AND SIZE OF CUTS, COPES, SICTOS AND HOLES 1 TYPE AND LOCATION OF SHOP AND FIELD CONTRICTIONS 1 TYPE AND LOCATION OF SHOP AND FIELD CONTRICTIONS 1 TYPE AND LOCATION OF SHOP AND FIELD CONTRICTIONS 1 TYPE AND LOCATION OF SHOP AND FIELD CONTRICTIONS 1 TYPE AND LOCATION OF SHOP AND FIELD CONTRICTIONS 1 TYPE AND EXCENT OF WELDS INDICATE WELDS BY WELDING SYMBOLS ADOPTED BY THE AMERICAN WELDING SOCIETY

arcint architecture

rcint architecture, lic nilwaukee wisconsin \$3207 www.arcint.architecture.com

PROJECT TEAU



PROJECT NAVE HI HAT LOUNGE GARAGE RENOVATIONS

1709 N ARLINGTON PL MILWAUKEE, WI 53202

DRAWNG ISSUE


SET IVES REVIEW DOCUMENTS

A A PROJECT NUMBER 13016

02-07-2014

STRUCTURAL PLANS AND DETAILS

SHEFT NUMBER

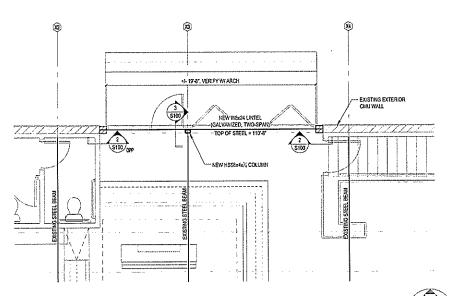

ROOF FRAMING PLAN