2. GENERAL CONTRACTOR SHALL CONSULT WITH STARBUCKS CONSTRUCTION MANAGER TO RESOLVE ANY CHANGES, OMISSIONS, OR PLAN DISCREPANCIES PRIOR TO BIDDING OR CONSTRUCTION.

3. ALL WORK SHALL BE PERFORMED IN STRICT COMPLIANCE WITH LOCAL, COUNTY, STATE, AND FEDERAL CODES AND ORDINANCES.

4. GENERAL CONTRACTOR SHALL VERIFY THE LOCATION OF ALL UTILITIES.

5. GENERAL CONTRACTOR TO VERIFY ALL DIMENSIONS, INCLUDING CLEARANCES REQUIRED BY OTHER TRADES, AND NOTIFY STARBUCKS CONSTRUCTION MANAGER OF ANY DISCREPANCIES PRIOR TO PROCEEDING WITH THE WORK. ALL DIMENSIONS ARE TO THE FACE OF THE FINISHED SURFACE UNLESS NOTED OTHERWISE. ALL DIMENSIONS TO BE TAKEN FROM DESIGNATED DATUM POINT. DO NOT SCALE DRAWINGS.

6. GENERAL CONTRACTOR SHALL PATCH AND REPAIR ALL EXISTING WALLS, FLOORS, CEILINGS, OR OTHER SURFACES IDENTIFIED TO REMAIN THAT MAY BECOME DAMAGED DURING THE COURSE OF THE WORK.

7. THE GENERAL CONTRACTOR IS RESPONSIBLE FOR OBTAINING PERMITS FOR FIRE PROTECTION, PLUMBING, MECHANICAL, AND ELECTRICAL SYSTEMS PRIOR TO INSTALLATION OF SUCH SYSTEMS.

8. GENERAL CONTRACTOR SHALL RETAIN ONE SET OF THE PLANS TO NOTE AND DOCUMENT ALL CHANGES DURING CONSTRUCTION. THIS SET SHALL BE A PART OF THE GENERAL CONTRACTOR'S "STORE CLOSE-OUT PACKAGE" AS DESCRIBED IN THE CONSTRUCTION MANAGEMENT AGREEMENT.

9. GENERAL CONTRACTOR IS RESPONSIBLE FOR COORDINATING DELIVERY OF MATERIALS FROM STARBUCKS CONTRACTED THIRD PARTY LOGISTICS DISTRIBUTION SERVICES AND VENDOR DIRECT SHIPMENTS. REFER TO CONSTRUCTION MANAGEMENT AGREEMENT FOR METHODS AND LEAD TIMES.

10. RESPONSIBILITY FOR SUPPLY AND DELIVERY OF MATERIALS AND EQUIPMENT IS IDENTIFIED IN THE DRAWING SCHEDULE SHEETS UNDER THE COLUMN LABELED "RESPONSIBILITY".

11. FOR THE PURPOSE OF THE DOCUMENTS, TO "INSTALL", SHALL MEAN TO PROVIDE ALL FASTENERS, MISCELLANEOUS HARDWARE, BLOCKING, ELECTRICAL CONNECTIONS, PLUMBING CONNECTIONS, AND OTHER ITEMS REQUIRED FOR A COMPLETE AND OPERATION INSTALLATION, UNLESS OTHERWISE NOTED.

12. ALL ITEM SUBSTITUTIONS MUST BE APPROVED BY THE STARBUCKS DESIGN MANAGER.

13. REFER TO ITEM CUTSHEETS FOR ADDITIONAL INFORMATION.

APPLICABLE BUILDING CODES:

BUILDING CODE: STRUCTURAL CODE: PLUMBING CODE: **MECHANICAL CODE:** ELECTRICAL CODE: FIRE/LIFE SAFETY CODE: ACCESSIBILITY CODE: **ENERYGY CODE:**

IBC 2009 (WI COMMERCIAL BUILDING CODE), CH 62 IBC 2009 (WI COMMERCIAL BUILDING CODE), CH 62 WI COMMERCIAL BUILDING CODE, CHAPTERS 81-84 IMC 2009 NEC 2008 (WI COMMERCIAL BUILDING CODE), CH 16

2009 NFPA-1 (WI COMMERCIAL BUILDING CODE), CH 14&30 ADA STANDARDS (WI COMMERCIAL BUILDING CODE), CH62 IECC 2009 (WI COMMERCIAL BUILDING CODE), CH 63

SITE AND OCCUPANCY

PROJECT DESCRIPTION: COMMERCIAL TENANT IMPROVEMENTS TO EXISTING BLDG

BUILDING HEIGHT: 46'-4" BUILDING AREA: 2500 SQ FT **CONSTRUCTION TYPE:** IIB (EXISTING)

FIRE SUPPRESSION SYSTEM: NO

BUILDING USE: RETAIL SALES & SERVICES **ZONING:** LB2

TYPE OF USE: COFFEE SHOP

TYPE OF OCCUPANCY: B-BUSINESS

OCCUPANCY LOAD: RETAIL: 320 SF / 30 = 991 SF / 15 = SEATING: LINEAR SEATING: 564IN/24 = BEVERAGE/PREP: 301 SF / 200 = WORKROOM/STORAGE: 303 SF / 300 = TOTAL OCCUPANCY = 106

TOTAL SQUARE FOOTAGE: 2500 SQ FT **TOTAL INERIOR SEATS:** 35

> LINEAR SEATING: 564IN/24= 24 **EXTERIOR SEASONAL**

SEATING: 10 **EXIT CAPACITY:**

> EXIT 2: 36" WIDE EXIT 3: 36" WIDE TOTAL EXIT WIDTH PROVIDED: 108in

0.20 x 106 OCCUPANTS = 21.2 IN REQUIRED 21.2 < 108, THEREFORE COMPLIES TRAVEL DISTANCE:

EXIT 1: 36" WIDE

ALLOWED TRAVEL DISTANCE: 250 '- 0" ACTUAL TRAVEL DISTANCE: 68' - 10"

NUMBER OF EXITS:

MIN. NUMBER OF EXITS REQUIRED: 2 NUMBER OF EXITS PROVIDED: 3

INDEX OF SHEETS

LIFE SAFETY PLAN

SCOPE OF WORK PLAN

DESIGN SPECIFICATIONS

DESIGN SPECIFICATIONS

ARCHITECTURAL SITE PLAN

DESIGN SPECIFICATIONS

EXTERIOR ELEVATIONS

EXTERIOR ELEVATIONS

DEMOLITION FLOOR PLAN

DEMOLITION CEILING PLAN

PENETRATION PLAN SCHEDULE & DETAILS

REFLECTED CEILING PLAN SCHEDULES & DETAILS

ENLARGED RESTROOM PLAN AND ELEVATIONS

PENETRATION PLAN

FLOOR PLAN

FF AND E PLAN

FF&E SCHEDULES

CASEWORK PLAN

FLOOR FINISH PLAN

WALL FINISH PLAN

INTERIOR ELEVATIONS

INTERIOR ELEVATIONS

INTERIOR ELEVATIONS

ENLARGED BAR PLANS

CONSTRUCTION DETAILS

CONSTRUCTION DETAILS

WORKROOM DETAILS

RESTROOM DETAILS

WALL FINISH DETAILS

WALL FINISH DETAILS

CASEWORK DETAILS

CASEWORK DETAILS

CASEWORK DETAILS CASEWORK DETAILS

MECHANICAL DESIGN

LIGHTING PLAN **ELECTRICAL DETAILS**

FFE&E - MATERIAL FINISHES

EXISTING CONDITION PHOTOS

MECHANICAL SPECIFICATIONS

ELECTRICAL SPECIFICATIONS

PLUMBING SPECIFICATIONS

PLUMBING WASTE / DRAIN PLAN

PLUMBING DETAILS & SANITARY ISOMETRIC

PLUMBING SUPPLY PLAN

STRUCTURAL PLAN

FIXTURE CALCULATION

Interior Occupant Load :

Exterior Occupant Load:

Wisconsin Plumbing Code:

Drinking Fountains Not Required

Total Occupant Load:

Lavatories

Water Closets

Lavatories

Minimum Number of Plumbing Fixtures:

Req'd Provide

Men: 58 Women: 58

1 Per 75 Occupants 1 Per 75 Occupants

1 Per 200 Occupants 1 Per 200 Occupants

Req'd Provide

N/A N/A

ELECTRICAL POWER PLAN

SCHEDULES

SCHEDULES

CASEWORK SCHEDULES

REFLECTED CEILING PLAN

DIMENSIONED CEILING PLAN

FLOOR FINISH SCHEDULES & DETAILS

GENERAL

G-0002

G-0003

G-0010

G-0011

G-0012

A-2101

A-2102

I-1101

I-1102

I-1112

I-1113

I-1114

I-1115

I-1116

I-1116.1

I-1116.2

I-1117

I-1118

I-2101

I-2102

I-2103

I-4101

I-4102

I-5101

I-5102

I-5103

I-5104

I-5105

I-5106

I-5107

I-5108

I-5109

I-5110 I-6101

I-6102

I-6103

I-6104

M-001

E-001

E-112

E-501

P-111

P-112

P-501

PLUMBING P-001

STRUCTURAL

MECHANICAL

ELECTRICAL

I-1117.1

I-1113.1

I-1114.1

INTERIORS

ARCHITECTURAL

Sheet Title

DESIGN MANAGER: STEPHENIE RYCHLIK STARBUCKS COFFEE COMPANY 550 W. WASHINGTON BLVD., SUITE 200 CHICAGO, IL 60661 (312) 775-6507 EXT. 2331 OFFICE (312) 502-6198 CELL SCHAMPIO@STARBUCKS.COM

PROJECT CONTACTS

CONSTRUCTION BRIAN GARVER MANAGER: STARBUCKS COFFEE COMPANY 550 W. WASHINGTON BLVD., SUITE 200

CHICAGO, IL 60661 (312) 775-6507 EXT. 2219 OFFICE (219) 712-6590 CELL BGARVER@STARBUCKS.COM

> LANDLORD: MIMI TRUST MARK SAIGH 39 EAST ALTADENA DRIVE

PASADENA, CA 91107 (626) 437-1804 OFFICE MSAIGH @CHARTER.NET

ARCHITECT OF NORR ILLINOIS INC. RECORD: 325 N. LASALLE STREET, SUITE 700 CHICAGO, IL 60654 (312) 424-2400 PHONE


(312) 424-2424 FAX

(314) 772-0109 FAX

MEP CONSULTANT OF ALKEMEYER AND ASSOCIATES 335 MARSHALL AVENUE, SUITE 100 ST. LOUIS, MO 63119 (314) 772-1782 PHONE

ARCHITECTURAL SYMBOL LEGEND

PXXX-ES PAINT TAG

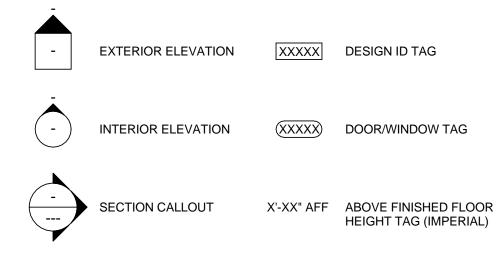



DIMENSION LINE FROM FACE


HEIGHT TAG (METRIC)


XXXX AFF ABOVE FINISHED FLOOR



REVISION CLOUD

VICINITY PLAN

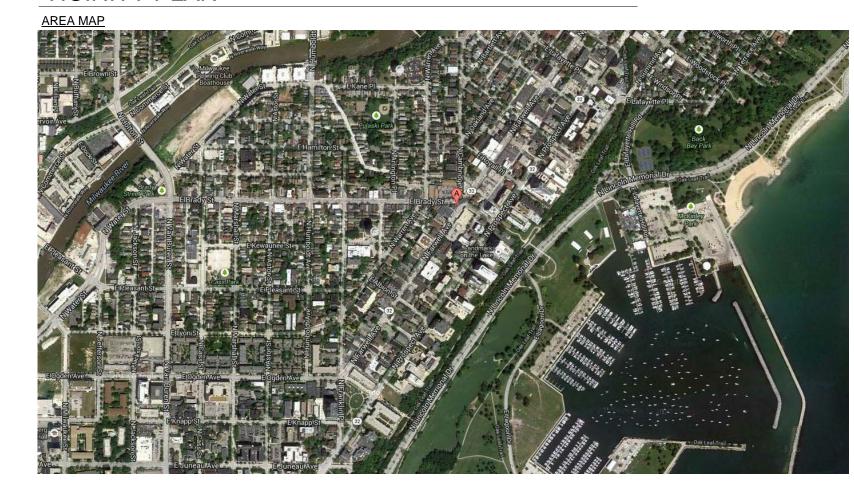

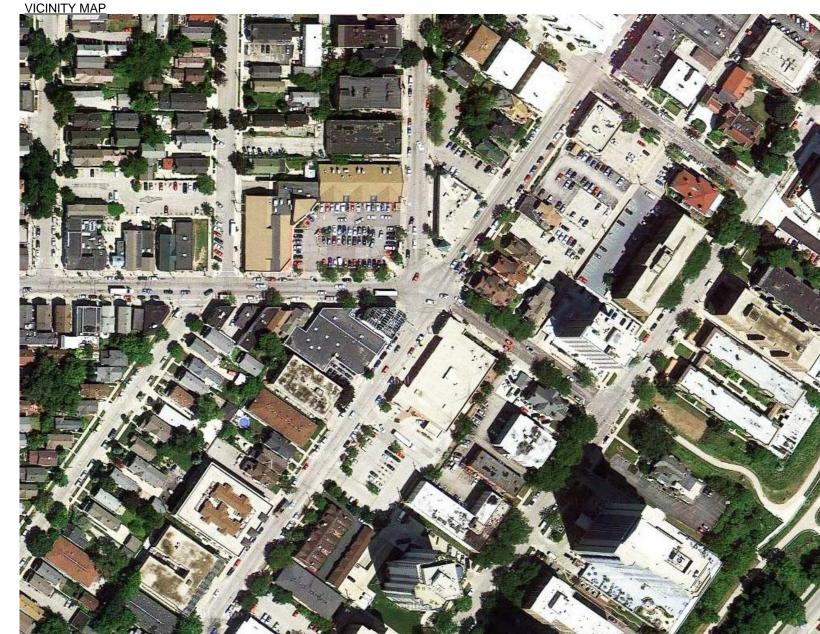





STARBUCKS COFFEE COMPANY 2401 UTAH AVENUE SOUTH

(206) 318-1575 THESE DRAWINGS AND SPECIFICATIONS ARE CONFIDENTIAL AND SHALL REMAIN THE SOLE PROPERTY OF STARBUCKS CORPORATION, WHICH IS REMAIN THE SOLE PROPERTY OF STARBUCKS CORPORATION, WHICH IS THE OWNER OF THE COPYRIGHT IN THIS WORK. THEY SHALL NOT BE REPRODUCED (IN WHOLE OR IN PART), SHARED WITH THIRD PARTIES OR USED IN ANY MANNER ON OTHER PROJECTS OR EXTENSIONS TO THIS PROJECT WITHOUT THE PRIOR WRITTEN CONSENT OF STARBUCKS CORPORATION. THESE DRAWINGS AND SPECIFICATIONS ARE INTENDED TO EXPRESS DESIGN INTENT FOR A PROTOTYPICAL STARBUCKS STORE (WHICH IS SUBJECT TO CHANGE AT ANYTIME) AND DO NOT REFLECT ACTUAL SITE CONDITIONS. NEITHER PARTY SHALL HAVE ANY OBLIGATION NOR LIABILITY TO THE OTHER (EXCEPT STATED ABOVE) UNTIL A WRITTEN AGREEMENT IS FULLY EXECUTED BY BOTH PARTIES.

SEATTLE, WASHINGTON 98134

ARCHITECT OF RECORD

UNTIL A WRITTEN AGREEMENT IS FULLY EXECUTED BY BOTH PARTIES





Mechanical - Electrical - Plumbing

Revision Schedule						
Rev	ev Date By Description					

FARWELI

STORE #: 2305 PROJECT #: 04217-001 CONCEPT: MCS PALETTE: HERITAGE ISSUE DATE: 12 09 13 **DESIGN MANAGER:** S. RYCHLIK LEED® AP: PRODUCTION DESIGNER: C. ALINOVICH CHECKED BY: K. GORIN

SHEET TITLE:


GENERAL INFORMATION

SCALE:

SHEET NUMBER:

G-0001

As indicated

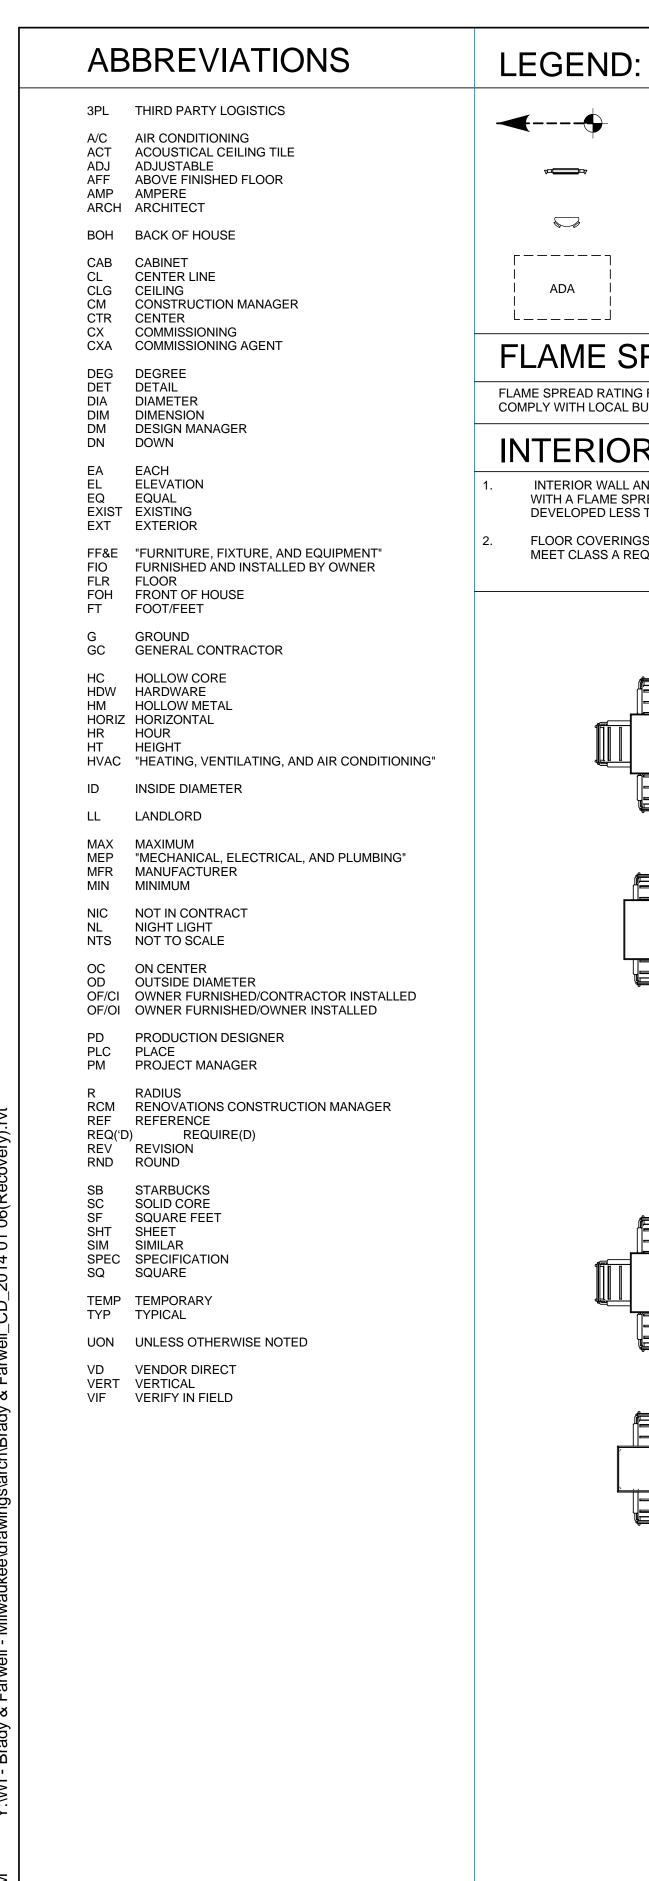

EXIT DIRECTION SIGN LEGEND:

indicate direction of Lighted Faces.

Indicates Inscription, Arrows and Single or Double Faced as Shown. Shaded Quadrants

All Exit Signs Shall Comply with Local Rules and Ordinances and Meet OSHA Requirements.

GC Shall Verify Type of Mounting with Construction Manager for All Exit Signs Prior to Ordering.

SINGLE FACE EXIT SIGNS TRAVEL DISTANCE CODE# SYMBOL FACE DESCRIPTION EXIT **EXIT LIGHT** (SEE REFLECTED CEILING PLAN) WALL MOUNTED EMERGENCY LIGHT (SEE REFLECTED CEILING PLAN) NOTES:

FLAME SPREAD RATING:

CLEAR FLOOR SPACE FOR ACCESSIBILITY

ADA


FLAME SPREAD RATING FOR ALL PROPOSED INTERIOR FINISHES SHALL COMPLY WITH LOCAL BUILDING CODE.

INTERIOR FINISH NOTES:

- INTERIOR WALL AND CEILING FINISH MATERIALS SHALL BE CLASS C WITH A FLAME SPREAD RATING LESS THAN 200 AND SMOKE DEVELOPED LESS THAN 450.
- FLOOR COVERINGS IN THE EXIT PATH OF ALL COMMON AREAS SHALL MEET CLASS A REQUIREMENTS.

ADA KEY

- ACCESSIBLE SEAT REQUIREMENTS: (30) INTERIOR SEATS: 30 x 0.05 = 2 ACCESSIBLE SEAT PROVIDED
- DINING SURFACE AT ADA TABLE AT 28-1/2" AFF
- 30" X 48" CLEAR FOR WHEELCHAIR ACCESS
- 32" MINIMUM CLEAR AT DOOR
- 60: DIAMETER CLEAR FOR WHEELCHAIR ACCESS
- LEVEL LANDING THRESHOLD
- BARRIER-FREE PATH OF TRAVEL
- POS, BARISTA HAND-OFF PLANE AND CONDIMENT COUNTERTOPS AT 2'-10" AFF MAX FOR WHEELCHAIR ACCESSIBILITY
- ACCESSIBLE GRADE CHANGE BETWEEN EXTERIOR PATIO. EXTERIOR WALKWAY AND CONCRETE PAD AT ENTRY DOOR LESS THAN 1/2"
 - EXISTING RAMP TO REMAIN IN REFERENCE TO IBC, <u>CHAPTER 34 EXISTING STRUCTURES</u>, <u>SECTION 3402</u>. TECHNICALLY INFEASIBLE. SECTION 3402 STATES AN ALTERATION OF A BUILDING OR A FACILITY THAT HAS LITTLE LIKELIHOOD OF BEING ACCOMPLISHED BECAUSE THE EXISTING STRUCTURAL CONDITIONS REQUIRE THE REMOVAL OR ALTERATION OF A LOAD-BEARING MEMBER THAT IS AN ESSENTIAL PART OF THE STRUCTURAL FRAME, OR BECAUSE OTHER EXISTING PHYSICAL OR SITE CONSTRAINTS PROHIBIT MODIFICATION OR ADDITION OF ELEMENTS, SPACES, OR FEATURES WHICH ARE IN FULL AND STRUCT COMPLIANCE WITH THE MINIMUM REQUIREMENTS FOR NEW CONSTRUCTION AND WHICH ARE NECESSARY TO PROVIDE ACCESSIBILITY.

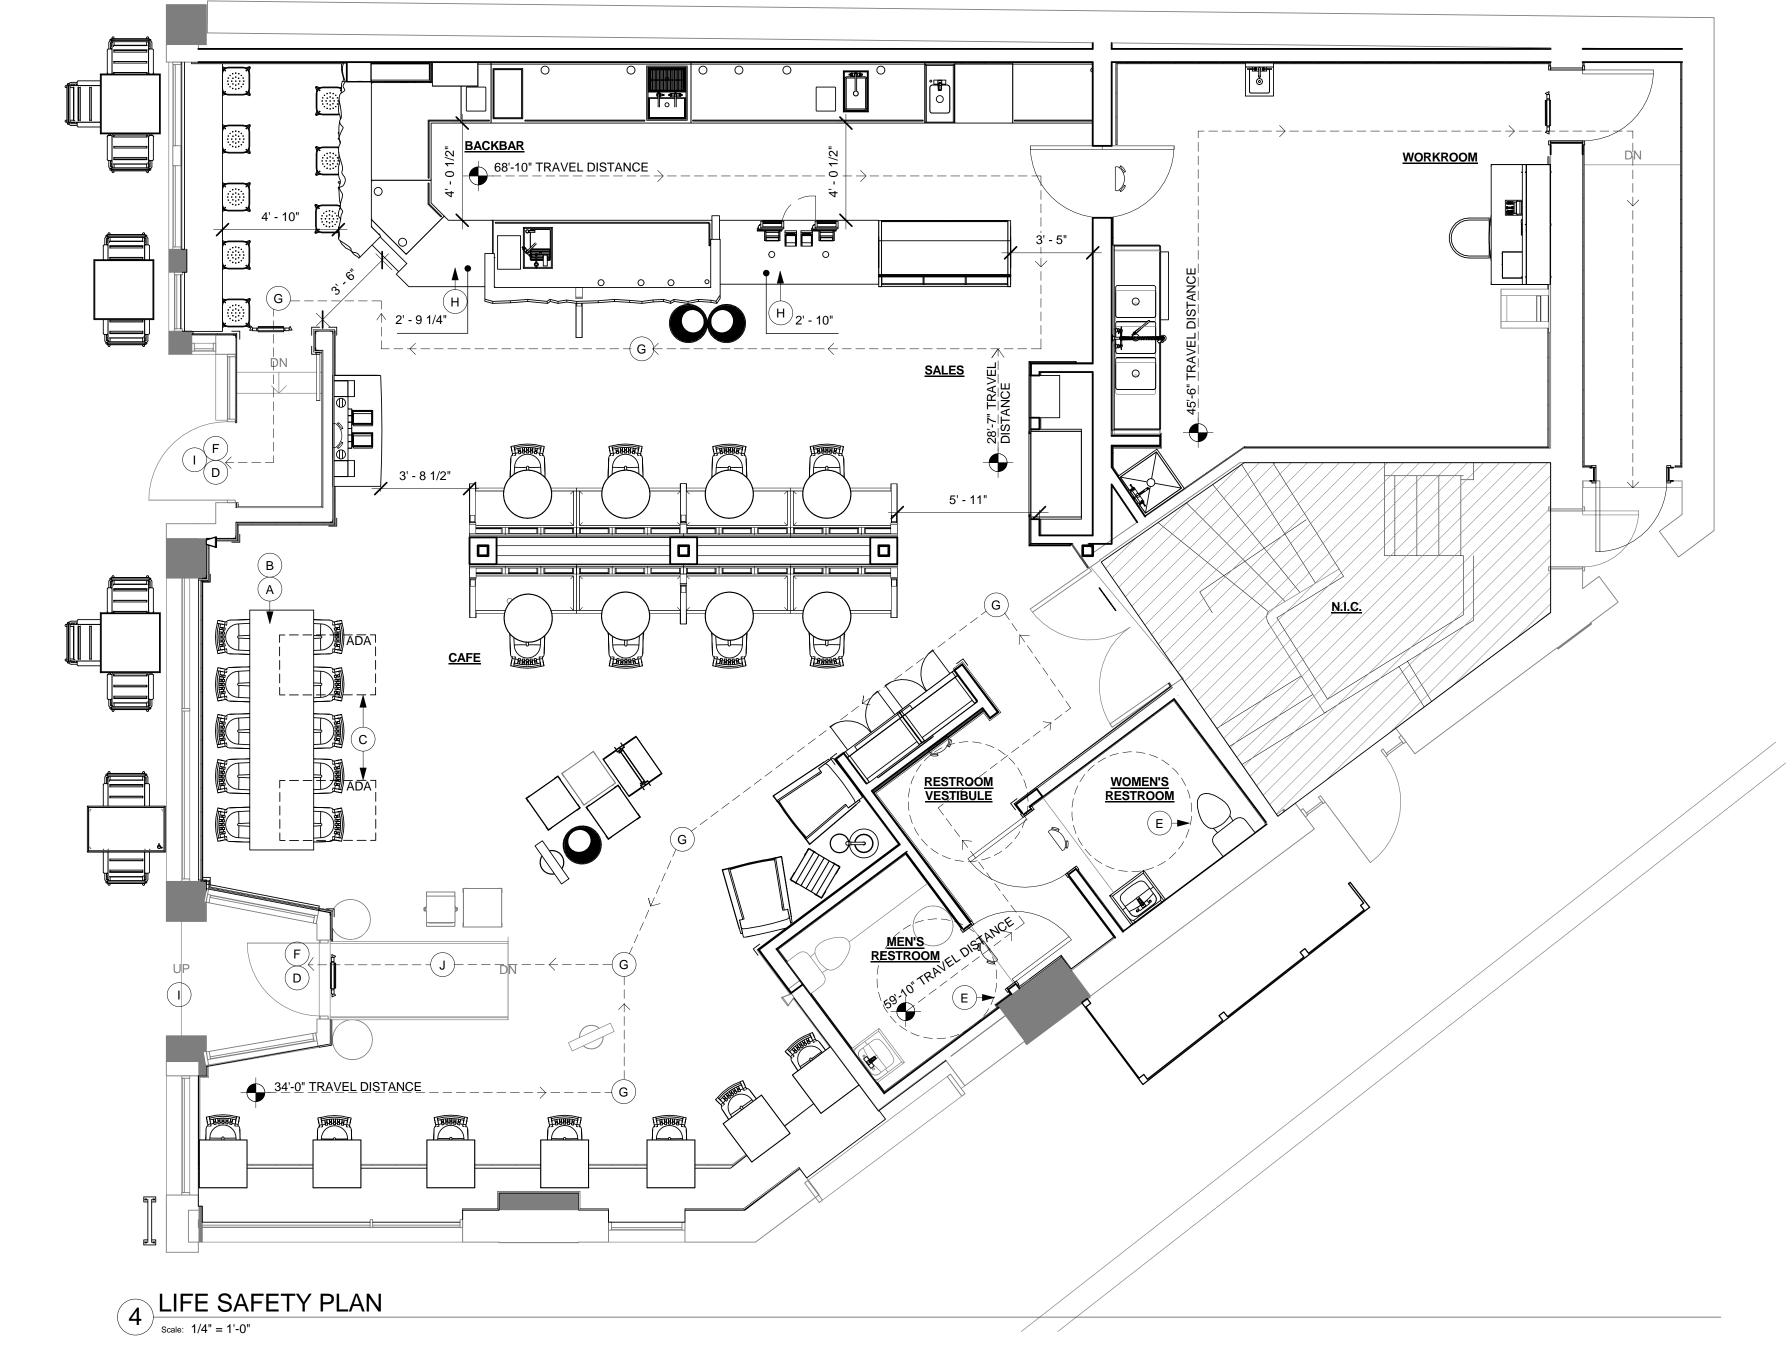



STARBUCKS COFFEE COMPANY 2401 UTAH AVENUE SOUTH

SEATTLE, WASHINGTON 98134

(206) 318-1575

THESE DRAWINGS AND SPECIFICATIONS ARE CONFIDENTIAL AND SHALL REMAIN THE SOLE PROPERTY OF STARBUCKS CORPORATION, WHICH IS THE OWNER OF THE COPYRIGHT IN THIS WORK. THEY SHALL NOT BE REPRODUCED (IN WHOLE OR IN PART), SHARED WITH THIRD PARTIES OR USED IN ANY MANNER ON OTHER PROJECTS OR EXTENSIONS TO THIS PROJECT WITHOUT THE PRIOR WRITTEN CONSENT OF STARBUCKS CORPORATION. THESE DRAWINGS AND SPECIFICATIONS ARE INTENDED TO EXPRESS DESIGN INTENT FOR A PROTOTYPICAL STARBUCKS STORE (WHICH IS SUBJECT TO CHANGE AT ANYTIME) AND DO NOT REFLECT ACTUAL SITE CONDITIONS. NEITHER PARTY SHALL HAVE ANY OBLIGATION NOR LIABILITY TO THE OTHER (EXCEPT STATED ABOVE) UNTIL A WRITTEN AGREEMENT IS FULLY EXECUTED BY BOTH PARTIES.

ARCHITECT OF RECORD





Engineering Consultants Mechanical - Electrical - Plumbing

Revision Schedule

STORE #: 2305 PROJECT #: 04217-001 MCS CONCEPT: PALETTE: HERITAGE ISSUE DATE: 12 09 13 **DESIGN MANAGER:** S. RYCHLIK LEED $^{ extsf{R}}$ AP: PRODUCTION DESIGNER: C. ALINOVICH K. GORIN CHECKED BY:

SHEET TITLE:

LIFE SAFETY PLAN

SCALE:

SHEET NUMBER:

G-0002

1/4" = 1'-0"

1. INSTALL EXTERIOR SIGNAGE AS INDICATED ON EXTERIOR ELEVATIONS.

2. CONSTRUCT INTERIOR PARTITION WALLS AS INDICATED ON FLOOR PLAN.

3. AFTER GC IS AWARDED PROJECT, GC TO VERIFY EXISTING TENANT SPACE DIMENSIONS PRIOR TO CONSTRUCTION.

4. INSTALL CASEWORK ITEMS AS INDICATED ON CASEWORK PLAN.

5. INSTALL CONDIMENT CART AS INDICATED ON CASEWORK PLAN.

6. INSTALL PLUMBING ITEMS AS INDICATED ON FF&E PLAN.

8. INSTALL NEW GRAPHICS AS INDICATED ON INTERIOR ELEVATIONS SHEETS.

9. INSTALL FURNITURE AS INDICATED ON FF&E PLAN.

7. INSTALL EQUIPMENT AS INDICATED ON FF&E PLAN.

10. INSTALL MERCHANDISE BAYS AS INDICATED ON FURNITURE PLAN.

11. INSTALL NEW CONVENIENCE OUTLETS AS INDICATED ON PENETRATION PLAN.

12. INSTALL CHAIR RAIL AND WAINSCOT AS INDICATED ON WALL FINISH AND CASEWORK AND WALL FINISH PLAN.

13. INSTALL WALL FINISHES THROUGHOUT AS INDICATED ON INTERIOR ELEVATIONS.

14. INSTALL FLOOR FINISHES AS INDICATED ON FLOOR FINISH PLAN.

15. INSTALL LIGHT FIXTURES AS INDICATED ON REFLECTED CEILING AND LIGHTING DESIGN PLANS.

CEILING PLANS.

17. PATCH, PRIME, AND PAINT WALL, CEILINGS AND/OR SOFFITS AS INDICTED ON REFLECTED

16. INSTALL CEILING FINISHES AS INDICATED ON REFLECTED CEILING AND DIMENSIONED

CEILING PLANS AND INTERIOR ELEVATIONS.

18. INSTALL BIKE RACK AS INDICATED. BIKE RACK PROVIDED BY STARBUCKS, INSTALLED BY GC.

19. INSTALL WALL OF CHILL AS INDICATED ON CASEWORK AND FF& E PLANS.

20. GC TO COORDINATE WITH LANDLORD AND SUBCONTRACTOR FOR ALL FIRE PROTECTION SYSTEMS REQUIRED BY LOCAL JURISDICTION.

21. EXISTING RAMP TO REMAIN IN REFERENCE TO IBC, <u>CHAPTER 34 EXISTING STRUCTURES</u>, <u>SECTION 3402</u>. TECHNICALLY INFEASIBLE. SECTION 3402 STATES AN ALTERATION OF A BUILDING OR A FACILITY THAT HAS LITTLE LIKELIHOOD OF BEING ACCOMPLISHED BECAUSE THE EXISTING STRUCTURAL CONDITIONS REQUIRE THE REMOVAL OR ALTERATION OF A LOAD-BEARING MEMBER THAT IS AN ESSENTIAL PART OF THE STRUCTURAL FRAME, OR BECAUSE OTHER EXISTING PHYSICAL OR SITE CONSTRAINTS PROHIBIT MODIFICATION OR ADDITION OF ELEMENTS, SPACES, OR FEATURES WHICH ARE IN FULL AND STRUCT COMPLIANCE WITH THE MINIMUM REQUIREMENTS FOR NEW CONSTRUCTION AND WHICH ARE NECESSARY TO PROVIDE ACCESSIBILITY.



STARBUCKS COFFEE COMPANY 2401 LITAH AVENUE SOUTH

2401 UTAH AVENUE SOUTH SEATTLE, WASHINGTON 98134 (206) 318-1575

THESE DRAWINGS AND SPECIFICATIONS ARE CONFIDENTIAL AND SHALL REMAIN THE SOLE PROPERTY OF STARBUCKS CORPORATION, WHICH IS THE OWNER OF THE COPYRIGHT IN THIS WORK. THEY SHALL NOT BE REPRODUCED (IN WHOLE OR IN PART), SHARED WITH THIRD PARTIES OR USED IN ANY MANNER ON OTHER PROJECTS OR EXTENSIONS TO THIS PROJECT WITHOUT THE PRIOR WRITTEN CONSENT OF STARBUCKS CORPORATION. THESE DRAWINGS AND SPECIFICATIONS ARE INTENDED TO EXPRESS DESIGN INTENT FOR A PROTOTYPICAL STARBUCKS STORE (WHICH IS SUBJECT TO CHANGE AT ANYTIME) AND DO NOT REFLECT ACTUAL SITE CONDITIONS. NEITHER PARTY SHALL HAVE ANY OBLIGATION NOR LIABILITY TO THE OTHER (EXCEPT STATED ABOVE) UNTIL A WRITTEN AGREEMENT IS FULLY EXECUTED BY BOTH PARTIES.

ARCHITECT OF RECORD





St. Louis, Missouri 63119
Phone (314) 772-1782
Fax (314) 373-3514

Engineering Consultants

Engineering Consultants
Mechanical - Electrical - Plumbing

Revision Schedule						
Rev	v Date By Description					

DY & FARWELL TADDRESS: N. FARWELL STREET AUKEE, WI 53202 AUKEE COUNTY

STORE #: 2305

PROJECT #: 04217-001

CONCEPT: MCS

PALETTE: HERITAGE

ISSUE DATE: 12 09 13

DESIGN MANAGER: S. RYCHLIK

LEED® AP: N/A

PRODUCTION DESIGNER: C. ALINOVICH

CHECKED BY: K. GORIN

SHEET TITLE:

SCOPE OF WORK PLAN

1/4" = 1'-0"

SCALE:

SHEET NUMBER:

G-0003

SCOPE OF WORK

Scale: 1/4" = 1'-0"

0 2' 4' 8'
Scale: 1/4" = 1'-0"

SECTIO	ON 014200 - RE	FERENCES
	1 - GENERAL	FERENCES
1.1	INDUSTRY ST	
		ICABILITY OF STANDARDS: UNLESS THE CONTRACT DOCUMENTS UDE MORE STRINGENT REQUIREMENTS, APPLICABLE CONSTRUCTION
	INDU	STRY STANDARDS HAVE THE SAME FORCE AND EFFECT AS IF BOUND
		OPIED DIRECTLY INTO THE CONTRACT DOCUMENTS TO THE EXTENT RENCED. SUCH STANDARDS ARE MADE A PART OF THE CONTRACT
		UMENTS BY REFERENCE.
		LICATION DATES: COMPLY WITH STANDARDS IN EFFECT AS OF DATE OF
		CONTRACT DOCUMENTS UNLESS OTHERWISE INDICATED. ES OF STANDARDS: EACH ENTITY ENGAGED IN CONSTRUCTION ON
	PRO	JECT SHOULD BE FAMILIAR WITH INDUSTRY STANDARDS APPLICABLE TO
		CONSTRUCTION ACTIVITY. COPIES OF APPLICABLE STANDARDS ARE NOT NO WITH THE CONTRACT DOCUMENTS.
	1.	WHERE COPIES OF STANDARDS ARE NEEDED TO PERFORM A
		REQUIRED CONSTRUCTION ACTIVITY, OBTAIN COPIES DIRECTLY
1.2	ABBREVIATIO	FROM PUBLICATION SOURCE. DNS AND ACRONYMS
		STRY ORGANIZATIONS: WHERE ABBREVIATIONS AND ACRONYMS ARE
		O IN SPECIFICATIONS OR OTHER CONTRACT DOCUMENTS, THEY SHALL IN THE RECOGNIZED NAME OF THE ENTITIES IN THE FOLLOWING LIST.
	ACI AHA	AMERICAN CONCRETE INSTITUTE AMERICAN HARDBOARD ASSOCIATION
	AITC	AMERICAN INSTITUTE OF TIMBER CONSTRUCTION
	ANSI	AMERICAN NATIONAL STANDARDS INSTITUTE
	APA ASHRAE	APA - THE ENGINEERED WOOD ASSOCIATION AMERICAN SOCIETY OF HEATING, REFRIGERATING AND
		AIR-CONDITIONING ENGINEERS
	ASTM	ASTM INTERNATIONAL (AMERICAN SOCIETY FOR TESTING AND MATERIALS INTERNATIONAL)
	AWI	ARCHITECTURAL WOODWORK INSTITUTE
	AWPA	AMERICAN WOOD PROTECTION ASSOCIATION (FORMERLY: AMERICAN WOOD PRESERVERS' ASSOCIATION)
	CRI	CARPET AND RUG INSTITUTE (THE)
	CRRC	COOL ROOF RATING COUNCIL (
	CSA CSA	CANADIAN STANDARDS ASSOCIATION CSA INTERNATIONAL
		(FORMERLY: IAS - INTERNATIONAL APPROVAL SERVICES)
	CSI ETL SEMCO	CONSTRUCTION SPECIFICATIONS INSTITUTE (THE) INTERTEK ETL SEMCO
		(FORMERLY: ITS - INTERTEK TESTING SERVICE NA)
	FM GLOBAL	FM GLOBAL (FORMERLY: FMG - FM GLOBAL)
	FSC	FOREST STEWARDSHIP COUNCIL
	HPVA ISO	HARDWOOD PLYWOOD & VENEER ASSOCIATION INTERNATIONAL ORGANIZATION FOR STANDARDIZATION
	ITS	INTERTEK TESTING SERVICE NA
	NACNAN	(NOW ETL SEMCO)
	MFMA MPI	MAPLE FLOORING MANUFACTURERS ASSOCIATION, INC. MASTER PAINTERS INSTITUTE
	NFPA	NFPA
	NOFMA	(NATIONAL FIRE PROTECTION ASSOCIATION) NOFMA: THE WOOD FLOORING MANUFACTURERS ASSOCIATION
		(FORMERLY: NATIONAL OAK FLOORING MANUFACTURERS
	OPL	ASSOCIATION) INTERTAK
	SDI	STEEL DOOR INSTITUTE
	SMACNA	SHEET METAL AND AIR CONDITIONING CONTRACTORS' NATIONAL ASSOCIATION
	UL	UNDERWRITERS LABORATORIES INC.
	USGBC WCLIB	U.S. GREEN BUILDING COUNCIL WEST COAST LUMBER INSPECTION BUREAU
	WI	WOODWORK INSTITUTE (FORMERLY: WIC - WOODWORK INSTITUTE
	D 005	OF CALIFORNIA)
		E AGENCIES: WHERE ABBREVIATIONS AND ACRONYMS ARE USED IN CIFICATIONS OR OTHER CONTRACT DOCUMENTS, THEY SHALL MEAN
	THE	RECOGNIZED NAME OF THE ENTITIES IN THE FOLLOWING LIST.
	DIN ICC	DEUTSCHES INSTITUT FUR NORMUNG E.V. INTERNATIONAL CODE COUNCIL
	ICC-ES	ICC EVALUATION SERVICE, INC.
	C.	FEDERAL GOVERNMENT AGENCIES: WHERE ABBREVIATIONS AND ACRONYMS ARE USED IN SPECIFICATIONS OR OTHER CONTRACT
		DOCUMENTS, THEY SHALL MEAN THE RECOGNIZED NAME OF THE
	EPA	ENTITIES IN THE FOLLOWING LIST. ENVIRONMENTAL PROTECTION AGENCY
	D. STAN	IDARDS AND REGULATIONS: WHERE ABBREVIATIONS AND ACRONYMS
		USED IN SPECIFICATIONS OR OTHER CONTRACT DOCUMENTS, THEY LL MEAN THE RECOGNIZED NAME OF THE STANDARDS AND REGULATIONS
		IE FOLLOWING LIST.
	ADAAG	AMERICANS WITH DISABILITIES ACT (ADA) ARCHITECTURAL BARRIERS ACT (ABA)
		ACCESSIBILITY GUIDELINES FOR BUILDINGS AND FACILITIES
	OED	AVAILABLE FROM U.S. ACCESS BOARD
	CFR	CODE OF FEDERAL REGULATIONS AVAILABLE FROM GOVERNMENT PRINTING OFFICE
		E GOVERNMENT AGENCIES: WHERE ABBREVIATIONS AND ACRONYMS
		USED IN SPECIFICATIONS OR OTHER CONTRACT DOCUMENTS, THEY LL MEAN THE RECOGNIZED NAME OF THE ENTITIES IN THE FOLLOWING
	LIST.	
	CDHS CDPH	CALIFORNIA DEPARTMENT OF HEALTH SERVICES CALIFORNIA DEPARTMENT OF PUBLIC HEALTH, INDOOR AIR QUALITY
		SECTION
END O	F SECTION 014	200

GENERAL CONDITIONS

GENERAL CONDITIONS (CONTINUED) SECTION 017419 - CONSTRUCTION WASTE MANAGEMENT AND DISPOSAL SALVAGING NONHAZARDOUS DEMOLITION AND CONSTRUCTION WASTE RECYCLING NONHAZARDOUS DEMOLITION AND CONSTRUCTION WASTE DISPOSING OF NONHAZARDOUS DEMOLITION AND CONSTRUCTION WASTE. 1.2 DEFINITIONS CONSTRUCTION WASTE: BUILDING AND SITE IMPROVEMENT MATERIALS AND OTHER SOLID WASTE RESULTING FROM CONSTRUCTION, REMODELING. RENOVATION, OR REPAIR OPERATIONS. CONSTRUCTION WASTE INCLUDES DEMOLITION WASTE: BUILDING AND SITE IMPROVEMENT MATERIALS RESULTING FROM DEMOLITION OR SELECTIVE DEMOLITION OPERATIONS DISPOSAL: REMOVAL OFF-SITE OF DEMOLITION AND CONSTRUCTION WASTE AND SUBSEQUENT SALE, RECYCLING, REUSE, OR DEPOSIT IN LANDFILL OR INCINERATOR ACCEPTABLE TO AUTHORITIES HAVING RECYCLE: RECOVERY OF DEMOLITION OR CONSTRUCTION WASTE FOR SUBSEQUENT PROCESSING IN PREPARATION FOR REUSE. SALVAGE: RECOVERY OF DEMOLITION OR CONSTRUCTION WASTE AND SUBSEQUENT SALE OR REUSE IN ANOTHER FACILITY. SALVAGE AND REUSE: RECOVERY OF DEMOLITION OR CONSTRUCTION WASTE AND SUBSEQUENT INCORPORATION INTO THE WORK. PERFORMANCE REQUIREMENTS END-OF-PROJECT RATES FOR SALVAGE/RECYCLING: 75 PERCENT. ACTION SUBMITTALS WASTE MANAGEMENT PLAN: SUBMIT PLAN WITHIN 7 DAYS OF DATE ESTABLISHED FOR COMMENCEMENT OF THE WORK. TYPES AND QUANTITIES OF DEMOLITION AND CONSTRUCTION TYPE OF WASTE AND WHETHER IT WILL BE SALVAGED, RECYCLED, OR DISPOSED OF IN LANDFILL OR INCINERATOR. NET ADDITIONAL COST OR NET SAVINGS RESULTING FROM WASTE MANAGEMENT PLAN. 1.5 INFORMATION SUBMITTALS WASTE REDUCTION PROGRESS REPORTS: CONCURRENT WITH EACH APPLICATION FOR PAYMENT, SUBMIT REPORT INDICATING TYPE OF WASTE AND WHETHER IT HAS BEEN SALVAGED, RECYCLED, OR DISPOSED OF IN LANDFILL OR INCINERATOR. WASTE DISPOSAL RECORDS: INDICATE RECEIPT AND ACCEPTANCE OF WASTE MATERIAL BY ACCEPTING AND PROCESSING FACILITIES LICENSED TO ACCEPT THEM. INCLUDE MANIFESTS, TYPE OF MATERIAL, WEIGHT OR VOLUME TICKETS, RECEIPTS, AND INVOICES. LEED SUBMITTAL: CWM REPORTING TEMPLATE, TABULATING TOTAL WASTE MATERIAL, QUANTITIES DIVERTED AND MEANS BY WHICH IT IS DIVERTED, AND STATEMENT THAT REQUIREMENTS FOR THE CREDIT HAVE RECYCLING WASTE RECYCLING INCENTIVES: REVENUES AND OTHER INCENTIVES FOR RECYCLING WILL ACCRUE TO OWNER. **END OF SECTION 017419 SECTION 019113 - GENERAL COMMISSIONING REQUIREMENTS** SUMMARY MEMBERS REPRESENTING CONTRACTOR, INCLUDING PROJECT SUPERINTENDENT AND SUBCONTRACTORS, INSTALLERS, SUPPLIERS, AND SPECIALISTS. MEMBERS REPRESENTING OWNER, INCLUDING COMMISSIONING AGENT (CXA), FACILITY USER AND OPERATION AND MAINTENANCE PERSONNEL, AND ARCHITECT AND ENGINEERING DESIGN PROFESSIONALS. CONTRACTOR'S RESPONSIBILITIES: CONTRACTOR SHALL ASSIGN REPRESENTATIVES WITH EXPERTISE AND AUTHORITY TO ACT ON ITS BEHALF AND SHALL SCHEDULE THEM TO PARTICIPATE IN AND PERFORM COMMISSIONING PROCESS ACTIVITIES INCLUDING, BUT NOT LIMITED TO, THE FOLLOWING: INTEGRATE AND COORDINATE COMMISSIONING PROCESS ACTIVITIES WITH CONSTRUCTION SCHEDULE. REVIEW AND ACCEPT COMMISSIONING CHECKLISTS AND PROCESS TEST PROCEDURES PROVIDED BY THE COMMISSIONING AGENT (CXA) SUPPORT COMMISSIONING INSTALLATION REVIEW AND PROCESS **EVALUATE INSTALLATION AND PERFORMANCE DEFICIENCIES** IDENTIFIED IN REPORTS AND, IN COLLABORATION WITH ENTITY RESPONSIBLE FOR SYSTEM AND EQUIPMENT INSTALLATION, RECOMMEND CORRECTIVE ACTION. COOPERATE WITH THE COMMISSIONING TEAM FOR RESOLUTION OF ISSUES RECORDED IN THE ISSUES LOG. COMMISSIONING AGENT'S (CXA'S) RESPONSIBILITIES: ORGANIZE AND LEAD COMMISSIONING TEAM. PROVIDE AND MANAGE COMMISSIONING PLAN.

PROVIDE PROJECT-SPECIFIC CHECKLISTS AND TEST PROCEDURES.

WITNESS, PREPARE AND MAINTAIN COMPLETED INSTALLATION

WITNESS SYSTEMS, ASSEMBLIES, EQUIPMENT, AND COMPONENT

WITNESS, PREPARE, AND MAINTAIN COMPLETED FUNCTIONAL

DEFICIENCIES; INCLUDE THEM IN THE SYSTEMS MANUAL AND

REVIEW COMMISSIONING REPORT WITH COMMISSIONING TEAM AND

COMPILE COMMISSIONING DOCUMENTS, RESULTS, AND

VERIFICATION CHECKLISTS.

PREPARE AND MAINTAIN THE ISSUES LOG.

IMPLEMENT PLAN TO RESOLVE DEFICIENCIES.

COMMISSIONING SUMMARY REPORT.

TESTING CHECKLISTS.

END OF SECTION 019113

```
EXISTING CONDITIONS
                                                                                           CONCRETE
 SECTION 024119 - SELECTIVE DEMOLITION
      SUMMARY
            DEMOLITION AND REMOVAL OF PORTIONS OF A BUILDING OR STRUCTURE.
                                                                                           1.1 SUMMARY
             HISTORIC ITEMS REMOVED AND SALVAGED FOR OWNER.
     SUBMITTALS
            SCHEDULE OF SELECTIVE DEMOLITION ACTIVITIES: INDICATE THE
                   DETAILED SEQUENCE OF SELECTIVE DEMOLITION AND REMOVAL
                   WORK, WITH STARTING AND ENDING DATES FOR EACH ACTIVITY.
                   ENSURE OWNER'S [BUILDING MANAGER'S] [AND] [OTHER TENANTS']
                   ON-SITE OPERATIONS ARE UNINTERRUPTED.
                   INTERRUPTION OF UTILITY SERVICES. INDICATE HOW LONG UTILITY
                    SERVICES WILL BE INTERRUPTED.
                   COORDINATION FOR SHUTOFF, CAPPING, AND CONTINUATION OF
                   UTILITY SERVICES.
                   USE OF ELEVATOR AND STAIRS.
                   COORDINATION OF OWNER'S CONTINUING OCCUPANCY OF
                   PORTIONS OF EXISTING BUILDING AND OF OWNER'S PARTIAL
                   OCCUPANCY OF COMPLETED WORK.
1.3 PROJECT CONDITIONS
            OWNER WILL NOT OCCUPY PORTIONS OF BUILDING IMMEDIATELY
             ADJACENT TO SELECTIVE DEMOLITION AREA.
            HAZARDOUS MATERIALS: UNKNOWN WHETHER HAZARDOUS MATERIALS WILL
             BE ENCOUNTERED. IF ENCOUNTERED, OWNER WILL REMOVE HAZARDOUS
             MATERIALS UNDER A SEPARATE CONTRACT.
J1.5 EXECUTION
            UTILITY SERVICES AND MECHANICAL/ELECTRICAL SYSTEMS: MAINTAINED TO
                   SHUT OFF: BY [OWNER] [BUILDING MANAGER] [CONTRACTOR].
            SITE ACCESS AND TEMPORARY CONTROLS: MINIMUM INTERFERENCE WITH
             ROADS, STREETS, WALKS, WALKWAYS, AND OTHER ADJACENT OCCUPIED
             AND USED FACILITIES
            TEMPORARY FACILITIES: PROVIDE TEMPORARY BARRICADES AND OTHER
             PROTECTION REQUIRED TO PREVENT INJURY TO PEOPLE AND DAMAGE TO
             ADJACENT BUILDINGS AND FACILITIES TO REMAIN.
            TEMPORARY SHORING: PROVIDE AND MAINTAIN SHORING, BRACING, AND
             STRUCTURAL SUPPORTS AS REQUIRED TO PRESERVE STABILITY AND
             PREVENT MOVEMENT, SETTLEMENT, OR COLLAPSE OF CONSTRUCTION AND
             FINISHES TO REMAIN. AND TO PREVENT UNEXPECTED OR UNCONTROLLED
             MOVEMENT OR COLLAPSE OF CONSTRUCTION BEING DEMOLISHED.
             REMOVED AND SALVAGED ITEMS: CLEANED, CRATED, STORED, AND
             TRANSPORTED TO OWNER'S ON-SITE STORAGE AREA.
             REMOVED AND REINSTALLED ITEMS: CLEANED, REPAIRED, CRATED,
             STORED, AND REINSTALLED.
             EXISTING ITEMS TO REMAIN: EXISTING CONSTRUCTION PROTECTED
             AGAINST DAMAGE.
            DISPOSAL OF DEMOLISHED ITEMS:
                   BURNING: NOT PERMITTED.
                   DISPOSAL: COMPLY WITH REQUIREMENTS SECTION 017419
                    "CONSTRUCTION WASTE MANAGEMENT AND DISPOSAL".
END OF SECTION 024119
```



AND FINISHES, FOR THE FOLLOWING: FOOTINGS.

FOUNDATION WALLS. SLABS-ON-GRADE. 1.2 SUBMITTALS

PRODUCT DATA: FOR EACH TYPE OF PRODUCT INDICATED. SHOP DRAWINGS: REINFORCING: PLACING DRAWINGS THAT DETAIL FABRICATION, BENDING, AND PLACEMENT. INCLUDE BAR SIZES, LENGTHS,

> BAR DIAGRAMS. BAR ARRANGEMENT, SPLICES AND LAPS, MECHANICAL CONNECTIONS, TIE SPACING, HOOP SPACING, AND SUPPORTS FOR CONCRETE REINFORCEMENT. SLAB LAYOUTS: DIMENSION LOCATIONS OF CONTROL EXPANSION, AND CONSTRUCTION JOINTS. RELATE TO BUILDING

MATERIAL, GRADE, BAR SCHEDULES, STIRRUP SPACING, BENT

GRID LINES. DESIGN MIXTURES: FOR EACH CONCRETE MIXTURE. SUBMIT ALTERNATE DESIGN MIXTURES WHEN CHARACTERISTICS OF MATERIALS, PROJECT CONDITIONS, WEATHER, TEST RESULTS, OR OTHER CIRCUMSTANCES WARRANT ADJUSTMENTS.

INDICATE AMOUNTS OF MIXING WATER TO BE WITHHELD FOR LATER ADDITION AT PROJECT SITE. CERTIFICATIONS: SUBMIT MILL CERTIFICATES FOR CEMENT

AGGREGATES, AND REINFORCING. MATERIALS

STEEL REINFORCEMENT: REINFORCING BARS: DEFORMED. MINIMUM RECYCLED CONTENT: 60%

PLAIN-STEEL WELDED WIRE REINFORCEMENT: ASTM A 185, PLAIN, FABRICATED FROM AS-DRAWN STEEL WIRE INTO FLAT CONCRETE MATERIALS:

PORTLAND CEMENT: ASTM C 150, TYPE I, GRAY, SUPPLEMENT WITH THE FOLLOWING:

FLY ASH: ASTM C 618, CLASS F OR C. GROUND GRANULATED BLAST-FURNACE SLAG: ASTM C989, GRADE 100 OR 120.

AGGREGATE: NORMAL WEIGHT. WATER: ASTM C 94/C 94M.

ADMIXTURES: PROVIDE ADMIXTURES CERTIFIED BY MANUFACTURER TO BE COMPATIBLE WITH OTHER ADMIXTURES AND THAT WILL NOT CONTRIBUTE WATER-SOLUBLE CHLORIDE IONS EXCEEDING THOSE PERMITTED IN HARDENED CONCRETE DO NOT USE CALCIUM CHLORIDE OR ADMIXTURES CONTAINING CALCIUM CHLORIDE. AIR-ENTRAINMENT: ASTM C 260.

WATER-REDUCING ADMIXTURE: ASTM C 494/C 494M, TYPF A

HIGH-RANGE, WATER-REDUCING ADMIXTURE: ASTM C494/C 494M, TYPE F. WATERSTOPS: FLEXIBLE RUBBER.

EXPANSION- AND ISOLATION-JOINT-FILLER STRIPS ASTM D 1751,

PLASTIC VAPOR RETARDER: ASTM E 1745, CLASS A. INCLUDE MANUFACTURER'S RECOMMENDED ADHESIVE OR PRESSURE-SENSITIVE

CURING MATERIALS: WATERBORNE, MONOMOLECULAR FILM FORMING, MANUFACTURED FOR APPLICATION TO FRESH CONCRETE. RELATED MATERIALS:

ASPHALT-SATURATED CELLULOSIC FIBER OR ASTM D 1752, CORK OR SELF-EXPANDING CORK. BONDING AGENT: ASTM C 1059/C 1059M, TYPE II, NON-REDISPERSIBLE, ACRYLIC EMULSION OR STYRENE

BUTADIENE. NON-SHRINK GROUTS: ASTM C 1107, GRADE B; NON-SHRINK NON-CATALYZED NATURAL AGGREGATE GROUT; MINIMUM COMPRESSIVE STRENGTH OF 7000 PSI AT 28 DAYS; 25 TO 30 SECOND FLOW WHEN TESTED IN ACCORDANCE WITH ASTM C 939 AT 45 TO 90 DEGREES F; CEMENT GRAY IN COL FORM RELEASE COATING: WATER BASED TYPE; VOC <150G/I;

NOX-CRETE "UTILITY RELEASE. CRESSET CHEMICAL COMPANY CRETE 20_VOC," OR APPROVED; NON STAINING.

REPAIR MATERIALS REPAIR UNDERLAYMENT: CEMENT-BASED, POLYMER-MODIFIED, SELF-LEVELING PRODUCT THAT CAN BE APPLIED IN THICKNESSES FROM 1/8 INCH (3.2 MM) AND THAT CAN BE FEATHERED AT EDGES TO MATCH ADJACENT FLOOR ELEVATIONS.

CEMENT BINDER: ASTM C 150, PORTLAND CEMENT OR HYDRAULIC OR BLENDED HYDRAULIC CEMENT AS DEFINED IN ASTM C 219. PRIMER: PRODUCT OF UNDERLAYMENT MANUFACTURER

RECOMMENDED FOR SUBSTRATE, CONDITIONS, AND AGGREGATE: WELL-GRADED, WASHED GRAVEL, 1/8 TO 1/4 INCH (3.2 TO 6 MM) OR COARSE SAND AS

RECOMMENDED BY UNDERLAYMENT MANUFACTURER. COMPRESSIVE STRENGTH: NOT LESS THAN 4100 PSI (29 MPA) AT 28 DAYS WHEN TESTED ACCORDING TO ASTM C 109/C 109M.

REPAIR OVERLAYMENT: CEMENT-BASED, POLYMER-MODIFIED. SELF-LEVELING PRODUCT HAT CAN BE APPLIED IN THICKNESSES FROM 1/8 INCH (3.2 MM) AND THAT CAN BE FEATHERED AT EDGES TO MATCH ADJACENT FLOOR ELEVATIONS. CEMENT BINDER: ASTM C 150, PORTLAND CEMENT OR

HYDRAULIC OR BLENDED HYDRAULIC CEMENT AS DEFINED PRIMER: PRODUCT OF TOPPING MANUFACTURER

RECOMMENDED FOR SUBSTRATE, CONDITIONS, AND APPLICATION. AGGREGATE: WELL-GRADED, WASHED GRAVEL, 1/8 TO

1/4 INCH (3.2 TO 6 MM) OR COARSE SAND AS RECOMMENDED BY TOPPING MANUFACTURER. COMPRESSIVE STRENGTH: NOT LESS THAN 5000 PSI (34.5 MPA) AT 28 DAYS WHEN TESTED ACCORDING TO

1.4 INSTALLATION

FLOOR AND SLAB FINISHES: FLOAT: SURFACES TO RECEIVE TROWEL FINISH. TROWEL: SURFACES EXPOSED TO VIEW, AND SURFACES TO BE COVERED WITH RESILIENT FLOORING, CARPET, CERAMIC OR

ASTM C 109/C 109M.

QUARRY TILE SET OVER A CLEAVAGE MEMBRANE, PAINT, OR ANOTHER THIN-FILM-FINISH COATING SYSTEM. TROWEL AND FINE BROOM: SURFACES TO BE COVERED WITH

CERAMIC OR QUARRY TILE INSTALLED BY EITHER THICKSET OR THIN-SET METHOD. BROOM: EXTERIOR CONCRETE PLATFORMS, STEPS, AND RAMPS.

1.5 FIELD QUALITY CONTROL TESTING: BY CONTRACTOR-ENGAGED AGENCY. INSPECTIONS: BY OWNER-ENGAGED SPECIAL INSPECTOR. END OF SECTION 033000

STARBUCKS COFFEE COMPANY 2401 UTAH AVENUE SOUTH SEATTLE, WASHINGTON 98134 (206) 318-1575

(C)2011 STARBUCKS COFFEE COMPANY

THESE DRAWINGS AND SPECIFICATIONS ARE CONFIDENTIAL AND SHALREMAIN THE SOLE PROPERTY OF STARBUCKS CORPORATION, WHICH I REMAIN THE SOLE PROPERTY OF STARBUCKS CORPORATION, WHICH IS THE OWNER OF THE COPYRIGHT IN THIS WORK. THEY SHALL NOT BE REPRODUCED (IN WHOLE OR IN PART), SHARED WITH THIRD PARTIES OR USED IN ANY MANNER ON OTHER PROJECTS OR EXTENSIONS TO THIS PROJECT WITHOUT THE PRIOR WRITTEN CONSENT OF STARBUCKS CORPORATION. THESE DRAWINGS AND SPECIFICATIONS ARE INTENDED TO EXPRESS DESIGN INTENT FOR A PROTOTYPICAL STARBUCKS STORE (WHICH IS SUBJECT TO CHANGE AT ANYTIME) AND DO NOT REFLECT ACTUAL SITE CONDITIONS. NEITHER PARTY SHALL HAVE ANY OBLIGATION NOR LIABILITY TO THE OTHER (EXCEPT STATED ABOVE) UNTIL A WRITTEN AGREEMENT IS FULLY EXECUTED BY BOTH PARTIES

ARCHITECT OF RECORD

325 N. LaSalle St. |Suite 700 |Chicago, IL 60654 t 312.424.2400 | f 312.424.2424 | www.norr.com ENGINEER OF RECORD

St. Louis, Missouri 63119 Phone (314) 772-1782 Fax (314) 373-3514 **Engineering Consultants** Mechanical - Electrical - Plumbing

Revision Schedule Description Rev Date By

 Δ

STORE #: 2305 PROJECT #: 04217-001 MCS CONCEPT: HERITAGE PALETTE: ISSUE DATE: 12 09 13 **DESIGN MANAGER:** S. RYCHLIK LEED® AP: N/A PRODUCTION DESIGNER: C. ALINOVICH CHECKED BY: K. GORIN

SHEET TITLE:

DESIGN **SPECIFICATIONS**

SHEET NUMBER:

SCALE:

G-0010

CONCRETE (CONTINUED)

FLOOR AND SLAB TREATMENTS VOC CONTENT: FLOOR TREATMENTS SHALL HAVE A VOC CONTENT OF 200 G/L OR LESS WHEN CALCULATED ACCORDING TO 40 CFR 59, SUBPART D (EPA

UNPIGMENTED MINERAL DRY-SHAKE FLOOR HARDENER: FACTORY-PACKAGED DRY COMBINATION OF PORTLAND CEMENT, GRADED QUARTZ AGGREGATE, AND PLASTICIZING ADMIXTURE.

PIGMENTED MINERAL DRY-SHAKE FLOOR HARDENER: FACTORY-PACKAGED, DRY COMBINATION OF PORTLAND CEMENT, GRADED QUARTZ AGGREGATE, COLOR PIGMENTS, AND PLASTICIZING ADMIXTURE. USE COLOR PIGMENTS THAT ARE FINELY GROUND, NONFADING MINERAL OXIDES INTERGROUND WITH

LIQUID FLOOR TREATMENTS VOC CONTENT: LIQUID FLOOR TREATMENTS SHALL HAVE A VOC CONTENT OF 200 G/L OR LESS WHEN CALCULATED ACCORDING TO 40 CFR 59, SUBPART D (EPA METHOD 24)

PENETRATING LIQUID FLOOR TREATMENT: CLEAR, CHEMICALLY REACTIVE. WATERBORNE SOLUTION OF INORGANIC SILICATE OR SILICONATE MATERIALS AND PROPRIETARY COMPONENTS: ODORLESS: THAT PENETRATES, HARDENS, AND DENSIFIES CONCRETE SURFACES. PENETRATING LIQUID FLOOR TREATMENTS FOR POLISHED CONCRETE FINISH:

CLEAR. WATERBORNE SOLUTION OF INORGANIC SILICATE OR SILICONATE MATERIALS AND PROPRIETARY COMPONENTS: ODORLESS: THAT PENETRATES. HARDENS, AND IS SUITABLE FOR POLISHED CONCRETE SURFACES.

1.4 INSTALLATION DRY-SHAKE FLOOR HARDENER FINISH: AFTER INITIAL FLOATING, APPLY DRY-SHAKE FLOOR HARDENER TO SURFACES

PENETRATING LIQUID FLOOR TREATMENT: PREPARE, APPLY, AND FINISH PENETRATING LIQUID FLOOR TREATMENT ACCORDING TO MANUFACTURER'S WRITTEN INSTRUCTIONS. SEALING COAT: UNIFORMLY APPLY A CONTINUOUS SEALING COAT OF CURING

AND SEALING COMPOUND TO HARDENED CONCRETE BY POWER SPRAY OR ROLLER ACCORDING TO MANUFACTURER'S WRITTEN INSTRUCTIONS. PROTECT LIQUID FLOOR TREATMENT FROM DAMAGE AND WEAR DURING THE REMAINDER OF CONSTRUCTION PERIOD. USE PROTECTIVE METHODS AND MATERIALS, INCLUDING TEMPORARY COVERING, RECOMMENDED IN WRITING

BY LIQUID FLOOR TREATMENTS INSTALLER. END OF SECTION 033500

SECTION 035416 - HYDRAULIC-CEMENT-BASED UNDERLAYMENT

SUMMARY HYDRAULIC-CEMENT-BASED UNDERLAYMENT FOR USE BELOW INTERIOR FLOOR COVERINGS.

MATERIALS UNDERLAYMENT: HYDRAULIC-CEMENT-BASED, POLYMER-MODIFIED, SELF-LEVELING PRODUCT THAT CAN BE APPLIED IN MINIMUM UNIFORM THICKNESS OF 1/4 INCH (6MM) AND THAT CAN BE FEATHERED AT EDGES TO MATCH ADJACENT FLOOR ELEVATIONS.

CEMENT BINDER: PORTLAND CEMENT, OR OTHER HYDRAULIC OR BLENDED HYDRAULIC CEMENT PRIMER: PRODUCT OF UNDERLAYMENT MANUFACTURER RECOMMENDED IN WRITING FOR SUBSTRATE, CONDITIONS, AND APPLICATION INDICATED.

PRIMER SHALL HAVE A VOC CONTENT OF 200 G/L OR LESS WHEN

CALCULATED ACCORDING TO 40 CFR 59, SUBPART D. **END OF SECTION 035416**

SECTION 055000 - METAL FABRICATIONS

STEEL FRAMING AND SUPPORTS FOR MECHANICAL AND ELECTRICAL STEEL FRAMING AND SUPPORTS FOR APPLICATIONS WHERE FRAMING AND

SUPPORTS ARE NOT SPECIFIED IN OTHER SECTIONS. SHELF ANGLES. METAL BOLLARDS.

SUBMITTALS 1.2 PRODUCT DATA: FOR THE FOLLOWING: PAINT PRODUCTS.

ALL PREFABRICATED PRODUCTS. SHOP DRAWINGS: SHOW FABRICATION AND INSTALLATION DETAILS FOR METAL FABRICATIONS.

INCLUDE PLANS, ELEVATIONS, SECTIONS, AND DETAILS OF METAL FABRICATIONS AND THEIR CONNECTIONS. SHOW ANCHORAGE AND PROVIDE TEMPLATES FOR ANCHORS AND BOLTS SPECIFIED FOR

INSTALLATION UNDER OTHER SECTIONS. WELDING CERTIFICATES. 1.3 PRODUCTS

MATERIALS: STEEL PLATES, SHAPES, AND BARS, STEEL PIPE, SLOTTED CHANNEL FRAMING. LOW-EMITTING PRIMER: METAL PRIMER SHALL HAVE A VOC CONTENT

> SUBPART D (EPA METHOD 24). MISCELLANEOUS FRAMING AND SUPPORTS: STEEL FRAMING AND SUPPORTS FOR MECHANICAL AND ELECTRICAL EQUIPMENT, APPLICATIONS WHERE FRAMING AND SUPPORTS ARE

OF 200 G/L OR LESS WHEN CALCULATED ACCORDING TO 40 CFR 59,

NOT SPECIFIED IN OTHER SECTIONS. GALVANIZE WHERE INDICATED. PRIME WITH ZINC-RICH PRIMER WHERE INDICATED.

ZINC-RICH PRIMER SHALL HAVE A VOC CONTENT OF 340 G/L OR LESS WHEN CALCULATED ACCORDING TO 40 CFR 59, SUBPART D (EPA METHOD 24). LOOSE STEEL LINTELS, GALVANIZED AT EXTERIOR WALLS.

SHELF ANGLES, GALVANIZED. STEEL WELD PLATES AND ANGLES NOT SPECIFIED IN OTHER SECTIONS, FOR CASTING INTO CONCRETE.

METAL BOLLARDS: SCHEDULE 40 STEEL PIPE. **END OF SECTION 055000**

WOOD AND PLASTICS

SECTION 061053 - MISCELLANEOUS ROUGH CARPENTRY

1.1 MATERIALS WOOD PRODUCTS, GENERAL: MAXIMUM MOISTURE CONTENT OF LUMBER: 15 PERCENT WOOD-PRESERVATIVE-TREATED MATERIALS:

PRESERVATIVE TREATMENT: AWPA U1: USE CATEGORY UC2. PRESERVATIVE CHEMICALS: CONTAINING NO ARSENIC OR CHROMIUM. DO NOT USE INORGANIC BORON (SBX) FOR SILL PLATES. APPLICATION: ITEMS INDICATED AND THE FOLLOWING:

ITEMS IN CONTACT WITH ROOFING OR WATERPROOFING. ITEMS IN CONTACT WITH CONCRETE OR MASONRY. FRAMING LESS THAN 18 INCHES (460 MM) ABOVE GROUND IN

FLOOR PLATES INSTALLED OVER CONCRETE SLABS-ON-GRADE. FIRE-RETARDANT-TREATED MATERIALS: EXTERIOR TYPE FOR EXTERIOR LOCATIONS AND WHERE INDICATED.

INTERIOR TYPE A UNLESS OTHERWISE INDICATED. APPLICATION: ITEMS INDICATED AND THE FOLLOWING: FRAMING FOR RAISED PLATFORMS. CONCEALED BLOCKING. ROOF FRAMING AND BLOCKING. ITEMS IN CONTACT WITH ROOFING.

PLYWOOD BACKING PANELS. FRAMING NON-LOAD-BEARING INTERIOR PARTITIONS: CONSTRUCTION OR NO. 2

MISCELLANEOUS LUMBER: DIMENSION LUMBER: CONSTRUCTION OR NO. 2 GRADE UTILITY SHELVING: 19 PERCENT MAXIMUM MOISTURE CONTENT. CONCEALED BOARDS: 19 PERCENT MAXIMUM MOISTURE CONTENT. PLYWOOD BACKING PANELS: EXPOSURE 1, C-D PLUGGED [, FIRE-RETARDANT

FASTENERS: HOT-DIP GALVANIZED STEEL WHERE EXPOSED TO WEATHER, IN GROUND CONTACT, IN CONTACT WITH TREATED WOOD, OR IN AREA OF HIGH RELATIVE HUMIDITY METAL FRAMING ANCHORS:

METAL: GALVANIZED STEEL; HOT-DIP HEAVY GALVANIZED STEEL FOR WOOD-PRESERVATIVE-TREATED LUMBER AND WHERE INDICATED. ADHESIVES: ADHESIVES SHALL HAVE A VOC CONTENT OF 70 G/L OR LESS WHEN CALCULATED ACCORDING TO 40 CFR 59, SUBPART D (EPA METHOD 24).

FURRING TO RECEIVE PLYWOOD OR HARDBOARD PANELING: 1-BY-3-INCH NOMINAL-SIZE (19-BY-63-MM ACTUAL-SIZE) FURRING AT [24 INCHES (610 MM)] FURRING TO RECEIVE GYPSUM BOARD: 1-BY-2-INCH NOMINAL-SIZE (19-BY-38-

MM ACTUAL-SIZE) FURRING AT [16 INCHES (406 MM)] [400 MM] O.C. **END OF SECTION 061053**

SECTION 064000 - INTERIOR ARCHITECTURAL WOODWORK

INTERIOR STANDING AND RUNNING TRIM. FLUSH WOOD PANELING AND WAINSCOTS. MELAMINE CABINETS. SOLID-SURFACING-MATERIAL COUNTERTOPS.

CLOSET AND UTILITY SHELVING. QUALITY ASSURANCE QUALITY STANDARD: AWI.

1.3 MATERIALS

WOOD PRODUCTS: COMPLY WITH THE FOLLOWING: HARDBOARD: AHA A135.4. MADE WITH BINDER CONTAINING NO UREA FORMALDEHYDE.

MEDIUM-DENSITY FIBERBOARD: ANSI A208.2, GRADE 130, MADE WITH BINDER CONTAINING NO UREA FORMALDEHYDE. MOISTURE RESISTANT MEDIUM-DENSITY FIBERBOARD ANSI A208.2, GRADE MD, MR50, MADE WITH BINDER CONTAINING

NO UREA FORMALDEHYDE. STRAW-BASED PARTICLEBOARD: ANSI A208.1, GRADE M-2, EXCEPT FOR DENSITY, MADE WITH ADHESIVE CONTAINING NO UREA FORMALDEHYDE.

SOFTWOOD PLYWOOD: DOC PS 1 VENEER-FACED PANEL PRODUCTS (HARDWOOD PLYWOOD): HPVA HP-1, MADE WITH ADHESIVE CONTAINING NO UREA

FORMALDEHYDE. ADHESIVES, GENERAL: DO NOT USE ADHESIVES THAT CONTAIN UREA FORMALDEHYDE.

VOC LIMITS FOR INSTALLATION ADHESIVES AND GLUES: USE INSTALLATION ADHESIVES THAT COMPLY WITH THE FOLLOWING LIMITS FOR VOC CONTENT WHEN CALCULATED ACCORDING TO 40 CFR 59, SUBPART D (EPA METHOD 24): WOOD GLUES: 30 G/L

PANEL ADHESIVE: 50 G/L MULTIPURPOSE CONSTRUCTION ADHESIVE: 70 G/L CONTACT ADHESIVE: 80 G/L. SPECIAL PURPOSE: 250 G/L

CLOSET AND UTILITY SHELVING: GRADE: ECONOMY SHELF MATERIAL: 3/4 INCH (19 MM) THERMOSET DECORATIVE PANEL WITH PVC OR POLYESTER EDGE BANDING.

CLEATS: 3/4 INCH (19 MM) PANEL PRODUCT.

SHOP FINISHING: GRADE: SAME GRADE AS WOODWORK. EXTENT: ALL WOODWORK SHOP FINISHED.

INSTALLATION SCRIBE AND CUT MILLWORK TO FIT ADJOINING WORK, REFINISH CUT

SURFACES, AND REPAIR DAMAGED FINISH AT CUTS. ANCHOR MILLWORK TO ANCHORS OR BLOCKING BUILT IN OR DIRECTLY ATTACHED TO SUBSTRATES. SECURE WITH COUNTERSUNK. CONCEALED FASTENERS AND BLIND NAILING AS REQUIRED FOR COMPLETE INSTALLATION. USE FINE FINISHING NAILS OR FINISHING SCREWS FOR EXPOSED FASTENING, COUNTERSUNK AND FILLED FLUSH WITH MILLWORK AND MATCHING FINAL FINISH IF TRANSPARENT FINISH

IS INDICATED. CABINETS: INSTALL WITHOUT DISTORTION SO DOORS AND DRAWERS FIT OPENINGS PROPERLY AND ARE ACCURATELY ALIGNED. ADJUST HARDWARE TO CENTER DOORS AND DRAWERS IN OPENINGS AND TO PROVIDE UNENCUMBERED OPERATION. COMPLETE INSTALLATION OF HARDWARE AND ACCESSORY ITEMS AS INDICATED. INSTALL CABINETS WITH NO MORE THAN 1/8 INCH IN 96 INCH

(3 MM IN 2400 MM) SAG, BOW, OR OTHER VARIATION FROM A STRAIGHT LINE. COUNTERTOPS: ANCHOR SECURELY BY SCREWING THROUGH CORNER BLOCKS OF BASE CABINETS OR OTHER SUPPORTS INTO UNDERSIDE OF COUNTERTOP

ALIGN ADJACENT SOLID-SURFACING-MATERIAL COUNTERTOPS AND FORM SEAMS TO COMPLY WITH MANUFACTURER'S WRITTEN RECOMMENDATIONS USING ADHESIVE IN COLOR TO MATCH COUNTERTOP. CAREFULLY DRESS JOINTS SMOOTH, REMOVE SURFACE SCRATCHES, AND CLEAN ENTIRE SURFACE.

INSTALL COUNTERTOPS WITH NO MORE THAN 1/8 INCH IN 96 INCH (3 MM IN 2400 MM) SAG, BOW, OR OTHER VARIATION FROM A STRAIGHT LINE

SECURE COVED BACKSPLASHES TO TOPS PER MANUFACTURES FABRICATION MANUAL AND TO WALLS WITH ADHESIVE. CALK SPACE BETWEEN BACKSPLASH AND WALL WITH SEALANT

SPECIFIED IN DIVISION 7 SECTION "JOINT SEALANTS."

END OF SECTION 064000

THERMAL AND MOISTURE PROTECTION

SECTION 07841 - THROUGH-PENETRATION FIRESTOP SYSTEMS

ASTM E 814 OR UL 1479:

SUBMITTALS PRODUCT DATA: FOR EACH TYPE OF PRODUCT INDICATED. QUALITY ASSURANCE

INSTALLER QUALIFICATIONS: AN FM GLOBAL-APPROVED FIRESTOP CONTRACTOR OR A UL-QUALIFIED FIRESTOP CONTRACTOR. FIRE-TEST-RESPONSE CHARACTERISTICS: TESTED PER ASTM E 814 BY

QUALIFIED TESTING AND INSPECTING AGENCY. PENETRATION FIRESTOPPING

PENETRATIONS IN FIRE-RESISTANCE-RATED WALLS: F-RATINGS PER ASTM E 814 OR UL 1479. PENETRATIONS IN HORIZONTAL ASSEMBLIES: F- AND T-RATINGS PER

PENETRATIONS IN SMOKE BARRIERS: L-RATINGS PER UL 1479. W-RATINGS: PER UL 1479. VOC CONTENT OF INTERIOR SEALANTS: PROVIDE INTERIOR SEALANTS AND SEALANT PRIMERS THAT COMPLY WITH THE FOLLOWING LIMITS FOR VOC CONTENT WHEN CALCULATED ACCORDING TO 40 CFR 59, SUBPART D (EPA METHOD 24):

SEALANTS: 250 G/L. SEALANT PRIMERS FOR NONPOROUS SUBSTRATES: 250 G/L. SEALANT PRIMERS FOR POROUS SUBSTRATES: 775 G/L.

INSTALLATION IDENTIFICATION: PREPRINTED METAL OR PLASTIC LABELS, PERMANENTLY ATTACHED.

FIELD QUALITY CONTROL INSPECTION OF INSTALLED FIRESTOP SYSTEMS: BY OWNER-ENGAGED AGENCY ACCORDING TO ASTM E 2174 REQUIREMENTS.

END OF SECTION 07841

SECTION 078446 - FIRE-RESISTIVE JOINT SYSTEMS SUMMARY

FIRE-RESISTIVE JOINT SYSTEMS FOR THE FOLLOWING: JOINTS IN OR BETWEEN FIRE-RESISTANCE-RATED CONSTRUCTIONS. JOINTS AT EXTERIOR CURTAIN-WALL/FLOOR INTERSECTIONS.

JOINTS IN SMOKE BARRIERS. PERFORMANCE REQUIREMENTS FIRE-RESISTANCE RATINGS OF JOINT SYSTEMS IN AND BETWEEN FIRE-RESISTANCE-RATED CONSTRUCTIONS: EQUALING OR EXCEEDING THE FIRE-RESISTANCE RATINGS OF CONSTRUCTION THAT THEY JOIN, [AND WITH MOVEMENT CAPABILITIES INDICATEDI AS DETERMINED BY UL 2079.

PRODUCT DATA: FOR EACH TYPE OF PRODUCT INDICATED.

1.4 QUALITY ASSURANCE FIRE-TEST-RESPONSE CHARACTERISTICS: TESTED BY QUALIFIED TESTING AND INSPECTING AGENCY. FIRE-RESISTIVE JOINT SYSTEMS

DESIGNATION SYSTEM FOR JOINTS IN OR BETWEEN FIRE-RESISTANCE-RATED CONSTRUCTIONS: ALPHANUMERIC SYSTEMS LISTED IN UL'S "FIRE RESISTANCE DIRECTORY" UNDER PRODUCT CATEGORY XHBN.

JOINTS IN OR BETWEEN FIRE-RESISTANCE-RATED CONSTRUCTION: EQUAL TO OR EXCEEDING THE FIRE-RESISTANCE RATING OF CONSTRUCTION THEY WILL JOINTS AT EXTERIOR CURTAIN-WALL/FLOOR INTERSECTIONS: EQUAL TO OR

EXCEEDING THE FIRE-RESISTANCE RATING OF THE FLOOR ASSEMBLY. JOINTS IN SMOKE BARRIERS: L-RATING: NOT EXCEEDING 5.0 CFM/FT (0.00775 CU. M/S X M) OF JOINT

AT 0.30 INCH WG (74.7 PA) AT BOTH AMBIENT AND ELEVATED TEMPERATURES. EXPOSED FIRE-RESISTIVE JOINT SYSTEMS: PROVIDE PRODUCTS WITH FLAME-SPREAD AND SMOKE-DEVELOPED INDEXES OF LESS THAN 25 AND 450,

RESPECTIVELY, AS DETERMINED PER ASTM E 84. VOC CONTENT: FIRE-RESISTIVE JOINT SYSTEM SEALANTS SHALL COMPLY WITH THE FOLLOWING LIMITS FOR VOC CONTENT WHEN CALCULATED ACCORDING TO 40 CFR 59, SUBPART D (EPA METHOD 24):

ARCHITECTURAL SEALANTS: 250 G/L SEALANT PRIMERS FOR NONPOROUS SUBSTRATES: 250 G/L. SEALANT PRIMERS FOR POROUS SUBSTRATES: 775 G/L. ACCESSORIES: FORMING MATERIALS AND OTHER COMPONENTS NEEDED

TO INSTALL FILL MATERIALS AND MAINTAIN RATINGS REQUIRED. THERMAL AND MOISTURE PROTECTION (CONT)

SECTION 079200 - JOINT SEALANTS

1.1 MATERIALS VOC CONTENT OF INTERIOR SEALANTS: PROVIDE INTERIOR SEALANTS AND SEALANT PRIMERS THAT COMPLY WITH THE FOLLOWING LIMITS FOR VOC CONTENT WHEN CALCULATED ACCORDING TO 40 CFR 59, SUBPART D (EPA METHOD 24):

SEALANTS: 250 G/L. SEALANT PRIMERS FOR NONPOROUS SUBSTRATES: 250 G/L. SEALANT PRIMERS FOR POROUS SUBSTRATES: 775 G/L.

SUITABILITY FOR CONTACT WITH FOOD: WHERE SEALANTS ARE INDICATED FOR JOINTS THAT WILL COME IN REPEATED CONTACT WITH FOOD, PROVIDE PRODUCTS THAT COMPLY WITH 21 CFR 177.2600. ELASTOMERIC JOINT SEALANTS: LIQUID APPLIED, CHEMICALLY CURING; ASTM C 920.

MULTICOMPONENT NONSAG NEUTRAL-CURING SILICONE SEALANT SINGLE-COMPONENT MILDEW-RESISTANT NEUTRAL-CURING SILICONE SEALANT ES-2.

SINGLE-COMPONENT MILDEW-RESISTANT ACID-CURING SILICONE SEALANT ES-3. SINGLE-COMPONENT MILDEW-RESISTANT ACID-CURING RTV SILICONE SEALANT ES-4.

MULTICOMPONENT NONSAG POLYUREA SEALANT ES-5. MULTICOMPONENT NONSAG POLYUREA FILLER ES-6. LATEX SEALANT LS-1: COMPLY WITH ASTM C 834, TYPE P, GRADE NF. JOINT-SEALANT BACKING: 1.2 JOINT-SEALANT SCHEDULE

JOINT-SEALANT APPLICATION JS-1: EXTERIOR HORIZONTAL NONTRAFFIC AND TRAFFIC ISOLATION AND CONTRACTION JOINTS IN CAST-IN-PLACE CONCRETE SLABS JOINT SEALANT: ES-5.

JOINT-SEALANT APPLICATION JS-2: EXTERIOR PERIMETER JOINTS BETWEEN WALL AND FRAMES OF DOORS AND WINDOWS. JOINT SEALANT: ES-1.

JOINT-SEALANT APPLICATION JS-3: EXTERIOR CONTROL AND EXPANSION JOINTS IN HORIZONTAL TRAFFIC SURFACES OF BRICK PAVERS, CERAMIC TILE, STONE PAVING UNITS, CONCRETE TILE. JOINT SEALANT: MULTICOMPONENT POURABLE POLYSULFIDE

JOINT-SEALANT COLOR: AS SELECTED BY ARCHITECT FROM MANUFACTURER'S FULL RANGE. JOINT-SEALANT APPLICATION JS-4: INTERIOR PERIMETER JOINTS OF

EXTERIOR OPENINGS. JOINT SEALANT: ES-3. JOINT-SEALANT APPLICATION JS-5: INTERIOR CERAMIC TILE EXPANSION,

CONTROL, CONTRACTION, AND ISOLATION JOINTS IN HORIZONTAL TRAFFIC SURFACES. JOINT SEALANT: ES-3. JOINT-SEALANT COLOR: AS NOTED.

JOINT-SEALANT APPLICATION JS-6: INTERIOR JOINTS BETWEEN PLUMBING FIXTURES AND ADJOINING WALLS, FLOORS, AND COUNTERS. JOINT SEALANT: ES-3. JOINT-SEALANT COLOR: TRANSLUCENT.

JOINT-SEALANT APPLICATION JS-7: VERTICAL JOINTS ON EXPOSED SURFACES OF INTERIOR PARTITIONS.

JOINT SEALANT: ES-3. JOINT-SEALANT APPLICATION JS-8: PERIMETER JOINTS BETWEEN INTERIOR WALL SURFACES AND FRAMES OF INTERIOR DOORS, WINDOWS. JOINT SEALANT: ES-3.

JOINT-SEALANT APPLICATION JS-9: HVAC JOINTS. JOINT SEALANT: ES-2. JOINT-SEALANT COLOR: ALUMINUM. JOINT-SEALANT APPLICATION JS-10: NON-POROUS MATERIAL TO

NON-POROUS MATERIAL. JOINT SEALANT: ES-4.

DOORS AND WINDOWS

SECTION 081416 - FLUSH WOOD DOORS

SUBMITTALS PRODUCT DATA: FOR EACH TYPE OF DOOR INDICATED. INCLUDE DETAILS

OF CORE AND EDGE CONSTRUCTION AND TRIM FOR OPENINGS. SHOP DRAWINGS: INDICATE LOCATION, SIZE, AND HAND OF EACH DOOR; ELEVATION OF EACH KIND OF DOOR: CONSTRUCTION DETAILS NOT COVERED IN PRODUCT DATA; LOCATION AND EXTENT OF HARDWARE

BLOCKING: AND OTHER PERTINENT DATA. INDICATE DIMENSIONS AND LOCATIONS OF MORTISES AND HOLES

FOR HARDWARE. INDICATE DIMENSIONS AND LOCATIONS OF CUTOUTS.

INDICATE REQUIREMENTS FOR VENEER MATCHING. INDICATE DOORS TO BE FACTORY FINISHED AND FINISH REQUIREMENTS. INDICATE FIRE-PROTECTION RATINGS FOR FIRE-RATED DOORS.

1.2 QUALITY ASSURANCE QUALITY STANDARD: AWI. AWI QUALITY CERTIFICATION LABELS OR AN AWI LETTER OF

WARRANTY: SAMPLE OF SPECIAL WARRANTY.

LICENSING FOR DOORS. WI-CERTIFIED COMPLIANCE CERTIFICATE FOR DOORS AND INSTALLATION.

FIRE-RATED WOOD DOORS: POSITIVE PRESSURE TESTING. DOOR CONSTRUCTION, GENERAL LOW-EMITTING MATERIALS: MADE WITH ADHESIVES AND COMPOSITE WOOD

PRODUCTS THAT DO HAVE NO ADDED UREA FORMALDEHYDE. WDMA I.S.1-A PERFORMANCE GRADE: HEAVY DUTY UNLESS OTHERWISE VENEERED-FACED DOORS FOR TRANSPARENT FINISH

INTERIOR SOLID-CORE DOORS: CORE: PARTICLEBOARD. CONSTRUCTION: FIVE OR SEVEN PLIES, BONDED.

PRIMING/FINISHING SHOP PRIMING:

DOORS FOR OPAQUE FINISH: ONE COAT OF WOOD PRIMER. DOORS FOR TRANSPARENT FINISH: STAIN AND FIRST COAT OF

FACTORY FINISHING: ALL DOORS. END OF SECTION 081416

FINISHES (CONTINUED)

SECTION 096400 - WOOD FLOORING

1.3

[FACTORY-] [FIELD-]FINISHED WOOD FLOORING.

PERFORMANCE REQUIREMENTS FLOORSCORE COMPLIANCE: COMPOSITE WOOD FLOORS SHALL COMPLY WITH REQUIREMENTS OF FLOORSCORE STANDARD. MATERIAL S

WOOD FLOORING ADHESIVE: VOC LIMITS: 100 G/L. **END OF SECTION 096400**

SECTION 096516 - RESILIENT SHEET FLOORING PRODUCTS

FLOORING SYSTEM: FLOORSCORE COMPLIANCE. VINYL SHEET FLOORING: BACKING: NONE, UNBACKED [NONFOAMED PLASTIC] [FOAMED

SEAMLESS-INSTALLATION METHOD: HEAT WELDED. RUBBER SHEET FLOORING: BACKING: NONE, UNBACKED.

MANUFACTURER FOR APPLICATIONS INDICATED.

SEAMLESS-INSTALLATION METHOD: HEAT WELDED. INSTALLATION MATERIALS TROWELABLE LEVELING AND PATCHING COMPOUNDS: LATEX-MODIFIED. PORTLAND CEMENT BASED OR BLENDED HYDRAULIC-CEMENT-BASED FORMULATION PROVIDED OR APPROVED BY RESILIENT SHEET FLOORING

ADHESIVE MANUFACTURERS TO SUIT RESILIENT SHEET FLOORING AND SUBSTRATE CONDITIONS INDICATED.

VINYL SHEET ADHESIVES SHALL HAVE A VOC CONTENT OF 50 G/L OR LESS. RUBBER SHEET ADHESIVES SHALL HAVE A VOC CONTENT OF 60 G/L OR LESS

INTEGRAL-FLASH-COVE-BASE ACCESSORIES: COVE STRIP: 1 INCH (25 MM) RADIUS PROVIDED OR APPROVED BY RESILIENT SHEET FLOORING MANUFACTURER. CAP STRIP: [SQUARE METAL, VINYL, OR RUBBER CAP] [TAPERED

VINYL CAP] <INSERT REQUIREMENTS> PROVIDED OR APPROVED BY RESILIENT SHEET FLOORING MANUFACTURER. FLOOR POLISH: PROVIDE PROTECTIVE, LIQUID FLOOR-POLISH PRODUCTS RECOMMENDED BY RESILIENT SHEET FLOORING

MANUFACTURER. **END OF SECTION 096516**

SECTION 097200 - WALL COVERINGS VINYL AND WOVEN GLASS-FIBER WALL COVERING.

MATERIALS ADHESIVE: MILDEW-RESISTANT, NONSTAINING, STRIPPABLE ADHESIVE, FOR USE WITH SPECIFIC WALL COVERING AND SUBSTRATE APPLICATION, AS RECOMMENDED IN WRITING BY WALL-COVERING MANUFACTURER, AND WITH A VOC CONTENT OF 50 G/L OR LESS WHEN CALCULATED ACCORDING TO 40 CFR 59, SUBPART D (EPA METHOD 24).

INSTALLATION INSTALL STRIPS IN SAME ORDER AS CUT FROM ROLL. **END OF SECTION 097200**

STARBUCKS COFFEE COMPANY 2401 UTAH AVENUE SOUTH SEATTLE, WASHINGTON 98134 (206) 318-1575

© 2011 STARBUCKS COFFEE COMPAN

THESE DRAWINGS AND SPECIFICATIONS ARE CONFIDENTIAL AND SHALREMAIN THE SOLE PROPERTY OF STARBUCKS CORPORATION, WHICH I THE OWNER OF THE COPYRIGHT IN THIS WORK. THEY SHALL NOT BE REPRODUCED (IN WHOLE OR IN PART), SHARED WITH THIRD PARTIES OF USED IN ANY MANNER ON OTHER PROJECTS OR EXTENSIONS TO THIS PROJECT WITHOUT THE PRIOR WRITTEN CONSENT OF STARBUCKS ORPORATION. THESE DRAWINGS AND SPECIFICATIONS ARE INTENDE! O EXPRESS DESIGN INTENT FOR A PROTOTYPICAL STARBUCKS STORE (WHICH IS SUBJECT TO CHANGE AT ANYTIME) AND DO NOT REFLECT ACTUAL SITE CONDITIONS. NEITHER PARTY SHALL HAVE ANY
OBLIGATION NOR LIABILITY TO THE OTHER (EXCEPT STATED ABOVE UNTIL A WRITTEN AGREEMENT IS FULLY EXECUTED BY BOTH PARTIES

ARCHITECT OF RECORD

325 N. LaSalle St. Suite 700 Chicago, IL 60654 t 312.424.2400 | f 312.424.2424 | www.norr.com

ENGINEER OF RECORD t. Louis, Missouri 63119 Phone (314) 772-1782 Fax (314) 373-3514 **Engineering Consultants** Mechanical - Electrical - Plumbing

Revision Schedule Description

2 ¦ ◀

STORE #: 2305 PROJECT #: 04217-001 CONCEPT: MCS PALETTE: **HERITAGE** ISSUE DATE: 12 09 13 **DESIGN MANAGER:** S. RYCHLIK LEED® AP: N/A PRODUCTION DESIGNER: C. ALINOVICH K. GORIN CHECKED BY:

SHEET TITLE:

SCALE:

DESIGN **SPECIFICATIONS**

1/4" = 1'-0'

SHEET NUMBER:

G-0011

END OF SECTION 079200

JOINT-SEALANT COLOR: CLEAR.

DOORS AND WINDOWS (CONTINUED) **SECTION 08331 - OVERHEAD COILING DOORS** 1.2 PRODUCT DATA: FOR EACH TYPE AND SIZE OF OVERHEAD COILING DOOR AND ACCESSORY. INCLUDE THE FOLLOWING: SHOP DRAWINGS: FOR EACH INSTALLATION AND FOR SPECIAL COMPONENTS NOT DIMENSIONED OR DETAILED IN MANUFACTURER'S PRODUCT DATA. INCLUDE PLANS, ELEVATIONS, SECTIONS, DETAILS, AND ATTACHMENTS TO OTHER WORK DETAIL EQUIPMENT ASSEMBLIES AND INDICATE DIMENSIONS. WEIGHTS, LOADS, REQUIRED CLEARANCES, METHOD OF FIELD ASSEMBLY, COMPONENTS, AND LOCATION AND SIZE OF EACH FIELD CONNECTION SAMPLES FOR INITIAL SELECTION: MANUFACTURER'S FINISH CHARTS SHOWING FULL RANGE OF COLORS AND TEXTURES AVAILABLE FOR UNITS WITH FACTORY-APPLIED FINISHES INCLUDE SIMILAR SAMPLES OF ACCESSORIES INVOLVING COLOR SELECTION. SAMPLES FOR VERIFICATION: FOR EACH TYPE OF EXPOSED FINISH REQUIRED, PREPARED ON SAMPLES OF SIZE INDICATED BELOW. CURTAIN SLATS: 12 INCHES (305 MM) LONG. BOTTOM BAR: 6 INCHES (150 MM) LONG. GUIDES: 6 INCHES (150 MM) LONG. BRACKETS: 6 INCHES (150 MM) SQUARE HOOD: 6 INCHES (150 MM) SQUARE. DELEGATED-DESIGN SUBMITTAL: FOR OVERHEAD COILING DOORS INDICATED TO COMPLY WITH PERFORMANCE REQUIREMENTS AND DESIGN CRITERIA, INCLUDING ANALYSIS DATA SIGNED AND SEALED BY THE QUALIFIED PROFESSIONAL ENGINEER RESPONSIBLE FOR THEIR PREPARATION. DETAIL FABRICATION AND ASSEMBLY OF SEISMIC RESTRAINTS. SUMMARY OF FORCES AND LOADS ON WALLS AND JAMBS. QUALIFICATION DATA: FOR QUALIFIED INSTALLER. SEISMIC QUALIFICATION CERTIFICATES: FOR OVERHEAD COILING DOORS, ACCESSORIES, AND COMPONENTS, FROM MANUFACTURER. MAINTENANCE DATA: FOR OVERHEAD COILING DOORS TO INCLUDE IN MAINTENANCE MANUALS. PERFORMANCE REQUIREMENTS OPERATION-CYCLE REQUIREMENTS: PROVIDE OVERHEAD COILING GRILLE COMPONENTS AND OPERATORS CAPABLE OF OPERATING FOR NOT LESS THAN 50,000 CYCLES AND FOR 25 CYCLES PER DAY. DOOR ASSEMBLY GENERAL: FABRICATE OVERHEAD COILING GRILLE CURTAIN CONSISTING OF A NETWORK OF 5/16 INCH (8 MM) MINIMUM DIAMETER HORIZONTAL RODS, OR RODS COVERED WITH TUBE SPACERS, SPACED AS INDICATED. INTERCONNECT RODS BY VERTICAL LINKS APPROXIMATELY 5/8 INCH (16 MM) WIDE, SPACED AS INDICATED AND ROTATING ON RODS. SPACE RODS AT APPROXIMATELY 1-1/2 INCHES (38 MM) O.C. SPACE LINKS APPROXIMATELY 9 INCHES (228 MM) APART IN A STRAIGHT IN-LINE PATTERN. ALUMINUM GRILLE CURTAIN: ASTM B 221(ASTM B 221M), ALLOY AND TEMPER RECOMMENDED BY ALUMINUM PRODUCER AND FINISHER FOR TYPE OF USE AND FINISH INDICATED. HOOD: ALUMINUM. MANUAL DOOR OPERATOR INSTALLATION FACTORY-AUTHORIZED REPRESENTATIVE TO [PERFORM STARTUP SERVICE AND TESTING] [AND] [TRAIN OWNER'S PERSONNEL]. **END OF SECTION 08331 SECTION 08345 - DOUBLE ACTING SWING DOORS** PART 1 - GENERAL SUMMARY SECTION INCLUDES: SOLID-CORE DOUBLE ACTING SWING DOORS WITH PLASTIC LAMINATE FACES. PRODUCT DATA: FOR EACH TYPE OF PRODUCT INDICATED. INCLUDE CONSTRUCTION DETAILS, MATERIAL DESCRIPTIONS, CORE DESCRIPTIONS, FIRE-RESISTANCE RATING, TEMPERATURE-RISE RATINGS, AND FINISHES. SHOP DRAWINGS: INCLUDE THE FOLLOWING: ELEVATIONS OF EACH DOOR DESIGN. DETAILS OF DOORS, INCLUDING VERTICAL AND HORIZONTAL EDGE DETAILS AND METAL THICKNESSES. FRAME DETAILS FOR EACH FRAME TYPE, INCLUDING DIMENSIONED PROFILES AND METAL THICKNESSES. LOCATIONS OF REINFORCEMENT AND PREPARATIONS FOR

DETAILS OF ACCESSORIES.

DESIGN: AS INDICATED.

DO NOT CONTAIN UREA FORMALDEHYDE.

SAME MATERIAL AS FACE SHEETS.

PRESSURE LAMINATE. PROVIDE DOORS COMPLYING WITH

FOR LEVEL AND MODEL AND ANSI/SDI A250.4 FOR PHYSICAL

HARDWARE REINFORCEMENT: FABRICATE ACCORDING TO

PRIME FINISH: APPLY MANUFACTURER'S STANDARD PRIMER

IMMEDIATELY AFTER CLEANING AND PRETREATING.

1.6 COLOR AND GLOSS: AS INDICATED BY MANUFACTURER'S DESIGNATIONS.

FROM EITHER COLD- OR HOT-ROLLED STEEL SHEET.

LEVEL 1 AND PHYSICAL PERFORMANCE LEVEL C

STANDARD DOUBLE ACTING SWING DOORS

PERFORMANCE LEVEL:

1.4 STOPS AND MOLDINGS

END OF SECTION 08345

(STANDARD DUTY)

MOLDINGS FOR GLAZED LITES IN DOORS:

PROLONGED EXPOSURE.

ACCEPTANCE CRITERIA.

LOOSE STOPS FOR GLAZED LITES IN FRAMES:

AS FRAMES IN WHICH THEY ARE INSTALLED.

MINIMUM 0.032 INCH (0.8 MM) THICK.

DETAILS OF MOLDINGS, REMOVABLE STOPS, AND GLAZING.

CORE CONSTRUCTION: 3/4 INCH (19 MM) EXTERIOR GRADE SOLID WOOD

CORE MADE WITH ADHESIVES AND COMPOSITE WOOD PRODUCTS THAT

VERTICAL EDGES FOR DOUBLE-ACTING DOORS: ROUND

TOLERANCES: COMPLY WITH SDI 117, "MANUFACTURING

INTERIOR DOORS: FACE SHEETS FABRICATED FROM DECORATIVE HIGH

REQUIREMENTS INDICATED BELOW BY REFERENCING ANSI/SDI A250.8

WIDTH: AS INDICATED ON DRAWINGS.

ANSI/SDI A250.6 WITH REINFORCING PLATES OF 18 GAUGE STAINLESS

FABRICATE CONCEALED STIFFENERS AND HARDWARE REINFORCEMENT

MINIMUM 0.032 INCH (0.8 MM) THICK, FABRICATED FROM SAME MATERIAL

SHOP PRIMER: MANUFACTURER'S STANDARD, FAST-CURING,

ANSI/SDI A250.10 ACCEPTANCE CRITERIA; RECOMMENDED BY

PRIMER MANUFACTURER FOR SUBSTRATE; COMPATIBLE WITH

LEAD- AND CHROMATE-FREE PRIMER COMPLYING WITH

SUBSTRATE AND FIELD-APPLIED COATINGS DESPITE

FACTORY-APPLIED PAINT FINISH: MANUFACTURER'S STANDARD,

COMPLYING WITH ANSI/SDI A250.3 FOR PERFORMANCE AND

TOLERANCES FOR STANDARD STEEL DOORS AND FRAMES."

TOP AND BOTTOM EDGES: CLOSED WITH FLUSH OR INVERTED

0.042 INCH (1.0 MM) THICK, END CLOSURES OR CHANNELS OF

VERTICAL EDGES WITH 2-1/8 INCH (54 MM) RADIUS.

GENERAL: PROVIDE DOORS OF DESIGN INDICATED, NOT LESS THAN

WITHOUT VISIBLE JOINTS OR SEAMS ON EXPOSED FACES UNLESS

THICKNESS INDICATED; FABRICATED WITH SMOOTH SURFACES,

OTHERWISE INDICATED. COMPLY WITH ANSI/SDI A250.8.

SECTION 092900 - GYPSUM BOARD SUMMARY INTERIOR GYPSUM BOARD. TILE BACKING PANELS. SUBMITTALS PRODUCT DATA: FOR EACH TYPE OF PRODUCT INDICATED. SAMPLES: FOR THE FOLLOWING PRODUCTS: TEXTURED FINISHES: MANUFACTURER'S STANDARD SIZE FOR EACH TEXTURED FINISH INDICATED AND ON SAME BACKING INDICATED 1.3 MATERIALS INTERIOR GYPSUM BOARD: GENERAL: COMPLYING WITH ASTM C 36/C 36M OR ASTM C 1396/C 1396M, AS APPLICABLE TO TYPE OF GYPSUM BOARD INDICATED AND WHICHEVER IS MORE STRINGENT. MUST BE CERTIFIED AS LOW EMITTING. CERTIFICATION MUST BE BASED UPON THE CALIFORNIA DEPARTMENT OF HEALTH SERVICES' "STANDARD PRACTICE FOR THE TESTING OF VOLATILE ORGANIC EMISSIONS FROM VARIOUS SOURCES USING SMALL-SCALE ENVIRONMENTAL CHAMBERS", INCLUDING 2004 ADDENDA OR A JURISDICTIONALLY RECOGNIZED STANDARD USING VALENT TESTING METHODOLOGIES AND VOC THRESHOLDS. THICKNESS: 5/8 INCH (15.9 MM). LONG EDGES: TAPERED. MOISTURE- AND MOLD-RESISTANT TYPE: WITH MOISTURE- AND MOLD-RESISTANT CORE AND SURFACES. CORE: 5/8 INCH (15.9 MM), TYPE X. LONG EDGES: TAPERED. MOLD RESISTANCE: ASTM D 3273, SCORE OF 10 AS RATED ACCORDING TO ASTM D 3274. TILE-BACKING PANELS: GLASS-MAT, WATER-RESISTANT BACKING BOARD ASTM C 1178/C 1178M, WITH MANUFACTURER'S STANDARD EDGES. MUST BE CERTIFIED AS LOW EMITTING. CERTIFICATION MUST BE BASED UPON THE CALIFORNIA DEPARTMENT OF HEALTH SERVICES' "STANDARD PRACTICE FOR THE TESTING OF VOLATILE ORGANIC EMISSIONS FROM VARIOUS SOURCES USING SMALL-SCALE ENVIRONMENTAL CHAMBERS", INCLUDING 2004 ADDENDA OR A JURISDICTIONALLY RECOGNIZED STANDARD USING EQUIVALENT TESTING METHODOLOGIES AND VOC THRESHOLDS CORE: 5/8 INCH (15.9 MM), TYPE X. MOLD RESISTANCE: ASTM D 3273, SCORE OF 10 AS RATED ACCORDING TO ASTM D 3274. CEMENTITIOUS BACKER UNITS: ANSI A118.9 AND ASTM C 1288 OR 1325, WITH MANUFACTURER'S STANDARD EDGES. THICKNESS: [1/4 INCH (6.4 MM)] [AS INDICATED]. MOLD RESISTANCE: ASTM D 3273, SCORE OF 10 AS RATED ACCORDING TO ASTM D 3274. TRIM ACCESSORIES:

INTERIOR: CORNERBEAD.

FINISHES

MATERIALS

SECTION 09216 - NON-LOAD-BEARING STEEL FRAMING

1.3 STEEL FRAMING FOR FRAMED ASSEMBLIES

AVAILABLE.

FOLLOWING:

STEEL FRAMING FOR FRAMED ASSEMBLIES:

STEEL STUDS AND RUNNERS: ASTM C 645.

DIMPLED STEEL STUDS AND RUNNERS:

LATERAL BRACING.

GALVANIZED, UNLESS OTHERWISE INDICATED.

OTHERWISE INDICATED ON DRAWINGS.

DEPTH: AS INDICATED ON DRAWINGS.

DEPTH: AS INDICATED ON DRAWINGS.

IN WIDTH TO ACCOMMODATE DEPTH OF STUDS.

STRAND OF 0.0475 INCH (1.21 MM) DIAMETER WIRE

DEPTH: 1-1/2 INCHES (38.1 MM)

HAT-SHAPED, RIGID FURRING CHANNELS: ASTM C 645.

DEPTH: AS INDICATED ON DRAWINGS.

DEPTH: AS INDICATED ON DRAWINGS.

0.0312 INCH (0.79 MM).

END OF SECTION 09216

END OF SECTION 092900

```
FINISHES (CONTINUED)
                                                                                SECTION 093000 - CERAMIC TILE
NON-LOAD-BEARING STEEL FRAMING MEMBERS FOR INTERIOR FRAMING
                                                                                             PAVER, GLAZED, AND WALL TILE.
                                                                                             WATERPROOF MEMBRANE FOR THIN-SET TILE INSTALLATIONS.
FRAMING MEMBERS, GENERAL: COMPLY WITH ASTM C 754 FOR CONDITIONS
      STEEL SHEET COMPONENTS: COMPLY WITH ASTM C 645
        REQUIREMENTS FOR METAL, UNLESS OTHERWISE INDICATED.
       PROTECTIVE COATING: COATING WITH EQUIVALENT CORROSION
        RESISTANCE OF ASTM A 653/A 653M, G40 (Z120), HOT-DIP
SALVAGED MATERIAL: USE SALVAGED FRAMING MATERIALS WHENEVER
        MINIMUM BASE-METAL THICKNESS: 0.033 INCH (0.84 MM) UNLESS
        MINIMUM BASE-METAL THICKNESS: 0.025 INCH (0.64 MM).
SLIP-TYPE HEAD JOINTS: WHERE INDICATED, PROVIDE ONE OF THE
       SINGLE LONG-LEG RUNNER SYSTEM: ASTM C 645 TOP RUNNER
        WITH 2 INCH (50.8 MM) DEEP FLANGES IN THICKNESS NOT LESS
        THAN INDICATED FOR STUDS, INSTALLED WITH STUDS FRICTION FIT
       INTO TOP RUNNER AND WITH CONTINUOUS BRIDGING LOCATED
        WITHIN 12 INCHES (305 MM) OF THE TOP OF STUDS TO PROVIDE
       DOUBLE-RUNNER SYSTEM: ASTM C 645 TOP RUNNERS, INSIDE
        RUNNER WITH 2 INCH (50.8 MM) DEEP FLANGES IN THICKNESS NOT
        LESS THAN INDICATED FOR STUDS AND FASTENED TO STUDS, AND
       OUTER RUNNER SIZED TO FRICTION FIT INSIDE RUNNER.
      DEFLECTION TRACK: STEEL SHEET TOP RUNNER MANUFACTURED
        TO PREVENT CRACKING OF FINISHES APPLIED TO INTERIOR
        PARTITION FRAMING RESULTING FROM DEFLECTION OF STRUCTURE
        ABOVE: IN THICKNESS NOT LESS THAN INDICATED FOR STUDS AND
                                                                                END OF SECTION 093000
COLD-ROLLED CHANNEL BRIDGING: 0.0538 INCH (1.37 MM) BARE-STEEL
 THICKNESS, WITH MINIMUM 1/2 INCH (12.7 MM) WIDE FLANGES.
      CLIP ANGLE: NOT LESS THAN 1-1/2 BY 1-1/2 INCHES (38.1 BY
        38.1 MM), 0.068 INCH (1.73 MM) THICK, GALVANIZED STEEL.
       MINIMUM BASE METAL THICKNESS: AS INDICATED ON DRAWINGS.
                                                                                1.2 SUBMITTALS
COLD-ROLLED FURRING CHANNELS: 0.0538 INCH (1.37 MM) BARE-STEEL
 THICKNESS. WITH MINIMUM 1/2 INCH (12.7 MM) WIDE FLANGES.
       FURRING BRACKETS: ADJUSTABLE, CORRUGATED-EDGE TYPE OF
        STEEL SHEET WITH MINIMUM BARE-STEEL THICKNESS OF
       TIE WIRE: ASTM A 641/A 641M, CLASS 1 ZINC COATING, SOFT
        TEMPER, 0.0625 INCH (1.59 MM) DIAMETER WIRE, OR DOUBLE
Z-SHAPED FURRING: WITH SLOTTED OR NONSLOTTED WEB, FACE FLANGE
OF 1-1/4 INCHES (31.8 MM), WALL ATTACHMENT FLANGE OF 7/8 INCH
 (22.2 MM), MINIMUM BARE-METAL THICKNESS OF 0.0179 INCH (0.45 MM), AND
 DEPTH REQUIRED TO FIT INSULATION THICKNESS INDICATED.
```

METAL EDGE STRIPS INSTALLED AS PART OF TILE INSTALLATIONS. QUALITY ASSURANCE MOCKUPS FOR EACH FORM OF CONSTRUCTION. GLAZED WALL TILE TRIM SHAPES: COVED BASE, BULLNOSE CAP. THRESHOLDS: SATIN ANODIZED ALUMINUM THRESHOLDS AND TRANSITION BEVEL EDGES AT 1:2 SLOPE, WITH LOWER EDGE OF BEVEL ALIGNED WITH OR UP TO 1/16 INCH (1.5 MM) ABOVE ADJACENT FLOOR SURFACE. FINISH BEVEL TO MATCH TOP SURFACE OF THRESHOLD. LIMIT HEIGHT OF THRESHOLD TO 1/2 INCH (12.7 MM) OR LESS ABOVE ADJACENT FLOOR SURFACE. MORTAR: LATEX-PORTLAND CEMENT ELASTOMERIC SEALANTS: ONE-PART, MILDEW-RESISTANT SILICONE. SEALANTS SHALL HAVE A VOC CONTENT OF 250 G/L OR LESS WHEN CALCULATED ACCORDING TO 40 CFR 59, SUBPART D (EPA METHOD 24). 1.4 FLOOR TILE INSTALLATION SCHEDULE INTERIOR FLOORS ON CONCRETE: THIN-SET MORTAR. TILE TYPE: UNGLAZED PAVER TILE. MORTAR: LATEX- PORTLAND CEMENT MORTAR BOND COAT. GROUT: POLYMER-MODIFIED UNSANDED 100% SOLIDS EPOXY NON-SAGGING GROUT INTERIOR FLOORS ON [WATERPROOF] [CRACK-SUPPRESSION] MEMBRANE OVER CONCRETE AND WOOD: THIN-SET MORTAR. TILE TYPE: UNGLAZED PAVER TILE. MORTAR: LATEX- PORTLAND CEMENT MORTAR BOND COAT. GROUT: POLYMER-MODIFIED UNSANDED 100% SOLIDS EPOXY NON-SAGGING GROUT. WALL TILE INSTALLATION SCHEDULE INTERIOR WALLS OVER GLASS-MAT WATER-RESISTANT BACKER BOARD OR CEMENTITIOUS BACKER UNITS: THIN-SET MORTAR. TILE TYPE: **GLAZED WALL** TILE. MORTAR: LATEX- PORTLAND CEMENT MORTAR GROUT: POLYMER-MODIFIED UNSANDED GROUT **SECTION 095113 - ACOUSTICAL PANEL CEILINGS** ACOUSTICAL PANELS AND EXPOSED SUSPENSION SYSTEMS PRODUCT DATA: FOR EACH TYPE OF PRODUCT INDICATED COORDINATION DRAWINGS: REFLECTED CEILING PLANS, DRAWN TO SCALE ON WHICH THE FOLLOWING ITEMS ARE SHOWN AND COORDINATED WITH EACH OTHER, BASED ON INPUT FROM INSTALLERS OF THE ITEMS CEILING SUSPENSION SYSTEM MEMBERS. METHOD OF ATTACHING HANGERS TO BUILDING STRUCTURE. CEILING-MOUNTED ITEMS INCLUDING LIGHTING FIXTURES, DIFFUSERS, GRILLES, SPEAKERS, SPRINKLERS, ACCESS PANELS, AND SPECIAL MOLDINGS. SAMPLES FOR VERIFICATION: FOR EACH COMPONENT INDICATED AND FOR EACH EXPOSED FINISH REQUIRED, PREPARED ON SAMPLES OF SIZE INDICATED BELOW. ACOUSTICAL PANEL: SET OF FULL-SIZE SAMPLES OF EACH TYPE, COLOR, PATTERN, AND TEXTURE. EXPOSED SUSPENSION SYSTEM MEMBERS, MOLDINGS, AND TRIM: SET OF 12 INCH (300 MM) LONG SAMPLES OF EACH TYPE, FINISH, AND COLOR. QUALIFICATION DATA: FOR TESTING AGENCY. FIELD QUALITY-CONTROL TEST REPORTS. PRODUCT TEST REPORTS: BASED ON EVALUATION OF COMPREHENSIVE TESTS PERFORMED BY A QUALIFIED TESTING AGENCY, FOR EACH ACOUSTICAL PANEL CEILING. MAINTENANCE DATA: FOR FINISHES TO INCLUDE IN MAINTENANCE MANUALS. 1.3 QUALITY ASSURANCE ACOUSTICAL PANEL QUALITY STANDARD: ASTM E 1264. METAL SUSPENSION SYSTEM QUALITY STANDARD: ASTM C 635. ACOUSTICAL CEILING PANELS GENERAL: MUST BE CERTIFIED AS LOW EMITTING. CERTIFICATION MUST BE BASED UPON THE CALIFORNIA DEPARTMENT OF HEALTH SERVICES' "STANDARD PRACTICE FOR THE TESTING OF VOLATILE ORGANIC EMISSIONS FROM VARIOUS SOURCES USING SMALL-SCALE ENVIRONMENTAL CHAMBERS", INCLUDING 2004 ADDENDA OR A JURISDICTIONALLY RECOGNIZED STANDARD USING EQUIVALENT TESTING METHODOLOGIES AND VOC THRESHOLDS. ACOUSTICAL CEILING PANELS WASHABLE CLASSIFICATION: TYPE IV, MINERAL BASE WITH MEMBRANE-FACED OVERLAY; FORM 2, WATER FELTED; WITH VINYL OVERLAY ON FACE; PATTERN G (SMOOTH). COLOR: AS INDICATED ON DRAWINGS. THICKNESS: 5/8 INCH (15 MM) MODULAR SIZE: 24 BY 48 INCHES (610 BY 1220 MM) BROAD SPECTRUM ANTIMICROBIAL FUNGICIDE AND BACTERICIDE TREATMENT: PROVIDE ACOUSTICAL TILES TREATED WITH MANUFACTURER'S STANDARD ANTIMICROBIAL FORMULATION THAT INHIBITS FUNGUS, MOLD, MILDEW, AND GRAM-POSITIVE AND GRAM-NEGATIVE BACTERIA AND SHOWING NO MOLD, MILDEW, OR BACTERIAL GROWTH WHEN TESTED ACCORDING TO ASTM D 3273 AND EVALUATED ACCORDING TO ASTM D 3274 OR ASTM G 21. ACOUSTICAL CEILING PANELS TEXTURED: CLASSIFICATION: TYPE III, MINERAL BASE WITH PAINTED FINISH; FORM 2, WATER FELTED; PATTERN E (LIGHTLY TEXTURED). COLOR: AS INDICATED ON DRAWINGS. THICKNESS: 5/8 INCH (15 MM). MODULAR SIZE: 24 BY 48 INCHES (610 BY 1220 MM) BROAD SPECTRUM ANTIMICROBIAL FUNGICIDE AND BACTERICIDE TREATMENT: PROVIDE ACOUSTICAL TILES TREATED WITH MANUFACTURER'S STANDARD ANTIMICROBIAL FORMULATION THAT INHIBITS FUNGUS, MOLD, MILDEW, AND GRAM-POSITIVE AND GRAM-NEGATIVE BACTERIA AND SHOWING NO MOLD, MILDEW, OR BACTERIAL GROWTH WHEN TESTED ACCORDING TO ASTM D 3273 AND EVALUATED ACCORDING TO ASTM D 3274 OR ASTM G 21. ACOUSTICAL CEILING PANELS PERFORATED: CLASSIFICATION: TYPE III, MINERAL BASE WITH PAINTED FINISH; FORM 2, WATER FELTED; PATTERN CE (PERFORATED, SMALL HOLES AND LIGHTLY TEXTURED). COLOR: AS INDICATED ON DRAWINGS. THICKNESS: 3/4 INCH (15 MM). MODULAR SIZE: 24 BY 48 INCHES (610 BY 1220 MM) BROAD SPECTRUM ANTIMICROBIAL FUNGICIDE AND BACTERICIDE TREATMENT: PROVIDE ACOUSTICAL TILES TREATED WITH MANUFACTURER'S STANDARD ANTIMICROBIAL FORMULATION THAT INHIBITS FUNGUS, MOLD, MILDEW, AND GRAM-POSITIVE AND GRAM-NEGATIVE BACTERIA AND SHOWING NO MOLD, MILDEW, OR BACTERIAL GROWTH WHEN TESTED ACCORDING TO ASTM D 3273 AND EVALUATED ACCORDING TO ASTM D 3274 OR ASTM G 21. METAL SUSPENSION SYSTEMS: WIDE-FACE, CAPPED, DOUBLE-WEB STEEL: INTERMEDIATE DUTY. METAL EDGE MOLDINGS AND TRIM: ROLL-FORMED SHEET METAL. 1.5 INSTALLATION INSTALLATION: [ASTM C 636] [UBC STANDARD 25-2].

FIELD QUALITY CONTROL

END OF SECTION 095113

TESTING: BY [OWNER] [CONTRACTOR]-ENGAGED AGENCY TO TEST

ACOUSTICAL PANEL CEILING HANGER FASTENERS.

```
FINISHES (CONTINUED)
SECTION 099123 - INTERIOR PAINTING
            SURFACE PREPARATION AND THE APPLICATION OF PAINT SYSTEMS ON
             INTERIOR SUBSTRATES.
      SUBMITTALS
            SAMPLES FOR VERIFICATION:
                   FOR EACH NON-STANDARD LATEX TOPCOAT COLOR AND GLOSS
                   FOR EACH TYPE OF NON-STANDARD PAINT SYSTEM AND IN EACH
                   COLOR AND GLOSS OF TOPCOAT INDICATED.
      QUALITY ASSURANCE
                                                                                                      (C)2011 STARBUCKS COFFEE COMPANY
            QUALITY STANDARDS: "MPI APPROVED PRODUCTS LIST" AND "MPI
                   ARCHITECTURAL PAINTING SPECIFICATION MANUAL."
```

STARBUCKS COFFEE MOCKUPS FOR EACH COLOR AND FINISH. VOC CONTENT: PRODUCTS SHALL COMPLY WITH VOC LIMITS OF COMPANY AUTHORITIES HAVING JURISDICTION [AND, FOR INTERIOR PAINTS AND 2401 UTAH AVENUE SOUTH COATINGS APPLIED AT PROJECT SITE, THE FOLLOWING VOC LIMITS, SEATTLE, WASHINGTON 98134 (206) 318-1575 THESE DRAWINGS AND SPECIFICATIONS ARE CONFIDENTIAL AND SHALREMAIN THE SOLE PROPERTY OF STARBUCKS CORPORATION, WHICH I THE OWNER OF THE COPYRIGHT IN THIS WORK. THEY SHALL NOT BE REPRODUCED (IN WHOLE OR IN PART), SHARED WITH THIRD PARTIES C USED IN ANY MANNER ON OTHER PROJECTS OR EXTENSIONS TO THI PROJECT WITHOUT THE PRIOR WRITTEN CONSENT OF STARBUCKS CORPORATION. THESE DRAWINGS AND SPECIFICATIONS ARE INTENDED OF EXPRESS DESIGN INTENT FOR A PROTOTYPICAL STARBUCKS STORE

> ARCHITECT OF RECORD 325 N. LaSalle St. |Suite 700 |Chicago, IL 60654

(WHICH IS SUBJECT TO CHANGE AT ANYTIME) AND DO NOT REFLEC

ACTUAL SITE CONDITIONS. NEITHER PARTY SHALL HAVE ANY
OBLIGATION NOR LIABILITY TO THE OTHER (EXCEPT STATED ABOVE

UNTIL A WRITTEN AGREEMENT IS FULLY EXECUTED BY BOTH PARTIES



Mechanical - Electrical - Plumbing

Revision Schedule Description Rev Date By

2 ો ◀

STORE #: 2305 PROJECT #: 04217-001 MCS CONCEPT: PALETTE: **HERITAGE** ISSUE DATE: 12 09 13 **DESIGN MANAGER:** S. RYCHLIK LEED® AP: N/A PRODUCTION DESIGNER: C. ALINOVICH K. GORIN CHECKED BY:

SHEET TITLE:

DESIGN **SPECIFICATIONS**


1/4" = 1'-0'

SCALE: SHEET NUMBER:

G-0012

```
EXCLUSIVE OF COLORANTS ADDED TO A TINT BASE, WHEN CALCULATED
             ACCORDING TO 40 CFR 59, SUBPART D (EPA METHOD 24)].
                   FLAT PAINTS AND COATINGS: 50 G/L.
                    NONFLAT PAINTS AND COATINGS: 150 G/L.
                   DRY-FOG COATINGS: 400 G/L.
                    PRIMERS, SEALERS, AND UNDERCOATERS: 200 G/L
                    ANTICORROSIVE AND ANTIRUST PAINTS APPLIED TO FERROUS
                    METALS: 250 G/L
                    ZINC-RICH INDUSTRIAL MAINTENANCE PRIMERS: 340 G/L.
                    PRETREATMENT WASH PRIMERS: 420 G/L
                   FLOOR COATINGS: 100 G/L.
                    SHELLACS, CLEAR: 730 G/L
                   SHELLACS, PIGMENTED: 550 G/L
      INTERIOR PAINTING SCHEDULE
            STEEL SUBSTRATES:
                    INSTITUTIONAL LOW-ODOR/VOC LATEX SYSTEM:
                          PRIME COAT: PRIMER, RUST-INHIBITIVE, WATER BASED.
                          TOPCOAT: INSTITUTIONAL LOW-ODOR/VOC INTERIOR
                          LATEX (GLOSS
                                             LEVEL AS INDICATED IN PAINT
SCHEDULE).
             GALVANIZED-METAL SUBSTRATES:
                   INSTITUTIONAL LOW-ODOR/VOC LATEX SYSTEM:
                          PRIME COAT: PRIMER, GALVANIZED, WATER BASED.
                          TOPCOAT: LATEX, INTERIOR, INSTITUTIONAL LOW
                          ODOR/VOC, (GLOSS LEVEL AS INDICATED IN PAINT
            WOOD SUBSTRATES:
                    INSTITUTIONAL LOW-ODOR/VOC LATEX SYSTEM:
                          PRIME COAT: INTERIOR LATEX PRIMER/SEALER
                          TOPCOAT: INSTITUTIONAL LOW-ODOR/VOC INTERIOR
                          LATEX (GLOSS LEVEL AS INDICATED IN PAINT SCHEDULE).
            GYPSUM BOARD SUBSTRATES:
                   INSTITUTIONAL LOW-ODOR/VOC LATEX SYSTEM:
                          PRIME COAT: INTERIOR LATEX PRIMER/SEALER.
                          TOPCOAT: INSTITUTIONAL LOW-ODOR/VOC INTERIOR
                          LATEX (GLOSS LEVEL AS INDICATED IN PAINT SCHEDULE).
             HIGH-IMPACT GYPSUM BOARD SUBSTRATES:
                   HIGH-PERFORMANCE ARCHITECTURAL LATEX SYSTEM:
                          PRIME COAT: INTERIOR LATEX PRIMER/SEALER
                          TOPCOAT: INSTITUTIONAL LOW-ODOR/VOC INTERIOR
                          LATEX (GLOSS LEVEL AS INDICATED IN PAINT SCHEDULE).
            PLASTER SUBSTRATES:
                   INSTITUTIONAL LOW-ODOR/VOC LATEX SYSTEM:
                          PRIME COAT: INTERIOR LATEX PRIMER/SEALER.
                          TOPCOAT: INSTITUTIONAL LOW-ODOR/VOC INTERIOR
                          LATEX (GLOSS LEVEL AS INDICATED IN PAINT SCHEDULE).
            ACOUSTICAL CEILING TILE:
                   INSTITUTIONAL LOW-ODOR/VOC LATEX SYSTEM:
                          PRIME COAT: INTERIOR LATEX PRIMER/SEALER
                          TOPCOAT: INSTITUTIONAL LOW-ODOR/VOC INTERIOR
                          LATEX (GLOSS LEVEL AS INDICATED IN PAINT SCHEDULE).
END OF SECTION 099123
SECTION 09930 - WOOD STAINS AND TRANSPARENT FINISHES
            SURFACE PREPARATION AND APPLICATION OF WOOD FINISHES ON
             [EXTERIOR] [AND] [INTERIOR] SUBSTRATES.
            SAMPLES FOR VERIFICATION: FOR EACH TYPE OF FINISH SYSTEM AND IN
             EACH COLOR AND GLOSS OF FINISH INDICATED.
      QUALITY ASSURANCE
            QUALITY STANDARDS: "MPI APPROVED PRODUCTS LIST" AND "MPI
             ARCHITECTURAL PAINTING SPECIFICATION MANUAL."
           CHEMICAL COMPONENTS OF FIELD-APPLIED INTERIOR PAINTS AND COATINGS:
                        CLEAR WOOD FINISHES, VARNISHES: VOC NOT MORE THAN
                          SHELLACS, CLEAR: VOC NOT MORE THAN 730 G/L
                          STAINS: VOC NOT MORE THAN 250 G/L
                           PRIMERS, SEALERS, AND UNDERCOATERS: 200 G/L.
                          FIRE RETARDANT COATINGS, CLEAR: 650 G/L.
                          FIRE RETARDANT COATINGS, PIGMENTED: 350 G/L.
     EXTERIOR WOOD-FINISH-SYSTEM SCHEDULE
            SOLID-COLOR LATEX STAIN SYSTEM: MPI EXT 6.3K.
                   PRIME COAT: PRIMER, LATEX FOR EXTERIOR WOOD.
                    INTERMEDIATE COAT: STAIN, EXTERIOR, WATER BASED, SOLID HIDE,
                    MATCHING TOPCOAT
                   TOPCOAT: STAIN, EXTERIOR, WATER BASED, SOLID HIDE.
            SEMITRANSPARENT STAIN SYSTEM: MPI EXT 6.3D.
                 TWO STAIN COATS: EXTERIOR SEMITRANSPARENT LATEX STAIN.
     INTERIOR WOOD-FINISH-SYSTEM SCHEDULE
            SEMITRANSPARENT STAIN SYSTEM:
                    PRIME COAT: STAIN, SEMI-TRANSPARENT, MATCHING TOPCOAT.
                    TOPCOAT: STAIN, SEMI-TRANSPARENT, FOR INTERIOR WOOD.
            WATER-BASED VARNISH SYSTEM:
                    PRIME COAT: WATER-BASED VARNISH MATCHING TOPCOAT.
                    INTERMEDIATE COAT: WATER-BASED VARNISH MATCHING TOPCOAT.
                    TOPCOAT: VARNISH, WATER BASED, CLEAR.
            WATER-BASED FIRE RETARDANT SYSTEM:
                    TOPCOAT: FIRE RETARDANT COATING, CLEAR.
                          CLASS A FLAME SPREAD AND SMOKE-DEVELOPED INDEX PER
                          ASTM E 84.
END OF SECTION 09930
```

1.2

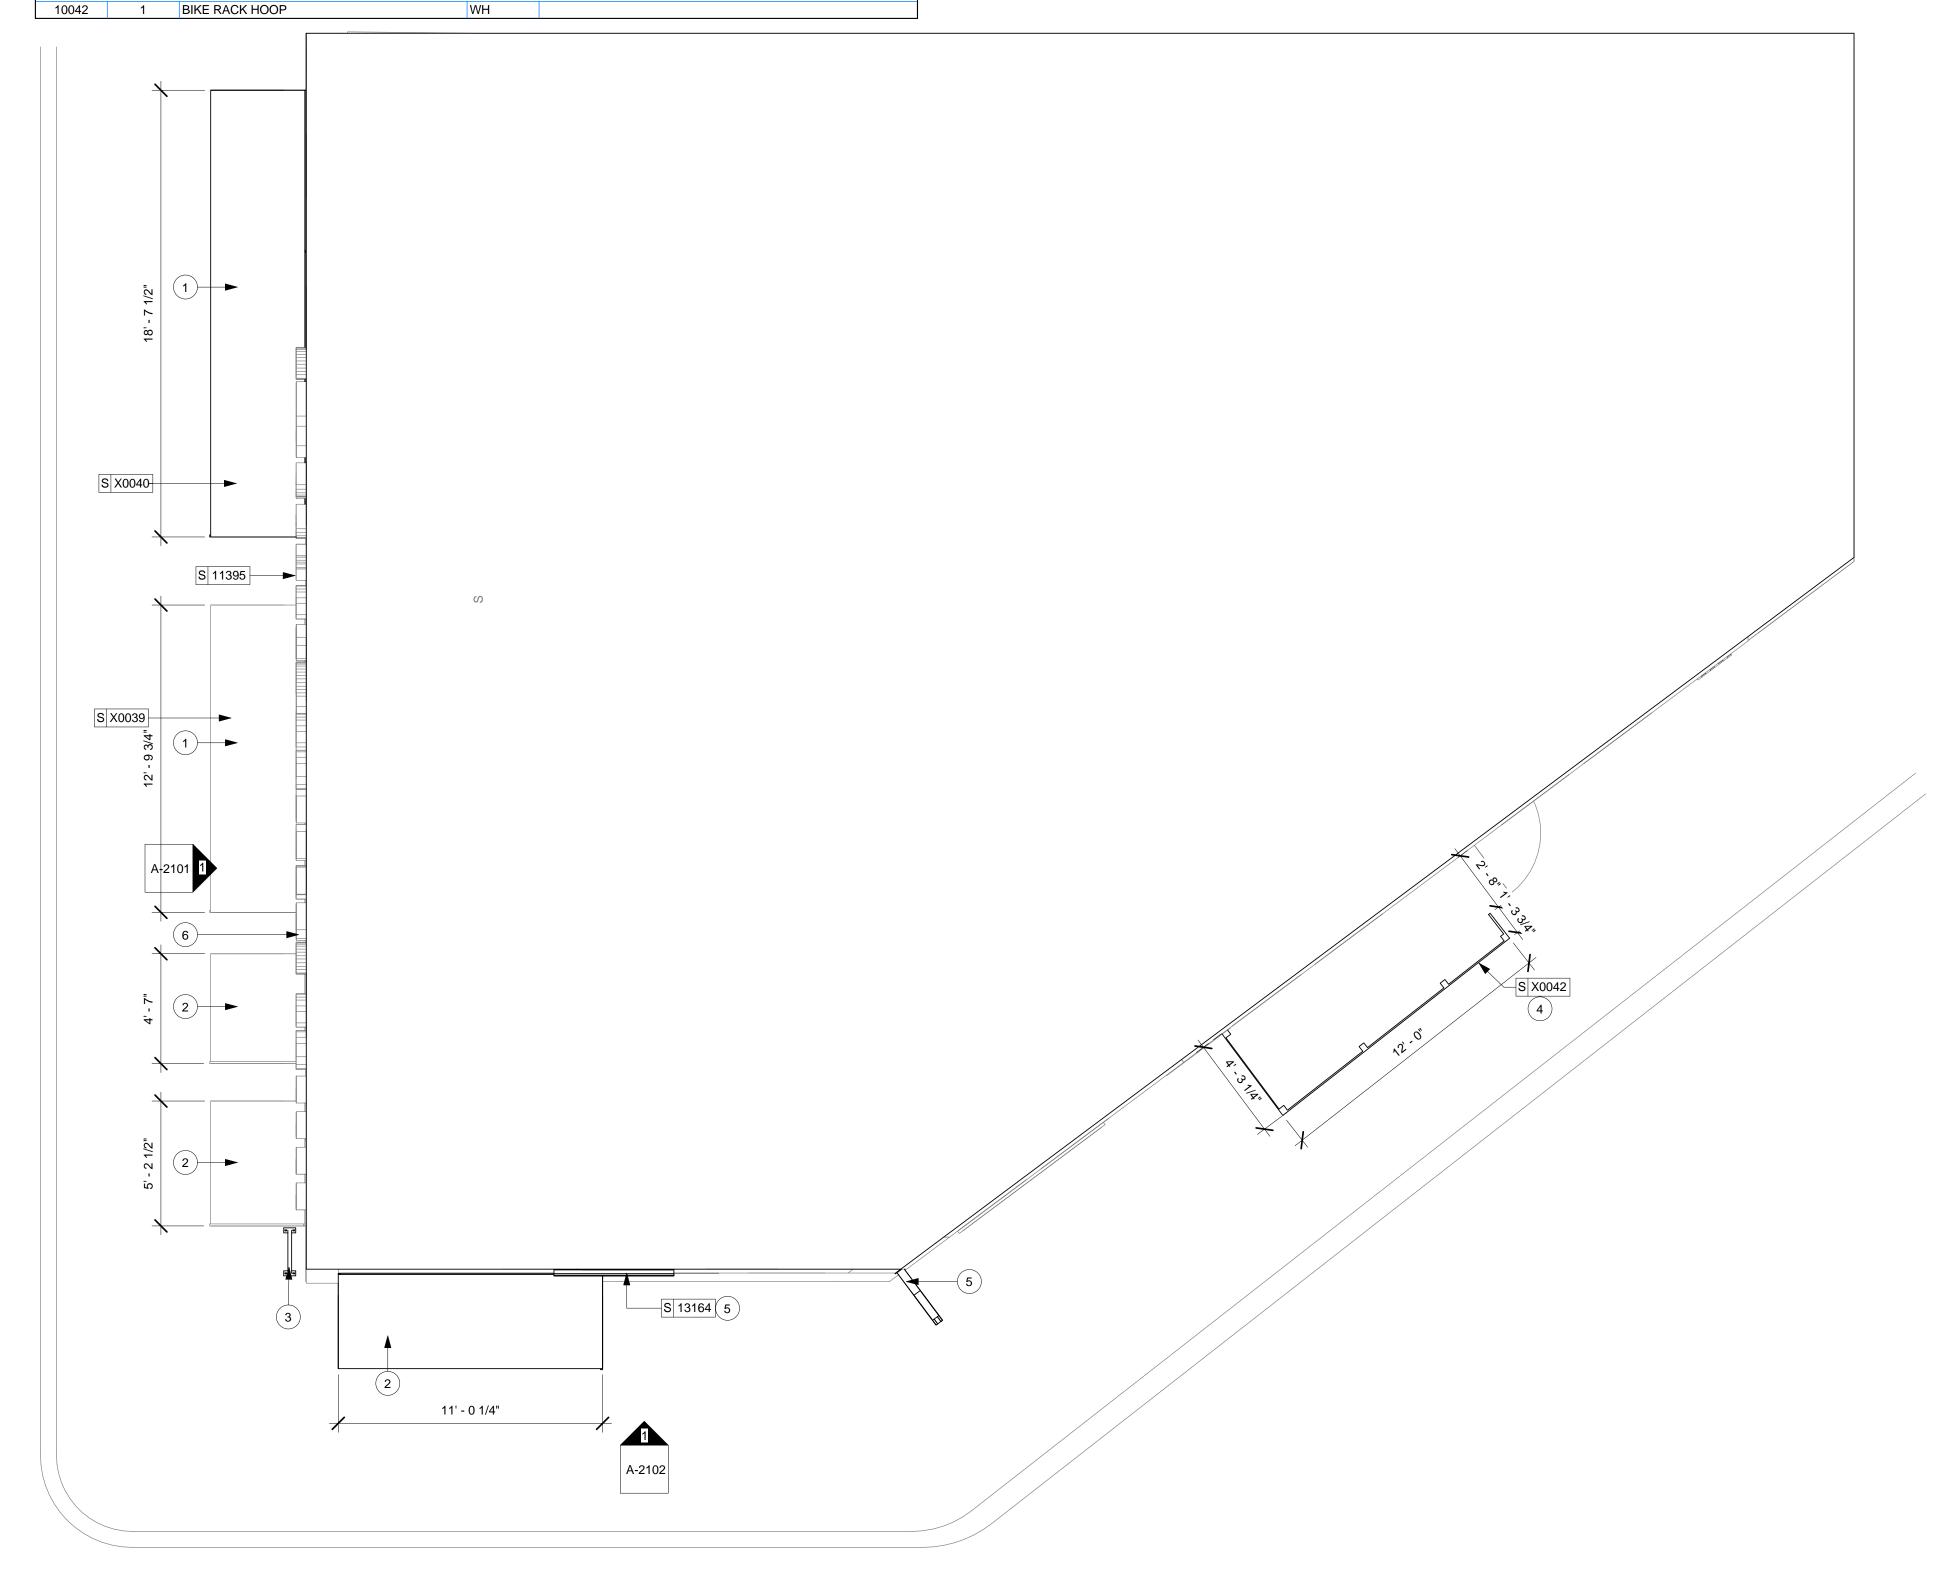

ARCHITECTURAL SITE PLAN NOTES

A. REFER TO EXTERIOR ELEVATIONS FOR BUILDING SIGNAGE LOCATION AND DESIGN ID. REFER TO ELECTRICAL PLANS FOR ELECTRICAL REQUIREMENTS.

B. LANDSCAPING TO BE PROVIDED PER ZONING CODE AND LEED REQUIREMENTS.

C. DRIVE-THRU EQUIPMENT INCLUDING VEHICLE DETECTION LOOP, WIRELESS COMMUNICATION, AND MONITORS COORDINATED BY STARBUCKS CONSTRUCTION MANAGER. REFER TO ELECTRICAL SPECIFICATIONS FOR ELECTRICAL REQUIREMENTS.

D. LANDLORD IS RESPONSIBLE FOR PROVIDING SITE WORK, INCLUDING NEW BOLLARDS, FOOTING AND CONDUIT FOR DRIVE-THRU SIGNAGE. COORDINATE WITH STARBUCKS CONSTRUCTION MANAGER.

E. ALL PARKING AND DRIVE-THRU STRIPING TO BE PROVIDED BY LANDLORD.

F. TRASH ENCLOSURE TO BE LOCKABLE USING STEEL GATES OR CHAIN TO BE PROVIDED BY LANDLORD.

G. LANDLORD TO PROVIDE 6" (150MM) THICK CONCRETE PAVING THE LENGTH OF THE DRIVE-THRU LANE, EXTENT TO INCLUDE DRIVE-THRU WINDOW STANDING PAD.

H. GENERAL CONTRACTOR TO APPLY CONCRETE SEALER TO ALL EXTERIOR CONCRETE PATIO AND WALKWAY SURFACES.

SHEET NOTES

1. NEW BLACK FABRIC AWNINGS PROVIDED BY HILTON DISPLAYS.


2. EXISTING AWNING FRAMES - REPAINT AND REUPHOLSTER WITH BLACK FABRIC. PROVIDED BY HILTON DISPLAYS.

3. GC TO INSTALL BIKE HOOP PER MANUFACTURER'S INSTRUCTIONS.

4. NEW TRASH ENCLOSURE. PROVIDED BY STARBUCKS. INSTALLED BY GC.

5. EXISTING 18" BLADE SIGN ENCLOSURE. SIGNAGE VENDOR TO REPLACE SIGN VINYL WITH EVOLVED LOGO DISK

6. EXISTING WORDMARK HOUSING. SIGNAGE VENDOR TO REPLACE WITH WHITE VINYL LETTERS.

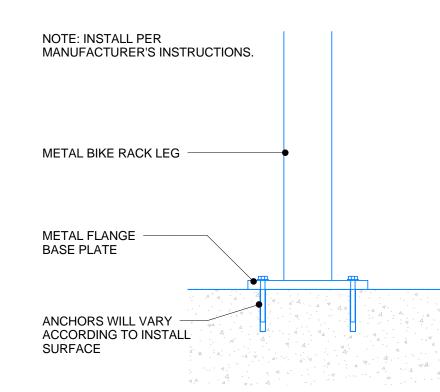

2 BIKE RACK INSTALLATION

Scale: 3" = 1'-0"





STARBUCKS COFFEE **COMPANY**

2401 UTAH AVENUE SOUTH SEATTLE, WASHINGTON 98134 (206) 318-1575

THESE DRAWINGS AND SPECIFICATIONS ARE CONFIDENTIAL AND SHALL REMAIN THE SOLE PROPERTY OF STARBUCKS CORPORATION, WHICH IS THE OWNER OF THE COPYRIGHT IN THIS WORK. THEY SHALL NOT BE REPRODUCED (IN WHOLE OR IN PART), SHARED WITH THIRD PARTIES OR USED IN ANY MANNER ON OTHER PROJECTS OR EXTENSIONS TO THIS PROJECT WITHOUT THE PRIOR WRITTEN CONSENT OF STARBUCKS CORPORATION. THESE DRAWINGS AND SPECIFICATIONS ARE INTENDED TO EXPRESS DESIGN INTENT FOR A PROTOTYPICAL STARBUCKS STORE (WHICH IS SUBJECT TO CHANGE AT ANYTIME) AND DO NOT REFLECT ACTUAL SITE CONDITIONS. NEITHER PARTY SHALL HAVE ANY OBLIGATION NOR LIABILITY TO THE OTHER (EXCEPT STATED ABOVE) UNTIL A WRITTEN AGREEMENT IS FULLY EXECUTED BY BOTH PARTIES.

ARCHITECT OF RECORD





Engineering Consultants Mechanical - Electrical - Plumbing

Revision Schedule

FARWELL

STORE #: 2305 PROJECT #: 04217-001 CONCEPT: MCS PALETTE: HERITAGE ISSUE DATE: 12 09 13 DESIGN MANAGER: S. RYCHLIK LEED® AP: PRODUCTION DESIGNER: C. ALINOVICH CHECKED BY:

SHEET TITLE:


ARCHITECTURAL SITE PLAN

As indicated

SCALE: SHEET NUMBER:

A-1101

SITE PLAN - FOR REFERENCE ONLY

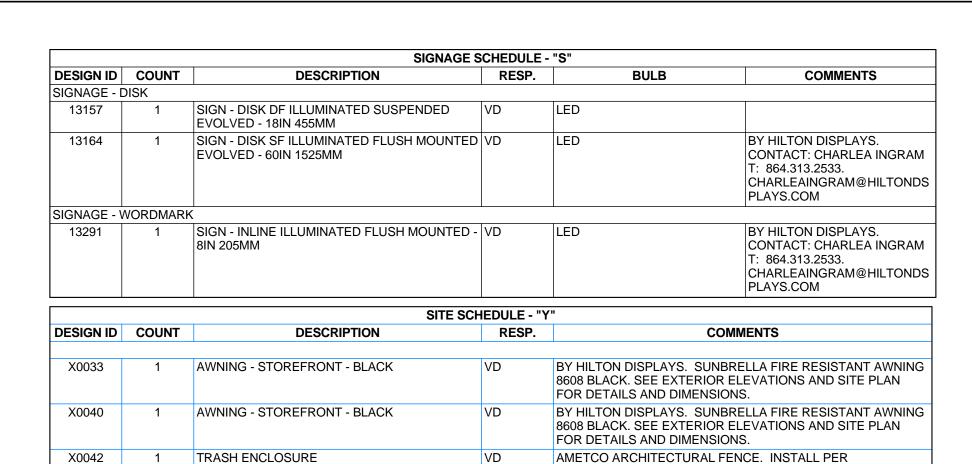

ALLOWED SIGNAGE RQMTS:

Wall Signage 18 sq ft of wall signage *businesses may also have one projecting wall sign, no more than 12 sq ft.

Window Signage: Cannot cover > 25% of window area

PROPOSED SIGNAGE:

Existing Starbucks Wordmark - ID: 11395 (Qty: 1) Area: 24 SF (Internally Illuminated Inline) Height: 18in

Logo Disk - ID: 13164 (Qty: 1) Area: 5 SF (Internally Illuminated Inline)

Height: 48 in Blade Logo Disk - ID: 13158 (Qty: 1) Area: 2 SF (Internally Illuminated Inline)

Height: 18 in Suspended Window Logo Disk - ID: 13157 (Qty: 1) Area: 2 SF (Internally Illuminated Inline) Height: 18 in

Proposed Signage Total Area: 33 SF

SHEET NOTES

- 1. GC TO REPAIR AND REPAINT SILLS
- 2. NEW AWNING AT EXPANSION SPACE STOREFRONT.
- 4. REUPHOLSTER EXISTING STARBUCKS AWNINGS.
- SALVAGE FRAMES.
- 5. NEW 18IN WORDMARK SIGN.
- 6. GC TO INSTALL NEW/REPAIR FLASHING AT STOREFRONT AS REQUIRED.
- 7. GC TO TUCKPOINT FACADE AS NECESSARY.
- 8. NEW STOREFRONT DOOR AND HARDWARE.
- 9. EXISTING 18IN BLADE SIGN. REPLACE WITH NEW EVOLVED LOGO DISK.
- 10. VERIFY FRAME PROFILE AND DIMENSIONS TO ENSURE IT CLEARS EXISTINF FIRE ESCAPE.
- 11. REPLACE AWNING FRAMES TO MATCH NEW ONLY IF NEW PROFILE IS REQUIRE PER EXISTING FIRE ESCAPE.

EXTERIOR ELEVATION NOTES


- A. GENERAL CONTRACTOR TO COORDINATE AND SCHEDULE SIGNAGE INSTALLATION WITH THE SIGNAGE CONTRACTOR PROVIDING A MINIMUM SCHEDULING NOTICE OF 4 WEEKS AND 1 WEEK PRIOR TO SCHEDULED DATE OF INSTALLATION. STARBUCKS
- 3. INSTALL NEW 24IN ILLUMINATED INTERIOR LOGO DISK CONSTRUCTION MANAGER TO PROVIDE GENERAL CONTRACTOR WITH SIGNAGE CONTRACTOR CONTACT INFORMATION. B. GENERAL CONTRACTOR SHALL COORDINATE WITH ELECTRICAL
 - CONTRACTOR TO FURNISH AND INSTALL ELECTRICAL CIRCUITS INCLUDING ALL CONDUIT, WIRE, CONNECTIONS, AND BREAKER AT PANEL BOARD NECESSARY TO SERVE SIGNAGE.
 - C. GENERAL CONTRACTOR TO PROVIDE FIRE TREATED WOOD STUD BLOCKING, OR EQUIVALENT TO SUPPORT SIGNAGE.
 - D. SIGNAGE CONTRACTOR SHALL VERIFY SIZE AND LOCATION OF ANY AND ALL ALLOWABLE MONUMENT OR POLE SIGNAGE WITH LANDLORD AND PROVIDE SHOP DRAWING(S) PRIOR TO FABRICATION TO STARBUCKS DESIGNER FOR APPROVAL.
 - E. SIGNAGE CONTRACTOR TO INSTALL SIGNAGE IN COMPLIANCE WITH LOCAL CODES AND OBTAIN PERMIT AND LANDLORD APPROVAL.
 - F. SIGNAGE CONTRACTOR TO SUPPLY SHOP DRAWINGS TO STARBUCKS CONSTRUCTION MANAGER AND TO THE GENERAL CONTRACTOR AS NEEDED. GENERAL CONTRACTOR TO NOTIFY STARBUCKS CONSTRUCTION MANAGER IMMEDIATELY IF SHOP DRAWINGS OR INSTALLATION IS IN DISCREPANCY WITH STARBUCKS ARCHITECTURAL DRAWINGS.
 - G. GENERAL CONTRACTOR TO CLEAN, PATCH AND REPAIR EXISTING EXTERIOR AS REQUIRED.
 - H. SEE SCHEDULE SHEETS FOR SIGNAGE SCHEDULE.



STARBUCKS COFFEE COMPANY 2401 UTAH AVENUE SOUTH

SEATTLE, WASHINGTON 98134 (206) 318-1575

THESE DRAWINGS AND SPECIFICATIONS ARE CONFIDENTIAL AND SHALL REMAIN THE SOLE PROPERTY OF STARBUCKS CORPORATION, WHICH IS THE OWNER OF THE COPYRIGHT IN THIS WORK. THEY SHALL NOT BE REPRODUCED (IN WHOLE OR IN PART), SHARED WITH THIRD PARTIES OR USED IN ANY MANNER ON OTHER PROJECTS OR EXTENSIONS TO THIS PROJECT WITHOUT THE PRIOR WRITTEN CONSENT OF STARBUCKS CORPORATION. THESE DRAWINGS AND SPECIFICATIONS ARE INTENDED TO EXPRESS DESIGN INTENT FOR A PROTOTYPICAL STARBUCKS STORE (WHICH IS SUBJECT TO CHANGE AT ANYTIME) AND DO NOT REFLECT ACTUAL SITE CONDITIONS. NEITHER PARTY SHALL HAVE ANY OBLIGATION NOR LIABILITY TO THE OTHER (EXCEPT STATED ABOVE) UNTIL A WRITTEN AGREEMENT IS FULLY EXECUTED BY BOTH PARTIES.

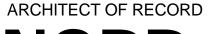





Engineering Consultants Mechanical - Electrical - Plumbing

Phone (314) 772-1782

Fax (314) 373-3514

Revision Schedule Description

STORE #: 2305 PROJECT #: 04217-001 MCS CONCEPT: HERITAGE ISSUE DATE: 12 09 13 **DESIGN MANAGER:** S. RYCHLIK LEED® AP: PRODUCTION DESIGNER: C. ALINOVICH

SHEET TITLE:

CHECKED BY:

EXTERIOR ELEVATIONS

1/4" = 1'-0"

SCALE: SHEET NUMBER:

A-2101



SITE SCHEDULE - "Y"						
DESIGN ID	COUNT	DESCRIPTION	RESP.	COMMENTS		
X0033	1	AWNING - STOREFRONT - BLACK	VD	BY HILTON DISPLAYS. SUNBRELLA FIRE RESISTANT AWNING 8608 BLACK. SEE EXTERIOR ELEVATIONS AND SITE PLAN FOR DETAILS AND DIMENSIONS.		
X0040	1	AWNING - STOREFRONT - BLACK	VD	BY HILTON DISPLAYS. SUNBRELLA FIRE RESISTANT AWNING 8608 BLACK. SEE EXTERIOR ELEVATIONS AND SITE PLAN FOR DETAILS AND DIMENSIONS.		
X0042	1	TRASH ENCLOSURE	VD	AMETCO ARCHITECTURAL FENCE. INSTALL PER MANUFACTURER'S INSTRUCTION.		
OTHER						
10042	1	BIKE RACK HOOP	WH			

2 S 13164 6 12' - 0" S X0042 4



- 1. GC TO REPAIR AND REPAINT SILLS AS NECESSARY. PAINT TO MATCH ALL OTHER SILLS.
- 2. INSTALL NEW 60IN FLUSH MOUNTED, ILLUMINATED LOGO DISK.
- 3. INSTALL NEW 18IN BLADE SIGN.
- 4. INSTALL NEW TRASH ENCLOSURE. GC TO INSTALL PER MANUFACTURER'S INSTRUCTIONS.
- 5. TUCKPOINT FACADE AS NECESSARY.
- 6. REPLACE AWNING FRAMES TO MATCH NEW ONLY IF NEW PROFILE IS REQUIRE PER EXISTING FIRE ESCAPE.



STARBUCKS COFFEE COMPANY 2401 UTAH AVENUE SOUTH

SEATTLE, WASHINGTON 98134

(206) 318-1575

THESE DRAWINGS AND SPECIFICATIONS ARE CONFIDENTIAL AND SHALL REMAIN THE SOLE PROPERTY OF STARBUCKS CORPORATION, WHICH IS THE OWNER OF THE COPYRIGHT IN THIS WORK. THEY SHALL NOT BE REPRODUCED (IN WHOLE OR IN PART), SHARED WITH THIRD PARTIES OR USED IN ANY MANNER ON OTHER PROJECTS OR EXTENSIONS TO THIS PROJECT WITHOUT THE PRIOR WRITTEN CONSENT OF STARBUCKS CORPORATION. THESE DRAWINGS AND SPECIFICATIONS ARE INTENDED TO EXPRESS DESIGN INTENT FOR A PROTOTYPICAL STARBUCKS STORE (WHICH IS SUBJECT TO CHANGE AT ANYTIME) AND DO NOT REFLECT ACTUAL SITE CONDITIONS. NEITHER PARTY SHALL HAVE ANY OBLIGATION NOR LIABILITY TO THE OTHER (EXCEPT STATED ABOVE) UNTIL A WRITTEN AGREEMENT IS FULLY EXECUTED BY BOTH PARTIES.

ARCHITECT OF RECORD





	Revision Schedule						
Rev	ev Date By Description						

STORE #:	2305
PROJECT #:	04217-001
CONCEPT:	MCS
PALETTE:	HERITAGE
ISSUE DATE:	12 09 13
DESIGN MANAGER:	S. RYCHLIK
LEED® AP:	N/A
PRODUCTION DESIGNER:	C. ALINOVICH
CHECKED BY:	K. GORIN

EXTERIOR ELEVATIONS


SHEET NUMBER:

1/4" = 1'-0"

A-2102

WEST STOREFRONT ELEVATION

Scale: 1/4" = 1'-0"

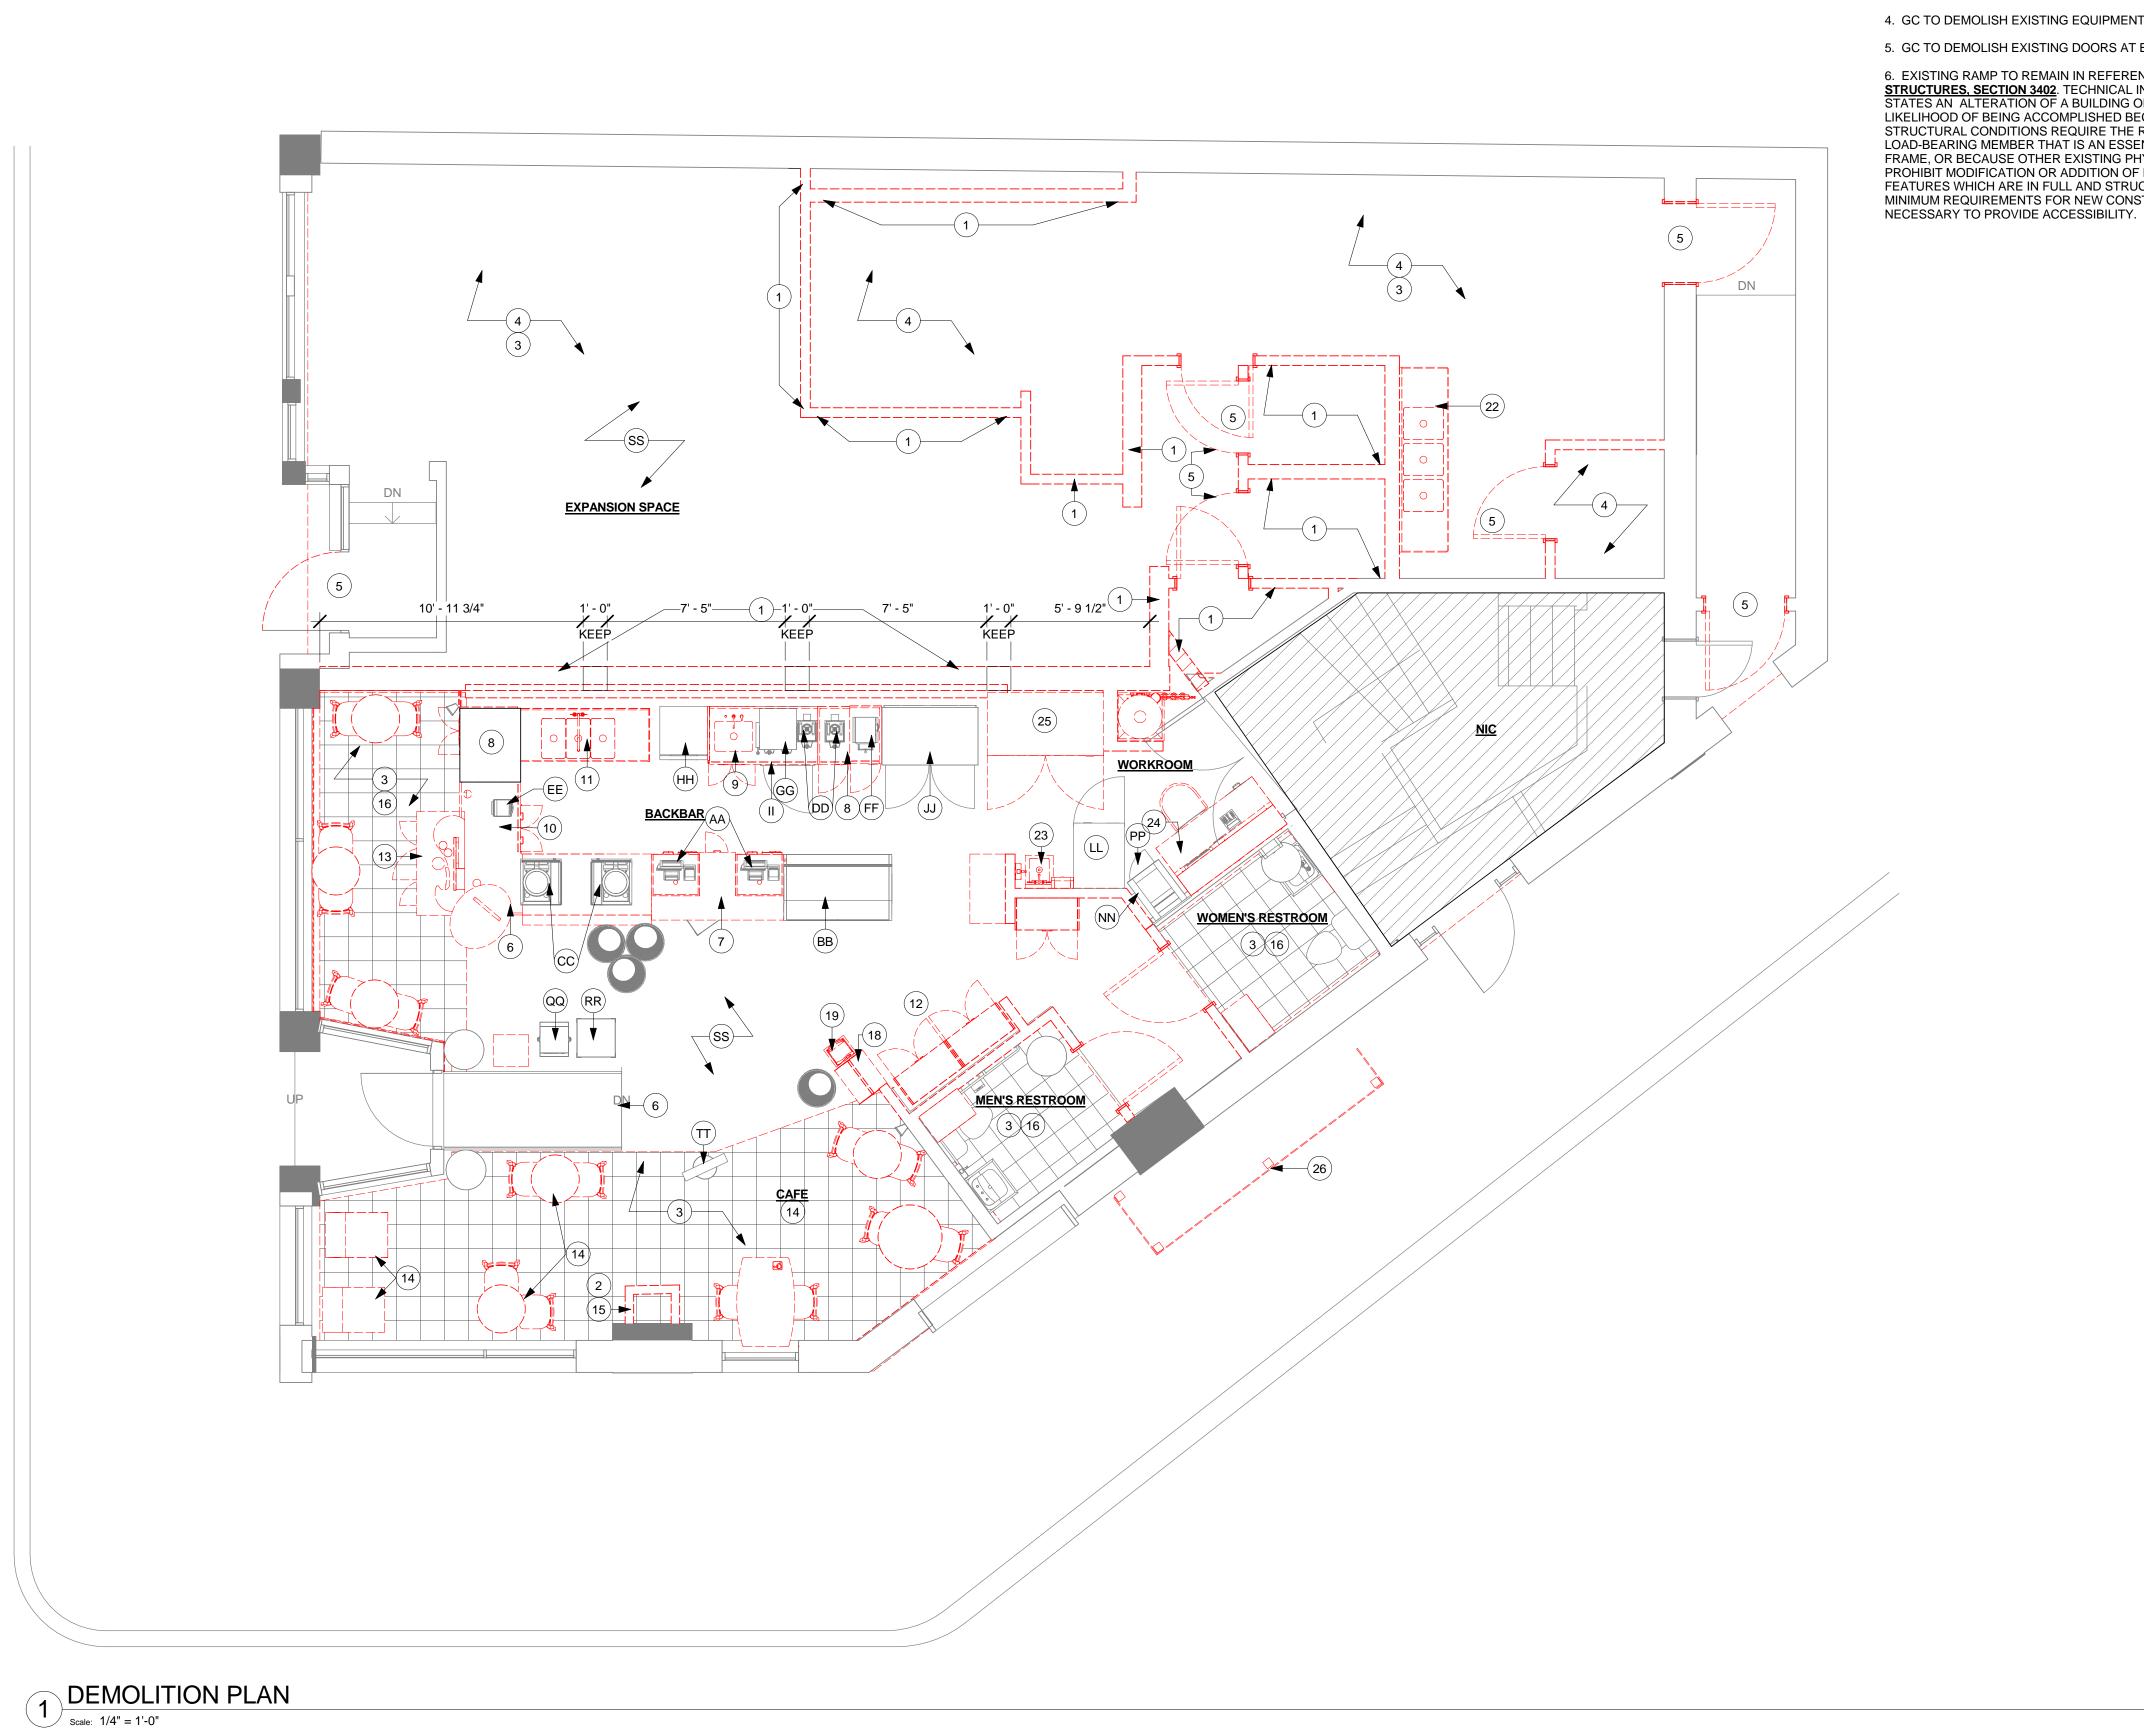

SHEET NOTES

- 1. DEMOLISH INTERIOR PARTITION WALLS AS INDICATED.
- 2. GC TO DEMOLISH EXISTING FIREPLACE
- 3. GC TO DEMOLISH EXISTING FLOOR TILE AS INDICATED.
- 4. GC TO DEMOLISH EXISTING EQUIPMENT IN EXPANSION SPACE.
- 5. GC TO DEMOLISH EXISTING DOORS AT EXPANSION SPACE.
- 6. EXISTING RAMP TO REMAIN IN REFERENCE TO IBC, <u>CHAPTER 34 EXISTING</u> C. EXISTING WALLS TO REMAIN. PATCH AND REPAIR AS <u>STRUCTURES, SECTION 3402</u>. TECHNICAL INFEASIBLE. SECTION 3402 REQUIRED TO PROVIDE A SMOOTH, PAINT READY FINISH. STATES AN ALTERATION OF A BUILDING OR A FACILITY THAT HAS LITTLE LIKELIHOOD OF BEING ACCOMPLISHED BECAUSE THE EXISTING STRUCTURAL CONDITIONS REQUIRE THE REMOVAL OR ALTERATION OF A LOAD-BEARING MEMBER THAT IS AN ESSENTIAL PART OF THE STRUCTURAL E. DEMOLISH EXISTING FLOOR FINISHES AS NECESSARY. FRAME, OR BECAUSE OTHER EXISTING PHYSICAL OR SITE CONSTRAINTS PROHIBIT MODIFICATION OR ADDITION OF ELEMENTS, SPACES, OR FEATURES WHICH ARE IN FULL AND STRUCT COMPLIANCE WITH THE MINIMUM REQUIREMENTS FOR NEW CONSTRUCTION AND WHICH ARE

DEMOLITION PLAN NOTES

A. IF DURING DEMOLITION CONDITIONS ARE REVEALED THAT MAY JEOPARDIZE INTEGRITY OF STRUCTURE OR PRECLUDE FOLLOWING DESIGN INTENT, GENERAL CONTRACTOR TO NOTIFY STARBUCKS CONSTRUCTION MANAGER IMMEDIATELY.

B. GENERAL CONTRACTOR RESPONSIBLE FOR SITE INVESTIGATION PRIOR TO DEMOLITION TO REVEAL FULL SCOPE OF WORK.

D. DEMOLISH EXISTING WALLS AND DOORS AS NECESSARY.

REPAIR OR REPLACE SUB-FLOOR AS REQUIRED TO PROVIDE AN EVEN WALKING SURFACE/FINISH FLOOR CONDITION.

F. DEMOLISH EXISTING GYPSUM WALL BOARD, CEILING TILE, GRID AND/OR OTHER CEILING FINISH AS NECESSARY TO PROVIDE FOR NEW CEILING READY CONDITION.

G. DEMOLISH EXISTING WALL FINISHES AS NECESSARY.

H. REMOVE EXISTING LIGHT FIXTURES, AUXILIARY EQUIPMENT/FIXTURES AND POWER LINES AS NECESSARY.

J. REMOVE EXISTING PLUMBING FIXTURES AS NECESSARY. CAP LINES AS NECESSARY FOR THOSE NOT BEING RE-

K. REMOVE EXTRANEOUS EQUIPMENT AS NECESSARY.

L. GENERAL CONTRACTOR TO NOTIFY ARCHITECT OF SIZE OF EXISTING RESTROOM AND LOCATION AND CONDITION OF FIXTURES PRIOR TO DEMOLITION OR CONSTRUCTION. PLUMBING FIXTURES TO BE RE-USED ARE TO BE REMOVED AND PROPERLY STORED FOR RE-INSTALLATION.



STARBUCKS COFFEE **COMPANY**

2401 UTAH AVENUE SOUTH SEATTLE, WASHINGTON 98134 (206) 318-1575

THESE DRAWINGS AND SPECIFICATIONS ARE CONFIDENTIAL AND SHALL REMAIN THE SOLE PROPERTY OF STARBUCKS CORPORATION, WHICH IS THE OWNER OF THE COPYRIGHT IN THIS WORK. THEY SHALL NOT BE REPRODUCED (IN WHOLE OR IN PART), SHARED WITH THIRD PARTIES OR USED IN ANY MANNER ON OTHER PROJECTS OR EXTENSIONS TO THIS PROJECT WITHOUT THE PRIOR WRITTEN CONSENT OF STARBUCKS CORPORATION. THESE DRAWINGS AND SPECIFICATIONS ARE INTENDED TO EXPRESS DESIGN INTENT FOR A PROTOTYPICAL STARBUCKS STORE (WHICH IS SUBJECT TO CHANGE AT ANYTIME) AND DO NOT REFLECT ACTUAL SITE CONDITIONS. NEITHER PARTY SHALL HAVE ANY OBLIGATION NOR LIABILITY TO THE OTHER (EXCEPT STATED ABOVE) UNTIL A WRITTEN AGREEMENT IS FULLY EXECUTED BY BOTH PARTIES.

ARCHITECT OF RECORD





Phone (314) 772-1782 Fax (314) 373-3514 **Engineering Consultants**

Mechanical - Electrical - Plumbing

Revision Schedule

ITEMS TO DEMOLISH:

BACKBAR 6. ESPRESSO BAR

7. POS STATION 8. BACKLINE CABINETS 9. BREW STATION

10. COLD BREW STATION 11. 3 COMP SINK

12. MERCHANDISE BAYS 13. CONDIMENT CART 14. CAFE CHARS, SOFT SEATING & TABLES 15. FIREPLACE/SURROUND

16. TILE FLOORING 17. ETAGERE 18. COFFEE PROMOTION STAND

19. SMALLWARES PROMOTION STAND

WORKROOM 21. WATER FILTRATION 22. 3-COMP SINK

23. HAND SINK, SOAP & TOWEL DISPENSER 24. MANAGER'S DESK 25. 2-DR FRIDGE

EXTERIOR 26. TRASH ENCLOSURE

ITEM TO PRESERVE:

FRONTBARAA. POS EQUIPMENT

BB. PASTRY CASE CC. ESPRESSO MACHINES (2) DD. SHUTTLE (1) EE. BLENDER (1)

FF. GRINDER GG. DOUBLE BREWER HH. SANITIZER II. 1-DR U/C FRIDGE JJ. 2-DR FRIDGE

WORKROOM KK. NOT USED

PP. SAFE

LL. 1-DR REACH IN FREEZER (2)

MM. NOT USED NN. IT RACK OO. NOT USED

CAFE QQ. NEWSPAPER RACK RR. MERCHANDISE CUBE SS. TERAZZO FLOOR

TT. BANNER STAND

WALL LEGEND - DEMO PLAN

[_____] MATERIAL TO BE DEMOLISHED ☐ EXISTING WALL TO REMAIN

EXISTING COLUMN TO REMAIN





FARWELL


STORE #: 2305 PROJECT #: 04217-001 MCS CONCEPT: PALETTE: HERITAGE ISSUE DATE: 12 09 13 DESIGN MANAGER: S. RYCHLIK LEED $^{ extsf{R}}$ AP: N/A PRODUCTION DESIGNER: C. ALINOVICH CHECKED BY: K. GORIN

SHEET TITLE:

DEMOLITION FLOOR

PLAN SCALE: 1/4" = 1'-0"

SHEET NUMBER:

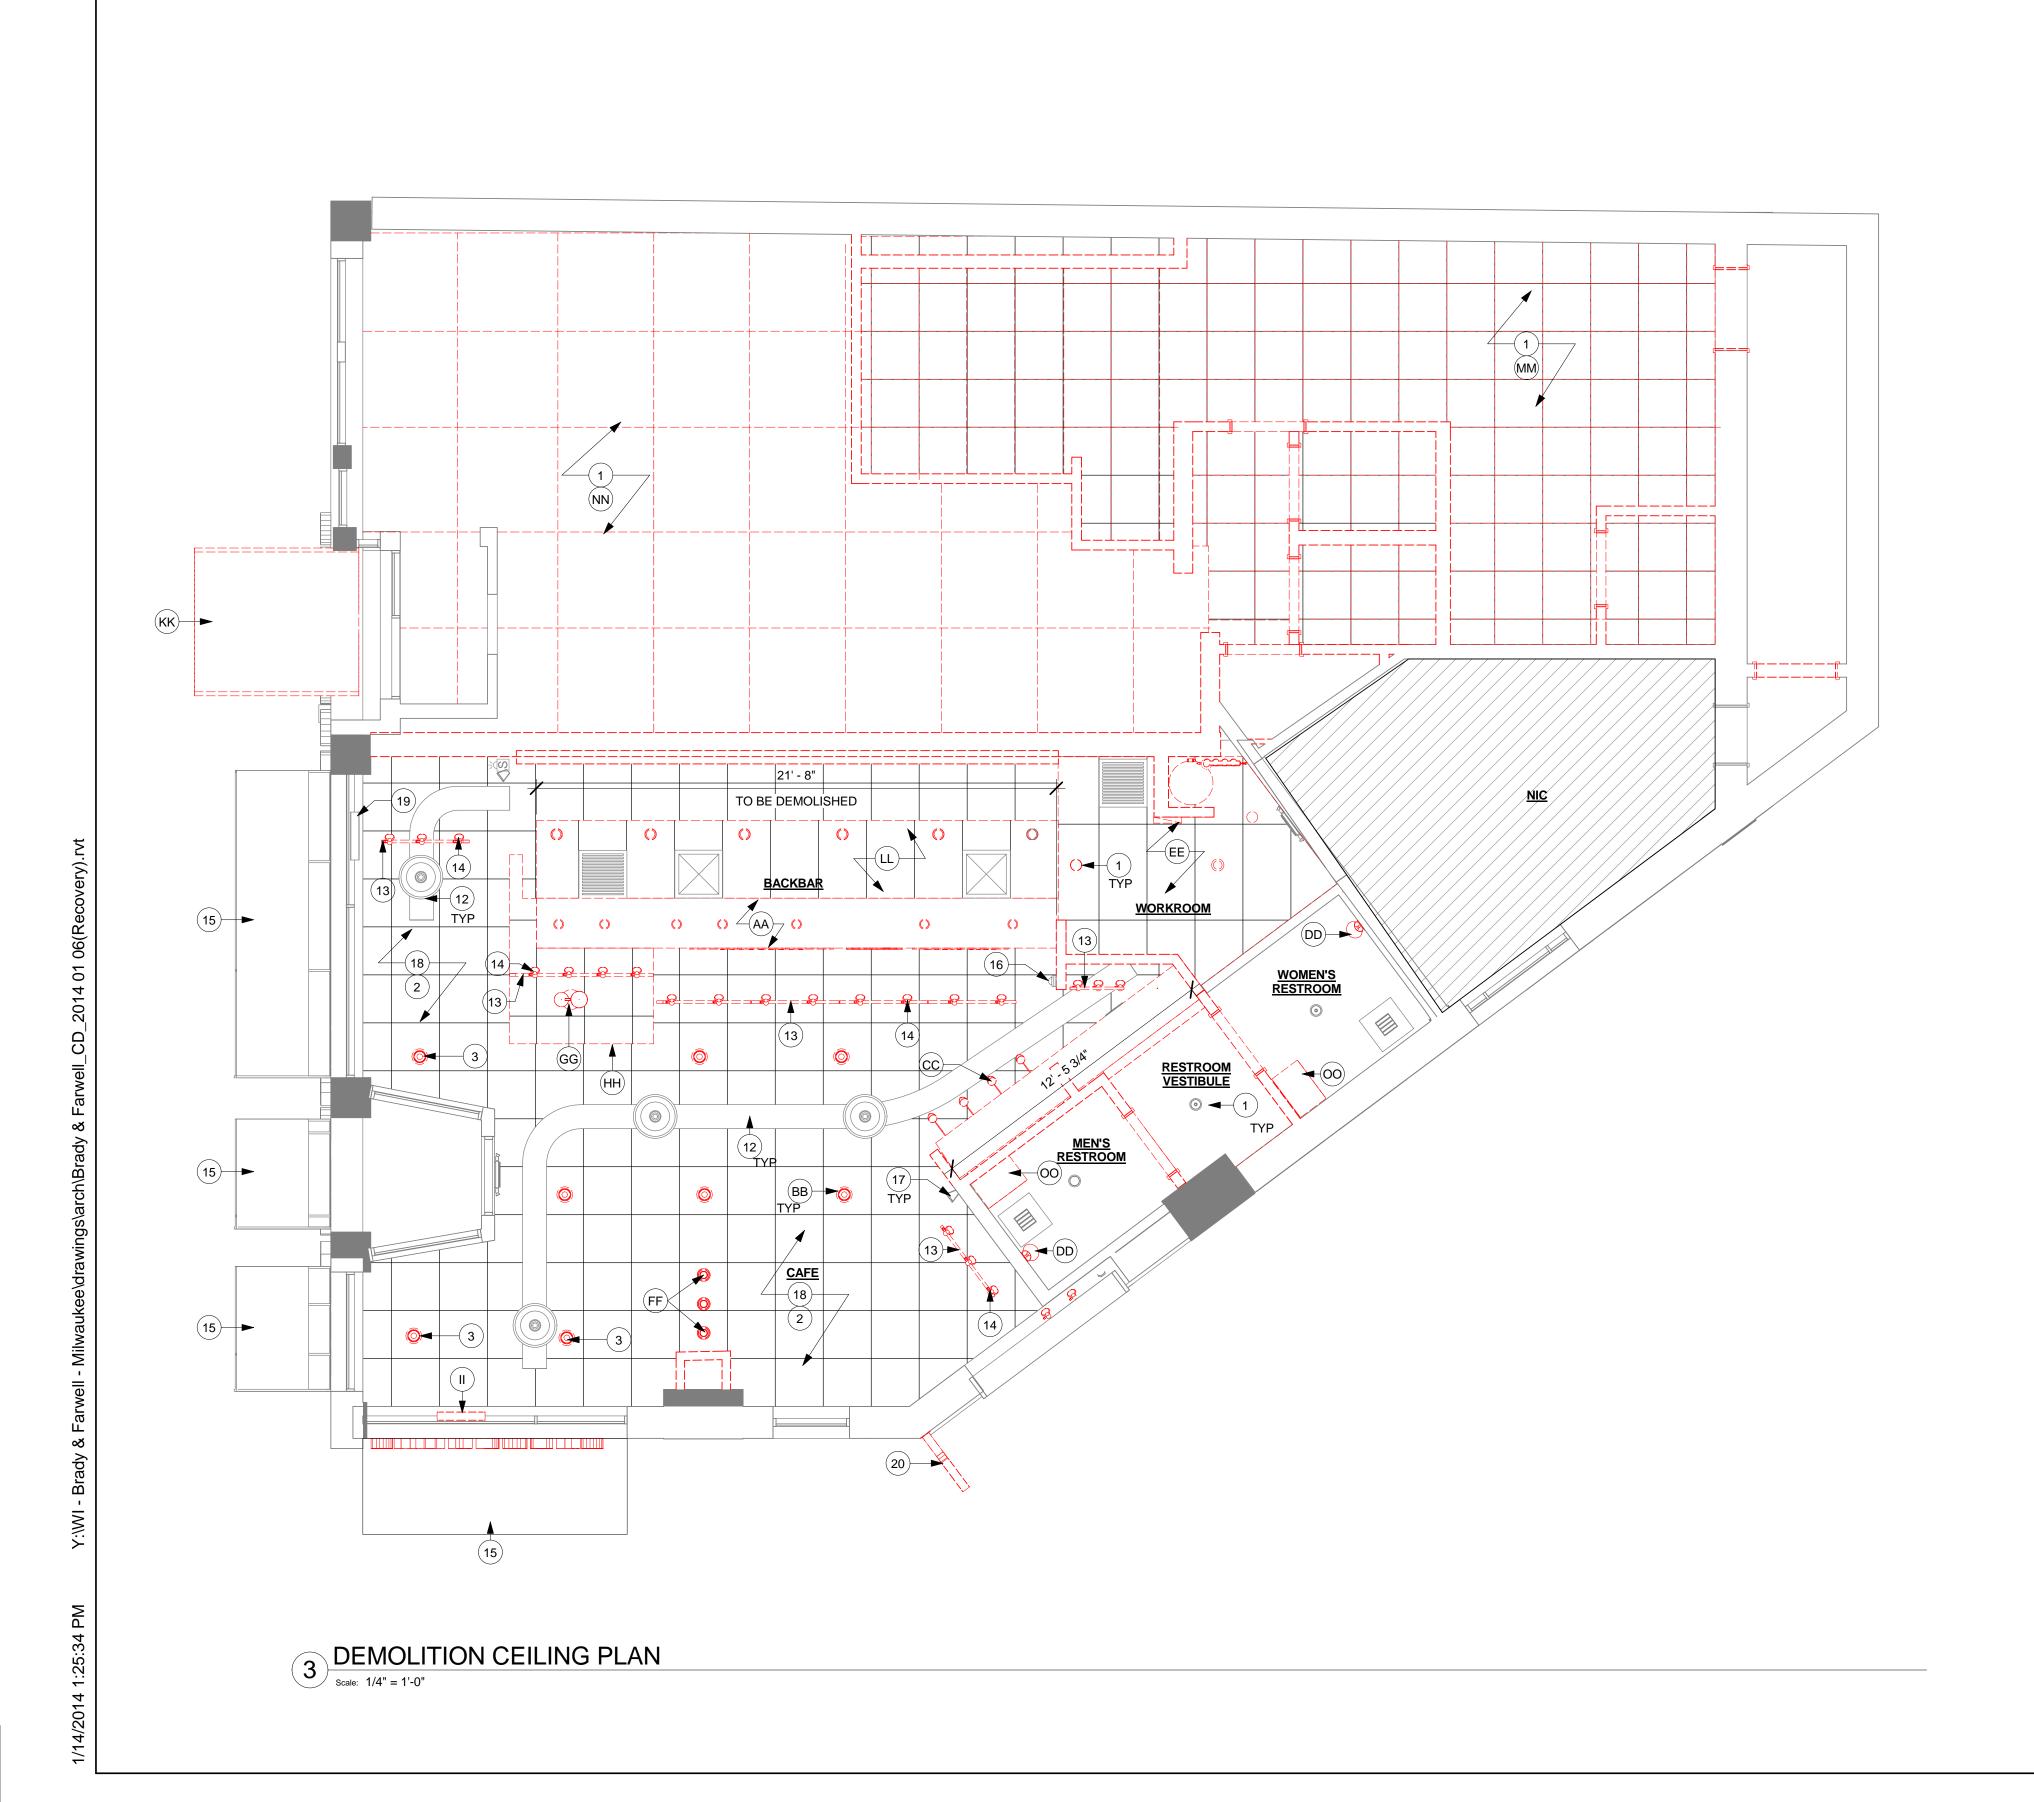

DEMOLITION RCP NOTES

A. IF DURING DEMOLITION CONDITIONS ARE REVEALED THAT MAY JEOPARDIZE INTEGRITY OF STRUCTURE OR PRECLUDE FOLLOWING DESIGN INTENT, GENERAL CONTRACTOR TO NOTIFY STARBUCKS CONSTRUCTION MANAGER IMMEDIATELY.

B. GENERAL CONTRACTOR RESPONSIBLE FOR SITE INVESTIGATION PRIOR TO DEMOLITION TO REVEAL FULL SCOPE OF WORK.

C. EXISTING WALLS TO REMAIN. PATCH AND REPAIR AS REQUIRED TO PROVIDE A SMOOTH, PAINT READY FINISH.

D. DEMOLISH EXISTING GYPSUM WALL BOARD, CEILING TILE, GRID AND/OR OTHER CEILING FINISH AS NECESSARY TO PROVIDE FOR NEW CEILING READY CONDITION.

E. DEMOLISH EXISTING WALL FINISHES AS NECESSARY.

F. REMOVE EXISTING LIGHT FIXTURES, AUXILIARY EQUIPMENT/FIXTURES AND POWER LINES AS NECESSARY.

G. REMOVE EXTRANEOUS EQUIPMENT AS NECESSARY.

ITEM TO PRESERVE:

1. DEMOLISH ALL FINISHED CEILINGS IN EXPANSION SPACE. PATCH AND REPAIR EXISTING GYPSUM BOARD FINISH ON UNDERSIDE OF DECK AS REQUIRED.

2. SALVAGE/MAINTAIN EXISTING DECORATIVE TIN, TILED CEILING AND MOULDING IN EXISTING SPACE IF APPLICABLE.

3. PENDANTS THAT ARE NOT REPLACED WITH NEW LIGHTING FIXTURE ARE TO BE PATCHED WITH COVER PLATE PAINTED TO MATCH CEILING TILE FINISH.

ITEM TO PRESERVE:


- 11. RECESSED CAN LIGHTS12. HVAC DUCTWORK, SUPPY & RETURN DROPS
- 13. TRACK MOUNTS
- 14. TRACK HEADS
- 15. EXTERIOR AWNINGS -- KEEP FRAMES, REPLACE CANVAS. 16. SECURITY CAMERA
- 17. INTERIOR SPEAKERS
- 18. SALVAGE/MAINTAIN EXISTING DECORATIVE, TILED CEILING
- 19. 24IN EXISTING SUSPENDED LOGO DISK REUSE HOUSING, REPLACE VINYL. 20. 18IN EXISTING BLADE SIGN. REUSE HOUSING, REPLACE VINYL LOGO.

ITEMS TO DEMOLISH:

- AA. GYP BD SOFFIT AT BACKBAR
- BB. CAN PENDANTS CC. GOOSENECK WALL SCONCE
- DD. RESTROOM SHELL SCONCE EE. ACT CEILING AT WORKROOM
- FF. DECORATIVE PENDANT
- GG. HANDOFF PENDANT AT BACKBAR HH. SUSPENDED SOFFIT AT HANDOFF PLANE II. NOT USED
- JJ. NOT USED
- KK. EXTERIOR AWNING AT EXPANSION SPACE
- LL. ACT CEILING AT BACKBAR MM. ACT AT EXPANSION SPACE
- NN. FAUX COFFERED CEILING AT EXPANSION SPACE OO. UPPER CUBBY AT RESTROOM

WALL LEGEND - DEMO RCP



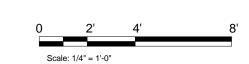





STARBUCKS COFFEE **COMPANY**

2401 UTAH AVENUE SOUTH SEATTLE, WASHINGTON 98134 (206) 318-1575

THESE DRAWINGS AND SPECIFICATIONS ARE CONFIDENTIAL AND SHALL REMAIN THE SOLE PROPERTY OF STARBUCKS CORPORATION, WHICH IS THE OWNER OF THE COPYRIGHT IN THIS WORK. THEY SHALL NOT BE REPRODUCED (IN WHOLE OR IN PART), SHARED WITH THIRD PARTIES OR USED IN ANY MANNER ON OTHER PROJECTS OR EXTENSIONS TO THIS PROJECT WITHOUT THE PRIOR WRITTEN CONSENT OF STARBUCKS CORPORATION. THESE DRAWINGS AND SPECIFICATIONS ARE INTENDED TO EXPRESS DESIGN INTENT FOR A PROTOTYPICAL STARBUCKS STORE (WHICH IS SUBJECT TO CHANGE AT ANYTIME) AND DO NOT REFLECT ACTUAL SITE CONDITIONS. NEITHER PARTY SHALL HAVE ANY OBLIGATION NOR LIABILITY TO THE OTHER (EXCEPT STATED ABOVE) UNTIL A WRITTEN AGREEMENT IS FULLY EXECUTED BY BOTH PARTIES.

ARCHITECT OF RECORD





Engineering Consultants Mechanical - Electrical - Plumbing

Revision Schedule Description

FARWELL

STORE #: 2305 PROJECT #: 04217-001 MCS CONCEPT: PALETTE: HERITAGE ISSUE DATE: 12 09 13 DESIGN MANAGER: S. RYCHLIK LEED $^{ extsf{R}}$ AP: N/A PRODUCTION DESIGNER: C. ALINOVICH CHECKED BY: K. GORIN

SHEET TITLE:

DEMOLITION CEILING

PLAN SCALE: 1/4" = 1'-0"

SHEET NUMBER:

	DOOR SCHEDULE - "D"						
DESIGN ID	DESIGN ID COUNT DESCRIPTION			COMMENTS			
DOOR							
10086	1	DOOR - SINGLE IMPACT DOUBLE ACTING - 36IN 915MM	GC	ELIASON DOOR WITH HARDWARE PACKAGE. DOOR FINISH - PL0012 - WEATHERED GREY WITH GRAIN. BRUSHED STANILESS STEEL KICKPLATE FINISH.			
13156	2	DOOR - SINGLE FLUSH - 900MM 35IN	GC				


DOOR LEGEND

DOOK LEGEND			
Construction:	Glazing:	Frame:	
SC = Solid Core HM = Hollow Metal AL = Aluminum Storefront WD = Wood Storefront E = Existing	T = Solid Core W = Hollow Metal Rating: NR = Non-Rated 1HR = 1 hour 2HR = 2 hour	AL = Aluminum Storefront HM1 =Hollow Metal Single Rabbet HM2 =Hollow Metal Double Rabbet HM3 =Hollow Metal Single Rabbet for CMU HM4 =Hollow Metal No Rabbet	
Miscellaneous: U = 1/2" undercut			

WALL BLOCKING KEY

Symbol	Item	Weight	Height	Approximate Width
A	Workroom Handsink	125LBS	3'-0" to 3'-4"	2'-6" Behind Sink
В	Shelves Above 3-Comp Sink	200LBS	5'-8" to 6'-0"	6'-0" Centered Above 3-Comp Sink
C	Shelves and Data Rack at Manager's Desk	300LBS	1/2" ACX Plywood	7'-0" Centered Above Manager's Desk and
D	Restroom Grab Bars	200LBS	2'-6" to 3'-0"	Data Rack 5'-0" Around WC
E	Restroom Hand Sink	200LBS	3'-0" to 3'-4"	2'-6" Behind Sink
F	Upper Storage (Cubby) Cabinets at Backbar	300LBS	6'-1" to 7'-10"	Extent of Backbar Upper Casework
G	Water Filter System	200LBS	4'-0" to 6'-6"	4'-0" Behind Left Side of 3-Comp Sink
Ĥ	Restroom Hand Dryer	200LBS	3'-0" to 4'-0"	2'-0" Starting 6" From Wall Corner
	Diaper Changing Station	250LBS	2'-4" to 4'-0"	See Plan and Restroom Details
J	Wood Wall Cladding	300LBS	4'-0" to 9'-0"	See Plan

Provide fire treated 2x6 or 2x8 wood stud blocking as required to support any wall attachments.

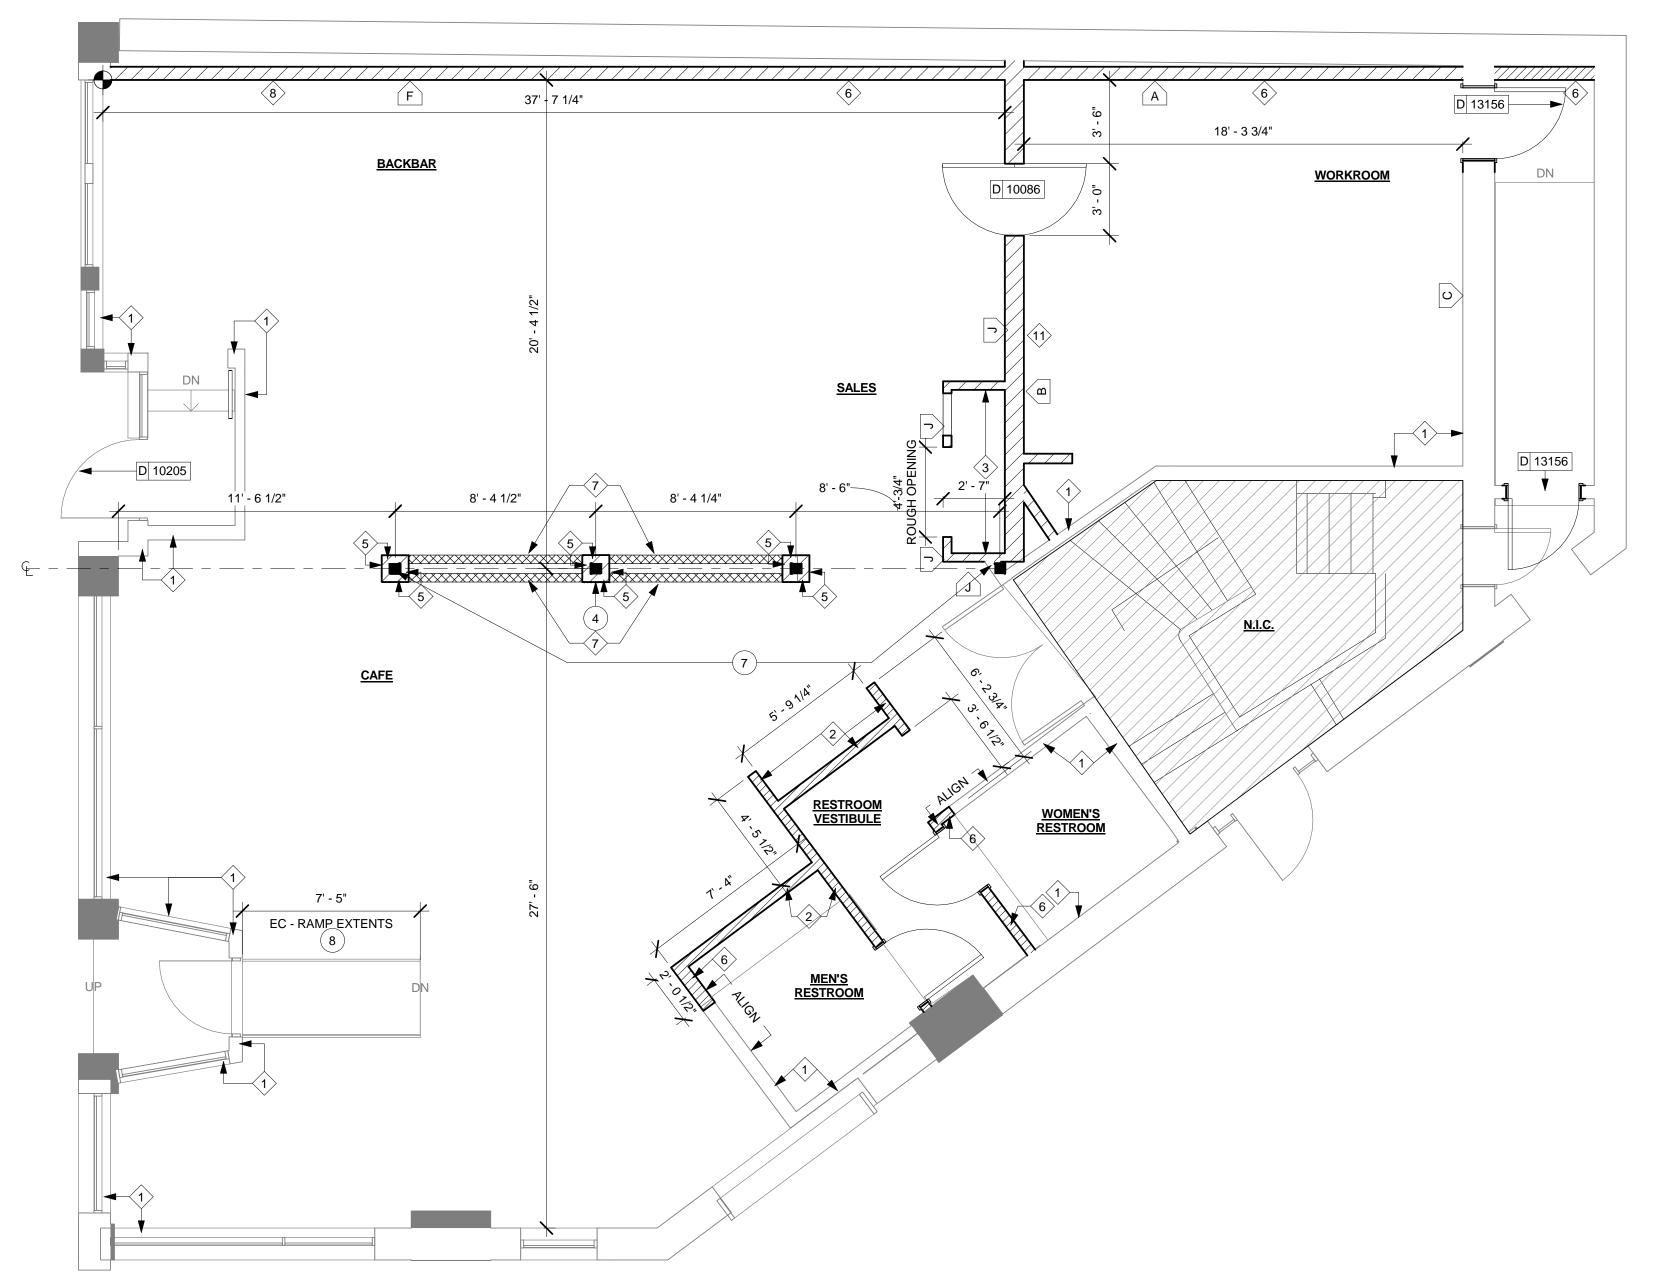

WALL TYPE LEGEND

1 Existing Wall

New Partition Wall to Structure 20 Ga 3-5/8" (86 mm) metal studs 16" (406mm) O.C. with 5/8" (16 mm) Type "X" GWB on both sides to structure above. Drywall screws @ 12" (305 mm) O.C. New Partition Wall to 6" (152mm) Above 20 Ga 3-5/8" (86 mm) metal studs 16" (406mm) O.C. with 5/8" (16 mm) Type "X" GWB on one or both sides to minimum of 6" (152 mm) above ceiling grid. Drywall screws

@ 12" (305 mm) O.C., 45 degrees. Metal stud reinforcement @ 48" (1219 mm) O.C. above ceiling line to structure above. Existing Wall A New Furred Wall to Structure

20 Ga 3-5/8" (86 mm) metal studs 16" (406 mm) O.C. with 5/8" (16 mm) Type "X" GWB to structure above. Drywall screws @ 12" (305 New Furred Wall to Structure

20 Ga 3-5/8" (86 mm) metal studs 16" (406 mm) O.C. with 5/8" (16 mm) Type "X" GWB to structure above. Drywall screws @ 12" (305

New Plumbing Wall to Structure

20 Ga 6" (152 mm) metal studs 16" (406 mm) O.C. with 5/8" (16 mm) moisture resistant gypsum board on both sides to structure above. Secure moisture resistant gypsum board to studs with drywall screws at 10" (254 mm) O.C. at panel edges and 12" (305 mm) O.C. at intermediate supports.

PARTIAL HEIGHT WALL - 3' - 9" 20 Ga 3-5/8" (86 mm) metal studs 16" (406 mm) O.C. with 5/8" (16 mm). Gyp finish not required

New Furred Plumbing Wall to 6" (152mm) Above Ceiling 20 Ga 6" (152 mm) metal studs 16" (406 mm) O.C. with 5/8" (16 mm) moisture resistant gypsum board to ceiling. Secure moisture resistant gypsum board to studs with drywall screws at 10" (254 mm) O.C. at panel edges and 12" (305 mm) O.C. at intermediate supports. 45 degree metal stud reinforcement @ 48" (1219 mm) O.C. above ceiling line to

structure above. 11 New Partition Wall to 6" (152mm) Above Ceiling (Moisture resistant gypsum board both sides) 20 Ga 3-5/8" (86 mm) metal studs 16" (406 mm) O.C. to 9'-0" (2743 mm) AFF with 5/8" (16 mm) moisture resistant gypsum board on both sides. Secure moisture resistant gypsum board to studs with drywall screws at 10" (254 mm) O.C. at panel edges and 12" (305 mm) O.C. at intermediate supports. 45 degrees

> metal stud reinforcement @ 48" (1219 mm O.C. above ceiling line to structure above.

FLOOR PLAN NOTES

A. GENERAL CONTRACTOR TO VERIFY ALL DIMENSIONS AND NOTIFY STARBUCKS CONSTRUCTION MANAGER OF ANY DISCREPANCIES PRIOR TO CONSTRUCTION. ALL DIMENSIONS TO BE TAKEN FROM DESIGNATED DATUM POINT.

B. IF EXISTING EXTERIOR ENTRANCE THRESHOLD EXCEEDS REQUIRED AMERICAN'S WITH DISABILITY ACT (ADA) MAXIMUM HEIGHT OF 1/2" (10MM), REMOVE AND REPLACE WITH ACCESSIBLE THRESHOLD. RAISED THRESHOLDS AND FLOOR LEVEL CHANGES AT ACCESSIBLE DOORWAYS TO BE BEVELED WITH A SLOPE NO GREATER THAN 1:12.

C. GENERAL CONTRACTOR TO PROVIDE FIRE TREATED WOOD STUD BLOCKING, OR EQUIVALENT TO SUPPORT ANY WALL ATTACHMENT AND/OR SIGNAGE.

D. ALL DOORS TO PROVIDE 3'-6" (900MM) MINIMUM CLEAR OPENING WHEN OPENED TO 90 DEGREE POSITION UNLESS OTHERWISE NOTED.

E. VERIFY ALL EXISTING DOORS, HARDWARE AND FRAMES MEET STARBUCKS AND/OR CODE REQUIREMENTS.

F. INSTALL 1/4" (6MM) GREEN BOARD ON BACKBAR WALL PER SPECIFICATION.

SHEET NOTES

FINISH P552-ES.

1. ALIGN FINISHED FACE OF WALL TO EXISTING FINISH.

2. REFER TO SHEETS I-5001 & I-5002 FOR CONSTRUCTION DETAIL.S

3. PROVIDE FIRE-TREATED WOOD BLOCKING AS REQUIRED TO SUPPORT ANY WALL ATTACHMENTS.

4. CONDUIT FOR ADJACENT TENANTS TO RUN UP COLUMN. PAINT COLUMN AND CONDUIT TO MATCH.

5. STRIP AND PAINT EXISTING DOOR FRAME. NEW VINYL WINDOW LOGO DISK.

6. STRIP AND STAIN EXISTING WOOD DOORS TO MATCH CHAIR RAIL - WD0001. PAINT DOOR FRAMES P534, BLACK FOX.

7. HSS5X5X5/16, TYPICAL PER STRUCTURAL ENGINEER SPECIFICATIONS. REFER TO STRUCTURAL PLAN SHEET S-1111 FOR MORE INFORMATION.

8. EXISTING RAMP TO REMAIN IN REFERENCE TO IBC, CHAPTER 34 EXISTING STRUCTURES, SECTION 3402. ALTERATION OF A BUILDING OR A FACILITY THAT HAS LITTLE LIKELIHOOD OF BEING ACCOMPLISHED BECAUSE THE EXISTING STRUCTURAL CONDITIONS REQUIRE THE REMOVAL OR ALTERATION OF A LOAD-BEARING MEMBER THAT IS AN ESSENTIAL PART OF THE STRUCTURAL FRAME, OR BECAUSE OTHER EXISTING PHYSICAL OR SITE CONSTRAINTS PROHIBIT MODIFICATION OR ADDITION OF ELEMENTS, SPACES, OR FEATURES WHICH ARE IN FULL AND STRUCT COMPLIANCE WITH THE MINIMUM REQUIREMENTS FOR NEW CONSTRUCTION AND WHICH ARE NECESSARY TO PROVIDE ACCESSIBILITY.



STARBUCKS COFFEE **COMPANY**

2401 UTAH AVENUE SOUTH SEATTLE, WASHINGTON 98134 (206) 318-1575

THESE DRAWINGS AND SPECIFICATIONS ARE CONFIDENTIAL AND SHAL REMAIN THE SOLE PROPERTY OF STARBUCKS CORPORATION, WHICH I REMAIN THE SOLE PROPERTY OF STARBUCKS CORPORATION, WHICH IS THE OWNER OF THE COPYRIGHT IN THIS WORK. THEY SHALL NOT BE REPRODUCED (IN WHOLE OR IN PART), SHARED WITH THIRD PARTIES OR USED IN ANY MANNER ON OTHER PROJECTS OR EXTENSIONS TO THIS PROJECT WITHOUT THE PRIOR WRITTEN CONSENT OF STARBUCKS CORPORATION. THESE DRAWINGS AND SPECIFICATIONS ARE INTENDED TO EXPRESS DESIGN INTENT FOR A PROTOTYPICAL STARBUCKS STORE (WHICH IS SUBJECT TO CHANGE AT ANYTIME) AND DO NOT REFLECT ACTUAL SITE CONDITIONS. NEITHER PARTY SHALL HAVE ANY OBLIGATION NOR LIABILITY TO THE OTHER (EXCEPT STATED ABOVE) UNTIL A WRITTEN AGREEMENT IS FULLY EXECUTED BY BOTH PARTIES. UNTIL A WRITTEN AGREEMENT IS FULLY EXECUTED BY BOTH PARTIES

ARCHITECT OF RECORD





Engineering Consultants Mechanical - Electrical - Plumbing

Revision Schedule Rev Date By Description

FARWELI

PROJECT NAM BRADY

2305 STORE #: PROJECT #: 04217-001 CONCEPT: MCS HERITAGE ISSUE DATE: 12 09 13 **DESIGN MANAGER:** S. RYCHLIK LEED $^{ extsf{R}}$ AP: N/A PRODUCTION DESIGNER: C. ALINOVICH CHECKED BY: K. GORIN


SCALE:

--NOTE-- THE SCHEDULED INTERCHANGEABLE CORE TO BE INSTALLED INTO ARM-A-DOOR (1) INTERCHANGEABLE CORE COMBINATED: FALCON C647A, 626 FINISH (VD, SEE NOTE #2

> SHEET TITLE: FLOOR PLAN


As indicated SHEET NUMBER:


DOOR TYPE & HARDWARE LEGEND

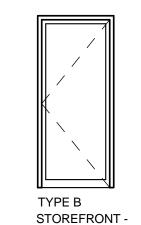



ALUMINUM SINGLE

DOOR HARDWARE

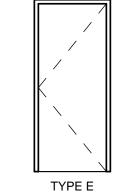

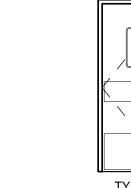

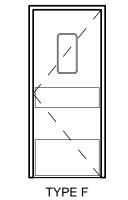

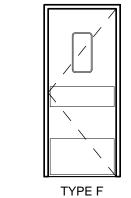

WORKROOM DOOR

SERVICE DOOR

SERVICE DOOR - INTERIOR SET #14

SERVICE DOOR - EXTERIOR

SET #12

INTERIOR/EXTERIOR

NO EXTERIOR EXPOSED HARDWARE IS ALLOWED

(1) DOOR CLOSURE: LCN 4041, ALUMINUM FINISH

(1) KICK PLATE 10X34: ROCKWOOD 10X34, 630 FINISH

(1) DOOR SWEEP 36": PEMKO 18062CP, MILL FINISH

(1) SMOKE GASKET 17': NGP 137NA17, MILL FINISH

(1) DOOR CLOSURE: LCN 4041, ÁLUMINUM FINISH

(1) KICK PLATE 10X34: ROCKWOOD 10X34, 630 FINISH (1) DOOR SWEEP 36": PEMKO 18062CP, MILL FINISH

(1) WEATHER STRIP 17': NGP 137NA17, MILL FINISH

(1) DOOR BELL: NU TONE MCN 304, WHITE/GOLD FINISH

NO EXTERIOR EXPOSED HARDWARE IS ALLOWED

(1) MORTISE CYLINDER: ADAMS RITE CAM, KSP 307-601, 26D FINISH

(3) DOOR HINGES 4.5 X 4.5 (NRP): STANLEY FBB191, US32D FINISH

(1) DOOR VIEWER: DOOR SPY DS-6, SILVER FINISH (VD, SEE NOTE #2)

(1) MORTISE CYLINDER: ADAMS RITE CAM, KSP 307-601, 26D FINISH

(3) DOOR HINGES 4.5 X 4.5 (NRP): STANLEY FBB191, US32D FINISH

(1) DOOR VIEWER: DOOR SPY DS-6, SILVER FINISH (VD, SEE NOTE #2)

--NOTE-- THE SCHEDULED INTERCHANGEABLE CORE TO BE INSTALLED INTO ARM-A-

(1) EXIT DEVICE: ARM-A-DOOR A101-002 W/ALARM, US28 FINISH (VD, SEE NOTE #2)

(1) EXIT DEVICE: ARM-A-DOOR A101-002 W/ALARM, US28 FINISH (VD, SEE NOTE #2)

(1) INTERCHANGEABLE CORE COMBINATED: FALCON C647A, 626 FINISH (VD, SEE NOTE

New Column

Existing Wall

AT BACKBAR

STOREFRONT - ALUMINUM SINGLE SET #3

(1) DOOR LOCK: ADAMS RITE MS1850S, DEADBOLT, 628 FINISH

(2) MORTISE CYLINDER: A/R CAM, KSP, 307-601,26D FINISH (2) INTERCHANGEABLE CORE: FALCON C647A, 626 FINISH (VD, SEE NOTE #2) (9) STORE KEYS: FALCON, (1) CONTROL KEY, (8) REGULAR, 7 PIN (VD, SEE NOTE #2) (2) DOOR PULL HANDLE: ROCKWOOD 108, US32D FINISH

RESTROOM - PRIVACY

(1) SIGN "THIS DOOR TO REMAIN UNLOCKED...": BBW 443, BLACK FINISH (2) DOOR CLOSURE: LCN 4041, ALUMINUM FINISH (2) DOOR STOP WITH HOOK: ROCKWOOD 473, 626 FINISH

(2) DOOR SWEEP 36": PEMKO 18062CP, MILL FINISH (1) WEATHER STRIP 20': NGP 137NA20, MILL FINISH (2) FLUSH BOLTS 12": ROCKWOOD 555X12, 26D FINISH

RESTROOM - PRIVACY

(1) CYLINDRICAL PRIVACY LATCHSET: FALCON T301 Q (FIC) 626 FINISH (3) DOOR HINGES 4.5 X 4.5 (NRP): STANLEY FBB179, US32D FINISH 1) DOOR CLOSURE: LCN 4041, ALUMINUM FINISH

(1) DOOR STOP WITH HOOK: ROCKWOOD 473, 626 FINISH (1) KICK PLATE 10X34: ROCKWOOD 10X34, 630 FINISH (1) RUBBER SILENCER: GLENN-JOHNSON 64

WORKROOM DOOR AT BACKBAR

(1) ELIASON DOOR PACKAGED WITH HARDWARE. (VD)

/////////////////// NEW FULL HEIGHT WALL NEW PARTIAL HEIGHT WALL ☐ EXISTING WALL EXISTING COLUMN NEW COLUMN

WALL LEGEND - FLOOR PLAN (1) DOOR BELL: NU TONE MCN 304, WHITE/GOLD FINISH



Scale: 1/4" = 1'-0"

PENETRATION PLAN NOTES

A. ALL STUB-UP DIMENSIONS ARE RELATIVE TO FINISHED WALL LOCATIONS (SHOWN AS OUTLINES ON THIS PLAN). REFER TO FLOOR PLAN FOR WALL PLACEMENT.

B. FLOOR SINK: REFER TO CUT SHEETS FOR COMPONENT SPECIFICATIONS AND CUTOUT REQUIREMENTS.

C. WASTE LINE PENETRATIONS: REFER TO PLUMBING PLANS FOR INDIVIDUAL LINE SPECIFICATIONS.

D. STUB-UP PENETRATIONS: REFER TO PLUMBING PLANS FOR INDIVIDUAL STUB-UP SPECIFICATIONS.

E. TOILET FLOOR PENETRATION: REFER TO CUT SHEETS FOR STUB-UP LOCATION RELATIVE TO FINISHED WALL.

F. PENETRATION TO BE LOCATED ON CENTERLINE OF WALL OR AS REQUIRED PER CONDITIONS.

G. TRENCHING OUTLINE FOR GUIDELINE USE ONLY. GENERAL CONTRACTOR TO COORDINATE WITH SPECIFIC TRADES AND SITE CONDITIONS TO DETERMINE ACTUAL LAYOUT.

SHEET NOTES

1. FLOOR SINK. SEE CUTSHEETS FOR COMPONENT SPECIFICATIONS AND CUTOUT REQUIREMENTS.

2. STUB-UP PENETRATIONS. SEE PLUMBING AND ELECTRICAL SHEETS FOR INDIVIDUAL STUB-UP SPECIFICATIONS.

3. ALL STUB-UP DIMENSIONS ARE RELATIVE TO FINISHED WALL LOCATIONS. REFER TO FLOOR PLAN FOR REPLACEMENT.

4. UTILIZE EXISTING FLOOR SINKS AND STUB-UPS WHERE POSSIBLE. GC TO VERIFY DURING PRE-CONSTRUCTINO MEETING WITH STARBUCKS PM.

5. GC TO SUPPLY AND RUN ELECTRICAL CONDUIT ALONG THE INSIDE OF COMMUNITY TABLE BASE. COLOR MATCH THE TABLE BASE. GC TO PRVIDE ELECTRICAL BOXES AT UNDERSIDE OF TABLE. FURNITURE VENDOR TO SEND WOOD COVER PLATES TO MATCH TABLE TOP.

6. GC TO SUPPLY AND RUN ELECTRICAL CONDUIT AT NEW BANQUETTES. ELECTRICAL CONDUIT TO BE CONCEALED. REFER TO DETAILS FOR MORE INFORMATION.

7. GC TO SUPPLY AND RUN ELECTRICAL CONDUIT ALONG THE INSIDE OF SIT-HERE COUNTER. COLOR MATCH THE TABLE BASE. GC TO PRVIDE ELECTRICAL BOXES AT UNDERSIDE OF TABLE. FURNITURE VENDOR TO SEND WOOD COVER PLATES TO MATCH TABLE TOP.

8. OUTLINE OF WINDOW BANQUETTE.

9. OUTLINE OF COMMUNITY TABLE.

10. OUTLINE OF BANQUETTE SETTEE 11. OUTLINE OF SIT-HERE COUNTER.

12. GC TO VERIFY CONDITION OF SUBFLOOR IN EXISTING SPACE. VERIFY CONDITION IS ADEQUATE AND FINISH-READY. CONFIRM IF STRUCTURE WORK IS REQUIRED.

13. GC TO FILL AND SEAL ALL EXISTING PENETRATIONS TO BE ABANDONED TO BE FINISH-READY CONDITION.



STARBUCKS COFFEE **COMPANY**

©2011 STARBUCKS COFFEE COMPANY

2401 UTAH AVENUE SOUTH SEATTLE, WASHINGTON 98134 (206) 318-1575

THESE DRAWINGS AND SPECIFICATIONS ARE CONFIDENTIAL AND SHALL REMAIN THE SOLE PROPERTY OF STARBUCKS CORPORATION, WHICH IS THE OWNER OF THE COPYRIGHT IN THIS WORK. THEY SHALL NOT BE REPRODUCED (IN WHOLE OR IN PART), SHARED WITH THIRD PARTIES OR USED IN ANY MANNER ON OTHER PROJECTS OR EXTENSIONS TO THIS PROJECT WITHOUT THE PRIOR WRITTEN CONSENT OF STARBUCKS CORPORATION. THESE DRAWINGS AND SPECIFICATIONS ARE INTENDED TO EXPRESS DESIGN INTENT FOR A PROTOTYPICAL STARBUCKS STORE (WHICH IS SUBJECT TO CHANGE AT ANYTIME) AND DO NOT REFLECT ACTUAL SITE CONDITIONS. NEITHER PARTY SHALL HAVE ANY OBLIGATION NOR LIABILITY TO THE OTHER (EXCEPT STATED ABOVE) UNTIL A WRITTEN AGREEMENT IS FULLY EXECUTED BY BOTH PARTIES.

ARCHITECT OF RECORD





Engineering Consultants Mechanical - Electrical - Plumbing

Revision Schedule Description

STORE #: 2305 PROJECT #: 04217-001 MCS CONCEPT: PALETTE: HERITAGE ISSUE DATE: 12 09 13 DESIGN MANAGER: S. RYCHLIK LEED $^{ extsf{R}}$ AP: PRODUCTION DESIGNER: C. ALINOVICH

SHEET TITLE:

CHECKED BY:

PENETRATION PLAN

K. GORIN

1/4" = 1'-0"

SCALE:

SHEET NUMBER:

I-1113


PENETRATION PLAN LEGEND



FLOOR SINK FLOOR PENETRATION


PLUMBING PENETRATION AREA

ELECTRICAL PENETRATION AREA

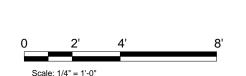


PENETRATION PLAN Scale: 1/4" = 1'-0"

PLUMBING FIXTURE SCHEDULE - "P"								
DESIGN ID COUNT DESCRIPTION RESP. COMMENTS								
			•					
X0001	X0001 1 GREASE TRAP		GC	REFER TO PLUMBING SHEETS FOR SPECIFICATIONS				
DRAIN								
10294	5	DRAIN - FLOOR SINK SQUARE - 12IN 305MM	GC	REFER TO PLUMBING SHEETS FOR SPECIFICATIONS				
10309	5	DRAIN - FLOOR SINK WITH HALF GRATE SQUARE - 12IN 305MM	GC	REFER TO PLUMBING SHEETS FOR SPECIFICATIONS				
FAUCET			•					
10152	1	FAUCET - DOUBLE LABORATORY WITH BENT RISER SPOUT	WH					
10153	1	FAUCET - WATER TOWER - 12IN 305MM	WH					
10215	2	FAUCET - DOUBLE LABORATORY WITH SWING SPOUT	WH					
10447	1	FAUCET - PRE RINSE SPRAYER WALL MOUNTED	WH					
10597	1	FAUCET - SINGLE HANDLE	WH					
10804	1	FAUCET - PRE RINSE SWING SPOUT	WH					
10874	1	FAUCET - HOT WATER DISPENSER GOOSENECK	WH					
10922	1	FAUCET - MOP SINK WALL MOUNTED	WH					
10943	1	FAUCET - SINGLE LABORATORY WITH SWING SPOUT	WH					
11003	1	FAUCET - DIPPERWELL	WH					
FILTER								
12896	1	FILTER - BRINE TANK	WH					
12899	2	FILTER - POLY GLASS VESSEL	WH					
13076	1	FILTER - PREFILTRATION SYSTEM	WH					
13080	1	FILTER - HEAD QUAD	WH					
13081	4	FILTER - CARBON FILTER CARTRIDGE	WH					
13082	1	FILTER - WATER SOFTENER TWIN	WH					
13149	1	FILTER - PRESSURE GAUGE	WH					
SINK								
10505	1	SINK - RINSE DROP IN - 27X20IN 685X510MM	WH					
10549	1	SINK - RINSE DROP IN SST - 12X20IN 305X510MM	WH					
10995	1	SINK - MOP - 24X24IN 610X610MM	WH					
12808	1	SINK - UTENSIL RINSE WITH GRATE SST - RH - 14X20IN 355X510MM	WH					
13264	1	SINK - 3 COMP WORK SST - 93IN 2350MM	WH					

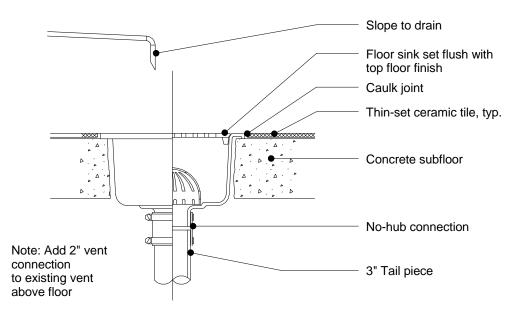


FLOOR DRAIN SECTION

Scale: 1 1/2" = 1'-0"

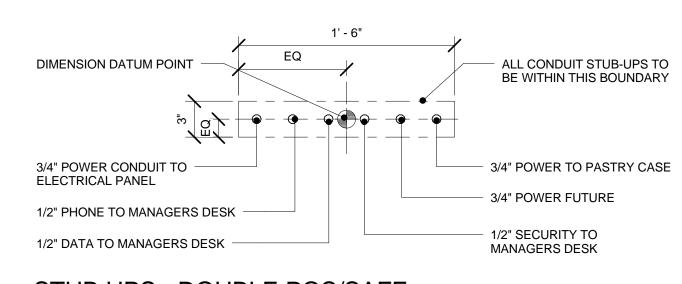




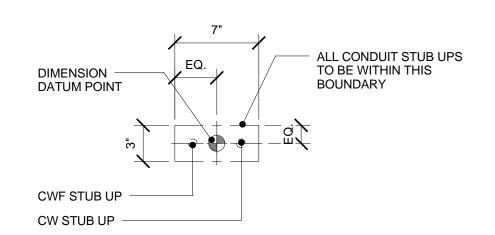

3 STUB UPS - ESPRESSO

Scale: 1 1/2" = 1'-0"

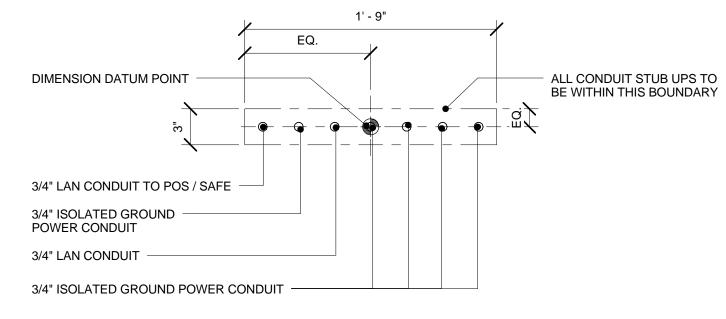

STUB UPS - FRONTBAR

Scale: 1 1/2" = 1'-0"



STARBUCKS COFFEE COMPANY 2401 UTAH AVENUE SOUTH SEATTLE, WASHINGTON 98134

(206) 318-1575 THESE DRAWINGS AND SPECIFICATIONS ARE CONFIDENTIAL AND SHALL REMAIN THE SOLE PROPERTY OF STARBUCKS CORPORATION, WHICH IS THE OWNER OF THE COPYRIGHT IN THIS WORK. THEY SHALL NOT BE REPRODUCED (IN WHOLE OR IN PART), SHARED WITH THIRD PARTIES OR USED IN ANY MANNER ON OTHER PROJECTS OR EXTENSIONS TO THIS PROJECT WITHOUT THE PRIOR WRITTEN CONSENT OF STARBUCKS CORPORATION. THESE DRAWINGS AND SPECIFICATIONS ARE INTENDED TO EXPRESS DESIGN INTENT FOR A PROTOTYPICAL STARBUCKS STORE (WHICH IS SUBJECT TO CHANGE AT ANYTIME) AND DO NOT REFLECT ACTUAL SITE CONDITIONS. NEITHER PARTY SHALL HAVE ANY OBLIGATION NOR LIABILITY TO THE OTHER (EXCEPT STATED ABOVE) UNTIL A WRITTEN AGREEMENT IS FULLY EXECUTED BY BOTH PARTIES.

ARCHITECT OF RECORD





		Revisi	on Schedule
Rev	Date	Ву	Description


STORE #: 2305 PROJECT #: 04217-001 MCS CONCEPT: PALETTE: HERITAGE ISSUE DATE: 12 09 13 DESIGN MANAGER: S. RYCHLIK LEED® AP: PRODUCTION DESIGNER: C. ALINOVICH CHECKED BY:

SHEET TITLE:

PENETRATION PLAN SCHEDULE & DETAILS 1 1/2" = 1'-0"

SHEET NUMBER:

I-1113.1

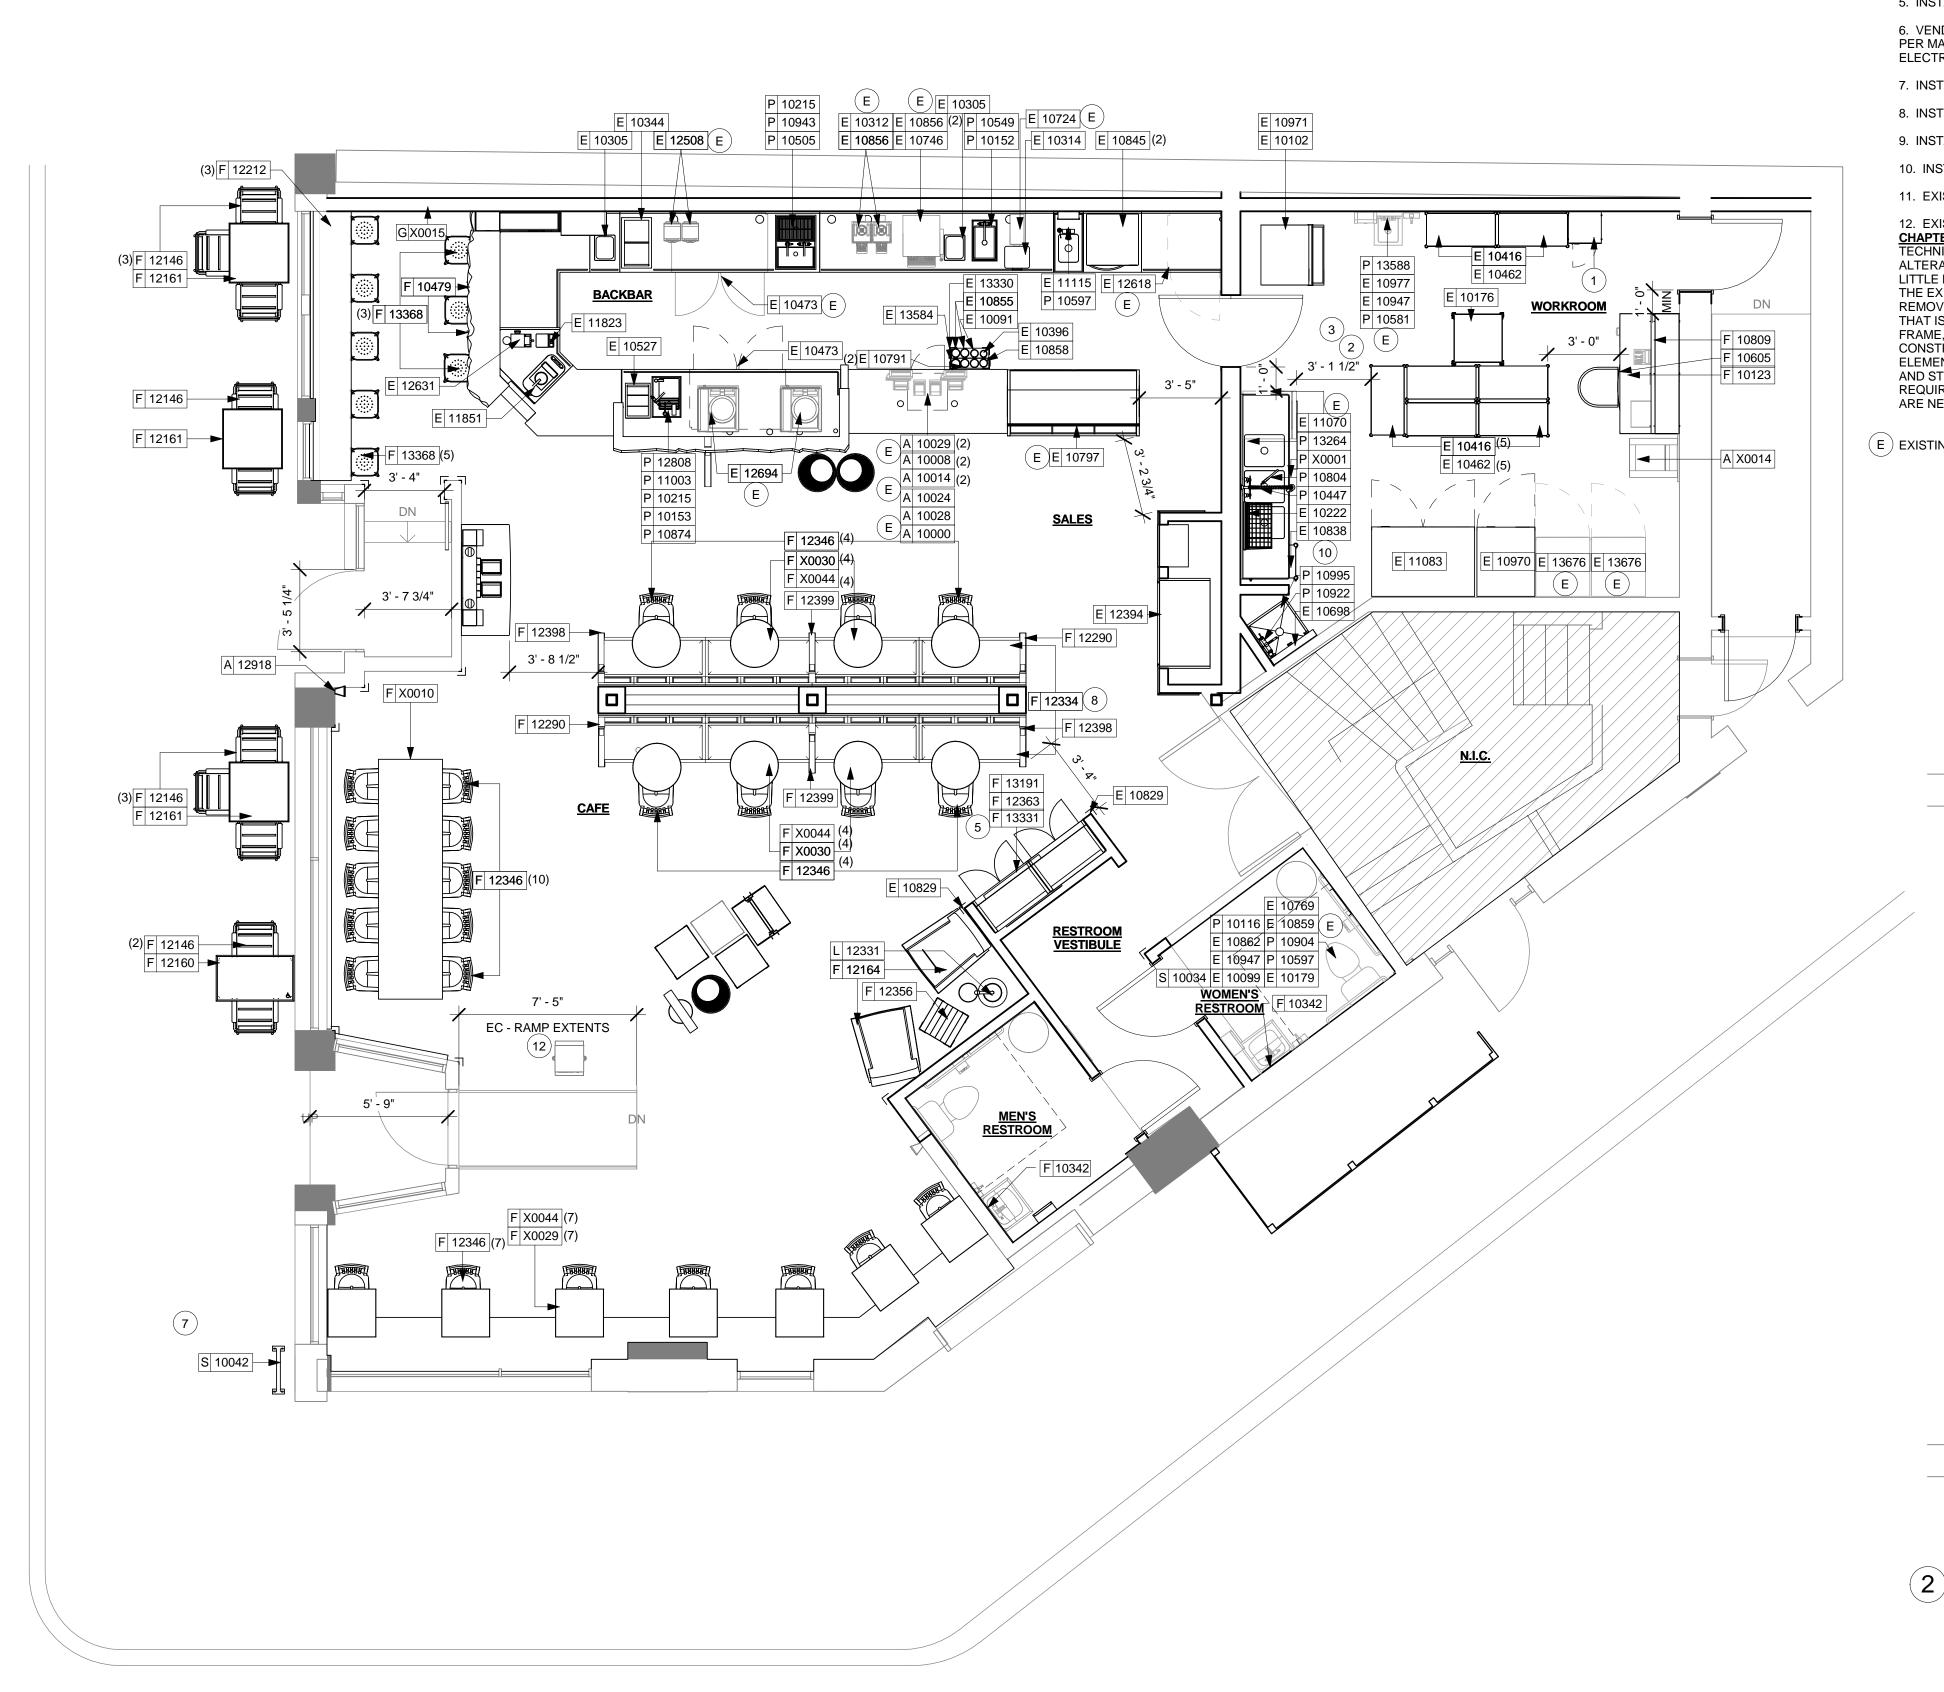

1ST FLOOR - FURNITURE, FIXTURES, AND EQUIPMENT PLAN

Scale: 1/4" = 1'-0"

SHEET NOTES

1. SECURE LOCKERS TO WALL.

2. PLACE FIRE EXTINGUISHER IN WORKROOM PER FIRE INSPECTOR.

3. NEW LOCATION OF ALL SWITCHING.

4. SPEAKERS TO BE MOUNTED AT MAXIMUM HEIGHT PER CUTSHEET.

5. INSTALL NEW MERCH BAYS AS INDICATED.

6. VENDOR TO INSTALL WATER SYSTEM IN BASEMENT PER MANUFACTURER'S INSTRUCTIONS. GC TO PROVIDE ELECTRICAL AND PLUMBING REQUIREMENTS.

- INSTALL NEW BIKE RACK AS INDICATED.
- 8. INSTALL BANQUETTE SETEE AS INDICATED.
- 9. INSTALL NEW WATER FILTRATION IN BASEMENT
- 10. INSTALL NEW MOP SINK.
- 11. EXISTING WATER HEATER TO REMAIN.

12. EXISTING RAMP TO REMAIN IN REFERENCE TO IBC, CHAPTER 34 EXISTING STRUCTURES, SECTION 3402. ALTERATION OF A BUILDING OR A FACILITY THAT HAS LITTLE LIKELIHOOD OF BEING ACCOMPLISHED BECAUSE THE EXISTING STRUCTURAL CONDITIONS REQUIRE THE REMOVAL OR ALTERATION OF A LOAD-BEARING MEMBER THAT IS AN ESSENTIAL PART OF THE STRUCTURAL FRAME, OR BECAUSE OTHER EXISTING PHYSICAL OR SITE CONSTRAINTS PROHIBIT MODIFICATION OR ADDITION OF ELEMENTS, SPACES, OR FEATURES WHICH ARE IN FULL AND STRUCT COMPLIANCE WITH THE MINIMUM REQUIREMENTS FOR NEW CONSTRUCTION AND WHICH ARE NECESSARY TO PROVIDE ACCESSIBILITY.

(E) EXISTING ITEM TO BE RELOCATED.

FF AND E PLAN NOTES

A. GENERAL CONTRACTOR TO SCHEDULE WITH LOCAL REFRIGERATION CONTRACTOR TO CONDUCT INITIAL FOOD CASE START-UP AND TESTING. FOR APPROVED CONTRACTOR, CONTACT VENDOR.

B. THE SPACE IS SERVED BY THE MUNICIPAL WATER AND SEWER SYSTEM UNLESS OTHERWISE NOTED.

C. ALL EQUIPMENT AND INSTALLATION WILL MEET NATIONAL SANITATION FOUNDATION STANDARDS OR EQUIVALENT.

D. EQUIPMENT UNITS SHALL CONTAIN NO EXPOSED THREADS, EMBELLISHMENTS OR OVERHANGING EDGES THAT SERVE AS PLACES FOR ACCUMULATION OF DUST, DIRT AND

E. WARMING OVEN(S) SHOWN FOR PERMITTING PURPOSES. INSTALLATION AT STORE OPENING TO BE VERIFIED BY STARBUCKS CONSTRUCTION REPRESENTATIVE.

F. EACH HAND WASHING SINK WILL HAVE A SINGLE SERVICE TOWEL AND SOAP DISPENSER, AND ALL HAND SINKS TO HAVE A COMBINATION FAUCET OR PREMIXING FAUCET.

G. FOR PLUMBING FIXTURES, REFER TO THE PLUMBING DESIGN PLAN. FOR DATA DEVICE SCHEDULE, REFER TO THE ELECTRICAL DESIGN PLAN

H. SEE SHEET I-601 FOR SCHEDULES.



STARBUCKS COFFEE COMPANY

2401 UTAH AVENUE SOUTH SEATTLE, WASHINGTON 98134 (206) 318-1575

THESE DRAWINGS AND SPECIFICATIONS ARE CONFIDENTIAL AND SHALL REMAIN THE SOLE PROPERTY OF STARBUCKS CORPORATION, WHICH IS THE OWNER OF THE COPYRIGHT IN THIS WORK. THEY SHALL NOT BE REPRODUCED (IN WHOLE OR IN PART), SHARED WITH THIRD PARTIES OR USED IN ANY MANNER ON OTHER PROJECTS OR EXTENSIONS TO THIS PROJECT WITHOUT THE PRIOR WRITTEN CONSENT OF STARBUCKS CORPORATION. THESE DRAWINGS AND SPECIFICATIONS ARE INTENDED TO EXPRESS DESIGN INTENT FOR A PROTOTYPICAL STARBUCKS STORE (WHICH IS SUBJECT TO CHANGE AT ANYTIME) AND DO NOT REFLECT ACTUAL SITE CONDITIONS. NEITHER PARTY SHALL HAVE ANY OBLIGATION NOR LIABILITY TO THE OTHER (EXCEPT STATED ABOVE) UNTIL A WRITTEN AGREEMENT IS FULLY EXECUTED BY BOTH PARTIES.

ARCHITECT OF RECORD



ENGINEER OF RECORD

St. Louis, Missouri 63119 Phone (314) 772-1782 Fax (314) 373-3514 Engineering Consultants Mechanical - Electrical - Plumbing

Revision Schedule

STORE #: 2305 PROJECT #: 04217-001 CONCEPT: MCS PALETTE: HERITAGE ISSUE DATE: 12 09 13 DESIGN MANAGER: S. RYCHLIK LEED® AP: PRODUCTION DESIGNER: C. ALINOVICH

SHEET TITLE: FF AND E PLAN

1/4" = 1'-0"

SCALE: SHEET NUMBER:

CHECKED BY:

I-1114

EXISTING WATER HEATER

BASEMENT - FURNITURE, FIXTURE, AND EQUIPMENT PLAN

| Scale: 1/4" = 1'-0"

LOCATION OF CONDUIT/ELECTRIC PANELS

(4) P 13081 P 13149

DATA DEVICE SCHEDULE - "A"						
DESIGN ID	COUNT	DESCRIPTION	RESP.	COMMENTS		
X0014	1	EQUIPMENT RACK - 39IN	VD	CUSTOM SHORT EQUIPEMENT RACK - SUPPLIER: CHATSWORTH PRODUCTS #15322 HEAVY-DUTY WALL-MOUNTED		
				EQUIPMENT RACK OPTION 2 - 23IN WIDE BY 38.5IN HIGH COLOR: GRAY WEBSITE: WWW.CHATSWORTH.COM		
DATA						
10007	1	PRINTER MANAGER WORKSTATION	WH			

		FURNITURE SCHEDULE	- "F"	
DESIGN ID	COUNT	DESCRIPTION	RESP.	COMMENTS
BANQUETTE				
12290	2	BANQUETTE - SETTEE ARM RH - DISTRESSED DARK WARM BROWN WD0001	WH	
12334	8	BANQUETTE - SETTEE - 54IN 1370MM - BRICK RED NATURAL F0017	WH	
12398	2	BANQUETTE - SETTEE ARM LH - DISTRESSED DARK WARM BROWN WD0001	WH	
12399	3	BANQUETTE - SETTEE ARM CENTER - DISTRESSED DARK WARM BROWN WD0001	WH	
CAFE				
12363	2	MERCH BAY UNIT BACK PANEL SOLID	WH	NOT PROVIDED BY CASEWORK VENDOR
12367	2	MERCH FEATURE CUBE FREESTANDING TALL	VD	NOT PROVIDED BY CASEWORK VENDOR
13191	1	MERCH BAY UNIT END PANELS METAL MESH	WH	NOT PROVIDED BY CASEWORK VENDOR
13331	2	MERCH BAY UNIT	WH	NOT PROVIDED BY CASEWORK VENDOR
CHAIR				
12146	10	CHAIR - CAFE SLATTED METAL SUITE WITH ARMS - BLACK MT0028	WH	
12164	2	CHAIR - LOUNGE CLUB - CARAMEL BROWN NATURAL F0008	WH	
12346	25	CHAIR - CAFE SCHOOLHOUSE - DISTRESSED DARK WARM BROWN WD0001	WH	
13368	8	CHAIR - STOOL 29IN 735MM INDUSTRIAL - DISTRESSED DARK BROWN PRESSBOARD WD0012	WH	
DESK			•	
10123	1	DESK - MANAGERS WORKSTATION - 60X30X30IN 1525X760X760MM - ALMOND LAMINATE	WH	
10605	1	DESK - MANAGERS WORKSTATION KEYBOARD TRAY - BLACK PLASTIC	WH	
10809	1	DESK - MANAGERS WORKSTATION SHELVES WALL MOUNTED - ALMOND LAMINATE	WH	
MIRROR				
10342	2	MIRROR - RESTROOM - 18X36IN 455X915MM	WH	
OTHER				
10479	2	COAT HOOK 2 PRONG	WH	
10820	1	COAT HOOK STRIP - 46IN 1170MM	WH	
TABLE	1	TABLE ACCEPCIBLE METAL CHITE 20V22IN	14/11	
12160		TABLE - ACCESSIBLE METAL SUITE - 39X23IN 990X585MM - BLACK MT0028	WH	
12161	3	TABLE - CAFE METAL SUITE SQUARE - 30IN 760MM - BLACK MT0028	WH	
12212	3	TABLE - BASE BAR HEIGHT DOME ACCENT - 18X42IN 455X1065MM - HOT ROLLED STEEL MT0011	WH	
12356	1	TABLE - OCCASIONAL WOOD PLANK SQUARE - DISTRESSED HONEY BROWN WD0002	WH	
X0010	1	TABLE - ACCESSIBLE	VD	SEE CASEWORK DETAIL SHEET FOR CLARIFICATIONSTAIN WOOD TO MATCH WD0001.
X0029	7	TABLE - TOP SQUARE - 24IN 610MM - AMBER HONEY WD0005	VD	1" SOLID WOOD TOP STAINED TO MATCH WD0002. PROVIDED BY CHARLIE SANSONE. CJSSANSONE@ATT.NET. T: 847.204.6106
X0030	8	TABLE - TOP ROUND - 24IN 610MM - AMBER HONEY WD0005	VD	1" SOLID WOOD TOP STAINED TO MATCH WD0002. PROVIDED BY CHARLIE SANSONE. CJSSANSONE@ATT.NET. T: 847.204.6106
X0044	15	TABLE - BASE CAFE ORNATE - FLAT BLACK POWDERCOAT MT0028	VD	METAL BASES BY CHARLIE SANSON. CJSSANSONE@ATT.NET. T: 847.204.6106.

DESIGN ID	COUNT	DESCRIPTION	RESP.	COMMENTS
X0001	1	GREASE TRAP	GC	REFER TO PLUMBING SHEETS FOR SPECIFICATIONS
DRAIN			<u>'</u>	
10294	5	DRAIN - FLOOR SINK SQUARE - 12IN 305MM	GC	REFER TO PLUMBING SHEETS FOR SPECIFICATIONS
10309	5	DRAIN - FLOOR SINK WITH HALF GRATE SQUARE - 12IN 305MM	GC	REFER TO PLUMBING SHEETS FOR SPECIFICATIONS
FAUCET			•	
10152	1	FAUCET - DOUBLE LABORATORY WITH BENT RISER SPOUT	WH	
10153	1	FAUCET - WATER TOWER - 12IN 305MM	WH	
10215	2	FAUCET - DOUBLE LABORATORY WITH SWING SPOUT	WH	
10447	1	FAUCET - PRE RINSE SPRAYER WALL MOUNTED	WH	
10597	1	FAUCET - SINGLE HANDLE	WH	
10804	1	FAUCET - PRE RINSE SWING SPOUT	WH	
10874	1	FAUCET - HOT WATER DISPENSER GOOSENECK	WH	
10922	1	FAUCET - MOP SINK WALL MOUNTED	WH	
10943	1	FAUCET - SINGLE LABORATORY WITH SWING SPOUT	WH	
11003	1	FAUCET - DIPPERWELL	WH	
FILTER		•	•	
12896	1	FILTER - BRINE TANK	WH	
12899	2	FILTER - POLY GLASS VESSEL	WH	
13076	1	FILTER - PREFILTRATION SYSTEM	WH	
13080	1	FILTER - HEAD QUAD	WH	
13081	4	FILTER - CARBON FILTER CARTRIDGE	WH	
13082	1	FILTER - WATER SOFTENER TWIN	WH	
13149	1	FILTER - PRESSURE GAUGE	WH	
SINK				
10505	1	SINK - RINSE DROP IN - 27X20IN 685X510MM	WH	
10549	1	SINK - RINSE DROP IN SST - 12X20IN 305X510MM	WH	
10995	1	SINK - MOP - 24X24IN 610X610MM	WH	
12808	1	SINK - UTENSIL RINSE WITH GRATE SST - RH - 14X20IN 355X510MM	WH	
13264	1	SINK - 3 COMP WORK SST - 93IN 2350MM	WH	

		GRAPHICS SCHEDULE -	· "G"	
DESIGN ID	COUNT	DESCRIPTION	RESP.	COMMENTS
GRAPHICS -	INTERIOR	MENU		·
12837	5	MENU BOARD - 1 FRONT PANEL INSERT STYLE	WH	
12838	3	MENU BOARD - DAILY OFFERING CHALKBOARD FRONT PANEL RECTANGULAR	WH	
12839	8	MENU BOARD - UNIVERSAL MOUNTING HARDWARE FOR FRONT PANELS	WH	
X0015	1	CAFE ART AT RESERVE	VD	PROVIDED BY GFX. CAFE COFFEE CHALK ART - NS0702, COFFEE ANATOMY. CHALKBOARD ART WITH FRAME STAINED TO MATCH CHAIR RAIL. OVERALL DIMENSIONS: 4'-1" x 3'-7". SEE INTERIOR ELEVATIONS FO MORE INFORMATION.
X0023	1	COMMUNITY BOARD	VD	PROVIDED BY GFX. CONTACT: MARY SANSONE. SEE INTERIOR ELEVATIONS FOR CLARIFICATION. OVERALL DIMENSIONS: 3' 10" x 2' 9".
X0024	1	ARTWORK AT SOFT SEATS	VD	PROVIDED BY GFX. CONTACT: MARY SANSONE. SEE INTERIOR ELEVATIONS FOR CLARIFICATION. OVERALL DIMENSIONS: 3' 10" x 2' 9".
GRAPHICS -	- OTHER			
10753	1	RESTROOM SIGN SET ACCESSIBLE	WH	
X0041	2	EVOLVED LOGO DISK VINYL DECAL	VD	PROVIDED BY GFX. CONTACT: MARY SANSONE. SEE INTERIOR ELEVATIONS FOR CLARIFICATION. VINYL EVOLVED WINDOW DISK TO ADHERE TO FIRE RATED DOUBLE DOORS TO COMMON HALLWAY. SEE INTERIOR ELEVATIONS FOR MORE INFORMATION/DIMENSIONS.

		SPECIALTY EQUIPMENT SCHE		
DESIGN ID	COUNT	DESCRIPTION	RESP.	COMMENTS
COOLING		T	I	T
10473	1	FRIDGE UNDERCOUNTER 2 DOOR - 48IN 1220MM	WH	ENERGY STAR COMPLIANT
10970	1	FRIDGE REACH IN 1 DOOR LH - 29IN 735MM	WH	ENERGY STAR COMPLIANT
EQUIPMENT				
10845	2	OVEN TURBOCHEF CONVECTION MICROWAVE	WH	TURBOCHEF
11851	1	BREWER CLOVER	WH	
12631	1	GRINDER DITTING KR804	WH	
FOOD CASE				
12394	1	FOOD CASE - UPRIGHT - 46IN 1170MM - BLACK	WH	
ICE				
10102	1	ICE - BIN 590LB	VD	
10344	1	ICE - BIN DROP IN 90LB 40KG	VD	ELKAY
10527	1	ICE - BIN DROP IN 45LB	WH	
10971	1	ICE - MACHINE 625LB AIR COOLED SIDE VENT	WH	ENERGY STAR COMPLIANT
OTHER				
10091	1	CUP DISPENSER TALL HOT VERTICAL	WH	
10305	2	TRASH DROP RING LINER SQUARE - BLACK	WH	
10314	1	SCALE DIGITAL WITH ADJUSTABLE DISPLAY MOUNT	WH	
10396	1	CUP DISPENSER SHORT HOT VERTICAL	WH	
10467	1	FILE CABINET 2 DRAWER	WH	
10501	1	FIRE EXTINGUISHER	GC	VERIFY QUANTITY WITH LOCAL FIRE MARSHALL
10769	1	RESTROOM GRAB BAR VERTICAL - 18IN 455MM	WH	
10791	2	CUP DISPENSER GRANDE VENTI COLD VERTICAL	WH	
10829	13	CORNER GUARD - 1.25IN 30MM - PEWTER	WH	
10855	2	CUP DISPENSER GRANDE VENTI HOT VERTICAL	WH	
10858	1	CUP DISPENSER TALL COLD VERTICAL	WH	
10992	1	PAPER TOWEL DISPENSER HALF SIZE - TRANSLUCENT GRAY	WH	
11115	1	SOAP DISPENSER SINK MOUNTED	WH	BACKBAR
11823	1	SCALE DIGITAL	WH	
13330	1	MOBILE CUP DISPENSER CADDY	WH	
13584	1	CUP DISPENSER TRENTA COLD VERTICAL	WH	
STORAGE			•	·
10176	1	ROLLING PASTRY TRAY RACK	WH	
10222	1	WIRE SHELF GRID AT SINK	WH	
10293	1	10 COMP LOCKER	WH	ATTACH TO WALL
10416	7	WORKROOM WIRE SHELVING	WH	
10462	7	WORKROOM WIRE SHELVING POSTS	WH	
10698	1	MOP RACK WITH 3 HOLDERS	WH	
10838	1	ROLLING WIRE CART FOR 3 COMP SINK	WH	

Design ID	Count	Existing Items to be Relocated - DO I Description	Type Comments	Comments
10000	1	PHONE 1 LINE	7,2 22	EXISTING TO BE RELOCATE
10001	 1	PHONE 2 LINE		EXISTING TO BE RELOCATE
10002	 1	COMPUTER MANAGER WORKSTATION		EXISTING TO BE RELOCATE
10004	<u>·</u> 1	ALARM SYSTEM		EXISTING TO BE RELOCATE
10005	 1	MUSIC SYSTEM		EXISTING TO BE RELOCATE
10008	2	REGISTER COMPACT		EXISTING TO BE RELOCATE
10014	2	POS PRINTER		EXISTING TO BE RELOCATE
10019	1	WIDE AREA NETWORK HARDWARE		EXISTING TO BE RELOCATE
10013	<u> </u>	MONEY COUNTER		EXISTING TO BE RELOCATE
10024	<u> </u>	SAFE LH - 20X18X26IN 510X455X660MM		EXISTING TO BE RELOCATE
10024	1	SAFE BASE		EXISTING TO BE RELOCATE
10020	4	POS BANK		EXISTING TO BE RELOCATE
10029	1	TRASH ROUND		EXISTING TO BE RELOCATE
10034	<u>'</u> 1	AMPLIFIER - 14IN 355MM		EXISTING TO BE RELOCATE
10076	<u>1</u> 1			EXISTING TO BE RELOCATE
	<u>-</u>	RESTROOM TOILET PAPER HOLDER		
10116 10179	1	SINK - RESTROOM WALL MOUNTED		EXISTING TO BE RELOCATE
	1	HAND DRYER SURFACE MOUNTED		EXISTING TO BE RELOCATE
10312	2	BREWER SINGLE SOFT HEAT WARMING STAND		EXISTING TO BE RELOCATE
10473	1	FRIDGE UNDERCOUNTER 2 DOOR - 48IN 1220MM	ENERGY STAR COMPLIANT	EXISTING TO BE RELOCATE
10581	1	SINK - WORK WALL MOUNTED SST	INTEGRAL FAUCET WITH 0.5 GPM AERATOR	EXISTING TO BE RELOCATE
10597	1	FAUCET - SINGLE HANDLE		EXISTING TO BE RELOCATE
10724	1	GRINDER GRINDMASTER		EXISTING TO BE RELOCATE
10746	1	BREWER DUAL SOFT HEAT		EXISTING TO BE RELOCATE
10797	1	FOOD CASE - STACKED - 66IN 1675MM - BRONZE		EXISTING TO BE RELOCATE
10856	4	BREWER SERVER SOFT HEAT		EXISTING TO BE RELOCATE
10859	1	RESTROOM GRAB BAR - 48IN 1220MM		EXISTING TO BE RELOCATE
10862	 1	RESTROOM GRAB BAR - 36IN 915MM		EXISTING TO BE RELOCATE
10904	<u>·</u> 1	TOILET WITH TANK		EXISTING TO BE RELOCATE
10947	<u>.</u> 1	SOAP DISPENSER WALL MOUNTED	WORKROOM	EXISTING TO BE RELOCATE
11070	 1	DISHWASHER SANITIZER	Work and one	EXISTING TO BE RELOCATE
11083	1	FRIDGE REACH IN 2 DOOR - 51X35IN 1295X890MM	ENERGY STAR COMPLIANT	EXISTING TO BE RELOCATE
12508	2	BLENDER QUIET MODEL ON COUNTER	COM LINUT	EXISTING TO BE RELOCATE
12618	1	FRIDGE UNDERCOUNTER 1 DOOR WITH SHELF - 27IN 685MM	ENERGY STAR COMPLIANT	EXISTING TO BE RELOCATE
12640	1	NEWSPAPER STAND 4 TIER - 39IN 990MM	COMI LIANT	EXISTING TO BE RELOCATE
12694	2	ESPRESSO MACHINE MASTRENA	1	EXISTING TO BE RELOCATE
12854	2	MERCH FEATURE CUBE FREESTANDING SHORT	NOT PROVIDED BY CASEWORK VENDOR	EXISTING TO BE RELOCATE
12918	1	SPEAKER SURFACE MOUNTED OUTDOOR - BLACK		EXISTING TO BE RELOCATE
13244	7	CAN - RECESSED TRIM REFLECTOR - 5IN 125MM - WHITE		EXISTING TO BE RELOCATE
13254	3	CAN - RECESSED - 5IN 125MM - WHITE		EXISTING TO BE RELOCATE
13264	1	SINK - 3 COMP WORK SST - 93IN 2350MM		EXISTING TO BE RELOCATE
		FAUCET - HAND SINK WALL MOUNTED		EXISTING TO BE RELOCATE
			 	
13588 13676	2	FAUCET - HAND SINK WALL MOUNTED FREEZER REACH IN 1 DOOR RH - 27IN 685MM		EXISTING TO BE RELC



STARBUCKS COFFEE COMPANY 2401 UTAH AVENUE SOUTH SEATTLE, WASHINGTON 98134

(206) 318-1575

THESE DRAWINGS AND SPECIFICATIONS ARE CONFIDENTIAL AND SHALL REMAIN THE SOLE PROPERTY OF STARBUCKS CORPORATION, WHICH IS THE OWNER OF THE COPYRIGHT IN THIS WORK. THEY SHALL NOT BE REPRODUCED (IN WHOLE OR IN PART), SHARED WITH THIRD PARTIES OR USED IN ANY MANNER ON OTHER PROJECTS OR EXTENSIONS TO THIS PROJECT WITHOUT THE PRIOR WRITTEN CONSENT OF STARBUCKS CORPORATION. THESE DRAWINGS AND SPECIFICATIONS ARE INTENDED TO EXPRESS DESIGN INTENT FOR A PROTOTYPICAL STARBUCKS STORE (WHICH IS SUBJECT TO CHANGE AT ANYTIME) AND DO NOT REFLECT ACTUAL SITE CONDITIONS. NEITHER PARTY SHALL HAVE ANY OBLIGATION NOR LIABILITY TO THE OTHER (EXCEPT STATED ABOVE) UNTIL A WRITTEN AGREEMENT IS FULLY EXECUTED BY BOTH PARTIES.

ARCHITECT OF RECORD





	Revision Schedule					
Rev	Date	Ву	Description			

RADY & FARWELL
ROJECT ADDRESS:

677 N. FARWELL STREE
IILWAUKEE, WI 53202
IILWAUKEE COUNTY

STORE #: 2305

PROJECT #: 04217-001

CONCEPT: MCS

PALETTE: HERITAGE

ISSUE DATE: 12 09 13

DESIGN MANAGER: S. RYCHLIK

LEED® AP: N/A

PRODUCTION DESIGNER: C. ALINOVICH

CHECKED BY: K. GORIN


SHEET TITLE:


FF&E SCHEDULES

SCAL

SHEET NUMBER:

I-1114.1

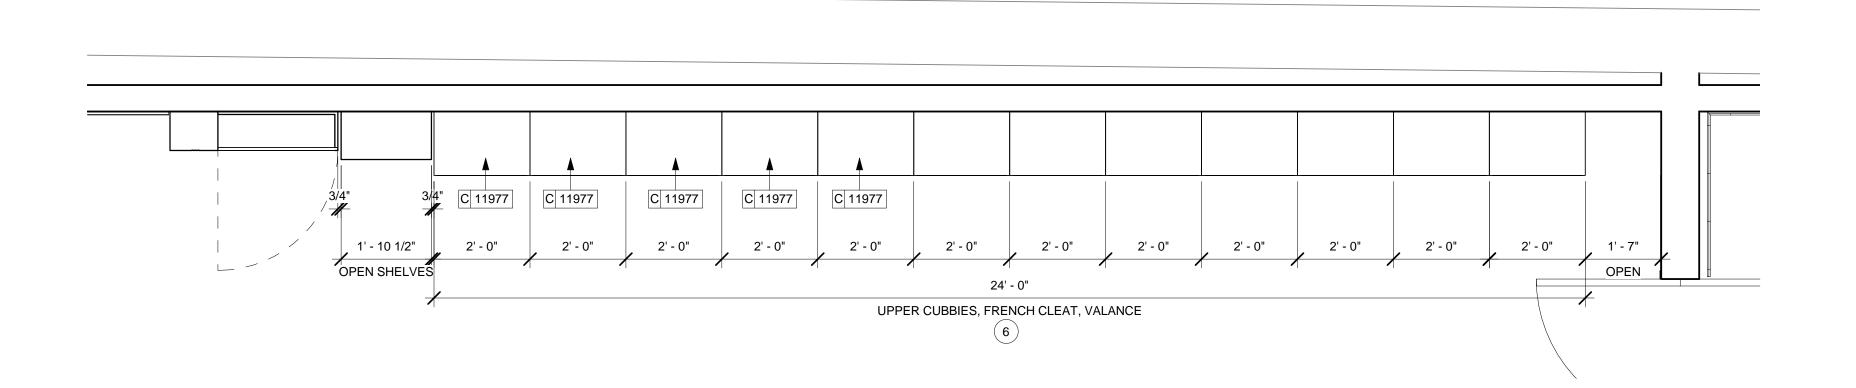

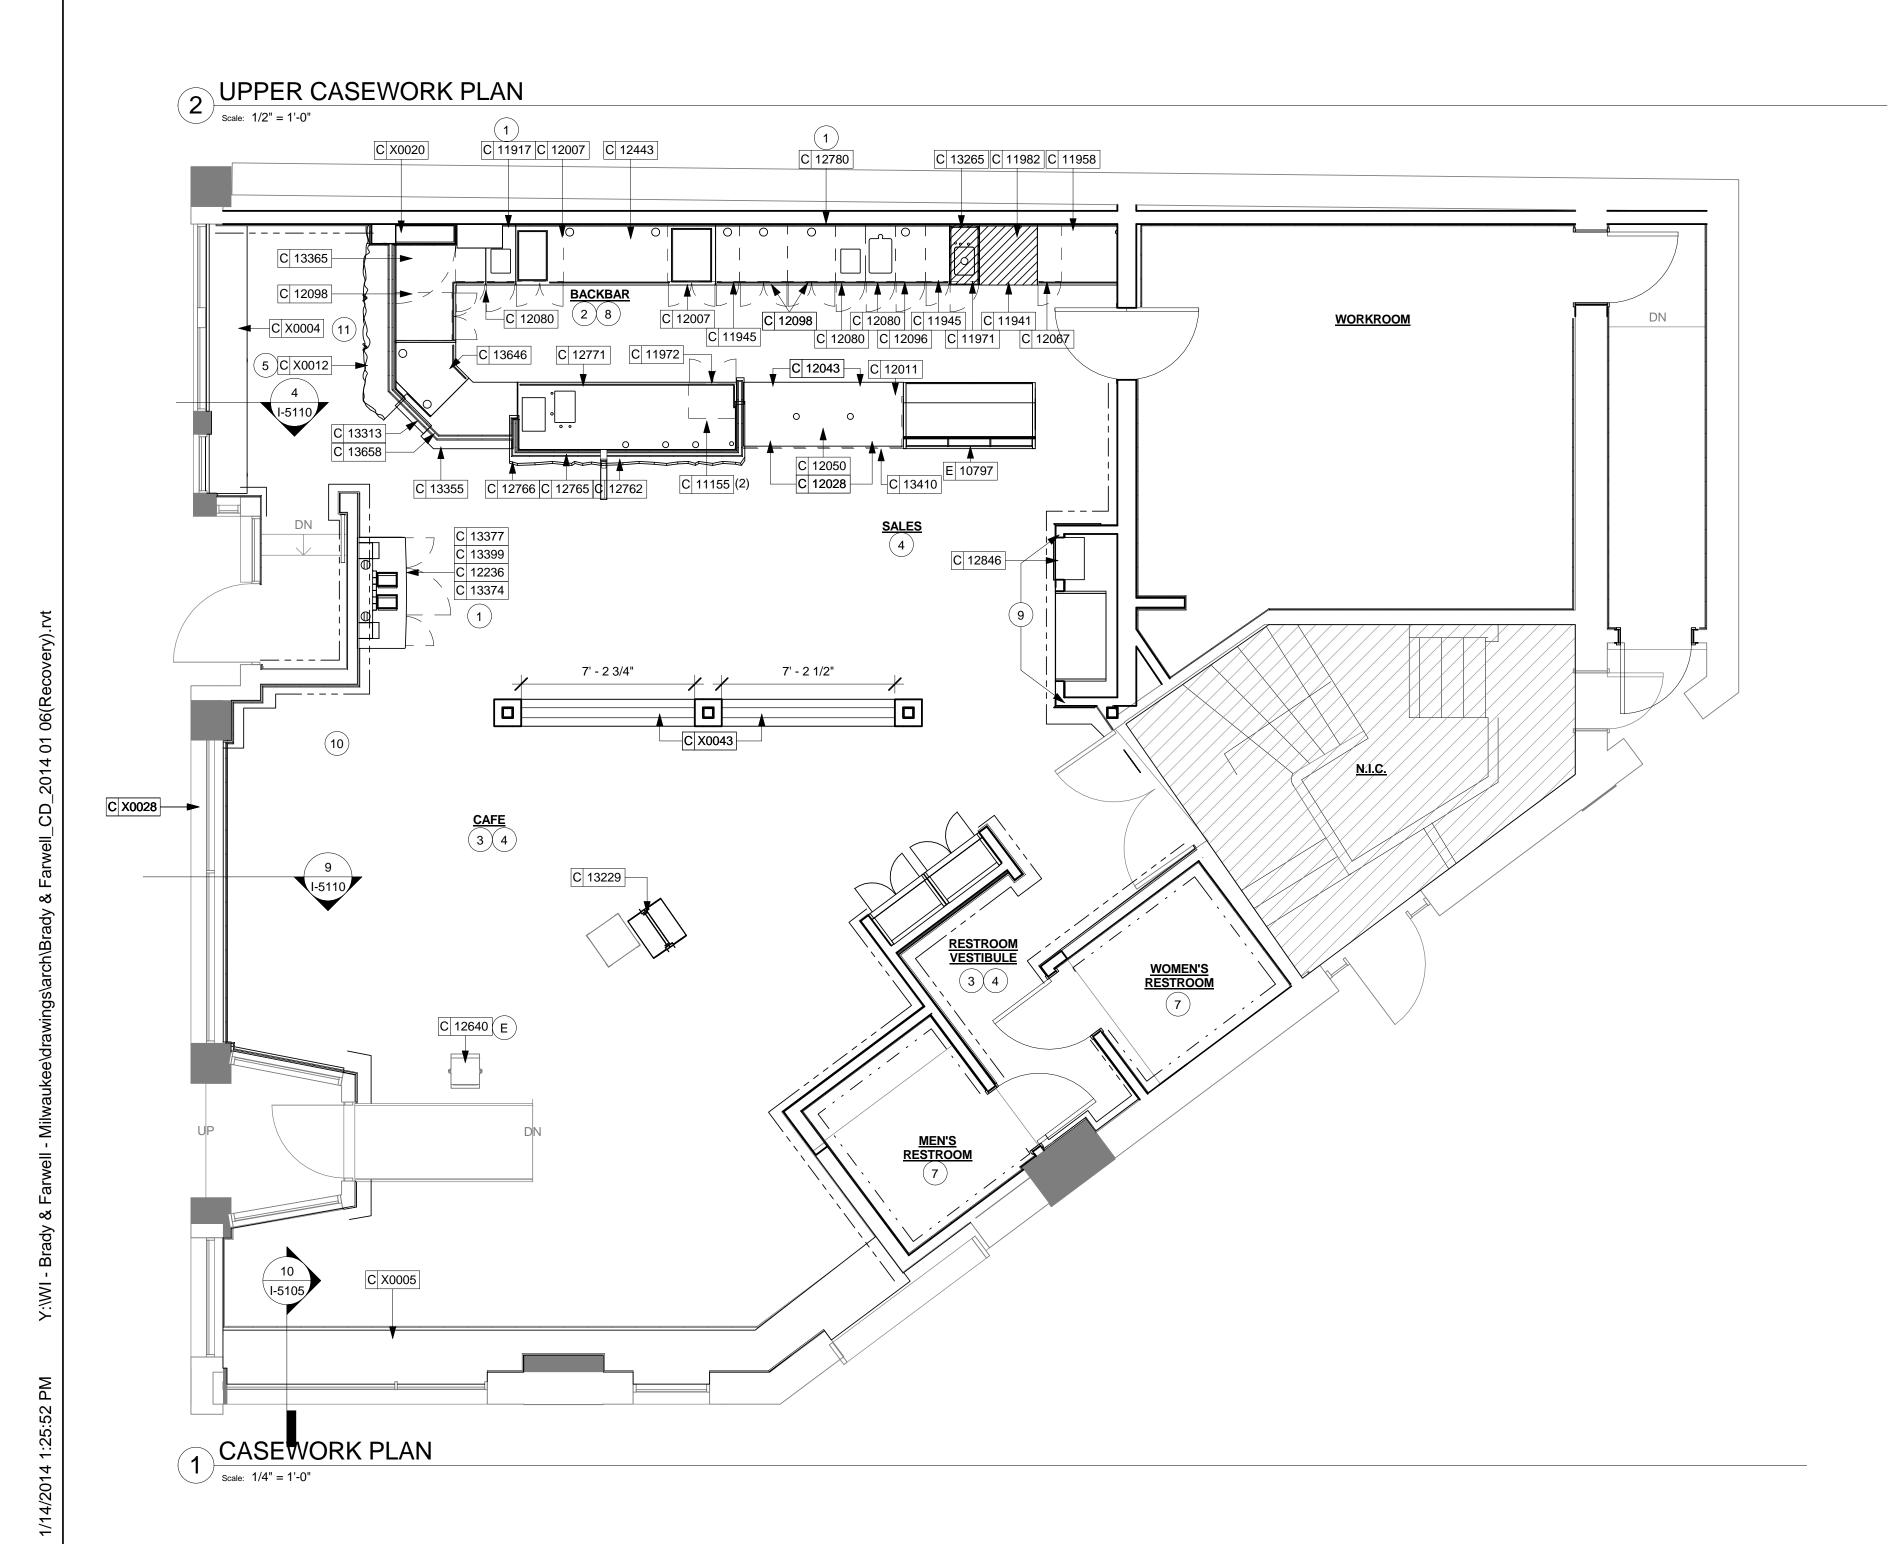

CASEWORK PLAN NOTES

A. GENERAL CONTRACTOR TO NOTIFY STARBUCKS CONSTRUCTION MANAGER IMMEDIATELY IF A DISCREPANCY EXISTS BETWEEN CASEWORK SHOP DRAWINGS, SITE DIMENSIONS, CASEWORK PLAN OR ACTUAL CASEWORK FIXTURES. ALL DIMENSIONS TO BE TAKEN FROM DESIGNATED DATUM POINT.

B. STARBUCKS CONSTRUCTION MANAGER TO COORDINATE AND SCHEDULE CASEWORK DELIVERY DATE. GENERAL CONTRACTOR TO CONFIRM CASEWORK DELIVERY DATE WITH CASEWORK MANUFACTURER 4 WEEKS AND 1 WEEK PRIOR TO SCHEDULED DATE OF DELIVERY.

C. STARBUCKS CONTRACTS DIRECTLY WITH CASEWORK VENDOR TO SUPPLY CASEWORK LISTED IN CASEWORK SCHEDULE, UNLESS OTHERWISE NOTED.

D. REFER TO CASEWORK INSTALLATION MANUAL PROVIDED BY CASEWORK VENDOR FOR COMPLETE INSTALLATION INSTRUCTIONS.

E. ALL CASEWORK BASE UNITS SHALL BE SET ON 1/4" (6MM) NON-ABSORBENT PLASTIC SHIMS PROVIDED BY CASÉWORK VENDOR.

F. SEE WALL FINISH PLAN FOR LOCATION, TAGGING, AND FINISH SCHEDULES OF APPLIED WALL TREATMENTS.

G. INSTALL OVEN STAINLESS STEEL COUNTERTOP AND BASE CABINET WITH 1/2" (10MM) GAP BETWEEN ADJACENT COUNTERTOPS.

H. SEE REFLECTED CEILING PLAN FOR CASEWORK SOFFIT LOCATIONS.

J. SEE SCHEDULE SHEETS FOR SCHEDULES.

SHEET NOTES

CLARIFICATION.

CLARIFICATION.

1. DO NOT CAULK TRASH RINGS TO COUNTERTOPS.

2. INSTALL 2" WOOD TILE TRIM AT BACKBAR.

3. INSTALL CHAIR RAIL AS INDICATED. REFER TO

INTERIOR ELEVATIONS FOR CLARIFICATION. 4. INSTALL CORNER GUARDS THROUGHOUT AS INDICATED. SEE INTERIOR ELEVATIONS FOR

5. INSTALL CUSTOM ESPRESSO CAP AS INDICATED. SEE DETAIL SHEETS FOR MORE INFORMATION.

6. INSTALL UPPER CUBBIES WITH FRENCH CLEAT AND LIGHT VALANCE AS INDICATED. RETURN LIGHT VALANCE TO WALL AT OPEN CUBBY ENDS.

7. INSTALL WOOD TRIM AT RESTROOM WALL TILE AS INDICATED. SEE INTERIOR ELEVATIONS FOR

8. GC TO SEAL ALL EXPOSED EDGES OF CABINETS.

9. INSTALL FULL HEIGHT WOOD WALL CLADDING AT WALL OF CHILL

10. INSTALL CUSTOM, FIXED COMMUNITY TABLE WITH INTEGRATED POWER AS INDICATED. ELECTRICAL TO RUN UP TABLE TOP THROUGH LEG OF BASE.

11. INSTALL CUSTOM BAR HEIGHT SIT HERE COUNTER AT WINDOW WITH INTEGRATED POWER AS INDICATED. SEE CASEWORK DETAIL SHEETS FOR MORE INFORMATION.

CASEWORK PLAN LEGEND

—— – – – INDICATES CHAIR RAIL

--- -- INDICATES WOOD WALL CLADDING

— - - — INDICATES WOOD TRIM AT RESTROOM









STARBUCKS COFFEE COMPANY

2401 UTAH AVENUE SOUTH SEATTLE, WASHINGTON 98134 (206) 318-1575

THESE DRAWINGS AND SPECIFICATIONS ARE CONFIDENTIAL AND SHALL REMAIN THE SOLE PROPERTY OF STARBUCKS CORPORATION, WHICH IS THE OWNER OF THE COPYRIGHT IN THIS WORK. THEY SHALL NOT BE REPRODUCED (IN WHOLE OR IN PART), SHARED WITH THIRD PARTIES OR USED IN ANY MANNER ON OTHER PROJECTS OR EXTENSIONS TO THIS PROJECT WITHOUT THE PRIOR WRITTEN CONSENT OF STARBUCKS CORPORATION. THESE DRAWINGS AND SPECIFICATIONS ARE INTENDED TO EXPRESS DESIGN INTENT FOR A PROTOTYPICAL STARBUCKS STORE (WHICH IS SUBJECT TO CHANGE AT ANYTIME) AND DO NOT REFLECT ACTUAL SITE CONDITIONS. NEITHER PARTY SHALL HAVE ANY OBLIGATION NOR LIABILITY TO THE OTHER (EXCEPT STATED ABOVE) UNTIL A WRITTEN AGREEMENT IS FULLY EXECUTED BY BOTH PARTIES.

ARCHITECT OF RECORD





Mechanical - Electrical - Plumbing

Revision Schedule

STORE #: 2305 PROJECT #: 04217-001 MCS CONCEPT: PALETTE: HERITAGE ISSUE DATE: 12 09 13 DESIGN MANAGER: S. RYCHLIK LEED $^{ extsf{R}}$ AP: PRODUCTION DESIGNER: C. ALINOVICH CHECKED BY: K. GORIN

SHEET TITLE:

CASEWORK PLAN

As indicated

SCALE: SHEET NUMBER:

		CASEWORK SCHED	1	
DESIGN ID	COUNT	DESCRIPTION	RESP.	COMMENTS
X0004	2	SIT HERE COUNTER AT WINDOW	VD	PROVIDED BY CHARLIE SANSONE. CJSSANSONE@ATT.NET. T: 847.204.6106 SEE INTERIOR ELEVATIONS AND CASEWORK DETAIL SHEETS FOR MORE INFORAMATION
X0005	1	BANQUETTE AT WINDOW	VD	PROVIDED BY CHARLIE SANSONE. CJSSANSONE@ATT.NET. T: 847.204.6106 SEE INTERIOR ELEVATIONS AND CASEWORK DETAIL SHEETS FOR MORE INFORAMATION
X0016	4	2" WOOD TRIM AT BACKBAR/ELIASON	VD	PROVIDED BY CHARLIE SANSONE. CJSSANSONE@ATT.NET. T: 847.204.6106 SEE INTERIOR ELEVATIONS AND CASEWORK DETAIL SHEETS FOR MORE INFORAMATION. OVERALL LENGTH NEEDED: 42' - 0"
X0017	10	2" WOOD TRIM AT RESTROOM TILE	VD	PROVIDED BY CHARLIE SANSONE. CJSSANSONE@ATT.NET. T: 847.204.6106 SEE INTERIOR ELEVATIONS AND CASEWORK DETAIL SHEETS FOR MORE INFORAMATION. OVERALL LENGTH NEEDED: 42' - 8 1/2"
X0028	1	CORIAN WINDOW SILLS	VD	CORIAN WINDOW SILLS - CP0005. PROVIDED BY CASEWORK VENDOR. SEE CASEWORK SHEETS AND FINISH SCHEDULES FOR MORE INFORMATION. OVERALL LENGTH NEEDED: 95' - 6 1/2"
X0033	2	CROWN MOULDING	VD	PROVIDED BY CHARLIE SANSONE. CJSSANSONE@ATT.NET. T: 847.204.6106. CROWN MOULDING AT PERMIETER OF COFFERED CEILING ABOVE BANQUETTE AND SOFFIT AT BACKBAR. SEE INTERIOR ELEVATIONS AND RCP FOR CLARIFICATION OVERALL LENGTH NEEDED: 95' - 61/2"
X0035	1	COFFERED CEILING	GC	COFFERED CEILING CONSTRUCTION WITH P551 PAINT FINISH - INSET TIN CEILING PANELS SEE RCP DETAIL SHEETS FOR DIMENSIONS AND DETAILS.
X0036	1	OPEN SHELVES AT BACKBAR	VD	PROVIDED BY CHARLIE SANSONE. CJSSANSONE@ATT.NET. T: 847.204.6106. STAIN TO MATCH CHAIR RAIL. SEE CASEWORK DETAIL SHEETS AND INTERIOR ELEVATIONS FOR MORE INFORMATION
X0037	1	SHELVING BRACKETS	VD	VAN DYKES. ITEM # 02040365. STORE ID: 211529 IRON SHELF BRACKET. SOLD IN PAIRS. NEED TOTAL OF 3 PAIRS. VANDYKES.COM. 800.558.1234.
X0038	1	WOOD WINDOW TRIM	VD	PROVIDED BY CASEWORK VENDOW. 2IN WOOD TRIM TO FRAME EXISTING WINDOW AT EXPANSION SPACE ENTRANCE. STAIN WOOD TO MATCH WD0001
X0043	1	BANQUETTE TOP CAP	VD	PROVIDED BY CHARLIE SANSONE. 1/4" TOP CAP AT BANQUETTE SETEE AT COLUMNS. STAIN WOOD TO MATCH BANQUETTE - WD0001. SEE ASEWORK PLAN AND DETAIL SHEETS FOR MORE INFORMATION.
CABINET				
11941	1	CABINET - WARMING CART BASE	VD	

		CASEWORK SCHEDULE		
DESIGN ID	COUNT	DESCRIPTION	RESP.	COMMENTS
11945	2	CABINET - 12IN 305MM	VD	
11971	1	CABINET - SINK OR ICE BIN - 15IN 380MM	VD	
11972	1	CABINET - ESPRESSO - 24IN 610MM	VD	
11977	12	CABINET - UPPER CUBBY - 24X16X21IN	VD	
		610X405X535MM		
12007	2	CABINET - SINK OR ICE BIN - 24IN 610MM	VD	PL0014
12043	2	CABINET - POS - 29IN 735MM	VD	PL0014
12050		CABINET - POS BRIDGE FOR SAFE - 22X27IN	VD	PL0014
12000	'	560X685MM		1 20014
12067	1	CABINET - WARMING WITH TRASH DROP - 12IN	VD	PL0014
12001	'	305MM	1	1 20014
12080	4	CABINET - 15IN 380MM	VD	PL0014
12096	1	CABINET - WITH DRAWER - 15IN 380MM	VD	PL0014
			VD	
12098	3	CABINET - BREW GRIND - 24IN 610MM		PL0014
12846	1	CABINET - PACKAGED FOOD CUBBY INSET	VD	PL0014
13646	1	CABINET - RESERVE CLOVER WITH DRAWER -	VD	PL0014
		12IN 305MM		
X0020	1	CABINET - RESERVE TOWER - LH	VD	PL0014
CAFE				
12236	1	CONDIMENT CART SINGLE TOP SOLID	VD	CP0005
		SURFACE	<u>L</u>	
13229	1	COFFEE FLOOR STAND WITH METAL MESH	WH	NOT PROVIDED BY CASEWORK
				VENDOR
13374	1	CONDIMENT CART SINGLE BASE FRAME	VD	
13377	1	CONDIMENT CART SINGLE FINISH PANELS	VD	WD0016
13399	<u>.</u> 1	CONDIMENT CART SINGLE METAL TOP	VD	· · - · - · · · · · · · · · · ·
.5555	'	ASSEMBLY	-	
COUNTERTO)P	· -		
11917	1	COUNTERTOP - TRASH SOLID SURFACE - 15IN	VD	
11817	ı	380MM	טען	
14050	A		VD	
11958	1	COUNTERTOP - WARMING SOLID SURFACE -	VD	
14000		42IN 1065MM	\/D	
11982	1	COUNTERTOP - WARMING WITH FRONT	VD	
100::		BUMPER STAINLESS - 29IN /35MM	\	
12011	1	COUNTERTOP - POS SOLID SURFACE - 80IN	VD	
		2030MM	L	
12443	1	COUNTERTOP - CBS SOLID SURFACE - LH -	VD	
		100IN 2540MM		
12771	1	COUNTERTOP - ESPRESSO RINSE SINK AND	VD	
		ICE BIN SOLID SURFACE - LH - 140IN 3555MM		
12780	1	COUNTERTOP - BREW GRIND RINSE SINK AND	VD	
		TRASH SOLID SURFACE - LH - 117IN 2970MM		
13265	1	COUNTERTOP - HAND SINK LOW SPLASH	VD	
		STAINLESS - 15IN 380MM		
13355	1	COUNTERTOP - RESERVE CLOVER HANDOFF	VD	
		SOLID SURFACE - LH		
13365	1	COUNTERTOP - RESERVE CORNER SOLID	VD	
		SURFACE - LH	<u>L</u>	
DIEWALL				
12765	1	DIEWALL - ESPRESSO - LH - 140IN 3555MM	VD	
12766	<u> </u>	DIEWALL - ESPRESSO TOP CAP - LH - 140IN	VD	
.2.00	'	3555MM	-	
13658	1	DIEWALL - RESERVE - LH	VD	
X0012	1	DIEWALL - RESERVE TOP CAP CUSTOMER	VD	
AUU12	1	BAR - LH	טען	
EIT IZIT		DAIX - LIT		
FIT KIT		FIT WIT DECEDING COST	\ /P	
13328	1	FIT KIT - RESERVE CORNER	VD	
OTHER				
11142	1	CORBEL SUPPORT - 24IN 610MM	VD	
11155	2	ESPRESSO MACHINE PUMP MOUNT - 10X10IN	VD	
		255X255MM		
12100	4	ESPRESSO COUNTERTOP SUPPORT LEG	VD	
		STAINLESS		
13410	1	POS DOUBLE TOE KICK - CORNER - 80IN	VD	
-		2030MM		
PANEL		•	•	•
12028	2	PANEL - POS - 29IN 735MM	VD	
12020		PANEL - POS - 29IN 735IVIIVI	VD	
	1			HANDOEE EINIOU DANE: NOT
12762	1	PANEL - ESPRESSO - LH - 140IN 3555MM	VD	HANDOFF FINISH PANEL NOT
				REQUIRED WHEN INCORPORATING
				RESERVE STATION. VERIFY DESIGNATION OF ABRICATION.
40010		DANIEL DECEDITE LL	\/D	I NION TO FADRICATION.
13313	1	PANEL - RESERVE - LH	VD	
13571	1	PANEL - UPRIGHT FOOD CASE FRONT	VD	
13580	2	PANEL - UPRIGHT FOOD CASE SIDE	VD	

LOCATION	DESCRIPTION	FINISH CODE	COMMENTS
2" TRIM AT BACKBAR TILE	WOOD	WD0051	PROVIDED BY CASEWORK VENDOR. STAIN TO MATCH WD0051
CORIAN SILL	CORIAN	CP0001	
ELIASON DOOR	PLASTIC LAMINATE - WEATHERED GREY WITH GRAIN	PL0012	
CABINETS		•	
BACKBAR UPPER STORAGE CUBBIES	PLASTIC LAMINATE - MEDIUM TONE BROWN WITH GRAIN	PL0014	
UNDERCOUNTER CABINET EDGE BANDING	PLASTIC LAMINATE - BLACK		
UNDERCOUNTER CABINET EXPOSED BACK, SIDE	PLASTIC LAMINATE - BLACK		
UNDERCOUNTER CABINET EXTERIOR	PLASTIC LAMINATE - MEDIUM TONE BROWN WITH GRAIN	PL0014	
UNDERCOUNTER CABINET INTERIOR	PLASTIC LAMINATE - ALMOND (ST655-S)		
CAFE		'	'
CHAIR RAIL	WOOD - WARM BROWN DARK TONE DISTRESSED	WD0001	
CONDIMENT CART TOP	COMPOSITE - BLACK WITH FLECKS	CP0001	
CONDIMENT CART TOP	COMPOSITE - BLACK WITH FLECKS	CP0001	
CONDIMENT CART, ETAGERE, MERCH BAY EXTERIOR	PLASTIC LAMINATE - MEDIUM TONE BROWN WITH GRAIN	PL0014	
FOOD CASE WALL CLADDING	WOOD - BLONDE RUSTIC	WD0051	
COUNTERTOPS - BACKBAR			
BACKBAR, SIDELINE COUNTERTOPS	COMPOSITE - BLACK WITH FLECKS	CP0001	
ESPRESSO COUNTERTOPS	STAINLESS STEEL - #4 BRUSHED 16GA SST		
ESPRESSO COUNTERTOPS	COMPOSITE - BLACK WITH FLECKS	CP0001	
HAND SINK COUNTERTOP	STAINLESS STEEL - #4 BRUSHED 16GA SST		
COUNTERTOPS - FRONT BAR			
HANDOFF PLANE	COMPOSITE - BLACK WITH FLECKS	CP0001	
POS, FRONTBAR COUNTERTOPS	COMPOSITE - BLACK WITH FLECKS	CP0001	
FINISH PANELS			
ESPRESSO FINISH PANELS	WOOD - BLONDE RUSTIC	WD0051	
FINISH PANEL MOUNTING BRACKETS	COLD ROLLED STEEL	MT0002	
FINISH PANEL TRIM DETAILS	HOT ROLLED STEEL WITH MATTE SEALER	MT0011	
HANDOFF, SIDELINE FINISH PANELS	WOOD - BLONDE RUSTIC	WD0051	
POS, FRONTBAR FINISH PANELS	WOOD - BLONDE RUSTIC	WD0051	
OTHER			
ESPRESSO TOP CAP	WOOD - WARM BROWN DARK TONE DISTRESSED	WD0001	LIVE EDGE
OVER "BLACK" DUPLEX OUTLETS IN WAINSCOT LOCATIONS	SWITCHPLATE - PART #4752-112-CD VENETIAN BRONZE		GC SUPPLIED

CASEWORK MCS CABINET BASE OPTION SCHEDULE					
DESIGN ID COUNT		BASE OPTION	DESCRIPTION		
11941	1	Other	CABINET - WARMING CART BASE		
11945	2	Other	CABINET - 12IN 305MM		
11971	1	Other	CABINET - SINK OR ICE BIN - 15IN 380MM		
11972	1	Other	CABINET - ESPRESSO - 24IN 610MM		
12007	2	Other	CABINET - SINK OR ICE BIN - 24IN 610MM		
12043	2	Other	CABINET - POS - 29IN 735MM		
12050	1	Box Base	CABINET - POS BRIDGE FOR SAFE - 22X27IN 560X685MM		
12067	1	Other	CABINET - WARMING WITH TRASH DROP - 12IN 305MM		
12080	4	Other	CABINET - 15IN 380MM		
12096	1	Other	CABINET - WITH DRAWER - 15IN 380MM		
12098	3	Other	CABINET - BREW GRIND - 24IN 610MM		
13646	1	Other	CABINET - RESERVE CLOVER WITH DRAWER - 12IN 305MM		



STARBUCKS COFFEE
COMPANY
2401 UTAH AVENUE SOUTH
SEATTLE, WASHINGTON 98134
(206) 318-1575

THESE DRAWINGS AND SPECIFICATIONS ARE CONFIDENTIAL AND SHALL REMAIN THE SOLE PROPERTY OF STARBUCKS CORPORATION, WHICH IS THE OWNER OF THE COPYRIGHT IN THIS WORK. THEY SHALL NOT BE REPRODUCED (IN WHOLE OR IN PART), SHARED WITH THIRD PARTIES OR USED IN ANY MANNER ON OTHER PROJECTS OR EXTENSIONS TO THIS PROJECT WITHOUT THE PRIOR WRITTEN CONSENT OF STARBUCKS CORPORATION. THESE DRAWINGS AND SPECIFICATIONS ARE INTENDED TO EXPRESS DESIGN INTENT FOR A PROTOTYPICAL STARBUCKS STORE (WHICH IS SUBJECT TO CHANGE AT ANYTIME) AND DO NOT REFLECT ACTUAL SITE CONDITIONS. NEITHER PARTY SHALL HAVE ANY OBLIGATION NOR LIABILITY TO THE OTHER (EXCEPT STATED ABOVE) UNTIL A WRITTEN AGREEMENT IS FULLY EXECUTED BY BOTH PARTIES.

ARCHITECT OF RECORD





Revision Schedule				
Date	Ву	Description		
	Date			

ROJECT ADDRESS:

677 N. FARWELL STREE
IILWAUKEE, WI 53202
IILWAUKEE COUNTY

STORE #: 2305

PROJECT #: 04217-001

CONCEPT: MCS

PALETTE: HERITAGE

ISSUE DATE: 12 09 13

DESIGN MANAGER: S. RYCHLIK

LEED® AP: N/A

PRODUCTION DESIGNER: C. ALINOVICH


CHECKED BY: K. GORIN

SHEET TITLE:

CASEWORK SCHEDULES

SCALE:
SHEET NUMBER:

I-1115.1

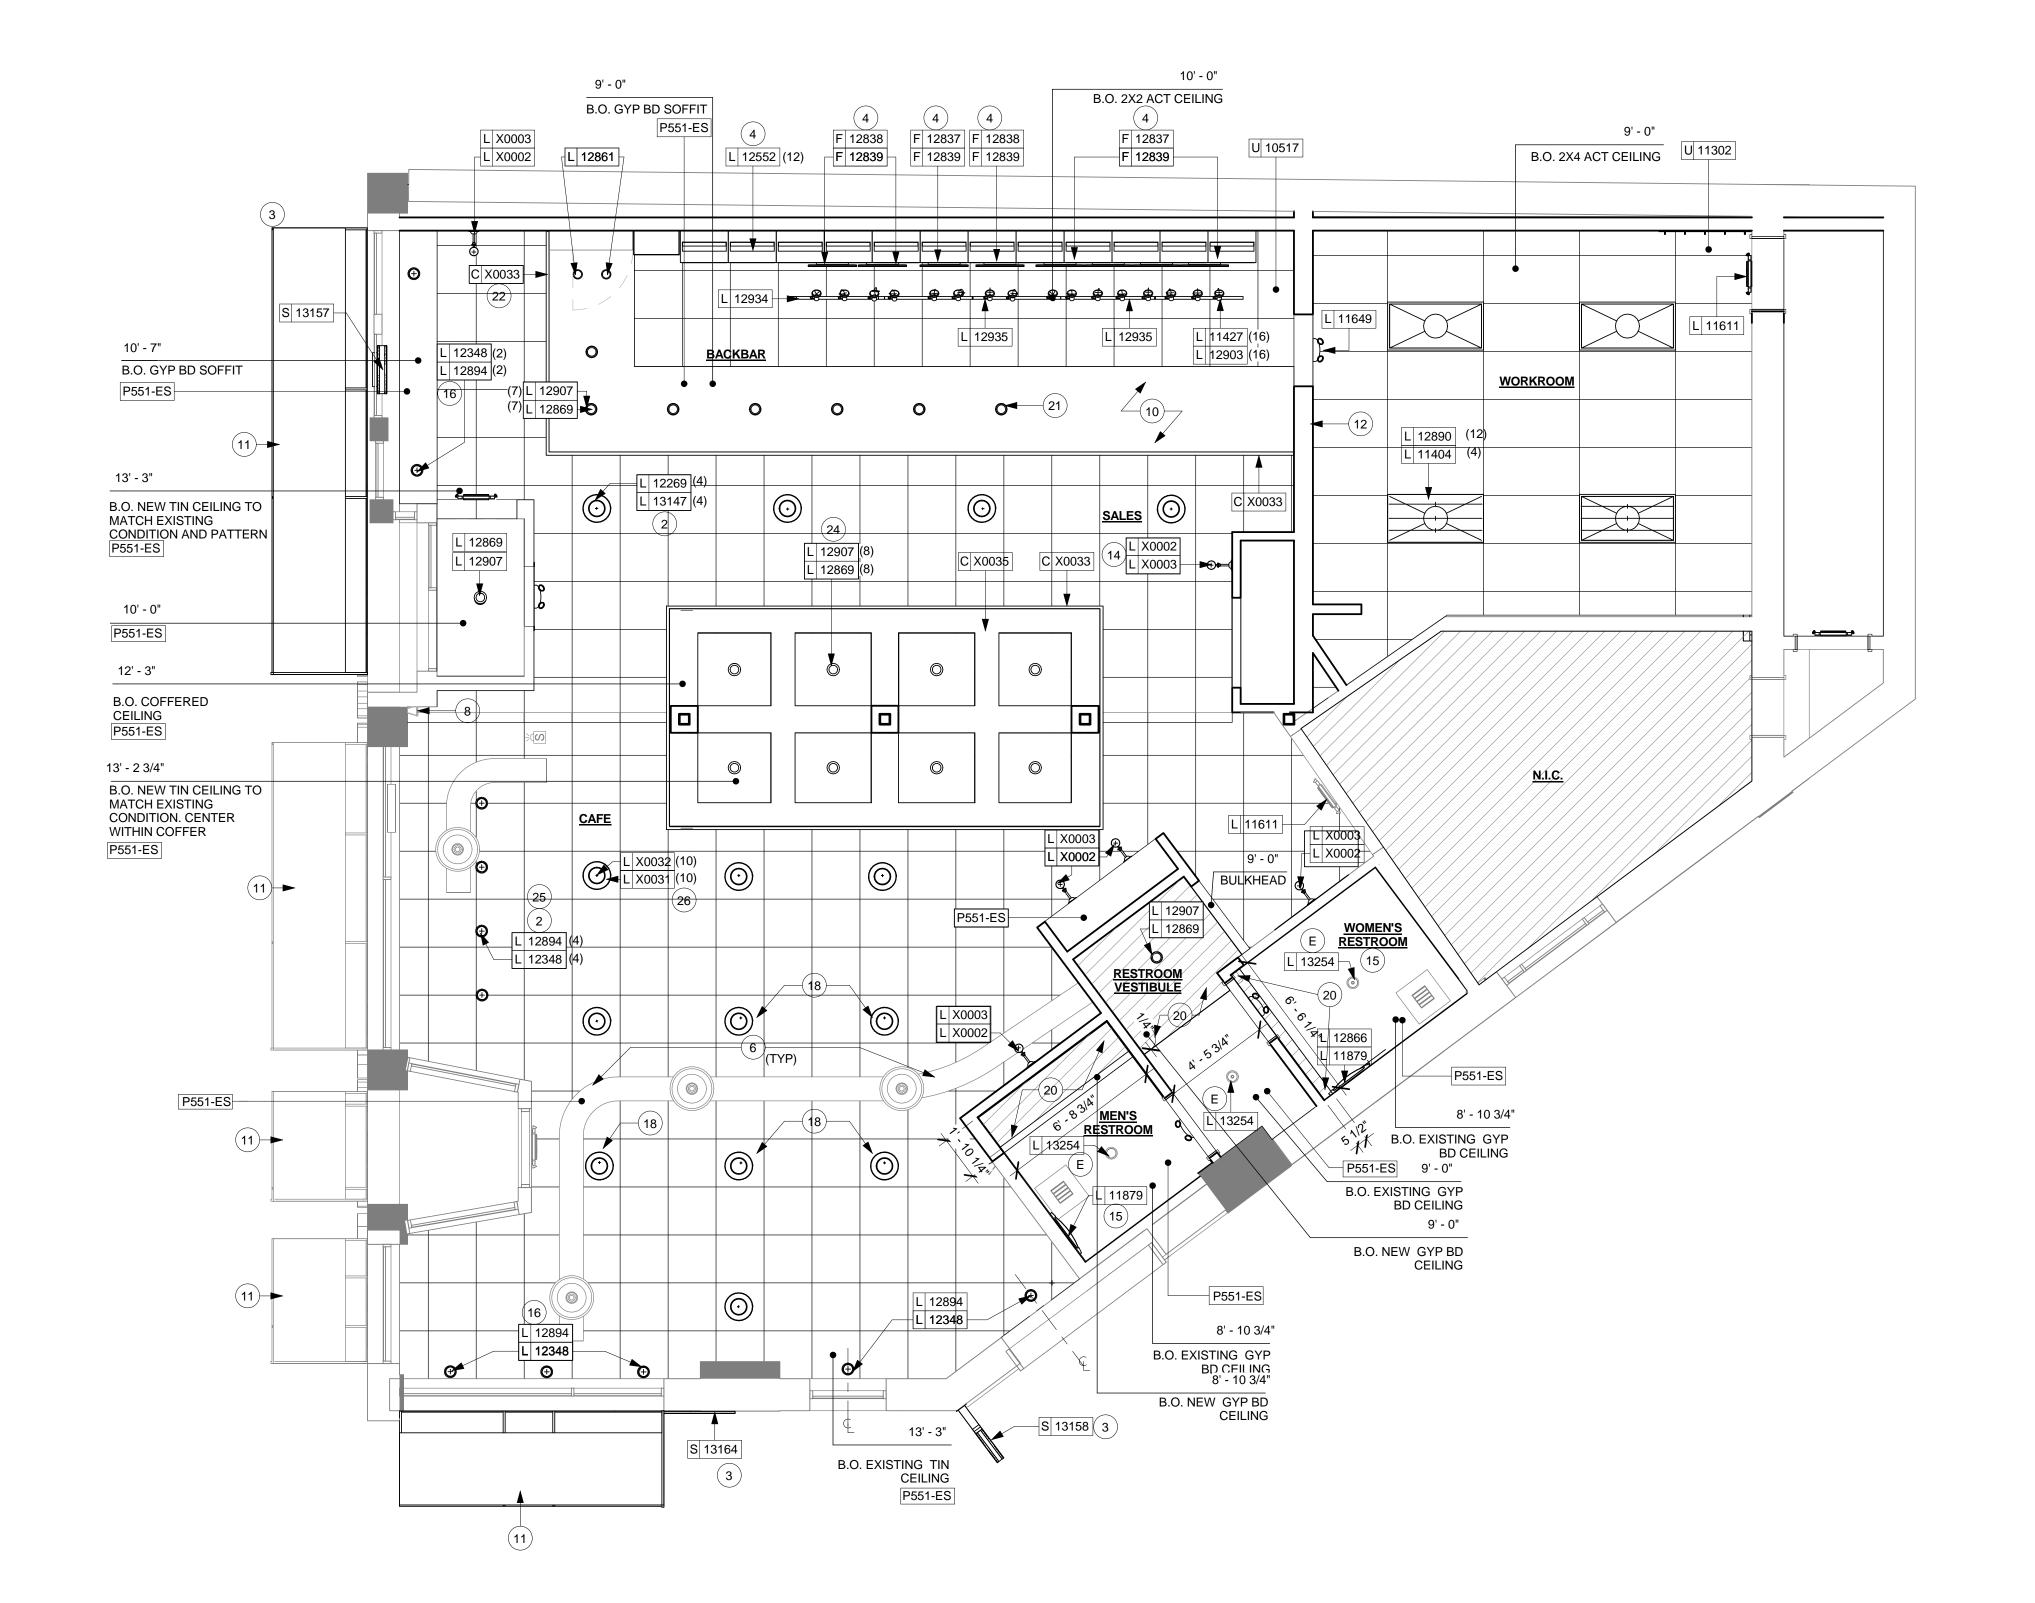

1 REFLECTED CEILING PLAN

REFLECTED CEILING PLAN NOTES

A. IF REQUIRED BY LOCAL CODE, GENERAL CONTRACTOR TO PROVIDE SEMI-RECESSED SPRINKLER HEADS WITH POLISHED CHROME ESCUTCHEONS CENTERED IN ACOUSTICAL CEILING TILE. IF PENDANT HEADS ARE REQUIRED IN GYPSUM SOFFIT OVER FRONTBAR, CONCEAL SUPPLY PIPING WITHIN SOFFIT. GENERAL CONTRACTOR TO SUBMIT SPRINKLER LAYOUT TO STARBUCKS' CONSTRUCTION MANAGER FOR APPROVAL PRIOR TO INSTALLATION.

B. GENERAL CONTRACTOR TO PROVIDE AND LOCATE SPRINKLERS PER LOCAL CODES. CONTACT STARBUCKS CONSTRUCTION MANAGER IF DESIGN INTENT IS AFFECTED.

C. WHERE ACOUSTICAL CEILING MEETS WALL, PROVIDE ANGLE WALL MOLDING FOR REVEAL. MATCH CEILING GRID COLOR WHEN APPLICABLE.

D. LEAVE (10) ADDITIONAL RETAIL CEILING TILES, TO MATCH RETAIL CEILING PAINT COLOR, ABOVE THE WORKROOM CEILING AT MANAGER'S DESK FOR FUTURE USE.

E. PROVIDE GROMMET AT ALL CEILING PENETRATIONS FOR FIXTURES OR SUPPORTS.

F. HEATING, VENTILATING, AND AIR CONDITIONING (HVAC) SHOWN FOR DESIGN INTENT ONLY. CONTACT PROJECT MANAGER IF CHANGED.

G. DIFFUSERS AND RETURNS AT BACKBAR IN ACOUSTICAL CEILING TILE TO BE CENTERED IN TILE, PAINTED TO MATCH ADJACENT FINISHES, TYPICAL.

H. PAINT ALL HVAC DUCTS, HVAC DIFFUSERS, RECESSED SPEAKERS AND LIGHT TRIM RINGS THE SAME COLOR AS CEILING OR SOFFIT. TYPICAL THROUGHOUT RETAIL PORTION OF STORE.

J. PAINT SUBSTITUTIONS ARE NOT ALLOWED. USE STARBUCKS' NATIONAL ACCOUNT "COLOR CODE" WHEN ORDERING PAINTS. SEE SCHEDULE SHEETS FOR SCHEDULES

K. SEE LIGHTING DESIGN PLAN FOR FIXTURE TYPES AND LOCATION DIMENSIONS.

SHEET NOTES

1. REFER TO SHEET I-1105.1 FOR CEILING/LIGHTING DIMENSIONS.

2. REFER TO INTERIOR ELEVATIONS FOR PENDANT MOUNTING HEIGHTS.

3. REFER TO EXTERIOR ELEVATIONS FOR SIGNAGE MOUNTING HEIGHTS.

4. REFER TO INTERIOR ELEVATIONS FOR MENU BOARD SPACING.

5. GC TO COORDINATE SECURITY CAMERA QUANTITIES AND LOCATIONS WITH STARBUCKS CONSTRUCTION MANAGER.

6. GC TO PAINT ALL HVAC SUPPLY AND RETURN DIFFUSERS TO MATCH SURROUNDING CEILING COLOR. PAINT EXPOSED HVAC DUCTWORK AND DIFFUSERS IN CAFE TO MATCH PAINT FINISH - P551.

7. SUSPENDED TRACK LIGHTING. ALIGN TRACK HEADS ABOVE MERCHANDISE BAYS, ARTWORK, MENU BOARDS, ETC.

8. INSTALL WALL MOUNTED SPEAKERS AT MAXIMUM HEIGHT ALLOWABLE PER SPEC SHEETS.

9. PAINT RECESSED LIGHTING TRIM TO MATCH CEILING AS CLOSELY AS POSSIBLE.

10. PAINT GYPSUM BOARD CEILINGS AS INDICATED.

11. INSTALL NEW & REUPHOLSTERED FABRIC AWNINGS AS INDICATED. SEE EXTERIOR ELEVATINOS FOR CLARIFICATION AND MOUNTING HEIGHTS.

12. NEW LOCATION OF ALL SWITCHING.

13. LOCATIONS OF ALL EGRESS LIGHTING FOR REFERENCE ONLY. GC TO VERIFY WITH LOCAL FIRE MARSHALL PRIOR TO INSTALLATION.

14. CENTER LIGHT AT FOOD CASE.

15. GC TO INSTALL SCONCES CENTERED OVER MIRROR AND SINK AS INDICATED ON INTERIOR ELEVATIONS.

16. CENTER WINDOW PENDANTS AT WINDOWS AS INDICATED.

17. SURFACE MOUNTED TRACK LIGHTING. CENTER AT MENU BOARDS.

18. NEW FIELD PENDANTS TO REPLACE EXISTING CAN PENDANTS.

19. ALL LIGHTING AND CEILING MOUNTED FIXTURES TO BE SURFACE MOUNTED. PAINT CONDUIT TO MATCH CEILING - PX019-ES.

20. NEW GYP BD, PATCH, REPAIR, PRIME/PAINT GYP BOARD CEILING AS NECESSARY. ALIGN WITH FINISH FACE OF EXISTING CEILING

21. CENTER RECESSED CAN ABOVE POS STATION AT FRONTBAR.

22. CROWN MOULDING AT UPPER PERIMETER OF GYP

23. INSTALL LED INTEGRATED TASK LIGHT AS

BD SOFFIT. PAINT TO MATCH CEILING- P551-ES.

INDICATED.

24. CENTER RECESSED CAN WITHIN COFFER.25. CENTER PENDANTS ABOVE COMMUNITY TABLE.

26. CENTER NEW FLUSH MOUNT FIXTURES WITHIN TIN CEILING TILE.







STARBUCKS COFFEE COMPANY

2401 UTAH AVENUE SOUTH SEATTLE, WASHINGTON 98134 (206) 318-1575

THESE DRAWINGS AND SPECIFICATIONS ARE CONFIDENTIAL AND SHALL REMAIN THE SOLE PROPERTY OF STARBUCKS CORPORATION, WHICH IS THE OWNER OF THE COPYRIGHT IN THIS WORK. THEY SHALL NOT BE REPRODUCED (IN WHOLE OR IN PART), SHARED WITH THIRD PARTIES OR USED IN ANY MANNER ON OTHER PROJECTS OR EXTENSIONS TO THIS PROJECT WITHOUT THE PRIOR WRITTEN CONSENT OF STARBUCKS CORPORATION. THESE DRAWINGS AND SPECIFICATIONS ARE INTENDED TO EXPRESS DESIGN INTENT FOR A PROTOTYPICAL STARBUCKS STORE (WHICH IS SUBJECT TO CHANGE AT ANYTIME) AND DO NOT REFLECT ACTUAL SITE CONDITIONS. NEITHER PARTY SHALL HAVE ANY OBLIGATION NOR LIABILITY TO THE OTHER (EXCEPT STATED ABOVE) UNTIL A WRITTEN AGREEMENT IS FULLY EXECUTED BY BOTH PARTIES.

ARCHITECT OF RECORD





Engineering Consultants
Mechanical - Electrical - Plumbing

Revision Schedule

Rev Date By Description

PROJECT NAME:

BRADY & FARWELL

PROJECT ADDRESS:

1677 N. FARWELL STREE

MILWAUKEE, WI 53202

MILWAUKEE, WI 53202

MILWAUKEE, COLINITY

STORE #: 2305 PROJECT #: 04217-001 CONCEPT: MCS PALETTE: HERITAGE ISSUE DATE: 12 09 13 **DESIGN MANAGER:** S. RYCHLIK LEED® AP: N/A PRODUCTION DESIGNER: C. ALINOVICH CHECKED BY: K. GORIN

SHEET TITLE:

REFLECTED CEILING

SCALE: PLAN
1/4" = 1'-0"

SHEET NUMBER:







STARBUCKS COFFEE COMPANY

2401 UTAH AVENUE SOUTH SEATTLE, WASHINGTON 98134 (206) 318-1575

THESE DRAWINGS AND SPECIFICATIONS ARE CONFIDENTIAL AND SHALL REMAIN THE SOLE PROPERTY OF STARBUCKS CORPORATION, WHICH IS THE OWNER OF THE COPYRIGHT IN THIS WORK. THEY SHALL NOT BE REPRODUCED (IN WHOLE OR IN PART), SHARED WITH THIRD PARTIES OR USED IN ANY MANNER ON OTHER PROJECTS OR EXTENSIONS TO THIS PROJECT WITHOUT THE PRIOR WRITTEN CONSENT OF STARBUCKS CORPORATION. THESE DRAWINGS AND SPECIFICATIONS ARE INTENDED TO EXPRESS DESIGN INTENT FOR A PROTOTYPICAL STARBUCKS STORE (WHICH IS SUBJECT TO CHANGE AT ANYTIME) AND DO NOT REFLECT ACTUAL SITE CONDITIONS. NEITHER PARTY SHALL HAVE ANY OBLIGATION NOR LIABILITY TO THE OTHER (EXCEPT STATED ABOVE) UNTIL A WRITTEN AGREEMENT IS FULLY EXECUTED BY BOTH PARTIES.

ARCHITECT OF RECORD





Engineering Consultants Mechanical - Electrical - Plumbing

Revision Schedule Description Rev Date By

& FARWELL


STORE #: 2305 PROJECT #: 04217-001 MCS CONCEPT: PALETTE: HERITAGE ISSUE DATE: 12 09 13 DESIGN MANAGER: S. RYCHLIK LEED® AP: PRODUCTION DESIGNER: C. ALINOVICH CHECKED BY:

SHEET TITLE:

DIMENSIONED CEILING PLAN

1/4" = 1'-0" SCALE: SHEET NUMBER:

I-1116.1

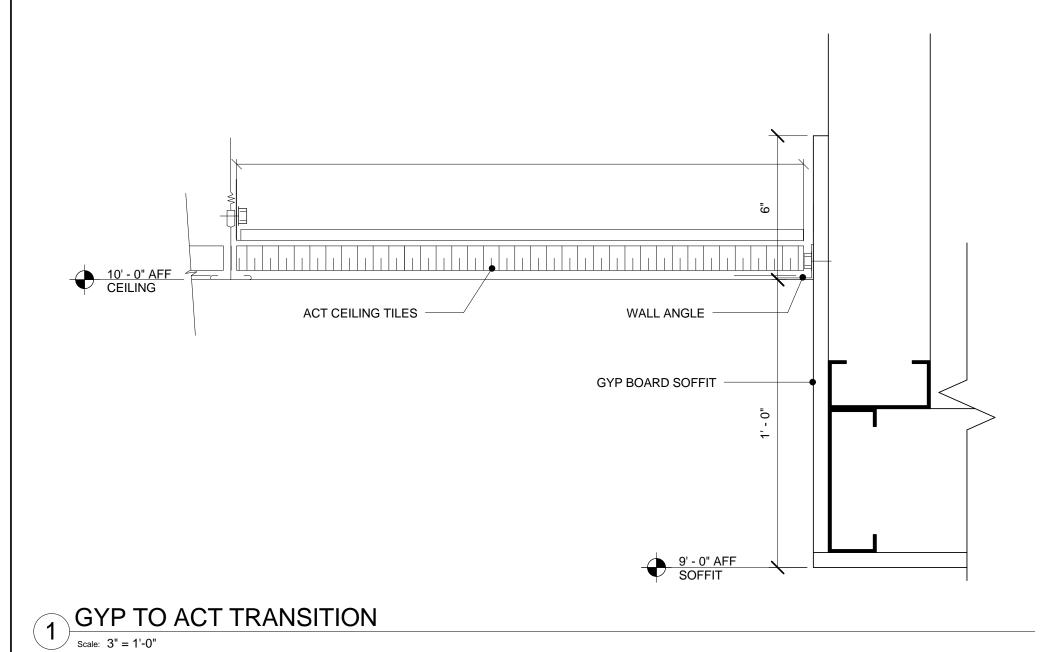


CEILING/SOFFIT SUPPORT STRUCTURE

5/8" GYP WALL BOARD

LIGHTING FIXTURE TRACK ATTACHED
TO CEILING STRUCTURE ABOVE GYP
W/#12x1 1/2" PANHEAD SH. MTL.


TRACK MOUNTED TO GYPSUM BOARD SOFFIT

Scale: 6" = 1'-0"

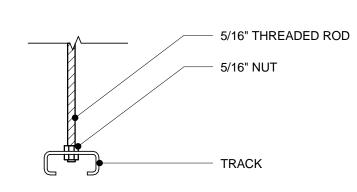



SECTION

TRACK LIGHTING - SUSPENDED MOUNT Scale: 3" = 1'-0"

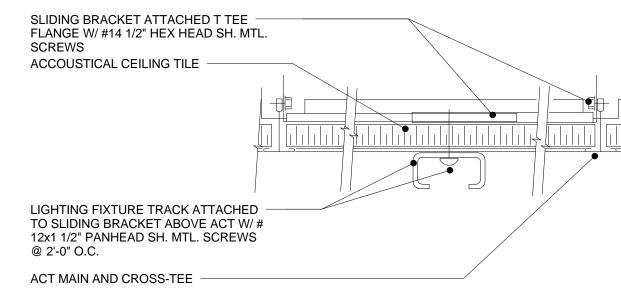

<u></u>	TRACK	MOUNTING	TO ACT
$\langle 0 \rangle$	0" 41 0"		

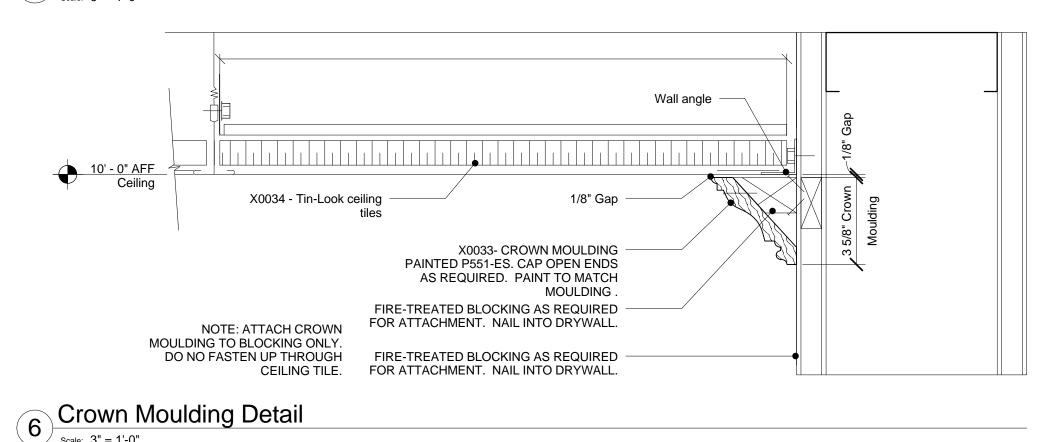

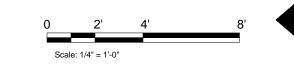



THESE DRAWINGS AND SPECIFICATIONS ARE CONFIDENTIAL AND SHALL REMAIN THE SOLE PROPERTY OF STARBUCKS CORPORATION, WHICH IS THE OWNER OF THE COPYRIGHT IN THIS WORK. THEY SHALL NOT BE REPRODUCED (IN WHOLE OR IN PART), SHARED WITH THIRD PARTIES OR USED IN ANY MANNER ON OTHER PROJECTS OR EXTENSIONS TO THIS PROJECT WITHOUT THE PRIOR WRITTEN CONSENT OF STARBUCKS CORPORATION. THESE DRAWINGS AND SPECIFICATIONS ARE INTENDED TO EXPRESS DESIGN INTENT FOR A PROTOTYPICAL STARBUCKS STORE (WHICH IS SUBJECT TO CHANGE AT ANYTIME) AND DO NOT REFLECT ACTUAL SITE CONDITIONS. NEITHER PARTY SHALL HAVE ANY OBLIGATION NOR LIABILITY TO THE OTHER (EXCEPT STATED ABOVE)

ARCHITECT OF RECORD

UNTIL A WRITTEN AGREEMENT IS FULLY EXECUTED BY BOTH PARTIES.

ARCHITECTS PLANNERS
325 N. LaSalle St. |Suite 700 |Chicago, IL 60654 t 312.424.2400 | f 312.424.2424 | www.norr.com



Revision Schedule			
Rev	Date	Ву	Description

SADY & FARWELL

SADY & FARWELL

JECT ADDRESS:

7 N. FARWELL STREET

WAUKEE, WI 53202

WAUKEE COUNTY

l		
	STORE #:	2305
	PROJECT #:	04217-001
l	CONCEPT:	MCS
l	PALETTE:	HERITAGE
	ISSUE DATE:	12 09 13
	DESIGN MANAGER:	S. RYCHLIK
	LEED® AP:	N/A
	PRODUCTION DESIGNER:	C. ALINOVICH
	CHECKED BY:	K. GORIN


SHEET TITLE:


REFLECTED CEILING
PLAN SCHEDULES &

SCALE: DETAILS

SHEET NUMBER:

I-1116.2

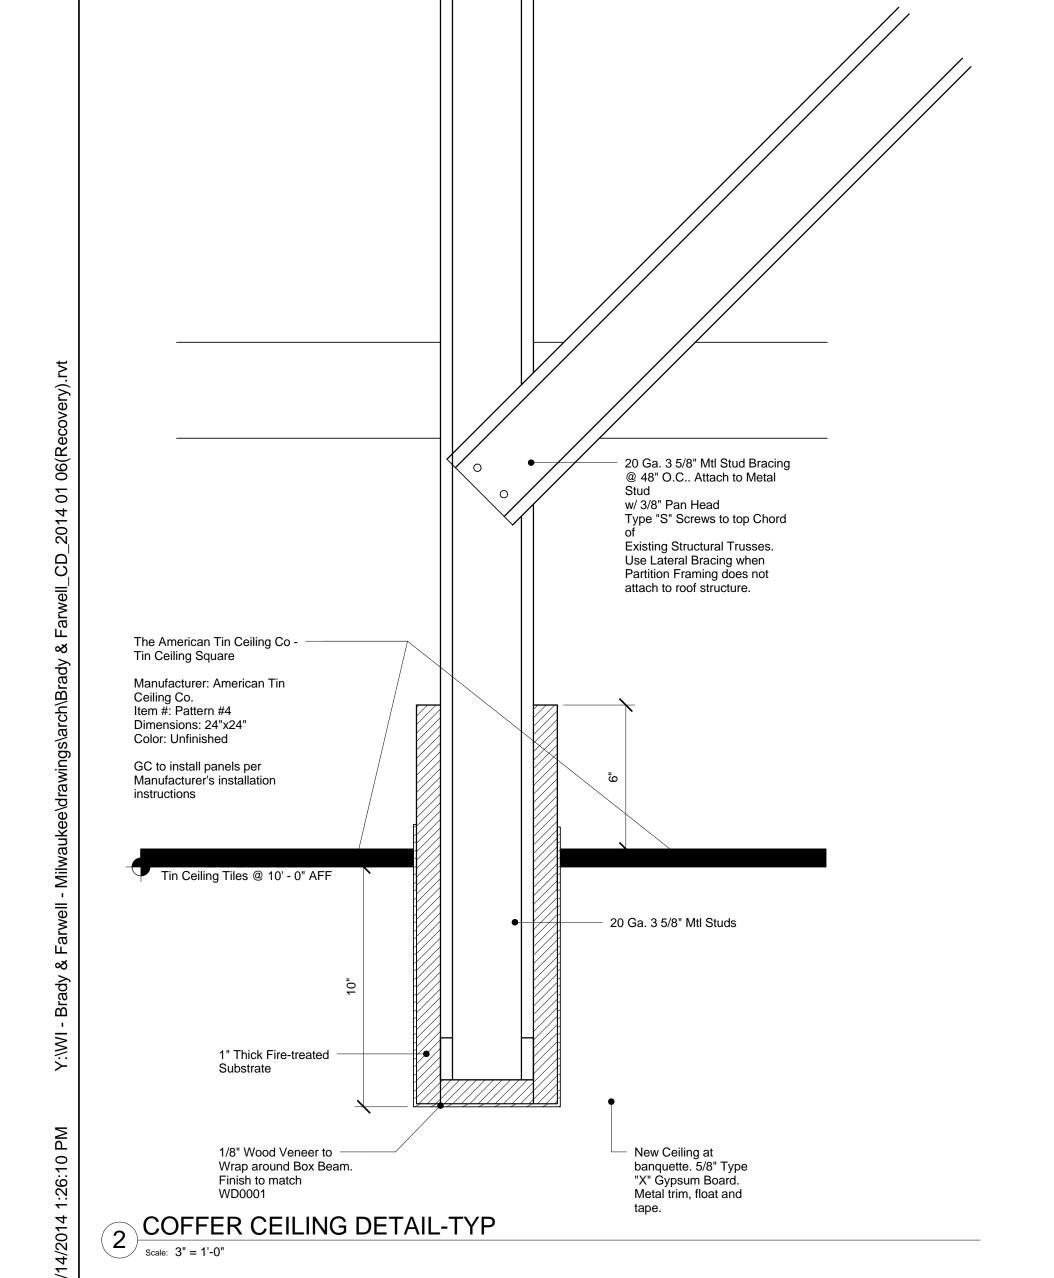

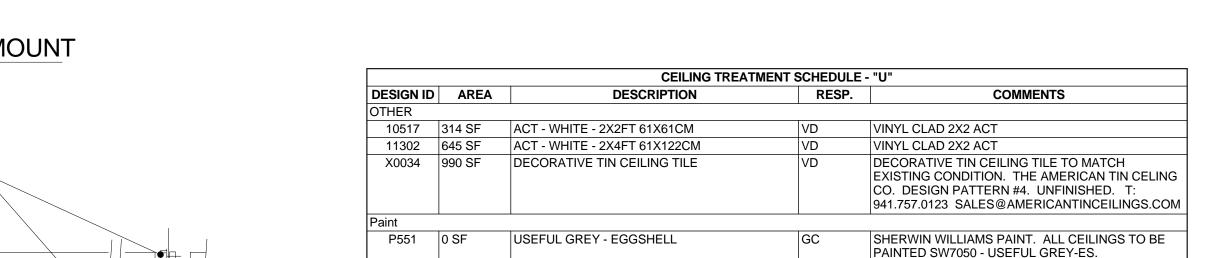

DESIGN ID COUNT

11611

11649

12866

12890

12894

12903

12906

X0032

12331

PENDANT

12269

12348

X0031

RECESSED CAN

12861

12869

12907

13241

SCONCE

11879

X0002

12552

11427

12934

12935

TROFFER 11404

OTHER

LIGHTING FIXTURE SCHEDULE - "L"

RESP.

BULB

LED 5W LOW ENERGY OR

LED 5W LOW ENERGY OR

CFL 9W SELF-BALLAST DECORATIVE OR EQUAL

LED 5W LOW ENERGY OR

(1) 12885 - CFL G30 10-29W

(1) 12894 - INCAND T9 EDISON

(1) 12905 - LED PAR 20 1-9W PROVIDED BY CED

(1) 12866 - FL T5 10-19W 22IN FSG

(1) 12885 - CFL G30 10-19W

(6) INTEGRAL LED 1W

(3) 12890 - FL T8 20-29W

EQUAL

EQUAL

100W MAX

EQUAL

30-39W

(1) X0032

(550MM)

NARROW FLOOD

COMMENTS

PROVIDED BY CED. TO BE USED

PROVIDED BY CED. USE WITH DID

THURMAN FLUSH CEILING FIXTURE.

POLISHED NICKEL FINISH. ITEM

REJUVENATION. T: 888.401.1900. TRADESALES@REJUVENAION.COM

#A5162 W/FLARED 12" SCHOOLHOUSE SHADE.

PROVIDED BY CED

HARDWARE.

PROVIDED BY CED

FIXTURE BY RESTORATION

JUMPER CORD REQUIRED WHEN

CONNECTING MULTIPLE UNITS

WITH DID 11879

PROVIDED BY CED

USE WITH DID X0002

USE WITH ID X0031

DESCRIPTION

EMERGENCY LIGHT DOUBLE - BLACK

EMERGENCY LIGHT DOUBLE - WHITE

12 INCAND EDISON T9 30W BEACON FILAMENT

FLOOR LAMP PHARMACY - BRONZE DARK

PENDANT - SMALL SCHOOLHOUSE - MILK

PENDANT - SMALL METAL MESH CYLINDER -

CAN - RECESSED HOUSING ADJUSTABLE - 4IN | VD

CAN - RECESSED INTEGRATED LED HOUSING - VD

CAN - RECESSED TRIM ADJUSTABLE GIMBAL VD

SCONCE - RESTROOM VANITY BOWED - SATIN | VD

18 CAN - RECESSED TRIM BAFFLE - 5IN 125MM - VD

SCONCE - ANTIQUE GLASS SHADE - MILK

12 TASK LIGHT INTEGRATED LED - 22IN 560MM - VD

TRACK - FIXTURE ENCLOSED - 5IN 125MM -

TRACK - WITH CONNECTORS - 4FT 122CM -

TRACK - WITH CONNECTORS - 8FT 244CM -

TROFFER - RECESSED - 48X24IN 1220X610MM - VD

5IN 125MM - 600LM NEW CEILING

RING - 4IN 100MM - WHITE

NICKEL

WHITE

GLASS GL0001

EMERGENCY EXIT LIGHT - WHITE

2 FL T5 10-19W - 22IN 550MM

12 FL T8 20-29W - 48IN 1220MM

19 LED PAR 30S 10-19W NFL

4 CFL SP 20-29W

6 40W EDISON BULB

10 100W INCANDESCENT

PATINA MT0005

GLASS GL0001

MILK GLASS GL0001

100MM - NEW CEILING

BLACKENED STEEL MT0019

10 FLUSH PENDANT - SMALL SCHOOLHOUSE -

2 LED PAR 20 1-9W NFL - WHITE

\-1117.1

B 13101

Q X0038

FLOOR FINISH PLAN NOTES

A. STARBUCKS TO SUPPLY RETAIL FLOOR TILE AND TILE BASE, GENERAL CONTRACTOR TO INSTALL, GENERAL CONTRACTOR TO SUPPLY WORKROOM TILE AND BASE AND INSTALL. GENERAL CONTRACTOR TO SUPPLY AND INSTALL MORTAR, ADHESIVE, AND GROUT. GENERAL CONTRACTOR TO INSPECT ALL TILES AND REJECT DAMAGED OR SUBSTANDARD TILES PRIOR TO INSTALLATION.

B. ALL TILE AND SLATE TO BE INSTALLED PER TILE COUNCIL OF AMERICA STANDARDS.

C. ALL FLOORING AND BASE MATERIAL TO BE INSTALLED ACCORDING TO STARBUCKS SPECIFICATIONS.

D. CABINET BASES TO BE SET AFTER TILE INSTALLATION.

E. ALIGN TILE TRANSITIONS ON WHOLE TILES AS SHOWN.

F. FOR CARPET INSTALLATION, REFER TO MANUFACTURERS' INSTALLATION INSTRUCTIONS.

SHEET NOTES

1. TILE START POINT.

TILE BASE

B 11284

—|T|11449 | |B|11284 |

2. FLOOR SINK/FLOOR DRAIN LOCATION.

3. PASTRY CASE FOOTPRINT.

4. INSTALL FLOOR TILE AND BASE AT CAFE AS INDICATED.

5. INSTALL WALK-OFF MAT AT ENTRY AS INDICATED. INSTALL FLUSH WITH TILE PER MANUFACTURER'S SPECIFICATIONS.

6. INSTALL NEW TERAZZO FLOOR TO MATCH EXISTING TERAZZO. INSTALL AND SEAL PER MANUFACTURER'S INSTALLATION INSTRUCTIONS.


7. EXISTING TERAZZO FLOORING. POLISH AND REPAIR EXISTING TERAZZO AS NECESSARY.

8. EXISTING RAMP TO REMAIN IN REFERENCE TO IBC, CHAPTER 34 EXISTING STRUCTURES, SECTION 3402. TECHNICALLY INFEASIBLE. SECTION 3402 STATES AN ALTERATION OF A BUILDING OR A FACILITY THAT HAS LITTLE LIKELIHOOD OF BEING ACCOMPLISHED BECAUSE THE EXISTING STRUCTURAL CONDITIONS REQUIRE THE REMOVAL OR ALTERATION OF A LOAD-BEARING MEMBER THAT IS AN ESSENTIAL PART OF THE STRUCTURAL FRAME, OR BECAUSE OTHER EXISTING PHYSICAL OR SITE CONSTRAINTS PROHIBIT MODIFICATION OR ADDITION OF ELEMENTS, SPACES, OR FEATURES WHICH ARE IN FULL AND STRUCT COMPLIANCE WITH THE MINIMUM REQUIREMENTS FOR NEW CONSTRUCTION AND WHICH ARE NECESSARY TO PROVIDE ACCESSIBILITY.


FLOOR FINISH LEGEND

CAFE NEW TERRAZO TO MATCH EXISTING CONDITION

CAFE EXISTING TERRAZO:

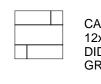

CAFE, RESTROOM, BACKBAR TILE: 12x24 GRAPHITE FLOOR TILE -DID 12203 GROUT: MAPEI - 10 BLACK

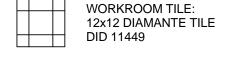


WALK-OFF MAT AT ENTRY

DID 12231



EXTERIOR 1x1 MOSAIC TILE AT ENTRY: PORCELANOSA QUATTRO AVENUE BLACK

 - - - - 6x12 GRAPHITE BASE TILE - CAFE, RESTROOMS, BACKBAR DID 13101, GROUT: MAPEI - 10 BLACK — - - - - 6x12 BIANO ALPI BASE TILE - WORKROOM DID 11284

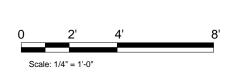





STARBUCKS COFFEE **COMPANY** 2401 UTAH AVENUE SOUTH

SEATTLE, WASHINGTON 98134

(206) 318-1575 THESE DRAWINGS AND SPECIFICATIONS ARE CONFIDENTIAL AND SHALL REMAIN THE SOLE PROPERTY OF STARBUCKS CORPORATION, WHICH IS THE OWNER OF THE COPYRIGHT IN THIS WORK. THEY SHALL NOT BE REPRODUCED (IN WHOLE OR IN PART), SHARED WITH THIRD PARTIES OR USED IN ANY MANNER ON OTHER PROJECTS OR EXTENSIONS TO THIS PROJECT WITHOUT THE PRIOR WRITTEN CONSENT OF STARBUCKS CORPORATION. THESE DRAWINGS AND SPECIFICATIONS ARE INTENDED TO EXPRESS DESIGN INTENT FOR A PROTOTYPICAL STARBUCKS STORE (WHICH IS SUBJECT TO CHANGE AT ANYTIME) AND DO NOT REFLECT ACTUAL SITE CONDITIONS. NEITHER PARTY SHALL HAVE ANY OBLIGATION NOR LIABILITY TO THE OTHER (EXCEPT STATED ABOVE) UNTIL A WRITTEN AGREEMENT IS FULLY EXECUTED BY BOTH PARTIES.

ARCHITECT OF RECORD





Engineering Consultants Mechanical - Electrical - Plumbing

Revision Schedule

FARWELL

STORE #: 2305 PROJECT #: 04217-001 CONCEPT: MCS PALETTE: HERITAGE ISSUE DATE: 12 09 13 DESIGN MANAGER: S. RYCHLIK LEED® AP: N/A

PRODUCTION DESIGNER: C. ALINOVICH

CHECKED BY: SHEET TITLE:

SHEET NUMBER:

FLOOR FINISH PLAN

K. GORIN


1/4" = 1'-0"

SCALE:


I-1117

FLOOR FINISH PLAN

Scale: 1/4" - 1' O"

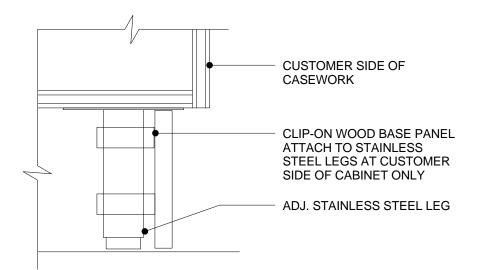


CLIP-ON TOE KICK AT POS Scale: 3" = 1'-0"

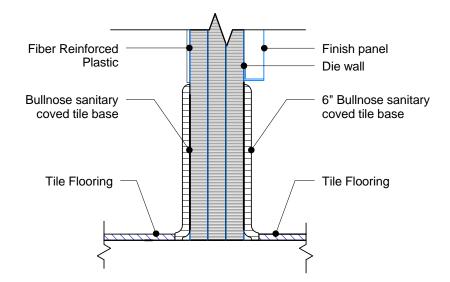


TILE BASE AT DIE WALL


Scale: 3" = 1'-0"

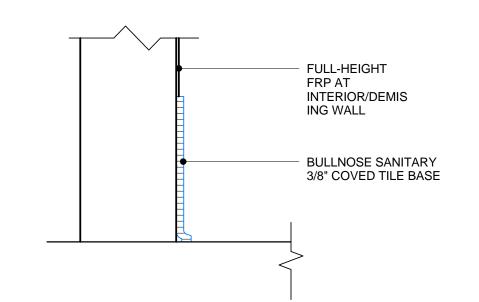


8 TILE BASE AT WORKROOM WALL


Scale: 3" = 1'-0"

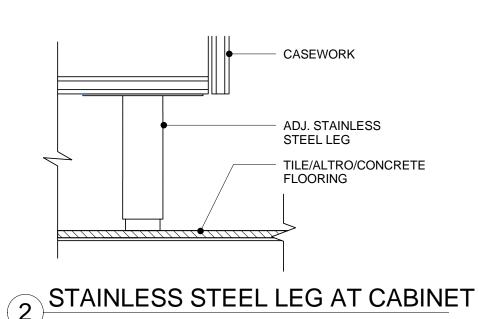

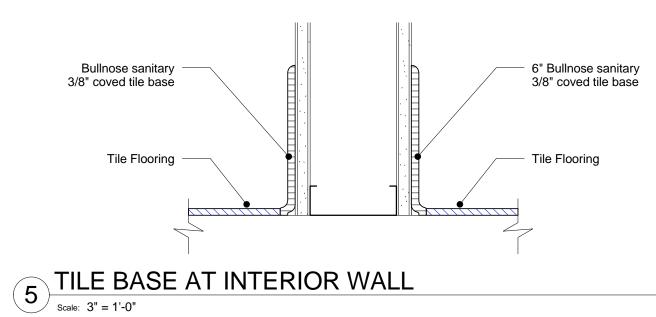

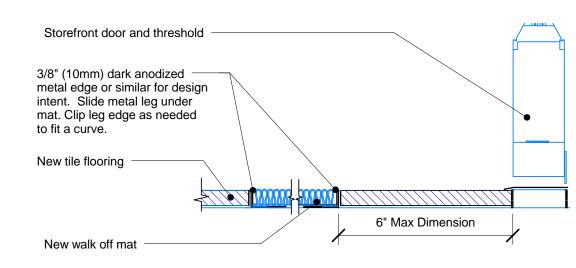


TRANSITION - TILE TO WALK-OFF MAT

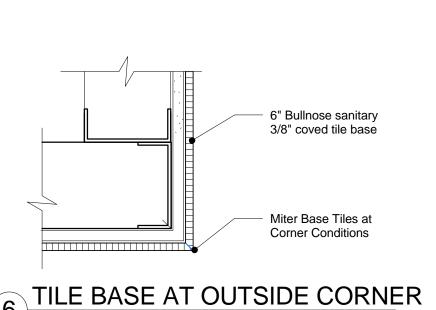

6 TILE BASE AT OUTSIDE CORNER

Scale: 3" = 1'-0"

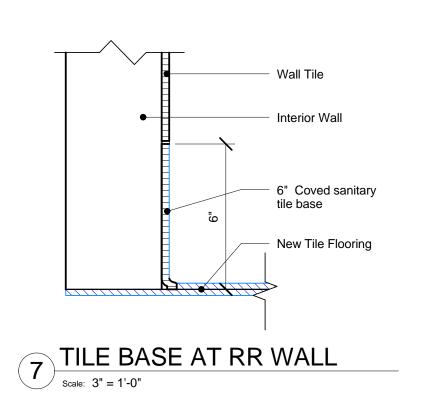



STARBUCKS COFFEE COMPANY

2401 UTAH AVENUE SOUTH SEATTLE, WASHINGTON 98134 (206) 318-1575

THESE DRAWINGS AND SPECIFICATIONS ARE CONFIDENTIAL AND SHALL REMAIN THE SOLE PROPERTY OF STARBUCKS CORPORATION, WHICH IS THE OWNER OF THE COPYRIGHT IN THIS WORK. THEY SHALL NOT BE REPRODUCED (IN WHOLE OR IN PART), SHARED WITH THIRD PARTIES OR USED IN ANY MANNER ON OTHER PROJECTS OR EXTENSIONS TO THIS PROJECT WITHOUT THE PRIOR WRITTEN CONSENT OF STARBUCKS CORPORATION. THESE DRAWINGS AND SPECIFICATIONS ARE INTENDED TO EXPRESS DESIGN INTENT FOR A PROTOTYPICAL STARBUCKS STORE (WHICH IS SUBJECT TO CHANGE AT ANYTIME) AND DO NOT REFLECT ACTUAL SITE CONDITIONS. NEITHER PARTY SHALL HAVE ANY OBLIGATION NOR LIABILITY TO THE OTHER (EXCEPT STATED ABOVE) UNTIL A WRITTEN AGREEMENT IS FULLY EXECUTED BY BOTH PARTIES.

ARCHITECT OF RECORD





Revision Schedule					
Rev	Date	Ву	Description		

& FARWELL


STORE #:	2305
PROJECT #:	04217-001
CONCEPT:	MCS
PALETTE:	HERITAGE
ISSUE DATE:	12 09 13
DESIGN MANAGER:	S. RYCHLIK
LEED® AP:	N/A
PRODUCTION DESIGNER:	C. ALINOVICH
CHECKED BY:	K. GORIN

FLOOR FINISH **SCHEDULES & DETAILS** 3" = 1'-0"

SHEET NUMBER:

I-1117.1

WALL FINISH PLAN

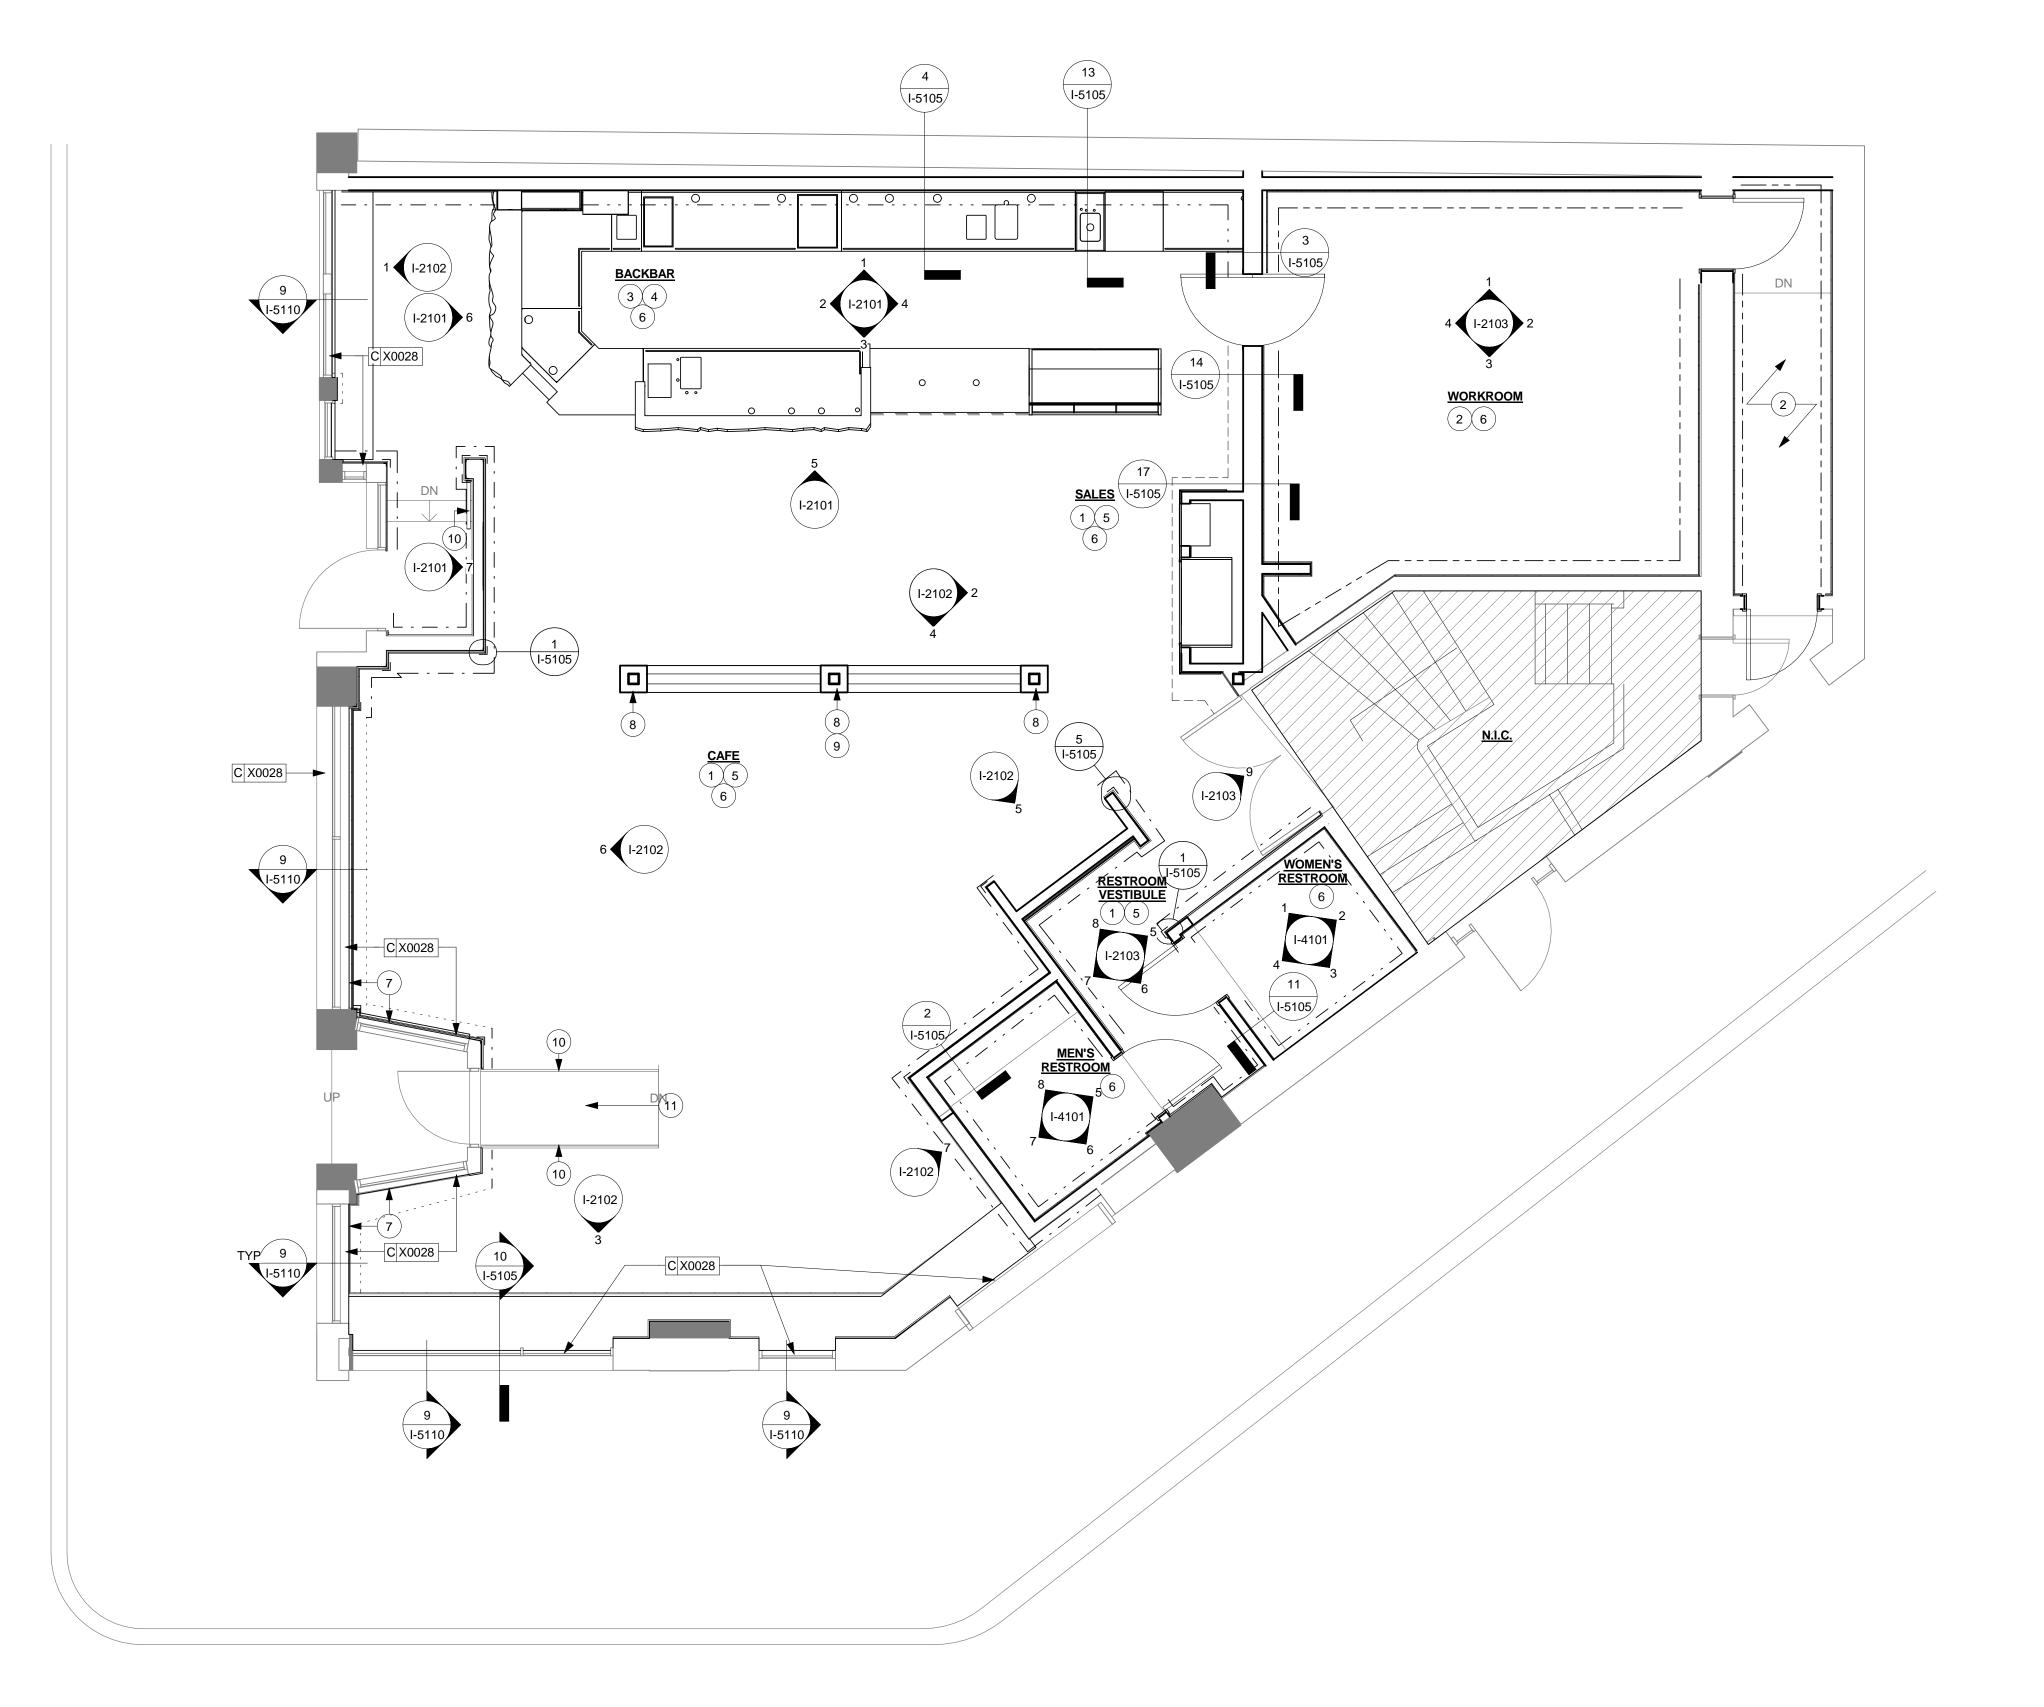

WALL FINISH PLAN NOTES

B. INSTALL CLEAR CORNER GUARDS AS INDICATED. MOUNT AT 6" (150MM) AFF. BACK-PAINT WITH CORRESPONDING WALL COLOR. ADHERE WITH CLEAR SILICONE ADHESIVE AND #6 STAINLESS STEEL OVAL HEAD SCREWS 3" (75MM) FROM ENDS, 12" (305MM) ON CENTER. OFFSET SCREWS ON EITHER SIDE BY 1/2" (10MM) VERTICALLY. CUT CORNER GUARDS TO FIT BELOW CHAIR RAIL AT APPLICABLE LOCATIONS. DO NOT INSTALL CORNER GUARDS ABOVE CHAIR RAIL.

HEAD SCREWS 3" (75MM) FROM ENDS, 12" (305MM) ON CENTER OFFSET SCREWS ON EITHER SIDE BY 1/2" (10MM) VERTICALLY. TO BE INSTALLED IN BACK OF HOUSE ONLY.

LOCATIONS.

SHEET NOTES

1. INSTALL VINYL WAINSCOT AS INDICATED. SEE INTERIOR ELEVATIONS FOR INSTALLATION HEIGHT.

2. INSTALL FULL HEIGHT FRP AT WORKROOM WALLS AS INDICATED.

5. INSTALL HOT-ROLLED CORNER GUARDS AS INDICATED.

6. PROVIDE FIRE TREATED BLOCKING AS REQUIRED TO SUPPORT ANY WALL ATTACHEMTNS.

WHERE INDICATED.

8. PAINT COLUMNS P551-ES AT BANQUETTE AS INDICATED.

9. EXPOSED CONDUIT TO BE PAINTED P551-ES TO MATCH

10. PAINT HAND RAILINGS - P534 BLACK FOX.

A. WORKROOM TO BE FINISHED PER LOCAL CODE REQUIREMENTS.

C. INSTALL METAL CORNER GUARDS AS INDICATED. MOUNT AT 6" (150MM) AFF. AFFIX WITH #6 STAINLESS STEEL OVAL

D. CHANGE OF PAINT COLOR ALLOWED AT INSIDE CORNERS

E. REFER TO INTERIOR ELEVATIONS FOR GRAPHICS

F. REFER TO CASEWORK FINISH SCHEDULE FOR ADDITIONAL INFORMATION

G. GENERAL CONTRACTOR TO PROVIDE AND INSTALL WORKROOM WALL FINISHES.

3. GC TO INSTALL BACKBAR WALL TILE AS INDICATED ON INTERIOR ELEVATIONS. BACKBAR TILE TO RUN BEHIND WARMING OVEN TO TOP OF BASE TILE.

4. INSTALL FRP AT WALL BELOW BACKBAR COUNTERTOPS.

SEE INTERIOR ELEVATIONS FOR LENGTHS REQUIRED.

7. INSTALL VINYL WALL COVERING BELOW WINDOW SILLS

11. EXISTING RAMP TO REMAIN IN REFERENCE TO IBC, **CHAPTER 34 EXISTING STRUCTURES, SECTION 3402.** TECHNICALLY INFEASIBLE. SECTION 3402 STATES AN ALTERATION OF A BUILDING OR A FACILITY THAT HAS LITTLE LIKELIHOOD OF BEING ACCOMPLISHED BECAUSE THE EXISTING STRUCTURAL CONDITIONS REQUIRE THE REMOVAL OR ALTERATION OF A LOAD-BEARING MEMBER THAT IS AN ESSENTIAL PART OF THE STRUCTURAL FRAME, OR BECAUSE OTHER EXISTING PHYSICAL OR SITE CONSTRAINTS PROHIBIT MODIFICATION OR ADDITION OF ELEMENTS, SPACES, OR FEATURES WHICH ARE IN FULL AND STRUCT COMPLIANCE WITH THE MINIMUM REQUIREMENTS FOR NEW CONSTRUCTION AND WHICH ARE NECESSARY TO PROVIDE ACCESSIBILITY.

WALL TREATMENT LEGEND

---- INDICATES WOOD WALL CLADDING — - — - — INDICATES CHAIR RAIL & WAINSCOT — - - - — INDICATES BACKBAR WALL TILE —— - - — INDICATES RESTROOM WALL TILE INDICATES VINYL WALL COVERING BELOW SILLS INDICATES PAINT ONLY

INDICATES WAINSCOT VERTICAL TRIM AND/OR CORNER GUARD







PRODUCTION DESIGNER: C. ALINOVICH

2305

MCS

04217-001

HERITAGE

S. RYCHLIK

K. GORIN

12 09 13

N/A

STORE #:

CONCEPT:

PALETTE:

ISSUE DATE:

LEED® AP:

CHECKED BY:

DESIGN MANAGER:

PROJECT #:

© 2011 STARBUCKS COFFEE COMPANY

STARBUCKS COFFEE

COMPANY

2401 UTAH AVENUE SOUTH SEATTLE, WASHINGTON 98134

(206) 318-1575

THESE DRAWINGS AND SPECIFICATIONS ARE CONFIDENTIAL AND SHALL REMAIN THE SOLE PROPERTY OF STARBUCKS CORPORATION, WHICH IS THE OWNER OF THE COPYRIGHT IN THIS WORK. THEY SHALL NOT BE REPRODUCED (IN WHOLE OR IN PART), SHARED WITH THIRD PARTIES OR USED IN ANY MANNER ON OTHER PROJECTS OR EXTENSIONS TO THIS PROJECT WITHOUT THE PRIOR WRITTEN CONSENT OF STARBUCKS CORPORATION. THESE DRAWINGS AND SPECIFICATIONS ARE INTENDED TO EXPRESS DESIGN INTENT FOR A PROTOTYPICAL STARBUCKS STORE (WHICH IS SUBJECT TO CHANGE AT ANYTIME) AND DO NOT REFLECT ACTUAL SITE CONDITIONS. NEITHER PARTY SHALL HAVE ANY OBLIGATION NOR LIABILITY TO THE OTHER (EXCEPT STATED ABOVE) UNTIL A WRITTEN AGREEMENT IS FULLY EXECUTED BY BOTH PARTIES.

ARCHITECT OF RECORD

325 N. LaSalle St. |Suite 700 |Chicago, IL 60654

ENGINEER OF RECORD

Engineering Consultants Mechanical - Electrical - Plumbing

Revision Schedule

Description


St. Louis, Missouri 63119

Phone (314) 772-1782

Fax (314) 373-3514

t 312.424.2400 | f 312.424.2424 | www.norr.com

SCALE: 1/4" = 1'-0" SHEET NUMBER:

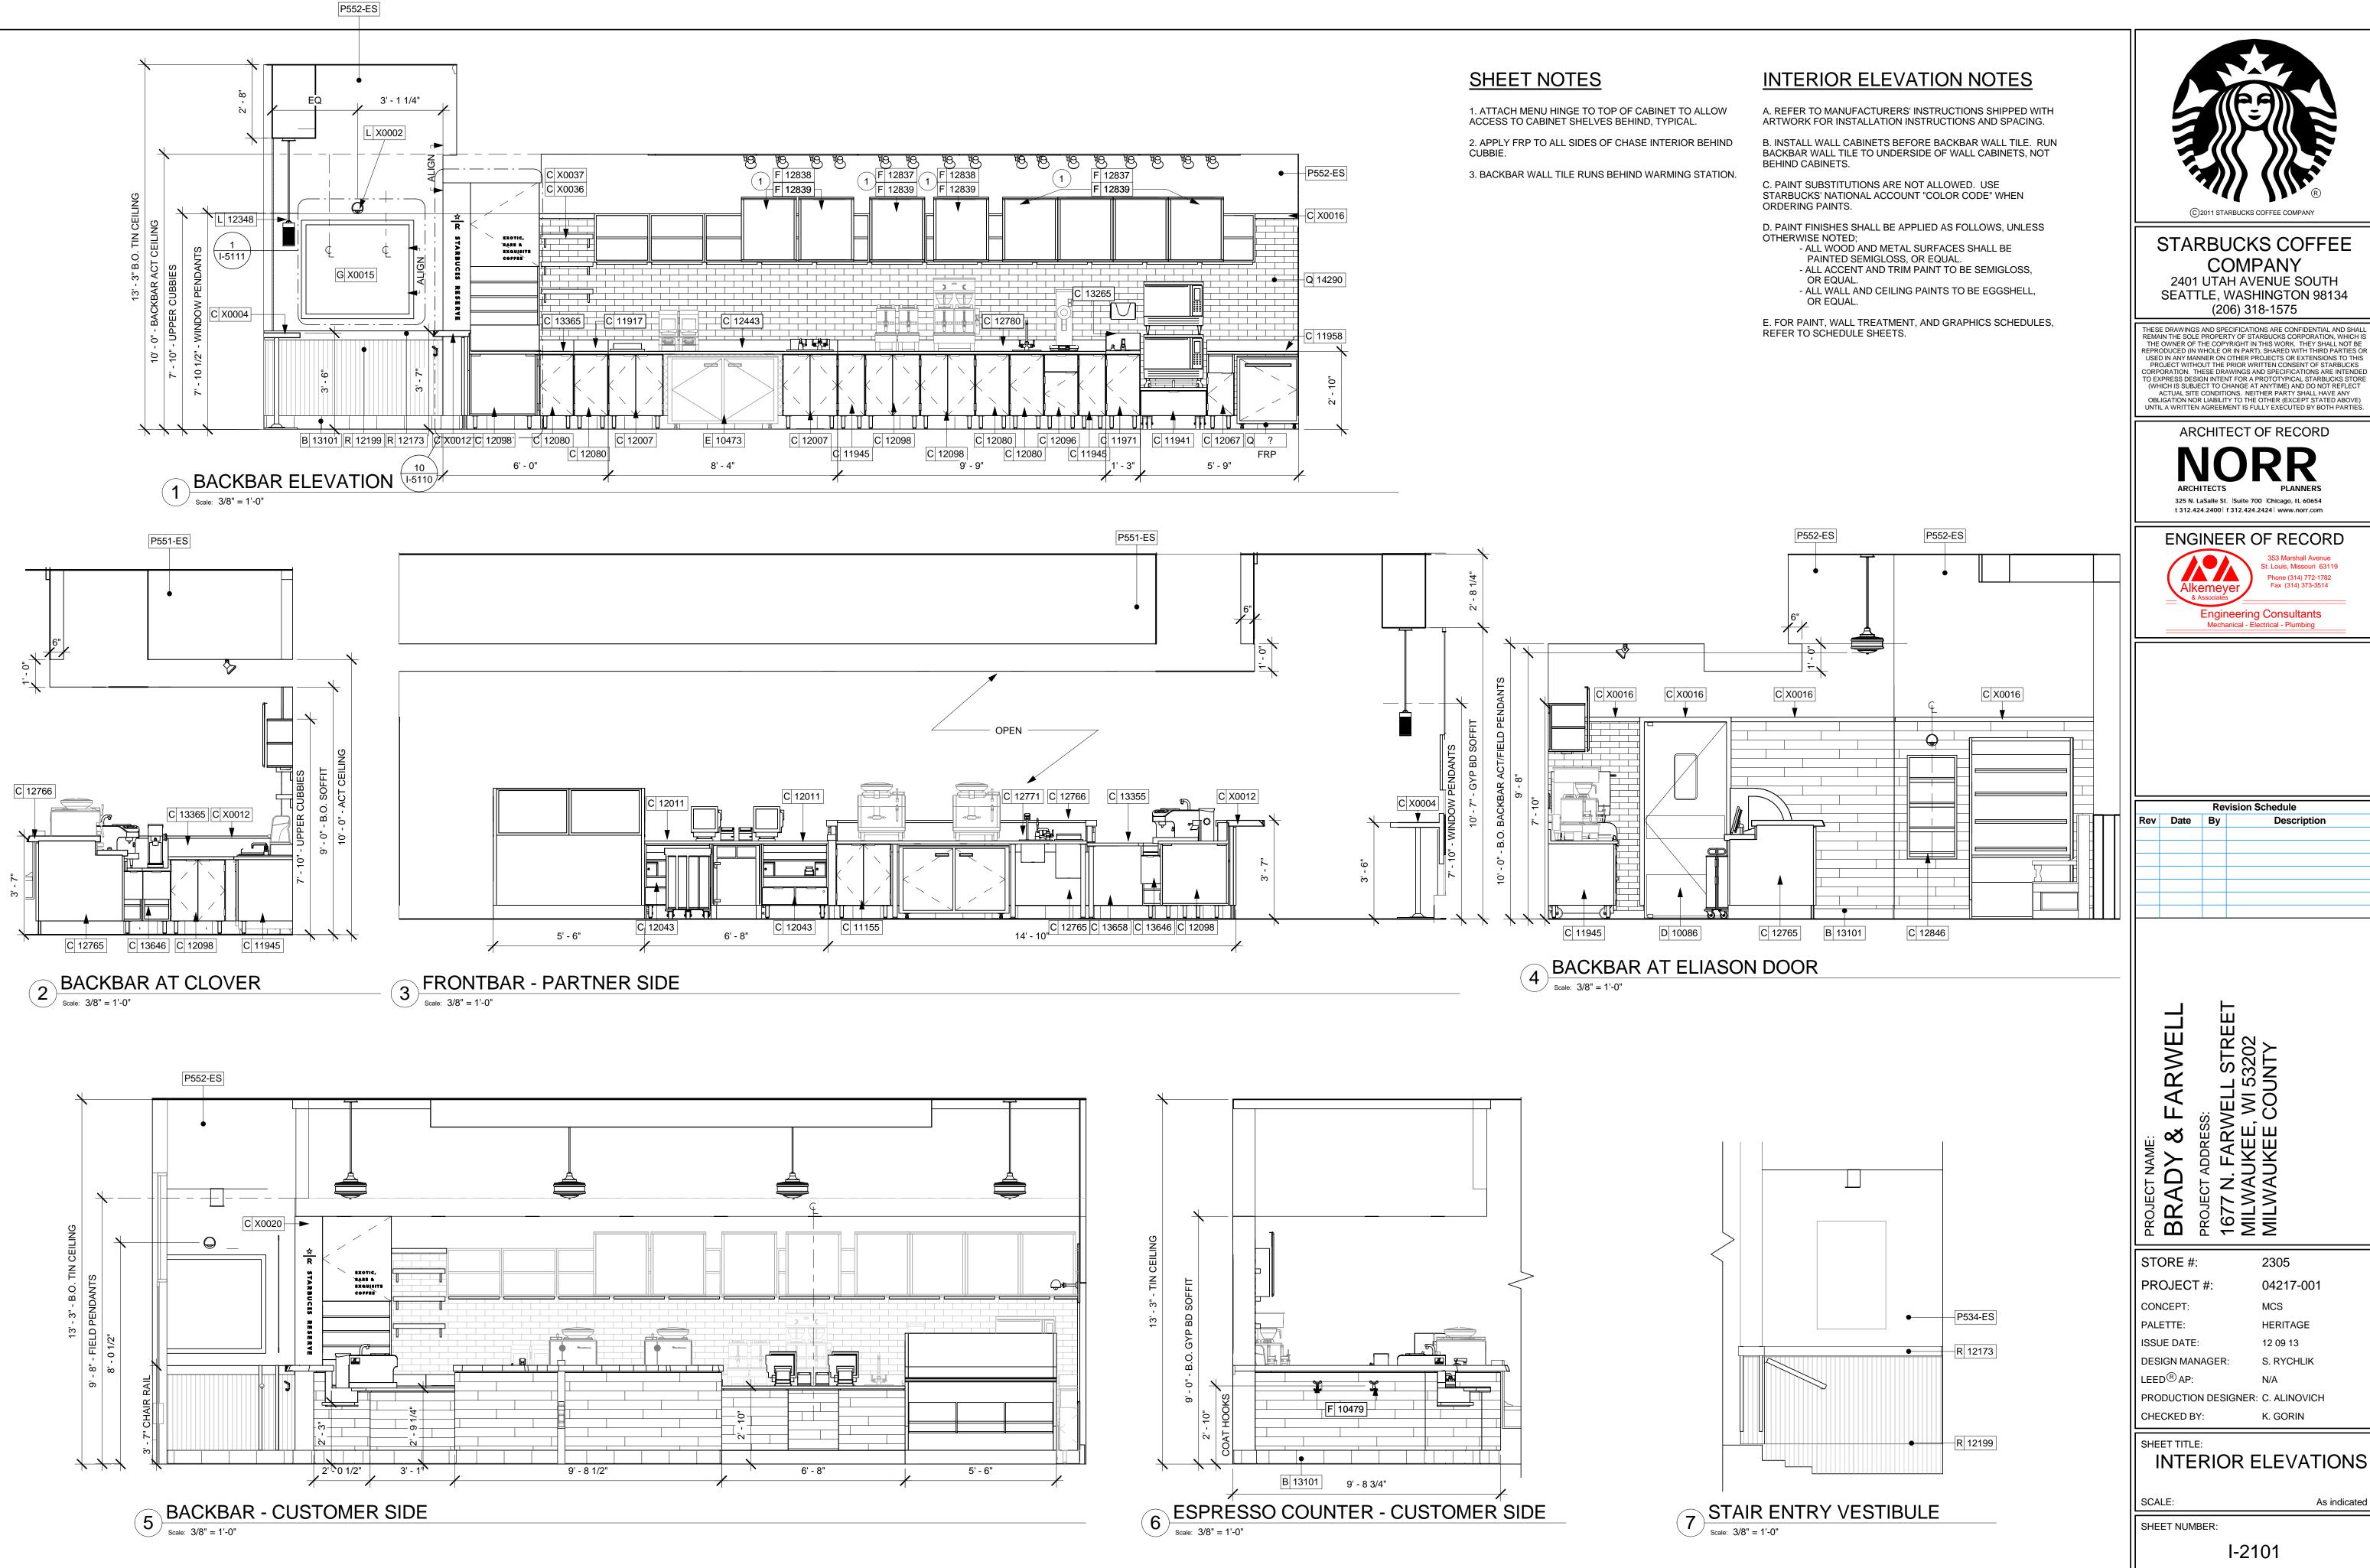

FARWELL

STORE #: 2305 PROJECT #: 04217-001 CONCEPT: MCS PALETTE: HERITAGE ISSUE DATE: DESIGN MANAGER: S. RYCHLIK LEED $^{ extsf{R}}$ AP: PRODUCTION DESIGNER: C. ALINOVICH K. GORIN

©2011 STARBUCKS COFFEE COMPANY

COMPANY

2401 UTAH AVENUE SOUTH

(206) 318-1575

ARCHITECT OF RECORD

325 N. LaSalle St. |Suite 700 |Chicago, IL 60654 t 312.424.2400 | f 312.424.2424 | www.norr.com

ENGINEER OF RECORD

Engineering Consultants Mechanical - Electrical - Plumbing


Revision Schedule

St. Louis, Missouri 63119 Phone (314) 772-1782 Fax (314) 373-3514

SHEET TITLE:

INTERIOR ELEVATIONS

SCALE: As indicated

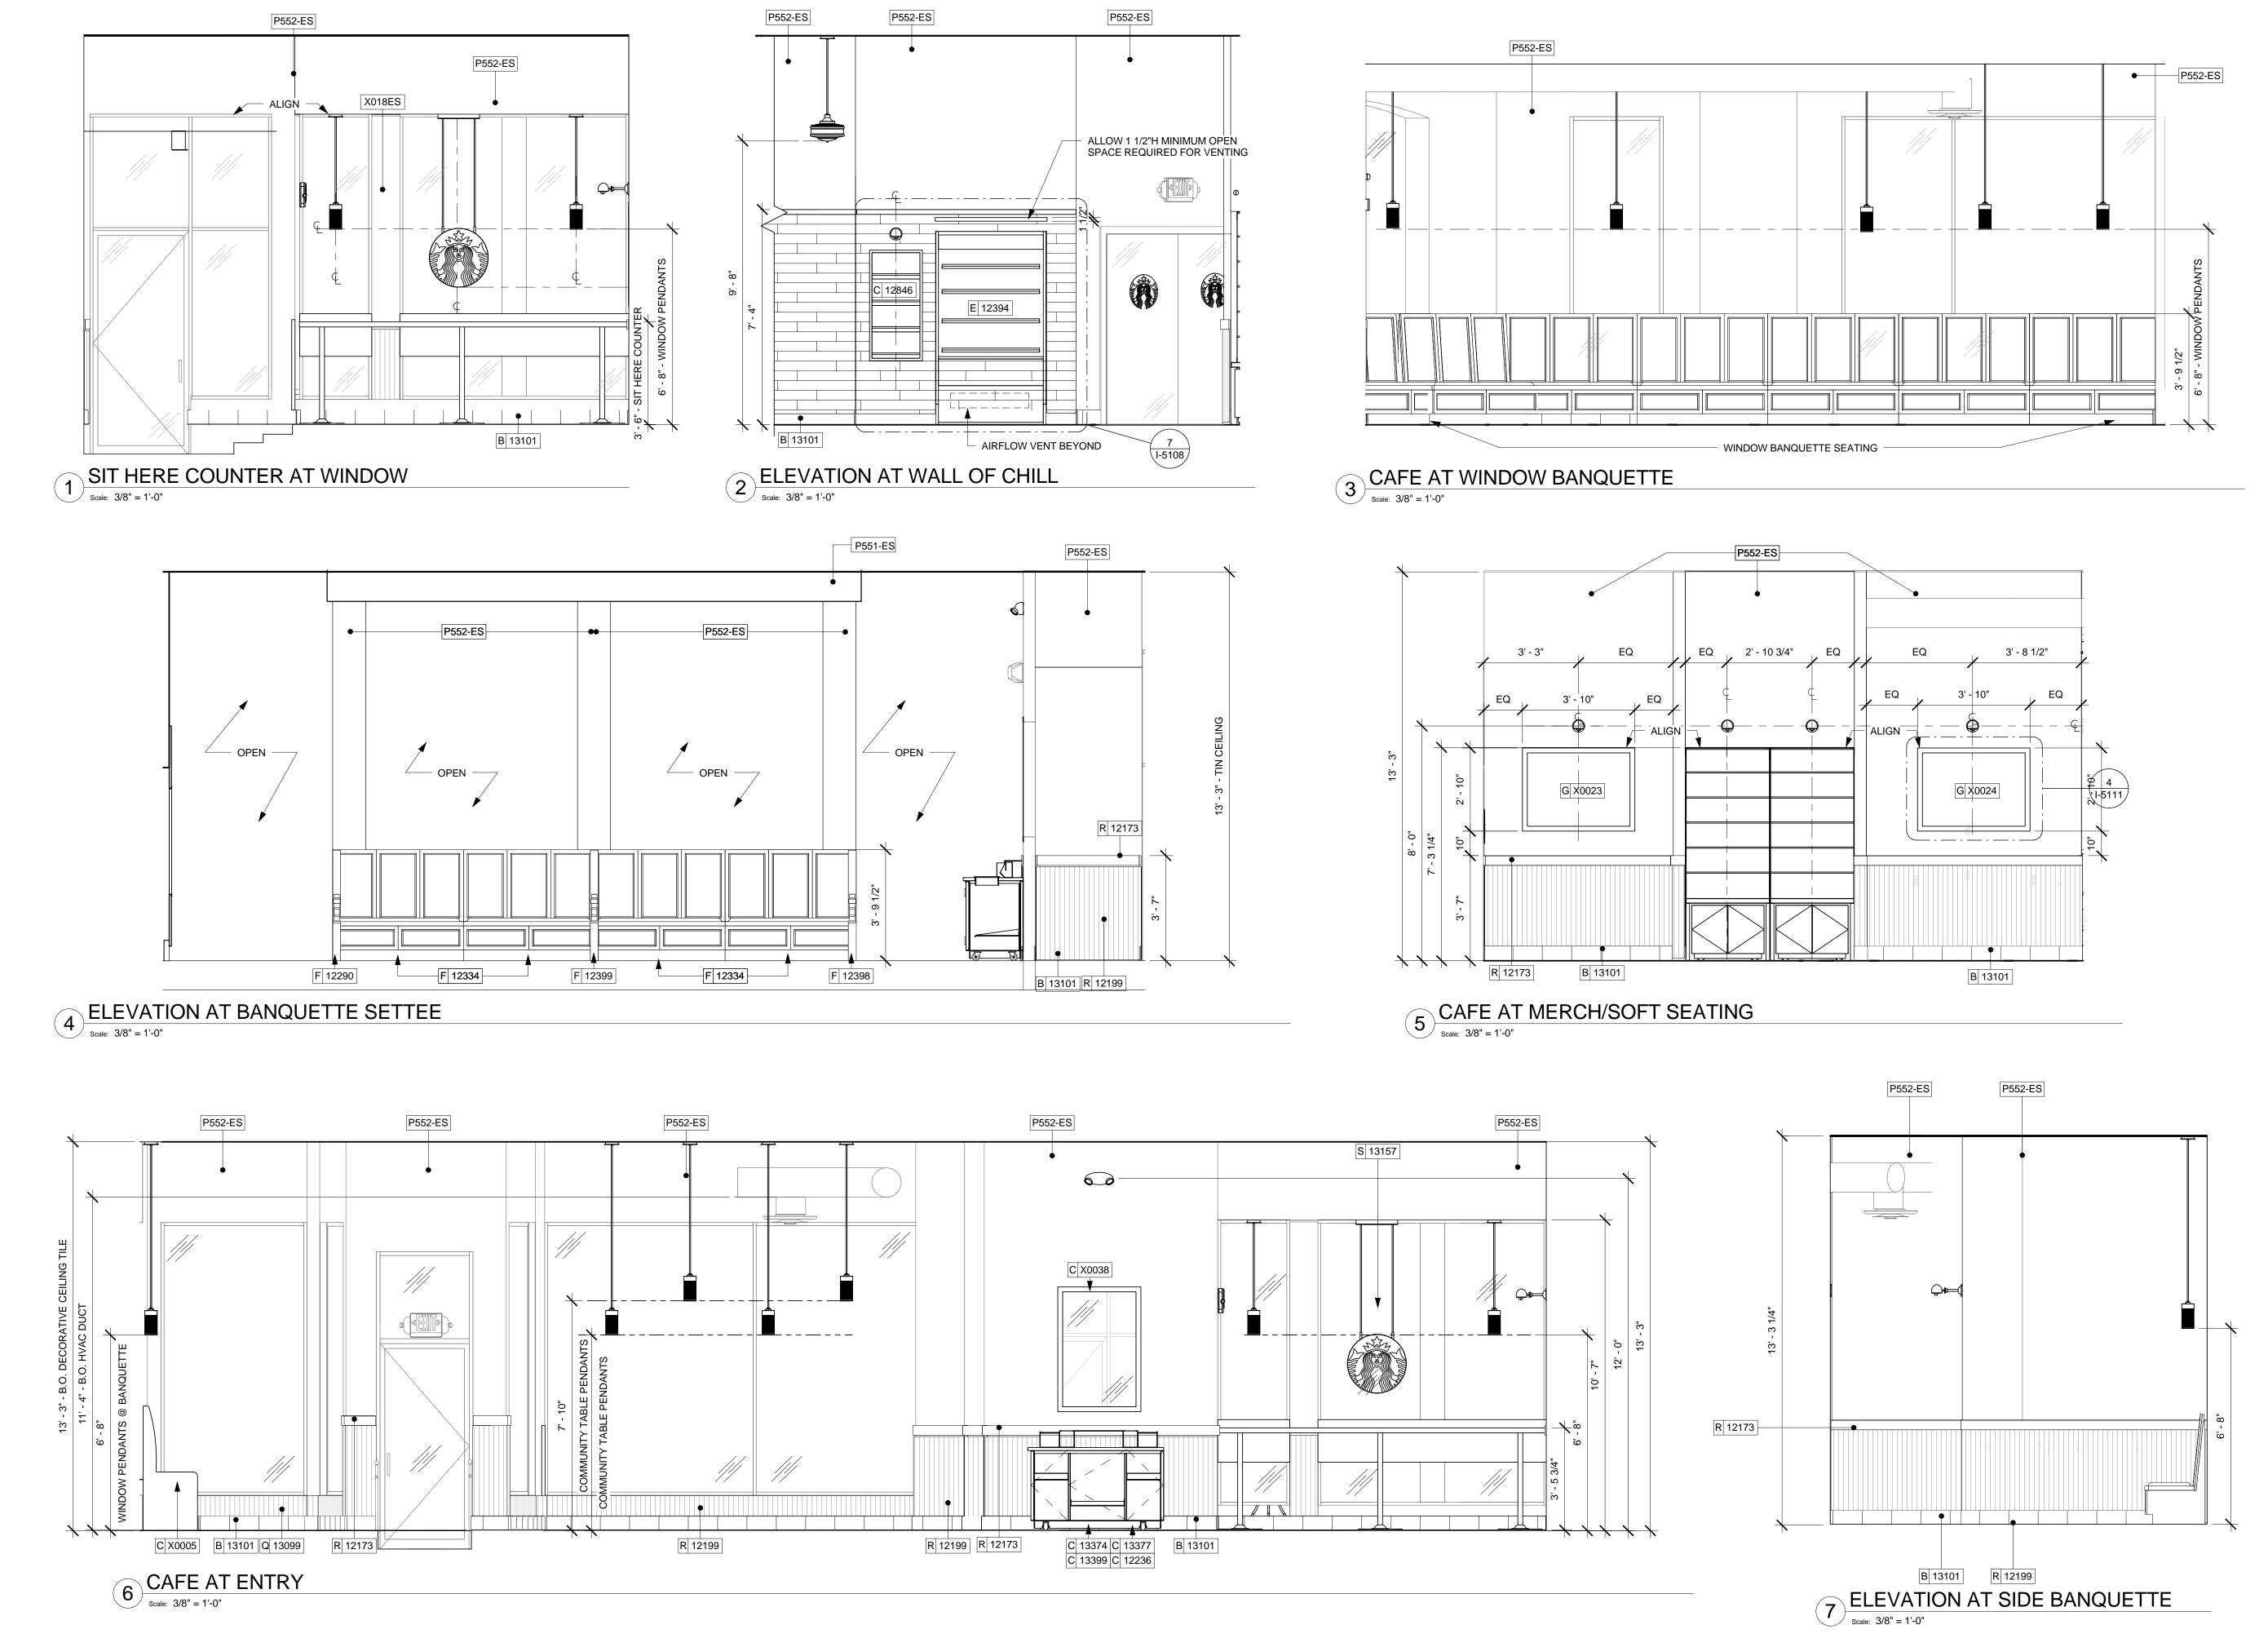



STARBUCKS COFFEE COMPANY

2401 UTAH AVENUE SOUTH SEATTLE, WASHINGTON 98134 (206) 318-1575

THESE DRAWINGS AND SPECIFICATIONS ARE CONFIDENTIAL AND SHALL REMAIN THE SOLE PROPERTY OF STARBUCKS CORPORATION, WHICH IS THE OWNER OF THE COPYRIGHT IN THIS WORK. THEY SHALL NOT BE REPRODUCED (IN WHOLE OR IN PART), SHARED WITH THIRD PARTIES OR USED IN ANY MANNER ON OTHER PROJECTS OR EXTENSIONS TO THIS PROJECT WITHOUT THE PRIOR WRITTEN CONSENT OF STARBUCKS CORPORATION. THESE DRAWINGS AND SPECIFICATIONS ARE INTENDED TO EXPRESS DESIGN INTENT FOR A PROTOTYPICAL STARBUCKS STORE (WHICH IS SUBJECT TO CHANGE AT ANYTIME) AND DO NOT REFLECT ACTUAL SITE CONDITIONS. NEITHER PARTY SHALL HAVE ANY OBLIGATION NOR LIABILITY TO THE OTHER (EXCEPT STATED ABOVE) UNTIL A WRITTEN AGREEMENT IS FULLY EXECUTED BY BOTH PARTIES.

ARCHITECT OF RECORD

St. Louis, Missouri 63119
Phone (314) 772-1782
Fax (314) 373-3514

Engineering Consultants
Mechanical - Electrical - Plumbing

Revision Schedule
Rev Date By Description

WELL
TREET
202
TY

RADY & FARWELL

RADY & FARWELL

NECT ADDRESS:

TO N. FARWELL STREET

WAUKEE, WI 53202

STORE #: 2305

PROJECT #: 04217-001

CONCEPT: MCS

PALETTE: HERITAGE

ISSUE DATE: 12 09 13

DESIGN MANAGER: S. RYCHLIK

LEED® AP: N/A

PRODUCTION DESIGNER: C. ALINOVICH

SHEET TITLE:


CHECKED BY:


INTERIOR ELEVATIONS


K. GORIN

3/8" = 1'-0"

SCALE:
SHEET NUMBER:

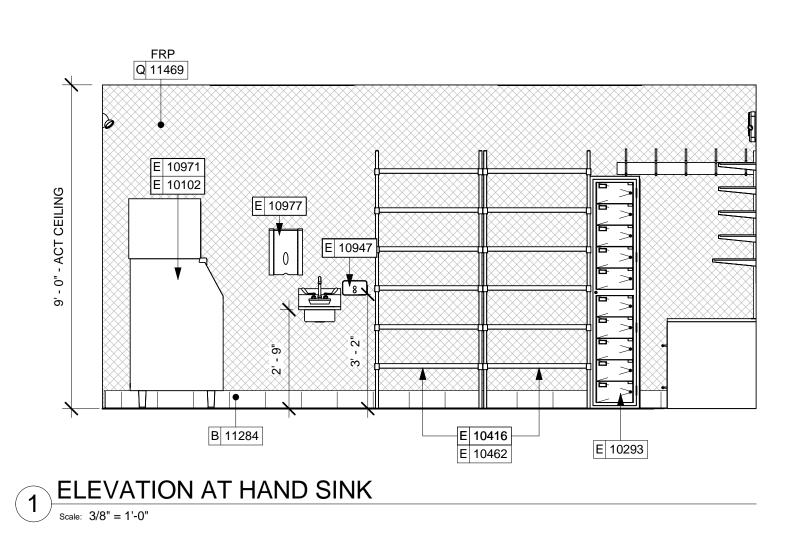

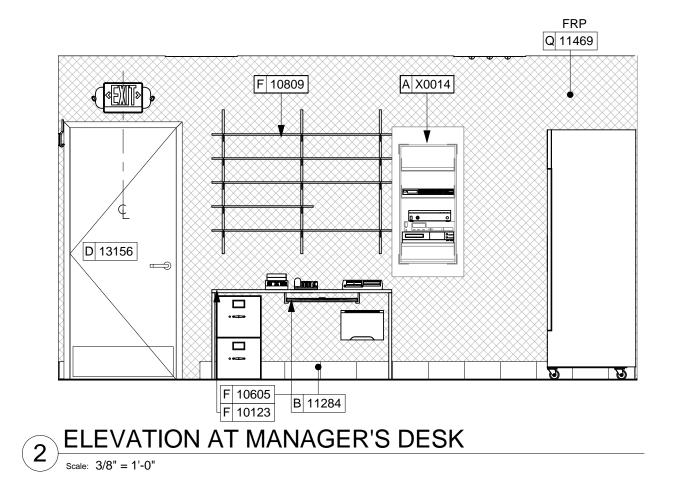

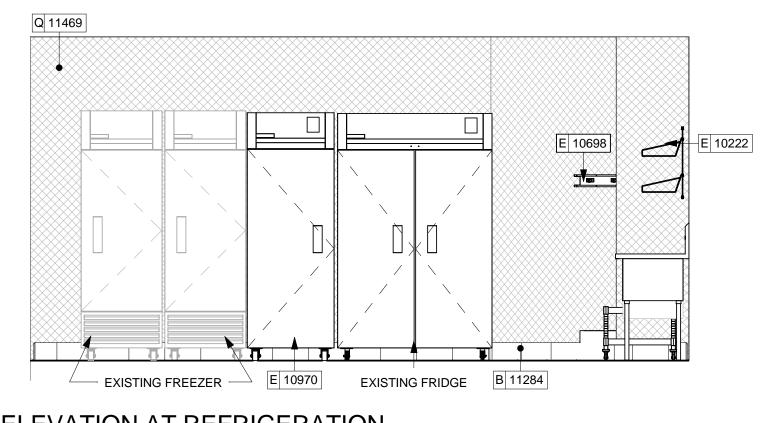

3 ELEVATION AT REFRIGERATION

Scale: 3/8" = 1'-0"



STARBUCKS COFFEE COMPANY 2401 UTAH AVENUE SOUTH

SEATTLE, WASHINGTON 98134

(206) 318-1575 THESE DRAWINGS AND SPECIFICATIONS ARE CONFIDENTIAL AND SHALL REMAIN THE SOLE PROPERTY OF STARBUCKS CORPORATION, WHICH IS THE OWNER OF THE COPYRIGHT IN THIS WORK. THEY SHALL NOT BE REPRODUCED (IN WHOLE OR IN PART), SHARED WITH THIRD PARTIES OR USED IN ANY MANNER ON OTHER PROJECTS OR EXTENSIONS TO THIS PROJECT WITHOUT THE PRIOR WRITTEN CONSENT OF STARBUCKS CORPORATION. THESE DRAWINGS AND SPECIFICATIONS ARE INTENDED TO EXPRESS DESIGN INTENT FOR A PROTOTYPICAL STARBUCKS STORE (WHICH IS SUBJECT TO CHANGE AT ANYTIME) AND DO NOT REFLECT ACTUAL SITE CONDITIONS. NEITHER PARTY SHALL HAVE ANY OBLIGATION NOR LIABILITY TO THE OTHER (EXCEPT STATED ABOVE) UNTIL A WRITTEN AGREEMENT IS FULLY EXECUTED BY BOTH PARTIES.

ARCHITECT OF RECORD





	Revision Schedule					
Rev	Date	Ву	Description			

FARWELL

STORE #: 2305 PROJECT #: 04217-001 MCS CONCEPT: PALETTE: HERITAGE ISSUE DATE: 12 09 13 DESIGN MANAGER: S. RYCHLIK LEED® AP: PRODUCTION DESIGNER: C. ALINOVICH

SHEET TITLE:


CHECKED BY:


INTERIOR ELEVATIONS

K. GORIN

SCALE: 3/8" = 1'-0"

SHEET NUMBER:

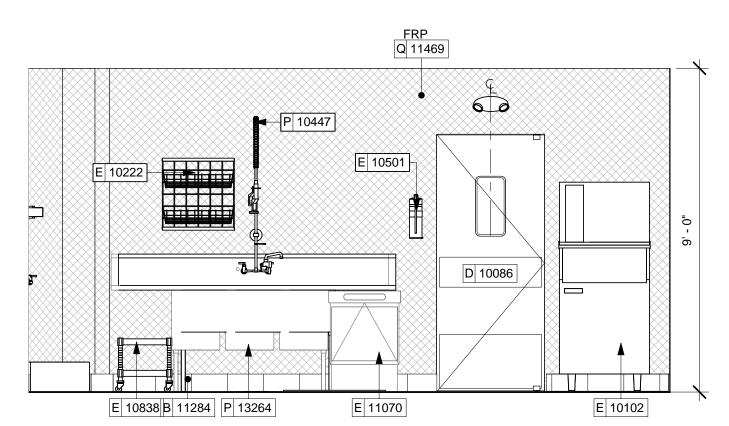


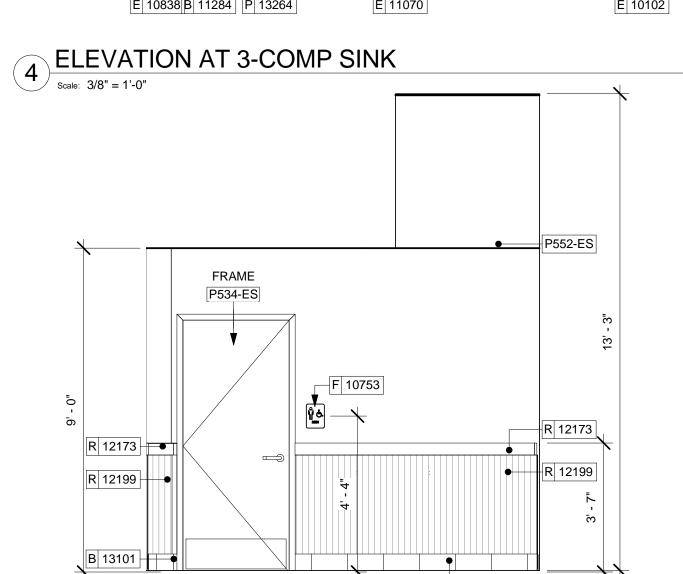



7 RR VESTIBULE @ MEN'S

| Scale: 3/8" = 1'-0"

B 13101

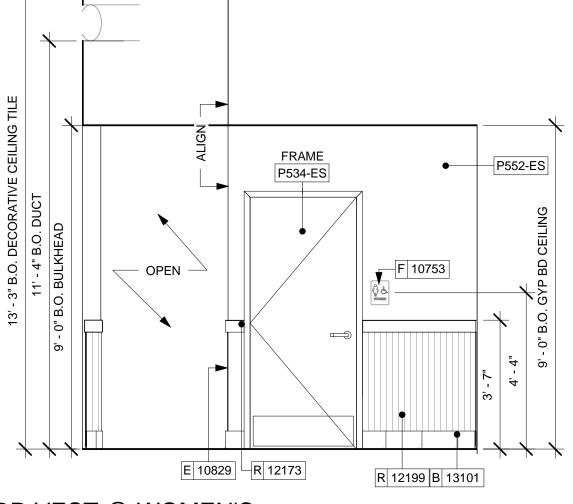

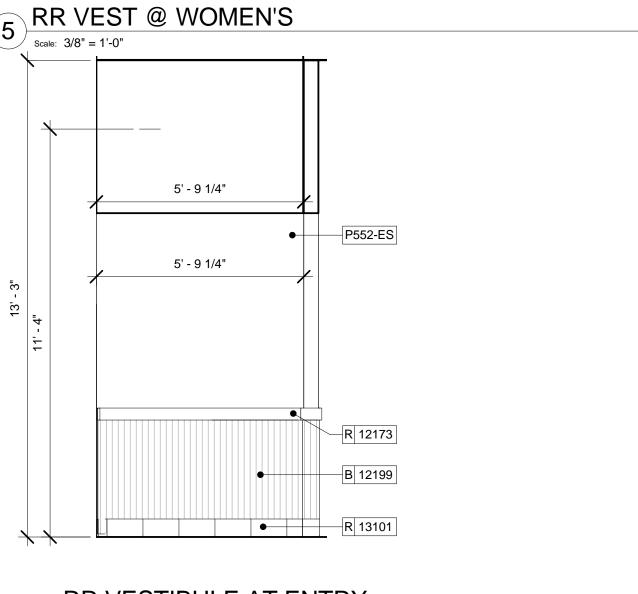


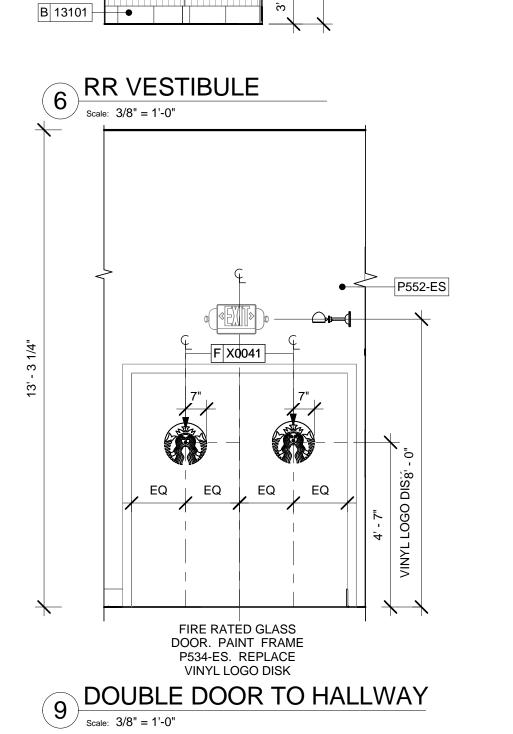


P551-ES

R 12173

R 12199

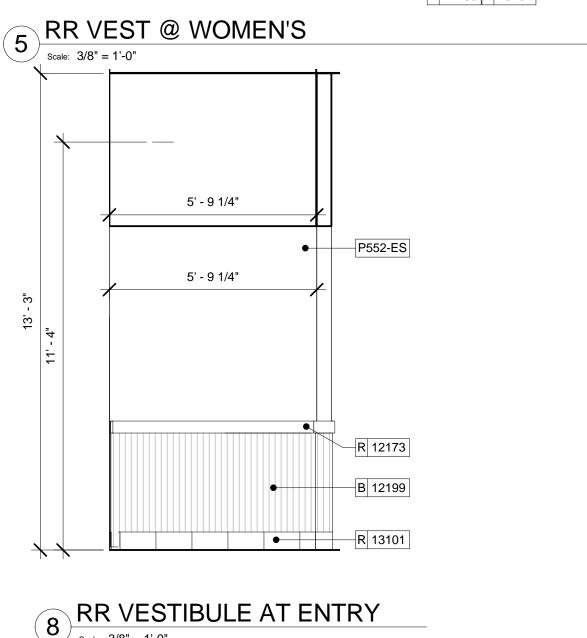

8 RR VESTIBULE AT ENTRY
| Scale: 3/8" = 1'-0"

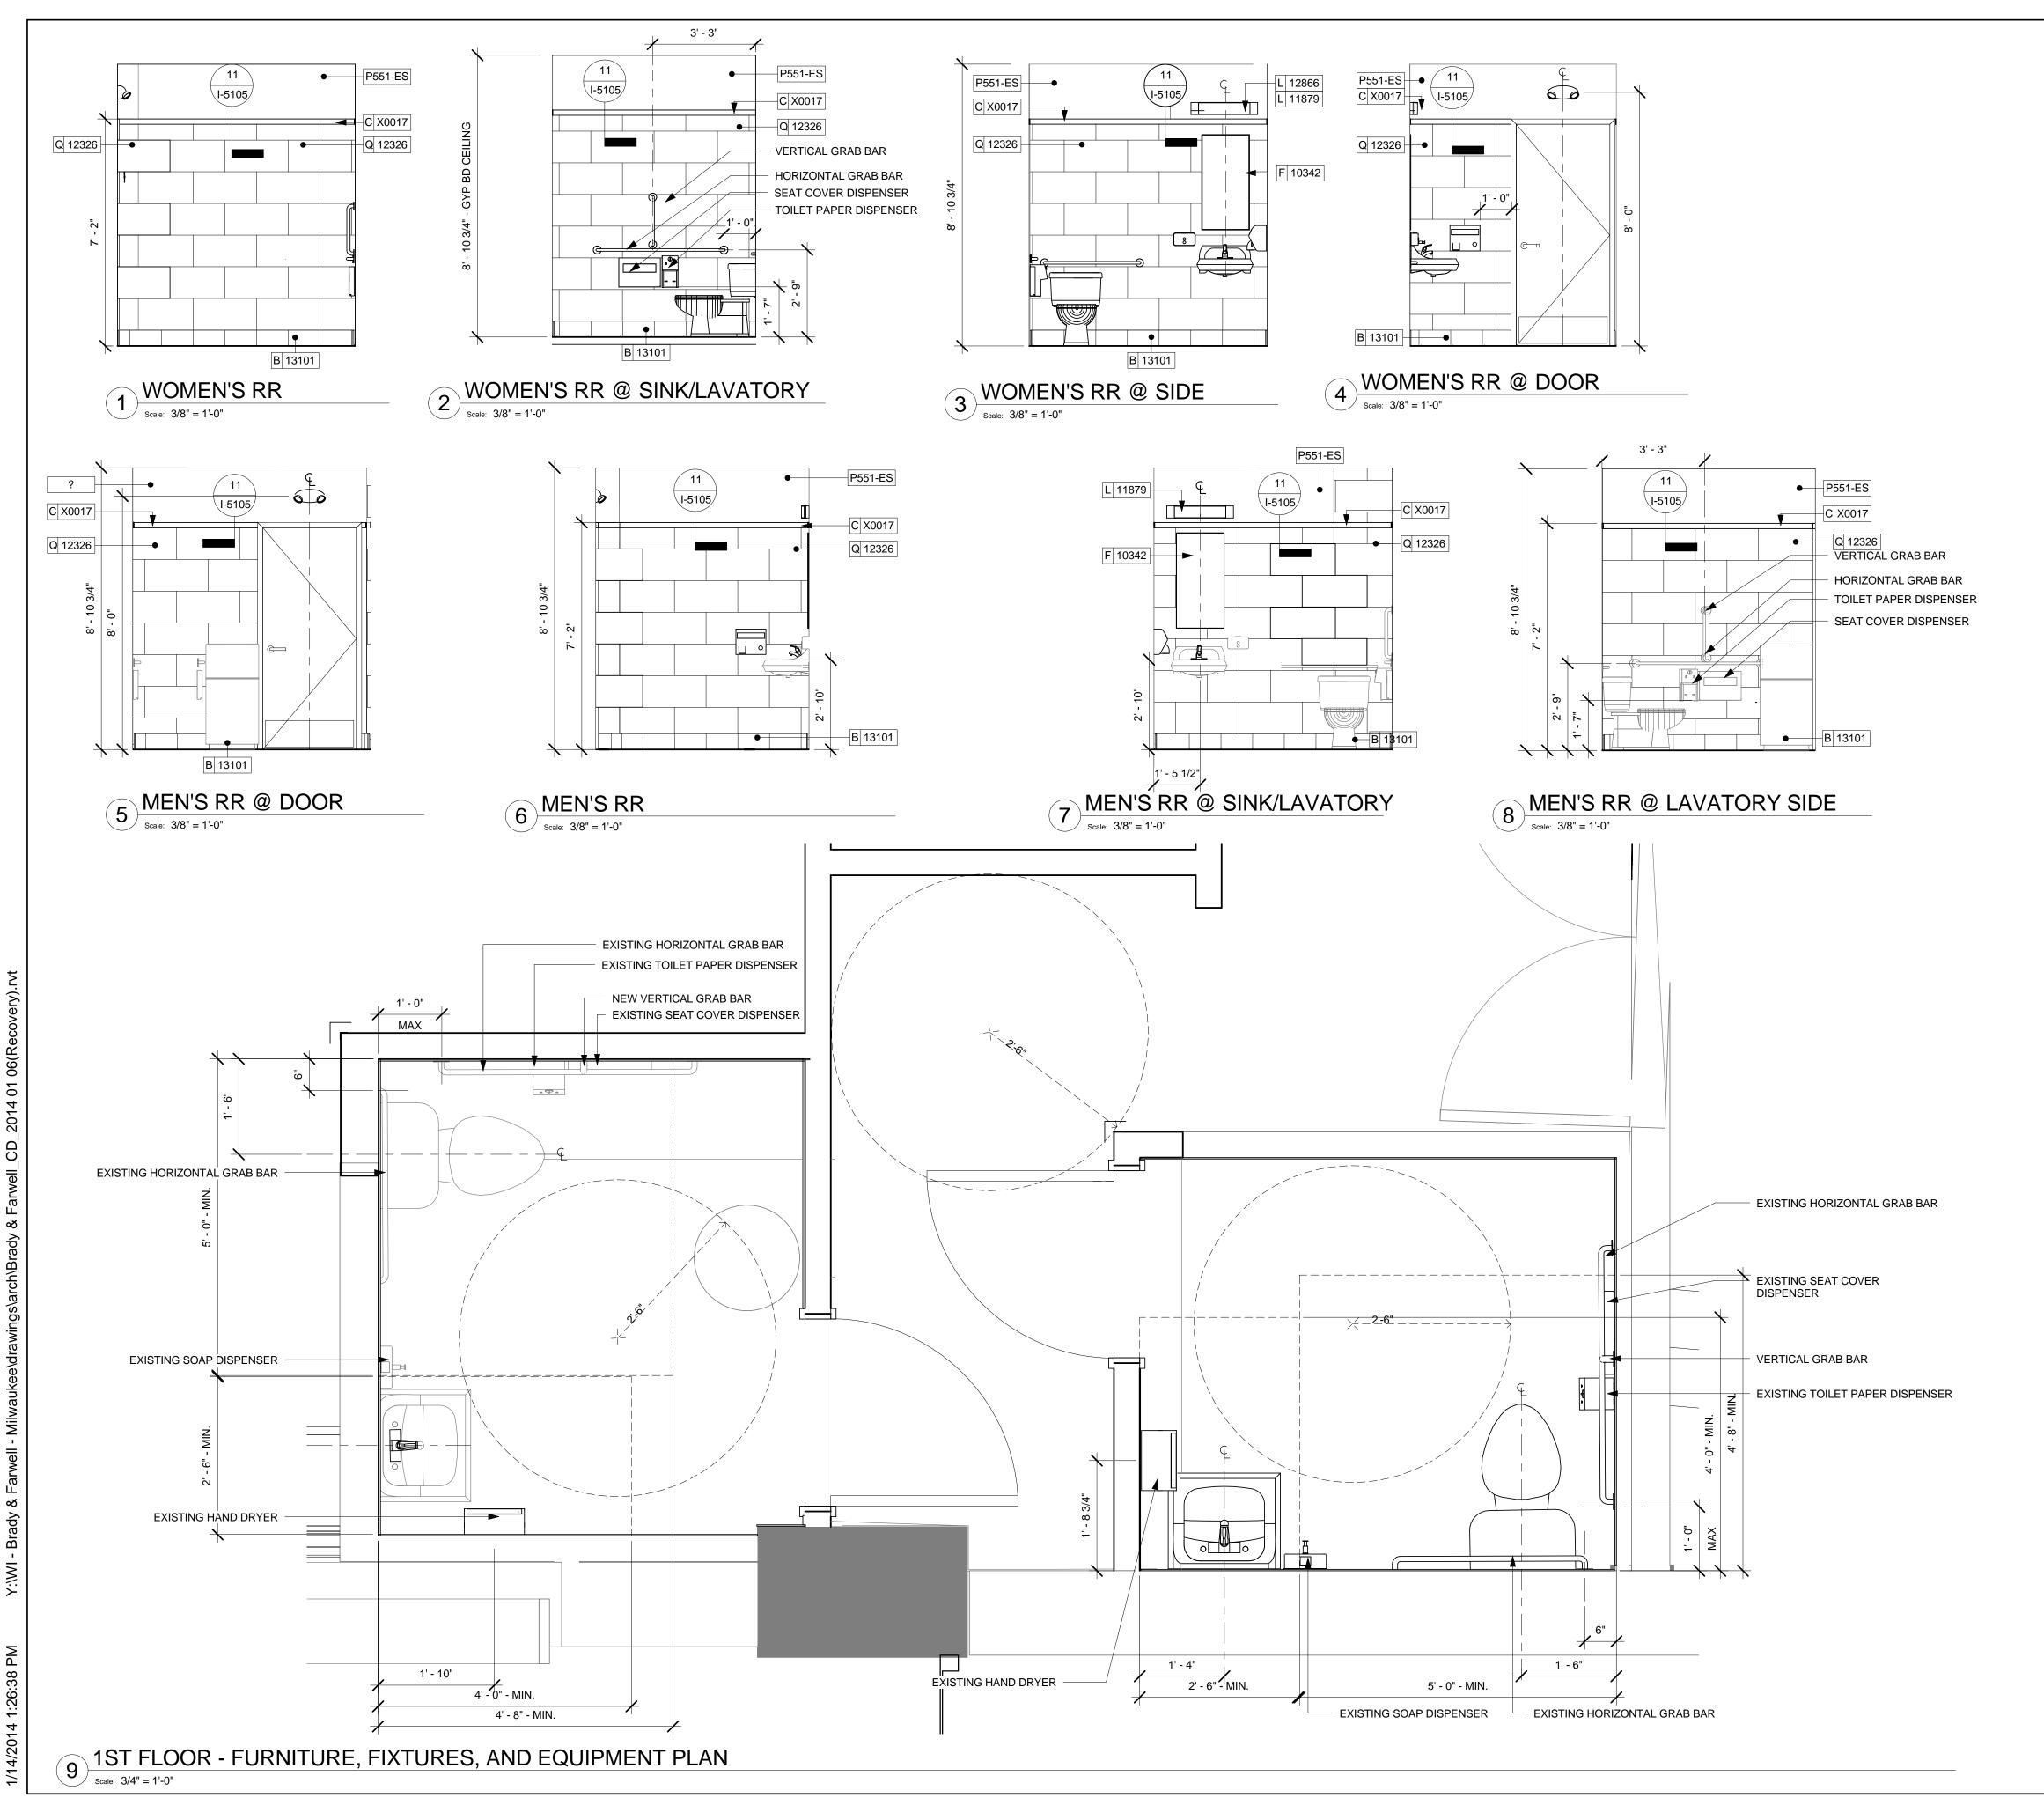

ENLARGED RESTROOM PLAN NOTES

A. DETAILS ARE FOR REFERENCE ONLY.

B. ALL RESTROOM ACCESSORIES MOUNTING HEIGHTS TO MEET ACCESSIBILITY REQUIREMENTS PER STARBUCKS ACCESSIBILITY STANDARDS.

C. GENERAL CONTRACTOR TO VERIFY ALL DIMENSIONS AND NOTIFY STARBUCKS CONSTRUCTION MANAGER OF ANY DISCREPANCIES PRIOR TO CONSTRUCTION. ALL DIMENSIONS TO BE TAKEN FROM DESIGNATED DATUM

D. DIMENSIONS ARE TO FACE OF FINISHED SURFACE.



STARBUCKS COFFEE COMPANY 2401 UTAH AVENUE SOUTH SEATTLE, WASHINGTON 98134

(206) 318-1575

THESE DRAWINGS AND SPECIFICATIONS ARE CONFIDENTIAL AND SHALL REMAIN THE SOLE PROPERTY OF STARBUCKS CORPORATION, WHICH IS THE OWNER OF THE COPYRIGHT IN THIS WORK. THEY SHALL NOT BE REPRODUCED (IN WHOLE OR IN PART), SHARED WITH THIRD PARTIES OR USED IN ANY MANNER ON OTHER PROJECTS OR EXTENSIONS TO THIS PROJECT WITHOUT THE PRIOR WRITTEN CONSENT OF STARBUCKS CORPORATION. THESE DRAWINGS AND SPECIFICATIONS ARE INTENDED TO EXPRESS DESIGN INTENT FOR A PROTOTYPICAL STARBUCKS STORE (WHICH IS SUBJECT TO CHANGE AT ANYTIME) AND DO NOT REFLECT ACTUAL SITE CONDITIONS. NEITHER PARTY SHALL HAVE ANY OBLIGATION NOR LIABILITY TO THE OTHER (EXCEPT STATED ABOVE) UNTIL A WRITTEN AGREEMENT IS FULLY EXECUTED BY BOTH PARTIES.

ARCHITECT OF RECORD



St. Louis, Missouri 63119
Phone (314) 772-1782
Fax (314) 373-3514

Engineering Consultants

Mechanical - Electrical - Plumbing

	Revision Schedule					
Rev	Date	Ву	Description			

RADY & FARWELL

SJECT ADDRESS:
77 N. FARWELL STREET
LWAUKEE, WI 53202
LWAUKEE COUNTY

STORE #: 2305

PROJECT #: 04217-001

CONCEPT: MCS

PALETTE: HERITAGE

ISSUE DATE: 12 09 13

DESIGN MANAGER: S. RYCHLIK

LEED® AP: N/A


PRODUCTION DESIGNER: C. ALINOVICH


CHECKED BY: K. GORIN

SHEET TITLE:

ENLARGED RESTROOM
PLAN AND ELEVATIONS

SHEET NUMBER:

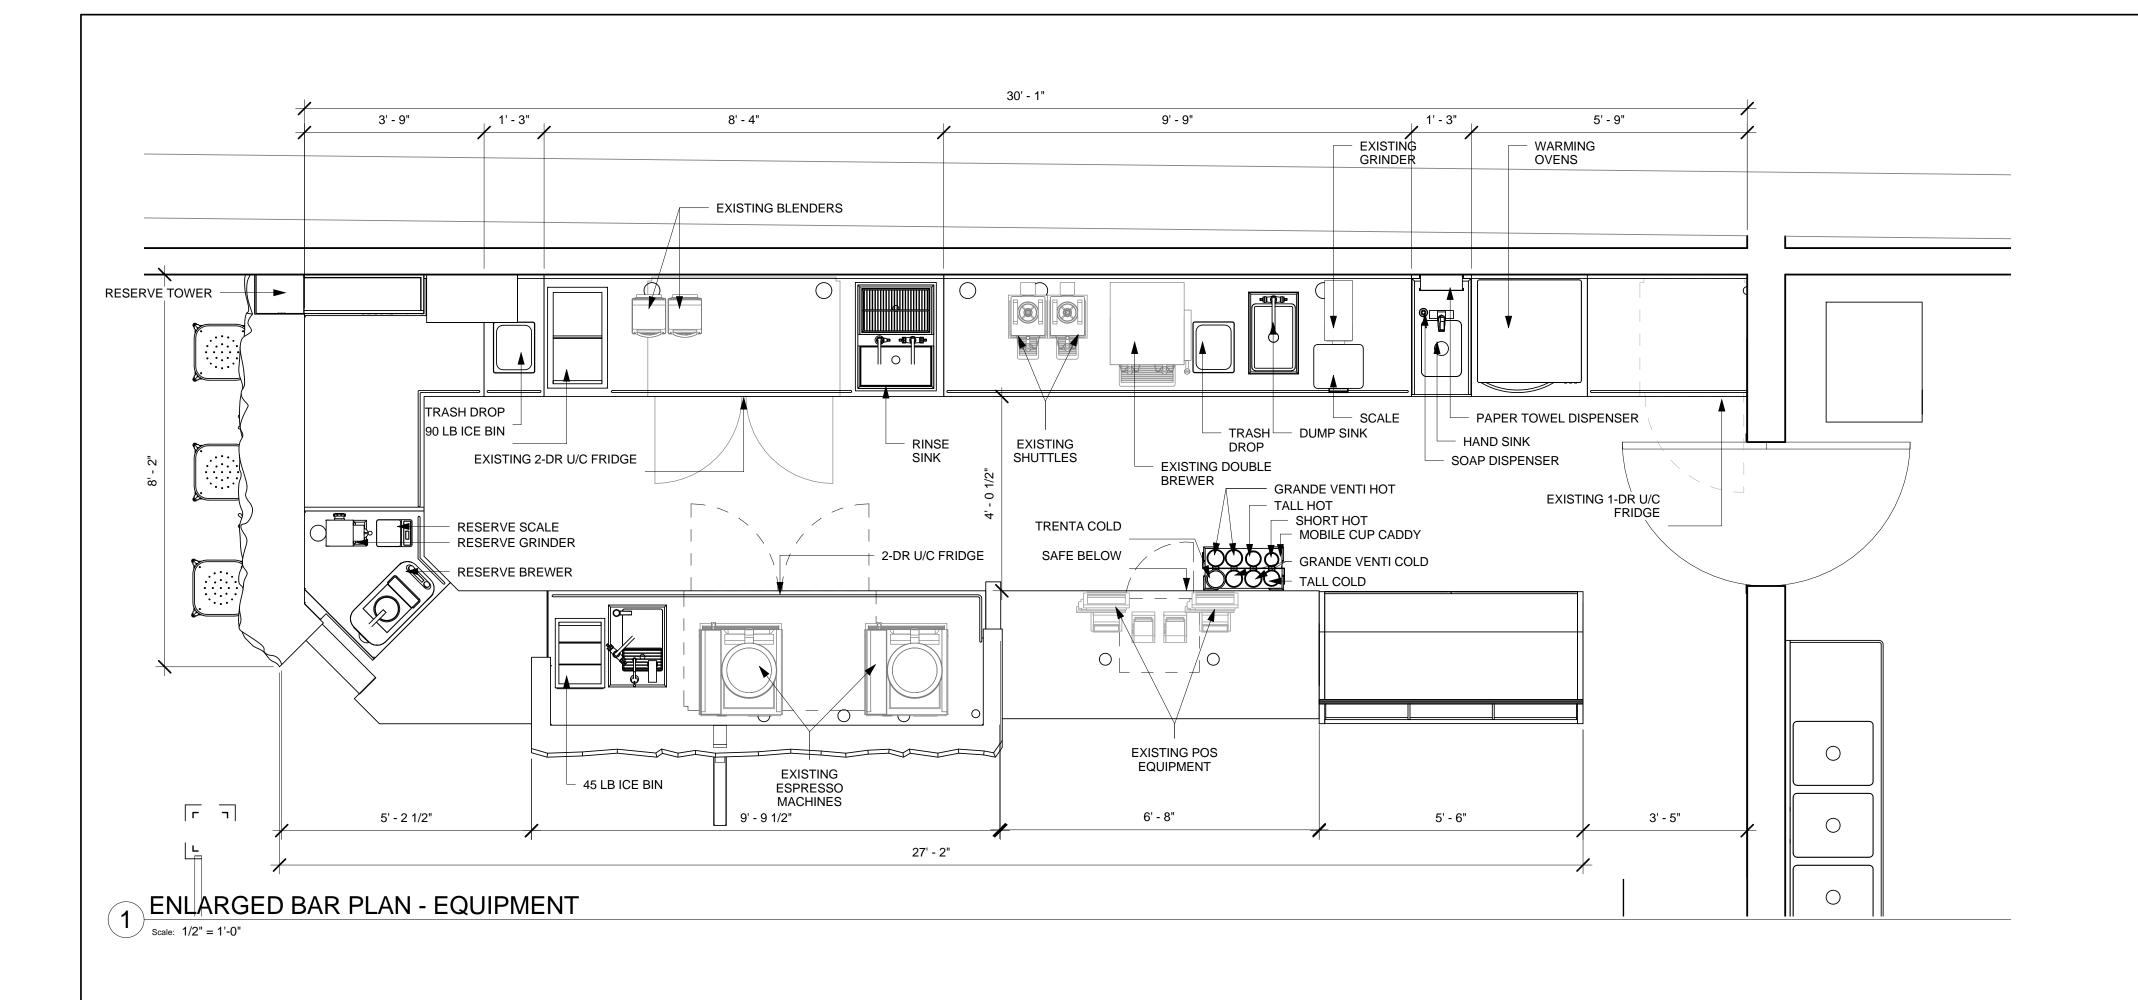

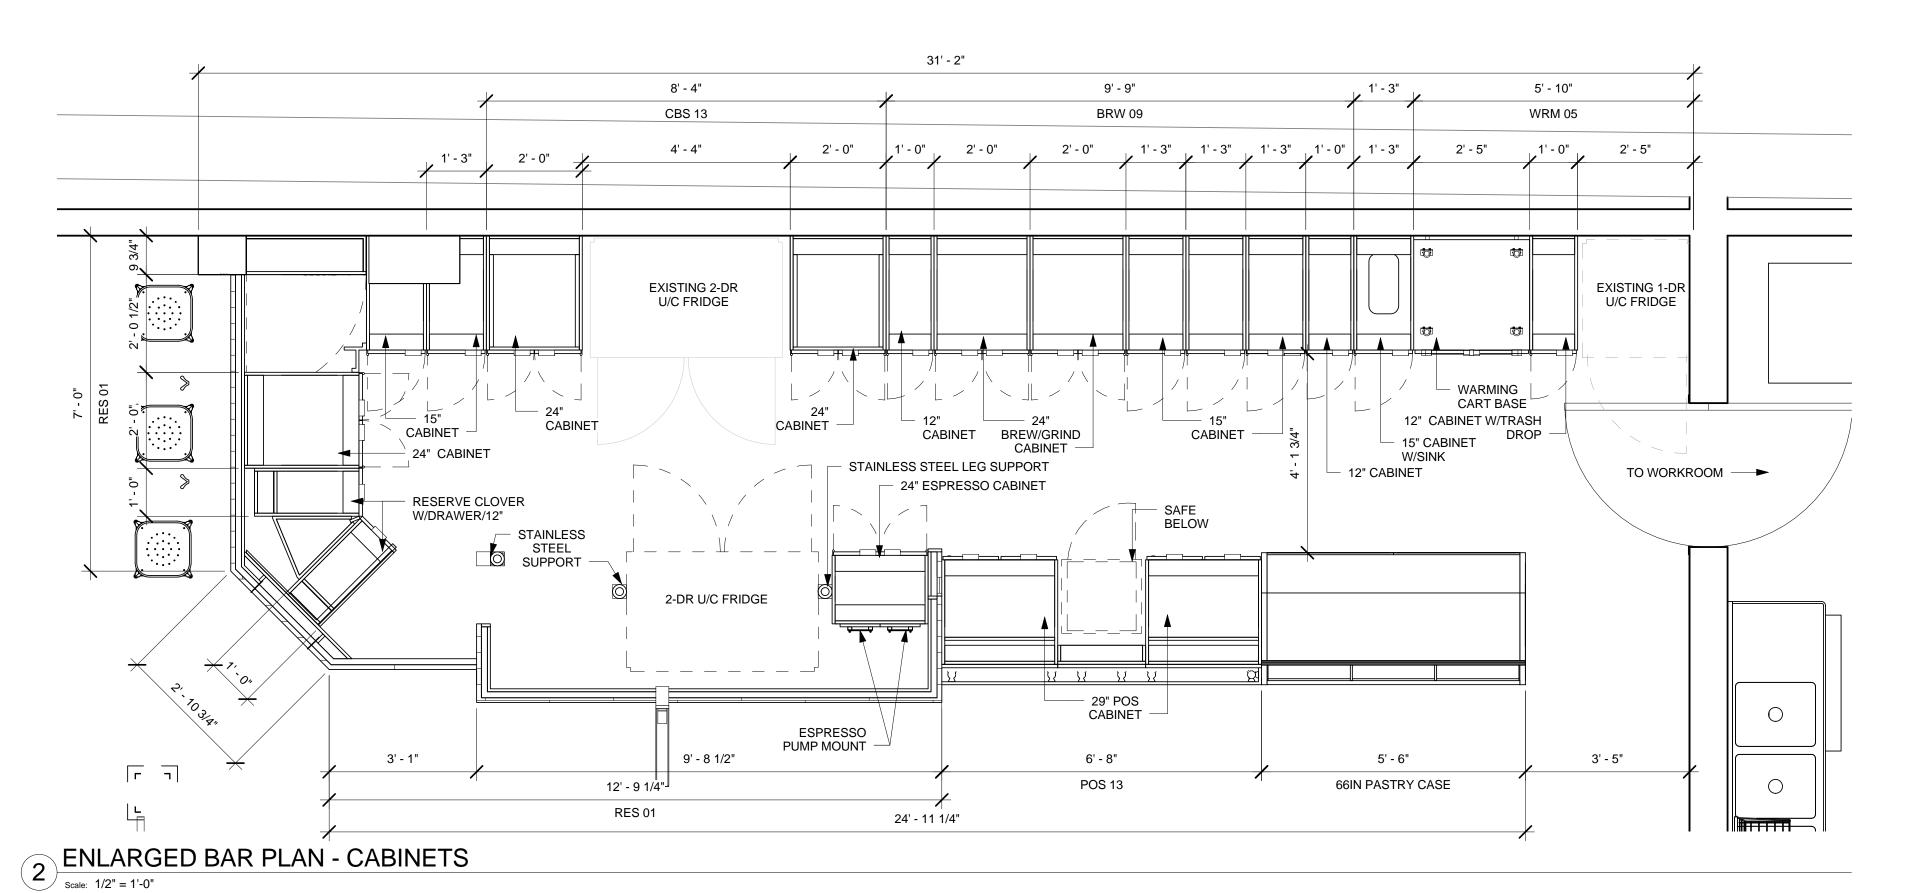



STARBUCKS COFFEE COMPANY

2401 UTAH AVENUE SOUTH SEATTLE, WASHINGTON 98134 (206) 318-1575

THESE DRAWINGS AND SPECIFICATIONS ARE CONFIDENTIAL AND SHALL REMAIN THE SOLE PROPERTY OF STARBUCKS CORPORATION, WHICH IS THE OWNER OF THE COPYRIGHT IN THIS WORK. THEY SHALL NOT BE REPRODUCED (IN WHOLE OR IN PART), SHARED WITH THIRD PARTIES OR USED IN ANY MANNER ON OTHER PROJECTS OR EXTENSIONS TO THIS PROJECT WITHOUT THE PRIOR WRITTEN CONSENT OF STARBUCKS CORPORATION. THESE DRAWINGS AND SPECIFICATIONS ARE INTENDED TO EXPRESS DESIGN INTENT FOR A PROTOTYPICAL STARBUCKS STORE (WHICH IS SUBJECT TO CHANGE AT ANYTIME) AND DO NOT REFLECT ACTUAL SITE CONDITIONS. NEITHER PARTY SHALL HAVE ANY OBLIGATION NOR LIABILITY TO THE OTHER (EXCEPT STATED ABOVE) UNTIL A WRITTEN AGREEMENT IS FULLY EXECUTED BY BOTH PARTIES.

ARCHITECT OF RECORD





Engineering Consultants

Mechanical - Electrical - Plumbing

Revision Schedule						
Rev	Date	Ву	Description			

SADY & FARWELL SADY & FARWELL SUBCT ADDRESS: LWAUKEE, WI 53202 LWAUKEE COUNTY

STORE #: 2305 PROJECT #: 04217-001 CONCEPT: MCS PALETTE: HERITAGE ISSUE DATE: 12 09 13 DESIGN MANAGER: S. RYCHLIK LEED® AP: PRODUCTION DESIGNER: C. ALINOVICH CHECKED BY: K. GORIN

SHEET TITLE:

ENLARGED BAR PLANS

1/2" = 1'-0"


CALE:


SHEET NUMBER:

I-4102

1 Y:\WI - Brady & Farwell - Milwaukee\drawings\arch\Brady & Farwell_CD_2014 01 06(Recovery).rvt

014 1:26:41 PM Y:\WI - Bradv & Farwell - Milv

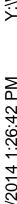

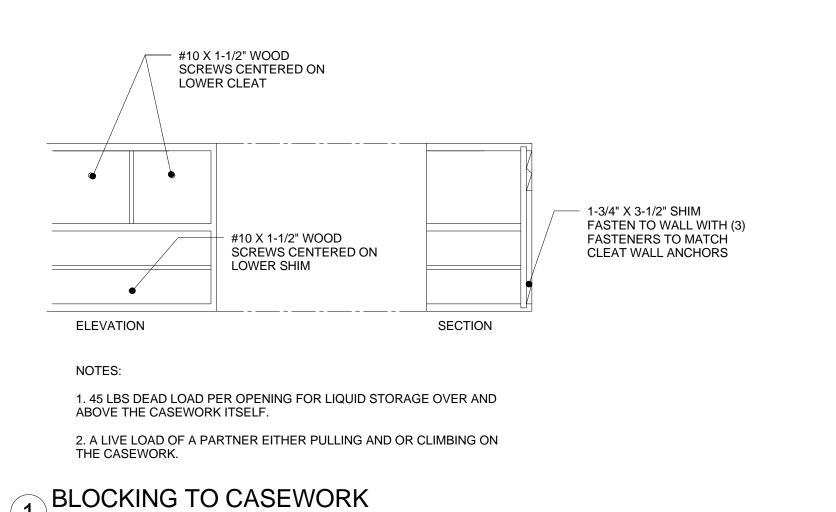

STUD


BLOCKING

FASTEN BLOCKING TO EACH STUD WITH WOOD INSERTS & (3) TEK SCREWS

NOTES:

1. 45 LBS DEAD LOAD PER OPENING FOR LIQUID STORAGE OVER AND ABOVE THE CASEWORK ITSELF.

2. A LIVE LOAD OF A PARTNER EITHER PULLING AND OR CLIMBING ON THE CASEWORK.

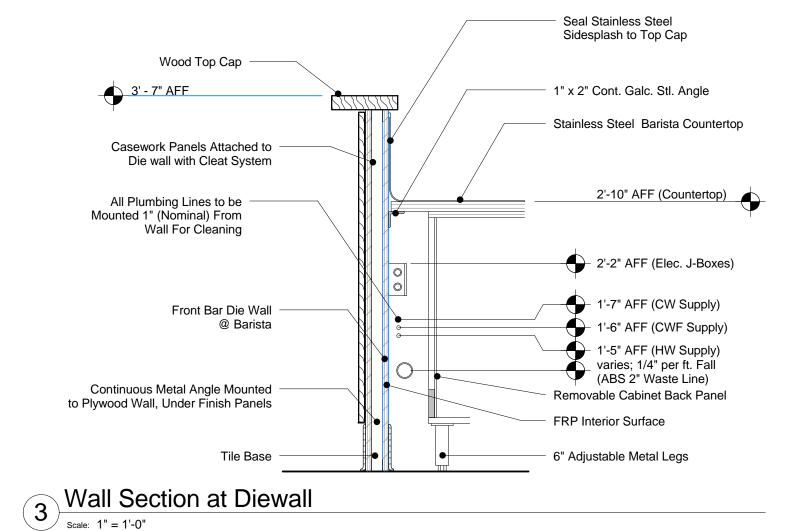

3"X3/4"X32" CLEAT


(7) #8 TEK SCREWS @ 41/2" O.C.


NOTES:

1. 45 LBS DEAD LOAD PER OPENING FOR LIQUID STORAGE OVER AND ABOVE THE CASEWORK ITSELF.

2. A LIVE LOAD OF A PARTNER EITHER PULLING AND OR CLIMBING ON THE CASEWORK.

Scale: 1/2" = 1'-0"

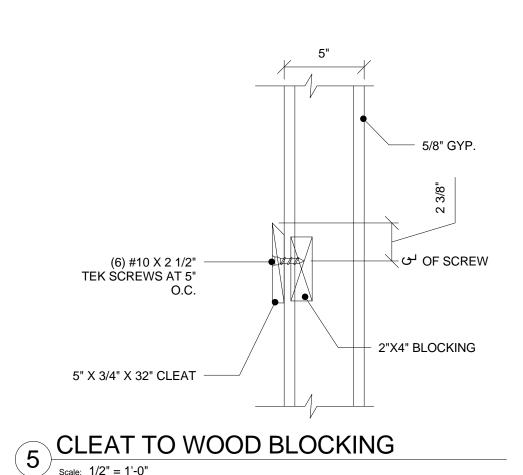

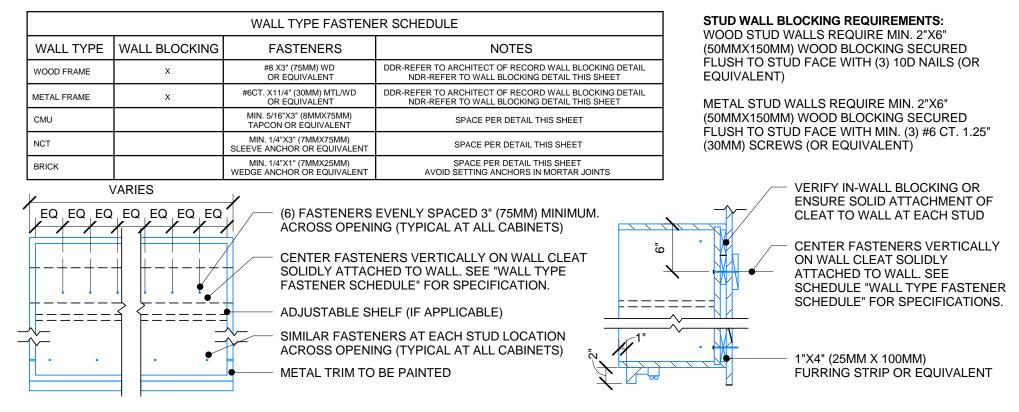

6 UPPER CABINET ATTACHMENT

| Scale: 1" = 1'-0"



STARBUCKS COFFEE
COMPANY
2401 UTAH AVENUE SOUTH

SEATTLE, WASHINGTON 98134

(206) 318-1575

THESE DRAWINGS AND SPECIFICATIONS ARE CONFIDENTIAL AND SHALL REMAIN THE SOLE PROPERTY OF STARBUCKS CORPORATION, WHICH IS THE OWNER OF THE COPYRIGHT IN THIS WORK. THEY SHALL NOT BE REPRODUCED (IN WHOLE OR IN PART), SHARED WITH THIRD PARTIES OR USED IN ANY MANNER ON OTHER PROJECTS OR EXTENSIONS TO THIS PROJECT WITHOUT THE PRIOR WRITTEN CONSENT OF STARBUCKS CORPORATION. THESE DRAWINGS AND SPECIFICATIONS ARE INTENDED TO EXPRESS DESIGN INTENT FOR A PROTOTYPICAL STARBUCKS STORE (WHICH IS SUBJECT TO CHANGE AT ANYTIME) AND DO NOT REFLECT ACTUAL SITE CONDITIONS. NEITHER PARTY SHALL HAVE ANY OBLIGATION NOR LIABILITY TO THE OTHER (EXCEPT STATED ABOVE) UNTIL A WRITTEN AGREEMENT IS FULLY EXECUTED BY BOTH PARTIES.

ARCHITECT OF RECORD



St. Louis, Missouri 63119
Phone (314) 772-1782
Fax (314) 373-3514

Engineering Consultants
Mechanical - Electrical - Plumbing

Rev Date By Description

ROJECT NAME:
RADY & FARWELL
ROJECT ADDRESS:
677 N. FARWELL STREET
IILWAUKEE, WI 53202
IILWAUKEE COUNTY

STORE #: 2305

PROJECT #: 04217-001

CONCEPT: MCS

PALETTE: HERITAGE

ISSUE DATE: 12 09 13

DESIGN MANAGER: S. RYCHLIK

LEED® AP: N/A

PRODUCTION DESIGNER: C. ALINOVICH

CHECKED BY: K. GORIN


SHEET TITLE:

SCALE:

CONSTRUCTION DETAILS

As indicated

SHEET NUMBER:

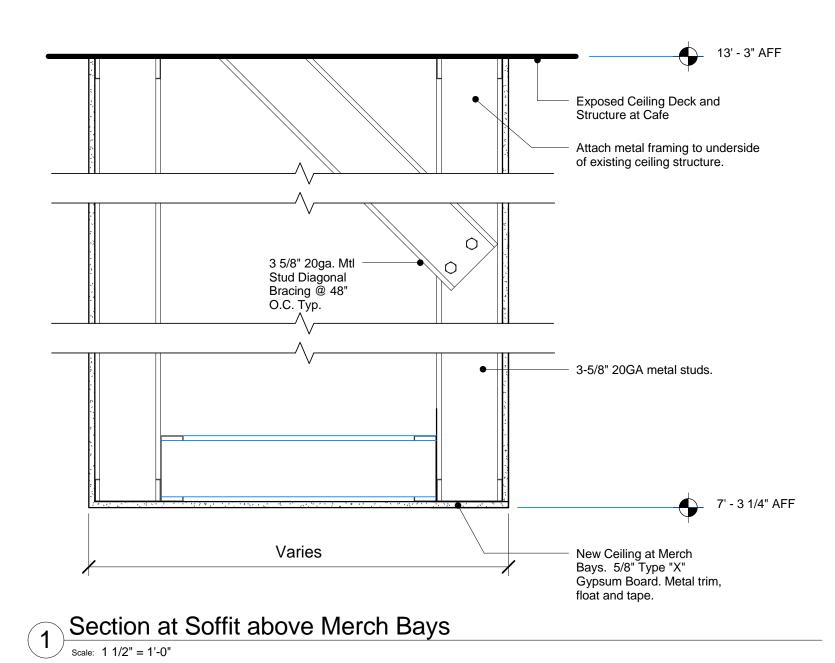

Metal Studs (Per Wall Type)

@ 16" O.C. To Underside of Roof Structure, To Minimum

or to Underside of Existing Soffit or Ceiling. Mtl Studs To Meet I.C.B.O. #1715 of Eq.

Nail Stud Runner to Floor

32" O.C. Maximum.

Existing Concrete Slab

SECTION @ FLOOR

New Partition Wall to Structure

| Scale: 1" = 1'-0"

(I.C.B.O. #2388)

w/ Hilti NK Fasteners, 1 1/8" Minimum Penetration @

of 6" Above Suspended Ceiling

Existing Roof — Structure

SECTION @ CEILING

Attach metal framing to underside of existing

structure

20 Ga. 3 5/8" Mtl Stud Bracing@ 48" O.C.. Attach to Partition

Framing w/ 3/8" Pan Head Type "S" Screws. Use Lateral Bracing When Partition Framing Does Not Attach to Roof

Suspended Ceiling, As Occurs

5/8" G.W.B. Type "X" Both

Sides to Minimum of 6" Above Ceiling. Type "S" Dry-Wall Screws at 8" O.C. to Vertical Edges and 12" O.C.


to Intermediate Studs. Staggering Joints 24" O.C., Each Side.

Structure.

Existing Roof Metal Studs (Per Wall Type) Structure 20 Ga. 3 5/8" Mtl Stud Bracing @ 16" O.C. To Underside of @ 48" O.Ç.. Attach to Partition Roof Structure, To Minimum Framing w/ 3/8" Pan Head of 6" Above Suspended Ceiling or to Underside of Existing
Soffit or Ceiling. Mtl Studs
To Meet I.C.B.O. #1715 of Eq. Type "S" Screws. Use Lateral Bracing When Partition Framing Does Not Attach to Roof Structure. Suspended Ceiling, As Occurs Nail Stud Runner to Floor w/ Hilti NK Fasteners, 1 1/8" Minimum Penetration @ 32" O.C. Maximum. 5/8" G.W.B. Type "X" Both (I.C.B.O. #2388) Sides to Minimum of 6" Above Ceiling. Type "S" Dry-Wall Screws at 8" O.C. to Vertical Edges and 12" O.C. Existing Concrete Slab to Intermediate Studs. Staggering Joints 24" O.C., Each Side. SECTION @ FLOOR SECTION @ CEILING

New Partition Wall 6" Above Ceiling

| Scale: 1" = 1'-0"

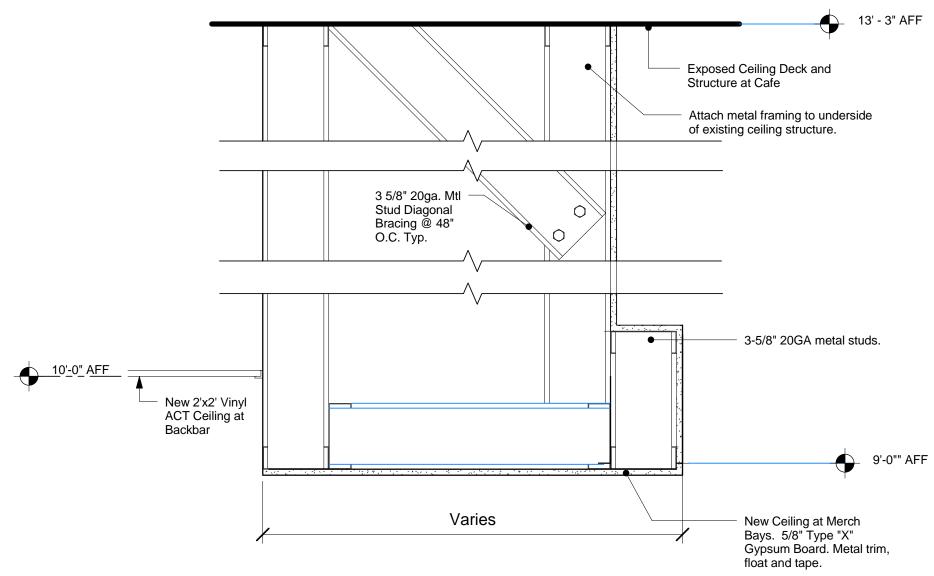

Section at Soffit above Merch Bays

| Scale: 1 1/2" = 1'-0"

9'-0"" AFF

©2011 STARBUCKS COFFEE COMPANY STARBUCKS COFFEE COMPANY 2401 UTAH AVENUE SOUTH SEATTLE, WASHINGTON 98134

(206) 318-1575 THESE DRAWINGS AND SPECIFICATIONS ARE CONFIDENTIAL AND SHALL REMAIN THE SOLE PROPERTY OF STARBUCKS CORPORATION, WHICH IS THE OWNER OF THE COPYRIGHT IN THIS WORK. THEY SHALL NOT BE REPRODUCED (IN WHOLE OR IN PART), SHARED WITH THIRD PARTIES OR USED IN ANY MANNER ON OTHER PROJECTS OR EXTENSIONS TO THIS PROJECT WITHOUT THE PRIOR WRITTEN CONSENT OF STARBUCKS CORPORATION. THESE DRAWINGS AND SPECIFICATIONS ARE INTENDED TO EXPRESS DESIGN INTENT FOR A PROTOTYPICAL STARBUCKS STORE (WHICH IS SUBJECT TO CHANGE AT ANYTIME) AND DO NOT REFLECT ACTUAL SITE CONDITIONS. NEITHER PARTY SHALL HAVE ANY OBLIGATION NOR LIABILITY TO THE OTHER (EXCEPT STATED ABOVE) UNTIL A WRITTEN AGREEMENT IS FULLY EXECUTED BY BOTH PARTIES.

ARCHITECT OF RECORD





	Re	vision Schedule
Rev D	ate By	Description
	ı F	_
NEWELL	j i i j c	-L STREET 53202 UNTY
\geq)	320 NT
Ω	-	- 22 F

PROJECT NAME BRADY


l		
	STORE #:	2305
	PROJECT #:	04217-001
l	CONCEPT:	MCS
l	PALETTE:	HERITAGE
l	ISSUE DATE:	12 09 13
	DESIGN MANAGER:	S. RYCHLIK
l	LEED [®] AP:	N/A
l	PRODUCTION DESIGNER:	C. ALINOVICH
	CHECKED BY:	K. GORIN

SHEET TITLE:

SCALE:

CONSTRUCTION **DETAILS** As indicated


SHEET NUMBER:

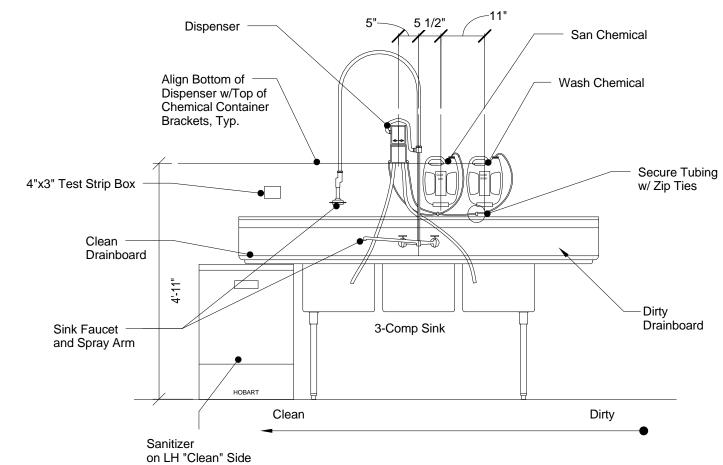

CLICK SAN/WASH INSTALL (FOR REFERENCE ONLY)

Scale: 1/2" = 1'-0"

Indirect drain line from Sanitizer to nearest floor drain or Mop Sink Hot water for Sanitizer with shut-off under sink at 18" (460mm) AFF Line length must allow ease of movement Hot and cold water for Sink Faucet Drain line from Sink to waste line in wall

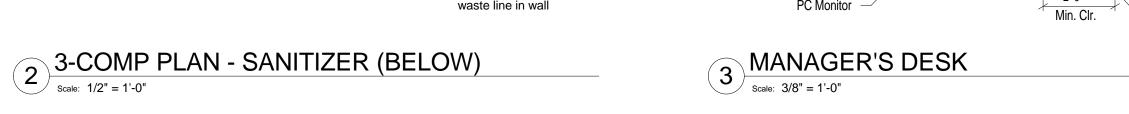

Line of Ceiling

Shelving

Secured

to Solid

Blocking

Counter

Cabinet

Keyboard

PC Monitor


and Tray

[©] 2'-6"

Shelves are

Evenly Spaced

2'-0"

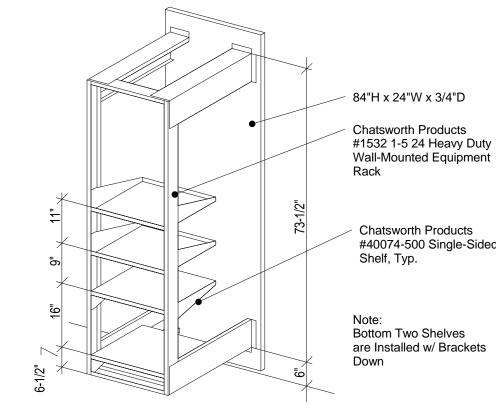

2'x7' Plywood —Back Panel

Rack Secured

Alarm Panel

Internet Hub

<u>Uninteruptable</u>

Power Supply

Security Recorder

Security Monitor

Manager's CPU

Equipment Rack


Electronic


LAN Hub and Modem

Wireless

to Solid Blocking

EQUIPMENT RACK

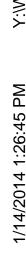

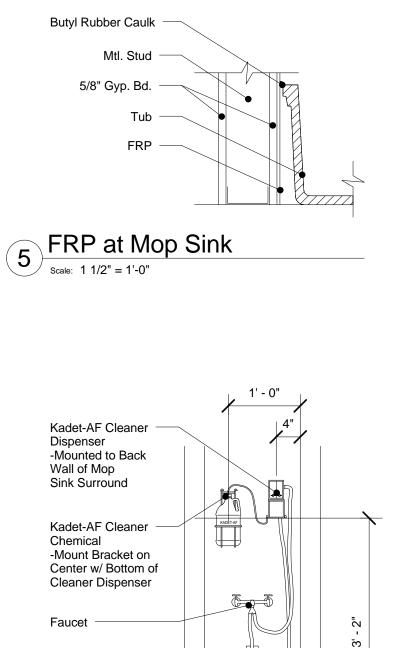



Fresh Water Hose

Mop Sink Basin

6 M075 Kadet Mounting

Scale: 3/4" = 1'-0"

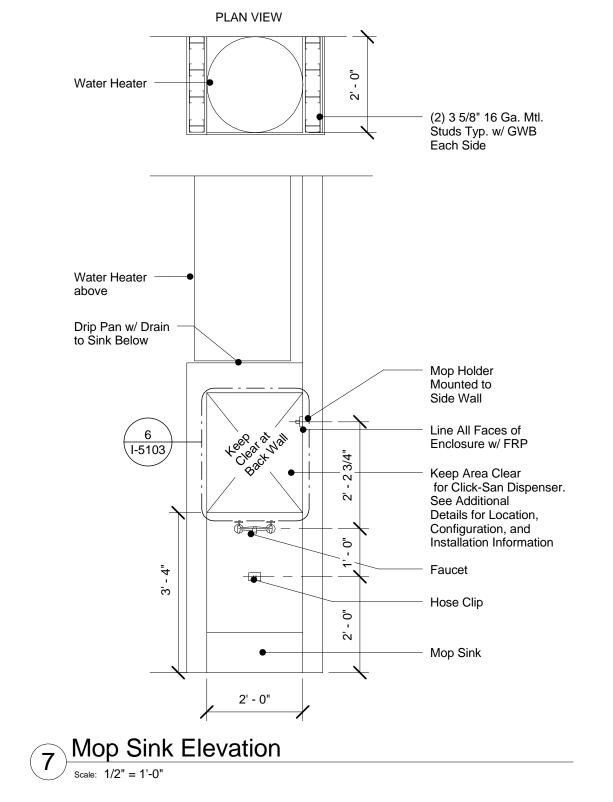

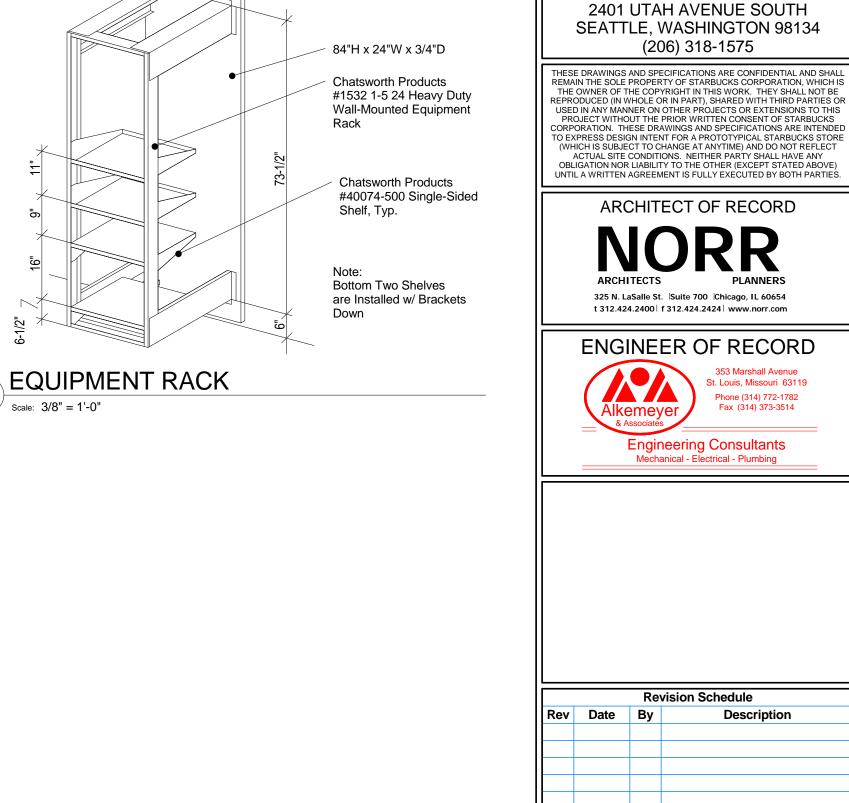

STORE #: 2305 PROJECT #: 04217-001 CONCEPT: MCS PALETTE: HERITAGE ISSUE DATE: 12 09 13 DESIGN MANAGER: S. RYCHLIK LEED® AP: N/A PRODUCTION DESIGNER: C. ALINOVICH CHECKED BY: K. GORIN

©2011 STARBUCKS COFFEE COMPANY

STARBUCKS COFFEE

COMPANY

St. Louis, Missouri 63119 Phone (314) 772-1782 Fax (314) 373-3514

SHEET TITLE: **WORKROOM DETAILS**


SHEET NUMBER:


SCALE:


FARWELL


I-5103

As indicated

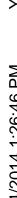


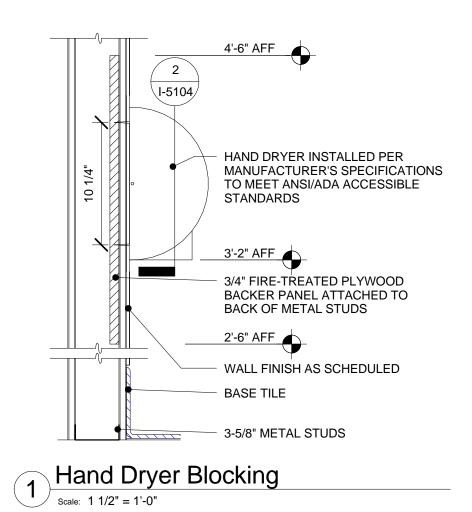


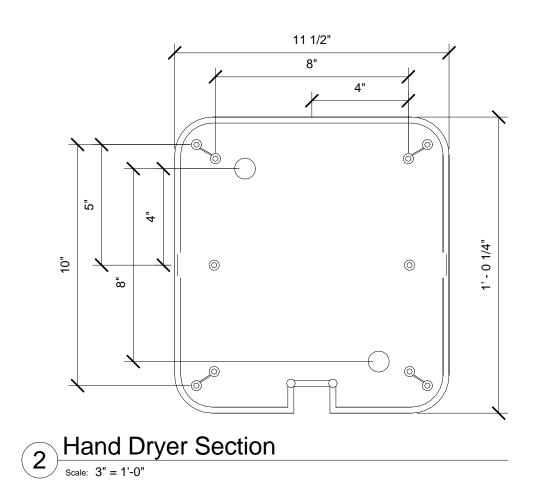

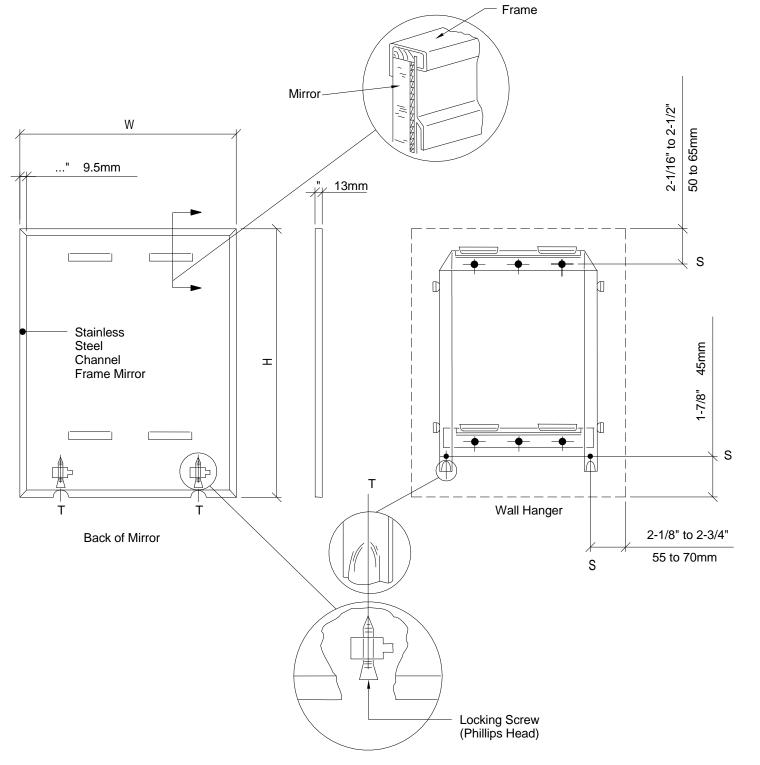



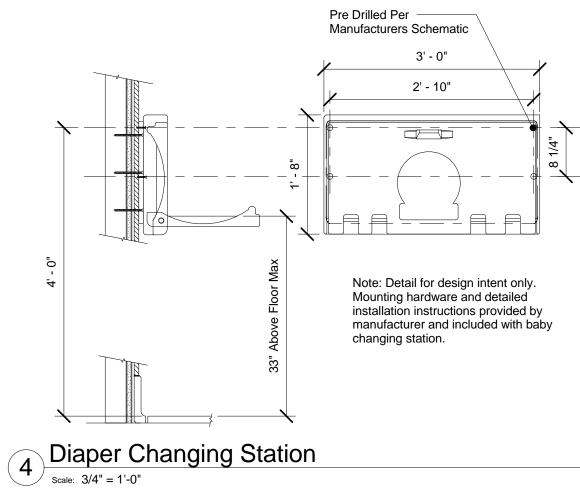

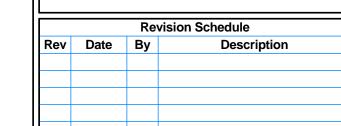

©2011 STARBUCKS COFFEE COMPANY

STARBUCKS COFFEE

COMPANY 2401 UTAH AVENUE SOUTH

SEATTLE, WASHINGTON 98134 (206) 318-1575

THESE DRAWINGS AND SPECIFICATIONS ARE CONFIDENTIAL AND SHALL REMAIN THE SOLE PROPERTY OF STARBUCKS CORPORATION, WHICH IS THE OWNER OF THE COPYRIGHT IN THIS WORK. THEY SHALL NOT BE REPRODUCED (IN WHOLE OR IN PART), SHARED WITH THIRD PARTIES OR USED IN ANY MANNER ON OTHER PROJECTS OR EXTENSIONS TO THIS PROJECT WITHOUT THE PRIOR WRITTEN CONSENT OF STARBUCKS CORPORATION. THESE DRAWINGS AND SPECIFICATIONS ARE INTENDED TO EXPRESS DESIGN INTENT FOR A PROTOTYPICAL STARBUCKS STORE (WHICH IS SUBJECT TO CHANGE AT ANYTIME) AND DO NOT REFLECT ACTUAL SITE CONDITIONS. NEITHER PARTY SHALL HAVE ANY OBLIGATION NOR LIABILITY TO THE OTHER (EXCEPT STATED ABOVE) UNTIL A WRITTEN AGREEMENT IS FULLY EXECUTED BY BOTH PARTIES.

ARCHITECT OF RECORD

325 N. LaSalle St. |Suite 700 |Chicago, IL 60654

t 312.424.2400 | f 312.424.2424 | www.norr.com

ENGINEER OF RECORD

Engineering Consultants
Mechanical - Electrical - Plumbing

St. Louis, Missouri 63119 Phone (314) 772-1782 Fax (314) 373-3514

ECT NAME:

ADY & FARWELL

SET ADDRESS:
7 N. FARWELL STREET

NAUKEE, WI 53202

NAUKEE COUNTY

STORE #: 2305 PROJECT #: 04217-001 MCS CONCEPT: PALETTE: HERITAGE ISSUE DATE: 12 09 13 DESIGN MANAGER: S. RYCHLIK LEED® AP: N/A PRODUCTION DESIGNER: C. ALINOVICH CHECKED BY: K. GORIN

SHEET TITLE:

RESTROOM DETAILS

As indicated


SCALE:

SHEET NUMBER:

I-5104

3 Mirror Mounting

Scale: 3/4" = 1'-0"

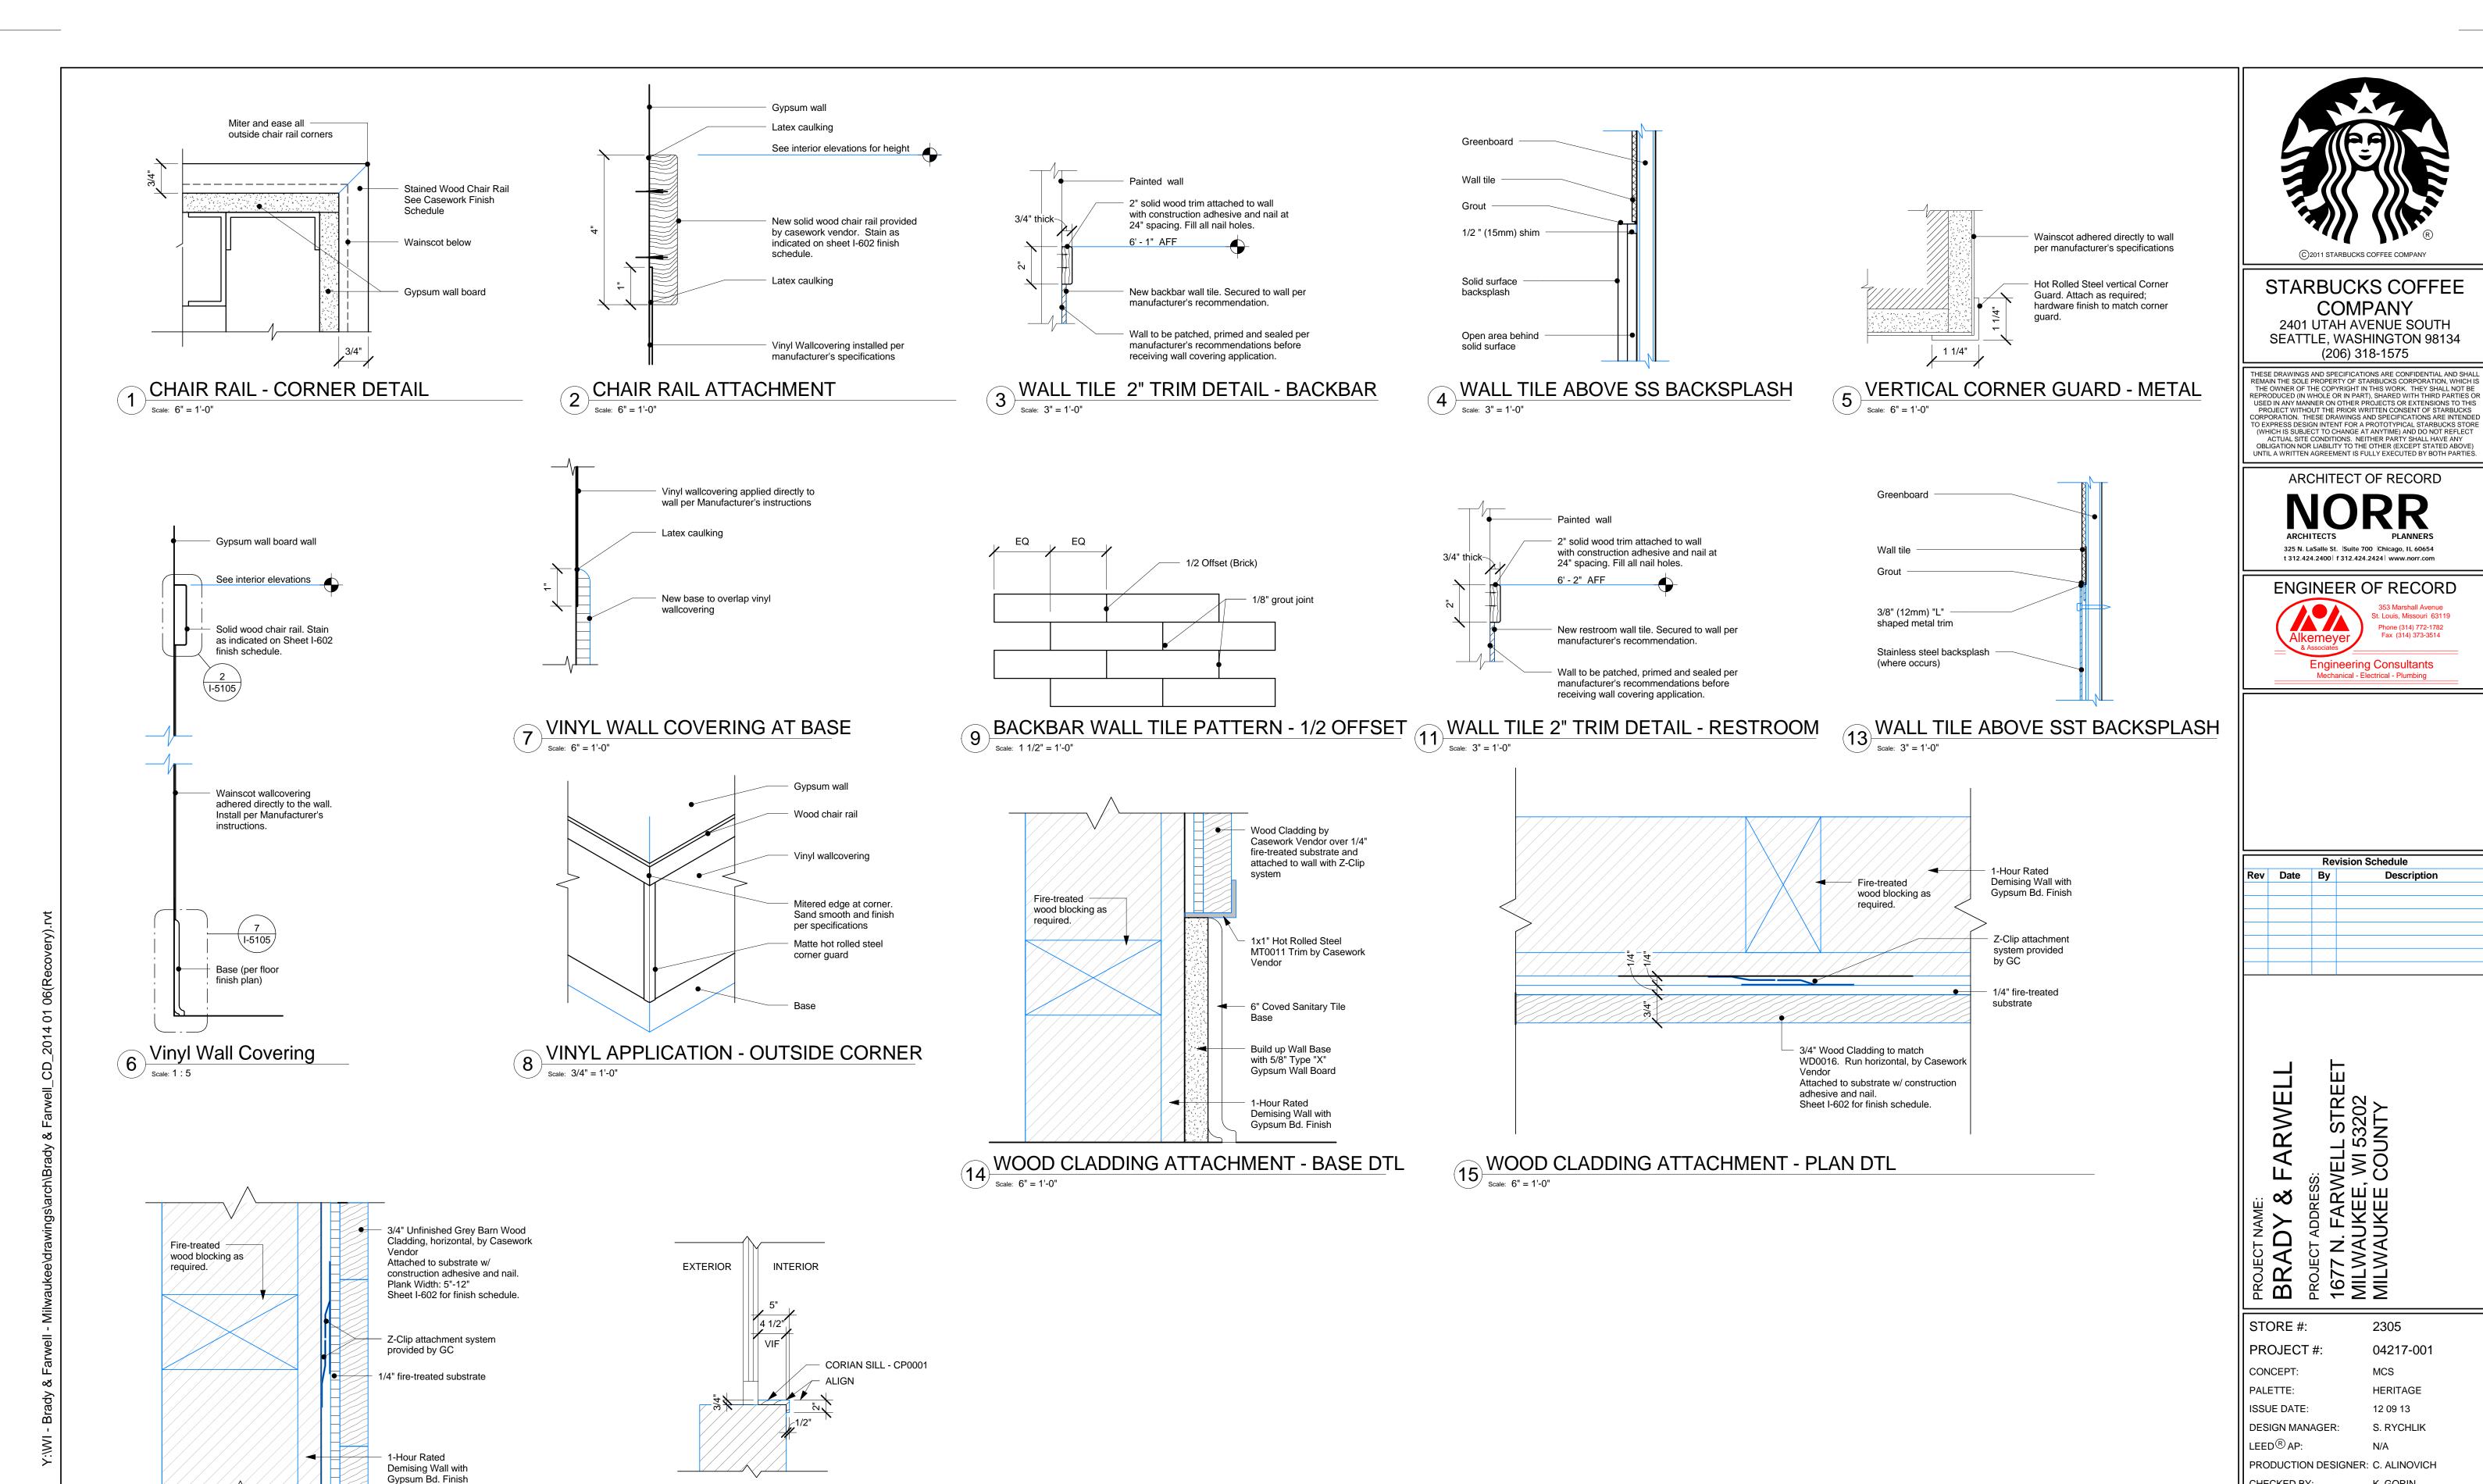

WOOD CLADDING ATTACHMENT - SECTION DTL

Scale: 6" = 1'-0"

10 X0028 - SILL DETAIL - TYP.

Scale: 1" = 1'-0"

2305 04217-001 MCS HERITAGE

COMPANY

(206) 318-1575

St. Louis, Missouri 63119

Phone (314) 772-1782

Fax (314) 373-3514

Mechanical - Electrical - Plumbing

Revision Schedule

Description

SHEET TITLE: WALL FINISH DETAILS

CHECKED BY:

As indicated SCALE: SHEET NUMBER:

I-5105

12 09 13

N/A

S. RYCHLIK

K. GORIN



STARBUCKS COFFEE COMPANY

2401 UTAH AVENUE SOUTH SEATTLE, WASHINGTON 98134 (206) 318-1575

THESE DRAWINGS AND SPECIFICATIONS ARE CONFIDENTIAL AND SHALL REMAIN THE SOLE PROPERTY OF STARBUCKS CORPORATION, WHICH IS THE OWNER OF THE COPYRIGHT IN THIS WORK. THEY SHALL NOT BE REPRODUCED (IN WHOLE OR IN PART), SHARED WITH THIRD PARTIES OR USED IN ANY MANNER ON OTHER PROJECTS OR EXTENSIONS TO THIS PROJECT WITHOUT THE PRIOR WRITTEN CONSENT OF STARBUCKS CORPORATION. THESE DRAWINGS AND SPECIFICATIONS ARE INTENDED TO EXPRESS DESIGN INTENT FOR A PROTOTYPICAL STARBUCKS STORE (WHICH IS SUBJECT TO CHANGE AT ANYTIME) AND DO NOT REFLECT ACTUAL SITE CONDITIONS. NEITHER PARTY SHALL HAVE ANY OBLIGATION NOR LIABILITY TO THE OTHER (EXCEPT STATED ABOVE) UNTIL A WRITTEN AGREEMENT IS FULLY EXECUTED BY BOTH PARTIES.

ARCHITECT OF RECORD



St. Louis, Missouri 63119

Alkemeyer
& Associates

Associates

Associates

Associates

Engineering Consultants

Mechanical - Electrical - Plumbing

Revision Schedule			
Rev	Date	Ву	Description

ROJECT NAME:

SRADY & FARWELL

ROJECT ADDRESS:

677 N. FARWELL STREET

AILWAUKEE, WI 53202

AILWAUKEE COUNTY

STORE #: 2305

PROJECT #: 04217-001

CONCEPT: MCS

PALETTE: HERITAGE

ISSUE DATE: 12 09 13

DESIGN MANAGER: S. RYCHLIK

LEED® AP: N/A


PRODUCTION DESIGNER: C. ALINOVICH


CHECKED BY: K. GORIN

SHEET TITLE:


WALL FINISH DETAILS

SHEET NUMBER:

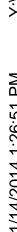


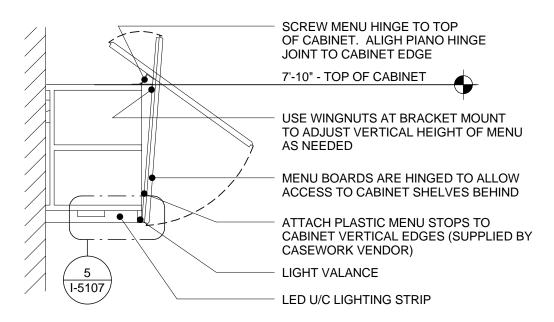


CASEWORK MENU MOUNTING SECTION

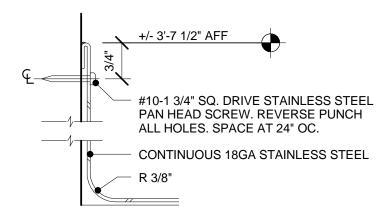


BACKSPLASH DETAIL Scale: 6" = 1'-0"

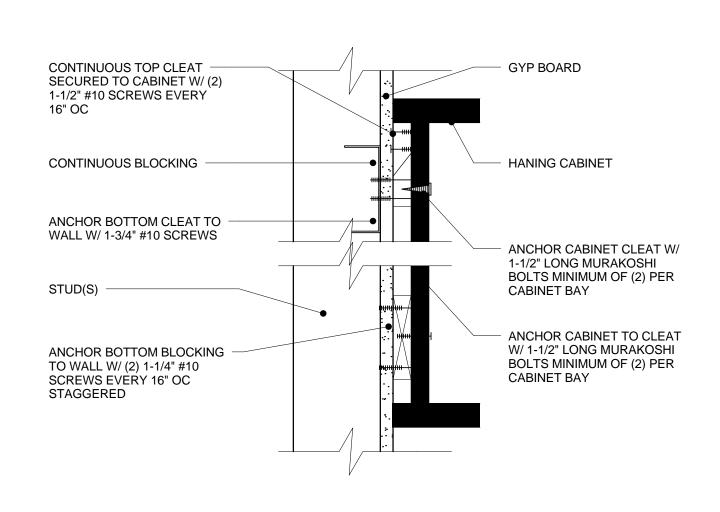


3 ANCHOR DETAIL Scale: 3" = 1'-0"

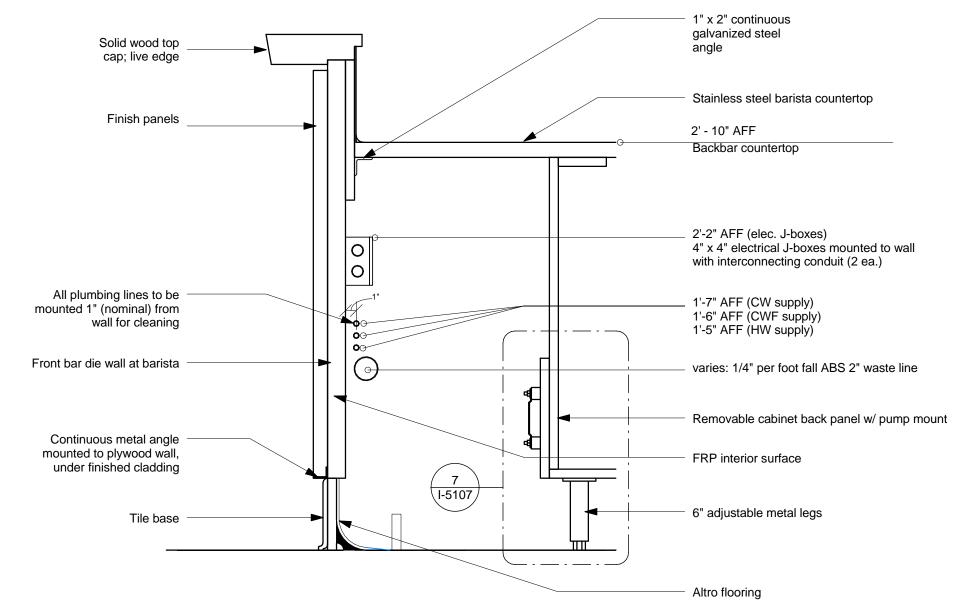


DIE WALL ASSEMBLY AT BARISTA Scale: 1 1/2" = 1'-0"

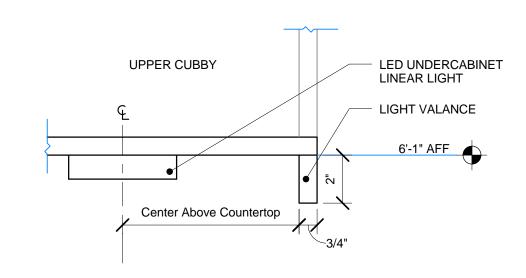


5 LIGHT VALANCE SECTION

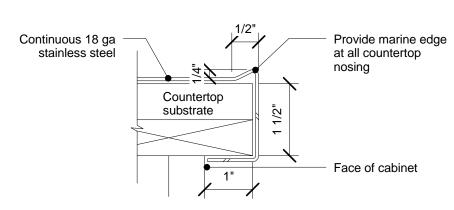



6 MARINE EDGE DETAIL

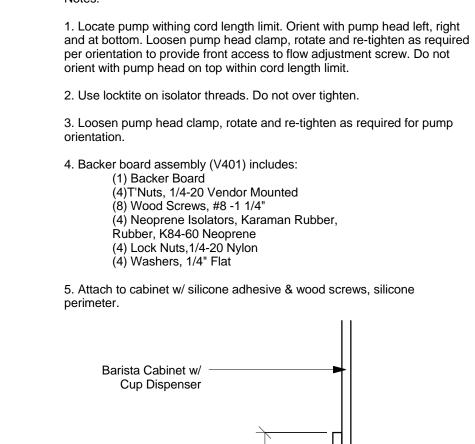

Scale: 1 1/2" = 1'-0"

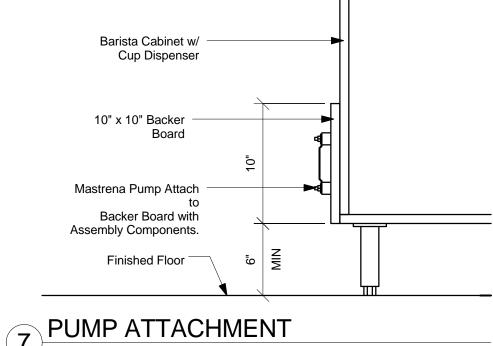


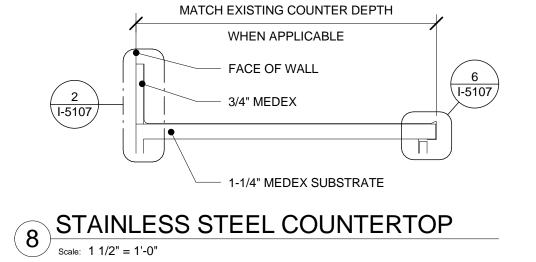

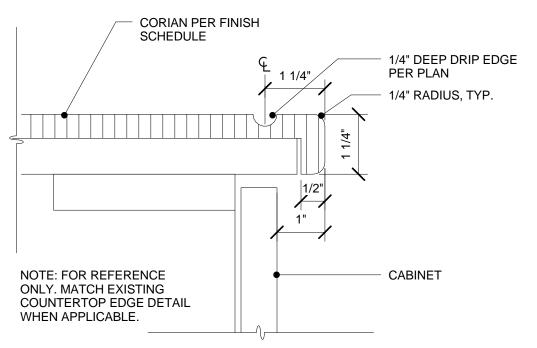

9 TYP. CORIAN DRIP EDGE - BACKLINE

| Scale: 6" = 1'-0"

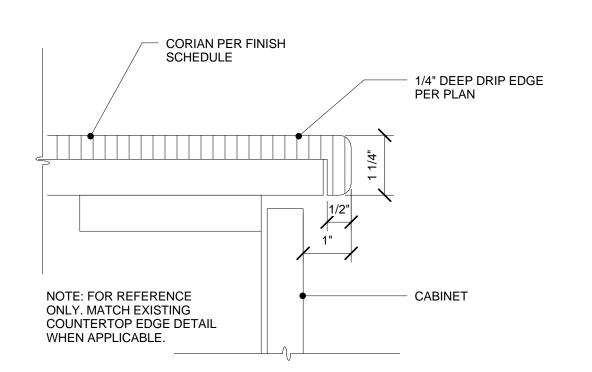

TYP. CORIAN EDGE - FRONTLINE

Scale: 6" = 1'-0"



STARBUCKS COFFEE COMPANY 2401 UTAH AVENUE SOUTH SEATTLE, WASHINGTON 98134

(206) 318-1575 THESE DRAWINGS AND SPECIFICATIONS ARE CONFIDENTIAL AND SHALL REMAIN THE SOLE PROPERTY OF STARBUCKS CORPORATION, WHICH IS THE OWNER OF THE COPYRIGHT IN THIS WORK. THEY SHALL NOT BE REPRODUCED (IN WHOLE OR IN PART), SHARED WITH THIRD PARTIES OR USED IN ANY MANNER ON OTHER PROJECTS OR EXTENSIONS TO THIS PROJECT WITHOUT THE PRIOR WRITTEN CONSENT OF STARBUCKS CORPORATION. THESE DRAWINGS AND SPECIFICATIONS ARE INTENDED TO EXPRESS DESIGN INTENT FOR A PROTOTYPICAL STARBUCKS STORE (WHICH IS SUBJECT TO CHANGE AT ANYTIME) AND DO NOT REFLECT ACTUAL SITE CONDITIONS. NEITHER PARTY SHALL HAVE ANY OBLIGATION NOR LIABILITY TO THE OTHER (EXCEPT STATED ABOVE) UNTIL A WRITTEN AGREEMENT IS FULLY EXECUTED BY BOTH PARTIES.

ARCHITECT OF RECORD





Rev Date By Description			Re	vision Schedule
	Rev	Date	Ву	Description
			L	

FARWELL

STORE #:	2305
PROJECT #:	04217-001
CONCEPT:	MCS
PALETTE:	HERITAGE
ISSUE DATE:	12 09 13
DESIGN MANAGER:	S. RYCHLIK
LEED® AP:	N/A
PRODUCTION DESIGNER:	C. ALINOVICH
CHECKED BY:	K. GORIN


SHEET TITLE:


CASEWORK DETAILS


SCALE: SHEET NUMBER:


I-5107

As indicated

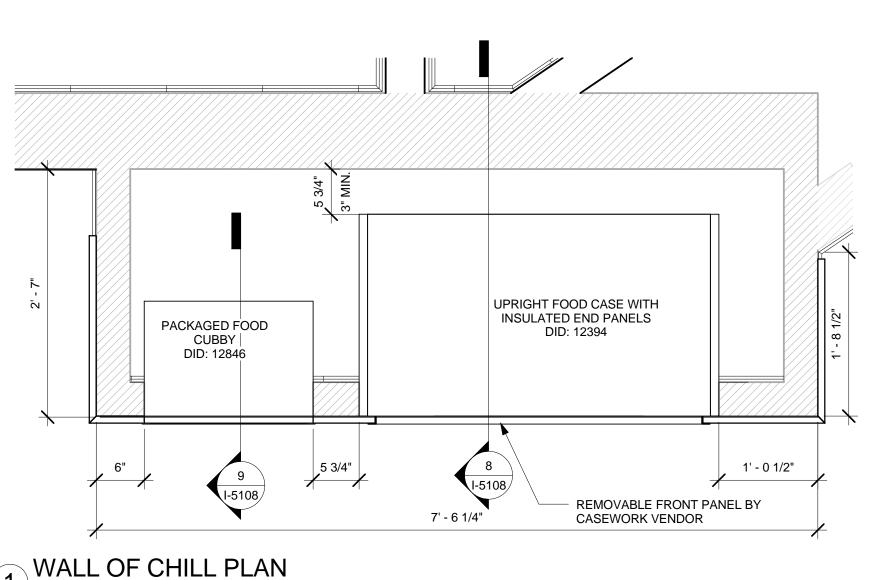

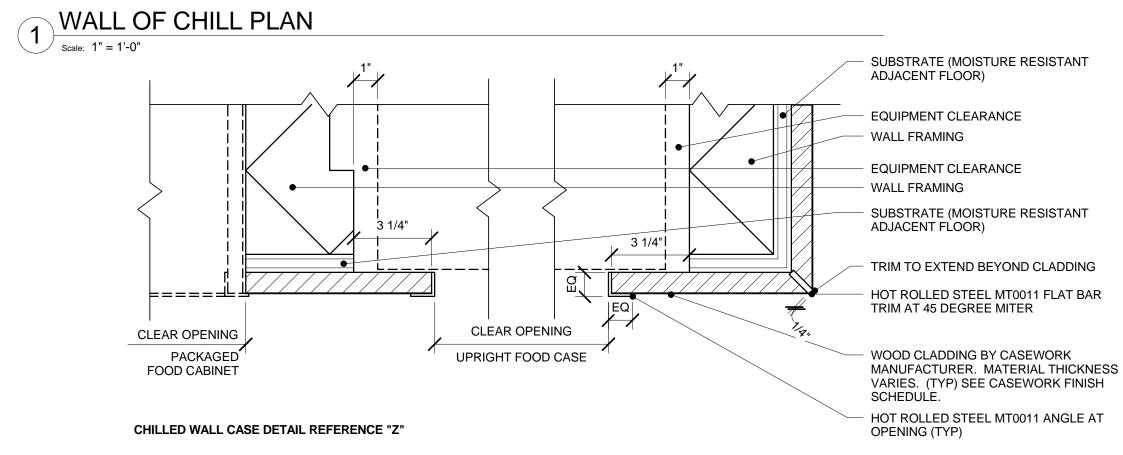


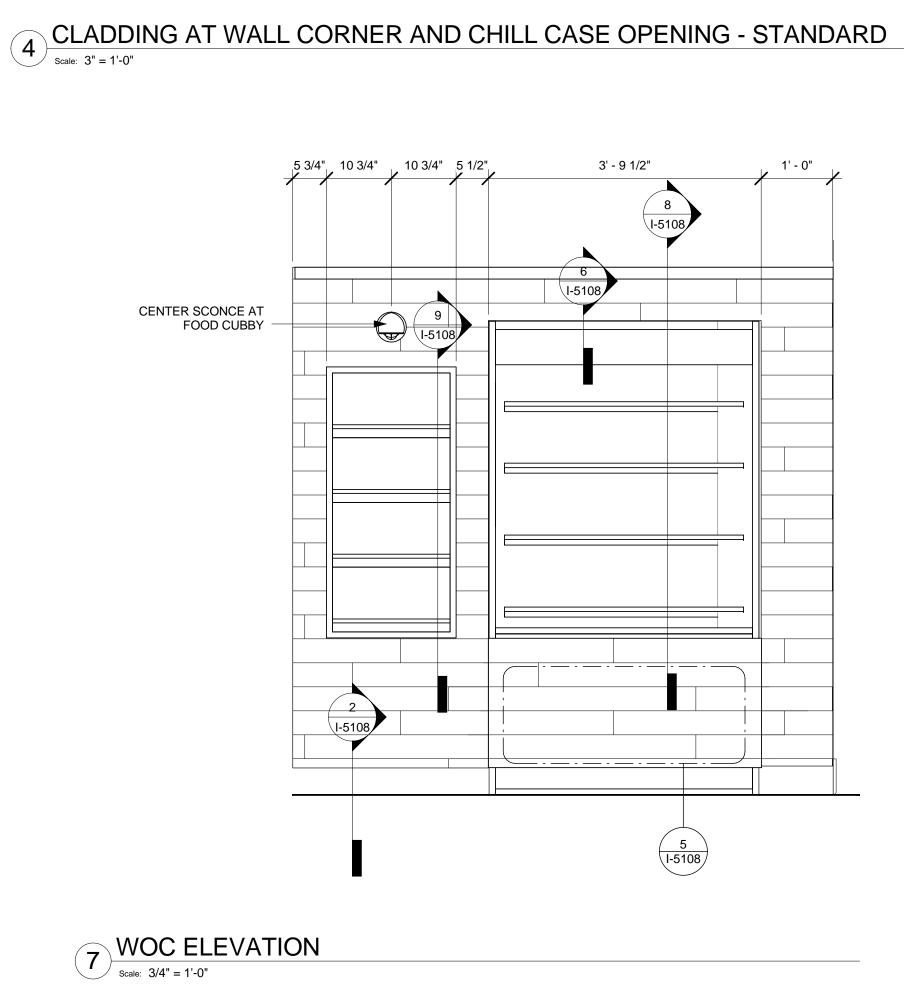

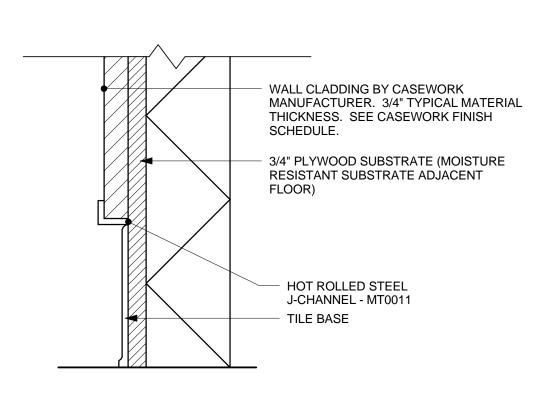


CHILLED WALL CASE DETAIL REFERENCE "E-E"


2 CLADDING AT BASE Scale: 3" = 1'-0"

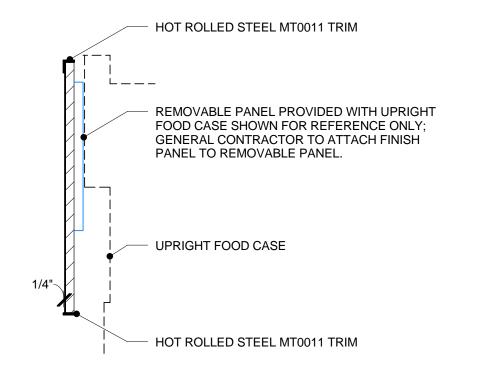

CHILLED WALL CASE DETAIL REFERENCE "C-C"

REMOVABLE PANEL AT CHILLED CASE

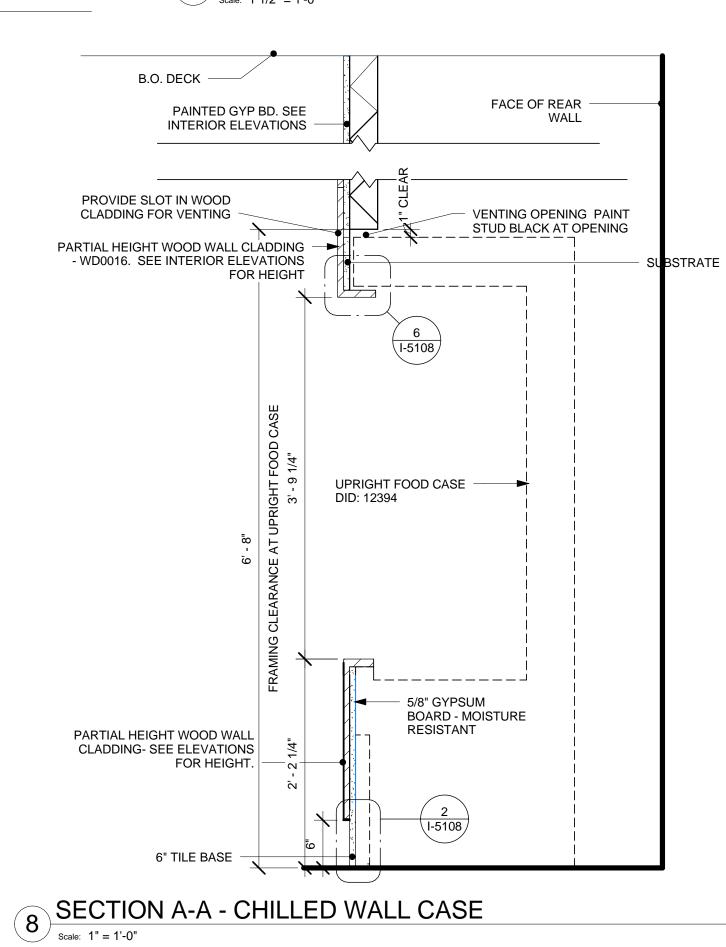


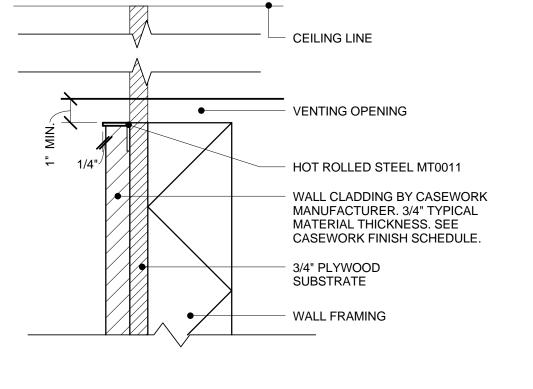

CHILLED WALL CASE DETAIL REFERENCE "F-F"


CLADDING AT CEILING



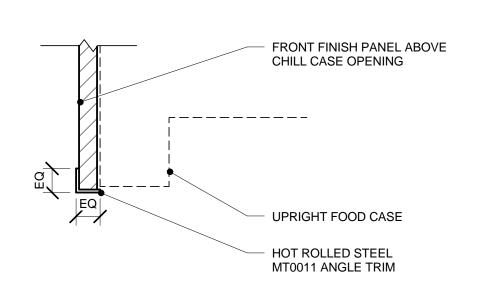

CHILLED WALL CASE DETAIL REFERENCE "D-D"

6 CLADDING AT TOP OF CHILLED CASE OPENING

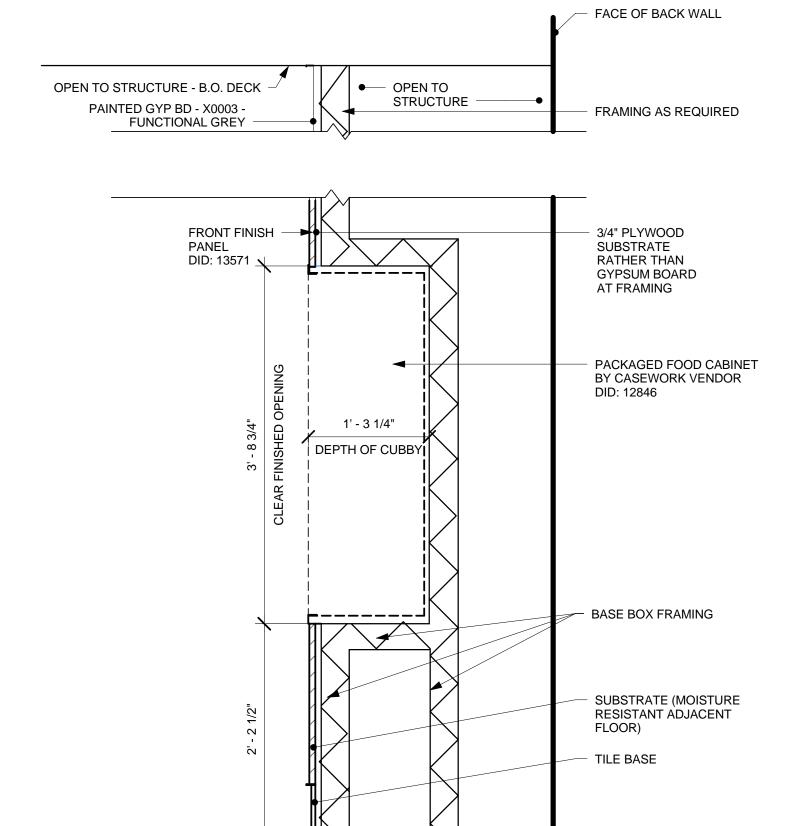

9 SECTION B-B - PACKAGED FOOD INSERT CABINET

| Scale: 1" = 1'-0"



STARBUCKS COFFEE
COMPANY
2401 UTAH AVENUE SOUTH


THESE DRAWINGS AND SPECIFICATIONS ARE CONFIDENTIAL AND SHALL REMAIN THE SOLE PROPERTY OF STARBUCKS CORPORATION, WHICH IS THE OWNER OF THE COPYRIGHT IN THIS WORK. THEY SHALL NOT BE REPRODUCED (IN WHOLE OR IN PART), SHARED WITH THIRD PARTIES OR USED IN ANY MANNER ON OTHER PROJECTS OR EXTENSIONS TO THIS PROJECT WITHOUT THE PRIOR WRITTEN CONSENT OF STARBUCKS CORPORATION. THESE DRAWINGS AND SPECIFICATIONS ARE INTENDED TO EXPRESS DESIGN INTENT FOR A PROTOTYPICAL STARBUCKS STORE (WHICH IS SUBJECT TO CHANGE AT ANYTIME) AND DO NOT REFLECT ACTUAL SITE CONDITIONS. NEITHER PARTY SHALL HAVE ANY OBLIGATION NOR LIABILITY TO THE OTHER (EXCEPT STATED ABOVE) UNTIL A WRITTEN AGREEMENT IS FULLY EXECUTED BY BOTH PARTIES.

SEATTLE, WASHINGTON 98134

(206) 318-1575

ARCHITECT OF RECORD



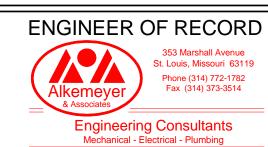

	Revision Schedule								
Rev	Date By Description								

ADY & FARWELL

ADDRESS:
7 N. FARWELL STREET

WAUKEE, WI 53202

WAUKEE COUNTY

STORE #: 2305 PROJECT #: 04217-001 MCS CONCEPT: PALETTE: HERITAGE ISSUE DATE: 12 09 13 DESIGN MANAGER: S. RYCHLIK LEED $^{ extsf{R}}$ AP: N/A PRODUCTION DESIGNER: C. ALINOVICH CHECKED BY: K. GORIN

SHEET TITLE:


CASEWORK DETAILS

SCALE: As indicated

SHEET NUMBER:

I-5108

3 PM Y:\WI - Brady & Farwell - Milwaukee\drawings\arch\B

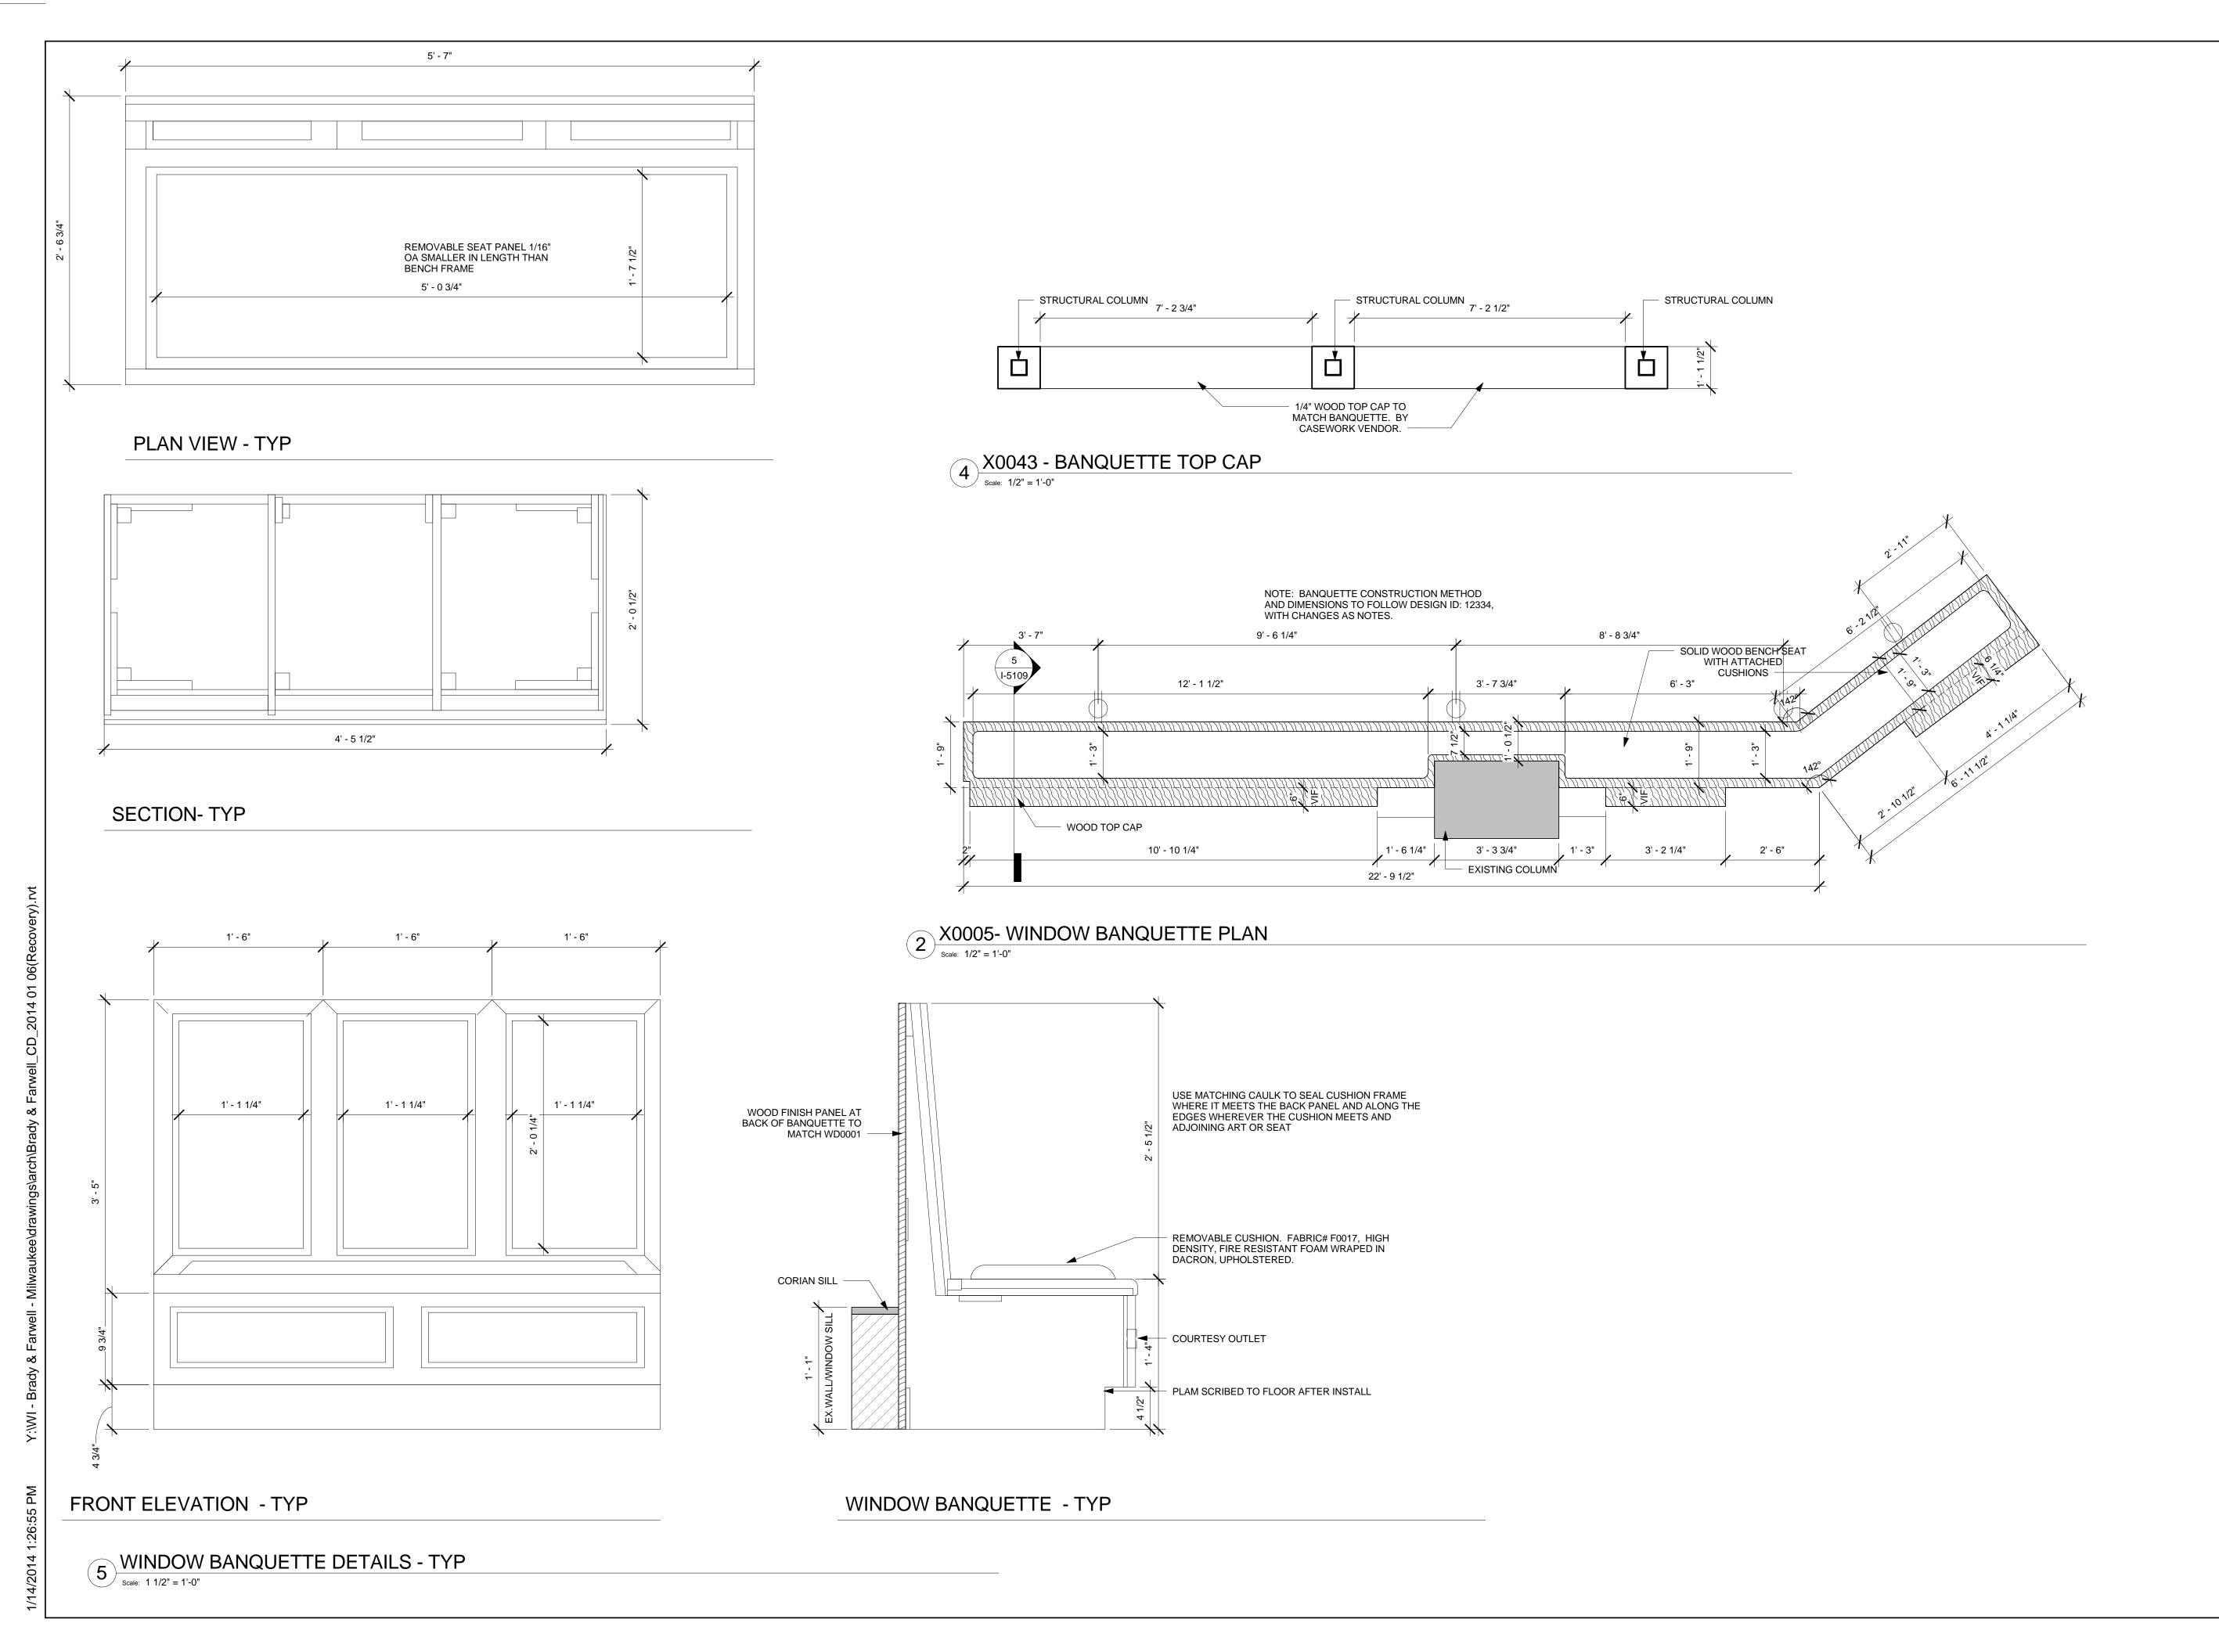



STARBUCKS COFFEE COMPANY

2401 UTAH AVENUE SOUTH SEATTLE, WASHINGTON 98134 (206) 318-1575

THESE DRAWINGS AND SPECIFICATIONS ARE CONFIDENTIAL AND SHALL REMAIN THE SOLE PROPERTY OF STARBUCKS CORPORATION, WHICH IS THE OWNER OF THE COPYRIGHT IN THIS WORK. THEY SHALL NOT BE REPRODUCED (IN WHOLE OR IN PART), SHARED WITH THIRD PARTIES OR USED IN ANY MANNER ON OTHER PROJECTS OR EXTENSIONS TO THIS PROJECT WITHOUT THE PRIOR WRITTEN CONSENT OF STARBUCKS CORPORATION. THESE DRAWINGS AND SPECIFICATIONS ARE INTENDED TO EXPRESS DESIGN INTENT FOR A PROTOTYPICAL STARBUCKS STORE (WHICH IS SUBJECT TO CHANGE AT ANYTIME) AND DO NOT REFLECT ACTUAL SITE CONDITIONS. NEITHER PARTY SHALL HAVE ANY OBLIGATION NOR LIABILITY TO THE OTHER (EXCEPT STATED ABOVE) UNTIL A WRITTEN AGREEMENT IS FULLY EXECUTED BY BOTH PARTIES.

ARCHITECT OF RECORD





Revision Schedule
Rev Date By Description

JECT NAME:

ADY & FARWELL

JECT ADDRESS:

7 N. FARWELL STREET

WAUKEE, WI 53202

WAUKEE COUNTY

STORE #: 2305 PROJECT #: 04217-001 CONCEPT: MCS PALETTE: HERITAGE ISSUE DATE: 12 09 13 DESIGN MANAGER: S. RYCHLIK LEED® AP: N/A PRODUCTION DESIGNER: C. ALINOVICH CHECKED BY: K. GORIN


SHEET TITLE:

CASEWORK DETAILS

As indicated

SCALE:

SHEET NUMBER:

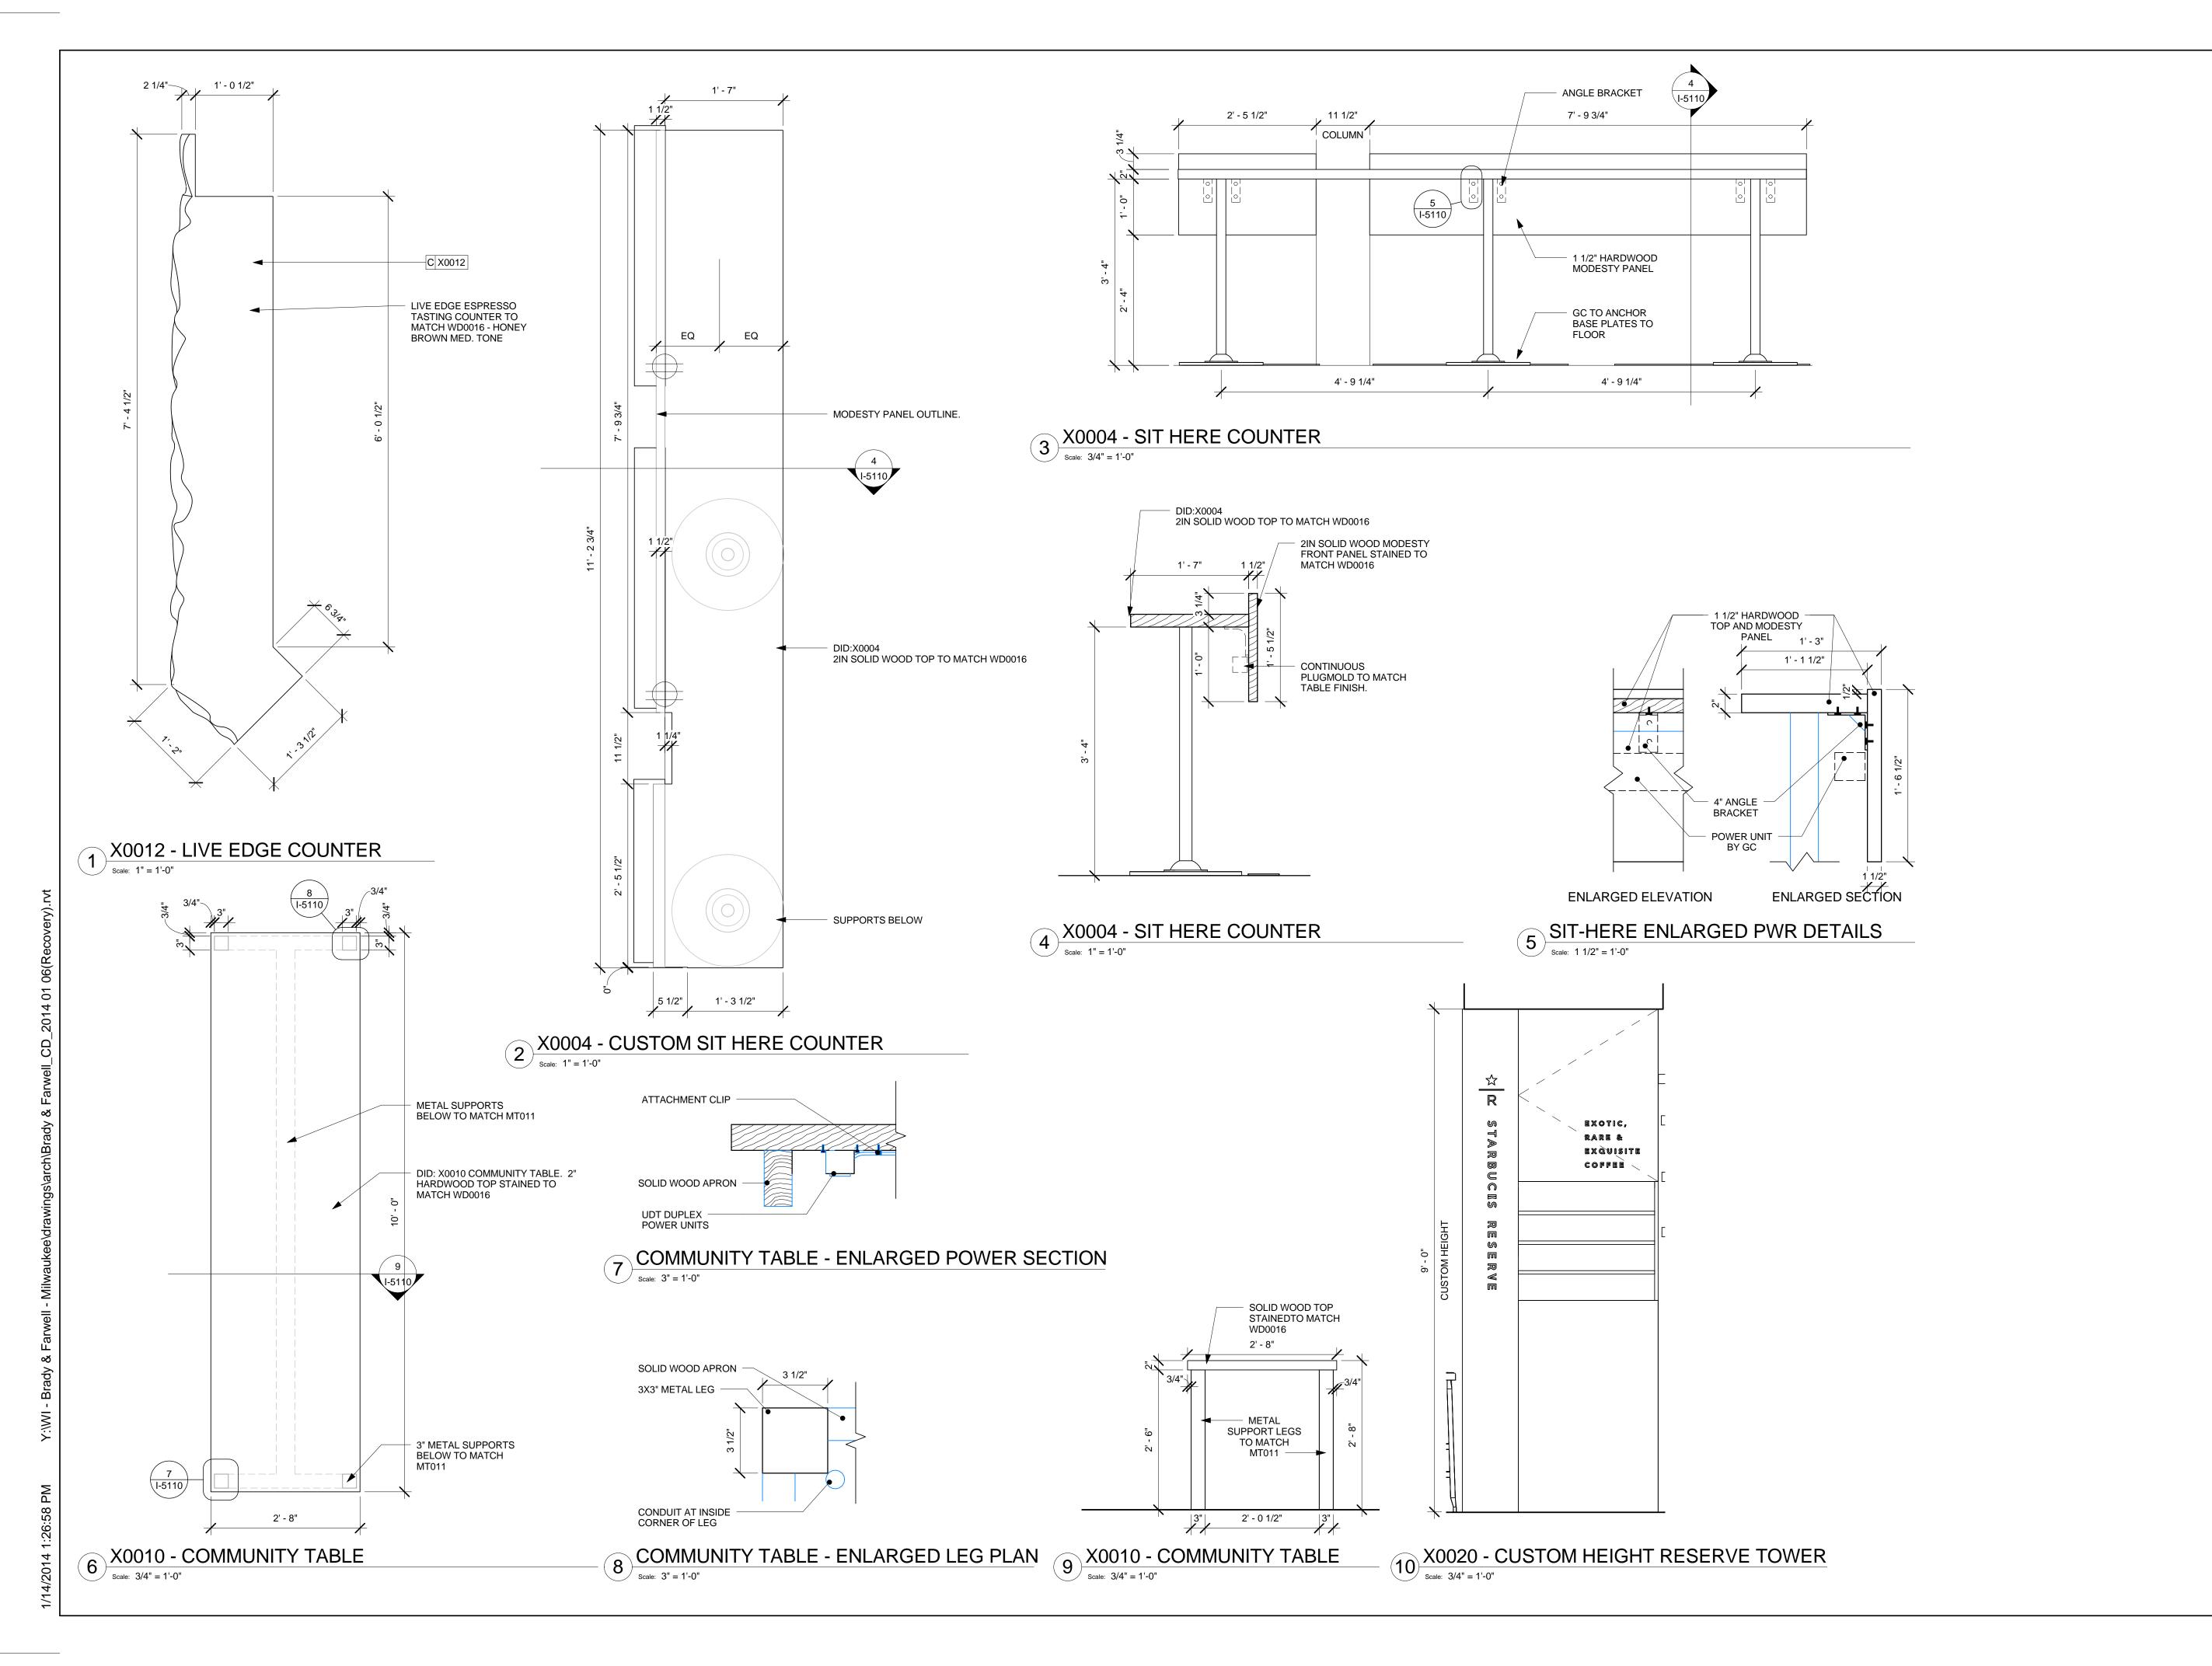



STARBUCKS COFFEE COMPANY 2401 UTAH AVENUE SOUTH

2401 UTAH AVENUE SOUTH SEATTLE, WASHINGTON 98134 (206) 318-1575

THESE DRAWINGS AND SPECIFICATIONS ARE CONFIDENTIAL AND SHALL REMAIN THE SOLE PROPERTY OF STARBUCKS CORPORATION, WHICH IS THE OWNER OF THE COPYRIGHT IN THIS WORK. THEY SHALL NOT BE REPRODUCED (IN WHOLE OR IN PART), SHARED WITH THIRD PARTIES OR USED IN ANY MANNER ON OTHER PROJECTS OR EXTENSIONS TO THIS PROJECT WITHOUT THE PRIOR WRITTEN CONSENT OF STARBUCKS CORPORATION. THESE DRAWINGS AND SPECIFICATIONS ARE INTENDED TO EXPRESS DESIGN INTENT FOR A PROTOTYPICAL STARBUCKS STORE (WHICH IS SUBJECT TO CHANGE AT ANYTIME) AND DO NOT REFLECT ACTUAL SITE CONDITIONS. NEITHER PARTY SHALL HAVE ANY OBLIGATION NOR LIABILITY TO THE OTHER (EXCEPT STATED ABOVE) UNTIL A WRITTEN AGREEMENT IS FULLY EXECUTED BY BOTH PARTIES.

ARCHITECT OF RECORD





	Revision Schedule								
Rev	Date	Ву	Description						

ADY & FARWELL ADY & FARWELL JECT ADDRESS: 7 N. FARWELL STREET WAUKEE, WI 53202 WAUKEE COUNTY

STORE #: 2305

PROJECT #: 04217-001

CONCEPT: MCS

PALETTE: HERITAGE

ISSUE DATE: 12 09 13

DESIGN MANAGER: S. RYCHLIK

LEED® AP: N/A

PRODUCTION DESIGNER: C. ALINOVICH

SHEET TITLE:

SHEET NUMBER:


CHECKED BY:


CASEWORK DETAILS

K. GORIN


As indicated


SCALE:

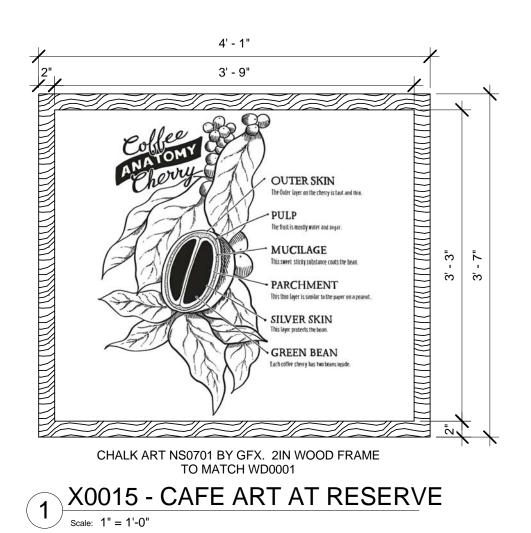

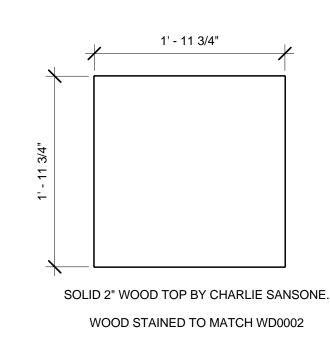

2 X0029 - SQUARE TABLETOPS
Scale: 1" = 1'-0"

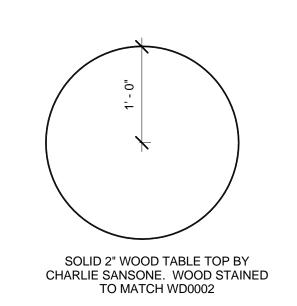

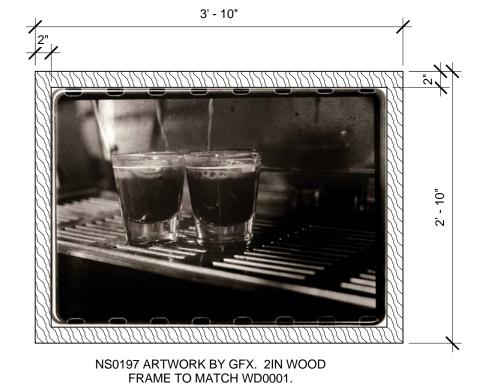

3 X0030 - ROUND TABLETOPS

Scale: 1" = 1'-0"





STARBUCKS COFFEE COMPANY

2401 UTAH AVENUE SOUTH SEATTLE, WASHINGTON 98134 (206) 318-1575

THESE DRAWINGS AND SPECIFICATIONS ARE CONFIDENTIAL AND SHALL REMAIN THE SOLE PROPERTY OF STARBUCKS CORPORATION, WHICH IS THE OWNER OF THE COPYRIGHT IN THIS WORK. THEY SHALL NOT BE REPRODUCED (IN WHOLE OR IN PART), SHARED WITH THIRD PARTIES OR USED IN ANY MANNER ON OTHER PROJECTS OR EXTENSIONS TO THIS PROJECT WITHOUT THE PRIOR WRITTEN CONSENT OF STARBUCKS CORPORATION. THESE DRAWINGS AND SPECIFICATIONS ARE INTENDED TO EXPRESS DESIGN INTENT FOR A PROTOTYPICAL STARBUCKS STORE (WHICH IS SUBJECT TO CHANGE AT ANYTIME) AND DO NOT REFLECT ACTUAL SITE CONDITIONS. NEITHER PARTY SHALL HAVE ANY OBLIGATION NOR LIABILITY TO THE OTHER (EXCEPT STATED ABOVE) UNTIL A WRITTEN AGREEMENT IS FULLY EXECUTED BY BOTH PARTIES.

ARCHITECT OF RECORD





Revision Schedule							
Rev	Date By Description						

ROJECT NAME:

RADY & FARWELL

ROJECT ADDRESS:

677 N. FARWELL STREET

IILWAUKEE, WI 53202

IILWAUKEE COUNTY

STORE #: 2305

PROJECT #: 04217-001

CONCEPT: MCS

PALETTE: HERITAGE

ISSUE DATE: 12 09 13

DESIGN MANAGER: S. RYCHLIK

LEED® AP: N/A

PRODUCTION DESIGNER: C. ALINOVICH

CHECKED BY: K. GORIN

SHEET TITLE:

DESIGN DETAILS

1" = 1'-0"

SHEET NUMBER:

	DOOR SCHEDULE - "D"						
DESIGN ID	COUNT	DESCRIPTION	RESP.	COMMENTS			
DOOR			·				
10086	1	DOOR - SINGLE IMPACT DOUBLE ACTING - 36IN 915MM	GC	ELIASON DOOR WITH HARDWARE PACKAGE. DOOR FINISH - PL0012 - WEATHERED GREY WITH GRAIN. BRUSHED STANILESS STEEL KICKPLATE FINISH.			
13156	2	DOOR - SINGLE FLUSH - 900MM 35IN	GC				

DEGICALID	COUNT	DESCRIPTION	DECD	COMMENTO
DESIGN ID	COUNT	DESCRIPTION	RESP.	COMMENTS
COOLING	4	EDIDOE LINDEDCOLINITED O DOOD 40IN	14/11	ENERGY STAR COMPLIANT
10473	1	FRIDGE UNDERCOUNTER 2 DOOR - 48IN 1220MM	WH	ENERGY STAR COMPLIANT
10970	1	FRIDGE REACH IN 1 DOOR LH - 29IN 735MM	WH	ENERGY STAR COMPLIANT
EQUIPMENT				
10845	2	OVEN TURBOCHEF CONVECTION MICROWAVE	WH	TURBOCHEF
11851	1	BREWER CLOVER	WH	
12631	1	GRINDER DITTING KR804	WH	
FOOD CASE				
12394	1	FOOD CASE - UPRIGHT - 46IN 1170MM - BLACK	WH	
ICE			•	·
10102	1	ICE - BIN 590LB	VD	
10344	1	ICE - BIN DROP IN 90LB 40KG	VD	ELKAY
10527	1	ICE - BIN DROP IN 45LB	WH	
10971	1	ICE - MACHINE 625LB AIR COOLED SIDE VENT	WH	ENERGY STAR COMPLIANT
OTHER		1	l .	1
10091	1	CUP DISPENSER TALL HOT VERTICAL	WH	
10305	2	TRASH DROP RING LINER SQUARE - BLACK	WH	
10314	1	SCALE DIGITAL WITH ADJUSTABLE DISPLAY MOUNT	WH	
10396	1	CUP DISPENSER SHORT HOT VERTICAL	WH	
10467	1	FILE CABINET 2 DRAWER	WH	
10501	1	FIRE EXTINGUISHER	GC	VERIFY QUANTITY WITH LOCAL FIR
10301	'	TIRE EXTINGUISHER	GC	MARSHALL
10769	1	RESTROOM GRAB BAR VERTICAL - 18IN 455MM	WH	
10791	2	CUP DISPENSER GRANDE VENTI COLD VERTICAL	WH	
10829	13	CORNER GUARD - 1.25IN 30MM - PEWTER	WH	
10855	2	CUP DISPENSER GRANDE VENTI HOT VERTICAL	WH	
10858	1	CUP DISPENSER TALL COLD VERTICAL	WH	
10992	1	PAPER TOWEL DISPENSER HALF SIZE - TRANSLUCENT GRAY	WH	
11115	1	SOAP DISPENSER SINK MOUNTED	WH	BACKBAR
11823	1	SCALE DIGITAL	WH	
13330	1	MOBILE CUP DISPENSER CADDY	WH	
13584	1	CUP DISPENSER TRENTA COLD VERTICAL	WH	
STORAGE			1	
10176	1	ROLLING PASTRY TRAY RACK	WH	
10222	1	WIRE SHELF GRID AT SINK	WH	
10293	<u>·</u> 1	10 COMP LOCKER	WH	ATTACH TO WALL
10416	7	WORKROOM WIRE SHELVING	WH	
10462	7	WORKROOM WIRE SHELVING POSTS	WH	
10698	1	MOP RACK WITH 3 HOLDERS	WH	
10838	1	ROLLING WIRE CART FOR 3 COMP SINK	WH	

		SIGNAGE S	CHEDULE	- "S"	
DESIGN ID	COUNT	DESCRIPTION	RESP.	BULB	COMMENTS
SIGNAGE - D	DISK				
13157	1	SIGN - DISK DF ILLUMINATED SUSPENDED EVOLVED - 18IN 455MM	VD	LED	
13164	1	SIGN - DISK SF ILLUMINATED FLUSH MOUNTED EVOLVED - 60IN 1525MM	VD	LED	BY HILTON DISPLAYS. CONTACT: CHARLEA INGRAM T: 864.313.2533. CHARLEAINGRAM@HILTONDS PLAYS.COM
SIGNAGE - V	VORDMAR	<			
13291	1	SIGN - INLINE ILLUMINATED FLUSH MOUNTED - 8IN 205MM	VD	LED	BY HILTON DISPLAYS. CONTACT: CHARLEA INGRAM T: 864.313.2533. CHARLEAINGRAM@HILTONDS PLAYS.COM

		GRAPHICS SCHEDULE -	"G"	
DESIGN ID	COUNT	DESCRIPTION	RESP.	COMMENTS
GRAPHICS -	INTERIOR	MENU		
12837	5	MENU BOARD - 1 FRONT PANEL INSERT STYLE	WH	
12838	3	MENU BOARD - DAILY OFFERING CHALKBOARD FRONT PANEL RECTANGULAR	WH	
12839	8	MENU BOARD - UNIVERSAL MOUNTING HARDWARE FOR FRONT PANELS	WH	
X0015	1	CAFE ART AT RESERVE	VD	PROVIDED BY GFX. CAFE COFFEE CHALK ART - NS0702, COFFEE ANATOMY. CHALKBOARD ART WITH FRAME STAINED TO MATCH CHAIR RAIL. OVERALL DIMENSIONS: 4'-1" x 3'-7". SEE INTERIOR ELEVATIONS FO MORE INFORMATION.
X0023	1	COMMUNITY BOARD	VD	PROVIDED BY GFX. CONTACT: MARY SANSONE. SEE INTERIOR ELEVATIONS FOR CLARIFICATION. OVERALL DIMENSIONS: 3' 10" x 2' 9".
X0024	1	ARTWORK AT SOFT SEATS	VD	PROVIDED BY GFX. CONTACT: MARY SANSONE. SEE INTERIOR ELEVATIONS FOR CLARIFICATION. OVERALL DIMENSIONS: 3' 10" x 2' 9".
GRAPHICS -	OTHER			
10753	1	RESTROOM SIGN SET ACCESSIBLE	WH	
X0041	2	EVOLVED LOGO DISK VINYL DECAL	VD	PROVIDED BY GFX. CONTACT: MARY SANSONE. SEE INTERIOR ELEVATIONS FOR CLARIFICATION. VINYL EVOLVED WINDOW DISK TO ADHERE TO FIRE RATED DOUBLE DOORS TO COMMON HALLWAY. SEE INTERIOR ELEVATIONS FOR MORE INFORMATION/DIMENSIONS.

		PLUMBING FIXTURE SCHED		
DESIGN ID	COUNT	DESCRIPTION	RESP.	COMMENTS
X0001	1	GREASE TRAP	GC	REFER TO PLUMBING SHEETS FOR SPECIFICATIONS
DRAIN				or zon fortherte
10294	5	DRAIN - FLOOR SINK SQUARE - 12IN 305MM	GC	REFER TO PLUMBING SHEETS FOR SPECIFICATIONS
10309	5	DRAIN - FLOOR SINK WITH HALF GRATE SQUARE - 12IN 305MM	GC	REFER TO PLUMBING SHEETS FOR SPECIFICATIONS
FAUCET				
10152	1	FAUCET - DOUBLE LABORATORY WITH BENT RISER SPOUT	WH	
10153	1	FAUCET - WATER TOWER - 12IN 305MM	WH	
10215	2	FAUCET - DOUBLE LABORATORY WITH SWING SPOUT	WH	
10447	1	FAUCET - PRE RINSE SPRAYER WALL MOUNTED	WH	
10597	1	FAUCET - SINGLE HANDLE	WH	
10804	1	FAUCET - PRE RINSE SWING SPOUT	WH	
10874	1	FAUCET - HOT WATER DISPENSER GOOSENECK	WH	
10922	1	FAUCET - MOP SINK WALL MOUNTED	WH	
10943	1	FAUCET - SINGLE LABORATORY WITH SWING SPOUT	WH	
11003	1	FAUCET - DIPPERWELL	WH	
FILTER				
12896	1	FILTER - BRINE TANK	WH	
12899	2	FILTER - POLY GLASS VESSEL	WH	
13076	1	FILTER - PREFILTRATION SYSTEM	WH	
13080	1	FILTER - HEAD QUAD	WH	
13081	4	FILTER - CARBON FILTER CARTRIDGE	WH	
13082	1	FILTER - WATER SOFTENER TWIN	WH	
13149	1	FILTER - PRESSURE GAUGE	WH	
SINK				
10505	1	SINK - RINSE DROP IN - 27X20IN 685X510MM	WH	
10549	1	SINK - RINSE DROP IN SST - 12X20IN 305X510MM	WH	
10995	1	SINK - MOP - 24X24IN 610X610MM	WH	
12808	1	SINK - UTENSIL RINSE WITH GRATE SST - RH - 14X20IN 355X510MM	WH	
13264	1	SINK - 3 COMP WORK SST - 93IN 2350MM	WH	

		LIGHTING FIX	CTURE SCH	IEDULE - "L"	
DESIGN ID	COUNT	DESCRIPTION	RESP.	BULB	COMMENTS
EXIT					
11419	3	EMERGENCY LIGHT DOUBLE - BLACK	VD	LED 5W LOW ENERGY OR EQUAL	
11611	3	EMERGENCY EXIT LIGHT - WHITE	VD	LED 5W LOW ENERGY OR EQUAL	
11649	2	EMERGENCY LIGHT DOUBLE - WHITE	VD	CFL 9W SELF-BALLAST DECORATIVE OR EQUAL	
LAMP					
12866	2	FL T5 10-19W - 22IN 550MM	VD		PROVIDED BY CED. TO BE USED WITH DID 11879
12890	12	FL T8 20-29W - 48IN 1220MM	VD		
12894	12	INCAND EDISON T9 30W BEACON FILAMENT	VD		PROVIDED BY CED. USE WITH DID 12348
12903	19	LED PAR 30S 10-19W NFL	VD		
12906	2	LED PAR 20 1-9W NFL - WHITE	VD		PROVIDED BY CED
13147	4	CFL SP 20-29W	VD		
X0003	6	40W EDISON BULB	VD		USE WITH DID X0002
X0032	10	100W INCANDESCENT	VD	100W MAX	USE WITH ID X0031
OTHER			•		
12331	1	FLOOR LAMP PHARMACY - BRONZE DARK PATINA MT0005	WH	LED 5W LOW ENERGY OR EQUAL	
PENDANT					
12269	4	PENDANT - SMALL SCHOOLHOUSE - MILK GLASS GL0001	VD	(1) 12885 - CFL G30 10-29W	
12348	11	PENDANT - SMALL METAL MESH CYLINDER - BLACKENED STEEL MT0019	WH	(1) 12894 - INCAND T9 EDISON 30-39W	
X0031	10	FLUSH PENDANT - SMALL SCHOOLHOUSE - MILK GLASS GL0001	VD	(1) X0032	THURMAN FLUSH CEILING FIXTURE POLISHED NICKEL FINISH. ITEM #A5162 W/FLARED 12" SCHOOLHOUSE SHADE. REJUVENATION. T: 888.401.1900. TRADESALES@REJUVENAION.COM
RECESSED	CAN			'	
12861	2	CAN - RECESSED HOUSING ADJUSTABLE - 4IN 100MM - NEW CEILING	VD	(1) 12905 - LED PAR 20 1-9W NARROW FLOOD	PROVIDED BY CED
12869	18	CAN - RECESSED TRIM BAFFLE - 5IN 125MM - WHITE	VD		
12907	17	CAN - RECESSED INTEGRATED LED HOUSING - 5IN 125MM - 600LM NEW CEILING	VD		
13241	2	CAN - RECESSED TRIM ADJUSTABLE GIMBAL RING - 4IN 100MM - WHITE	VD		PROVIDED BY CED
SCONCE					
11879	2	SCONCE - RESTROOM VANITY BOWED - SATIN NICKEL	VD	(1) 12866 - FL T5 10-19W 22IN (550MM)	FSG
X0002	6	SCONCE - ANTIQUE GLASS SHADE - MILK GLASS GL0001	VD	(1) 12885 - CFL G30 10-19W	FIXTURE BY RESTORATION HARDWARE.
STRIP			•		
12552	12	TASK LIGHT INTEGRATED LED - 22IN 560MM - BLACK	VD	(6) INTEGRAL LED 1W	JUMPER CORD REQUIRED WHEN CONNECTING MULTIPLE UNITS
TRACK					
11427	16	TRACK - FIXTURE ENCLOSED - 5IN 125MM - WHITE	VD		
12934	1	TRACK - WITH CONNECTORS - 4FT 122CM - WHITE	VD		
12935	2	TRACK - WITH CONNECTORS - 8FT 244CM - WHITE	VD		
TROFFER			1	1	1
11404	4	TROFFER - RECESSED - 48X24IN 1220X610MM - WHITE	VD	(3) 12890 - FL T8 20-29W	PROVIDED BY CED

	SITE SCHEDULE - "Y"						
DESIGN ID	COUNT	DESCRIPTION	RESP.	COMMENTS			
X0033	1	AWNING - STOREFRONT - BLACK	VD	BY HILTON DISPLAYS. SUNBRELLA FIRE RESISTANT AWNING 8608 BLACK. SEE EXTERIOR ELEVATIONS AND SITE PLAN FOR DETAILS AND DIMENSIONS.			
X0040	1	AWNING - STOREFRONT - BLACK	VD	BY HILTON DISPLAYS. SUNBRELLA FIRE RESISTANT AWNING 8608 BLACK. SEE EXTERIOR ELEVATIONS AND SITE PLAN FOR DETAILS AND DIMENSIONS.			
X0042	1	TRASH ENCLOSURE	VD	AMETCO ARCHITECTURAL FENCE. INSTALL PER MANUFACTURER'S INSTRUCTION.			
OTHER							
10042	1	BIKE RACK HOOP	WH				

FURNITURE SCHEDULE - "F"

		FURNITURE SCHEDULE	- r	
DESIGN ID	COUNT	DESCRIPTION	RESP.	COMMENTS
BANQUETTE				
12290	2	BANQUETTE - SETTEE ARM RH - DISTRESSED DARK WARM BROWN WD0001	WH	
12334	8	BANQUETTE - SETTEE - 54IN 1370MM - BRICK RED NATURAL F0017	WH	
12398	2	BANQUETTE - SETTEE ARM LH - DISTRESSED DARK WARM BROWN WD0001	WH	
12399	3	BANQUETTE - SETTEE ARM CENTER - DISTRESSED DARK WARM BROWN WD0001	WH	
CAFE				
12363	2	MERCH BAY UNIT BACK PANEL SOLID	WH	NOT PROVIDED BY CASEWORK VENDOR
12367	2	MERCH FEATURE CUBE FREESTANDING TALL	VD	NOT PROVIDED BY CASEWORK VENDOR
13191	1	MERCH BAY UNIT END PANELS METAL MESH	WH	NOT PROVIDED BY CASEWORK VENDOR
13331	2	MERCH BAY UNIT	WH	NOT PROVIDED BY CASEWORK VENDOR
CHAIR				
12146	10	CHAIR - CAFE SLATTED METAL SUITE WITH ARMS - BLACK MT0028	WH	
12164	2	CHAIR - LOUNGE CLUB - CARAMEL BROWN NATURAL F0008	WH	
12346	25	CHAIR - CAFE SCHOOLHOUSE - DISTRESSED DARK WARM BROWN WD0001	WH	
13368	8	CHAIR - STOOL 29IN 735MM INDUSTRIAL - DISTRESSED DARK BROWN PRESSBOARD WD0012	WH	
DESK				
10123	1	DESK - MANAGERS WORKSTATION - 60X30X30IN 1525X760X760MM - ALMOND LAMINATE	WH	
10605	1	DESK - MANAGERS WORKSTATION KEYBOARD TRAY - BLACK PLASTIC	WH	
10809	1	DESK - MANAGERS WORKSTATION SHELVES WALL MOUNTED - ALMOND LAMINATE	WH	
MIRROR				
10342	2	MIRROR - RESTROOM - 18X36IN 455X915MM	WH	
OTHER				
10479	2	COAT HOOK 2 PRONG	WH	
10820	1	COAT HOOK STRIP - 46IN 1170MM	WH	
TABLE				
12160	1	TABLE - ACCESSIBLE METAL SUITE - 39X23IN 990X585MM - BLACK MT0028	WH	
12161	3	TABLE - CAFE METAL SUITE SQUARE - 30IN 760MM - BLACK MT0028	WH	
12212	3	TABLE - BASE BAR HEIGHT DOME ACCENT - 18X42IN 455X1065MM - HOT ROLLED STEEL MT0011	WH	
12356	1	TABLE - OCCASIONAL WOOD PLANK SQUARE - DISTRESSED HONEY BROWN WD0002	WH	
X0010	1	TABLE - ACCESSIBLE	VD	SEE CASEWORK DETAIL SHEET FOR CLARIFICATIONSTAIN WOOD TO MATCH WD0001.
X0029	7	TABLE - TOP SQUARE - 24IN 610MM - AMBER HONEY WD0005	VD	1" SOLID WOOD TOP STAINED TO MATCH WD0002. PROVIDED BY CHARLIE SANSONE. CJSSANSONE@ATT.NET. T: 847.204.6106
X0030	8	TABLE - TOP ROUND - 24IN 610MM - AMBER HONEY WD0005	VD	1" SOLID WOOD TOP STAINED TO MATCH WD0002. PROVIDED BY CHARLIE SANSONE. CJSSANSONE@ATT.NET. T: 847.204.6106
X0044	15	TABLE - BASE CAFE ORNATE - FLAT BLACK POWDERCOAT MT0028	VD	METAL BASES BY CHARLIE SANSON CJSSANSONE@ATT.NET. T: 847.204.6106.

DOOR SCHEDULE - "D"

COMMENTS

ELIASON DOOR WITH HARDWARE PACKAGE. DOOR FINISH - PL0012 -WEATHERED GREY WITH GRAIN. BRUSHED STANILESS STEEL KICKPLATE FINISH.

DESCRIPTION

1 DOOR - SINGLE IMPACT DOUBLE ACTING - 36IN 915MM

13156 2 DOOR - SINGLE FLUSH - 900MM 35IN



STARBUCKS COFFEE
COMPANY
2401 UTAH AVENUE SOUTH
SEATTLE, WASHINGTON 98134

(206) 318-1575

THESE DRAWINGS AND SPECIFICATIONS ARE CONFIDENTIAL AND SHALL REMAIN THE SOLE PROPERTY OF STARBUCKS CORPORATION, WHICH IS THE OWNER OF THE COPYRIGHT IN THIS WORK. THEY SHALL NOT BE REPRODUCED (IN WHOLE OR IN PART), SHARED WITH THIRD PARTIES OR USED IN ANY MANNER ON OTHER PROJECTS OR EXTENSIONS TO THIS PROJECT WITHOUT THE PRIOR WRITTEN CONSENT OF STARBUCKS CORPORATION. THESE DRAWINGS AND SPECIFICATIONS ARE INTENDED TO EXPRESS DESIGN INTENT FOR A PROTOTYPICAL STARBUCKS STORE (WHICH IS SUBJECT TO CHANGE AT ANYTIME) AND DO NOT REFLECT ACTUAL SITE CONDITIONS. NEITHER PARTY SHALL HAVE ANY OBLIGATION NOR LIABILITY TO THE OTHER (EXCEPT STATED ABOVE) UNTIL A WRITTEN AGREEMENT IS FULLY EXECUTED BY BOTH PARTIES.

ARCHITECT OF RECORD





Revision Schedule

Rev Date By Description

AADY & FARWELL

AADY & FARWELL

SUBCT ADDRESS:

77 N. FARWELL STREET

LWAUKEE, WI 53202

LWAUKEE COUNTY

STORE #: 2305 PROJECT #: 04217-001 MCS CONCEPT: PALETTE: HERITAGE ISSUE DATE: 12 09 13 S. RYCHLIK DESIGN MANAGER: LEED® AP: N/A PRODUCTION DESIGNER: C. ALINOVICH K. GORIN CHECKED BY:

SCHEDULES

SCALE:
SHEET NUMBER:

SHEET TITLE:

I-6101

3 PM Y:\WI - Brady & Farwell - Milwaukee\drawings\arch\Brady &

V MG 50.75.04 1.07.07.07

WALL TREATMENT (LENGTH) SCHEDULE- "R"							
DESIGN ID	LENGTH	DESCRIPTION	RESP.	COMMENTS			
			·				
11284	104' - 8 1/2"	TILE BASE - BIANCO ALPI- 6x12in 150x305mm	WH	DIAMANTE GROUT SPECIFICATION - MAPEI 19 PEARL GREY			
12173	108' - 4 1/2"	CHAIR RAIL - 4in 100mm	VD	SEE CASEWORK FINISH SCHEDULE FOR MATERIAL			
12199	124' - 7 1/4"	VINYL WALL COVERING- BLACK STRIPE TEXTURE - 48in (1220) AFF	VD	SUPPLIER - KOROSEAL. DESCRIPTION: LEATHER-3. PART #: RJF 8676			
13101	260' - 1 1/2"	TILE BASE - GRAPHITE - 6x12in 150x305mm	WH	GROUT SPECIFICATION: LATICRETE45 - RAVEN			

		WALL TREATMENT (A	AREA) SCHEDU	JLE - "Q"
DESIGN ID	AREA	DESCRIPTION	RESP.	COMMENTS
Ceramic			'	
12326	387 SF	TILE - OLIVE GREY - 12x24in 305x610mm	SB	GROUT SPECIFICATION MAPEI 19
14290	129 SF	BACKBAR TILE	SB	PRATT & LARSON CERAMICS. 2X8 SMOOTH, GLAZED CERAMIC TILE.
Paint				
P551	5 SF	USEFUL GREY - EGGSHELL	GC	SHERWIN WILLIAMS PAINT. ALL CEILINGS TO BE PAINTED SW7050 - USEFUL GREY-ES.
Plastic				
11469	1849 SF	FRP - WHITE	GC	

		CEILING TREATMENT S	SCHEDULE -	· "U"
DESIGN ID	AREA	DESCRIPTION	RESP.	COMMENTS
OTHER				
10517	314 SF	ACT - WHITE - 2X2FT 61X61CM	VD	VINYL CLAD 2X2 ACT
11302	645 SF	ACT - WHITE - 2X4FT 61X122CM	VD	VINYL CLAD 2X2 ACT
X0034	990 SF	DECORATIVE TIN CEILING TILE	VD	DECORATIVE TIN CEILING TILE TO MATCH EXISTING CONDITION. THE AMERICAN TIN CELING CO. DESIGN PATTERN #4. UNFINISHED. T: 941.757.0123 SALES@AMERICANTINCEILINGS.COM
Paint				
P551	0 SF	USEFUL GREY - EGGSHELL	GC	SHERWIN WILLIAMS PAINT. ALL CEILINGS TO BE PAINTED SW7050 - USEFUL GREY-ES.

		FLOOR TREAT	MENT SCH	EDULE - "T"
DESIGN ID	AREA	DESCRIPTION	RESP.	COMMENTS
Carpet			•	
12231	51 SF	WALK OFF MAT	VD	GRAND ENTRANCE. PATTERN: TREADLINE. COLOR: CHARCOAL
Ceramic			•	
12203	511 SF	TILE - GRAPHITE - 12x24in 305x610mm	SB	GROUT: MAPEI 10 - BLACK
X0013	33 SF	EXTERIOR TILE- QUATTRO - 'AVENUE BLACK' - 1x1	VD	SUPPLIER: PORCELANOSA. COLOR: QUATTRO AVENUE BLACK. PRODUCT CODE: C223023421.
TERAZZO			•	
X0038	618 SF	TERAZZO FLOOR	VD	TERRAZZO FLOOR TO MATCH EXISTING CONDITION ONCE EXISTING TERRAZZO IS POLISHED AND RESTORED. INSTALL PER MANUFACTURER'S INSTRUCTIONS. ALIGN FLUSH WITH EXISTING FLOOR. FINAL FINISH TO BE SUBMITTED TO DESIGN MANAGER FOR FINAL APPROVAL. SOURCED THROUGH TERRAZZO & MARBLE SUPPLY COMPANY. WWW.TMSUPPLY.COM. 77 SOUTH WHEELING RD, WHEELING, IL 60090, T: 877.TM.SLABS

	CW FINISH - NCS		
LOCATION	DESCRIPTION	FINISH CODE	COMMENTS
2" TRIM AT BACKBAR TILE	WOOD	WD0051	PROVIDED BY CASEWORK VENDOR. STAIN TO MATCH WD0051
CORIAN SILL	CORIAN	CP0001	
ELIASON DOOR	PLASTIC LAMINATE - WEATHERED GREY WITH GRAIN	PL0012	
CABINETS			
BACKBAR UPPER STORAGE CUBBIES	PLASTIC LAMINATE - MEDIUM TONE BROWN WITH GRAIN	PL0014	
UNDERCOUNTER CABINET EDGE BANDING	PLASTIC LAMINATE - BLACK		
UNDERCOUNTER CABINET EXPOSED BACK, SIDE	PLASTIC LAMINATE - BLACK		
UNDERCOUNTER CABINET EXTERIOR	PLASTIC LAMINATE - MEDIUM TONE BROWN WITH GRAIN	PL0014	
UNDERCOUNTER CABINET INTERIOR	PLASTIC LAMINATE - ALMOND (ST655-S)		
CAFE			
CHAIR RAIL	WOOD - WARM BROWN DARK TONE DISTRESSED	WD0001	
CONDIMENT CART TOP	COMPOSITE - BLACK WITH FLECKS	CP0001	
CONDIMENT CART TOP	COMPOSITE - BLACK WITH FLECKS	CP0001	
CONDIMENT CART, ETAGERE, MERCH BAY EXTERIOR	PLASTIC LAMINATE - MEDIUM TONE BROWN WITH GRAIN	PL0014	
FOOD CASE WALL CLADDING	WOOD - BLONDE RUSTIC	WD0051	
COUNTERTOPS - BACKBAR			'
BACKBAR, SIDELINE COUNTERTOPS	COMPOSITE - BLACK WITH FLECKS	CP0001	
ESPRESSO COUNTERTOPS	STAINLESS STEEL - #4 BRUSHED 16GA SST		
ESPRESSO COUNTERTOPS	COMPOSITE - BLACK WITH FLECKS	CP0001	
HAND SINK COUNTERTOP	STAINLESS STEEL - #4 BRUSHED 16GA SST		
COUNTERTOPS - FRONT BAR			
HANDOFF PLANE	COMPOSITE - BLACK WITH FLECKS	CP0001	
POS, FRONTBAR COUNTERTOPS	COMPOSITE - BLACK WITH FLECKS	CP0001	
FINISH PANELS			
ESPRESSO FINISH PANELS	WOOD - BLONDE RUSTIC	WD0051	
FINISH PANEL MOUNTING BRACKETS	COLD ROLLED STEEL	MT0002	
FINISH PANEL TRIM DETAILS	HOT ROLLED STEEL WITH MATTE SEALER	MT0011	
HANDOFF, SIDELINE FINISH PANELS	WOOD - BLONDE RUSTIC	WD0051	
POS, FRONTBAR FINISH PANELS	WOOD - BLONDE RUSTIC	WD0051	
OTHER			
ESPRESSO TOP CAP	WOOD - WARM BROWN DARK TONE DISTRESSED	WD0001	LIVE EDGE
OVER "BLACK" DUPLEX OUTLETS IN WAINSCOT LOCATIONS	SWITCHPLATE - PART #4752-112-CD VENETIAN BRONZE		GC SUPPLIED

		CASEWORK SCHED		
DESIGN ID	COUNT	DESCRIPTION	RESP.	COMMENTS
X0004	2	SIT HERE COUNTER AT WINDOW	VD	PROVIDED BY CHARLIE SANSONE. CJSSANSONE@ATT.NET. T: 847.204.6106 SEE INTERIOR ELEVATIONS AND CASEWORK DETAIL SHEETS FOR MORE INFORAMATION
X0005	1	BANQUETTE AT WINDOW	VD	PROVIDED BY CHARLIE SANSONE. CJSSANSONE@ATT.NET. T: 847.204.6106 SEE INTERIOR ELEVATIONS AND CASEWORK DETAIL SHEETS FOR MORE INFORAMATION
X0016	4	2" WOOD TRIM AT BACKBAR/ELIASON	VD	PROVIDED BY CHARLIE SANSONE. CJSSANSONE@ATT.NET. T: 847.204.6106 SEE INTERIOR ELEVATIONS AND CASEWORK DETAIL SHEETS FOR MORE INFORAMATION. OVERALL LENGTH NEEDED: 42' - 0"
X0017	10	2" WOOD TRIM AT RESTROOM TILE	VD	PROVIDED BY CHARLIE SANSONE. CJSSANSONE@ATT.NET. T: 847.204.6106 SEE INTERIOR ELEVATIONS AND CASEWORK DETAIL SHEETS FOR MORE INFORAMATION. OVERALL LENGTH NEEDED: 42' - 8 1/2'
X0028	1	CORIAN WINDOW SILLS	VD	CORIAN WINDOW SILLS - CP0005. PROVIDED BY CASEWORK VENDOR. SEE CASEWORK SHEETS AND FINISH SCHEDULES FOR MORE INFORMATION. OVERALL LENGTH NEEDED: 95' - 6 1/2"
X0033	2	CROWN MOULDING	VD	PROVIDED BY CHARLIE SANSONE. CJSSANSONE@ATT.NET. T: 847.204.6106. CROWN MOULDING AT PERMIETER OF COFFERED CEILING ABOVE BANQUETTE AND SOFFIT AT BACKBAR. SEE INTERIOR ELEVATIONS AND RCP FOR CLARIFICATION OVERALL LENGTH NEEDED: 95' - 61/2"
X0035	1	COFFERED CEILING	GC	COFFERED CEILING CONSTRUCTION WITH P551 PAINT FINISH - INSET TIN CEILING PANELS SEE RCP DETAIL SHEETS FOR DIMENSIONS AND DETAILS.
X0036	1	OPEN SHELVES AT BACKBAR	VD	PROVIDED BY CHARLIE SANSONE. CJSSANSONE@ATT.NET. T: 847.204.6106. STAIN TO MATCH CHAIR RAIL. SEE CASEWORK DETAIL SHEETS AND INTERIOR ELEVATIONS FOR MORE INFORMATION
X0037	1	SHELVING BRACKETS	VD	VAN DYKES. ITEM # 02040365. STORE ID: 211529 IRON SHELF BRACKET. SOLD IN PAIRS. NEED TOTAL OF 3 PAIRS. VANDYKES.COM. 800.558.1234
X0038	1	WOOD WINDOW TRIM	VD	PROVIDED BY CASEWORK VENDOW. 2IN WOOD TRIM TO FRAME EXISTING WINDOW AT EXPANSION SPACE ENTRANCE. STAIN WOOD TO MATCH WD0001
X0043	1	BANQUETTE TOP CAP	VD	PROVIDED BY CHARLIE SANSONE. 1/4" TOP CAP AT BANQUETTE SETEE AT COLUMNS. STAIN WOOD TO MATCH BANQUETTE - WD0001. SEE ASEWORK PLAN AND DETAIL SHEETS FOR MORE INFORMATION.
CABINET				
11941	1	CABINET - WARMING CART BASE	VD	

	CASE	WORK MCS CAB	INET BASE OPTION SCHEDULE
DESIGN ID	COUNT	BASE OPTION	DESCRIPTION
11941	1	Other	CABINET - WARMING CART BASE
11945	2	Other	CABINET - 12IN 305MM
11971	1	Other	CABINET - SINK OR ICE BIN - 15IN 380MM
11972	1	Other	CABINET - ESPRESSO - 24IN 610MM
12007	2	Other	CABINET - SINK OR ICE BIN - 24IN 610MM
12043	2	Other	CABINET - POS - 29IN 735MM
12050	1	Box Base	CABINET - POS BRIDGE FOR SAFE - 22X27IN 560X685MM
12067	1	Other	CABINET - WARMING WITH TRASH DROP - 12IN 305MM
12080	4	Other	CABINET - 15IN 380MM
12096	1	Other	CABINET - WITH DRAWER - 15IN 380MM
12098	3	Other	CABINET - BREW GRIND - 24IN 610MM
13646	1	Other	CABINET - RESERVE CLOVER WITH DRAWER - 12IN 305MM

DECIGNUD	COLINIT	CASEWORK SCHEDULE		COMMENTS
DESIGN ID	COUNT	DESCRIPTION	RESP.	COMMENTS
11945	2	CABINET - 12IN 305MM	VD	
11971	1	CABINET - SINK OR ICE BIN - 15IN 380MM	VD	
11972	1	CABINET - ESPRESSO - 24IN 610MM	VD	
11977	12	CABINET - UPPER CUBBY - 24X16X21IN	VD	
		610X405X535MM		
12007	2	CABINET - SINK OR ICE BIN - 24IN 610MM	VD	PL0014
12043	2	CABINET - POS - 29IN 735MM	VD	PL0014
12050	1	CABINET - POS BRIDGE FOR SAFE - 22X27IN	VD	PL0014
12000		560X685MM	\ \bar{\bar{\bar{\bar{\bar{\bar{\bar{	1 20014
12067	1	CABINET - WARMING WITH TRASH DROP - 12IN	VD	PL0014
12007	'	305MM	110	1 20014
12080	4	CABINET - 15IN 380MM	VD	PL0014
12096	1	CABINET - WITH DRAWER - 15IN 380MM	VD	PL0014
12090	3	CABINET - BREW GRIND - 24IN 610MM	VD	PL0014
12846	1	CABINET - PACKAGED FOOD CUBBY INSET	VD	PL0014
13646	1	CABINET - RESERVE CLOVER WITH DRAWER -	VD	PL0014
		12IN 305MM		
X0020	1	CABINET - RESERVE TOWER - LH	VD	PL0014
CAFE				_
12236	1	CONDIMENT CART SINGLE TOP SOLID	VD	CP0005
		SURFACE		
13229	1	COFFEE FLOOR STAND WITH METAL MESH	WH	NOT PROVIDED BY CASEWORK
				VENDOR
13374	1	CONDIMENT CART SINGLE BASE FRAME	VD	
13377	1	CONDIMENT CART SINGLE FINISH PANELS	VD	WD0016
13399	1	CONDIMENT CART SINGLE METAL TOP	VD	
. 5556		ASSEMBLY	1	
COUNTERT	OΡ			
11917	1	COUNTERTOP - TRASH SOLID SURFACE - 15IN	VD	
. 1017	'	380MM		
11958	1	COUNTERTOP - WARMING SOLID SURFACE -	VD	
11930	'	42IN 1065MM	VD	
11982	1	COUNTERTOP - WARMING WITH FRONT	VD	
11902	'	BUMPER STAINLESS - 29IN 735MM	VD	
12011	1	COUNTERTOP - POS SOLID SURFACE - 80IN	VD	
12011	•	2030MM	VD	
12443	1	COUNTERTOP - CBS SOLID SURFACE - LH -	VD	
12440	'	100IN 2540MM	\ \bar{\bar{\bar{\bar{\bar{\bar{\bar{	
12771	1	COUNTERTOP - ESPRESSO RINSE SINK AND	VD	
12771	'	ICE BIN SOLID SURFACE - LH - 140IN 3555MM	VD	
12780	1	COUNTERTOP - BREW GRIND RINSE SINK AND	VD	
12700	'	TRASH SOLID SURFACE - LH - 117IN 2970MM	VD	
13265	1	COUNTERTOP - HAND SINK LOW SPLASH	VD	
13203	'	STAINLESS - 15IN 380MM	VD	
13355	1	COUNTERTOP - RESERVE CLOVER HANDOFF	VD	
15555	'	SOLID SURFACE - LH	VD	
13365	1	COUNTERTOP - RESERVE CORNER SOLID	VD	
15505	'	SURFACE - LH	VD	
DIEWALL		90.11.7102 2.1		
	1	DIEWALL ESPRESSO LL 140IN 2555MM	VD	
12765	1	DIEWALL - ESPRESSO - LH - 140IN 3555MM	VD	
12766	1	DIEWALL - ESPRESSO TOP CAP - LH - 140IN 3555MM	VD	
40000	4		VD	
13658	1	DIEWALL - RESERVE TOP CAR CUSTOMER	VD	
X0012	1	DIEWALL - RESERVE TOP CAP CUSTOMER	VD	
ロエルエ		BAR - LH		
FIT KIT		FIT LUT DECEDITE COST	\	
13328	1	FIT KIT - RESERVE CORNER	VD	
OTHER				
11142	1	CORBEL SUPPORT - 24IN 610MM	VD	
11155	2	ESPRESSO MACHINE PUMP MOUNT - 10X10IN	VD	
		255X255MM		
12100	4	ESPRESSO COUNTERTOP SUPPORT LEG	VD	
		STAINLESS		
13410	1	POS DOUBLE TOE KICK - CORNER - 80IN	VD	
		2030MM		
PANEL				
12028	2	PANEL - POS - 29IN 735MM	VD	
12473	1	PANEL - POS - 22IN 560MM	VD	
12762	1	PANEL - FSPRESSO - LH - 140IN 3555MM	VD	HANDOFF FINISH PANEL NOT
12/02	Į.	1 ANEL - LOFINESSO - LM - 1401N 30001VIIVI	עט	REQUIRED WHEN INCORPORATING
				RESERVE STATION. VERIFY DESIGN
				PRIOR TO FABRICATION.
	1	PANEL - RESERVE - LH	VD	
13313			, . -	The second secon
13313 13571	-	PANEL - UPRIGHT FOOD CASE FRONT	VD	
13313 13571 13580	1 2	PANEL - UPRIGHT FOOD CASE FRONT PANEL - UPRIGHT FOOD CASE SIDE	VD VD	

CASEWORK SCHEDULE - "C"



STARBUCKS COFFEE
COMPANY
2401 UTAH AVENUE SOUTH
SEATTLE, WASHINGTON 98134

THESE DRAWINGS AND SPECIFICATIONS ARE CONFIDENTIAL AND SHALL REMAIN THE SOLE PROPERTY OF STARBUCKS CORPORATION, WHICH IS THE OWNER OF THE COPYRIGHT IN THIS WORK. THEY SHALL NOT BE REPRODUCED (IN WHOLE OR IN PART), SHARED WITH THIRD PARTIES OR USED IN ANY MANNER ON OTHER PROJECTS OR EXTENSIONS TO THIS PROJECT WITHOUT THE PRIOR WRITTEN CONSENT OF STARBUCKS CORPORATION. THESE DRAWINGS AND SPECIFICATIONS ARE INTENDED TO EXPRESS DESIGN INTENT FOR A PROTOTYPICAL STARBUCKS STORE (WHICH IS SUBJECT TO CHANGE AT ANYTIME) AND DO NOT REFLECT ACTUAL SITE CONDITIONS. NEITHER PARTY SHALL HAVE ANY OBLIGATION NOR LIABILITY TO THE OTHER (EXCEPT STATED ABOVE) UNTIL A WRITTEN AGREEMENT IS FULLY EXECUTED BY BOTH PARTIES.

(206) 318-1575

ARCHITECT OF RECORD





Revision Schedule

Rev Date By Description

RADY & FARWELL

OJECT ADDRESS:
77 N. FARWELL STREET
LWAUKEE, WI 53202
LWAUKEE COUNTY

STORE #: 2305

PROJECT #: 04217-001

CONCEPT: MCS

PALETTE: HERITAGE

ISSUE DATE: 12 09 13

DESIGN MANAGER: S. RYCHLIK

LEED® AP: N/A

PRODUCTION DESIGNER: C. ALINOVICH

SCHEDULES

:


SHEET NUMBER:

SHEET TITLE:







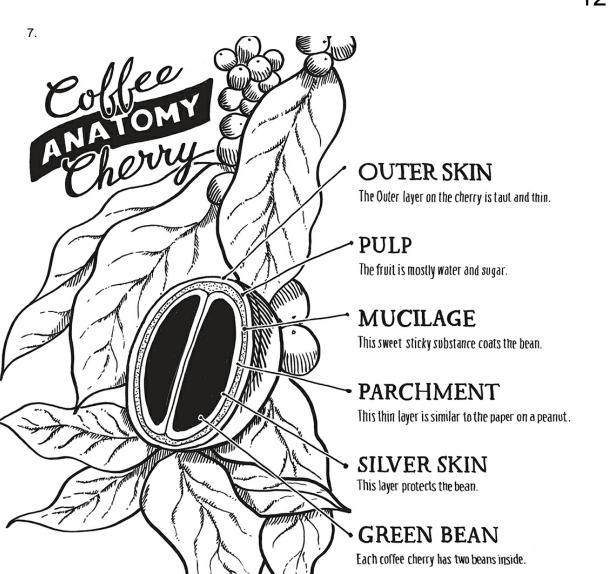











- 1. CEILING PAINT: SHERWIN WILLIAMS, WOOL SKEIN
- 2. CEILING TILE: PAINTED SHERWIN WILLIAMS WOOL SKEIN
- 3. GENERAL PAINT: SHERWIN WILLIAMS, MEGA GREIGE
- 4. ACCENT PAINT: SHERWIN WILLIAMS, BLACK FOX
- 5. COUNTERTOPS: CORIAN, BLACK W/FLECKS
- 6. BACKBAR TILE: 2X8 LIGHT GLOSS CERAMIC TILE 7. WOOD WALL & BAR CLADDING, RUSTIC BLONDE
- 8. FLUSH MOUNT THURMAN CEILING FIXTURE,
- REJUVENATION
- 9. CUSTOM CHALK ART AT RESERVE TOWER
- 10. ESPRESSO COFFEE ART AT CAFE
 11. CUSTOM BANQUETTE
 12. SOFT SEATING



STARBUCKS COFFEE COMPANY
2401 UTAH AVENUE SOUTH
SEATTLE, WASHINGTON 98134
(206) 318-1575

THESE DRAWINGS AND SPECIFICATIONS ARE CONFIDENTIAL AND SHALL REMAIN THE SOLE PROPERTY OF STARBUCKS CORPORATION, WHICH IS THE OWNER OF THE COPYRIGHT IN THIS WORK. THEY SHALL NOT BE REPRODUCED (IN WHOLE OR IN PART), SHARED WITH THIRD PARTIES OR USED IN ANY MANNER ON OTHER PROJECTS OR EXTENSIONS TO THIS PROJECT WITHOUT THE PRIOR WRITTEN CONSENT OF STARBUCKS CORPORATION. THESE DRAWINGS AND SPECIFICATIONS ARE INTENDED TO EXPRESS DESIGN INTENT FOR A PROTOTYPICAL STARBUCKS STORE (WHICH IS SUBJECT TO CHANGE AT ANYTIME) AND DO NOT REFLECT ACTUAL SITE CONDITIONS. NEITHER PARTY SHALL HAVE ANY OBLIGATION NOR LIABILITY TO THE OTHER (EXCEPT STATED ABOVE) UNTIL A WRITTEN AGREEMENT IS FULLY EXECUTED BY BOTH PARTIES.



Revision Schedule					
Rev	Date	Ву	Description		

STORE #: 2305 PROJECT #: 04217-001 CONCEPT: MCS HERITAGE DESIGN MANAGER: S. RYCHLIK LEED $^{ extsf{R}}$ AP: PRODUCTION DESIGNER: C. ALINOVICH CHECKED BY:

SHEET TITLE:

FFE&E - MATERIAL **FINISHES**

SHEET NUMBER:

















STARBUCKS COFFEE

COMPANY
2401 UTAH AVENUE SOUTH
SEATTLE, WASHINGTON 98134

(206) 318-1575

THESE DRAWINGS AND SPECIFICATIONS ARE CONFIDENTIAL AND SHALL REMAIN THE SOLE PROPERTY OF STARBUCKS CORPORATION, WHICH IS THE OWNER OF THE COPYRIGHT IN THIS WORK. THEY SHALL NOT BE REPRODUCED (IN WHOLE OR IN PART), SHARED WITH THIRD PARTIES OR USED IN ANY MANNER ON OTHER PROJECTS OR EXTENSIONS TO THIS PROJECT WITHOUT THE PRIOR WRITTEN CONSENT OF STARBUCKS CORPORATION. THESE DRAWINGS AND SPECIFICATIONS ARE INTENDED TO EXPRESS DESIGN INTENT FOR A PROTOTYPICAL STARBUCKS STORE (WHICH IS SUBJECT TO CHANGE AT ANYTIME) AND DO NOT REFLECT ACTUAL SITE CONDITIONS. NEITHER PARTY SHALL HAVE ANY OBLIGATION NOR LIABILITY TO THE OTHER (EXCEPT STATED ABOVE) UNTIL A WRITTEN AGREEMENT IS FULLY EXECUTED BY BOTH PARTIES.

ARCHITECT OF RECORD





Mechanical - Electrical - Plumbing	
	_

Revision Schedule				
Rev	Date	Ву	Description	

STORE #: PROJECT #: 04217-001 DESIGN MANAGER: LEED® AP:

PRODUCTION DESIGNER: C. ALINOVICH

CHECKED BY:


EXISTING CONDITION PHOTOS

SHEET NUMBER:

I-6104

EXISTING STARBUCKS SPACE



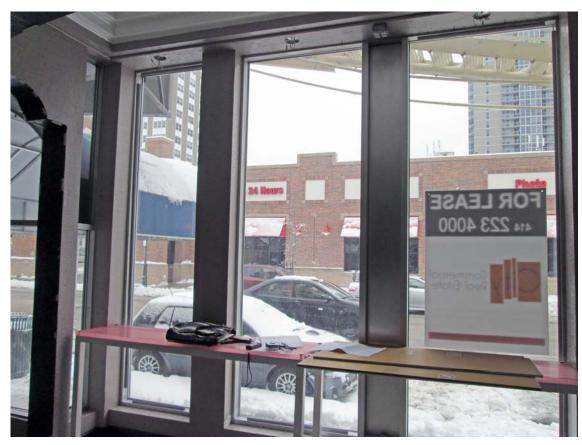







VIEW FROM BRADY & FARWELL