*NOTE: ALL TRIM AND COLUMNS TO BE WHITE.



O1 EAST ELEVATION

SCALE: 1/20" = 1'0"

SCALE: 1:20 (24"x36" SHEET)


0' 20' 40' 60



WEST ELEVATION SCALE: 1/20" = 1'0"





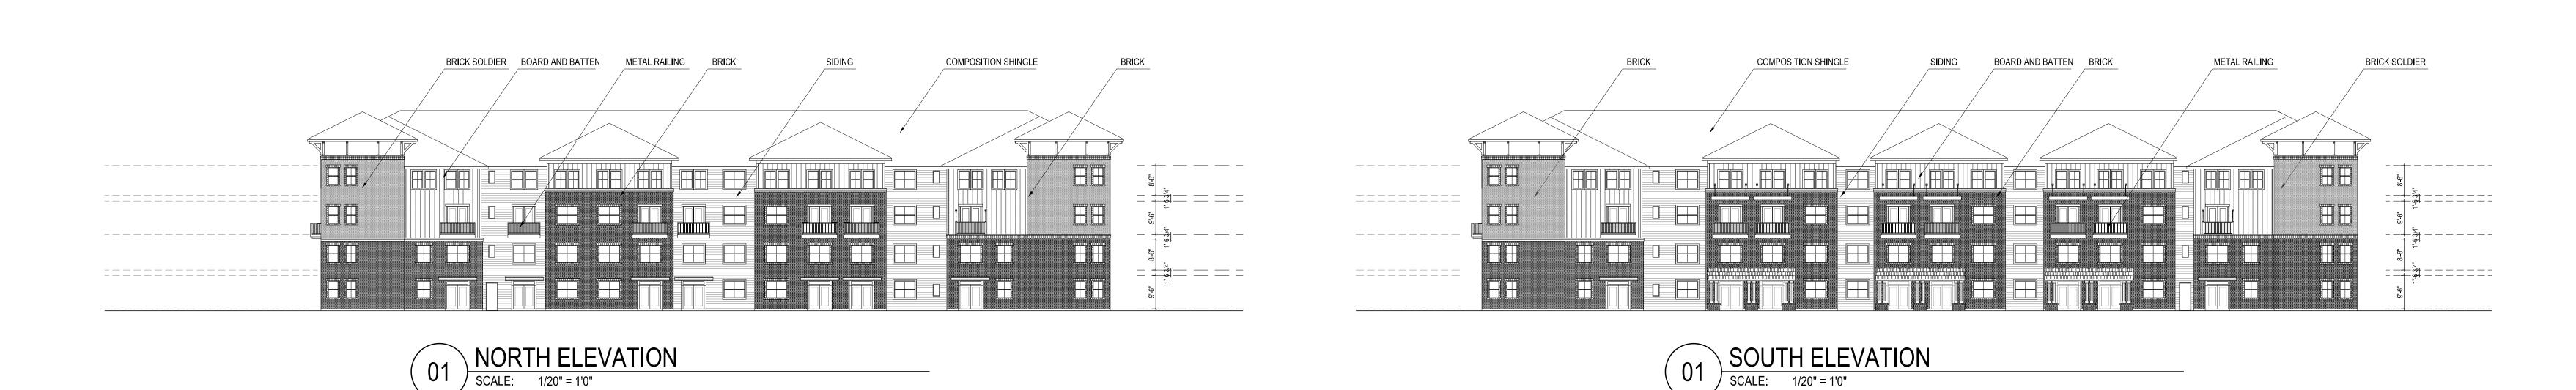

SCALE: 1:20 (24"x36" SHEET)

A415


HUMPHREYS & PARTNERS ARCHITECTS L.P.

5339 Alpha Road, Suite 300 Dallas, TX 75240 (972) 701—9636 (972) 701—9639


www.humphreys.com marketing@humphreys.com


DALLAS CHARLOTTE IRVINE LAS VEGAS NEW ORLEANS NORFOLK ORLANDO PHOENIX


1/19/2012

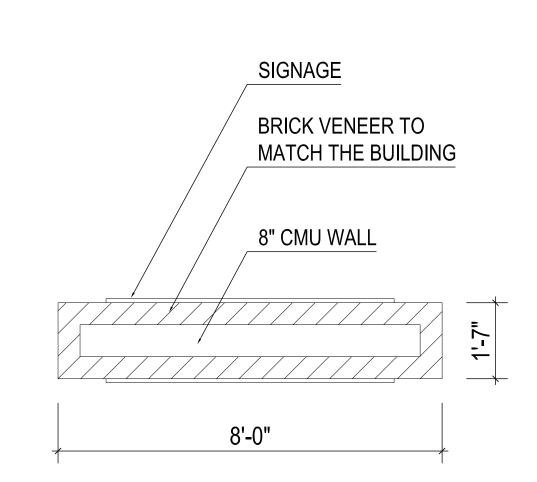




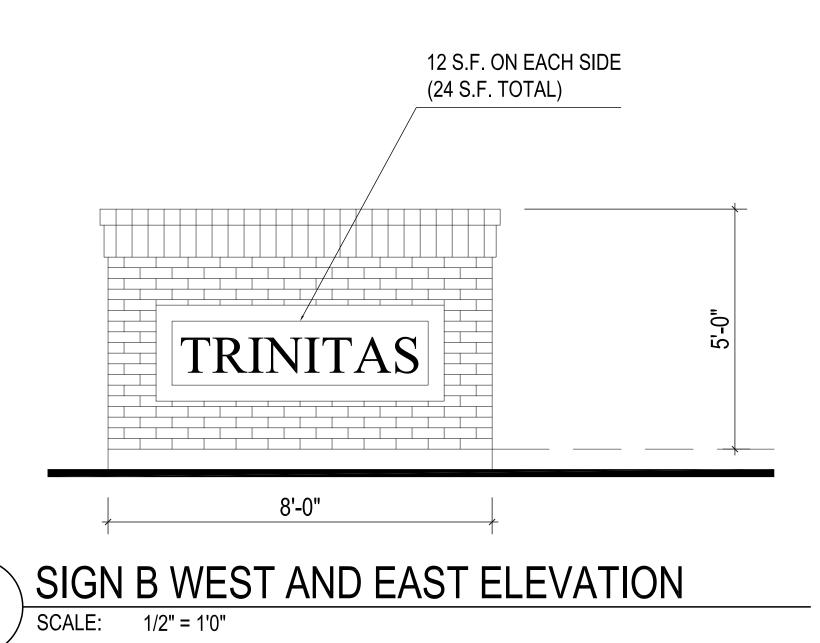

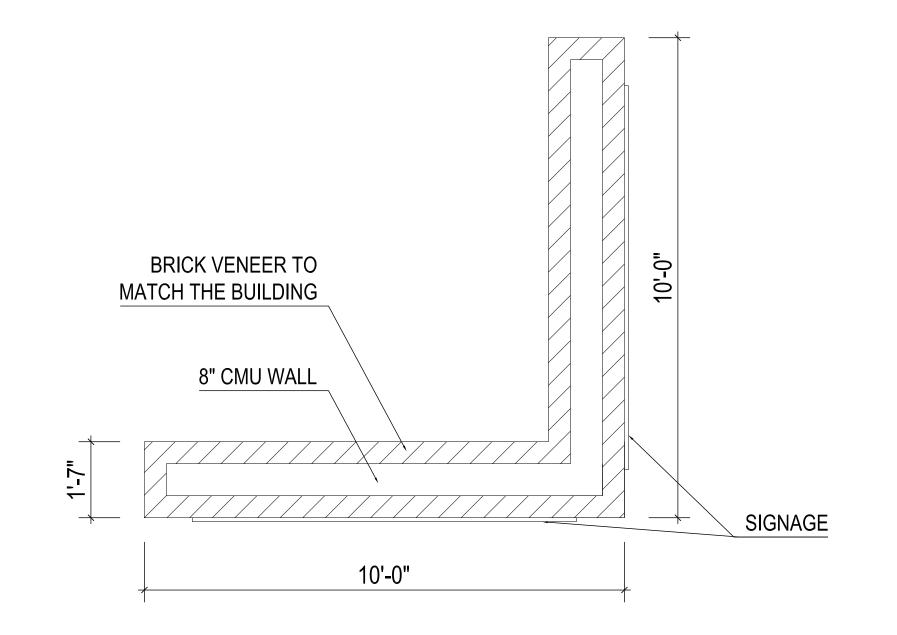

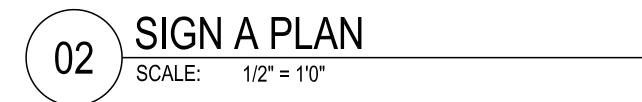

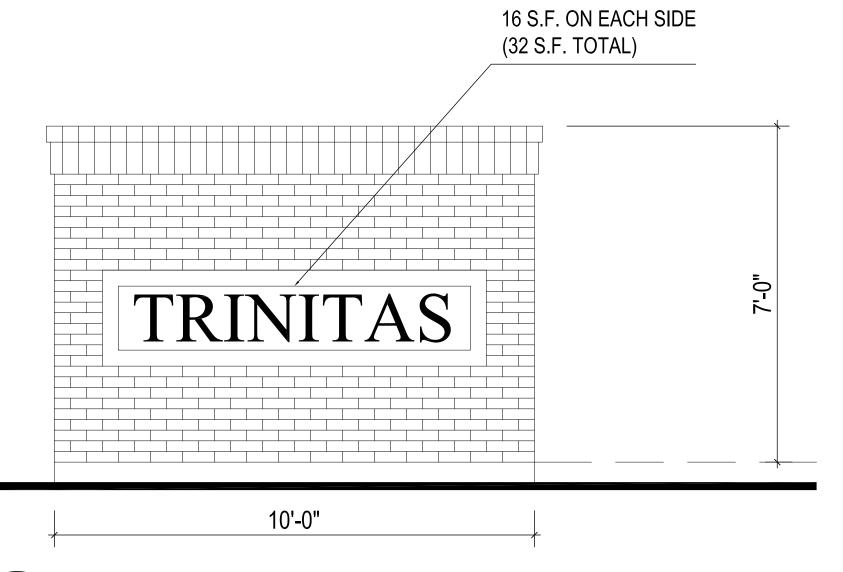

SIGN A SOUTH AND EAST ELEVATION

SCALE: 1/2" = 1'0"

SCALE: 1/2 '=1'-0" (24"x36" SHEET)


are the sole property of Humphreys

& Partners Architects, LP and may

not be reproduced in any form

without its written permission

A901

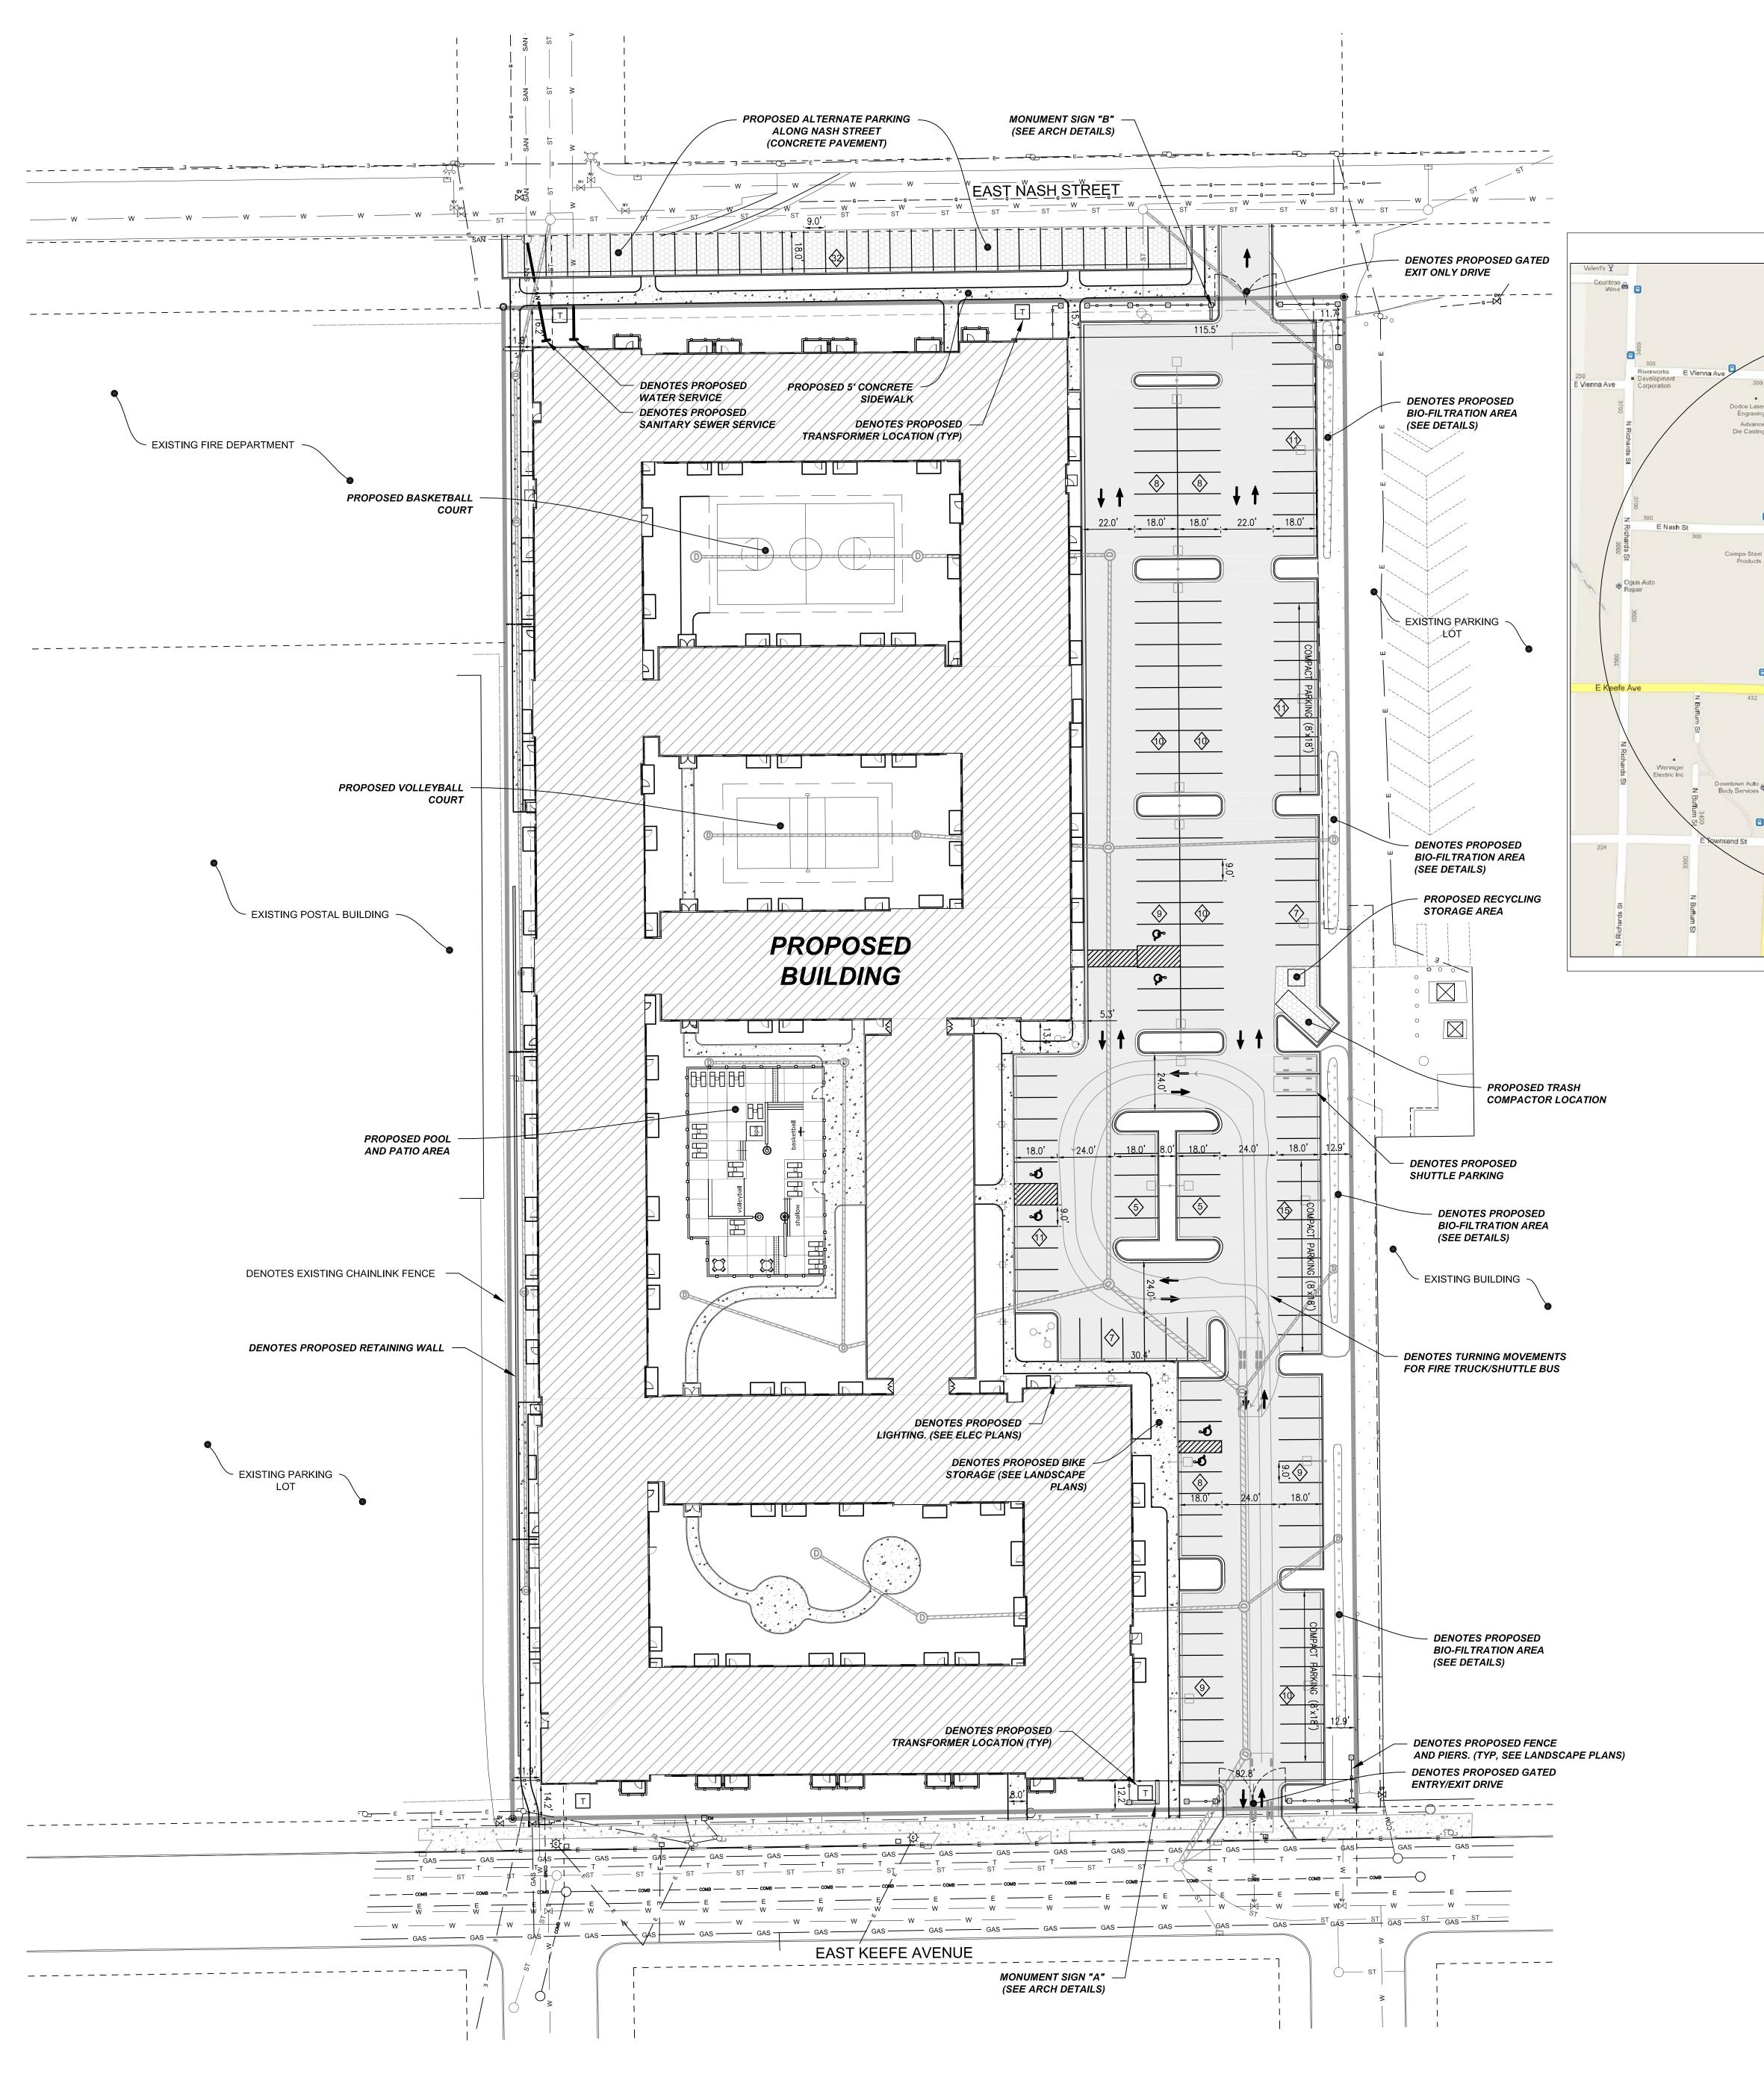



- THE EXISTING SITE INFORMATION ON THIS PLAN WAS TAKEN FROM A SITE SURVEY PROVIDED BY CAPITOL SURVEY ENTERPRISES. THE ENGINEER MAKES NO WARRANTY OR REPRESENTATION WITH REFERENCE TO THE ACCURACY AND COMPLETENESS OF THE EXISTING CONDITIONS INDICATED OR NOT INDICATED ON THE ENGINEERING PLANS PROVIDED. THE CONTRACTOR SHALL VERIFY THE LOCATION OF ALL EXISTING SITE CONDITIONS INCLUDING UNDERGROUND UTILITIES, UNDERGROUND UTILITY ELEVATIONS, BUILDING SETBACKS AND EXISTING BUILDING LOCATIONS. THE CONTRACTOR SHALL INFORM THE OWNER AND ENGINEER OF ANY DISCREPANCIES PRIOR TO COMMENCING WITH WORK. QUESTIONS REGARDING THE EXISTING SURVEY SHALL BE DIRECTED TO THE PARTIES LISTED ABOVE.
- BEFORE PROCEEDING WITH ANY UTILITY CONSTRUCTION, CONTRACTOR SHALL EXCAVATE EACH EXISTING LATERAL TO BE CONNECTED TO (VERIFYING ELEVATION, LOCATION AND SIZE). SHOULD THE EXISTING UTILITY NOT BE AS INDICATED ON THE
- PLAN, THE ENGINEER SHALL BE NOTIFIED IMMEDIATELY FOR EVALUATION. ALL UTILITY CONSTRUCTION SHALL ADHERE TO THE STANDARD SPECIFICATIONS FOR
- ALL UTILITY PERMITS MUST BE RECEIVED FROM THE CITY OF MILWAUKEE PRIOR TO
- THE START OF CONSTRUCTION. NOTIFY THE PUBLIC WORKS INSPECTION DEPT. AT LEAST 48 HOURS BEFORE STARTING

SEWER AND WATER CONSTRUCTION IN WISCONSIN (2003), AS WELL AS, THE CITY OF MILWAUKEE CONSTRUCTION STANDARDS AND THE DEPT. OF COMMERCE SEC. 82-87.

CONSTRUCTION. BACKFILL REQUIREMENTS AND ROADWAY/SIDEWALK RESTORATION SHALL ADHERE TO

LOCAL STANDARDS (GRANULAR BACKFILL UNDER OR WITHIN 5' OF CURBS, SIDEWALK,

ALL BUILDING UTILITIES SHALL BE VERIFIED WITH THE ARCHITECTURAL PLANS PRIOR

OR PAVEMENT. SPOIL MAY BE USED ELSEWHERE. SLURRY BACKFILL WILL BE

REQUIRED IN PUBLIC ROADWAYS.)

ELASTOMERIC JOINTS.

DIRECTED BY THE OWNER.

SPECIFICATIONS)

- TO CONSTRUCTION. ALL PROPOSED WATERMAIN SHALL BE PVC SDR 18, CLASS 150, AWWA C900 WITH
- PROPOSED SANITARY SEWER PIPE SHALL BE PVC, ASTM D-3034, SDR 35 WITH RUBBER GASKETED JOINTS CONFORMING TO ASTM D-3212.
- PROPOSED STORM SEWER SHALL BE PVC, ASTM D-3034, SDR 35 WITH RUBBER
- ELASTOMERIC JOINTS CONFORMING TO ASTM D-3212 (UNLESS OTHERWISE NOTED). 1. UTILITY TRENCHES SHALL BE MECHANICALLY COMPACTED IN ACCORDANCE WITH THE
- STANDARD SPECIFICATIONS FOR SEWER AND WATER CONSTRUCTION IN WISCONSIN. . SILT FENCE AND ALL OTHER EROSION CONTROL METHODS MUST BE INSTALLED PRIOR TO COMMENCEMENT OF CONSTRUCTION. ALSO, CONTRACTOR IS RESPONSIBLE FOR

FREE. SWEEP STREETS AS NEEDED TO MAINTAIN CLEAN STREETS.

- REMOVING EROSION CONTROL METHODS ONCE THE SITE IS STABILIZED. I3. $\,$ THE PROPOSED SITE LOCATION AND SURROUNDING STREETS MUST BE KEPT DEBRIS
- 14. ALL EXCAVATED OR STRIPPED MATERIALS NOT BEING REPLACED IN UTILITY TRENCHES OR BEING USED FOR FILL SHALL BE REMOVED FROM THE SITE, UNLESS OTHERWISE
- 15. ALL DISTURBED GRASS AREAS SHALL BE STABILIZED (PER DNR TECHNICAL STANDARDS) WITHIN 7 DAYS OF COMPLETION. DISTURBED GRASS AREAS SHALL BE TOPSOILED (6"), RESEEDED AND STABILIZED. AREAS WITH A SLOPE OF 3H:1V OR STEEPER SHALL BE COVERED WITH A CLASS 1 - TYPE A EROSION FABRIC. (SEE
- 16. SEE ARCHITECTURAL PLANS FOR EXACT BUILDING & FOUNDATION DETAILS AND ORIENTATION.
- 17. ALL ON-SITE CONCRETE CURB AND GUTTER TO BE 18" WIDE VERTICAL FACE, UNLESS
- 18. ALL CURB ELEVATIONS ARE EDGE OF PAVEMENT UNLESS OTHERWISE NOTED. SEE CURB DETAIL FOR TOP OF CURB ELEVATIONS.
- 19. ALL CURB RADII ARE MEASURED TO THE FACE OF CURB UNLESS OTHERWISE NOTED.

OTHERWISE NOTED. REVERSE OR REGULAR STYLE CURB DENOTED ON PLANS.

- 20. CONTRACTOR SHALL MATCH PROPOSED CONCRETE CURB AND GUTTER, SIDEWALK AND PAVEMENT TO EXISTING IN ELEVATION AND ALIGNMENT.
- 21. REMOVAL OF CURB AND GUTTER, SIDEWALK AND PAVEMENT SHALL BE IN ACCORDANCE WITH THE STANDARD SPECIFICATIONS OF THE WISCONSIN D.O.T.
- 22. ALL CONCRETE FOR CURB AND GUTTER, ROADWAY AND SIDEWALKS MUST CONFORM TO THE STANDARD SPECIFICATIONS FOR READY MIXED CONCRETE. MINIMUM 28 DAY COMPRESSIVE STRENGTH TEST MUST EQUAL 4000 PSI.
- 23. CONTRACTOR IS RESPONSIBLE FOR PROTECTING ALL PROPERTY CORNERS.
- 23. CONTRACTOR IS RESPONSIBLE FOR REPAIRING ANY DAMAGE TO EXISTING UTILITIES, PAVEMENT OR SITE FEATURES. CONTRACTOR SHALL DOCUMENT ALL EXISTING DAMAGE PRIOR TO START OF CONSTRUCTION AND NOTIFY CONSTRUCTION MANAGER OF ANY FINDINGS.
- 24. PROJECT SAFETY ON-SITE SHALL BE THE SOLE RESPONSIBILITY OF THE CONTRACTOR.
- 25. CONTRACTOR IS RESPONSIBLE FOR VERIFYING EXISTING SOIL CONDITIONS, CONSTRUCTION MANAGER MAY HAVE SOILS REPORT FOR MORE INFO.
- 26. CONTRACTOR IS RESPONSIBLE FOR PROVIDING THE OWNER WITH A SET OF MARKED UP PLANS (AS-BUILTS) SHOWING ANY CHANGES DURING CONSTRUCTION.

UTILITY LEGEND

DESCRIPTION

EXISTING WATER MAIN

EXISTING GAS MAIN PROPOSED GAS MAIN

OVERHEAD WIRES

PROPOSED WATER SERVICE

EXISTING ELECTRICAL LINE PROPOSED ELECTRICAL LINE

EXISTING SANITARY SEWER

EXISTING STORM SEWER PROPOSED STORM SEWER

EXISTING POWER POLES

EXISTING WATER VALVE

PROPOSED WATER VALVE

EXISTING STORM STRUCTURE

PROPOSED STORM STRUCTURE

PROPOSED & EXISTING SPOT GRADE

DENOTES EMERGENCY OVERFLOW ROUTE / DRAINAGE

EXISTING LIGHT POLES

SANITARY MANHOLE

FIRE HYDRANT

PROPOSED REVERSE CURB

PROPOSED SANITARY SEWER

Issuance

Consultant:

Revisions

HARWOOD

ENGINEERING


CONSULTANTS, LTD

255 North 21st Street Milwaukee Wisconsin 53233

414.475.5554 414.475.5698 fax harwood@hecl.com

MUNICIPAL REVIEW SET (NOT FOR CONSTRUCTION) DATE: January 20, 2012

SITE PLAN

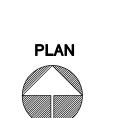

NORTH SCALE: 1" = 30'

KEEFE AVENUE HOUSING

JANUARY 20, 2012 Project No.

Sheet No.


11-1192.00

— E — E — —— GAS ——— GAS ——— Q -W 222,715 SF / 5.11 AC S \bowtie $\blacktriangleright \blacktriangleleft$ 100.00 100.00 HATCH LEGEND

SYMBOL

PROPOSED CONCRETE SIDEWALK PROPOSED REGULAR DUTY ASPHALT PAVEMENT PROPOSED HEAVY DUTY ASPHALT PAVEMENT PROPOSED CONCRETE PAVEMENT PROPOSED DEPRESSED CURB PROPOSED TAPER CURB

N ACCORDANCE WITH WISCONSIN STATUTE 182.0175. DAMAGE O TRANSMISSION FACILITIES, EXCAVATOR SHALL BE SOLELY RESPONSIBLE TO PROVIDE ADVANCE NOTICE TO THE DESIGNATED "ONE CALL SYSTEM" NOT LESS THAN THREE WORKING DAYS PRIOR TO COMMENCEMENT OF ANY EXCAVATION REQUIRED TO PERFORM WORK CONTAINED ON THESE DRAWINGS, AND FURTHER, EXCAVATOR SHALL COMPLY WITH ALL OTHER REQUIREMENTS OF THIS STATUTE RELATIVE TO EXCAVATOR'S WORK.

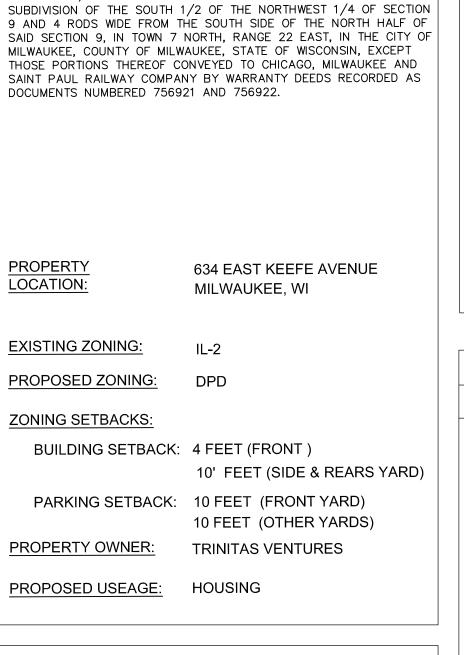

Natural Pet Food

PROJECT LOCATION

Moberg Piano SALES & Services

SITE ZONING AND LOCATION TABLE

THE EAST 1/4 ACRE OF LOT 11 AND ALL OF LOT 12 IN HUBBARD'S

LEGAL DESCRIPTION

VICINITY MAP

Milwaukee Habitat For ■

E Nash S


Petroleum


Y Ret Lounge

SITE CALCULATION TABLE (ON-SITE)

TOTAL SITE AREA	222,7	15 SF / 5.11 A	١C
TOTAL DISTURBED AREA	222,7	15 SF / 5.11 A	νC
EXISTING IMPERVIOUS AREA	213,8	06 SF / 4.91 A	ΛC
PROPOSED BUILDING FOOTPRINT	85,57	75 SF / 1.96 A	С
PROPOSED PARKING/DRIVES	53,51	6 SF / 1.23 A	С
PROPOSED OTHER IMPERVIOUS	25,05	51 SF / 0.58 A	C
PROPOSED TOTAL IMPERVIOUS AREA	164,1	42 SF / 3.77 A	/C
PROPOSED GREENSPACE	58,57	3 SF / 1.34 AC)
	(26%	% OF SITE)	
PROPOSED REGULAR PARKING SPAC	ES	127	
PROPOSED COMPACT CAR PARKING		30	
PROPOSED HANDICAP PARKING		6	
PROPOSED TOTAL ON-SITE PARKING		163	
		100	

PROPOSED ALTERNATE PARKING (ALONG NASH STREET) PROPOSED TOTAL PARKING

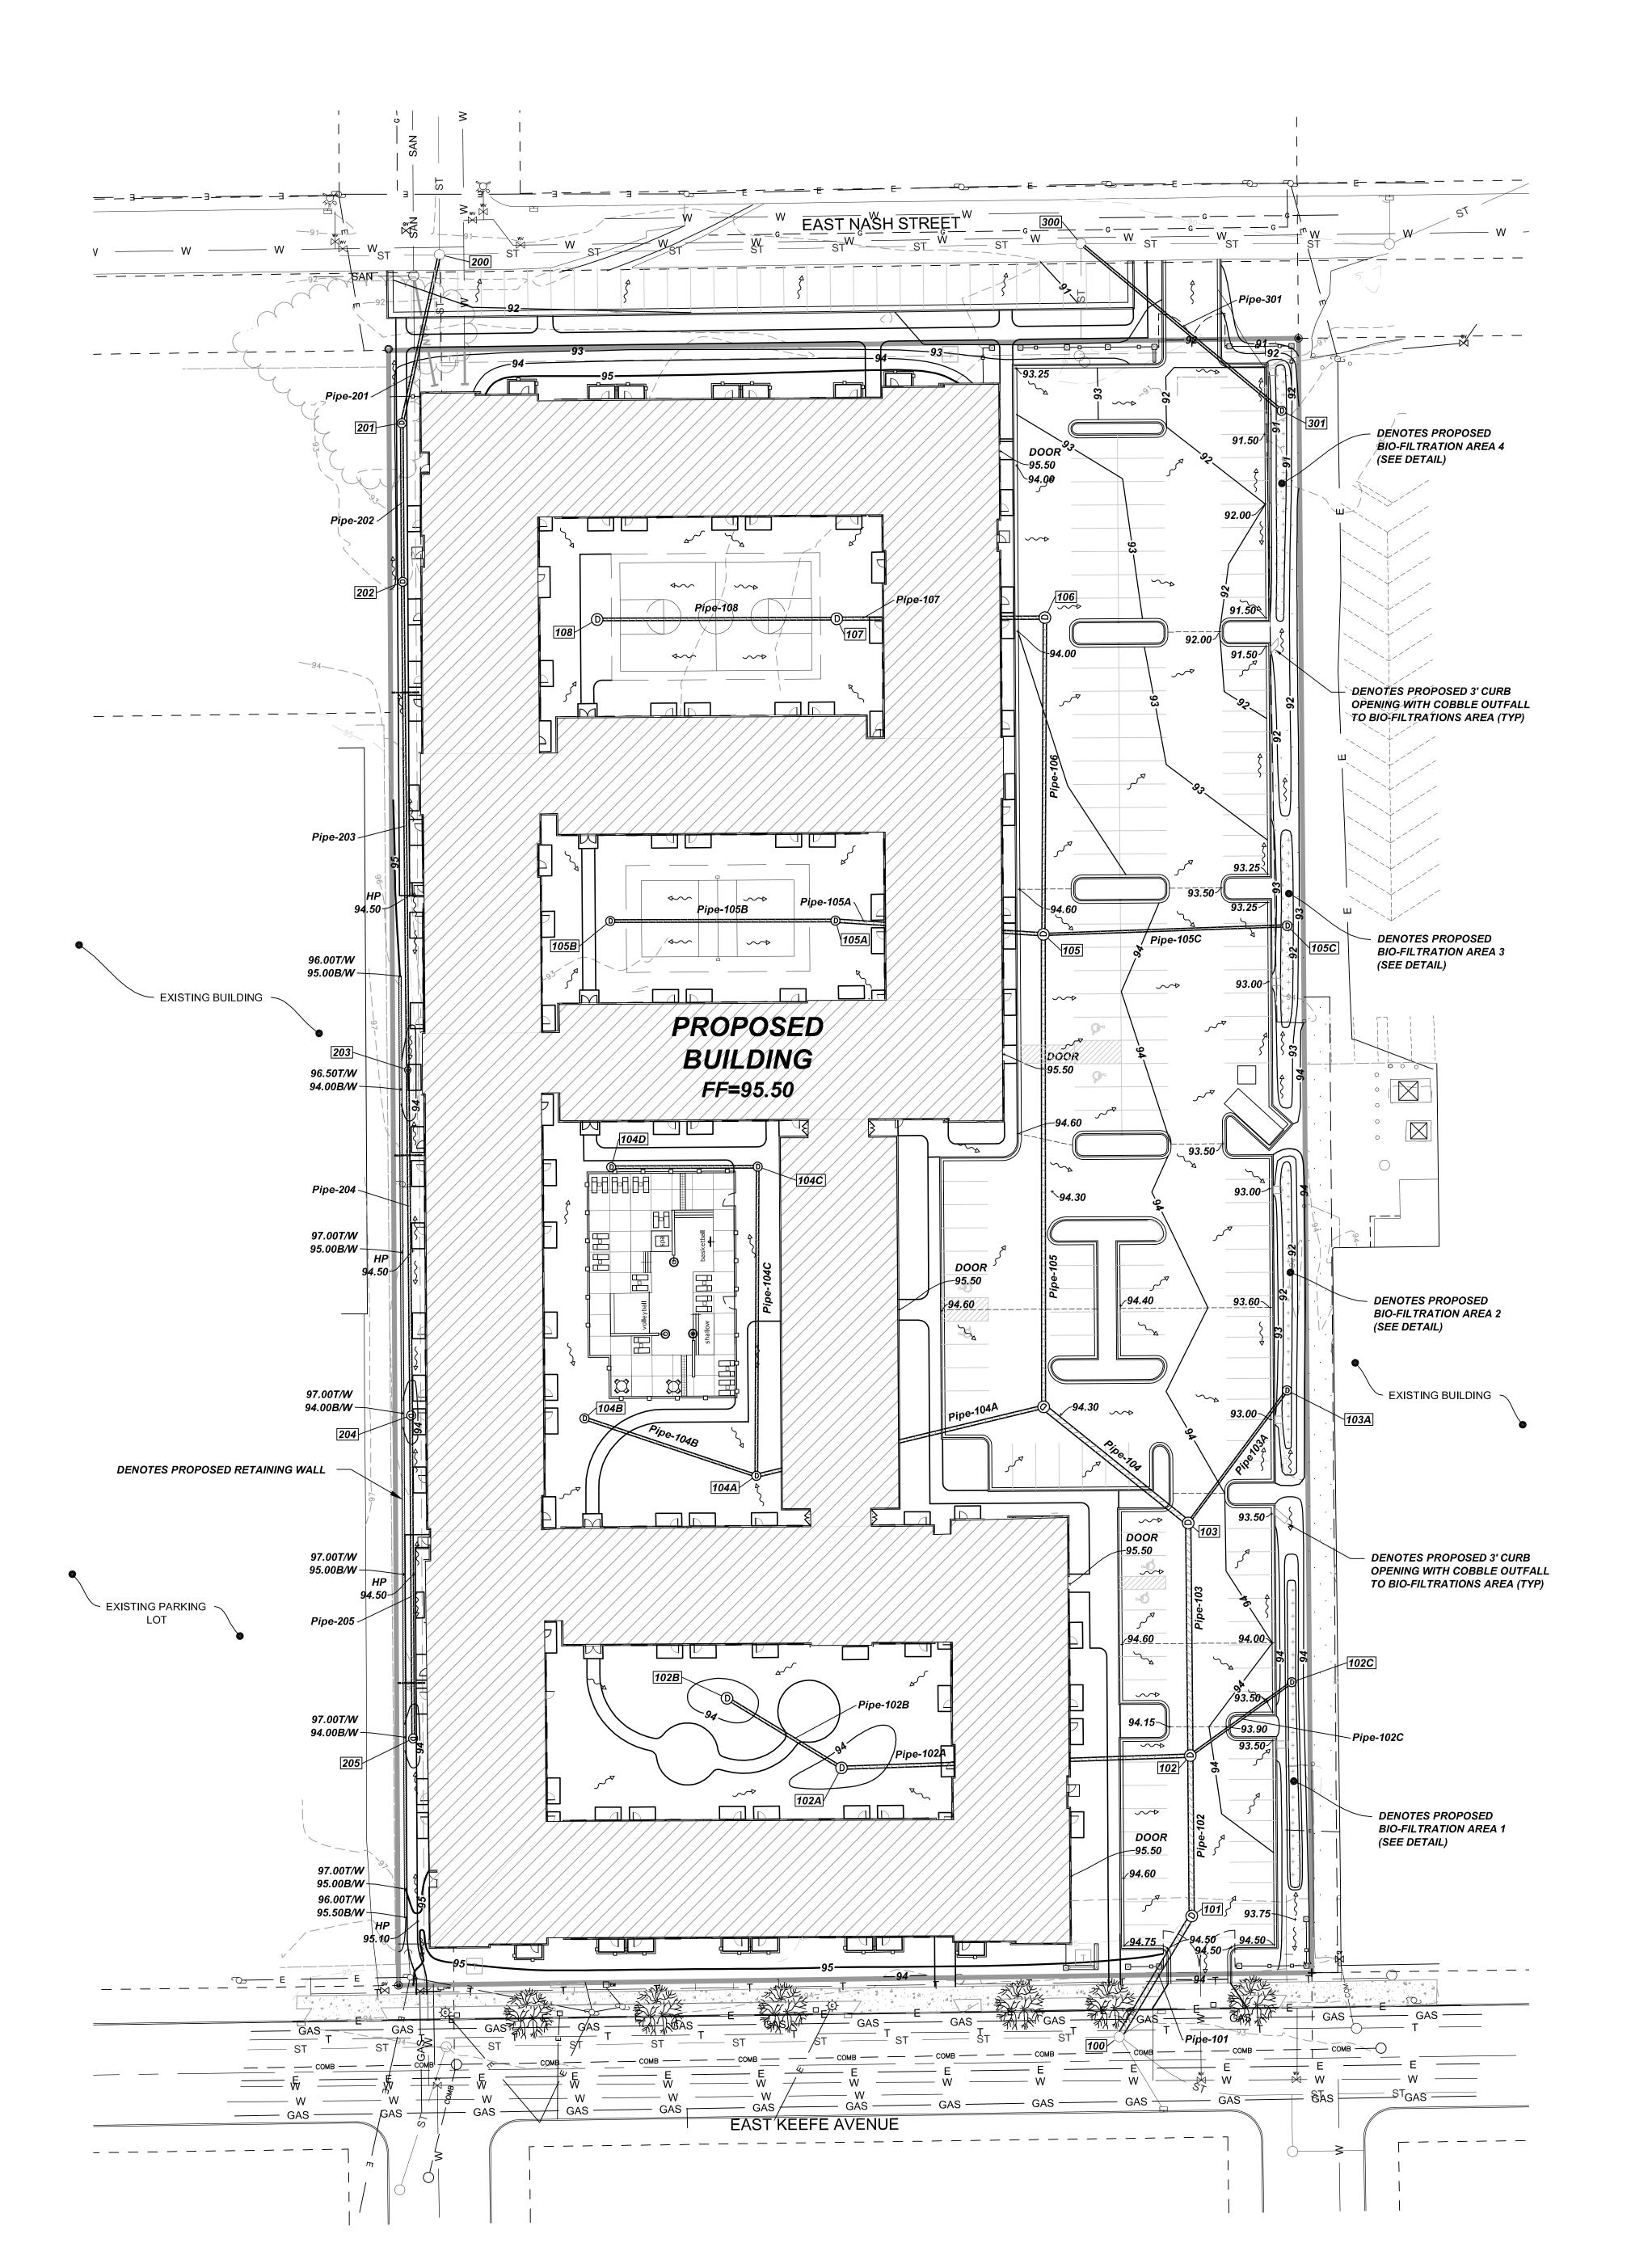

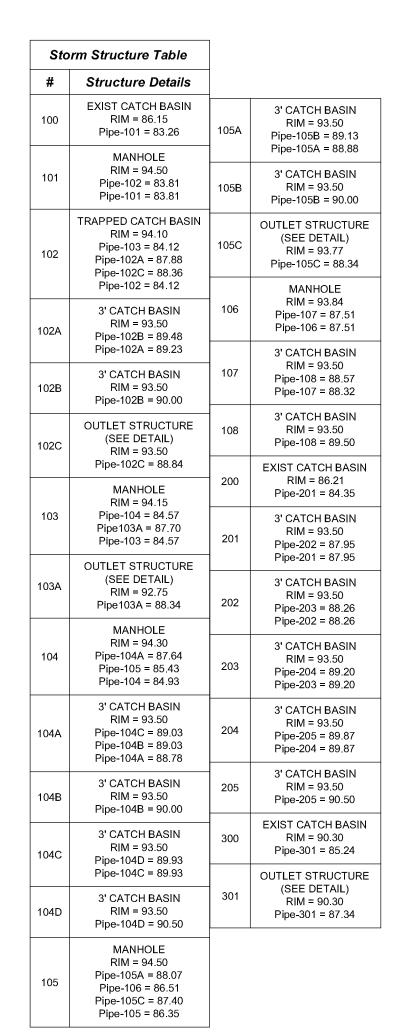

		Storm P	ipe Table		
Pipe Name	Size	Material	Length	Slope	Descript
Pipe-101	24	PVC	54	1.01%	
Pipe-102	24	PVC	62	0.50%	
Pipe-102A	15	PVC	135	1.00%	
Pipe-102B	12	PVC	52	1.00%	
Pipe-102C	10	PVC	48	0.99%	
Pipe-103	24	PVC	90	0.50%	
Pipe-104	24	PVC	72	0.50%	
Pipe-104A	15	PVC	114	1.00%	
Pipe-104B	12	PVC	70	1.39%	
Pipe-104C	12	PVC	120	0.75%	
Pipe-104D	12	PVC	57	1.01%	
Pipe-105	18	PVC	183	0.50%	
Pipe-105A	15	PVC	81	1.01%	
Pipe-105B	12	PVC	87	1.00%	
Pipe-105C	10	PVC	94	1.00%	
Pipe-106	15	PVC	122	0.82%	
Pipe-107	15	PVC	80	1.01%	
Pipe-108	12	PVC	93	1.00%	
Pipe-201	12	PVC	67	5.39%	
Pipe-202	12	PVC	61	0.51%	
Pipe-203	12	PVC	189	0.50%	
Pipe-204	12	PVC	134	0.50%	
Pipe-205	12	PVC	125	0.50%	
Pipe-301	10	PVC	101	2.08%	
Pipe103A	10	PVC	64	1.00%	

GENERAL NOTES AND SPECIFICATIONS

- THE EXISTING SITE INFORMATION ON THIS PLAN WAS TAKEN FROM A SITE SURVEY PROVIDED BY CAPITOL SURVEY ENTERPRISES. THE ENGINEER MAKES NO WARRANTY OR REPRESENTATION WITH REFERENCE TO THE ACCURACY AND COMPLETENESS OF THE EXISTING CONDITIONS INDICATED OR NOT INDICATED ON THE ENGINEERING PLANS PROVIDED. THE CONTRACTOR SHALL VERIFY THE LOCATION OF ALL EXISTING SITE CONDITIONS INCLUDING UNDERGROUND UTILITIES, UNDERGROUND UTILITY ELEVATIONS, BUILDING SETBACKS AND EXISTING BUILDING LOCATIONS. THE CONTRACTOR SHALL INFORM THE OWNER AND ENGINEER OF ANY DISCREPANCIES PRIOR TO COMMENCING WITH WORK. QUESTIONS REGARDING THE EXISTING SURVEY SHALL BE DIRECTED TO THE PARTIES LISTED ABOVE.
- BEFORE PROCEEDING WITH ANY UTILITY CONSTRUCTION, CONTRACTOR SHALL EXCAVATE EACH EXISTING LATERAL TO BE CONNECTED TO (VERIFYING ELEVATION, LOCATION AND SIZE). SHOULD THE EXISTING UTILITY NOT BE AS INDICATED ON THE PLAN, THE ENGINEER SHALL BE NOTIFIED IMMEDIATELY FOR EVALUATION.
- ALL UTILITY CONSTRUCTION SHALL ADHERE TO THE STANDARD SPECIFICATIONS FOR SEWER AND WATER CONSTRUCTION IN WISCONSIN (2003), AS WELL AS, THE CITY OF MILWAUKEE CONSTRUCTION STANDARDS AND THE DEPT. OF COMMERCE SEC. 82-87.
- 4. ALL UTILITY PERMITS MUST BE RECEIVED FROM THE CITY OF MILWAUKEE PRIOR TO THE START OF CONSTRUCTION.
- 5. NOTIFY THE PUBLIC WORKS INSPECTION DEPT. AT LEAST 48 HOURS BEFORE STARTING CONSTRUCTION.
- BACKFILL REQUIREMENTS AND ROADWAY/SIDEWALK RESTORATION SHALL ADHERE TO LOCAL STANDARDS (GRANULAR BACKFILL UNDER OR WITHIN 5' OF CURBS, SIDEWALK, OR PAVEMENT. SPOIL MAY BE USED ELSEWHERE. SLURRY BACKFILL WILL BE REQUIRED IN PUBLIC ROADWAYS.)
- ALL BUILDING UTILITIES SHALL BE VERIFIED WITH THE ARCHITECTURAL PLANS PRIOR TO CONSTRUCTION.
- 8. ALL PROPOSED WATERMAIN SHALL BE PVC SDR 18, CLASS 150, AWWA C900 WITH ELASTOMERIC JOINTS.
- 9. PROPOSED SANITARY SEWER PIPE SHALL BE PVC, ASTM D-3034, SDR 35 WITH RUBBER GASKETED JOINTS CONFORMING TO ASTM D-3212.
- 10. PROPOSED STORM SEWER SHALL BE PVC, ASTM D-3034, SDR 35 WITH RUBBER ELASTOMERIC JOINTS CONFORMING TO ASTM D-3212 (UNLESS OTHERWISE NOTED).
- 11. UTILITY TRENCHES SHALL BE MECHANICALLY COMPACTED IN ACCORDANCE WITH THE STANDARD SPECIFICATIONS FOR SEWER AND WATER CONSTRUCTION IN WISCONSIN.
- 12. SILT FENCE AND ALL OTHER EROSION CONTROL METHODS MUST BE INSTALLED PRIOR TO COMMENCEMENT OF CONSTRUCTION. ALSO, CONTRACTOR IS RESPONSIBLE FOR REMOVING EROSION CONTROL METHODS ONCE THE SITE IS STABILIZED.
- 13. THE PROPOSED SITE LOCATION AND SURROUNDING STREETS MUST BE KEPT DEBRIS FREE. SWEEP STREETS AS NEEDED TO MAINTAIN CLEAN STREETS.
- 14. ALL EXCAVATED OR STRIPPED MATERIALS NOT BEING REPLACED IN UTILITY TRENCHES OR BEING USED FOR FILL SHALL BE REMOVED FROM THE SITE, UNLESS OTHERWISE DIRECTED BY THE OWNER.
- 15. ALL DISTURBED GRASS AREAS SHALL BE STABILIZED (PER DNR TECHNICAL STANDARDS) WITHIN 7 DAYS OF COMPLETION. DISTURBED GRASS AREAS SHALL BE TOPSOILED (6"), RESEEDED AND STABILIZED. AREAS WITH A SLOPE OF 3H:1V OR STEEPER SHALL BE COVERED WITH A CLASS 1 - TYPE A EROSION FABRIC. (SEE SPECIFICATIONS)
- 16. SEE ARCHITECTURAL PLANS FOR EXACT BUILDING & FOUNDATION DETAILS AND ORIENTATION.
- 17. ALL ON-SITE CONCRETE CURB AND GUTTER TO BE 18" WIDE VERTICAL FACE, UNLESS OTHERWISE NOTED. REVERSE OR REGULAR STYLE CURB DENOTED ON PLANS.
- 18. ALL CURB ELEVATIONS ARE EDGE OF PAVEMENT UNLESS OTHERWISE NOTED. SEE CURB DETAIL FOR TOP OF CURB ELEVATIONS.
- 19. ALL CURB RADII ARE MEASURED TO THE FACE OF CURB UNLESS OTHERWISE NOTED.
- 20. CONTRACTOR SHALL MATCH PROPOSED CONCRETE CURB AND GUTTER, SIDEWALK AND PAVEMENT TO EXISTING IN ELEVATION AND ALIGNMENT.
- 21. REMOVAL OF CURB AND GUTTER, SIDEWALK AND PAVEMENT SHALL BE IN
- 22. ALL CONCRETE FOR CURB AND GUTTER, ROADWAY AND SIDEWALKS MUST CONFORM TO THE STANDARD SPECIFICATIONS FOR READY MIXED CONCRETE. MINIMUM 28 DAY


ACCORDANCE WITH THE STANDARD SPECIFICATIONS OF THE WISCONSIN D.O.T.

23. CONTRACTOR IS RESPONSIBLE FOR PROTECTING ALL PROPERTY CORNERS.

COMPRESSIVE STRENGTH TEST MUST EQUAL 4000 PSI.

- 23. CONTRACTOR IS RESPONSIBLE FOR REPAIRING ANY DAMAGE TO EXISTING UTILITIES, PAVEMENT OR SITE FEATURES. CONTRACTOR SHALL DOCUMENT ALL EXISTING DAMAGE PRIOR TO START OF CONSTRUCTION AND NOTIFY CONSTRUCTION MANAGER OF ANY FINDINGS.
- 24. PROJECT SAFETY ON-SITE SHALL BE THE SOLE RESPONSIBILITY OF THE CONTRACTOR.
- 25. CONTRACTOR IS RESPONSIBLE FOR VERIFYING EXISTING SOIL CONDITIONS, CONSTRUCTION MANAGER MAY HAVE SOILS REPORT FOR MORE INFO.
- 26. CONTRACTOR IS RESPONSIBLE FOR PROVIDING THE OWNER WITH A SET OF MARKED UP PLANS (AS-BUILTS) SHOWING ANY CHANGES DURING CONSTRUCTION.

UTILITY LEGEND						
SYMBOL	DESCRIPTION					
w w	EXISTING WATER MAIN					
w w	PROPOSED WATER SERVICE					
— E — E —	EXISTING ELECTRICAL LINE					
— E — E —	PROPOSED ELECTRICAL LINE					
—— GAS ——— GAS ———	EXISTING GAS MAIN					
—— GAS ——— GAS ———	PROPOSED GAS MAIN					
SAN SAN	EXISTING SANITARY SEWER					
SAN SAN	PROPOSED SANITARY SEWER					
ST ST	EXISTING STORM SEWER					
sr sr	PROPOSED STORM SEWER					
—— OHW——— ОНW———	OVERHEAD WIRES					
<u></u>	EXISTING POWER POLES					
- <u>M</u> -	EXISTING LIGHT POLES					
(\$)	SANITARY MANHOLE					
Q	FIRE HYDRANT					
\bowtie	EXISTING WATER VALVE					
>	PROPOSED WATER VALVE					
	EXISTING STORM STRUCTURE					
	PROPOSED STORM STRUCTURE					
	DENOTES EMERGENCY OVERFLOW ROUTE / DRAINAGE PATH					
100.00	PROPOSED & EXISTING SPOT GRADE					

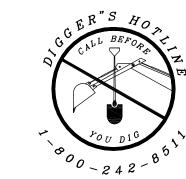

IN ACCORDANCE WITH WISCONSIN STATUTE 182.0175, DAMAGE TO TRANSMISSION FACILITIES, EXCAVATOR SHALL BE SOLELY RESPONSIBLE TO PROVIDE ADVANCE NOTICE TO THE DESIGNATED "ONE CALL SYSTEM" NOT LESS THAN THREE WORKING DAYS PRIOR TO COMMENCEMENT OF ANY EXCAVATION REQUIRED TO PERFORM WORK CONTAINED ON THESE DRAWINGS, AND FURTHER, EXCAVATOR SHALL COMPLY WITH ALL OTHER REQUIREMENTS OF THIS STATUTE RELATIVE TO EXCAVATOR'S WORK.



Consultant:




414.475.5554 414.475.5698 fax harwood@hecl.com

Revisions

Issuance

MUNICIPAL REVIEW SET (NOT FOR CONSTRUCTION) DATE: January 20, 2012

GRADING PLAN

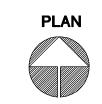

NORTH SCALE: 1" = 30'

KEEFE AVENUE HOUSING

JANUARY 20, 2012

11-1192.00

Project No.

Sheet No.

LEGAL DESCRIPTION:

THE EAST 1/4 ACRE OF LOT 11 AND ALL OF LOT 12 IN HUBBARD'S SUBDIVISION OF THE SOUTH 1/2 OF THE NORTHWEST 1/4 OF SECTION 9 AND 4 RODS WIDE FROM THE SOUTH SIDE OF THE NORTH HALF OF SAID SECTION 9, IN TOWN 7 NORTH, RANGE 22 EAST, IN THE CITY OF MILWAUKEE, COUNTY OF MILWAUKEE, STATE OF WISCONSIN, EXCEPT THOSE PORTIONS THEREOF CONVEYED TO CHICAGO, MILWAUKEE AND SAINT PAUL RAILWAY COMPANY BY WARRANTY DEEDS RECORDED AS DOCUMENTS NUMBERED 756921 AND 756922.

EASEMENT FOR THE BENEFIT OF PARCEL I CREATED BY LEASE AND RECIPROCAL EASEMENT AGREEMENT GRANT RECORDED MAY 7, 1981, REEL 783, IMAGES 1743 TO 1756 INCLUSIVE, AS DOCUMENT NO. 4838360, FOR DRIVEWAY PURPOSES AS PROVIDED FOR THEREIN.

CONTAINING: 222,715 SQUARE FEET OR 5.11 ACRES.

EXCEPTIONS

11. AGREEMENT RECORDED AS DOCUMENT NO. 771238. (DOES NOT AFFECT)
12. UTILITY EASEMENT GRANTED TO WISCONSIN ELECTRIC POWER COMPANY AND WISCONSIN TELEPHONE COMPANY RECORDED AS DOCUMENT NO. 4224306. (AS SHOWN)
13. UTILITY EASEMENT GRANTED TO WISCONSIN ELECTRIC POWER COMPANY AND WISCONSIN TELEPHONE COMPANY RECORDED AS DOCUMENT NO. 4263481. (UTILITY POLE AND WIRES AT THE NORTHEAST CORNER OF PROPERTY, AS SHOWN)
14. UTILITY EASEMENT GRANTED TO WISCONSIN ELECTRIC POWER COMPANY AND WISCONSIN TELEPHONE COMPANY RECORDED AS DOCUMENT NO. 4288493. (DOES NOT AFFECT)
15. LEASE AND RECIPROCAL EASEMENT GRANT BY AND BETWEEN INLAND CONTAINER CORPORATION AND KEEFE AVENUE CORPORATION RECORDED MAY 7, 1974, REEL 733, IMAGE 1743 AS DOCUMENT NO. 4838360. (AS SHOWN)

NOTES

- 1. SUBJECT PROPERTY ZONED IL2 LIGHT INDUSTRIAL.
- 2. SETBACKS BASED NOT YET PROVIDED BY INSURER.
- 3. LEGAL DESCRIPTION PROVIDED BY INSURER IN COMMITMENT FOR TITLE INSURANCE NO. 502540-4
- 4. THE UNDERGROUND UTILITY INFORMATION AS SHOWN HEREON IS BASED, IN PART, ON INFORMATION FURNISHED BY THE UTILITY COMPANIES, DIGGERS HOTLINE AND THE LOCAL MUNICIPALITY. WHILE THIS INFORMATION IS BELIEVED TO BE RELIABLE, ITS ACCURACY AND COMPLETENESS CANNOT BE GUARANTEED NOR CERTIFIED TO.
- 5. SUBJECT PROPERTY IS NOT IN THE 100 YEAR FLOOD PLAIN PER FLOOD INSURANCE RATE MAP #55079C0084E, EFFECTIVE DATE SEPTEMBER 26, 2008.
- 6. PROJECT BENCHMARK XXX.
- 7. SITE BENCHMARK XXX.
- 8. ELEVATIONS BASED ON INFORMATION FROM THE CITY OF MILWAUKEE AND ARE AT CITY OF MILWAUKEE DATUM.



Toll Free (800) 242-8511

Milwaukee Area (414) 259-1181

Hearing Impaired TDD (800) 542-2289

www.DiggersHotline.com

Tic.# 20114010376

TO (NAME OF INSURED, IF KNOWN), (NAME OF LENDER, IF KNOWN), (NAME OF INSURER, IF KNOWN), (NAMES OF OTHERS AS NEGOTIATED WITH THE CLIENT):


THIS IS TO CERTIFY THAT THIS MAP OR PLAT AND THE SURVEY ON WHICH IT IS BASED WERE MADE IN ACCORDANCE WITH THE 2011 MINIMUM STANDARD DETAIL REQUIREMENTS FOR ALTA/ACSM LAND TITLE SURVEYS, JOINTLY ESTABLISHED AND ADOPTED BY ALTA AND NSPS, AND INCLUDES ITEMS OF TABLE A THEREOF. THE FIELD WORK WAS COMPLETED ON ______.


SEPTEMBER 28, 2011

MICHAEL J. BERRY, R.L.S. REGISTERED LAND SURVEYOR S-2545

LEGEND	HYDRANT WW WELL	ST	EXISTING CONTOUR EXISTING STORM SEWER
OFP FLAG POLE -C- CONCRETE LIGHT POLE	☐TP TELEPHONE PEDESTAL	w	EXISTING SANITARY SEWER EXISTING WATER MAIN UNDERGROUND GAS SERVICE
□GM GAS METER	O UTILITY POLE		UNDERGROUND TELEPHONE SERVICE OVERHEAD UTILITY LINES

No.	DESCRIPTION	REVISION DATE INITIA

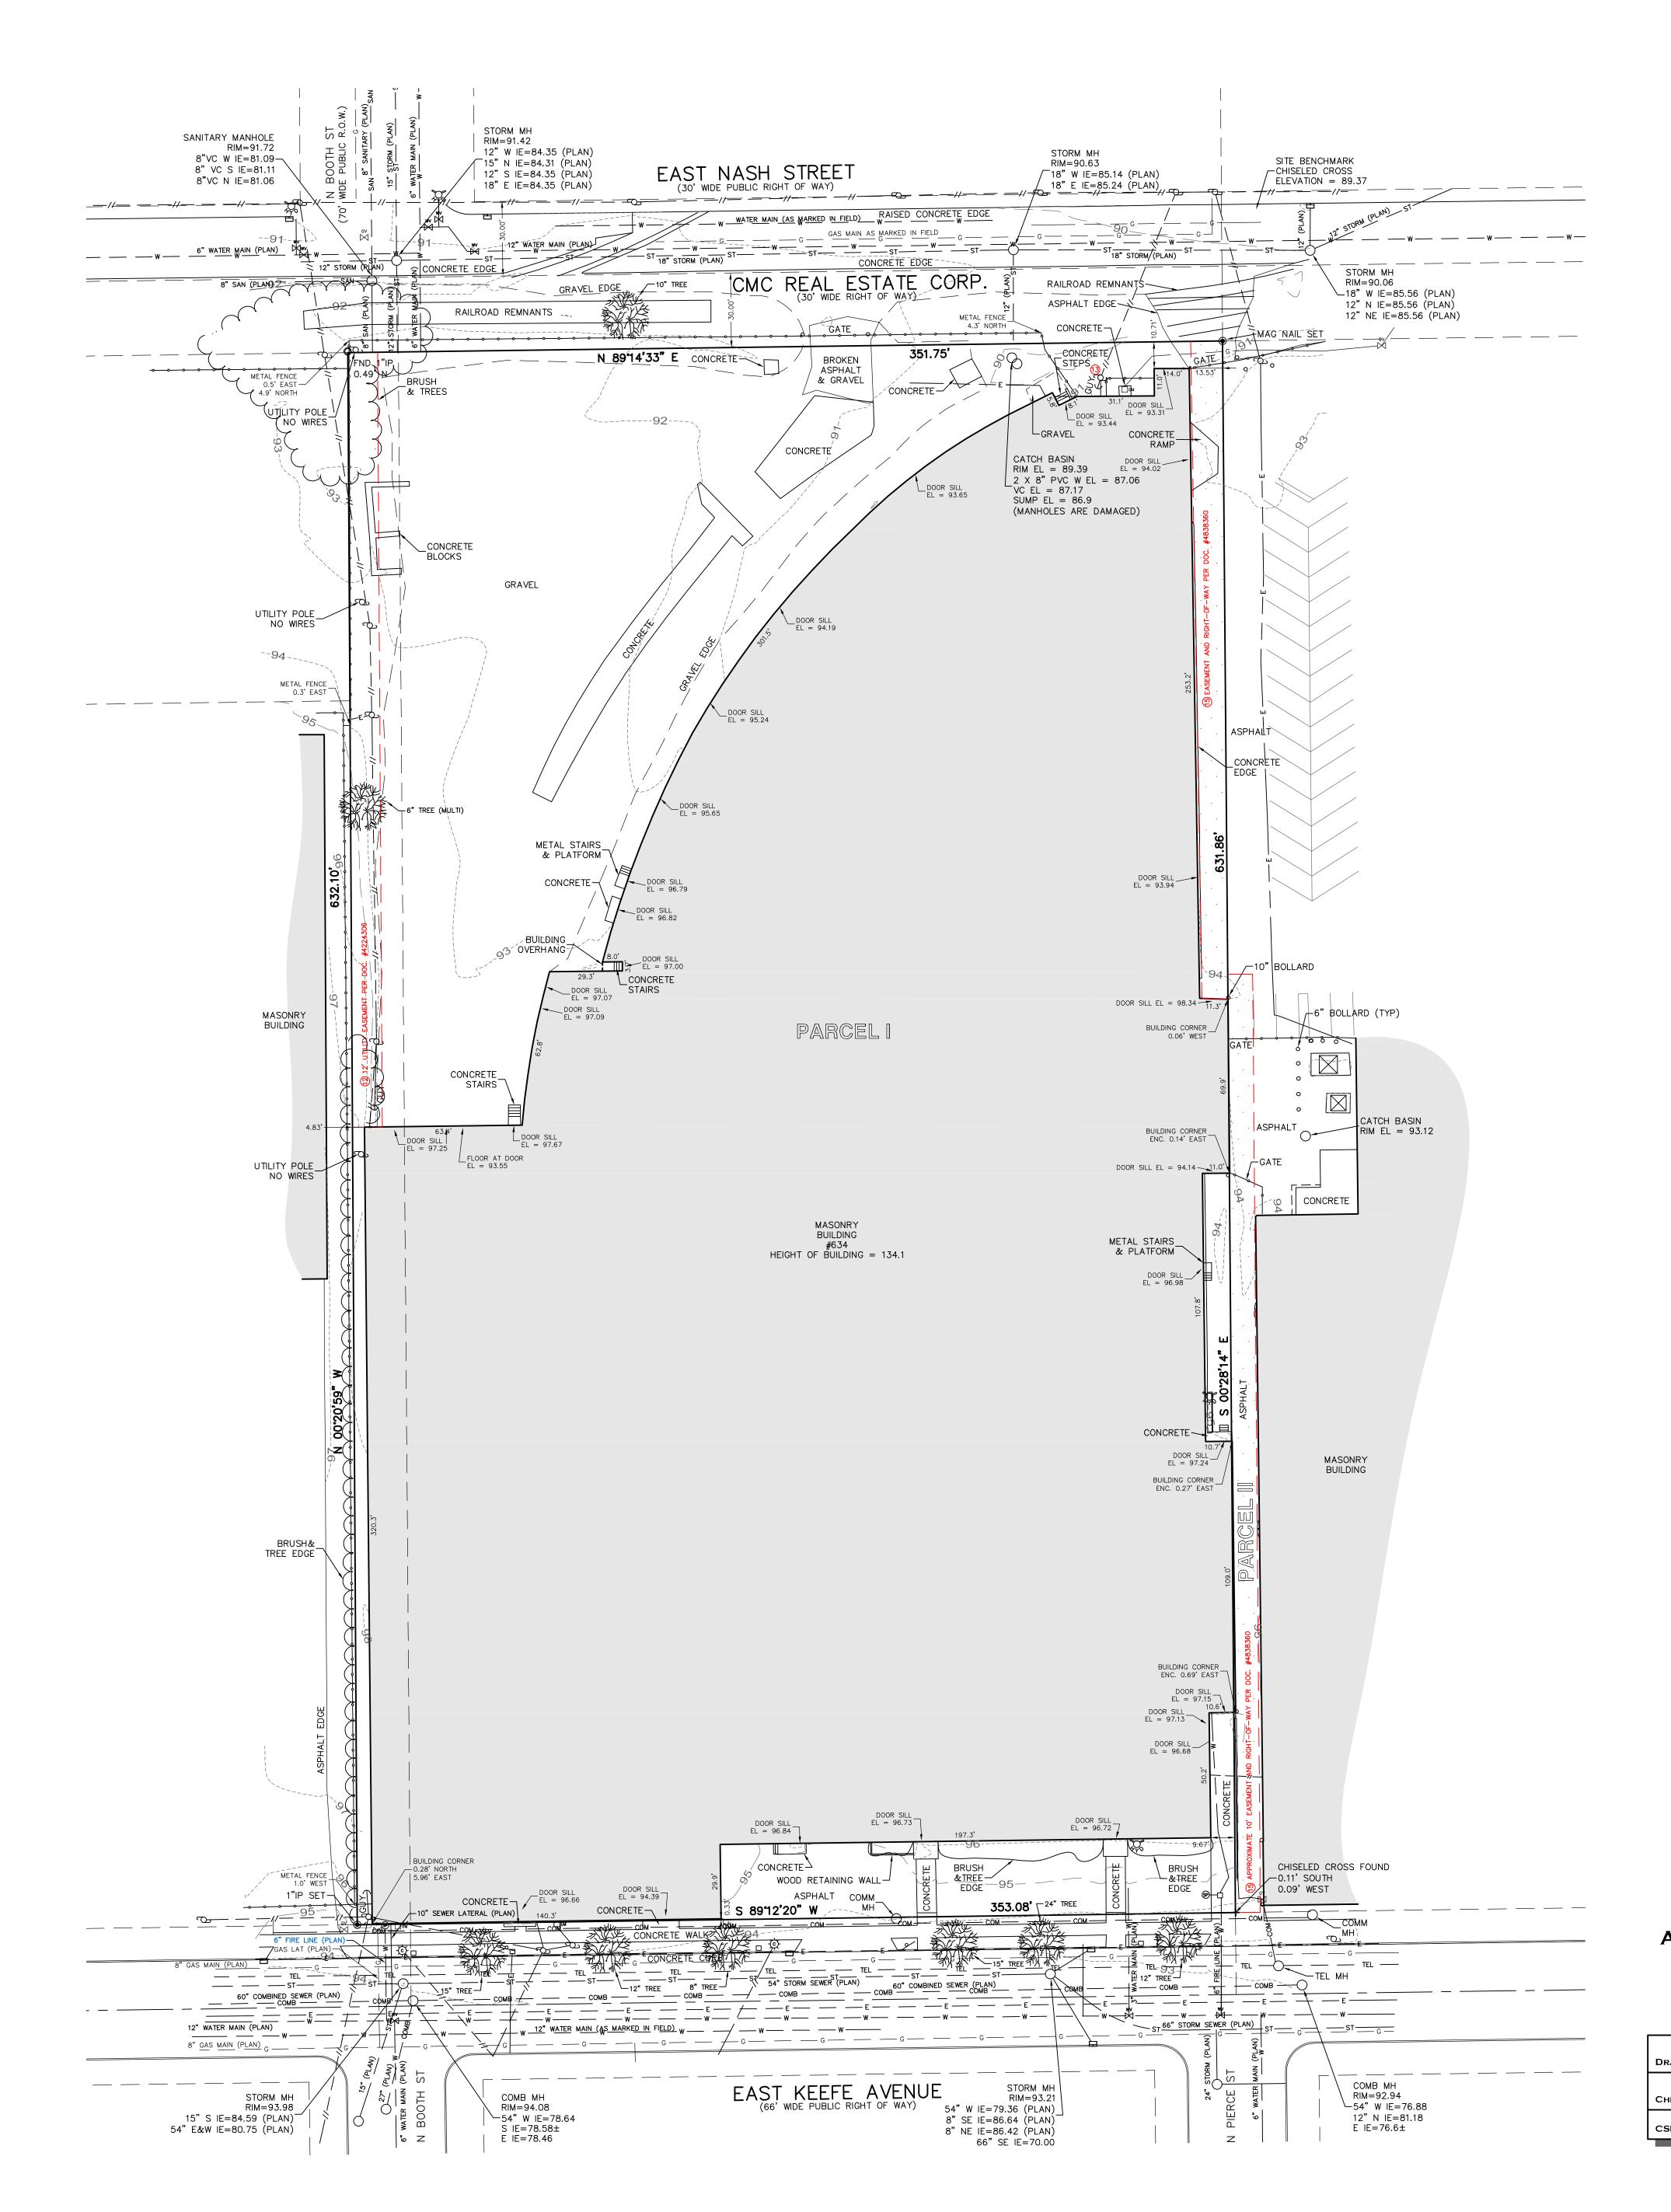

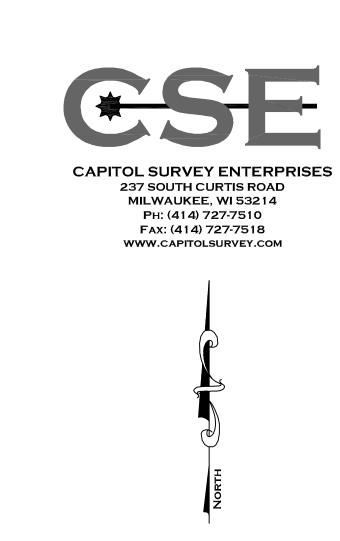





Issuance

MUNICIPAL REVIEW SET
(NOT FOR CONSTRUCTION)

DATE: January 20, 2012

neet

ALTA SURVEY (EXISTING CONDITIONS)



NORTH SCALE: 1" = 30'

Project

KEEFE AVENUE

HOUSING

ALTA-ACSM LAND TITLE SURVEY

GRAPHIC SCALE

1 INCH = 30 FT.

FOR
TRINITAS
634 E KEEFE AVE
MILWAUKEE, WI

			0/1140/1111/2
AWN BY:	RAP	DATE: 9/28/2011	Project No.
			11-1192.00
ECKED BY:	MJB	DRAWING NO. AL-O	Chart No
Е Јов No.:	11-130	SHEET 1 OF 1	Sheet No.


Date


JANUARY 20, 2012


Project No.

11-1192.00

C1.20

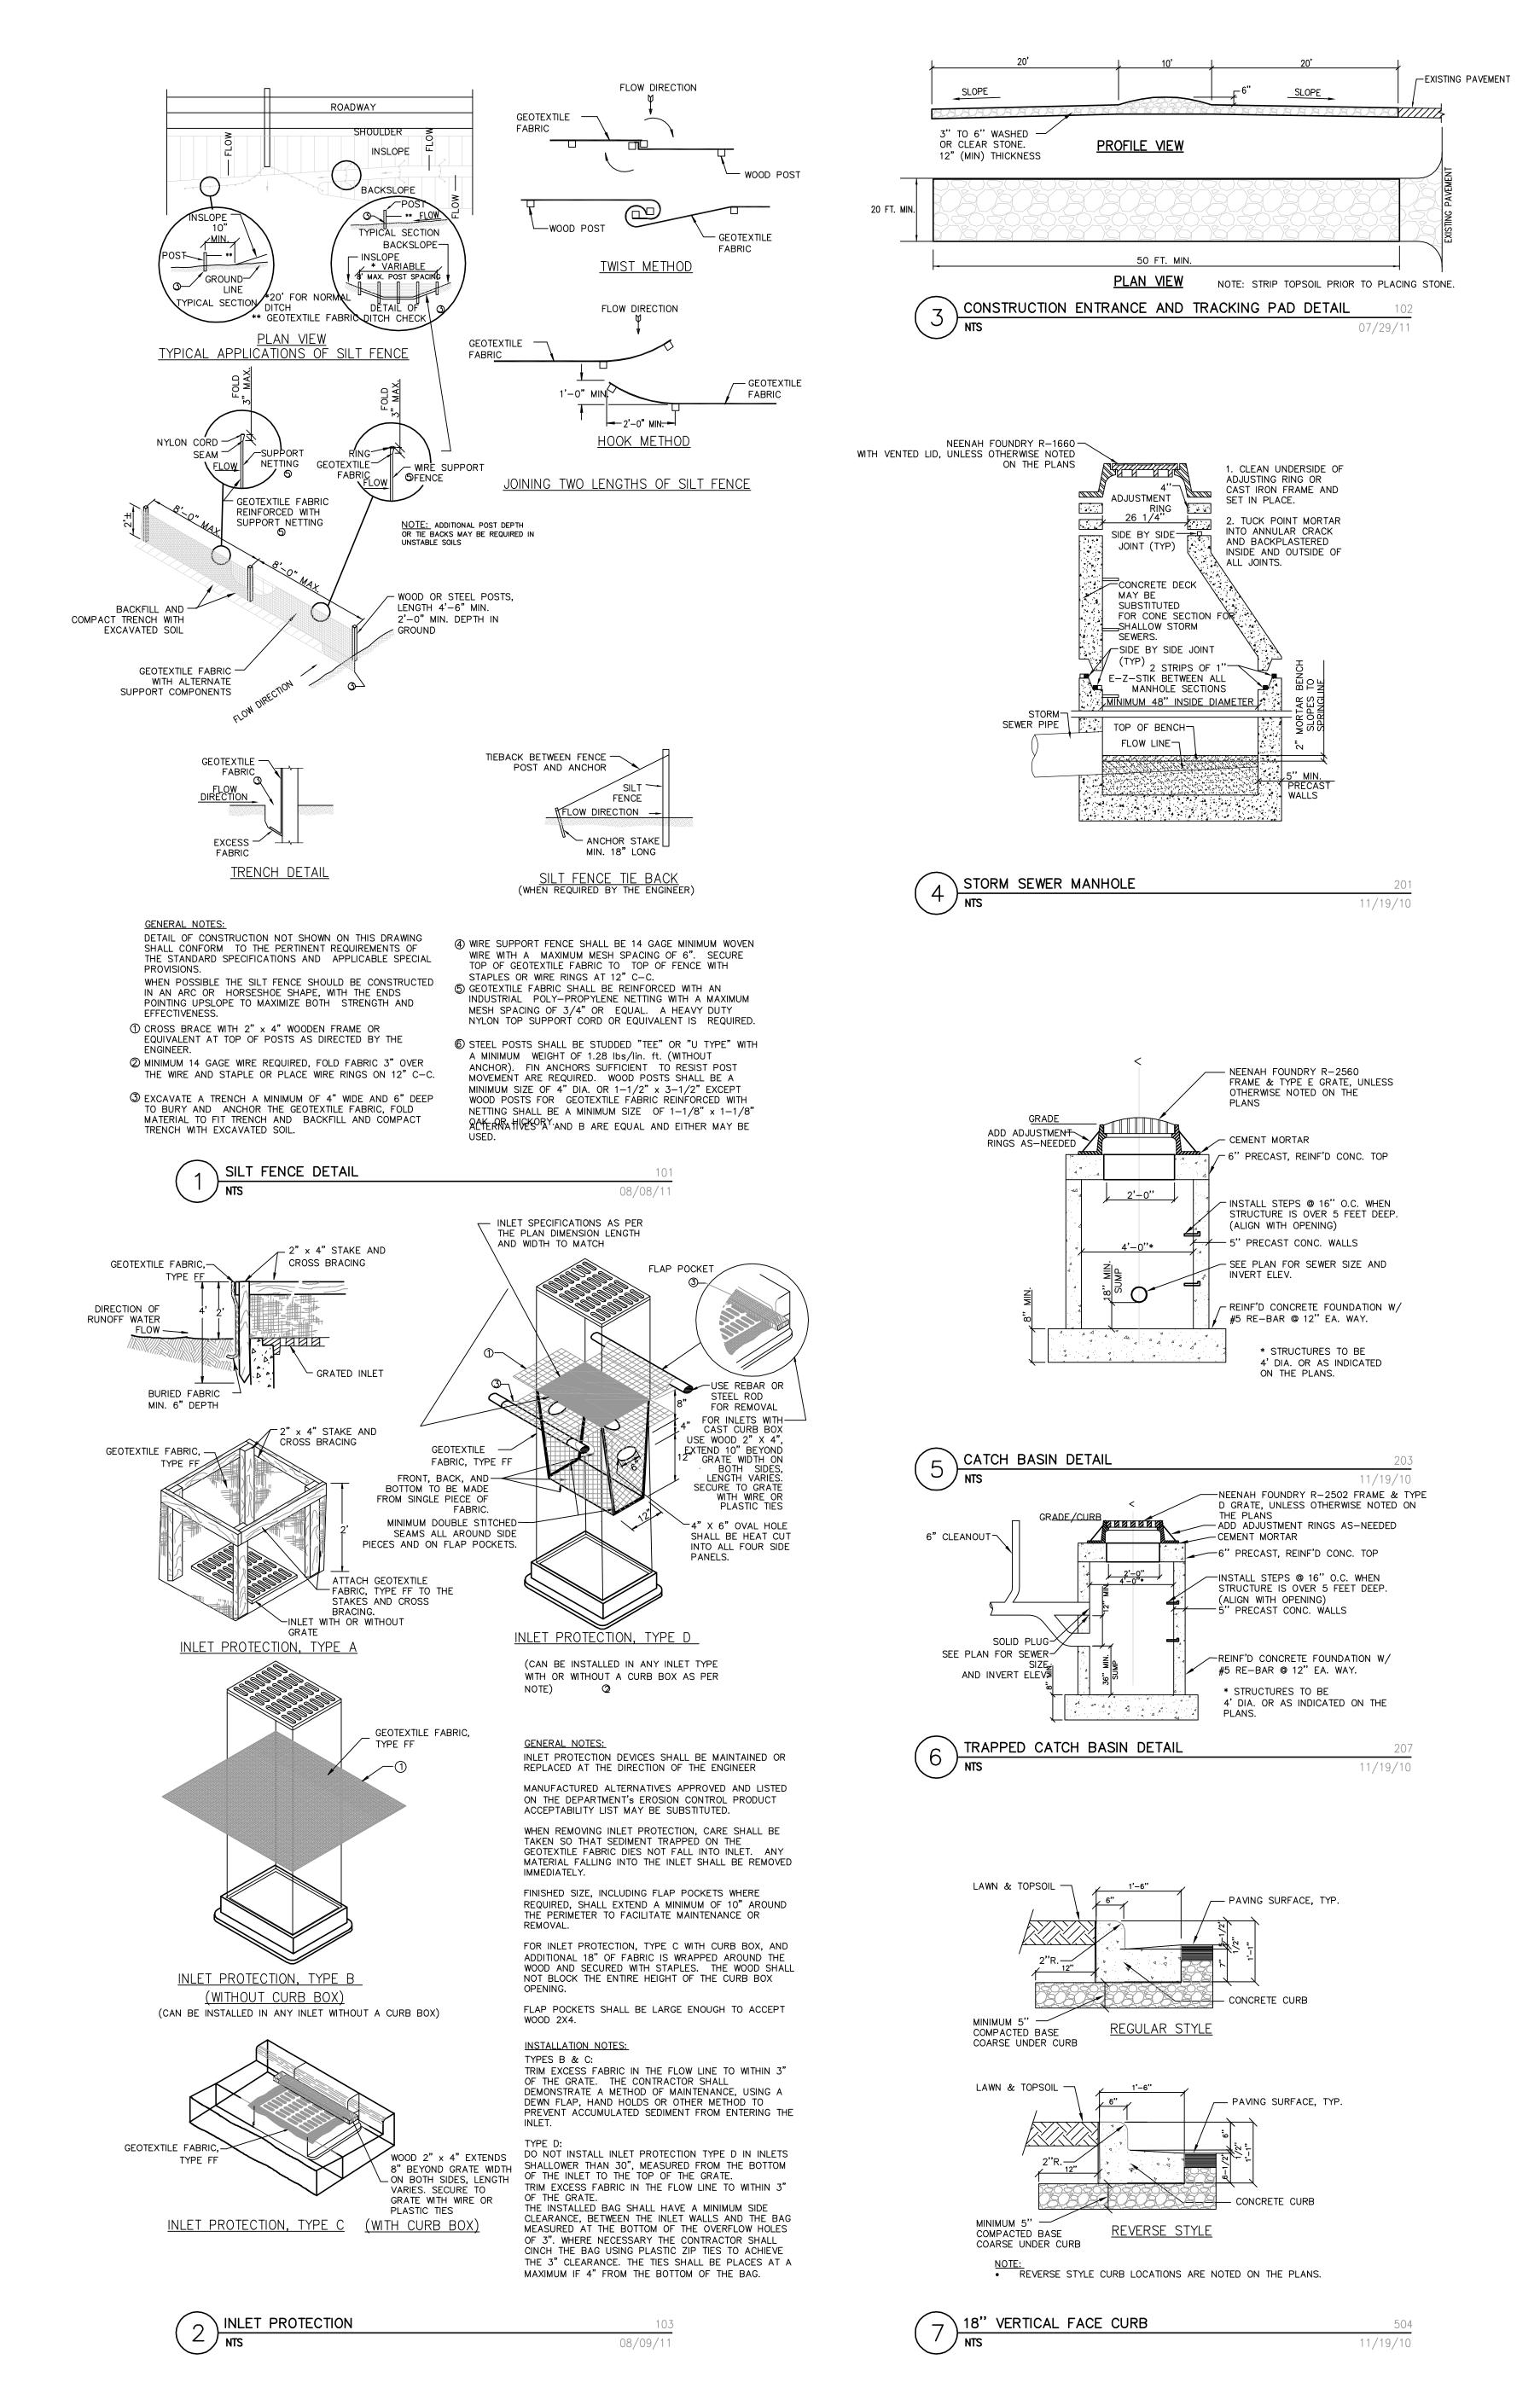

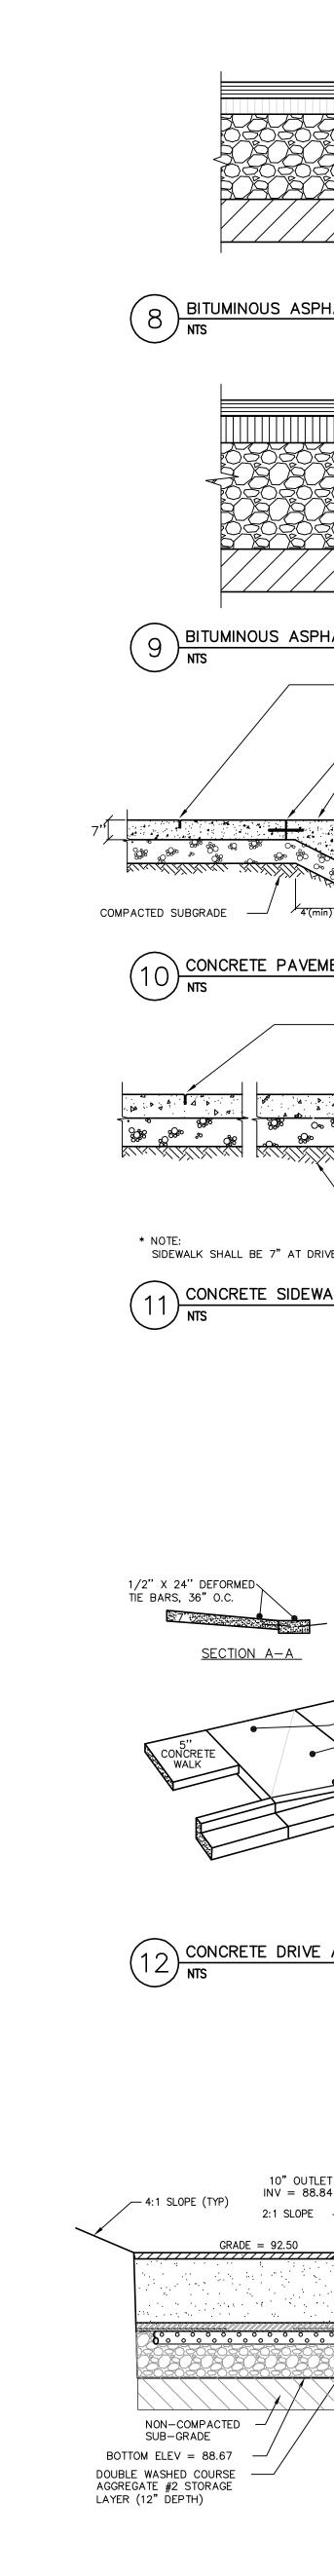

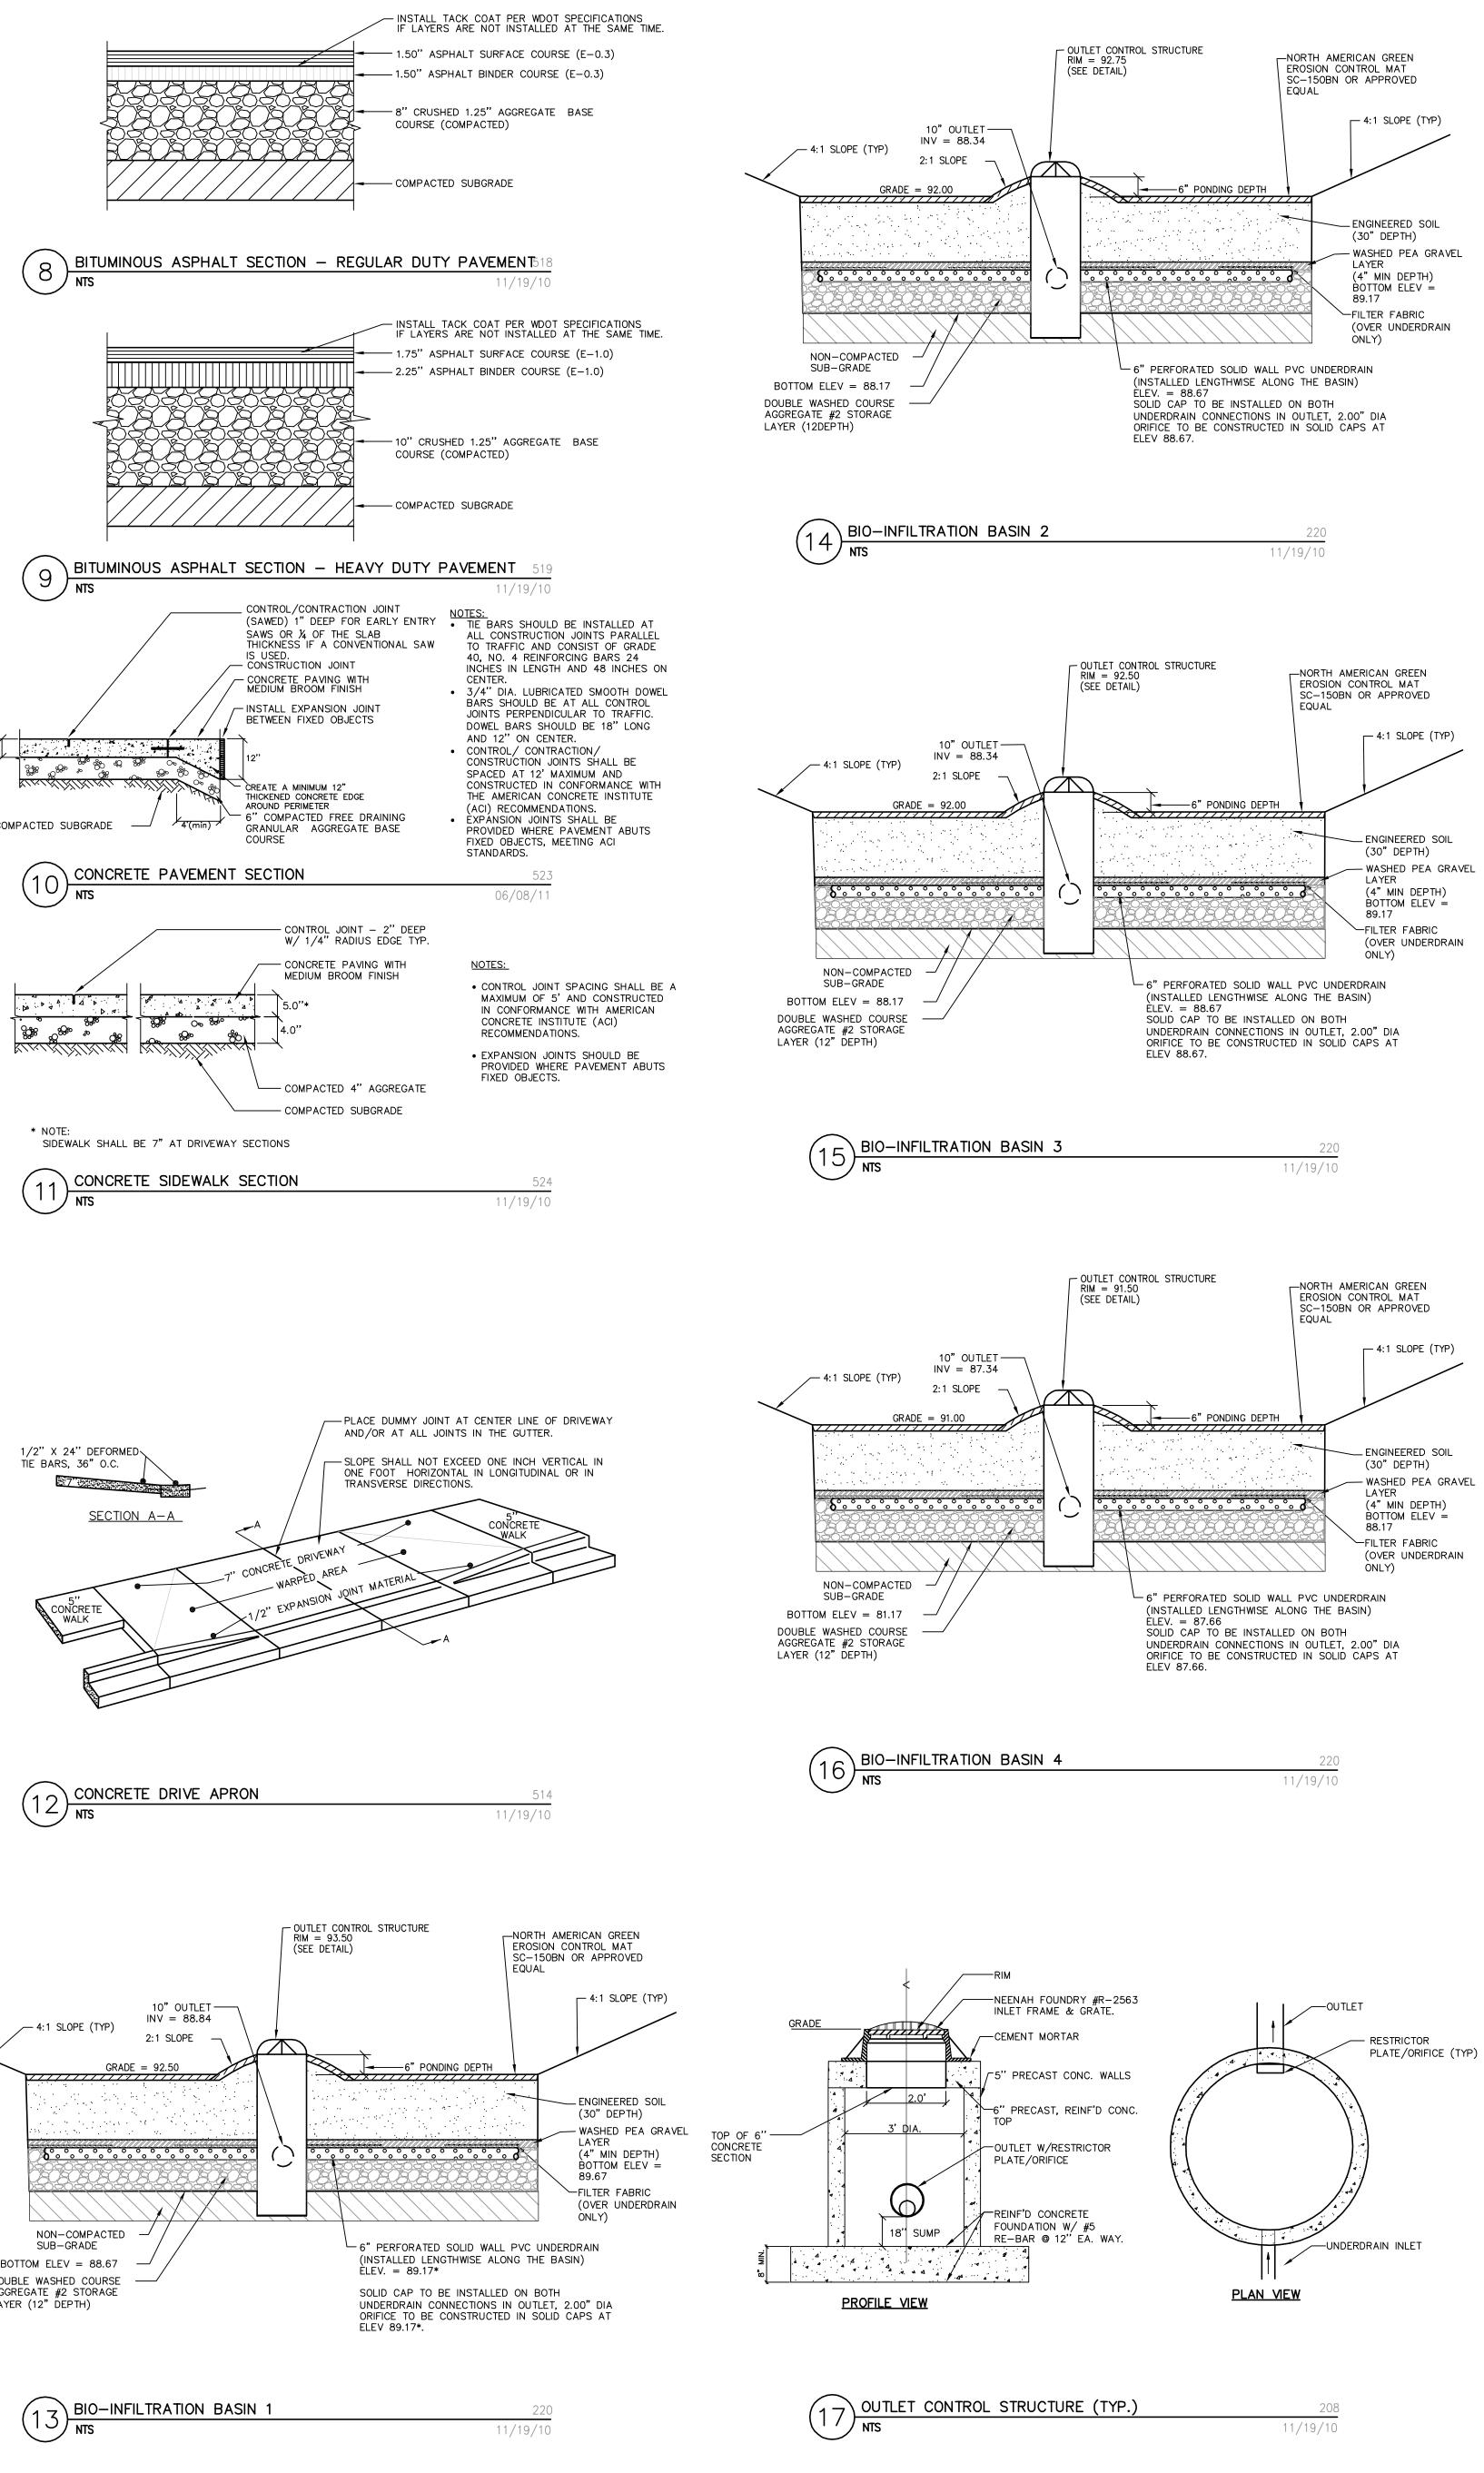





Issuance MUNICIPAL REVIEW SET (NOT FOR CONSTRUCTION) DATE: January 20, 2012

CONSTRUCTION **DETAILS**



KEEFE AVENUE HOUSING

JANUARY 20, 2012 Project No.

Sheet No.

11-1192.00

MUNICIPAL REVIEW SET (NOT FOR CONSTRUCTION) DATE: January 20, 2012


OVERALL LANDSCAPE

SCALE: 1"=20"-0" @ 42x30"

KEEFE AVENUE

Project No. 11-1192.00

L1.00

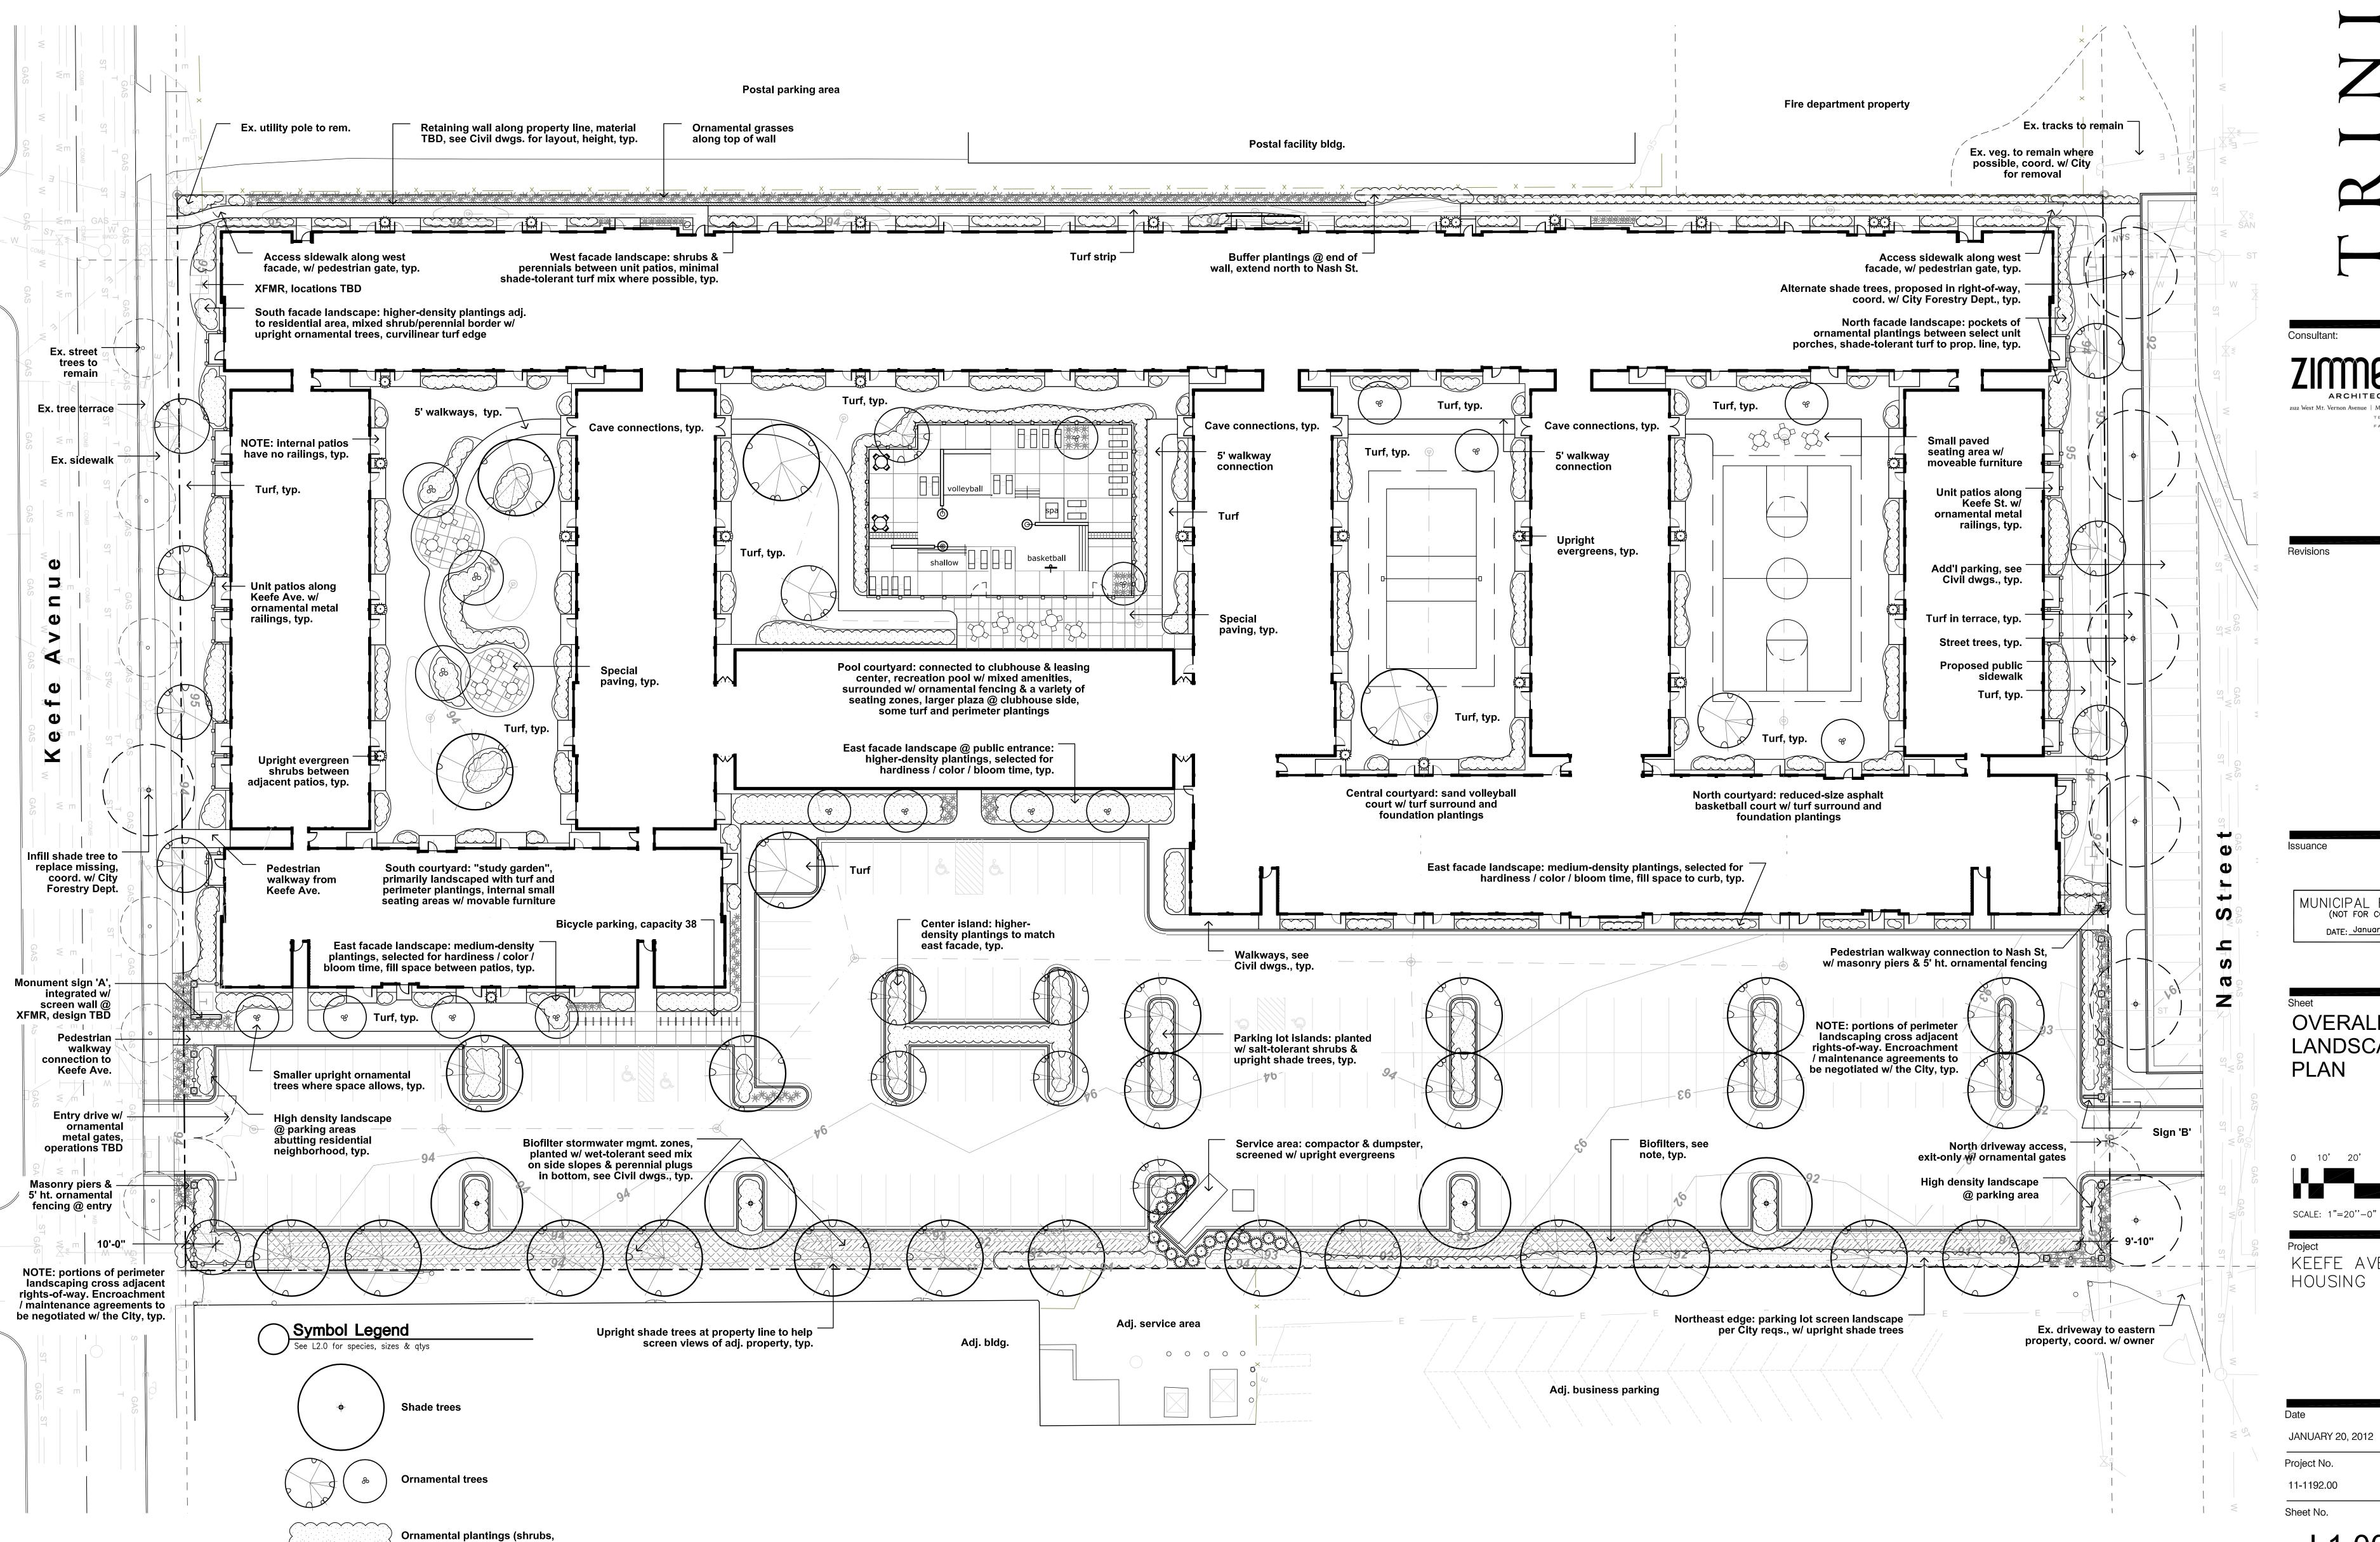

evergreens, perennials & grasses)

∖ Tree Planting Detail

Shrub Planting Detail

- 1.01 All landscape installation & maintenance to conform with all applicable local codes & ordinances, including (but not limited to) City of Milwaukee Municipal Code Ch. 295-405 "Landscaping."
- 1.02 See Site & Civil dwgs. for work limits, scope of construction, dimensions &/or construction notes. See Civil dwgs. for all hardscape, grading, stormwater management, site utilities & erosion control. See Landscape dwgs. for landscape plans, coverage/restoration requirements, details, schedules & notes. See Site electrical dwgs. for exterior lighting. See Architectural dwgs. for all building construction & signage.
- 1.03 Contractor shall provide shop drawings and material submittals of **all** hardscape & landscape construction elements shown in plan set for Landscape Architect review prior to construction.
- 1.04 Contractor to provide samples for Owner approval on all colors, finishes & materials (including but not limited to imported topsoil, gravels, mulches, seed mixes et al) prior to installation.
- 1.05 Caution: underground utilities may be present on site. The Contractor shall verify location of all above- and below-grade utilities, both public & private, prior to commencement of site construction. If unanticipated above- or below-grade conditions are encountered, notify Client & Landscape Architect prior to proceeding. Coordinate with local public utility locating entity as needed.
- 1.06 Contractor to verify layout prior to construction. Contact Landscape Architect or Civil Engineer if discrepancies are found.
- 1.07 Contractor to limit construction traffic to within work limit lines. All adjacent damage shall be the responsibility of the contractor to restore. See Civil drawings for limits of disturbance.
- 1.08 All written dimensions supersede scaled dimensions. All dimensions are taken from face of curb, wall or existing building foundations.
- 1.09 Private landscape installation in City rights-of-way will require written maintenance agreements with the City of Milwaukee, to be negotiated during the permit application process.

Landscape Notes

General Notes

- 2.01 Rough grading, utility installation, topsoil placement shall be completed by others. Landscape contractor shall coordinate with GC and/or earthwork contractor to complete the fine grading. Seed area and ornamental planting bed preparation shall be the landscape contractor's responsibility. Verify all existing site and grading conditions prior to construction.
- 2.02 All areas disturbed by grading or site construction shall be fine graded and restored with vegetative cover as shown in the plans. Areas outside of the work limit lines are to be left as-is unless disturbed by contractor's staging or stockpiling. See plans for cover types & locations. Coordinate restoration of staging / stockpile areas with LA prior to construction.
- 2.03 Contractor shall verify plant quantities shown on plan. Provide a material list to the LA prior to construction identifying the species, sizes & plant sources to be used throughout the project.
- 2.04 The Landscape Architect reserves the right to reject any substandard planting material. Such rejected material shall be removed from the project site immediately and replaced with material meeting the specifications set forth in the plans & schedules.
- 2.05 All nursery tags/labels shall be left on plant materials until the project punch-list inspection is completed by the Landscape Architect. Untagged materials will be assumed to be deficient.
- 2.06 All ornamental planting beds shall contain blended topsoil mix to a min. depth of 18". All seeded areas shall have a min. depth of 6". Suitable existing soil may be used & mixed if previously approved. Contractor is responsible for obtaining soil tests if existing topsoil is reused. Soil testing results shall include (but is not limited to) soil pH, % organic matter, phosphorus, potassium, calcium & texture (percentages of sand, silt and/or clay.) Contaminated soil shall be removed from the project site if discovered. Remove excessive clay, gravel & stones detrimental to healthy plant growth. Remove all stones greater than 1" diameter. Mix new topsoil mix into existing soil if needed.
- 2.07 Contractor is responsible for ensuring that all tree pits & planting areas drain properly. Notify Landscape Architect if drainage or moisture problems are encountered while planting.
- 2.08 Contractor shall backfill all trees, shrubs & evergreens with a mix of 1/3 plant starter mix & 2/3 remaining soil. Plant Starter Mix available from Liesener Soils, Jackson WI, or approved equal.
- 2.09 All existing trees to remain shall be protected. Prior to clearing/grubbing, install snow fencing @ 15' radius from trunks or driplines, whichever is farther. Fencing is to remain for duration of project. No grading or earthwork to occur in fenced zones except as indicated. No storage, traffic or parking to occur in fenced zones for the duration of the project.
- 2.10 All perennial and groundcover areas shall receive a 3" layer of plant starter mix and perennial starter fertilizer, rototilled into the top 6" of blended topsoil in beds.
- 2.11 All perennial areas shall receive a 1-2" layer of shredded hardwood bark mulch. Do not allow mulch to touch stems or leaves of perennials! All woody planting areas shall receive a 3" layer. Unless otherwise shown in the plans, no landscape fabric or weed barrier is to be installed.
- 2.12 Groundcover beds DO NOT receive a cover of shredded bark mulch.
- 2.13 Unless otherwise shown, all perennials & shrubs to be planted in triangular arrangements. For plants not shown individually, refer to the spacing shown in the plant schedule.
- 2.14 Stone mulch areas to contain 2-3" of Mississippi (or approved variant) 1" dia. stone installed over poly weed barrier. Edge with heavy-duty poly edging.
- 2.15 Before 60-day maintenance period ends, Contractor to install 6" shovel-cut edges wherever noted.
- 2.16 Contractor shall provide positive drainage away from all structures for a minimum of 10'.

Seeding Notes & Mixes

- 3.01 This work shall consist of preparing the seed beds and furnishing, sowing and mulching the required seed on the various seeded areas, as outlined in the site plans and specifications. All wet-tolerant seeding installation & maintenance shall conform with Wisconsin DNR Technical Document #1004.
- 3.02 Rough grading, drainage work, topsoiling and fine grading shall be completed before sowing the seed mixes. The areas to be seeded shall be worked with plow chisels, discs & harrows, soil finishers and/or other appropriate equipment until a reasonably even and loose seedbed is obtained. Seed beds shall be prepared immediately in advance of the seeding. If proposed seed areas are weedy, contractor to apply herbicide or other weed control measures to eliminate weeds. Conform with seed supplier's specifications if required.
- 3.03 Confirm that anticipated project schedule date(s) fall within the respective seed supplier's approved calendar prior to installation. Installations completed outside of acceptable seeding dates shall be the performed at the sole responsibility and expense of the contractor. For dormant seeding, a min. of one over-seed application in the following season will be required.
- 3.04 Seeds shall be PLS and will be mixed in accordance w/ mfr's specifications. Provide invoices, bag-tags or mix analysis results for approval prior to installation.
- 3.05 The seed mixtures shall be sown by means of equipment adapted to the purpose. Mechanical distribution of seed (i.e. Truax seed drill, Brillion seeder, cultipacker, slit-seeder, drop spreader or broadcast spreader) are the only accepted methods. No hand-broadcasting of seed.
- 3.06 No seeding shall occur if the wind exceeds 6 MPH.
- 3.07 Coordinate erosion control and/or mulching with Civil dwgs. In sloped areas steeper than 4:1, erosion matting shall be installed by others (see 3.09); installation coordination will be required. In areas with slopes between 4:1 and 8:1, landscape contractor shall apply clean hay or straw mulch, free of debris and seeds, on all newly seeded areas. Mulch shall be uniformly spread over the designated area at a rate of 55 bales per acre or as indicated in the respective seed supplier's specifications. Mulch material shall be chopped and blown into the seeded area. Lightweight E.C. matting and/or hydromulch will be accepted as a no-cost alternate if approved by Landscape Architect.
- 3.08 See Civil dwgs for erosion control devices. Coordinate with erosion control contractor where required to ensure that topsoil, seeding and/or mat installations are properly coordinated.
- 3.09 Contractor is responsible for obtaining soil tests for all seeded areas. Soil testing results shall include (but is not limited to) soil pH, % organic matter, phosphorus, potassium, calcium & texture (percentages of sand, silt and/or clay.) Contaminated soil shall be removed from the project site if discovered. If necessary, supply soil amendments required for specified seed mixes and/or coordinate alternate mixes if soils cannot be properly conditioned.
- 3.10 Seed mix substitutions will be considered only if submitted for approval 10 days before the close of bidding. All mixes to be installed & maintained per supplier's specifications. In addition to the mixes, with exception of the bluegrass zones, also Annual Rye cover crop @ 5 lbs per AC in spring/summer or 15 lbs per AC in fall.

BLUEGRASS MIX:

"Deluxe 50 Mix" to be supplied by Reinders, Elm Grove WI, 262-786-3300. Apply @ 5 lbs per 1000

FESCUE MIX:

"No-Mow Lawn Mix" to be supplied by Prairie Nursery, Westfield WI, 800-476-9453. Apply @ 220 lbs per AC.

WET MIX:

"Shortgrass Wet Prairie Mix" to be supplied by Agrecol Nursery, Madison WI, 608-223-3571 Apply @ 14 lbs per AC.

3.11 Contractor shall be responsible for providing two years of comprehensive seed area establishment, maintenance & warranty care for all seeded areas.


\ Hardscape / Amenity Notes

- 4.01 Fencing: Furnish, install & warranty ornamental fencing & masonry piers as shown. Fencing to be Ameristar "Montage Plus", color TBD from standard range. Shop drawings, details & specs shall be provided for review/approval. Heights:
 - Along north & south ends of the parking lot: 60" ht.
 - At the north & south-facing residential porches: 48" ht. - At the northwest & southwest corners of the building: 48" ht.
- Internal surrounding the pool: 42" ht. (or to meet min. pool code.)
- 4.02 Gates: Furnish, install & warranty ornamental metal swing gates at the two vehicle entrances. Gate materials & styles to match fencing. Operations & control systems TBD.
- 4.03 Segmental Retaining Walls: See Civil plans for all wall layouts, alignments & TOW/BOW heights. Walls to be furnished, installed & warrantied per individual manufacturer's specifications. The contractor shall be responsible for all necessary wall system engineering & site soil testing. Stamped shop drawings, details & specifications shall be provided for Architect / Landscape Architect / Civil Engineer's review prior to construction.

Following are approved wall systems. Other systems will be considered only if submitted for approval 10 days before the close of bidding. Color to be selected from standard mfr. range:

- Keystone "Compac" straight face Unilock "Pisa2" Versalok "Square Foot"

4.04 Add-alternate irrigation system: Furnish, install, maintain (for one year) & warranty a fully-automated design-build irrigation system for all project lawn areas (perimeter as well as courtyards.) System to consist of all required components for a functional system, including (but not limited to) all plumbing, street lateral(s), meter(s) & pit(s), master valve(s), RPBP(s), digital controller(s) w/ two-week programmable calendar, rain sensor(s), wiring, manifolds, lines, valves, laterals & heads. System to be designed by a Certified Irrigation Designer & installed by a Certified Irrigation Contractor. Layout to be based on the landscape plan. Shop drawings, details & specs shall be provided for review.

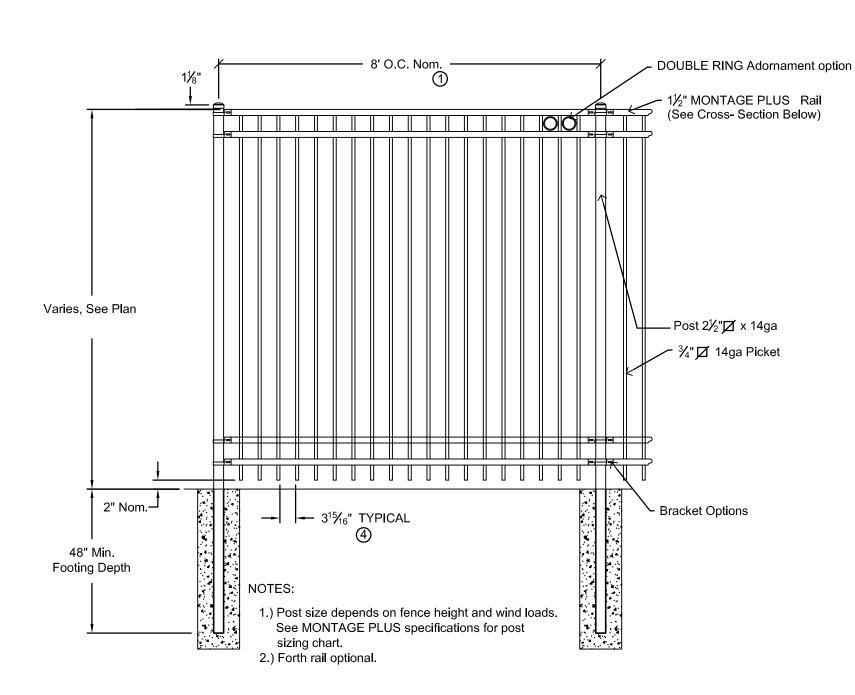

Ornamental Fencing Detail

- 5.01 This work shall consist of preparing the plug areas and furnishing, installing and mulching the required wet-tolerant perennial plugs on the various seeded areas, as outlined in the site plans and
- 5.02 Rough grading, drainage work & engineered soil spreading shall be completed by others before installing the plugs. See the Civil plans for the areas of engineered soil and its placement.
- 5.03 Install plugs during the respective plug supplier's approved calendar. Installations completed outside of acceptable install dates shall be the performed at the sole responsibility and expense of the contractor.
- 5.04 See 3.07 for erosion mat installation notes. Plugs are to be installed into the engineered soil via slits cut through the mat. See Civil dwgs for balance of site erosion control measures.
- 5.05 Plug kit/source substitutions will be considered only approved 10 days before the close of bidding.
- 5.06 Rain Garden Plugs: "Deluxe Rain Garden for Shade" kit(s.) To be supplied by Agrecol. Install & maintain per supplier's specifications. Install @ 12" o.c., staggered / triangular spacing.

\ Plant Schedule

NOTE: Species are representative only; final selections TBD

Symbol	Qty Prop.	Botanical Name	Common Name	Installed Size	Root	Spacing	Notes
Shade ¹	Trees [Qty. 32 + 7 shade trees]		1		<u>'</u>	
Gin Mag		Ginkgo biloba 'Magyar'	Magyar Ginkgo	3" Cal.	B/B	As Shown	
Gym Esp		Gymnocladus dioicus 'Espresso'	Seedless Kentucky Coffeetree	3" Cal.	B/B	As Shown	
Ulm New		Ulmus x. 'New Horizon'	New Horizon Hybrid Elm	3" Cal.	B/B	As Shown	
Orname	ental Ti	ees [Qty. 33]					
Ame Col		Amelanchier x. 'Cole's Select'	Cole's Select Serviceberry	8' Ht.	B/B	As Shown	Heavy Three S
Mal Sar		Malus sargentii 'Firebird'	Firebird Sargent Crabapple	6' Ht.	B/B	As Shown	Single Stem
Syr Ivo		Syringa ret. 'Ivory Silk'	Ivory Silk Jap. Tree Lilac	2.5" Cal.	B/B	As Shown	Single Stem
Pyr Aut		Pyrus calleryana 'Autumn Blaze'	Autumn Blaze Ornamental Pear	2.5" Cal.	B/B	As Shown	Single Stem
Pyr Cle		Pyrus calleryana 'Cleveland Select'	Cleveland Select Ornamental Pear	2.5" Cal.	B/B	As Shown	Single Stem
Decidu	ous Sh	rubs [Qty. 8,300 SF]					
Bux Gre		Buxus x 'Green Velvet'	Green Velvet Boxwood	24" Ht.	2 Gal.	42-48" o.c.	
Hyd Gra		Hydrangea arb. 'Grandiflora'	Snowhill Hydrangea	24" Ht.	2 Gal.	48" o.c.	
Myr Pen		Myrica pennsylvanica	Northern Bayberry	24" Ht.	2 Gal.	48" o.c.	
Rhu Gro		Rhus aromatica 'Gro Low'	Grow Low Sumac	24" Ht.	2 Gal.	48" o.c.	
Ros CFW		Rosa 'Carefree Wonder'	Carefree Wonder Rose	24" Ht.	2 Gal.	36" o.c.	
Spi Tor		Spiraea betulifolia 'Tor'	Tor Birchleaf Spirea	24" Ht.	2 Gal.	42" o.c.	
Spi Fri		Spiraea fritschiana	Fritsch Spirea	24" Ht.	2 Gal.	36-42" o.c.	
Syr Pal		Syringa meyeri 'Palibin'	Palibin Dwf. Lilac	30-36" Ht.	2 Gal.	48-54" o.c.	
Vib Red		Viburnum dentatum 'JN Select'	Red Feather Arrowwood Viburnum	48" Ht.	B/B	72" o.c.	
Evergre	en Shi	ubs [Qty. 3,500 SF]					
Jun Kal		Juniperus chinensis 'Kallay'	Kallay Compact Juniper	24" sprd.	7 Gal.	54-60" o.c.	
Jun Ska		Juniperus sabina 'Skandia'	Skandia Juniper	24" sprd.	7 Gal.	54-60" o.c.	
Tax Gem		Taxus x. media 'Gem'	Gem Densiform Yew	24" sprd.	7 Gal.	54-60" o.c.	
Perenn	ials & 0	Grasses [Qty. 2,900 SF]					
Alc Mol		Alchemilla mollis	Lady's Mantle	1 Gal.	Cont.	24" o.c.	
Aru Dio		Aruncus dioicus	Goatsbeard	1 Gal.	Cont.	24" o.c.	
Hem Hap		Hemerocallis 'Happy Returns'	Happy Returns Daylily	4.5"	Cont.	18-24" o.c.	
Hem Hyp		Hemerocallis 'Hyperion'	Hyperion Daylily	4.5"	Cont.	24" o.c.	
Hem Ros		Hemerocallis 'Rosy Returns'	Rosy Returns Daylily	4.5"	Cont.	18-24" o.c.	
Hos Roy		Hosta 'Royal Standard'	Royal Standard Hosta	1 Gal.	Cont.	30" o.c.	
Hos Sum		Hosta 'Sum & Substance'	Sum & Substance Hosta	1 Gal.	Cont.	42" o.c.	
Mis Mor		Miscanthus 'Morning Light'	Morning Light Maidenhair Grass	1 Gal.	Cont.	30" o.c.	
Per Lit		Perovskia atr. 'Little Spire'	Little Spire Russian Sage	4.5"	Cont.	24" o.c.	
Spo Het		Sporobolus heterolepsis	Prairie Dropseed	1 Gal.	Cont.	24" o.c.	
Ground	lcover	[Qty. 700 SF]		,			
Euo Col		Euonymus fortunei 'Coloratus	Purpleleaf Wintercreeper	2.5"	Cont.	10-12" o.c.	
			·				

Consultant:

TELEPHONE [414] 476.9500 FACSIMILE [414] 476.8582

Revisions

Issuance

MUNICIPAL REVIEW SET (NOT FOR CONSTRUCTION) DATE: January 20, 2012

LANDSCAPE DETAILS, SCHEDULES & NOTES

KEEFE AVENUE HOUSING

Project No.

JANUARY 20, 2012

11-1192.00 Sheet No.



:1.0 NIS


NOTES:

1. DIMENSIONS GIVEN ARE MINIMUM. PROVIDE POLE BASE DIAMETER AND DEPTH AS REQUIRED IN ACCORDANCE WITH LOCAL SOIL AND WIND VELOCITY CONDITIONS.

2. ALL LIGHTING POLE CONCRETE BASES SHALL BE LOCATED A MINIMUM OF 12 INCHES OFF THE FACE OF THE CURBING OR CENTERED WITHIN AN ISLAND. IN ALL CASES, HOWEVER, FINAL LOCATIONS OF LIGHTING POLES MUST BE VERIFIED WITH THE ARCHITECT/ENGINEER PRIOR TO INSTALLATION.

3. ALL DIMENSIONS POLE BASE ARE FOR BIDDING ONLY. POLE BASE SHALL MATCH THOSE AT EXISTING POLES, IF APPLICABLE.

POLE HEIGHT	BASE EMBEDMENT/DIAMETER							
I OLL TILIGITI	1 HEAD	2 HEAD	3 HEAD	4 HEAD				
15'-0"	6'-5"/2'-0"	6'-5"/2'-0"	6'-5"/2'-0"	6'-5"/2'-0"				
20'-0"	6'-5"/2'-0"	6'-5"/2'-0"	8'-0"/2'-0"	8'-0"/2'-0"				
25'-0"	6'-5"/2'-0"	8'-0"/2'-0"	9'-0"/2'-0"	10'-0"/2'-0'				
30'-0"	8'-0"/2'-6"	9'-0"/2'-6"	10'-0"/2'-6"	10'-0"/2'-6'				
NOTES: 1. TABLE I	PRESSURE OF	3000 PSF.						

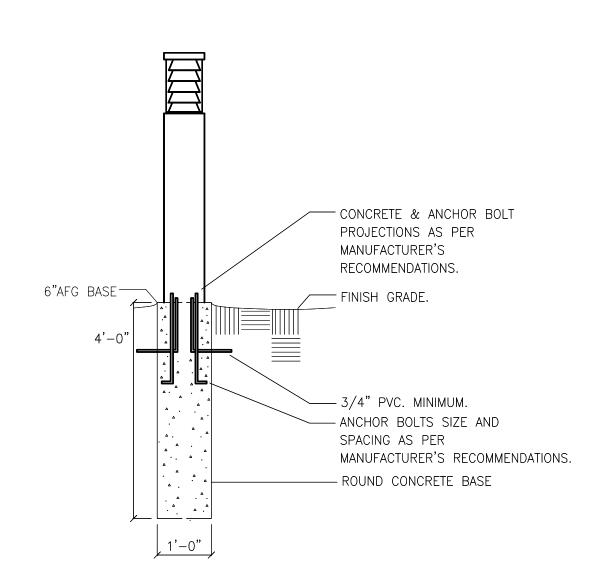

BOLLARD BASE DETAIL E1.0 NTS

NOTES:
1. DIMENSIONS GIVEN ARE MINIMUM. PROVIDE POLE
BASE DIAMETER AND DEPTH AS REQUIRED IN
ACCORDANCE WITH LOCAL SOIL AND WIND VELOCITY

CONDITIONS.

2. ALL LIGHTING POLE CONCRETE BASES SHALL BE LOCATED A MINIMUM OF 6 INCHES OFF THE FACE OF THE CURBING OR CENTERED WITHIN AN ISLAND. IN ALL CASES, HOWEVER, FINAL LOCATIONS OF LIGHTING POLES

MUST BE VERIFIED WITH THE ARCHITECT/ENGINEER PRIOR

PLAN NOTES:

ANAYLSIS.

TO INSTALLATION.

LIGHTING IN THIS AREA TO BE COORDINATED WITH THE CITY.

 LIGHTING ALONG THIS FACADE IS INTENDED TO BE BUILDING MOUNTED AND SHALL BE COORDINATED WITH THE ARCHITECT.

GENERAL NOTES:

1. THE TYPE "OD" FIXTURES SHOWN ON THE PLAN ARE INTENDED TO ILLUMINATE ORNAMENTAL TREES/LANDSCAPING/SIGNAGE. EXACT FIXTURE QUANTITIES/LOCATIONS TO BE DETERMINED. NOTE THAT THESE FIXTURES ARE NOT INCLUDED IN FOOTCANDLE CALCULATION.

2. THE RESULTS OF THIS FOOTCANDLE CALCULATION STUDY ARE TO BE VIEWED ONLY AS AN INDICATION OF POSSIBLE PERFORMANCE DUE TO VARIATIONS IN LAMPS, BALLASTS, MANUFACTURING, LINE VOLTAGE AND SITE CONDITIONS. A GUARANTEED LEVEL OF PERFORMANCE IS NOT POSSIBLE AND IS NOT REPRESENTED BY THIS

3. COURTYARD LIGHTING SHOWN IS NOT COMPLETE. LIGHTING SHALL BE COORDINATED AS THESE SPACES ARE DEVELOPED TO ACCOMMODATE ACTIVITY(IES) OF THOSE COURTYARDS. EXIT SIGNS AND EGRESS LIGHTING SHALL ALSO BE COORDINATED AS THESE SPACES ARE DEVELOPED.



TYPE "OA & OB" - POLE MOUNTED LUMINAIRE



TYPE "OC" - BOLLARD



TYPE "OD" - ACCENT FLOODLIGHT


29. INCLUDE SELF-DIAGNOSTICS

		LI(GHTING	FIX	KTU	RE SCH	HEDULE			H A R E N G C O N 255 North 21st Street Milw 414.475.5554 414.773.9299	WOOD INEERING SULTANTS raukee Wisconsin 53233 ax harwood@HECL.COM	
DEC	DECORPORAL	LAMP DATA					LIGHTING FIXTURE			T MTC	MTG.	SEE
DES.			NO. TYPE		DEPTH	MFR.	SERIES	RIES OPTIONS/ACCESSORIES		MTG.	SURF	NOT LF_
OA	SINGLE POLE MOUNTED LUMINAIRE FLAT GLASS; FULL CUTOFF; TYPE III DIST.;HOUSE SIDE SHIELD	1	250W PSMH	120	_	EMCO	AVA/1/3/250PSM 120/HS SERIES 25'POLE,3'AFG BA	03,18,26	PS	SURF	CONC BASE	
ОВ	DOUBLE POLE MTD. LUMINAIRE FLAT GLASS; FULL CUTOFF; TYPE III DISTRIBUTION	2	250W PSMH	120	_	EMCO	AVA/2@180/3/25 PSMH/120 SERIES 25'POLE,3'AFG BA	0 5 03,18,26 SE	PS	SURF	CONC BASE	
ОС	42"H ROUND BOLLARD CONE ROUND REFLECTOR 180DEG HOUSE SIDE SHIELD	1	70W PSMH	120	_	EMCO	BR8/C/70MH/120 /HS-180 SERIES 6" AFG BASE	03,18,26	PS	SURF	CONC BASE	
OD	ADJUST. ACCENT FLOODLIGHT 45DEG CAP, WET LOCATION	1	10W LED MR16	120	_	VISION 3	FL1A/C4/K1 SERI 3"AFG BASE	03,18,26	DRV	SURF	CONC BASE	
OE	SINGLE POLE MOUNTED LUMINAIRE FLAT GLASS; FULL CUTOFF; TYPE III DIST.;HOUSE SIDE SHIELD	1	400W PSMH	120	_	EMCO	AVA/1/3/250PSM 120/HS SERIES 25'POLE,3'AFG BA	H/ 03,18,26 SE	PS	SURF	CONC BASE	
AR CONC. EXP	VIATIONS: AS REQUIRED BASE CONCRETE BASE ELECTRONIC EXPOSED STRUCTURE	GR GY LA: LIG	P. GYPSUM BOAR S LENGTH AS SH		NA PS PENI REC	NOT APPLICABI PULSE START D PENDANT RECESSED	BALLAST SP ST/	EC SPECIAL LAND D	AS LEN	RIES NGTH AS D DRIVEI D DIMMA	7	
01. (0 02. H 03. F 04. S 05. F 006. E	IS/ACCESSORIES CODE LISTING: D.125" PATTERN 12 ACRYLIC LENS HOLOPHANE 8246 LENS PAINT AFTER FABRICATION SPRING LOADED LATCHES FLUSH ALUMINUM DOOR FRAME ELECTRONIC BALLAST, TOTAL HARMO DISTORTION ≤ 10% FLUORESCENT DIMMING BALLAST WHITE TRIM RING SEMI-DIFFUSE, LOW-IRIDESCENT CL		11. 12. 13. 14. 15. 16. 17.	PENDAN' SAFETY NEMA H WIRE GU EMERGEI TOP ANI TIME DE WET LOO	OOK, CO JARD NCY BAL D BOTTO LAY CATION L	T DRD AND PLUG LLAST DM LENSING		21. QUARTZ RESTRIKE 22. EMERGENCY OPERATIO INTEGRAL NICAD BA 23. LOCKING TYPE SOCKE 24. SLOPE ADAPTER 25. TWO BALLAST COVERS 26. STANDARD FINISH TO ARCHITECT 27. 277/24 VOLT TRANSF 28. LEAD—CALCIUM BATTER	TTERY TS BE SELE ORMER	CTED B	Y	

20. FURNISH WITH UNIVERSAL ARROWS AND

RED STENCIL FACE

ALZAK REFLECTOR

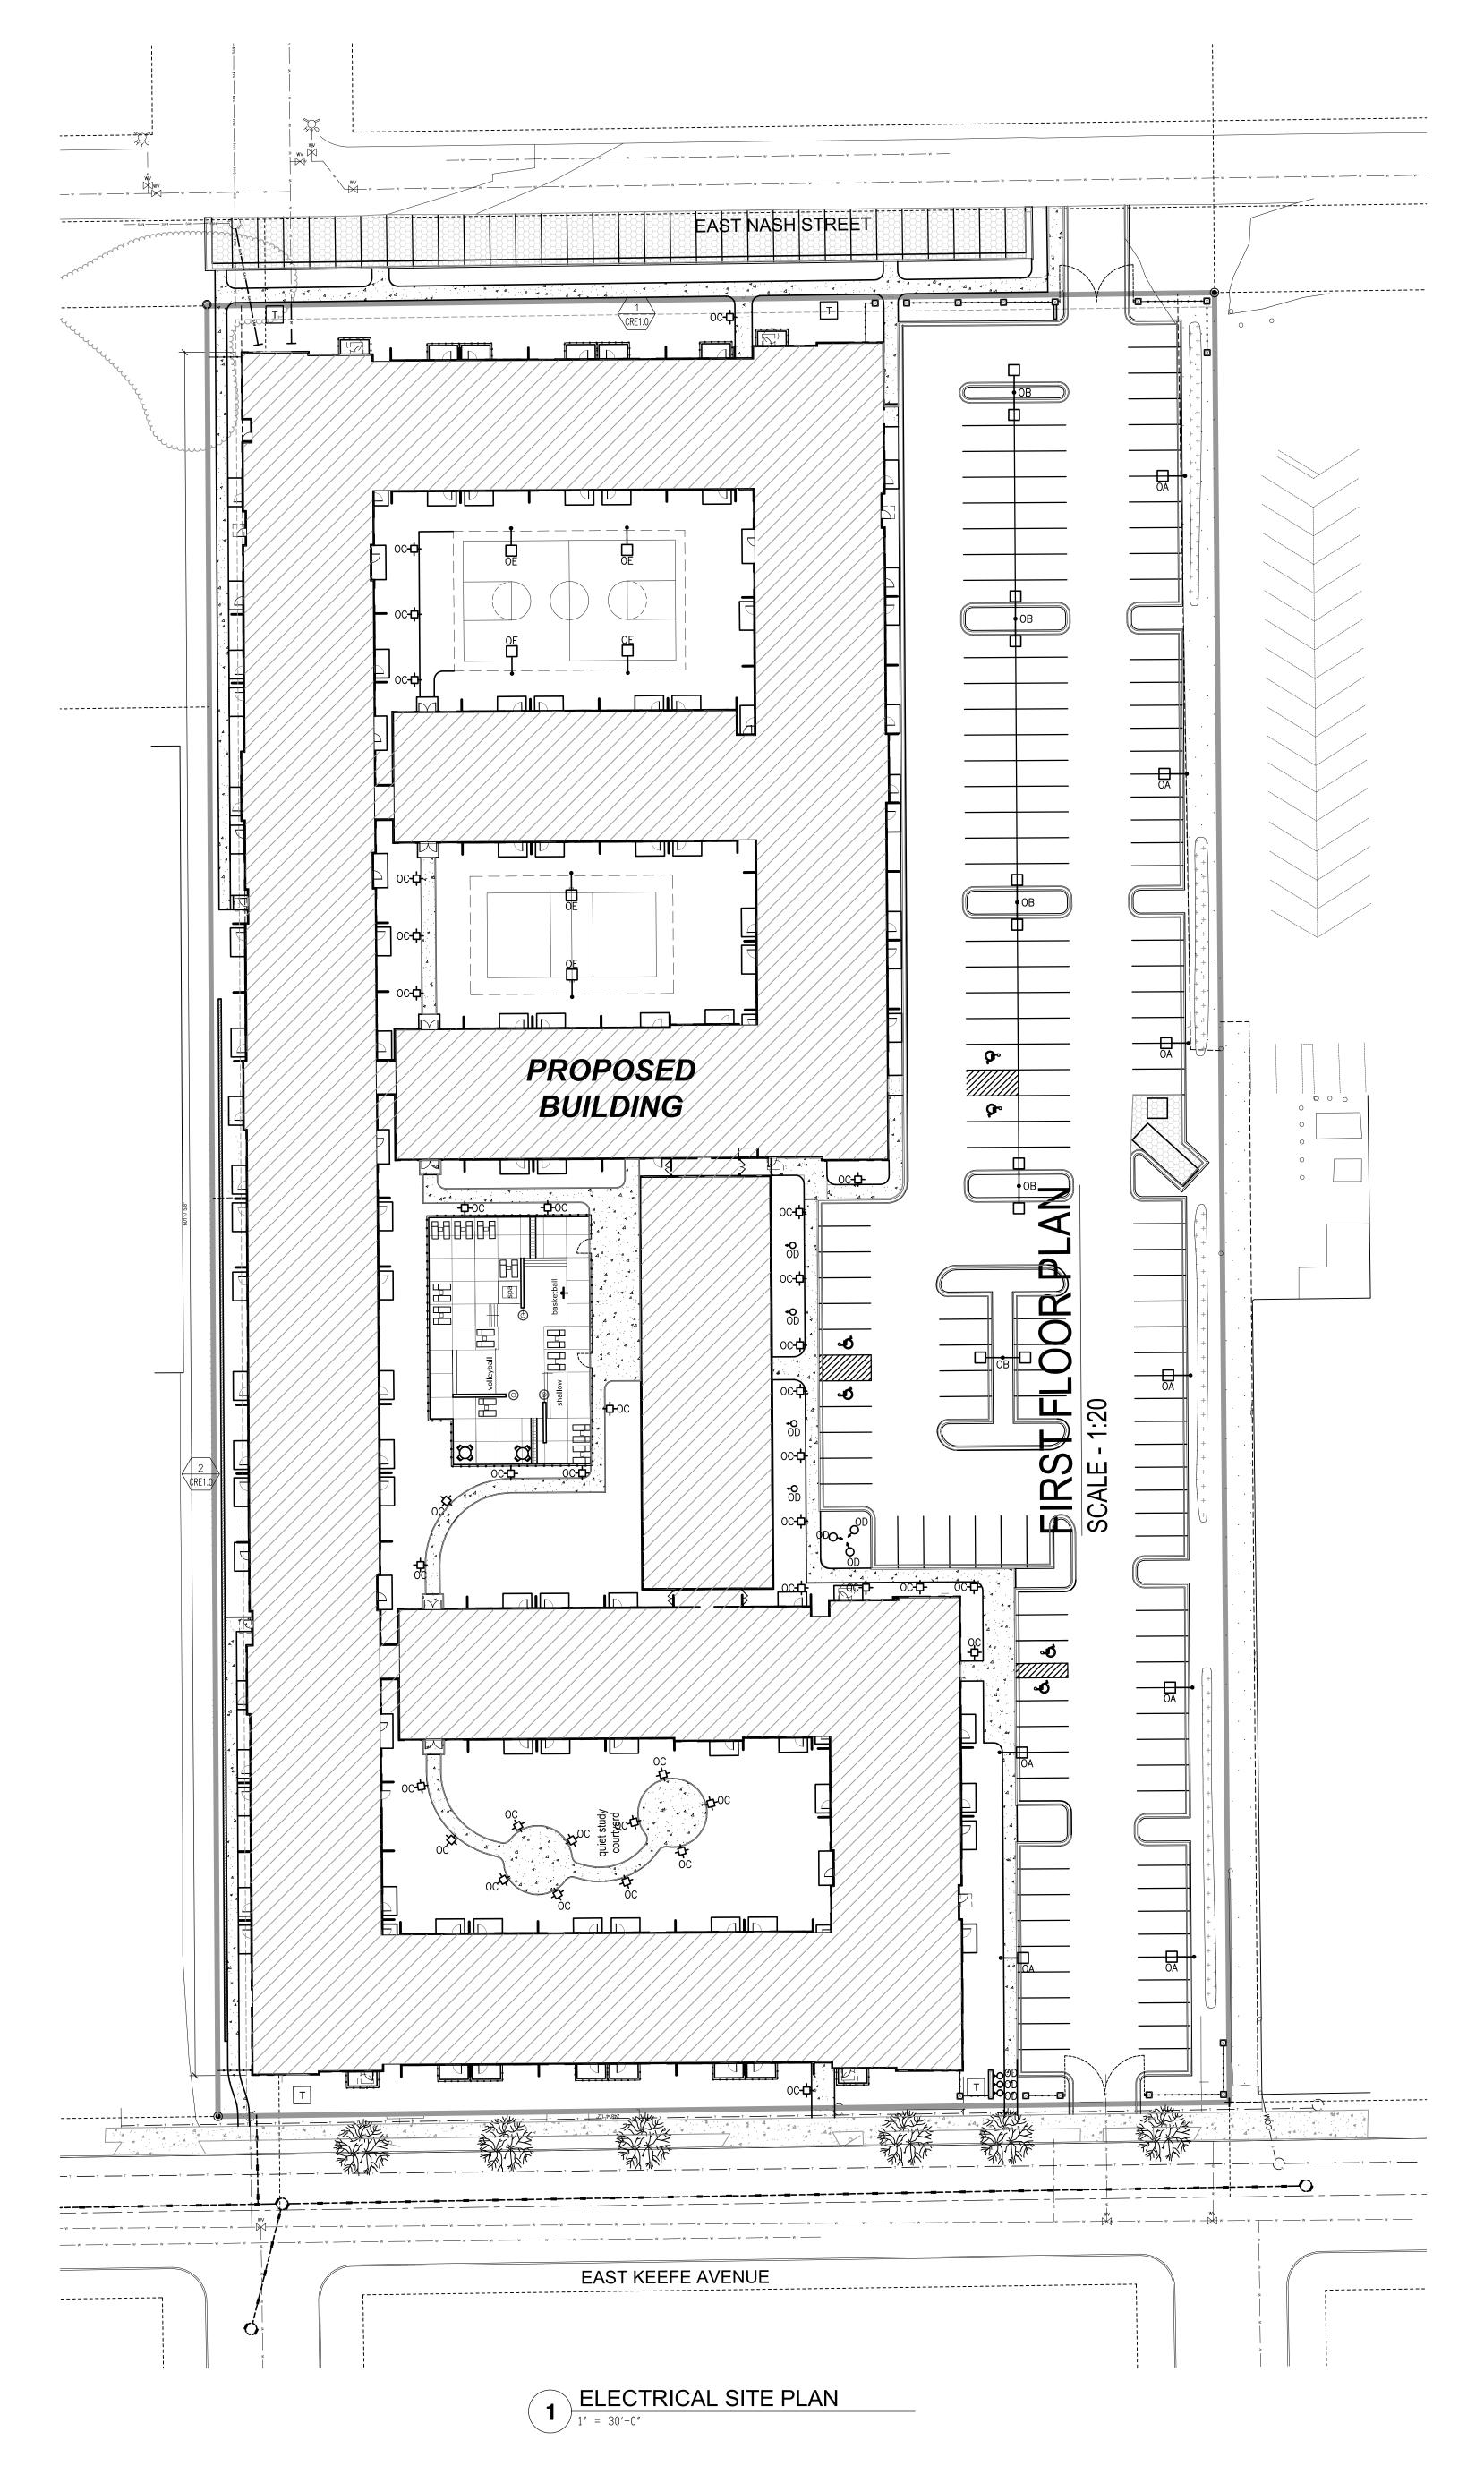








Sheet
ELECTRICAL SITE
PLAN

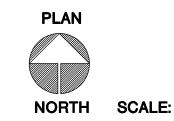

HOUSING

Project

KEEFE AVENUE

Date
JANUARY 20, 2012

Project No. 11-1192.00

Sheet No.

CRE1.0