




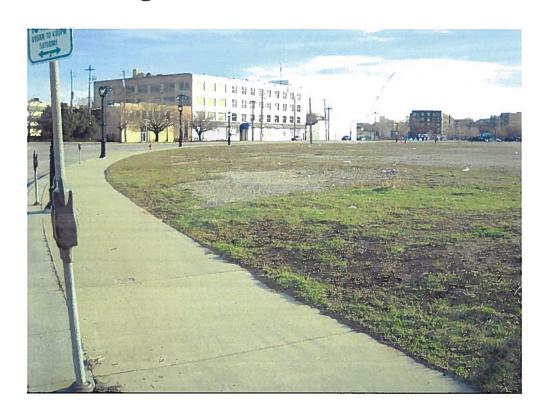

INT OF WATER ST AND MARKET ST LOOKING SOUTH SOME: N.T.S.



WATER ST LOOKING NORTHEAST SCALE N.T.S.



2 INT OF WATER ST AND MARKET ST LOOKING SOUTHWEST SOME NTS.



OGDEN ST LOOKING WEST
SCALE N.T.S.



INT OF KNAPP ST AND MARKET ST LOOKING SOUTHWEST SALE NTS.



3 INT OF KNAPP ST AND MARKET ST LOOKING NORTHWEST SCALE NT.S.




2 INT OF KNAPP ST AND MARKET ST LOOKING WEST SCALE N.T.S.





INT OF KNAPP ST AND MARKET ST LOOKING NORTH
SCALE N.T.S.


ZIMPERNAN ARCHITECTURAL STUDIOS INC.

SITE PHOTOGRAPHS

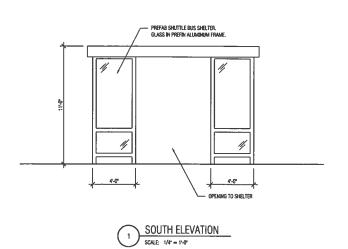

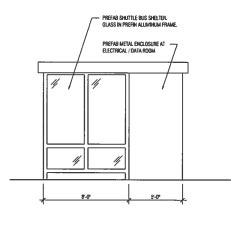

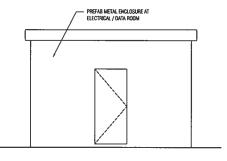

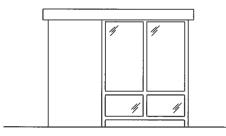










5 SIMILAR TYPE OF PREFAB STRUCTURE SCALE N.T.S.

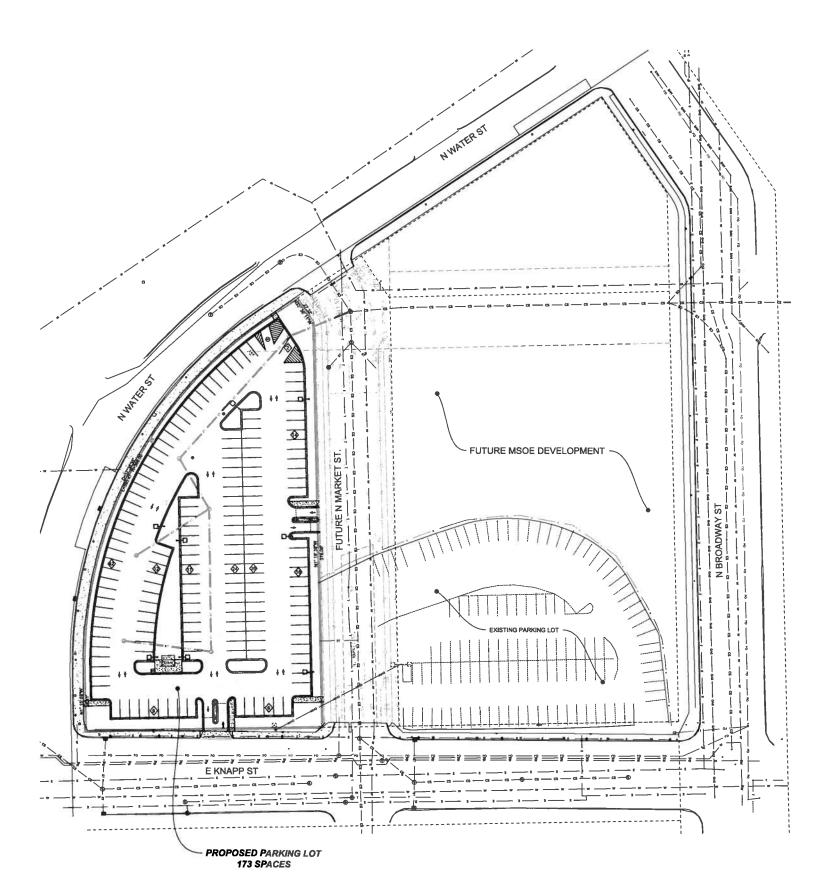

SITE ZONING AND LOCATION TABLE

LEGAL DESCRIPTION: LOT 3 OF PROPOSED CSM

PROPERTY LOCATION: 1303 N BROADWAY STREET MILWAUKEE, WI

EXISTING ZONING: RED PROPOSED ZONING:

ZONING SETBACKS:

PROPERTY OWNER:

BUILDING SETBACK: 6 FEET (KNAPP STREET)

0 FEET (WATER & MARKET STREETS

PARKING SETBACK: 6 FEET (KNAPP STREET) 5 FEET (WATER & MARKET STREETS)

M&I MARSHALL & ILSLEY BANK

PROPOSED USEAGE: PARKING LOT

SITE CALCULATION TABLE

TOTAL SITE AREA 67,728 SF / 1.56 AC TOTAL DISTURBED AREA EXISTING IMPERVIOUS AREA 67,728 SF / 1.56 AC 67,728 SF / 1.56 AC 55,147 SF / 1.27 AC PROPOSED GREENSPACE 12,589 SF / 0.29 AC (18.58% OF SITE)

PROPOSED REGULAR PARKING SPACES

PROPOSED TOTAL PARKING

LOCATION MAP: LOCATION E JUNEAU AVE.

HATCH LEGEND PROPOSED CONCRETE SIDEWALK EXISTING CONCRETE SIDEWALK PROPOSED REGULAR DUTY ASPHALT PAVEMENT ROPOSED DEPRESSED CURE PROPOSED CURB TAPER PROPOSED REVERSE CURB

CIVIL SHEET INDEX:

- C1.00 SITE PLAN OVERALL C1.01 SITE PLAN DETAILED
- C1.02 GRADING AND EROSION CONTROL PLAN
- C1.03 DEMOLITION PLAN
 C1.04 EXISTING SITE SURVEY
- C5.01 CONSTRUCTION DETAILS C5.02 CONSTRUCTION DETAILS

GENERAL NOTES AND SPECIFICATIONS

GENERAL NOTES AND STEATHS INTO INTO STREAM INTO STEATH INTO THE EXISTING SITE INFORMATION ON THIS PLAN WAS TAKEN FROM A SITE SURVEY PROVIDED BY THE SIGMA GROUP. THE ENGINEER MAKES NO WARRANTY OR REPRESENTATION WITH REFERENCE TO THE ACCURACY AND COMPLETNESS OF THE EXISTING CONDITIONS INDICATED ON NOT INDICATED ON THE ENGINEERING PLANS PROVIDED. THE CONTRACTOR SHALL VERIFY THE LOCATION OF ALL EXISTING SITE CONDITIONS INCLIDING UNDERGROUND UTILITIES, UNDERGROUND UTILITIES UNDERGROUND UTILITIES UNDERGROUND UTILITIES UNDERGROUND UTILITIES CONTRACTOR SHALL INFORM THE OWNER AND ENGINEER OF ANY DISCREPANCIES PRIOR TO COMMENCING WITH WORK. QUESTIONS REGARDING THE EXISTING SURVEY SHALL BE DIRECTED TO THE PARTIES LISTED ABOVE.

BEFORE PROCEEDING WITH ANY UTILITY CONSTRUCTION, CONTRACTOR SHALL EXCAVATE EACH EXISTING LATERAL TO BE CONNECTED TO VERIFYING ELEVATION, LOCATION AND SIZE). SHOULD THE EXISTING UTILITY NOT BE AS INDICATED ON THE PLAN, THE ENGINEER SHALL BE NOTIFIED IMMEDIATELY FOR EVALUATION.

ALL UTILITY CONSTRUCTION SHALL ADHERE TO THE STANDARD SPECIFICATIONS FOR SEVER AND WATER CONSTRUCTION IN WISCONSIN (2003), AS WELL AS, THE CITY OF MILWAUKEE CONSTRUCTION STANDARDS AND THE DEPT. OF COMMERCE SEC, 6247.

SHALL BE DIRECTED TO THE PARTIES LISTED ABOVE.

- ALL UTILITY PERMITS MUST BE RECEIVED FROM THE CITY OF MILWAUKEE PRIOR TO THE START OF CONSTRUCTION.
- NOTIFY THE PUBLIC WORKS INSPECTION DEPT. AT LEAST 48 HOURS BEFORE STARTING CONSTRUCTION,
- BACKFILL REQUIREMENTS AND ROADWAY/SIDEWALK RESTORATION SHALL ADHERE TO LOCAL STANDARDS (GRANULAR BACKFILL UNDER OR WITHIN 5' OF CURBS, SIDEWALK, OR PAVEMENT. SPOIL MAY BE USED ELSEWHERE. SLURRY BACKFILL WILL BE REQUIRED IN PUBLIC ROADWAYS.)
- PROPOSED STORM SEWER SHALL BE RCP, ASTM C-76, CLASS III WITH RUBBER GASKET JOINTS CONFORMING TO ASTM C-433 (UNLESS OTHERWISE NOTED).
- UTILITY TRENCHES SHALL BE MECHANICALLY COMPACTED IN ACCORDANCE WITH THE STANDARD SPECIFICATIONS FOR SEWER AND WATER CONSTRUCTION IN WISCONSIN.
- SILT FENCE AND ALL OTHER EROSION CONTROL METHODS MUST BE INSTALLED PRIOR TO COMMENCEMENT OF CONSTRUCTION, ALSO, CONTRACTOR IS RESPONSIBLE FOR REMOVING EROSION CONTROL METHODS ONCE THE SITE IS STABILIZED.
- THE PROPOSED SITE LOCATION AND SURROUNDING STREETS MUST BE KEPT DEBRIS
 FREE. SWEEP STREETS AS NEEDED TO MAINTAIN CLEAN STREETS.
- ALL EXCAVATED OR STRIPPED MATERIALS NOT BEING REPLACED IN UTILITY TRENCHES
 OR BEING USED FOR FILL SHALL BE REMOVED FROM THE SITE, UNLESS OTHERWISE
 DIRECTED BY THE OWNER.
- 12. ALL DISTURBED GRASS AREAS SHALL BE STABILIZED (PER DNR TECHNICAL STANDARDS) WITHIN 7 DAYS OF COMPLETION. DISTURBED GRASS AREAS SHALL BE TOPSOILED (6°), RESEEDED AND STABILIZED. AREAS WITH A SLOPE OF 3H:1V OR STEEPER SHALL BE COVERED WITH A CLASS 1 TYPE A EROSION FABRIC. (SEE SPECIFICATIONS)
- SEE ARCHITECTURAL PLANS FOR EXACT BUILDING & FOUNDATION DETAILS AND ORIENTATION.
- 14. ALL ON-SITE CONCRETE CURB AND GUTTER TO BE 18" WIDE VERTICAL FACE, UNLESS OTHERWISE NOTEO. REVERSE OR REGULAR STYLE CURB DENOTED ON PLANS.
- 15. ALL CURB ELEVATIONS ARE EDGE OF PAVEMENT UNLESS OTHERWISE NOTED. SEE CURB DETAIL FOR TOP OF CURB ELEVATIONS.
- 6. ALL CURB RADII ARE MEASURED TO THE FACE OF CURB UNLESS OTHERWISE NOTED.
- CONTRACTOR SHALL MATCH PROPOSED CONCRETE CURB AND GUTTER, SIDEWALK AND PAVEMENT TO EXISTING IN ELEVATION AND ALIGNMENT.
- REMOVAL OF CURB AND GUTTER, SIDEWALK AND PAVEMENT SHALL BE IN ACCORDANCE WITH THE STANDARD SPECIFICATIONS OF THE WISCONSIN D.O.T.
- ALL CONCRETE FOR CURB AND GUTTER, ROADWAY AND SIDEWALKS MUST CONFORM TO THE STANDARD SPECIFICATIONS FOR READY MIXED CONCRETE. MINIMUM 28 DAY COMPRESSIVE STRENGTH TEST MUST EQUAL 4000 PSI.
- 20. CONTRACTOR IS RESPONSIBLE FOR PROTECTING ALL PROPERTY CORNERS
- 21. CONTRACTOR IS RESPONSIBLE FOR REPAIRING ANY DAMAGE TO EXISTING UTILITIES OR SITE IMPROVEMENTS. CONTRACTOR SHALL DOCUMENT ALL EXISTING DAMAGE PRORT TO START OF CONSTRUCTION AND NOTIFY CONSTRUCTION MANAGER OF ANY
- 22. PROJECT SAFETY ON-SITE SHALL BE THE SOLE RESPONSIBILITY OF THE CONTRACTOR
- CONTRACTOR IS RESPONSIBLE FOR VERIFYING EXISTING SOIL CONDITIONS, CONSTRUCTION MANAGER MAY HAVE SOILS REPORT FOR MORE INFO.
- 24. CONTRACTOR IS RESPONSIBLE FOR PROVIDING THE OWNER WITH A SET OF MARKED UP PLANS (AS-BUILTS) SHOWING ANY CHANGES DURING CONSTRUCTION.

J		UTILITY LEGEND
	SYMBOL.	DESCRIPTION
	_ · · · · · · · · · ·	EXISTING WATER MAIN
	- -	PROPOSED WATER SERVICE
1		EXISTING ELECTRICAL LINE
ı	· ·	PROPOSEO ELECTRICAL LINE
ı	GAS GAS	EXISTING GAS MAIN
ı		PROPOSED GAS MAIN
ı		EXISTING SANITARY SEWER
ı		PROPOSED SANITARY SEWER
1	— n — n — n	EXISTING STORM SEWER
1	— I7 — I7 — I7 —	PROPOSED STORM SEWER
1		OVERHEAD WIRE\$
ı	<i>₽</i>	EXISTING POWER POLES
l	©	EXISTING LIGHT POLES
l	(S)	SANITARY MANHOLE
J	l Q l	FIRE HYDRANT
7	⋈	EXISTING WATER VALVE
l	H	PROPOSED WATER VALVE
l	0	EXISTING STORM STRUCTURE
l	200	PROPOSED STORM STRUCTURE
	□ ~~•	DENOTES EMERGENCY OVERFLOW ROUTE / DRAINAGE PATH
ı	100.00 100.00	PROPOSED & EXISTING SPOT ELEVATIONS



IN ACCORDANCE WITH WISCONSIN STATUTE 182.0175, DAMAGE TO TRANSMISSION FACULTES, EXCAVATOR SHALL BE SOLELY RESPONSIBLE TO PROVIDE ADVANCE NOTICE TO THE DESIGNATET ONE CALL SYSTEM* NOT LESS THAN THREE WORKING DAYS PRIOR TO COMMENCEMENT OF ANY EXCAVATION REQUIRED TO PERFORM WORK CONTRINED ON THESE DRAWNINGS, AND FURTHER EXCAVATION SHALL COMPLY WITH ALL OTHER REQUIREMENTS OF THIS STATUTE RELATIVE TO EXCAVATOR'S WORK.

HARWOOD ENGINEERING CONSULTANTS, LTD

M&I WATER STREET **PARKING**

MILWAUKEE, WI

MUNICIPAL REVIEW SET DATE: DECEMBER 2, 2011

Scale: [= 40'

SITE PLAN -**OVERALL**


	Date:	Issue Set:	
٦			
٦			
П			
٦			
П			
ate	:		

01/03/2012

Project No.:

011-0034.00 Sheet No.:

C1.00

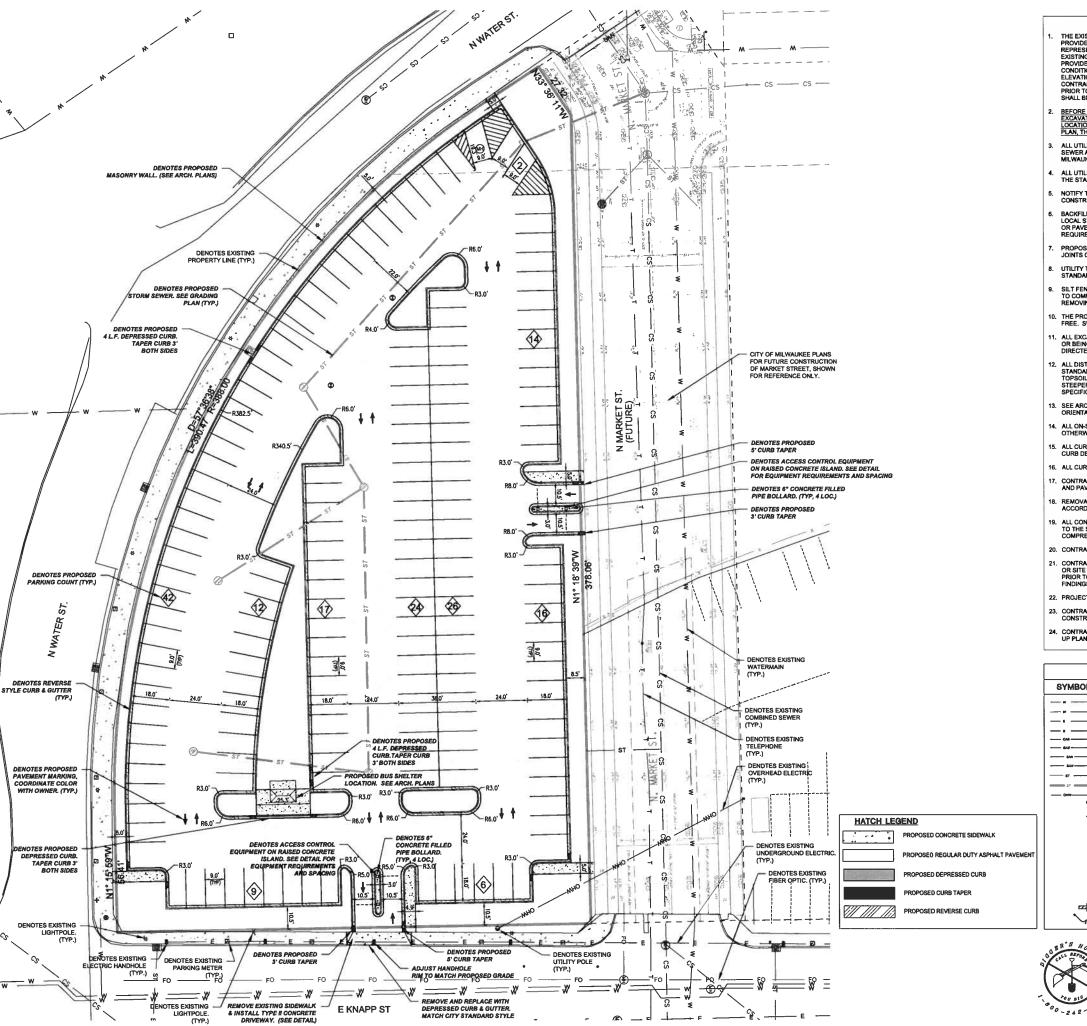



- THE EXISTING SITE INFORMATION ON THIS PLAN WAS TAKEN FROM A SITE SURVEY PROVIDED BY THE SIGMA GROUP. THE ENGINEER MAKES NO WARRANTY OR REPRESENTATION WITH REFERENCE TO THE ACCURACY AND COMPLETENESS OF THE EXISTING CONDITIONS INDICATED OR NOT INDICATED ON THE ENGINEERING PLANS PROVIDED. THE CONTRACTOR SHALL VERIFY THE LOCATION OF ALL EXISTING SITE CONDITIONS INCLUDING UNDERGROUND UTILITYES, UNDERGROUND UTILITY ELEVATIONS, BUILDING SETBACKS AND EXISTING BUILDING LOCATIONS. THE CONTRACTOR SHALL INFORM THE OWNER AND PREVIOURS OF CARMY DISCREPANCIES. CONTRACTOR SHALL INFORM THE OWNER AND ENGINEER OF ANY DISCREPANCIES PRIOR TO COMMENCING WITH PORT, QUESTIONS REGARDING THE EXISTING SURVEY SHALL BE DISCREPED TO THE ARTHES LISTED ABOVE.
- ALL UTILITY CONSTRUCTION SHALL ADHERE TO THE STANDARD SPECIFICATIONS FOR SEVER AND WATER CONSTRUCTION IN WISCOSISIN (2003), AS WELL AS, THE CITY OF MILWAUKER CONSTRUCTION STANDARDS AND THE DEPT. OF COMMERCE SEC. 82-87.
- ALL UTILITY PERMITS MUST BE RECEIVED FROM THE CITY OF MILWAUKEE PRIOR TO THE START OF CONSTRUCTION.
- NOTIFY THE PUBLIC WORKS INSPECTION DEPT. AT LEAST 48 HOURS BEFORE STARTING CONSTRUCTION.
- BACKFILL REQUIREMENTS AND ROADWAY/SIDEWALK RESTORATION SHALL ADHERE TO LOCAL STANDARDS (GRANULAR BACKFILL UNDER OR WITHIN 5' OF CURBS, SIDEWALK, OR PAVEMENT, SPOL MAY BE USED ELSEWHERE. SLURRY BACKFILL WILL BE REQUIRED IN PUBLIC ROADWAYS.)
- PROPOSED STORM SEWER SHALL BE RCP, ASTM C-76, CLASS III WITH RUBBER GASKET JOINTS CONFORMING TO ASTM C-433 (UNLESS OTHERWISE NOTED).
- UTILITY TRENCHES SHALL BE MECHANICALLY COMPACTED IN ACCORDANCE WITH THE STANDARD SPECIFICATIONS FOR SEWER AND WATER CONSTRUCTION IN WISCONSIN.
- SILT FENCE AND ALL OTHER EROSION CONTROL METHODS MUST BE INSTALLED PRIOR TO COMMENCEMENT OF CONSTRUCTION. ALSO, CONTRACTOR IS RESPONSIBLE FOR REMOVING EROSION CONTROL METHODS ONCE THE STE IS STABLIZED.
- 10. THE PROPOSED SITE LOCATION AND SURROUNDING STREETS MUST BE KEPT DEBRIS FREE, SWEEP STREETS AS NEEDED TO MAINTAIN CLEAN STREETS.
- ALL EXCAVATED OR STRIPPED MATERIALS NOT BEING REPLACED IN UTILITY TRENCHES OR BEING USED FOR FILL SHALL BE REMOVED FROM THE SITE, UNLESS OTHERWISE DIRECTED BY THE OWNER.
- ALL DISTURBED GRASS AREAS SHALL BE STABILIZED (PER DNR TECHNICAL STANDARDS) WITHIN 7 DAYS OF COMPLETION. DISTURBED GRASS AREAS SHALL BE TOPSOILED (6*), RESECDED AND STABILIZED. AREAS WITH A SLOPE OF 3H-IV OR STEEPER SHALL BE COVERED WITH A CLASS 1 TYPE A EROSION FABRIC. (SEE SPECIFICATIONS)
- SEE ARCHITECTURAL PLANS FOR EXACT BUILDING & FOUNDATION DETAILS AND ORIENTATION.
- 14. ALL ON-SITE CONCRETE CURB AND GUTTER TO BE 18" WIDE VERTICAL FACE, UNLESS OTHERWISE NOTED. REVERSE OR REGULAR STYLE CURB DENOTED ON PLANS.
- ALL CURB ELEVATIONS ARE EDGE OF PAVEMENT UNLESS OTHERWISE NOTED. SEE CURB DETAIL FOR TOP OF CURB ELEVATIONS.
- 16. ALL CURB RADII ARE MEASURED TO THE FACE OF CURB UNLESS OTHERWISE NOTED,
- REMOVAL OF CURB AND GUTTER, SIDEWALK AND PAVEMENT SHALL BE IN ACCORDANCE WITH THE STANDARD SPECIFICATIONS OF THE WISCONSIN D.O.T.
- ALL CONCRETE FOR CURB AND GUTTER, ROADWAY AND SIDEWALKS MUST CONFORM TO THE STANDARD SPECIFICATIONS FOR READY MIXED CONCRETE. MINIMUM 28 DAY COMPRESSIVE STRENGTH TEST MUST EQUAL 4000 PSI.
- 20. CONTRACTOR IS RESPONSIBLE FOR PROTECTING ALL PROPERTY CORNERS
- 21. CONTRACTOR IS RESPONSIBLE FOR REPAIRING ANY DAMAGE TO EXISTING UTILITIES OR SITE IMPROVEMENTS. CONTRACTOR SHALL DOCUMENT ALL EXISTING DAMAGE PRIDE TO START OF CONSTRUCTION AND NOTIFY CONSTRUCTION MANAGER OF ANY
- 22. PROJECT SAFETY ON-SITE SHALL BE THE SOLE RESPONSIBILITY OF THE CONTRACTOR.
- CONTRACTOR IS RESPONSIBLE FOR VERIFYING EXISTING SOIL CONDITIONS, CONSTRUCTION MANAGER MAY HAVE SOILS REPORT FOR MORE INFO.
- 24. CONTRACTOR IS RESPONSIBLE FOR PROVIDING THE OWNER WITH A SET OF MARKED UP PLANS (AS-BUILTS) SHOWING ANY CHANGES DURING CONSTRUCTION.

	UT	ILITY LEGEND
SYMBOL	D	ESCRIPTION
	w E	XISTING WATER MAIN
w w	* P	ROPOSED WATER SERVICE
-··	— E	XISTING ELECTRICAL LINE
-·	—•- P	ROPOSED ELECTRICAL LINE
cu cu	w E	XISTING GAS MAIN
	e4s P	ROPOSED GAS MAIN
544 544	— » E	XISTING SANITARY SEWER
	— м— Р	ROPOSED SANITARY SEWER
sr sr	— п — E	XISTING STORM SEWER
37 - 37	— : : — P	ROPOSED STORM SEWER
OHV DH	0*** C	VERHEAD WIRES
6 ا	, E	XISTING POWER POLES
🔅	- Е	XISTING LIGHT POLES
(S) s	ANITARY MANHOLE
	, F	IRE HYDRANT
 	l E	XISTING WATER VALVE
₩	Р	ROPOSED WATER VALVE
0	· E	XISTING STORM STRUCTURE
22	00 P	ROPOSED STORM STRUCTURE
		ENOTES EMERGENCY OVERFLOW ROUTE / DRAINAGE ATH
100.0	0 100.00 P	ROPOSED & EXISTING SPOT ELEVATIONS



IN ACCORDANCE WITH WISCONSIN STATUTE 182 0175, DAMAGE TO TRANSMISSION FACULTIES, EXCAVATOR SHALL BE SOLELY RESPONSIBLE TO PROVING ADVANCE NOTICE TO THE DESIGNATED TOME CALL SYSTEM' NOT LESS THAN THREE WORKING DAYS PRIOR TO COMMENCEMENT OF ANY EXCAVATION REQUIRED TO PERFORM WORK CONTAINED ON THESE CRAWMICS, AND FURTHER, EXCAVATOR SHALL COMPLY WITH ALL OTHER REQUIREMENTS OF THIS STATUTE RELATIVE TO EXCAVATOR'S WORK.

HARWOOD ENGINEERING CONSULTANTS, LTD 14.475.5554 414.475.5698 lax harwoods HEC Project Number: 11-0034.00

M&I WATER STREET PARKING


MILWAUKEE, WI

MUNICIPAL REVIEW SET DATE: DECEMBER 2, 2011

SITE PLAN -**DETAILED**

D:	de:	Issue Set:		
\perp				
-				
+				
-				
+				
Date:				
01/03	$\frac{1}{20}$	12		
			1	
Project N	lo.:			
011_0	no.	100		

Sheet No.: C1.01

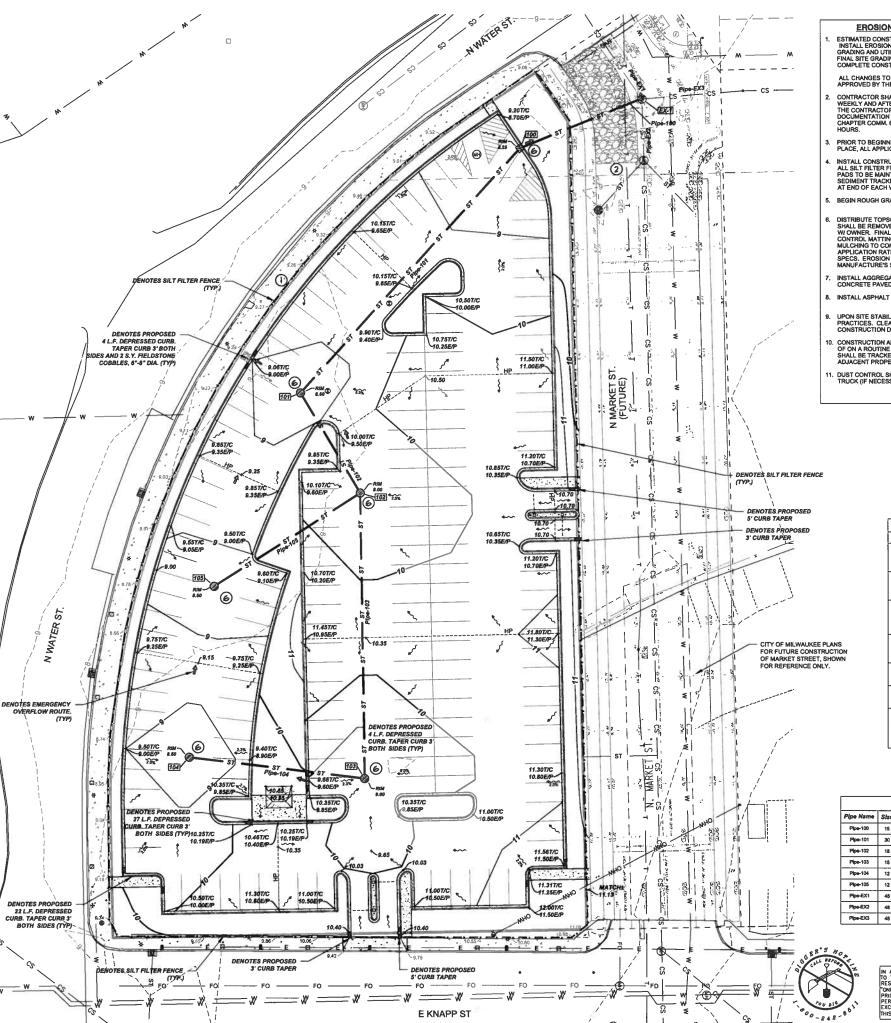

EROSION CONTROL NOTES AND PHASING

ESTIMATED CONSTRUCTION TIMEFRAMES: INSTALL EROSION CONTROL = MAY 2012 GRADING AND UTILITY INSTALLATION = MAY 2012 FINAL SITE GRADING AND RESTORATION = AUGUST 2012 COMPLETE CONSTRUCTION = SEPTEMBER 2012

ALL CHANGES TO THE ABOVE SCHEDULE SHALL BE REVIEWED AND APPROVED BY THE MUNICIPALITY.

- CONTRACTOR SHALL INSPECT ALL EROSION CONTROL PRACTICES WEEKLY AND AFTER ANY RAINFALL EVENT OF 0.5 INCHES OR GREATER. THE CONTRACTOR SHALL PERFORM ALL INSPECTIONS AND DOCUMENTATION PER MISCONSIN DEPARTMENT OF COMMENDED OF THE COMM. 60. ALL REQUIRED REPAIRS SHALL BE MADE WITHIN 24 CHAPTER COMM. 60.
- PRIOR TO BEGINNING CONSTRUCTION, THE CONTRACTOR WILL HAVE IN PLACE, ALL APPLICABLE PLAN APPROVALS AND PERMITS.
- INSTALL CONSTRUCTION ENTRANCES, SEDIMENT TRACKING PADS, AND ALL SILT FILTER FENCING, AS INDICATED ON PLANS. SEDIMENT TRACKING PADS TO BE MAINTAINED THROUGHOUT CONSTRUCTION PROJECT. SEDIMENT TRACKED ONTO STREETS SHALL BE REMOVED (BY SWEEPING) AT END OF EACH WORK DAY.
- BEGIN ROUGH GRADING SITE, AND INSTALLING STORM SEWER UTILITIES
- DISTRIBUTE TOPSOIL TO A DEPTH OF 6 INCHES, SURPLUS TOPSOIL SHALL BE REMOVED FROM THE SITE BY THE CONTRACTOR, COORDINATE WICHOWNER, FINAL GRADE, SEED AND MULCH SITE. PLACE EROSION CONTROL MATTING WHERE INDICATED ON PLANS, (SEEDING AND MULCHING TO CONFORM WITH APPROVED SEED MIXTURES AND APPLICATION RATES, SEE LANDSCAPE PLAN FOR FINAL SEED AND SOD SPECS. EROSION CONTROL MATTING TO BE INSTALLED PER MANUFACTURE'S SPECIFICATIONS.)
- INSTALL AGGREGATE BASE COURSE IN AREAS TO BE ASPHALT AND/OR CONCRETE PAVED
- INSTALL ASPHALT AND CONCRETE SECTIONS.
- UPON SITE STABILIZATION, REMOVE TEMPORARY EROSION CONTROL PRACTICES. CLEAN STRUCTURES OF ANY SEDIMENT AND/OR CONSTRUCTION DEBRIS.
- . CONSTRUCTION AND WASTE MATERIALS SHALL BE PROPERLY DISPOSED OF ON A ROUTINE BASIS. NO CONSTRUCTION OR WASTE MATERIALS SHALL BE TRACKED, BLOWN OR OTHERWISE LOCATED OR STORED ON ADJACENT PROPERTIES.
- DUST CONTROL SHALL BE MAINTAINED ONSITE WITH USE OF A WATER TRUCK (IF NECESSARY).

Storm Structure Tabla	
#	Structure Details
	TRAPPED CATCH BASIN - CURB
	RIM = 8,25
100	Pipe-100 = 2.32
	Pipe-101 = 2.32
	4' CATCH BASIN
101	RIM = 8.50
101	Pipe-101 = 2.63
	Pipe-102 = 3.63
	4' CATCH BASIN
	RIM = 9.00
102	Pipe-102 = 3.85
	Pipe-103 = 4.10
	Pipe-105 = 4.35
	4' CATCH BASIN
103	RIM = 9.00
103	Pipe-103 = 4,77
	Pipe-104 = 5.02
	3" CATCH BASIN
104	RIM = 8.50
	Pipe-104 = 5.43
	3' CATCH BASIN
105	RIM = 8.50
	Pipe-105 = 5.18
	EXISTING MANHOLE
	RIM = 4.93
EX-1	Pipe-EX1 = -0.90
241	Pipe-100 = 1.48
	Pipe-EX3 = -0.94
	Pipe-EX2 = -0.17

Storm Pipe Table						
Pipe Name	Size	Material	Length	Slope	Notes	
Plpe-100	15	RCP	61	1.40%	OUTLET CONTROL PIPE	
Pipe-101	30	RCP	154	0.20%		
Pipe-102	18	RCP	54	0.40%		
Plpe-103	15	RCP	133	0.50%		
Plps-104	12	RCP	82	0.50%		
Pipe-105	12	RCP	81	1.00%		
Plpe-EX1	48	RCP	91	1.25%	EXIST. COMBINED SEWE	
Plpe-EX2	48	RCP	29	0.64%	EXIST. COMBINED SEWE	
Pipe-EX3	48	RCP	47	0.64%	EXIST. COMBINED SEWER	

GENERAL NOTES AND SPECIFICATIONS

- THE EXISTING SITE INFORMATION ON THIS PLAN WAS TAKEN FROM A SITE SURVEY PROVIDED BY THE SIGMA GROUP. THE ENGINEER MAKES NO WARRANTY OR REPRESENTATION WITH REFERENCE TO THE ACCUPACY AND COMPLETENESS OF THE EXISTING CONDITIONS INDICATED OR NOT INDICATED ON THE ENGINEERING PLANS PROVIDED. THE CONTRACTOR SHALL VERIFY THE LOCATION OF ALL EXISTING SITE CONDITIONS INCLIDING UNDERGROUND UTILITY ELEVATIONS, BUILDING SETBACKS AND EXISTING BUILDING LOCATIONS. THE CONTRACTOR SHALL INFORM THE OWNER AND ENGINEER OF ANY DISCREPANCIES PRIOR TO COMMENCING WITH WORK. QUESTIONS REGARDING THE EXISTING SURVEY SHALL BE DIRECTED TO THE PARTIES LISTED ABOVE. SHALL BE DIRECTED TO THE PARTIES LISTED ABOVE.
- BEFORE PROCEEDING WITH ANY UTILITY CONSTRUCTION, CONTRACTOR SHALL EXCAVATE EACH EXISTING LATERAL TO BE CONNECTED TO VERIFYING ELEVATION, LOCATION AND SIZE). SHOULD THE EXISTING UTILITY NOT BE AS INDICATED ON THE PLAN, THE ENGINEER SHALL BE NOTIFIED IMMEDIATELY FOR EVALUATION.
- ALL UTILITY CONSTRUCTION SHALL ADHERE TO THE STANDARD SPECIFICATIONS FOR SEWER AND WATER CONSTRUCTION IN VISCONSIN (2003), AS WELL AS, THE CITY OF MILWAUKEE CONSTRUCTION STANDARDS AND THE DEPT. OF COMMERCE SEC. 82-87.
- ALL UTILITY PERMITS MUST BE RECEIVED FROM THE CITY OF MILWAUKEE PRIOR TO THE START OF CONSTRUCTION.
- NOTIFY THE PUBLIC WORKS INSPECTION DEPT. AT LEAST 48 HOURS BEFORE STARTING CONSTRUCTION.
- BACKFILL REQUIREMENTS AND ROADWAY/SIDEWALK RESTORATION SHALL ADHERE TO LOCAL STANDARDS (GRANULAR BACKFILL UNDER OR WITHIN 5' OF CURBS, SIDEWALK, OR PAVEMENT. SPOIL MAY BE USED ELSEWHERE. SLURRY BACKFILL WILL BE REQUIRED IN PUBLIC ROADWAYS.)
- PROPOSED STORM SEWER SHALL BE RCP, ASTM C-76, CLASS III WITH RUBBER GASKET JOINTS CONFORMING TO ASTM C-433 (UNLESS OTHERWISE NOTED).
- UTILITY TRENCHES SHALL BE MECHANICALLY COMPACTED IN ACCORDANCE WITH THE STANDARD SPECIFICATIONS FOR SEWER AND WATER CONSTRUCTION IN WISCONSIN.
- SLT FENCE AND ALL OTHER EROSION CONTROL METHODS MUST BE INSTALLED PRIOR TO COMMENCEMENT OF CONSTRUCTION. ALSO, CONTRACTOR IS RESPONSIBLE FOR REMOVING EROSION CONTROL METHODS ONCE THE SITE IS STABILIZED.
- . THE PROPOSED SITE LOCATION AND SURROUNDING STREETS MUST BE KEPT DEBRIS FREE. SWEEP STREETS AS NEEDED TO MAINTAIN CLEAN STREETS.
- ALL EXCAVATED OR STRIPPED MATERIALS NOT BEING REPLACED IN UTILITY TRENCHES OR BEING USED FOR FILL SHALL BE REMOVED FROM THE SITE, UNLESS OTHERWISE DIRECTED BY THE OWNER.
- 12. ALL DISTURBED GRASS AREAS SHALL BE STABILIZED (PER DNR TECHNICAL STANDARDS) WITHIN 7 DAYS OF COMPLETION. DISTURBED GRASS AREAS SHALL BE TOPSOILED (67). RESEEDED AND STABILIZED. AREAS WITH A SLOPE OF 3H:1V OR STEEPER SHALL BE COVERED WITH A CLASS 1 TYPE A EROSION FABRIC. (SEE
- SEE ARCHITECTURAL PLANS FOR EXACT BUILDING & FOUNDATION DETAILS AND ORIENTATION.
- ALL ON-SITE CONCRETE CURB AND GUTTER TO BE 18" WIDE VERTICAL FACE, UNLESS OTHERWISE NOTED. REVERSE OR REGULAR STYLE CURB DENOTED ON PLANS.
- 15. ALL CURB ELEVATIONS ARE EDGE OF PAVEMENT UNLESS OTHERWISE NOTED. SEE CURB DETAIL FOR TOP OF CURB ELEVATIONS.
- 18. ALL CURB RADII ARE MEASURED TO THE FACE OF CURB UNLESS OTHERWISE NOTED.
- CONTRACTOR SHALL MATCH PROPOSED CONCRETE CURB AND GUTTER, SIDEWALK AND PAVEMENT TO EXISTING IN ELEVATION AND ALIGNMENT.
- 3. REMOVAL OF CURB AND GUTTER, SIDEWALK AND PAVEMENT SHALL BE IN ACCORDANCE WITH THE STANDARD SPECIFICATIONS OF THE WISCONSIN D.O.T.
- ALL CONCRETE FOR CURB AND GUTTER, ROADWAY AND SIDEWALKS MUST CONFORM TO THE STANDARD SPECIFICATIONS FOR READY MIXED CONCRETE. MINIMUM 28 DAY COMPRESSIVE STRENGTH TEST MUST EQUAL 4000 PSI.
-). CONTRACTOR IS RESPONSIBLE FOR PROTECTING ALL PROPERTY CORNERS.
- CONTRACTOR IS RESPONSIBLE FOR REPAIRING ANY DAMAGE TO EXISTING UTILITIES
 OR SITE IMPROVEMENTS. CONTRACTOR SHALL DOCUMENT ALL EXISTING DAMAGE
 PRIOR TO START OF CONSTRUCTION AND NOTIFY CONSTRUCTION MANAGER OF ANY
 FINDINGS.
- 22. PROJECT SAFETY ON-SITE SHALL BE THE SOLE RESPONSIBILITY OF THE CONTRACTOR.
- CONTRACTOR IS RESPONSIBLE FOR VERIFYING EXISTING SOIL CONDITIONS, CONSTRUCTION MANAGER MAY HAVE SOILS REPORT FOR MORE INFO.
- CONTRACTOR IS RESPONSIBLE FOR PROVIDING THE OWNER WITH A SET OF MARKED UP PLANS (AS-BUILTS) SHOWING ANY CHANGES DURING CONSTRUCTION.

UTILITY LEGEND		
SYMBOL	DESCRIPTION	
_ * _ * _ * _ * _	EXISTING WATER MAIN	
www	PROPOSED WATER SERVICE	
<u></u>	EXISTING ELECTRICAL LINE	
_,,,	PROPOSEO ELECTRICAL LINE	
	EXISTING GAS MAIN	
— eu eu	PROPOSED GAS MAIN	
SAN SAN	EXISTING SANITARY SEWER	
EAR EAR	PROPOSED SANITARY SEWER	
— sī — sī — sī —	EXISTING STORM SEWER	
27 days 27 days 27	PROPOSED STORM SEWER	
0m 0m 0m	OVERHEAD WIRES	
ė	EXISTING POWER POLES	
₩	EXISTING LIGHT POLES	
S	SANITARY MANHOLE	
Д	FIRE HYDRANT	
\bowtie	EXISTING WATER VALVE	
H	PROPOSED WATER VALVE	
0	EXISTING STORM STRUCTURE	
Ø 0	PROPOSED STORM STRUCTURE	
~~~	DENOTES EMERGENCY OVERFLOW ROUTE / DRAINAGE PATH	
100.00 100.00	PROPOSED & EXISTING SPOT ELEVATIONS	

EROSION CONTROL	LEGEND
SILT FILTER FENCE	4 DITCH CHECK
2 CONSTRUCTION ENTRANCE	STABILIZED TOPSOIL PILE
(3) EROSION MAT FEGERS	(A) BHI ET SECONAENT CHARD

HARWOOD ENGINEERING CONSULTANTS, LTD

**M&I WATER STREET** PARKING

Location: MILWAUKEE, WI

MUNICIPAL REVIEW SET DATE: DECEMBER 2, 2011

Scale: 1"=20"


**GRADING & EROSION CONTROL PLAN** 

Date:	Issue Set:	
	·	

011-0034.00 Sheet No.:

Project No.:

C1.02

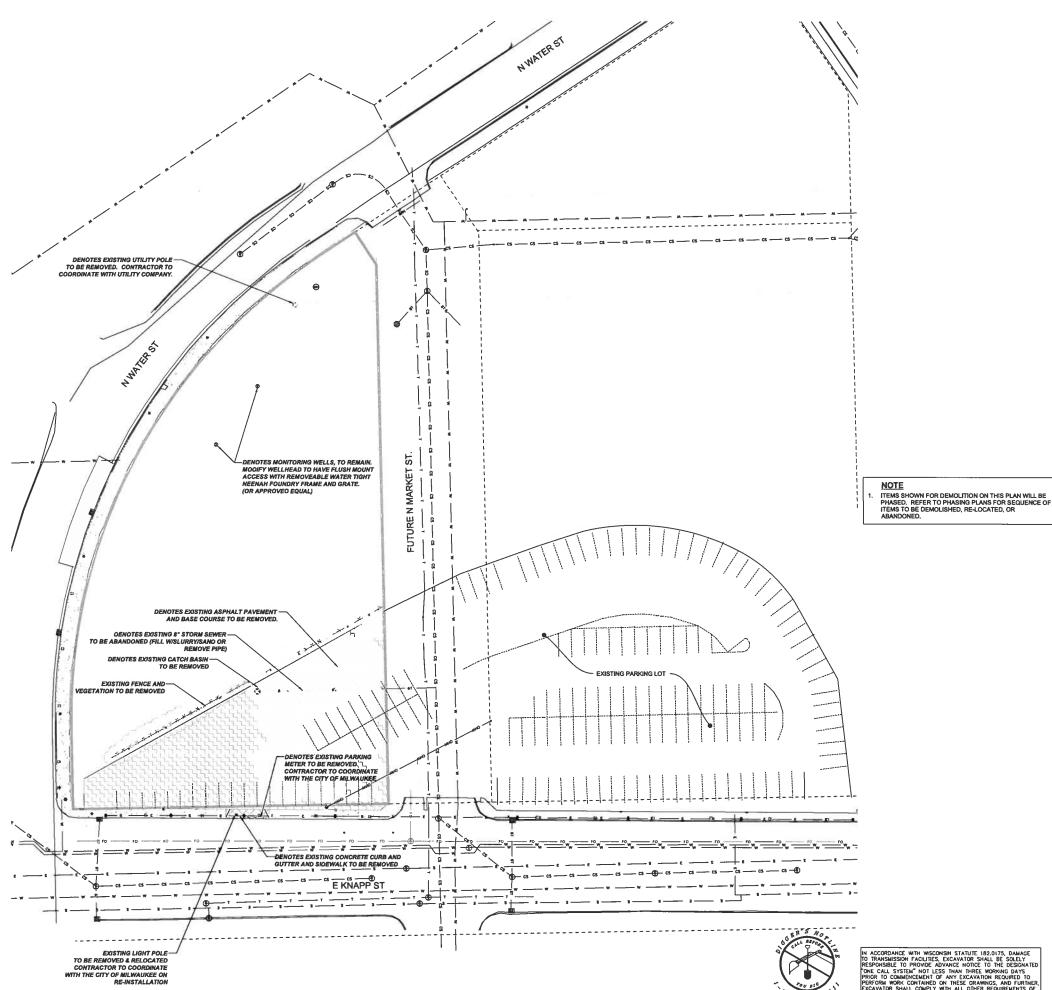

ACCORDANCE WITH WISCONSIN STATUTE 182.0175, DAMAGE TRANSMISSION FACULTIES, EXCAVATOR SHALL BE SOLELY SEPONSIBLE TO PROVIDE ADVANCE NOTICE TO THE DESIGNATED INC. CALL SYSTEM" NOT LESS THAN THREE WORKNO. DAYS RIGHT OF COMMENCEMENT OF ANY EXCAVATION REQUIRED TO REFORM WORK CONTAINED ON THESE GRAMMICS, AND FURTHER, KCAVATOR SHALL COMPLY WITH ALL OTHER REQUIREMENTS OF HIS STATUTE RELATIVE TO EXCAVATOR'S WORK.

#### **GENERAL NOTES AND SPECIFICATIONS**

- THE EXISTING SITE INFORMATION ON THIS PLAN WAS TAKEN FROM A SITE SURVEY PROVIDED BY THE SIGMA GROUP. THE ENGINEER MAKES NO WARRANTY OR REPRESENTATION WITH REFERENCE TO THE ACCURACY AND COMPLETENESS OF THE EXISTING CONDITIONS INDICATED OR NOT INDICATED ON THE ENGINEERING PLANS PROVIDED. THE CONTRACTOR SHALL VERTY THE LOCATION OF ALL EXISTING SITE CONDITIONS INCLUDING UNDERGROUND UTILITIES, UNDERGROUND UTILITY ELEVATIONS, BUILDING SETBACKS AND EXISTING BUILDING LOCATIONS. THE CONTRACTOR SHALL INFORM THE OWNER AND ENGINEER OF ANY DISCREPANCIES PRIOR TO COMMENCING WITH WORK. QUESTIONS REGARDING THE EXISTING SURVEY SHALL BE DIRECTED TO THE PARTIES LISTED ABOVE. SHALL BE DIRECTED TO THE PARTIES LISTED ABOVE.
- BEFORE PROCEEDING WITH ANY UTILITY CONSTRUCTION, CONTRACTOR SHALL EXCAVATE EACH EXISTING LATERAL TO BE CONNECTED TO VERIFYING ELEVATION, LOCATION AND SIZE). SHOULD THE EXISTING UTILITY NOT BE AS INDICATED ON THE PLAN, THE ENGINEER SHALL BE NOTIFIED IMMEDIATELY FOR EVALUATION.
- ALL UTILITY CONSTRUCTION SHALL ADHERE TO THE STANDARD SPECIFICATIONS FOR SEWER AND WATER CONSTRUCTION IN WISCONSIN (2003), AS WELL AS, THE CITY OF MILWAUKEE CONSTRUCTION STANDARDS AND THE DEPT. OF COMMERCE SEC. 82-87.
- ALL UTILITY PERMITS MUST BE RECEIVED FROM THE CITY OF MILWAUKEE PRIOR TO THE START OF CONSTRUCTION.
- NOTIFY THE PUBLIC WORKS INSPECTION DEPT. AT LEAST 48 HOURS BEFORE STARTING CONSTRUCTION.
- BACKFILL REQUIREMENTS AND ROADWAY/SIDEWALK RESTORATION SHALL ADHERE TO LOCAL STANDARDS (GRANULAR BACKFILL UNDER OR WITHIN 5' OF CURBS, SIDEWALK, OR PAVEMENT. SPOIL MAY BE USED ELSEWHERE. SLURRY BACKFILL WILL BE REQUIRED IN PUBLIC ROADWAYS.)
- PROPOSED STORM SEWER SHALL BE RCP, ASTM C-76, CLASS III WITH RUBBER GASKET JOINTS CONFORMING TO ASTM C-433 (UNLESS OTHERWISE NOTED),
- UTILITY TRENCHES SHALL BE MECHANICALLY COMPACTED IN ACCORDANCE WITH THE STANDARD SPECIFICATIONS FOR SEWER AND WATER CONSTRUCTION IN WISCONSIN.
- SILT FENCE AND ALL OTHER EROSION CONTROL METHODS MUST BE INSTALLED PRIOR TO COMMENCEMENT OF CONSTRUCTION. ALSO, CONTRACTOR IS RESPONSIBLE FOR REMOVING EROSION CONTROL METHODS ONCE THE SITE IS STABILIZED,
- 10. THE PROPOSED SITE LOCATION AND SURROUNDING STREETS MUST BE KEPT DEBRIS FREE. SWEEP STREETS AS NEEDED TO MAINTAIN CLEAN STREETS.
- ALL EXCAVATED OR STRIPPED MATERIALS NOT BEING REPLACED IN UTILITY TRENCHES OR BEING USED FOR FILL SHALL BE REMOVED FROM THE SITE, UNLESS OTHERWISE DIRECTED BY THE OWNER.
- 12. ALL DISTURBED GRASS AREAS SHALL BE STABILIZED (PER DNR TECHNICAL STANDARDS) WITHIN 7 DAYS OF COMPLETION. DISTURBED GRASS AREAS SHALL BE TOPSOILED (6°), RESEEDED AND STABILIZED. AREAS WITH A SLOPE OF 3H:14 OR STEEPER SHALL BE COVERED WITH A CLASS 1 TYPE A EROSION FABRIC. (SEE SPECIFICATIONS)
- SEE ARCHITECTURAL PLANS FOR EXACT BUILDING & FOUNDATION DETAILS AND ORIENTATION.
- 14. ALL ON-SITE CONCRETE CURB AND GUTTER TO BE 18" WIDE VERTICAL FACE, UNLESS OTHERWISE NOTED. REVERSE OR REGULAR STYLE CURB DENOTED ON PLANS.
- ALL CURB ELEVATIONS ARE EDGE OF PAVEMENT UNLESS OTHERWISE NOTED. SEE CURB DETAIL FOR TOP OF CURB ELEVATIONS.
- 16. ALL CURB RADII ARE MEASURED TO THE FACE OF CURB UNLESS OTHERWISE NOTED.
- . CONTRACTOR SHALL MATCH PROPOSED CONCRETE CURB AND GUTTER, SIDEWALK AND PAVEMENT TO EXISTING IN ELEVATION AND ALIGNMENT.
- REMOVAL OF CURB AND GUTTER, SIDEWALK AND PAVEMENT SHALL BE IN ACCORDANCE WITH THE STANDARD SPECIFICATIONS OF THE WISCONSIN D.O.T.
- ALL CONCRETE FOR CURB AND GUTTER, ROADWAY AND SIDEWALKS MUST CONFORM TO THE STANDARD SPECIFICATIONS FOR READY MIXED CONCRETE. MINIMUM 28 DAY COMPRESSIVE STRENGTH TEST MUST EQUAL 4000 PSI.
- 20. CONTRACTOR IS RESPONSIBLE FOR PROTECTING ALL PROPERTY CORNERS
- 21. CONTRACTOR IS RESPONSIBLE FOR REPAIRING ANY DAMAGE TO EXISTING UTILITIES OR SITE IMPROVEMENTS. CONTRACTOR SHALL DOCUMENT ALL ESTING DAMAGE PRIDE, TO START OF CONSTRUCTION AND NOTIFY CONSTRUCTION MANAGER OF ANY
- 22. PROJECT SAFETY ON-SITE SHALL BE THE SOLE RESPONSIBILITY OF THE CONTRACTOR.
- CONTRACTOR IS RESPONSIBLE FOR VERIFYING EXISTING SOIL CONDITIONS, CONSTRUCTION MANAGER MAY HAVE SOILS REPORT FOR MORE INFO.
- 24. CONTRACTOR IS RESPONSIBLE FOR PROVIDING THE OWNER WITH A SET OF MARKED UP PLANS (AS-BUILTS) SHOWING ANY CHANGES DURING CONSTRUCTION.

UTILITY LEGEND				
SYMBOL	DESCRIPTION			
w w	EXISTING WATER MAIN			
ww	PROPOSED WATER SERVICE			
	EXISTING ELECTRICAL LINE			
<u> </u>	PROPOSED ELECTRICAL LINE			
GAS GAS	EXISTING GAS MAIN			
	PROPOSED GAS MAIN			
— M — M — M –	EXISTING SANITARY SEWER			
EAH EAH	PROPOSED SANITARY SEWER			
— e7 —— e7 —	EXISTING STORM SEWER			
	PROPOSED STORM SEWER			
OHW OHW	OVERHEAD WIRES			
6	EXISTING POWER POLES			
Ð	EXISTING LIGHT POLES			
S	SANITARY MANHOLE			
Д	FIRE HYDRANT			
$\bowtie$	EXISTING WATER VALVE			
H	PROPOSED WATER VALVE			
<b>©</b>	EXISTING STORM STRUCTURE			
<b>2</b> 00	PROPOSED STORM STRUCTURE			
₩ ~~	DENOTES EMERGENCY OVERFLOW ROUTE / DRAINA PATH			
100.00	PROPOSED & EXISTING SPOT ELEVATIONS			

## DEMOLITION LEGEND

DENOTES PAVEMENT REMOVAL AREA

DENOTES CONCRETE SIDEWALK REMOVAL AREA

DENOTES ITEM TO BE ABANDONED OR REMOVED

HARWOOD ENGINEERING CONSULTANTS, LTD

**M&I WATER STREET PARKING** 

MILWAUKEE, WI

MUNICIPAL REVIEW SET DATE: DECEMBER 2, 2011


Scale: 1"=30"

SITE DEMOLITION PLAN

Date:	Issue Set:	
1		
:		
/03/20	)12	

Sheet No.: C1.03

011-0034.00

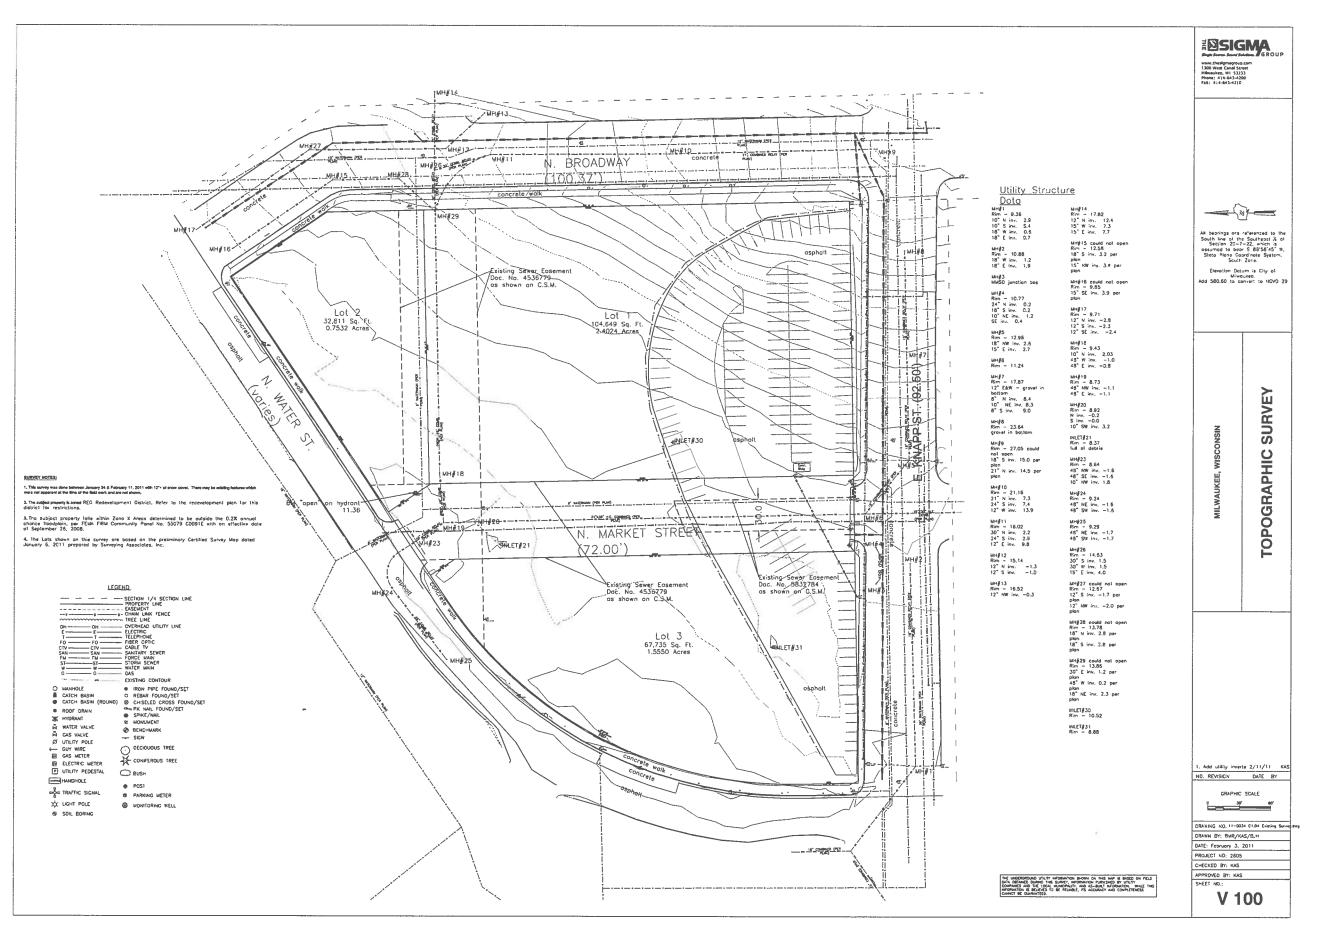

NOTE: SURVEY COMPLETED BY THE SIGMA GROUP. THE REFERENCE TO THE ACCURACY AND COMPLETENESS OF THE EXISTING CONDITIONS INDICATED OR NOT INDICATED ON THE ENGINEERING PLANS PROVIDED.

HARWOOD ENGINEERING CONSULTANTS, LTD 7420 West Stoto Street M&woukee Wisco 414.475.5554 418.475.5648 fox horwood HEC Project Number: 11-0034.00

Project: M&I WATER STREET **PARKING** 

MILWAUKEE, WI

MUNICIPAL REVIEW SET DATE: DECEMBER 2, 2011


Scale: 1 = 40

**EXISTING SITE SURVEY** 

01/03/2012

Project No.: 011-0034.00 Sheet No.:

C1.04

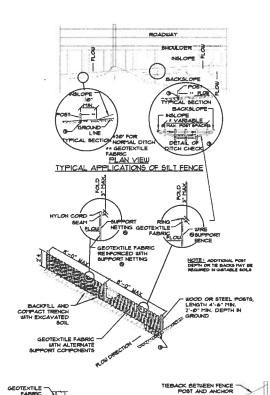

TRENCH DETAIL

- S EXCAVATE A TRENCH A HINNEH OF 4" WIDE AND 6" DEEP TO BURY AND ANCHOR THE GEOTEXTILE FABRIC, FOLD HATERIAL TO FIT TRENCH AND BACKFILL AND COMPACT TRENCH WITH EXCAVATED BOIL.

8ILT FENCE DETAIL



SILT -

ANCHOR STAKE MIN. 18" LONG

SILT FENCE TIE BACK


REGUIRED.


© STEEL POSTS SHALL BE STUDDED THE OR 'U TYPE'


WITH A HINRUM LEIGHT OF 1.25 B-716. N. (LITHOUT
ANCHOR). FH ANCHORS SUFFICIENT TO RESIST POST
MOVEMENT ARE REGUIRED. LUCOD POSTS SHALL BE A
HINRUM SIZE OF A" DIA, OR 1-1/2" x 3-1/2" ENCEPT
UCOD POSTS FOR GEOTEXTILE FABRIC RENORCED
WITH NETTING SHALL BE A HINITUM SIZE OF 1-1/8" x
1-1/8" OAK OR HICKORY.


ALTERNATIVES A AND B ARE EGUAL AND EITHER MAY
BE USED.


MALE! SPECIFICATIONS AS PER THE PLAN SHEWARK STRAIN AND MOTE 10 MATCH

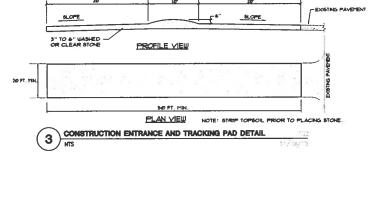

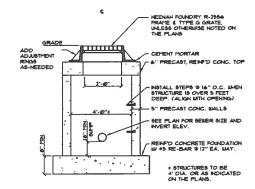


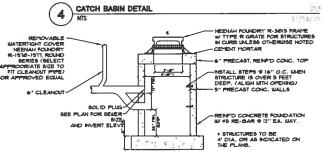

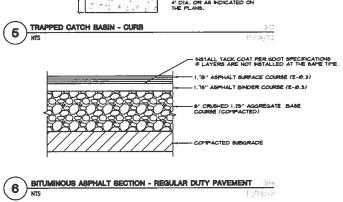

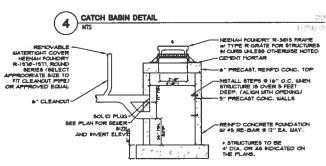



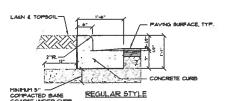



NOTE:

RESERVE STYLE CURB LOCATIONS ARE NOTED ON THE PLANS.

CONTRACTOR TO USE CITY OF MILIUALIKEE CURB DETAILS FOR AREAS IN THE PUBLIC ROLOGUE.

7 18° VERTICAL FACE CURB

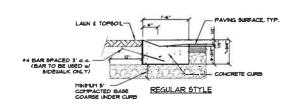

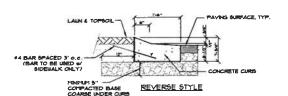

NOTE:

REVERSE STYLE CURB LOCATIONS ARE NOTED ON THE PLANS.

CONTRACTOR TO USE CITY OF HILIMANCE CURB DETAILS FOR AREAS IN THE PUBLIC ROLADIAN.

8 18" DEPRESSED CURB	509
NIS	50/19200
CONTROL JONT - 2" DEEP W 1/4" RADIUS BOGE TYP. CONTRETE PAVING UITH MEDIAN BROOM PNISH PEDIAN BROOM PNISH  COMPACTED 4" ASGREGATE COMPACTED SUBGRADE  * NOTE  * NOTE - SIDEWALK SHALL BE 1" AT DRIVEWAY SECTION COMPACTOR TO USE CITY OF HILWAKEE SIDEWALK DETAIL IN PUBLIC R.O.	NOTES:  CONTROL JOINT SPACING SHALL BE A HANKELT OF 5' AND CONSTRUCE ON CONFORTANCE HISTITUTE (ACL) RECONTROLATION (ACL)  EXPANSION JOINTS SHOULD BE PROVIDED UNERS PAYETENT ABUTS PORD OBJECTS.
CONCRETE SIDEWALK SECTION	524
9 MIS	11/15/16

HARWOOD ENGINEERING CONSULTANTS, LTD

**M&I WATER STREET PARKING** 

Localton: MILWAUKEE, WI

MUNICIPAL REVIEW SET DATE: DECEMBER 2, 2011


Scale:	
Sheet:	
CONSTRUCTION	
DETAILS	

-	Date:	Issue Set	 
1			
1			 
1			
4			
4			 
4			 
1			
4			
4			 
1			 
_			 
le:			
4 /	03/20	142	
"	03/20	112	
nie	ct No.:		
114	01 110		


C5.01

Sheet No.:


011-0034.00

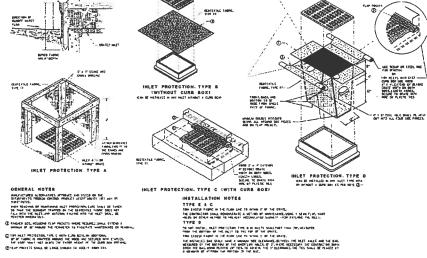

2 INLET PROTECTION NTS

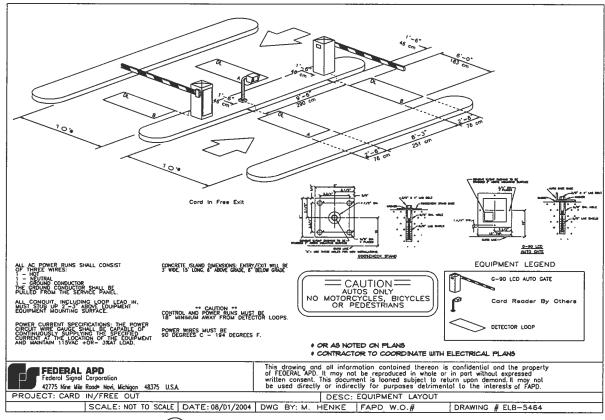

10 ACCESS GATE DETAIL

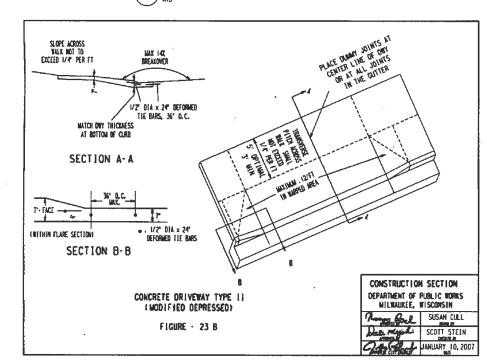

9 CONCRETE DRIVEWAY TYPE (I

ARCHITECTURAL STUDIOS, INC.

HARWOOD
ENGINEERING
CONSULTANTS, LTD
7420 Weal Stole Sineal Medicake Wiscomin 53213
414.073.5354 414.073.549f for browcoffised com

M&I WATER STREET PARKING

Location: MILWAUKEE, WI

MUNICIPAL REVIEW SET (NOT FOR CONSTRUCTION)

DATE: DECEMBER 2, 2011


Scale

Sheet: CONSTRUCTION DETAILS


$\equiv$	Date:	Issue Set		
$\rightarrow$			 	
$\rightarrow$				
+				
-			 	
-			 	
$\Box$				
Date:				
01/0	03/20	112		
0 170	JUI 20	112		
Projec	t No.:			
U11	-003	4.00		


C5.02

Sheet No.:

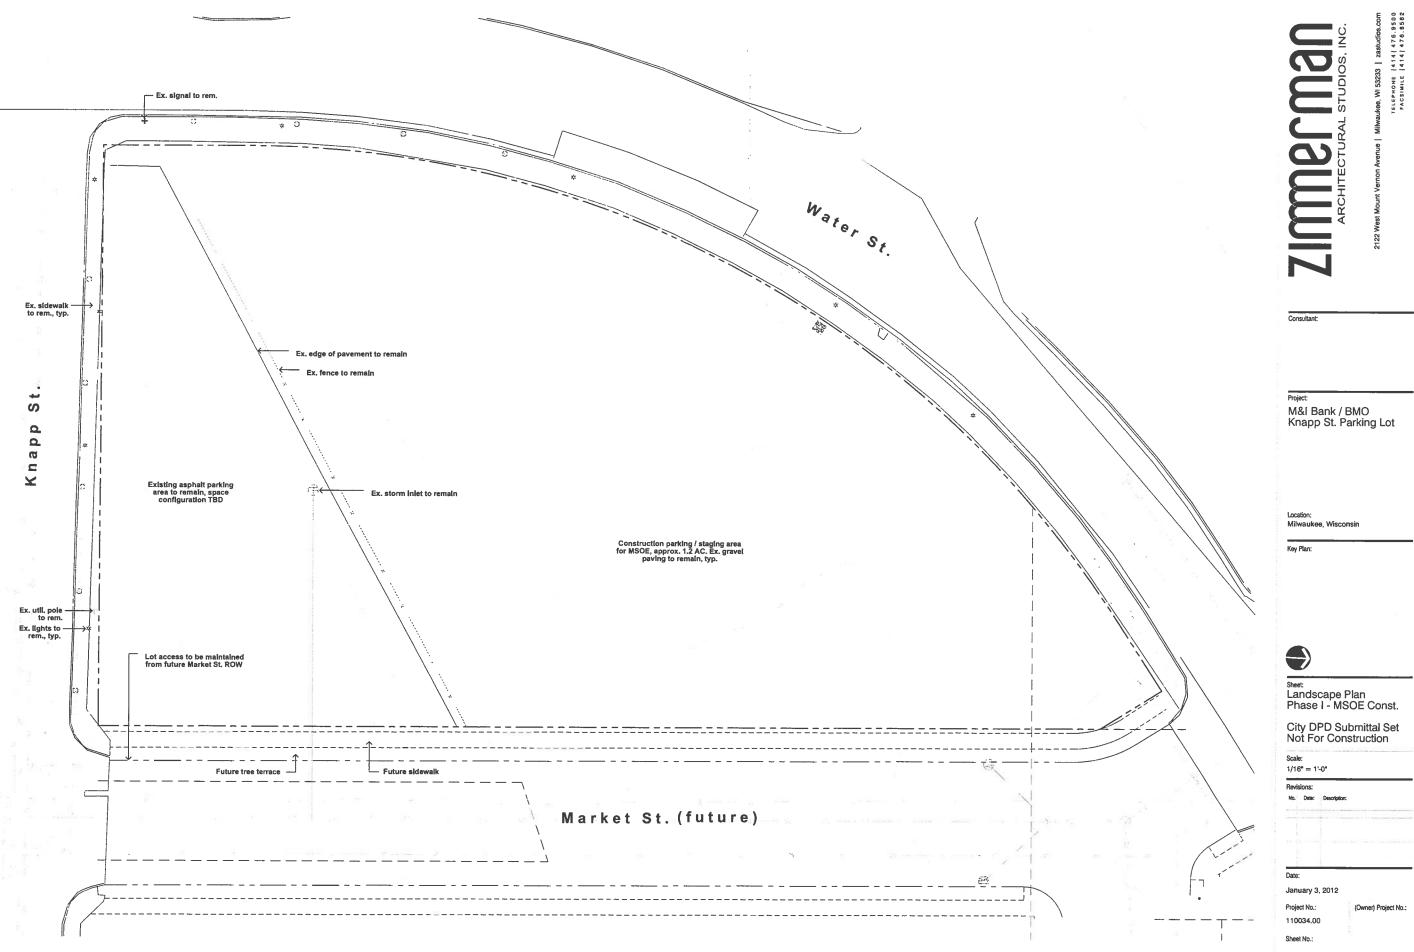

L1.0

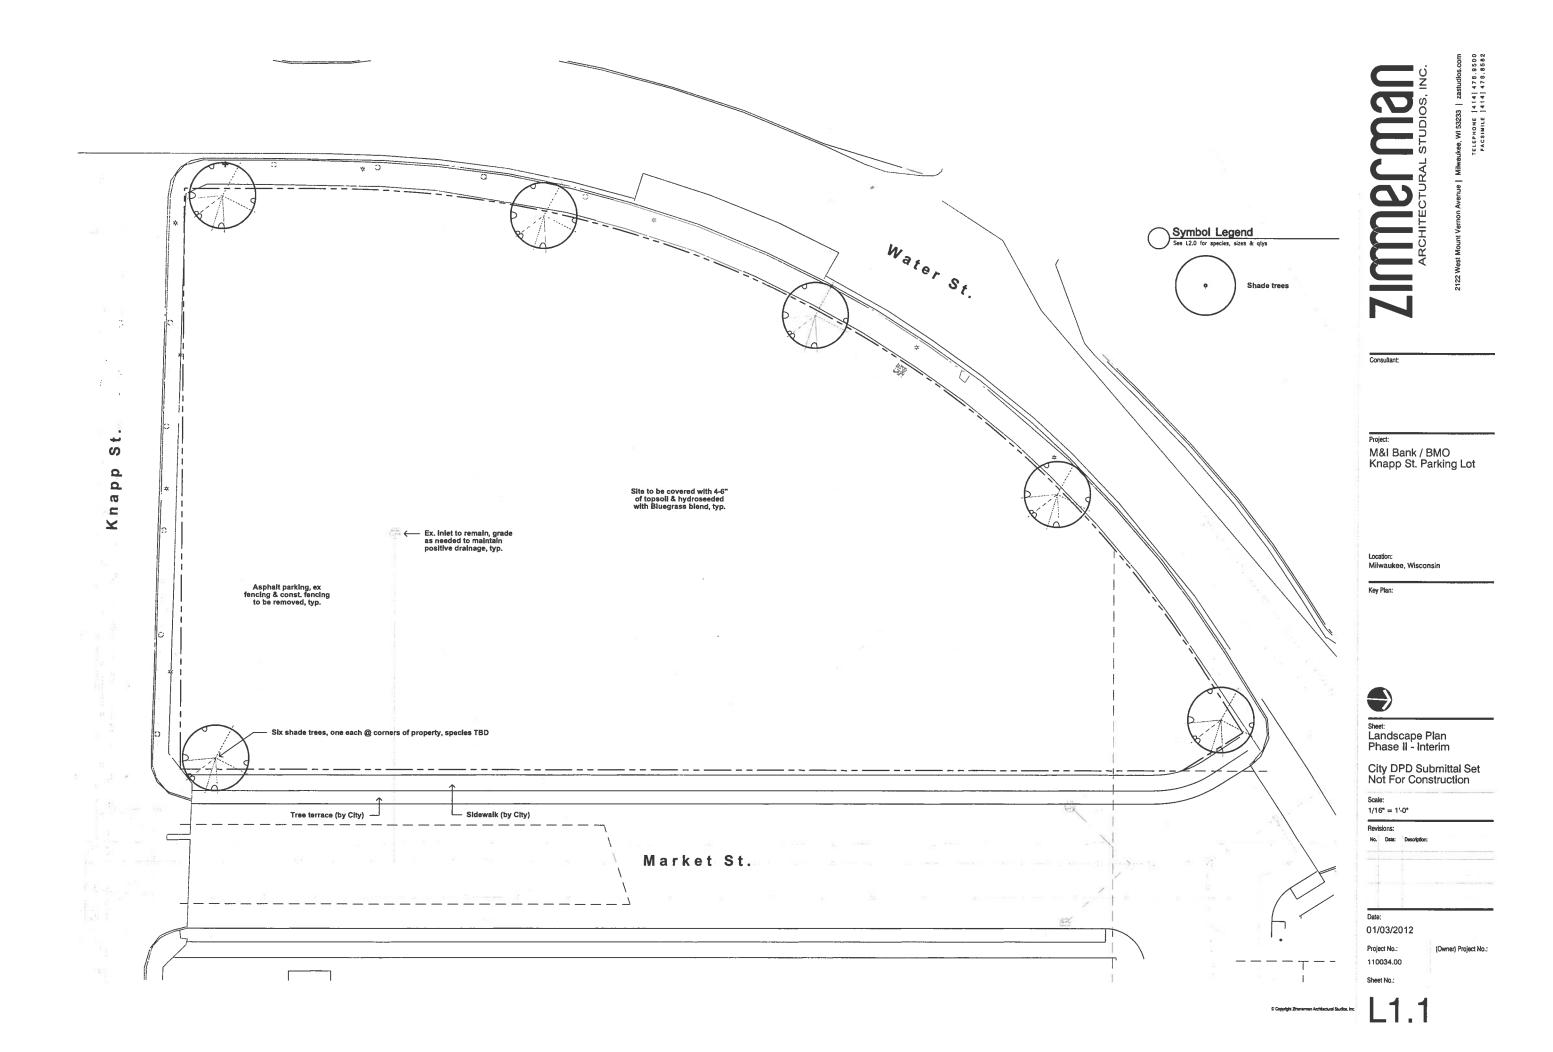

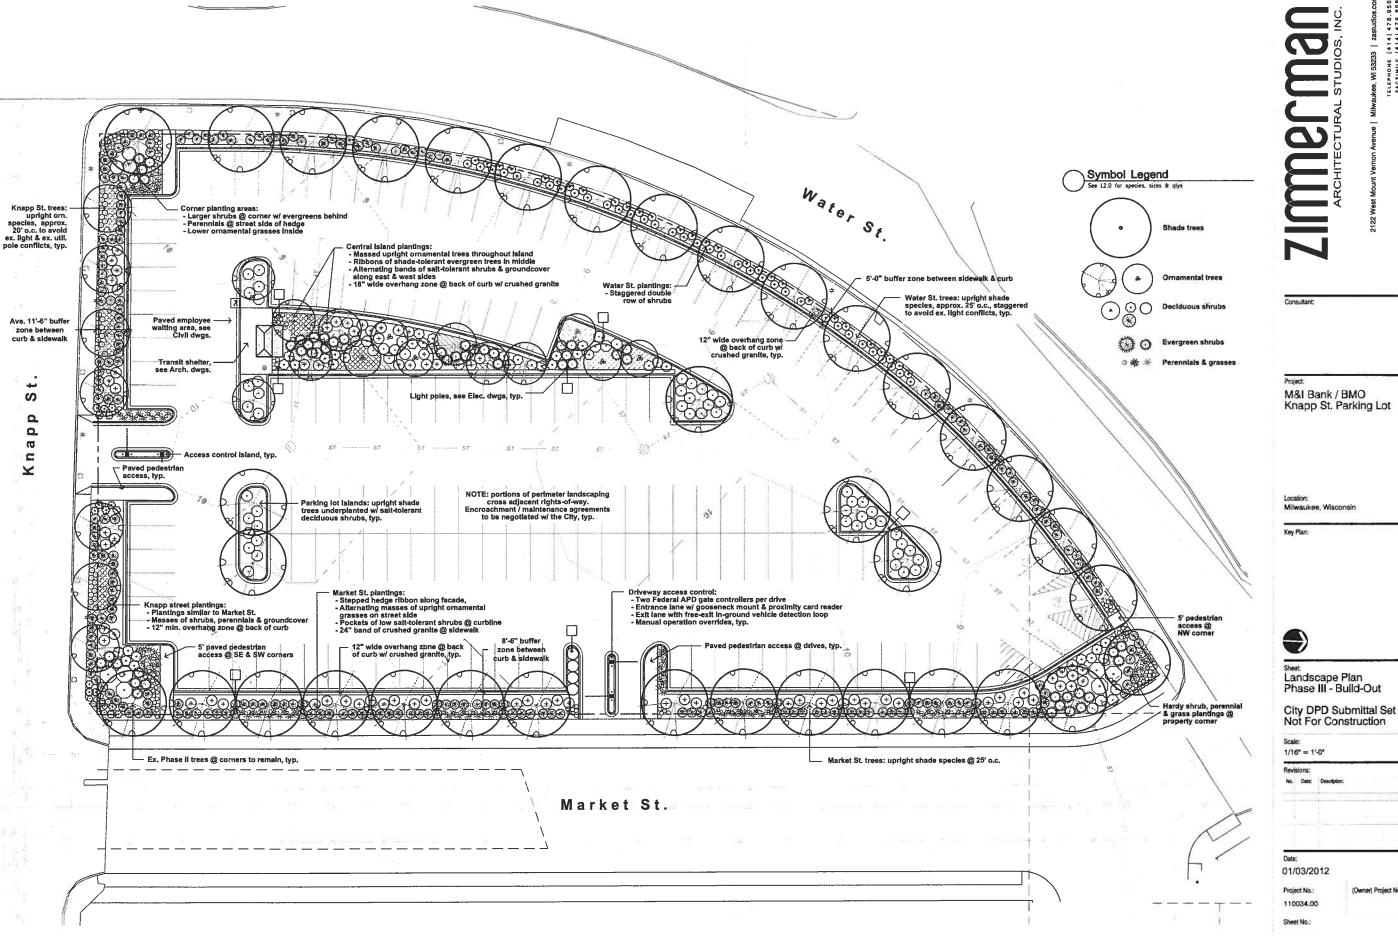

1.2

8° Long hardwood atake placed on windward and leeward side of tree. Calvanized wire with rubber hose trylocal Alternatic Nyon stapping Remove excess soil from top of ball to natural surface of rootball-fi needed.

Remove wire baskets or cut top and fold down in the pit after positioned and backfilled halfway. Cut and remove all poly ites.

2-4' depth of woody match: Stredded hardwood bark, aged or similar match. Keep mutch 6' back from trurk.

Backfilz: Use approved backfill per specification.) Water thoroughly to eliminate air pockets. Do not tampl

3X Dta, of rootball

Soil under rootball undisturbed to support root ball and reduce settling.

Tree Planting Detail

Notes: -See planting

specifications prior to installation

#### General Notes

- t.0 t All landscape installation & maintenance to conform with all applicable local codes & ordinances, including (but not limited to) City of Milwaukee Municipal Code Ch. 295-405 "Landscaping."
- 1.02 See Site dwgs. for work limits, scope of construction, hardscape, dimensions &/or construction notes. See Civil dwgs. for all grading, stormwater management, site utilities & erosion control. See Landscape dwgs. for landscape plans, site amenities, details, schedules, notes. See Architectural dwgs. for all construction. See Electrical drawings for all power, circulting, lighting & access control.
- 1.03 Contractor shall provide shop drawings and material submittals of <u>all</u> hardscape & landscape construction elements shown in plan set for Landscape Architect review prior to construction, including (but not limited to) ornamental fencing & all access control equipment.
- t.04 Contractor to provide samples for Landscape Architect's approval on all colors, finishes & materials prior to construction, including (but not limited to) topsoil, gravels, mulches, seed mixes et al.
- 1.05 Caution: underground utilities are present on site. The Contractor shall verify location of all aboveand below-grade utilities, <u>both public & private</u>, prior to commencement of site construction. If unanticipated above- or below-grade conditions are encountered, notify Client & Landscape Architect prior to proceeding. Coordinate with local public utility locating entity as needed.
- t.06 Contractor to verify hardscape layout prior to construction. Contact Landscape Architect if discrepancies are found.
- 1.07 Contractor to limit construction traffic to within work limit lines. All adjacent damage shall be the responsibility of the contractor to restore. See Civil drawings for limits of disturbance.
- 1.08 All written dimensions supersede scaled dimensions. All dimensions are taken from face of curb, wall or existing building foundations.
- 1.09 Any work done in the public right-of-way shall require an encroachment & maintenance agreement with the City of Milwaukee. Owner, LA & contractor to coordinate.

#### Landscape Notes

- 2.01 Rough grading & topsoil import/spreading are to be completed by others. Finish grading, seed area and omamental planting bed preparation shall be the landscape contractor's responsibility. Verify all existing site and grading conditions prior to construction.
- 2.02 All areas disturbed by site construction shall be fine graded and restored with vegetative cover as shown. See plans for cover types & locations, see specifications for materials & installation.
- 2.03 Contractor shall verify plant quantities shown on plan. Symbol quantities take precedence over plant keys. Forward a material list to the Landscape Architect prior to construction identifying species, sizes & plant sources to be used on the project.
- 2.04 All plant materials shall conform to the schedule and shall meet quality requirements outlined in the ANIA "American Standard for Nursery Stock", ANSI Z60.1-2004. The Landscape Architect reserves the right to reject any substandard planting material. Such rejected material shall be removed from the project site Immediately.
- 2.05 Ali nursery tags/labels shall be left on plant materials until the project punch-list inspection is completed by the Landscape Architect. Untagged materials will be assumed to be deficient.
- 2.06 All planting beds shall contain screened blended topsoil mix to a min. depth of 18". All lawn areas shall have min. 6". Sultable existing soil may be used & mixed if previously approved. Contractor shall be responsible for obtaining soil tests if existing topsoil is reused. Soil testing results shall include (but is not limited to) soil pH, % organic matter, phosphorus, potassium, calcium & texture (percentages of sand, silt and/or clay.) Remove excessive clay, gravel & stones detrimental to healthy plant growth. Remove all debris greater than 1" diameter.
- 2.07 Contractor is responsible for ensuring that all tree pits & planting areas drain properly. Notify Landscape Architect if drainage or moisture problems are encountered while planting.
- 2.08 Contractor shall backfill all trees, shrubs & evergreens with a mix of 1/3 plant starter mix & 2/3 remaining soil. Plant Starter Mix to be provided by Llesener Soils, Cedarburg Wi, or approved equal.
- 2.09 Ali perennial and groundcover areas shall receive a 3" layer of plant starter mix and perennial starter fertilizer, rototilled into the top 6" of blended topsoil in beds.
- 2.10 Ali perennial areas shall receive a 1-2" layer of shredded hardwood bark mulch. Groundcover beds do not receive a cover of shredded bark mulch. Do not allow mulch to touch stems or leaves of perennials! All woody planting areas shall receive a 3" layer. Unless otherwise shown in the plans, no landscape fabric or weed barrier is to be Installed.
- 2.11 Unless otherwise shown, all perennlals & shrubs to be planted in triangular arrangements. For plants not shown individually, refer to the spacing shown in the plant schedule.
- 2.12 All edging to be 3/16" x 4" alum. mill-finish. Permaloc "CleanLine" or "ProSlide", or approved equal.
- 2.13 Stone mulch areas to contain 2-3" of decorative stone installed over poly weed barrier. Stone to be decomposed/rotted granite or approved equal. Coordinate final material selection with LA.
- 2.14 Contractor shall provide positive drainage away from all structures for a minimum of 10'.

## Hardscape / Amenity Notes

- 5.01 Access control: Fumish, install, maintain (for one year) and warranty a vehicular access control system. Access gates to be "Federal APD" "G-90" series operators. Provide two each at each driveway. All associated equipment (gooseneck mount, vehicle detection loops, operator foolings, conduit & control equipment) to be included. Colors TBD from standard ranges. Available from TAPCO, Brown Deer Wi, 262-814-7000.
- 5.02 Add-alternate irrigation system: Furnish, install, maintain (for one year) & warranty a fully-automated design-build irrigation system. System to consist of all required components for a functional system, including (but not limited to) all plumbing, street lateral, meter & pit, master valve, RPBP, digital controller w/ two-week programmable calendar, rain sensor, witing, manifolds, lines, valves, laterats & heads. System to be designed by a Certified Irrigation Designer & installed by a Certified Irrigation Contractor. Layout to be based on the landscape plan. Shop drawlings, details & specs shall be provided for review/approval.

#### Plant Schedule (incl. all Phases)

Note: species shown are representative. Final selections TBD. Contractor is responsible for quantities, typ.

Symbol	Qty Prop.	Botanical Name	Common Name	Installed Size	Root	Spacing	Notes
Shade '	Trees [	Qty. 35]					
Gin Mag		Ginkgo biloba 'Magyar'	Magyar Ginkgo	3" Cal.	B/B	As Shown	
Gym Esp		Gymnocladus dioicus "Espresso"	Seedless Kentucky Coffeetree	3" Cal.	B/B	As Shown	
Ulm Naw		Ulmus x, 'New Horizon'	New Horizon Hybrid Elm	3" Cal.	B/B	As Shown	
Ornamo	ental Tr	ees [Qty. 19]					
Ame Col		Amelanchier x. 'Cole's Select'	Cole's Select Serviceberry	8" Ht.	B/B	As Shown	Heavy Three Sten
Mai Sar		Malus sargentil 'Firebird'	Firebird Sargent Crabepple	6" HL	B/B	As Shown	Single Stem
Syr Ivo		Syringa ret. 'Ivory Silk'	lvory Silk Jap. Tree Lilac	2.5° Cal.	B/B	As Shown	Single Stern
Pyr Aut		Pyrus calleryana 'Autumn Blaze'	Autumn Blaze Ornamental Pear	2.5" Cal.	B/B	As Shown	Single Stem
Pyr Cle		Pyrus calleryane 'Cleveland Select'	Cleveland Select Ornamental Pear	2.5" Cal.	B/B	As Shown	Single Stem
Decidu	ous Sh	rubs [Qty. 506]					
Bux Gre		Buxus x 'Green Velvet'	Green Velvet Boxwood	24° Ht.	2 Gal.	42-48" o.c.	
Hvd Gra		Hydranges arb, 'Grandiflora'	Snowhill Hydrangea	24° Ht.	2 Gal.	48° o.c.	
Myr Pen		Myrica pennsylvanica	Northern Bayberry	24" Ht.	2 Gal.	48° o.c.	
Rhu Gro		Rhus aromatica 'Gro Low'	Grow Low Surnac	24" Ht.	2 Gal.	48° o.c.	
Ros CFW		Rosa 'Carefree Wonder'	Carefree Wonder Rose	24" Ht.	2 Gal.	36° o.c.	
Spl Tor		Spiraea betuitiolia 'Tor'	Tor Birchleaf Spirea	24° Ht.	2 Gal.	42° o.c.	
Spl Frl		Spiraea fritschiana	Fritsch Spirea	24" Ht.	2 Gal.	36-42" o.c.	
Syr Pal		Syringa meyeri 'Patibin'	Palibin Dwf. Lilac	30-36" Ht.	2 Gal.	48-54" o.c.	
Vib Red		Viburnum dentatum 'JN Select'	Red Feather Arrowwood Viburnum	48" HI,	B/B	72° o.c.	
Evergre	en Shr	ubs [Qty. 50]					
Jun Kal		Juniperus chinensis 'Kallay'	Kallay Compact Juniper	24" sprd.	7 Gal.	54-60° o.c.	
Jun Ska	_	Juniperus sabina 'Skandla'	Skandia Juniper	24" sprd.	7 Gal.	54-60" o.c.	
Tax Gem		Taxus x. media 'Gem'	Gem Densiform Yew	24" sprd.	7 Gal.	54-60" o.c.	
Perenn	ials & G	Grasses [Qty. 260]					
Alc Mal		Alchemilla mollis	Lady's Mantie	1 Gal.	Cont	24" o.c.	
Aru Dio		Aruncus diolous	Gostsbeard	1 Gal.	Cont.	24" o.c.	
Hem Hep		Hemerocells 'Happy Returns'	Happy Returns Daylily	4.5*	Cont.	18-24° o.c.	
Hem Hyp		Hemerocallis 'Hyperion'	Hyperion Dayilly	4.5"	Cont.	24" o.c.	
Hem Ros		Hemerocallis 'Rosy Returns'	Rosy Returns Daylily	4.5*	Cont.	18-24° o.c.	
Hos Roy		Hosta 'Royal Standard'	Royal Standard Hosts	1 Gal.	Cont.	30" a.c.	
Hos Sum		Hosta 'Sum & Substance'	Sum & Substance Hosta	1 Gal.	Cont.	42° o.c.	
Mis Mor		Miscanthus 'Morning Light'	Morning Light Maidenhair Grass	1 Gal.	Cont.	30° o.c.	
Per Lit		Perovskia atr. "Little Spire"	Little Spire Russian Sage	4.5°	Cont.	24° o.c.	
Spo Het		Sporobolus heterolepsis	Prairie Dropseed	1 Gal.	Cont.	24° o.c.	
Ground	cover	Qty. 700 sf]					
Euo Col		Euonymus fortunei 'Coloratus	Purpleles! Wintercreeper	2.5"	Cont.	10-12" o.c.	

ARCHITECTURAL STUDIOS, INC.
2122 West Mount Vernon Avenue | Milwaukee, WI 53233 | zastudios.com

Consultant:

roject:

M&I Bank / BMO Knapp St. Parking Lot

Location: Milwaukee, Wisconsin

Key Plan:

Sheet: Landscape Details, Schedules & Notes

City DPD Submittal Set Not For Construction

Scale: As Shown

Revisions:

....

01/03/2012

Project No.: 110034.00

Sheet N

(Owner) Project No.:





. I. Existing we energies pole to be demolished and removed by we exercise.

2 EXISTING POLE AND ABANDONED ELECTRICAL EQUIPMENT TO BE DEMOUSHED AND REMOVED BY CONTRACTOR.

- 3. EXISTING WE ENERGIES POLE TO REMAIN IN SERVICE
- 4. HEW ELECTRICAL SERVICE METER PEDESTAL NEAR EXISTING POLE.
- 5 UNDERGROUND FEEDER TO ELECTRIC PANEL.

6 PHOTOCELL CONTROL FOR SITE LIGHTING. MOUNT TO BUS SHELTER CANOPY, FINAL LOCATION, TBD.

HARWOOD
ENGINEERING
CONSULTANTS, LTD
7420 West Stole Street Melvoulee Wiscorum 32/13
414 473-3254 414 473-3245 tor resembod fraction
Fraction of the Conference of the Confere

M&I WATER STREET PARKING

Location: MILWAUKEE, WI

MUNICIPAL REVIEW SET (NOT FOR CONSTRUCTION)

DATE: DECEMBER 2, 2011


Scale:
Sheet:
ELECTRICAL SITE PLAN

01/03/2012

Project No.: 011-0034.00

Sheet No.:


E1.01

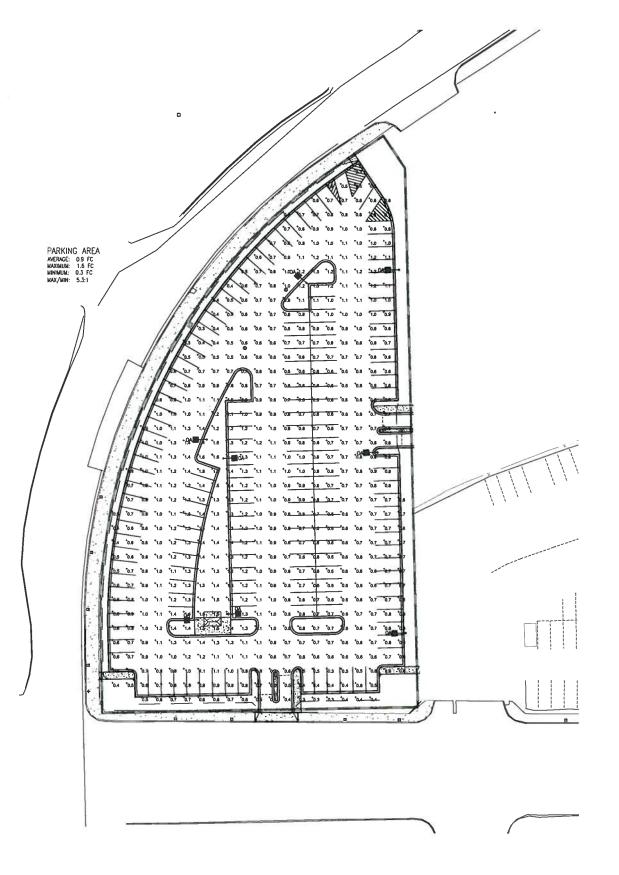

SITE PHOTOMETRIC CALCULATION

## NOTES:

- 1. THE RESULTS OF THIS STUDY ARE TO BE VIEWED ONLY AS AN INDICATION OF POSSIBLE PERFORMANCE. DUE TO VARIATIONS IN LAMPS, DRIVERS, MANUFACTURING, UNE VOLTAGE, AND SITE CONDITIONS, A CURAWITED LEVEL OF PERFORMANCE IS NOT POSSIBLE AND IS NOT REPRESENTED BY THIS
- 2. ALL CALCULATION POINTS ARE MEASURED IN FOOT-CANDLES.
- 3. CALCULATION INDICATES MAINTAINED LIGHT LEVELS USING A LIGHT LOSS FACTOR OF 0.85.

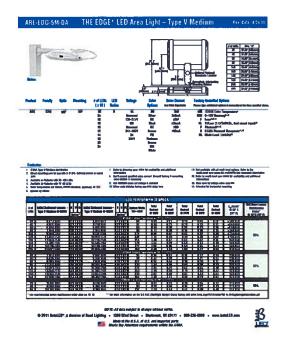

1 FIXTURE TYPE 'OA'
E1.02 NO SCALE

Imperman

HARWOOD ENGINEERING CONSULTANTS, LTD 7400 West 15tes 15tes 1440-4540 Wide conds 52113 414.475.8554 414.475.858 for howcodemectors 1600-4500 Project Author 1-1003400

Project:

M&I WATER STREET PARKING

Location: MILWAUKEE, WI

MUNICIPAL REVIEW SET (NOT FOR CONSTRUCTION)

DATE: DECEMBER 2, 2011

Cool

Sheet:


SITE PHOTOMETRIC CALCULATION

Date:	Issue Set:	
_		
		194

Date: 01/03/2012

Project No.: 011-0034.00

Sheet No.: **E1.02** 

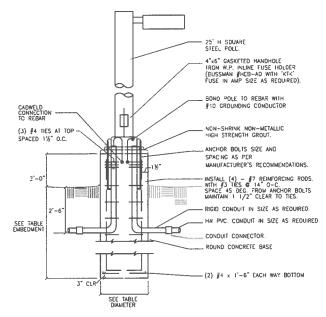



## POLE BASE DETAIL

NTS

NOTES:

1. DIMENSIONS GIVEN ARE MINIMUM. PROVIDE POLE BASE DIAMETER AND DEPTH
AS REQUIRED IN ACCORDANCE WITH LOCAL SOIL AND WIND VELOCITY CONDITIONS.

 ALL LIGHTING POLE CONCRETE BASES SHALL BE LOCATED A MINIMUM OF 12 INCHES OFF THE FACE OF THE CURRING OR CENTERED WITHIN AN ISLAND. IN ALL CASES, HOWEVER, FINAL COCATIONS OF LIGHTING POLES MUST 8E VERIFIED WITH THE ARCHTECT/ENGINEER PRIOR TO INSTALLATION.

 ALL DIMENSIONS POLE BASE ARE FOR BIODING ONLY. POLE BASE SHALL MATCH THOSE AT EXISTING POLES, & APPLICABLE.

POLE HEIGHT	1 HEAD	ASE EMBEDME 2 HEAD	NT/DIAMETER 3 HEAD	4 HEAD
15'-0"	6'-5"/2'-0"	6'-S"/2'-C"	6'-5"/2'-0"	6'-5"/2'-0"
20'-0"	6'-5"/2'-0"	6'-5"/2'-0"	8'-0"/2'-0"	8'-0"/2'-0"
25'-0"	6'-5"/2'-0"	8'-0"/2'-0"	9'-0"/2'-0"	10'-0"/2'-0
30'-0"	8'-0"/2'-6"	9'-0"/2'-6"	10'~0"/2'-6"	10'-0"/2'-6

		LIC	GHTING	FI	XTU	RE SCH	EDULE	3			<b>13</b>	1000 4111111	
	T	LAMP DATA LIGHTING FIXTURE					BALLAST	MTG.	MTG. SURF	SEI			
OES.	DESCRIPTION	NO.	TYPE	VOLT	ОЕРТН	MFR.	SERIES		OPTIONS/ACCESSORIES	TYPE	MIG.	SURF	i.F.
OA.	SINGLE HEAD POLE LIT. LUMINAIR 25'H SOU, POLE ON CONC. BASE 17FF V OIST; FINISH BY ARCH.	6	LEO MOOULES (120 LEO'S)	240	-	BETA LED	ARE-EDG-SM 12-C-24 SERIES	-DA-	18,26	-	SURF	CONC. BASE	-
AR CONC. E EXP	AS REQUIRED  BASE CONCRETE BASE ELECTRONIC EXPOSED STRUCTURE  NS/ACCESSORIES CODE LISTING:	GRI CYI LAS	CYPSUM BOAR LENGTH AS SH		NA PS PENO REC	PENDANT		S SPEC STAN SURF	SPECIAL U	NS LEI	ORIVE	SHOWI R BLE DR	
02. 03. 04. 05. 06.	0.125" PATTERN 12 ACRYLIC LEHS HOLOPHANE 3246 LENS HANTI AFTER FABRICATION SPRING LOADED LATCHES FLUSH ALUMINUM DOOR FRAME ELECTRONIC BALLAST, TOTAL HARM DISTORTION 2. 10% FLUORESCENT DIMMING BALLAST WHITE TIRM RING SEMI-DIFFUSE. LOW-IRDESCENT C ALZAK REFLECTOR	ONIC	11, 12, 13, 14, 15, 16, 17, 18,	PENDAN SAFETY NEMA H WIRE GI EMERGE TOP AN TIME DE WET LO DAMP L FURNISI	OOK, CO JARO NCY EAL O BOTTO LAY CATION L OCATION	RD AND PLUG LAST V LENSING ABEL CONSTRUCTION INIVERSAL ARROWS	S ANO	22. 23. 24. 25. 26.	SLOPE ADAPTER TWO BALLAST COVERS STANDARD FINISH TO ARCHITECT 277/24 VOLT TRANSF LEAD—CALCIUM BATTER	TTERY TS BE SELE ORMER TY	CIED B	Y	

DEHTING FIXTURE NOTES:

NOTES LET - LES ARE GENERAL NOTES APPLICABLE TO ENTIRE LIGHTING FOXTURE SCHEDULE WHERE APPROPRIATE.

LF1 - PROVIDE ALL NECESSARY COMPONENTS AND ACCESSORIES FOR A COMPLETE OPERATING INSTALLATION PER APPLICABLE CODES AND MANUFACTURER'S RECOMMENDATIONS.

172 - CONTRACTOR SHALL REVEW THE ENTIRE LICHTING FIXTURE SCHEDULE INCLIDING THE DESCRIPTION AND CATALOG MUNIBER. CONTRACTOR SHALL NOTIFY THE A/E OF ANY DISCREPANCIES PROR TO BEDDING.

1F3 - YERIFY ALL FINISHES/COLORS OF FIXTURES WITH A/E PRIOR TO CREERING.

LF4 - FOR FOTURES USTED IN SCHEDULE WITH (E) ELECTRONIC TYPE BALLASTS, DR (S) HID TYPE BALLAST, PROVIDE A BALLAST AS INDICATED IN SPECIFICATION.

LFS - PROVIDE 4 EXTRA LAMPS OF EACH TYPE INDICATED IN LIGHT FIXTURE SCHEDULE AND TURN OVER 10 DWNER.

		SI	PECI	AL (	UTI	LET	SC	HE	DUI	LE		<b>(4)</b>						
		T	FEED FROM		BREA	<b>UKER</b>	WIRING			WIRING		1ERMINAL		AL		7	LOAD (KW)	SEE
NO.	TO FEED	LOC.	PANEL	CKT.	SIZE	POLE	NO.	SIZE	GN0	COND.	R	D		VOLT	,ps'	(KW)	NOTE	
CATE	SECURITY LIFT GATE																	
		1															П	
		+-	<del>                                     </del>					<del></del> -		$\vdash$	_							
		+	-		ļ	-	-		-	ļ		_			_	$\vdash$		
							L									_		
		+																
	I	ı	I	I	I	i	I	l	l	1	1	(	1	ı	1	I	ı	



HARWOOD
ENGINEERING
CONSULTANTS, LTD
7/20 Word Life is Breat Nativockee Wilcome 15213
414 475 3584 C Reget I Ambre 11 - 11 000 M20

Project:

M&I WATER STREET PARKING

Location: MILWAUKEE, WI

MUNICIPAL REVIEW SET
(NOT FOR CONSTRUCTION)

DATE: DECEMBER 2, 2011

Scale:

Sheet: ELECTRICAL SCHEDULES AND DETAILS

Date:	Assur Set;	
+-		 
		 131
Date:	-	
01/03/20	140	
01/03/20	112	
Project No.:		
011-003	4 NN	

E2.01

Sheet No.:

## SECTION 1500G ELECTRICAL WORK

- GENERAL

  The Contractor shall provide all labor and materials to affect a complete electrical installation in accordance with the plans and
- B All work shall be in accordance with lazal, stare, International Eurlding, and National Electrical Codes.
- 0. The Contractor shall apply for all permits one pay all fees.
- E. The electrical contractor shall submit a Bill of Meteria and shap drawings upon request of the A/E.
- The Controctor shall conduct final tests to demonstrate compliance with plans and specifications. Owner shall be present for
- All electrical equipment shall be inecreal. Provids nameplates sescribing panel name, usage, vallage, phase, # of wires, and ment. Install new panel directories (typed, not free hand).
- Culting, Potching and Retinishing: The Contractor shall provide all openings in new and existing construction except where noted on the plans.

  The Contractor shall do all patching and relinishing at existing surfaces.

- Delinitions: A/E: Architect and/or Engineer Provide: Furnished, instelled, wired and connected by the Contractor. Contractor: the person or group responsible for project construction.
- Demoktion, Renovation and Disposition of Existing Equipment:
  All work required shall be done in a menner and time acceptable to the Owner and shall be acceptable as to time and
- 2. Existing electrical equipment not otherwise noted, or in conflict with construction, shall be removed and/or relocated as indicated on the drawings, as directed or require. Remove all electrical equipment relosed from service as a result of construction, and no equipment removed shall be resured except as specifically directed on the drawings or slesswhere herein. Heeltings equipment, apporatus and hardware removed and not resused, and not relosed by the Owner, shall become the property of the centracter and shall be removed from the site.
- Furnish a minimum of 5 copies of shop drawings for approval. Shop crowings of system equipment and common equipment shall be submitted in a bound brachure with an index sheet describing contents therein.
- All shop drawings when submitted shall bear the contractor's name, date and approval. Shop drawings will not be reviewed by
- Shop drowings shall be submitted electronically in pdf format.
- M. Warronty: The Controctor, in full knowledge of requirements of the controct documents relative to electrical work, guarantees that the electrical installation has been done in full occord with the same. Additionally, the Controctor shall warrant and maintain, remedy and/or replace at his expense any work or materials which may become delective within one year from date of substantial completion, provided such defects are not due to "Acts of Cod", or obuse/misuse by agents at the owner.
- RACEWAY
   Roceway shall be conecoled wherever possible.
- B. Use rigid steel 1/2" minimum for all conduit above grade or concrete. Use liquid tight and greenfield where required.
- C. Conduit installed in concrete or underground shall be heavy wall schedule 40 PVC. Install no conduit larger than  $3/4^{\circ}$  in thou slab.
- Couplings, connectors and filtings shall be standard devices to properly attach conduit to outlet boxes, panel enclosures, all steel, rain light, and concrete type, specifically designed for the application and bearing the UL label.
- E. Outlet boxes shall be 4" square minimum, 2-1/2" deep unless noted atherwise
- F. Exterior underground conduit shall be herey wall Schedule 4D PVC.

  1. Exterior underground conduit shall be buried at a depth of not less than 30 IN below grade. Provide conduits or outs terminating below grade with means to prevent entry of dirt or moisture. Underground conduits shall slope 1/8" per too for proper drainage. Conduits shall drain toward menhales and junction boxes, not the electrical equipment.
- A. All conductors shall be stronded copper with Types TW, THRN or THW (No. 12 and larger) 600 volt insulation.
- ELECTRIC SERVICE AND DISTRIBUTION EQUIPMENT
  Provide temporary service in the area of construction for all trades. Include local lighting and 120 vall power Cost of power shall be paid by Owner.
- Present permonent services, it existing, shall remain in place; alterwise locate as shown on plans. New feeders and panel bacrds shall be provided in accordance with drawings. Provide new distribution panels complete with circuit breakers with AIC rating as indicated.
- C. Grounding shall be in oceardance with Code.
- D. Safety switches shall be heavy duty (HD) type fused or unfused as required and rated at 200koic
- TRANSIENT VOLTAGE SURGE SUPPRESSION
- TRANSENT VOLTAGE SURGE SUPPRESSION
  The unit shall be rated for service enforce Category C location per ANSI/EEE C62.41-1991, and for 150,000 amperes per phase. Phase should be measured between (L-N & L-G). The IVSS shall provide protection modes to L-N, L-G, L-L, N-G. The unit shall have indicator status lights for the IVSS device, verifying proper operation. The internal design at the unit shall incorporate sine wave tracking and have EM/RF filtering for high trequency purposes. Acceptable manufacturer's: Current Technology TG series or Internalic PG or SG series.
- 8. The specified system shall be installed no further than twelve (12) inches in total wire lead length distance from the panel board it is protecting, and shall avoid any unnecessary bends. Insulated conductors shall be provided for all necessary power and ground connections. System shall be complete, including status indicator lights providing, with independent protection circuit status.
- C. Manufacturer shall provide a product warronty for 5 YEARS from date at installation. Warronty shall cover unlimited repracement of system components during the warronty period. WIRING DEVICES
- Verity color of all devices and facebates with Architect. Adjustment in color shall be made in the field without additional
- Local Switches:
   Hubbe® t22t, 1223, t224 series with single pole, three-way and four-way, as required.
- C. Receptocles:

  o. In Generot: All receptocles shall be roted for the eepocity and characteristics of the equipment served and shall be

  - in General: All receptocles shall be rotted for the cepacity and characteristics of the equipment served and shall be complete with one additional pole for grounding.

    2) 20 Amp 125 Yott Duplex: Hubbell S352.

    3) Ground Foult interrupter: 15 Amp, with built—in ground foult interruption, 5 mA sensitivity, LED indicator light ("DN" when appearable) and reset, Ut 2003 compliant. Duplex, Leviton 8598.

    4) TVSS 13ka 20 Amp 125 Yott Duplex with light and alarm: Hubbell 53625.

    All connections to wiring devices must be made by the binding screws only.

    Mounting height:

    1) Receptocles: 18 up

    2) Switches: 48 up

    3) Receptocles Above Counters: 6" up obove counter

- D. Furnish combination, multi-gong and special plates as required.
  o. In generati P&S p-line smooth thermoset plastic.
  b. Unfinished areas: Soin Stainless Steel with plate screws at similar material. Sierro Type 302.
  c. Weatherproof: Of type indicated by symbol on the drawings with Hubbell GF5362, 20 amp 125 vott ground fault receptorie with while-in-use over intermotic WP (DOD series).

- LICHTING FIXTURES AND LAMPS
  Provide fixtures complete with initial till of tamps as scheduled.
- 3. Refer to Lighting Fixture Schedule on plons.
- MOTOR WIRING
  Applicable motors turnished under Ceneral Construction. Heating, Vertilating, Air Conditioning and Plumbing branches of the work.
  Motor starlers and controllers shall be erected by the Contractor in an approved manner at locations established by contractor supplying the equipment. The Centractor shall extere motor concentrations are each instance. All five voltage multi-controllers and all includents line voltage multi-controller shall return to restrict the motor controllers and all includents line voltage multi-controller shirp them. aming an account of the control wing shall be done byte Contrector. Low voltage witing (less than 12) volts) shall be ty mechanical trade controlor. Provide MP roted mator discontrol skitches as required by Code. Provide NEWA I enclosures in generol, NEWA 3 enclosures wherever exposed to weather. The Controctor shall variety that all materials are provided for a complete electrical installation.
- SPECIAL DUTLET OUTLETS
- SPECIAL DUTIET OUTLETS
  Special Purpose oullet shall be bacted os required by equipment. The Contractor shall be responsible for verifying electricel characteristics of the actual equipment being furnished for the project prior to installation of outlets. The Contractor shall verify that of materials are provided for a complete setterized installation.
- EXCAVATION

  The controctor shall perform all excavation, and furnish and install oil code and make terminals as detailed on drawings.
- Measurements: The contractor shall key out this work and make all measurements required to fit his work to field conditions. He shall take all levels necessary and establish proper grade. The contractor shall verify all dimensions at the site and be responsible for their occurry and coordination with all existing trees, shrows, etc.
- D. The Contractor shall obtain linel grades from the owner before praceeding with trench work.
- Where the earth trench meets conduit either above or below the trench line, the trench shall be sloped at a grade of not more than two inches per tool to meet the conduit. Do not bend conduit to meet the trench.
- C. The trench shall be cleared at large stones, or large objects such as described under "Backfill". The trench bed shall be relatively clean, at debris and firm.
- H. During excavation, the Contractor shall exercise core to avaid injuring to existing trees, utilities, connections, etc. The expense of repairing any damage and restoring same shall be barne by the Contractor.

- BACK FILL

  The exceeded moterial adjacent to the trench may be used as back till except for hand chunks of earth,broken concrete, bricks, stances, or other objects larger than 2° in dometer which might domage the duct system.
- Additional back fill may be required to supplement excavated material in order to restore trench to meet precut condition and
- C. Back till shall be firmly tamped and solidly packed. However, do not tamp on top of PVC conduit.
- D. Inspect installation after 30 days with the Owner and perform such additional work as necessary and directed by Owner
- BIDDING PROCEDURES
- t. Base Eid shall include all labor required and all materials and equipment as shown on the contract drawings and
  - Base Bid shall not include any conditions or qualifying statements, shall be in strict accordance with specification requirements and shall be based upon the installation of meterials and equipment as specified.

## ABBREVIATIONS

A/E	ARCHITECT/ENGINEER	1.	INSTALLED
AF	AMP FUSE	IU	INTEGRAL TO UNIT
AFC	AVAILABLE FAULT CURRENT	KW	KILOWATT
AFF	ABOVE FINISHED FLOOR	LIG	LAY-IN GRID
ARCH	ARCHITECT	LDC	LOCATION
AFG	ABOVE FINAL GRADE	LTG	LIGHTING
AR	AS REQUIRED	MAG	MAGNETIC STARTER
AS	AMP SWITCH	MAN	MANUAL STARTER
В	JUNCTION BOX	MC	MECHANICAL CONTRACTOR
BKR	BREAKER	MCB	MAIN CIRCUIT BREAKER
BFG	BELOW FINAL GRADE	MLO	MAIN LUGS ONLY
C	MOUNTED 6" ABOVE COUNTER	MSB	MAIN SWITCHBOARD
CAB	CABINET	MTD	MOUNTED
CB	CIRCUIT BREAKER	NU	NEAR UNIT
cd	CANDELA	NIC	NOT IN CONTRACT
CKT	CIRCUIT	0	OTHERS
CLG	CEILING	oc	ON CENTER
COMB	COMBINATION STARTER W/DISCONNECT SWITCH	ORS	OVER RIDE SWITCH
CONC	CONCRETE	OU	
CP	CONTROL PANEL		ON UNIT
CS	COMBINATION STARTER/DISC. SWITCH	P	POLE
D	DISCONNECT SWITCH	PC	PHOTOCELL
DISC	DISCONNECT SWITCH	PEND	PENDANT
DN	DOWN	PLBG	PLUMBING CONTRACTOR
DNLT	DOWN LIGHT	PNL	PANEL
EWC	ELECTRIC WATER COOLER	P8	PUSH-BUTTON
E.C	ELECTRICAL CONTRACTOR	R	RECEPTACLE
ELEV	ELEVATION	REC	RECESSEO
EMT	ELECTRICAL METALLIC TUBING	SS	SWITCH STATION
ENT	ELECTRICAL NON-METALLIC TUBING	SURF	
ER	EXISTING TO BE REMOVED	SUSP	SUSPENDED
EXP	EXPOSED	S₩	SWITCH
EXR	EXISTING IN NEW LOCATION	TC	TIME CLOCK
ΕX	EXISTING TO REMAIN	TCC	TEMPERATURE CONTROL CONTRACTOR
Ē	FURNISHED	TYP	TYPICAL
FIXT	FIXTURE	UM	
FLUOR	FLUORESCENT		UNIT MANUFACTURER VERIFY
G.C.	GENERAL CONTRACTOR	VER	
GFI	GROUND FAULT INTERRUPTING	VF0 W	VARIABLE FREQUENCY DRIVE WIRED
GRC	GALVANIZED RIGID CONDUIT	WP	WEATHERPROOF
GYP	GYPSUM BOARD	XFMR	TRANSFORMER
HOA	HANO-OFF-AUTO SELECTOR SWITCH	VI MILL	TIONS ORMER
HP	HORSEPOWER		
HVAC	F HEATING, VENTILATING, AND		
HV	AIR CONDITIONING CONTRACTOR		
HW	HEAVYWALL		
	HEATTHORE		

#### GENERAL RENOVATION/DEMOLITION NOTES:

- ELECTRICAL DRAWINGS ARE EASED ON THE BEST INFORMATION ANNUABLE. FOR ARIAS BEING PERMODELED, WORK SYMBAN RETLICES INFORMATION SHOWN ON AS-BURT PLANS AND FELD INSERVATION, IT SO IN GLAMARITED IONS ACCURATE TO CONTRACTION WILST FILLD VERY CONDITIONS AND MAKE RECTSARY ADJUSTMENTS WINDOL CERTA COSTS TO THE PROJECT IO SUIT ACCURATE, VEIDS.
- 63 CIRCUITS INDICATED ARE INTENDED TO DENDTE WHICH DEWDES/FIXTURES ARE TO BE WRED TO A COMMON CIRCUIT BETAKER, AND ADT ITS POSTION IN THE PANEL UTBLEE RELEVENS/PANEL CIRCUIT BETAKER (AND ADT ITS POSTION IN THE PANEL) BETAKERS AS RECORD. REBNIANCE LONDS BETIREN FINASES (MAX. 7.5%) UPON COMPLETION OF REING.
- 4. ALL EXISTING DEVICES WHICH ARE NOT EHOWN ON THESE DRAWINGS OR DIRECTED BY A/F SHALL BE PEMOVED.
- 5. EXACT LOCATION OF SPECIAL FURPOSE OUTLETS SHALL BE VERFIED IN FIELD. VERFI'S SPECIFIC WIRNO REQUIREMENTS WITH VENDORS' DAWINGS, INSTRUCTION, COORDINATING ELECTRICAL WORK WITH WORK OF VENDOR AND OTHER TRADES.
- 5. INCLUDE FISH WIRE IN ALL NON-POWER CONDUITS.
- CONTRACTOR SHALL BE RESPONSIBLE FOR PROPERLY DISCONNECTING FORER AND REMOVING THE EXISTING FRITURES FOR REUSE. ANY FIXTURE(S), ELECTRICAL DEVICES, AND INDICATED TO BE REUSED SHALL BE PROPERLY DISPOSED OF AND/OR IN ACCORDANCE WITH THE SPECIFICATIONS.
- 8. VERIFY EXACT LOCATION OF LIGHTING FLATURES IN THE FIELD TO AVDID CONFLICT WITH MECHANICAL EQUIPMENT, DUCT WORK, AND PIPES.
- 9. THE CONTRACTOR SHALL BE RESPONSIBLE FOR ADJUSTING AND AMING ALL FIXTURES TO THE OPTIMUM DISTRIBUTION AND DIMMER'S SATISTACTION.
- TO, THE CONTRACTOR SHALL DO THE NECESSARY DEMOLITION WORK IN THE AFFECTED AREAS MICLIONIC THE REMOVAL OF LICHINGE FRURETS, LIMPS, WERNE, ACCESSIBLE CONDUIT, AND ELECTRICAL SOLUMENT. IN ADDITION, PRECEDUAL ORGANICION WORK, IS SHALL DE-ENERGIZE ALL ORICLAIS IN THE AFFECTED AREAS AND WHERE WIRNING, IS COUNTED THROUGH THESE AREAS SERVICE AREAS OF THE SULLIONS CHANNES IN FOURPMENT BEING REMOVED AND/OR ABANDONED BACK TO SOURCE
- A/E REVIEW OF REDUNDANT SUBMITTALS FROM BACKUP, SECOND SOURCE OR REPLACEMENT SUPPLIERS/CONTRACTORS IS CONTRACTOR'S EXPENSE.
- 12. A/E SERVICES RELATED TO A SUBSTITUTION OR CHANCE PROPOSED BY THE CONTRACTORS EXPENSE. DO NOT RELY ON ACCEPTANCE ON PREPARING BIDS. THE A/E MAY REJECT THESE WITHOUT CAUSE.

## SYMBOLS

- POLE MOUNTED LIGHT FIXTURE SIDE ARM
  - ELECTRICAL POLL
- SPECIAL PURPOSE OUTLET SEE SCHEOULE.

MISCELLANEOUS SYMBOLS



-INDICATES SHEET NUMBER -INDICATES NOTE NUMBER

SEE NOTE

SHEET INDEX

SYMBOLS, ABBREVIATIONS, AND NOTES

ELECTRICAL SITE PLAN
SITE PHOTOMETRIC CALCULATION
ELECTRICAL SCHEDULES AND DETAILS

--- INDICATES SHEET NUMBER

HARWOOD ENGINEERING CONSULTANTS, LTD

7420 Wast State Street Milwaucea Visuur 414.475.5554 K14.475.5698 fax harwoodfil HEC Project Number: E1-0034.00

a

**M&I WATER STREET** PARKING

Location MILWAUKEE. WI

MUNICIPAL REVIEW SET DATE: DECEMBER 2, 2011

NOTES

SYMBOLS.

ABBREVIATIONS AND

01/03/2012 Project No.

011-0034.00 Sheet No.: