

SCHEMATIC DESIGN II

MARRIOTT MILWAUKEE HOTEL

Milwaukee, WI 53202

KAHLER SLATER PROJECT: 210225.00 JULY 11, 2011

G0.10 TITLE SHEET AND SHEET INDEX G0.60 PARTITION LEGEND

A1.102 2nd FLOOR PLAN A1.105 5th AND 6th FLOOR PLANS A1.107 7th FLOOR AND ROOF PLANS A1.108 8th AND 9tH FLOOR PLANS A1.110 PENTHOUSE AND ROOF PLANS A2.11 EXTERIOR ELEVATIONS A2.12 EXTERIOR ELEVATIONS A2.13 EXTERIOR ELEVATIONS A3.11 BUILDING SECTIONS A3.12 BUILDING SECTIONS

A4.31 ENLARGED GUEST ROOM PLANS AND ELEVATIONS

A3.21 WALL SECTIONS

RESOURCE

NOTE: STRUCTURAL, PLUMBING, MECHANICAL AND ELECTRICAL DRAWINGS HAVE NOT BEEN UPDATED WITH THIS SET AND WILL BE ISSUED AT A FUTURE DATE.

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JULY 11, 2011

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Milwaukee, WI 53202

210225.00

Sheet Title

TITLE SHEET AND SHEET INDEX

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GENERAL AND ARCHITECTURAL DRAWINGS ARCHITECT: KAHLER SLATER 111 W. WISCONSIN AVE. MILWAUKEE, WI 53203

414.272.2000

CIVIL ENGINEERING DRAWINGS CIVIL ENGINEER: THE SIGMA GROUP 1300 WEST CANAL STREET MILWAUKEE, WI 53233

414.643.4200

LANDSCAPE DRAWINGS LANDSCAPE ARCHITECT:

INTERIORS DRAWINGS INTERIOR DESIGN: SIMEONE DEARY DESIGN GROUP

605 N. MICHIGAN AVE.

CHICAGO, IL 60611

312.274.0606

STRUCTURAL DRAWINGS STRUCTURAL ENGINEER: PIERCE ENGINEERS, INC.

241 N. BROADWAY, SUITE 500

MILWAUKEE, WI 53202

414.278.6060

ENGINEER:

PLUMBING DRAWINGS & FIRE PROTECTION DRAWINGS PLUMBING & FIRE PROTECTION T.B.D.

HVAC ENGINEER:

ELECTRICAL DRAWINGS

ELECTRICAL ENGINEER:

T.B.D.

T.B.D.

LIGHTING DRAWINGS

LIGHTING DESIGN:

FOOD SERVICE DRAWINGS FOOD SERVICE DESIGN: THE BOELTER COMPANIES N22W23685 RIDGEVIEW PARKWAY WEST

WAUKESHA, WI 53188


(262) 523-6200

TELECOMMUNICATIONS DRAWINGS **ENGINEER:**

TELECOMMUNICATIONS TBD

AUDIOVISUAL DRAWINGS AUDIOVISUAL DESIGN



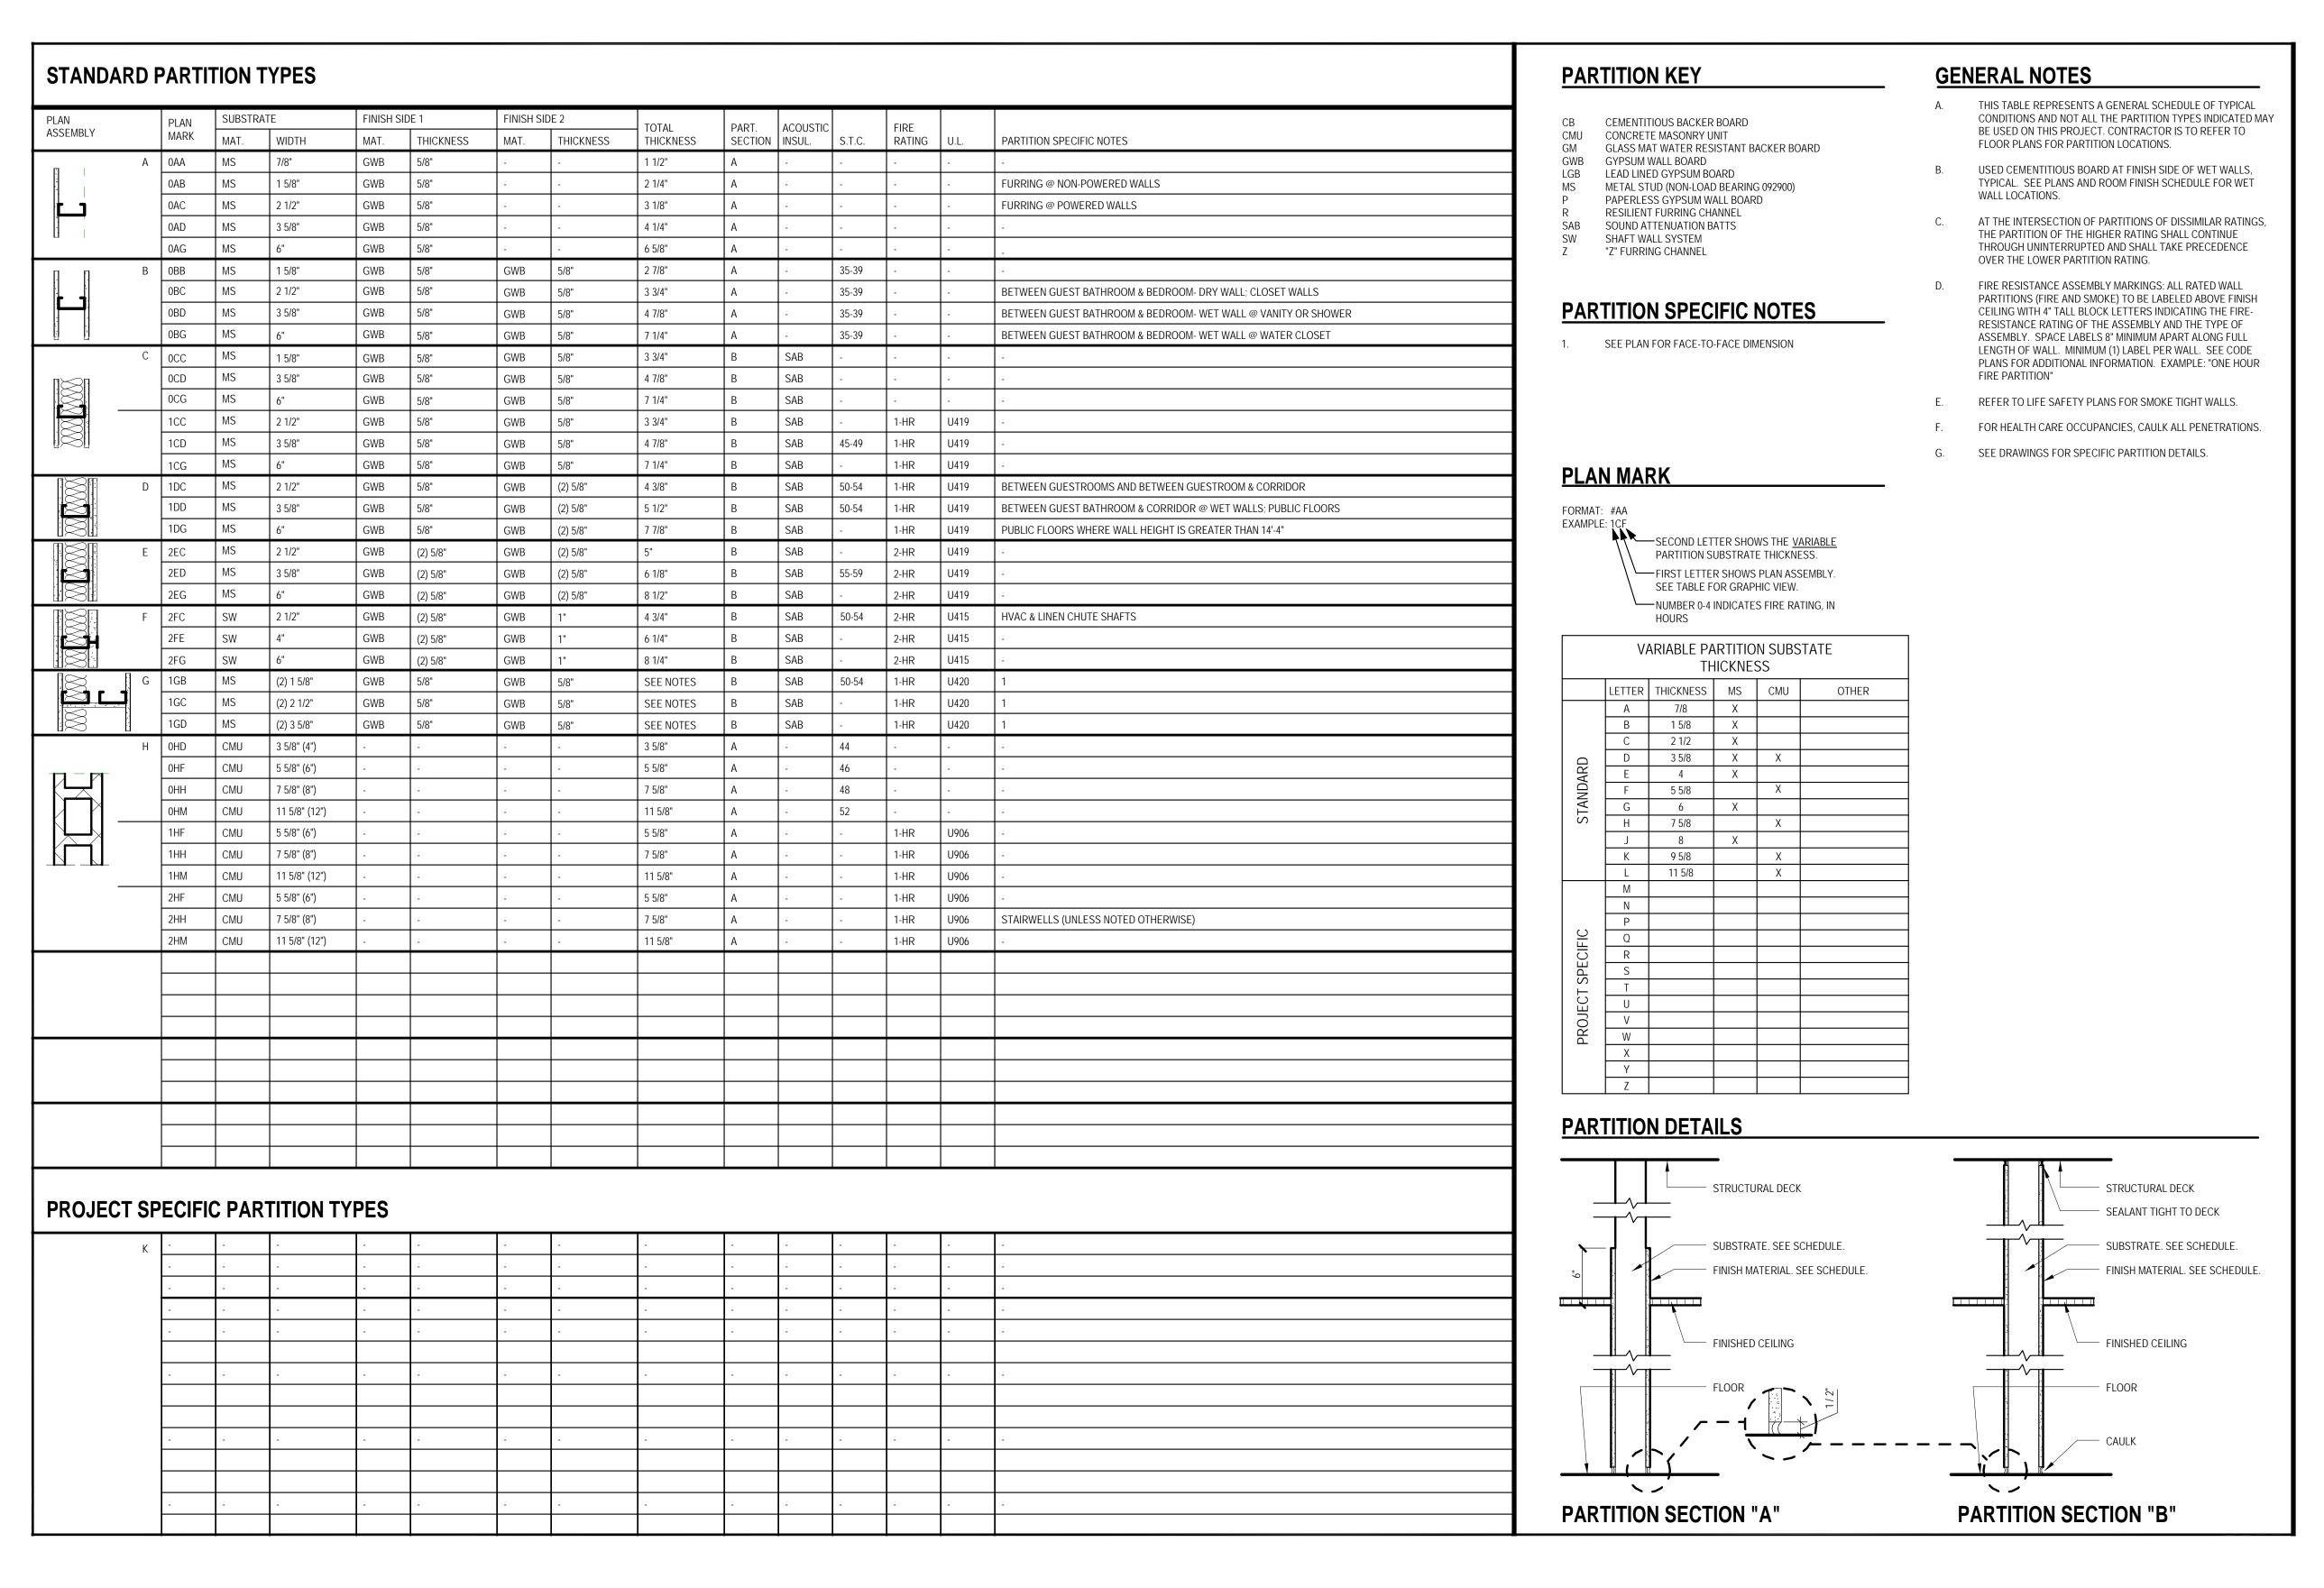

SYMBOL IDENTIFICATION					
SYMBOL NAME	SYMBOL MARK	NOTES	SYMBOL NAME SYMBOL MARK	NOTES	
DETAIL REFERENCE	1 A1-01	DRAWING NUMBER SHEET NUMBER	NEW STRUCURAL GRID-LINE REFERENCE	GRID-LINE NUMBER OR LETTER	
DETAIL MANUAL REFERENCE	21-101	—— DETAIL MANUAL SHEET NUMBER	EXISTING STRUCURAL GRID LINE REFERENCE	EXISTING GRID-LINE NUMBER OR LETTER	
SECTION REFERENCE	A1-01		ELEVATION REFERENC E 21 A1-01 22	—— SHEET NUMBER —— DRAWING NUMBER	
FLOOR PLAN KEY NOTE REFERENCE	1) -		REVISION REFERENCE ADD.		
DEMOLITION PLAN KEY NOTE REFERENCE	(1)	—— DEMOLITION PLAN KEY NOTE NUMBER	REVISION CLOUD	REVISION CLOUD	
ROOM REFERENCE	OFFICE 0102		FLOOR PLAN ELEVATION TARGET		
DOOR REFERENCE	0102A	—— DOOR NUMBER	BUILDING SECTION ELEVATION TARGET T.O. PRECAST CONC. PARAPET EL. +100'-0"	—— REMARK LINE 1 —— REMARK LINE 2 —— TARGET ELEVATION	
PARTITION TYPE REFERENCE	1A -	PARTITION NUMBER	FLOOR FINISH MATERIAL REFERENCE		
REFLECTED CEILING PLA KEY NOTE REFERENCE	NN (1) -	REFLECTED CEILING PLAN KEY NOTE NUMBER			
CEILING HEIGHT REFERENCE	8'-0"	—— CEILING HEIGHT			

MATERIAL IDENTIFICATION						
ACOUSTIC TILE	CONCRETE (CAST-IN-PLACE)	PLYWOOD	TILE			
ALUMINUM	CONCRETE (PRE-CAST)	RIGID INSULATION	WOOD			
BRICK	EARTH	SEMI-RIGID INSULATION				
СМИ	GRAVEL, BACKFILL	SPRAY-ON FIREPROOFING				
CMU (SOLID-FILLED)	MORTAR. MUDSET	STEEL				

Revisions

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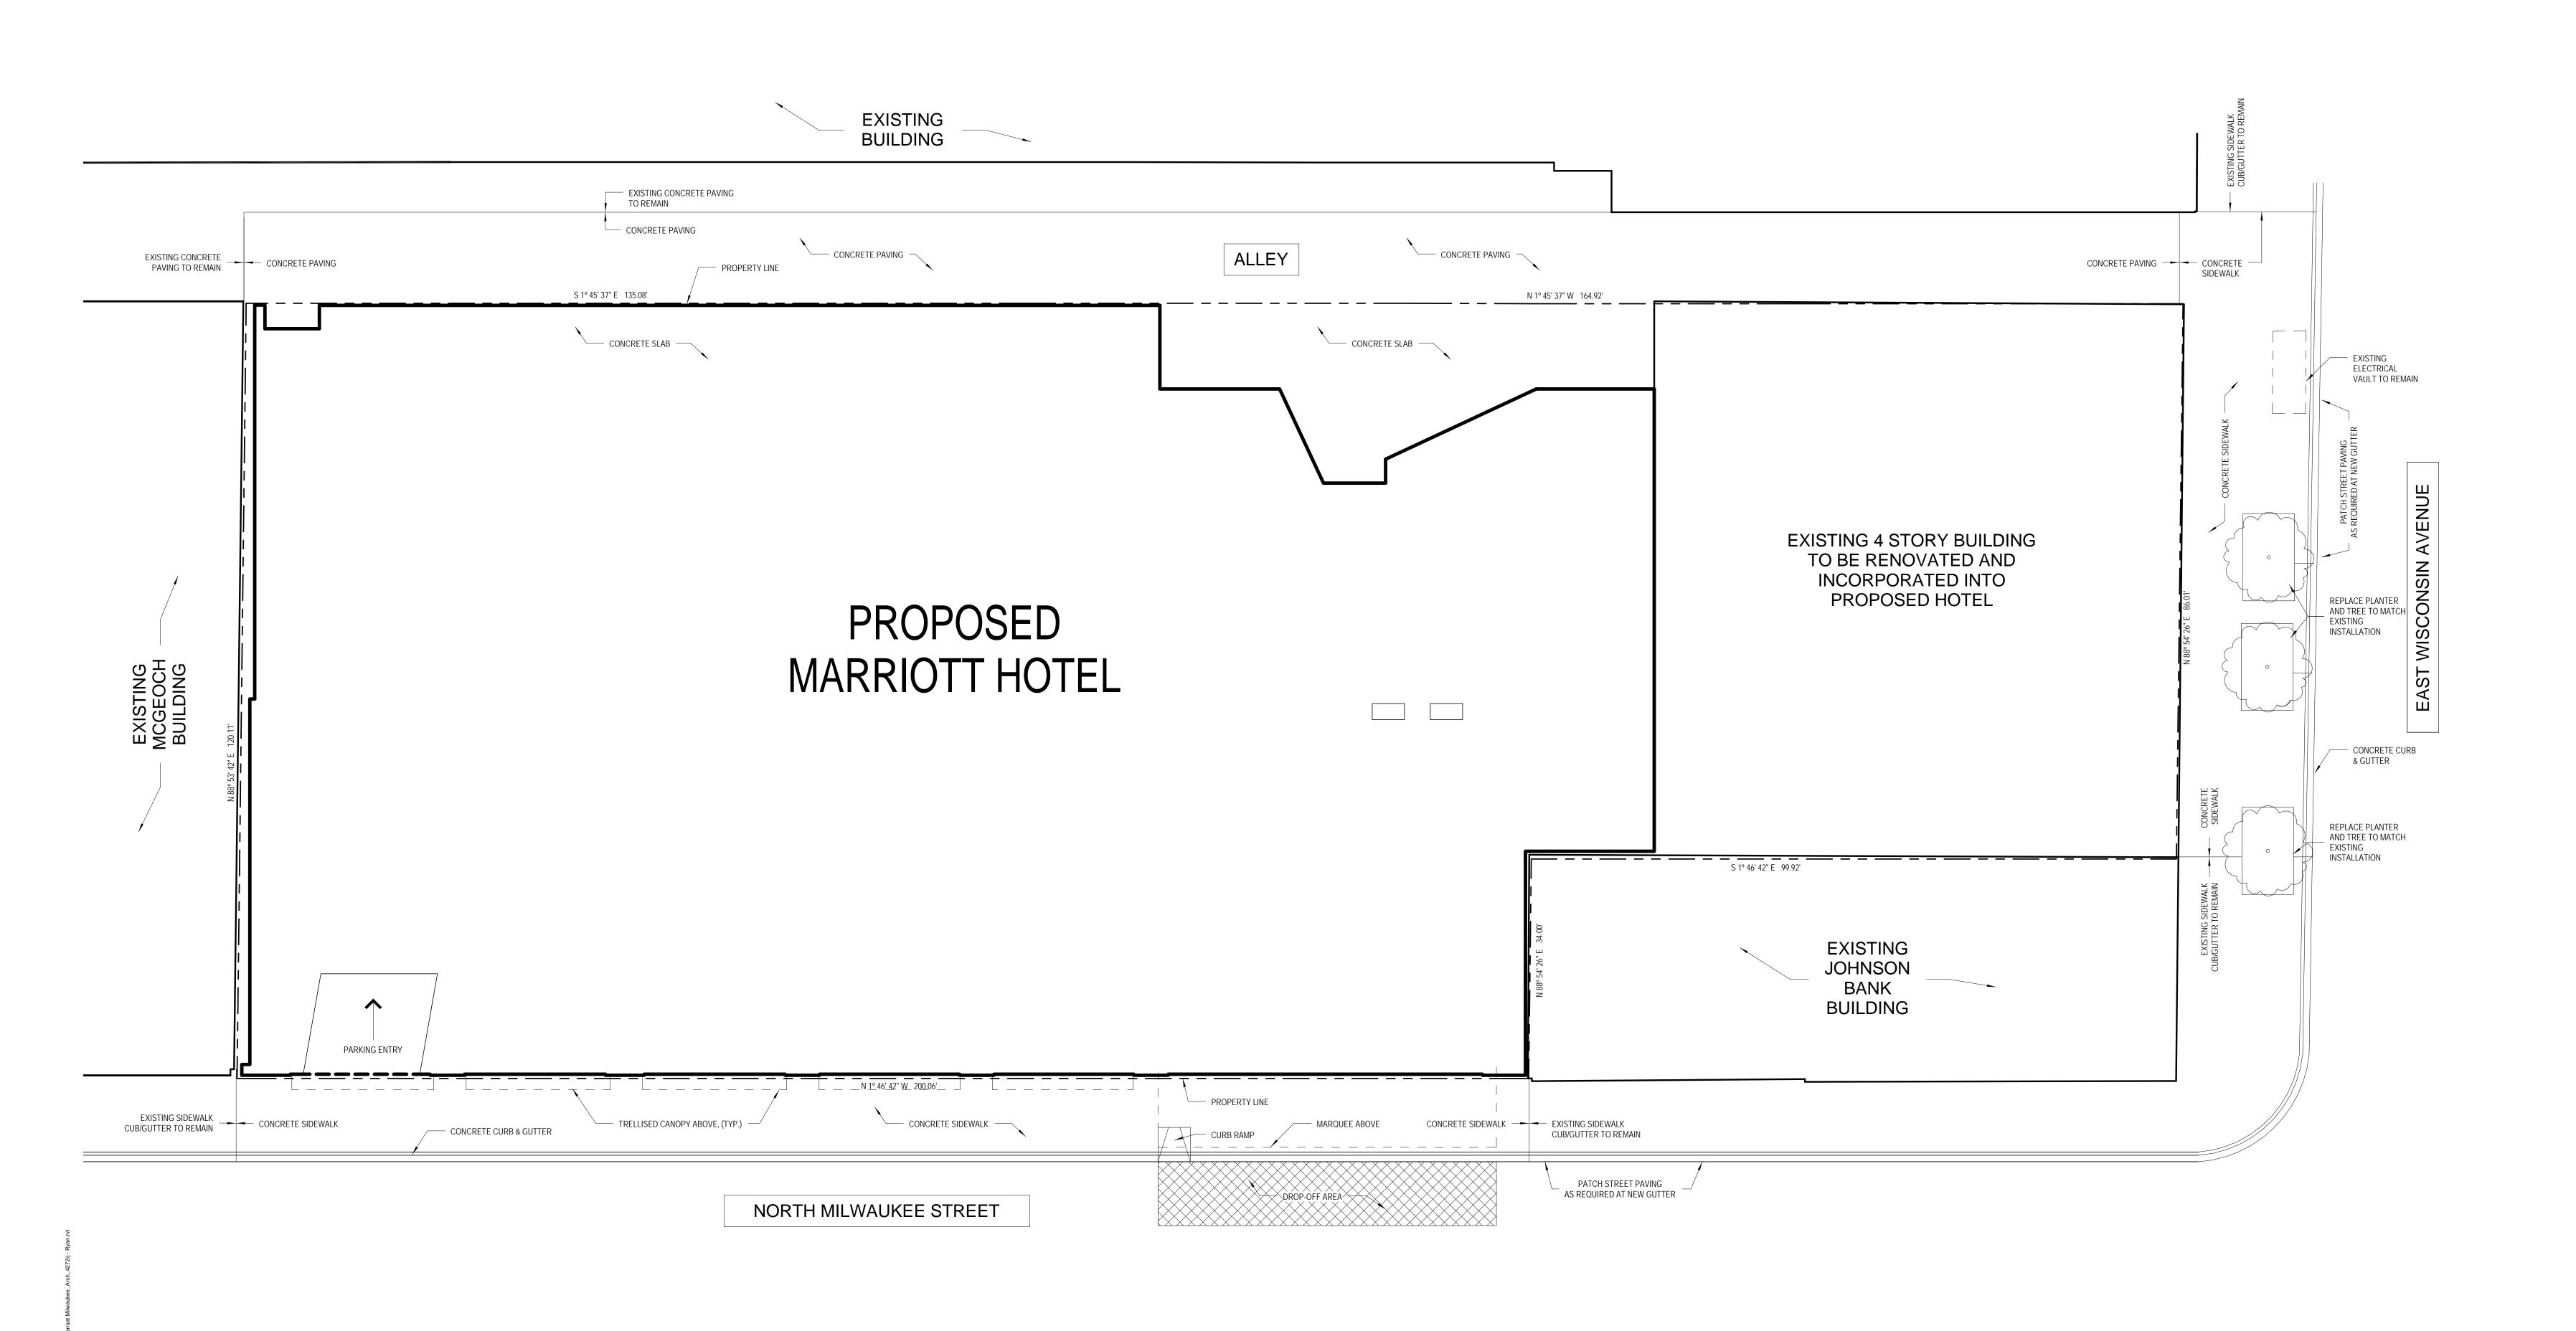
PARTITION LEGEND

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Drawing Date
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MARRIOTT MILWAUKEE HOTEL

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ARCHITECTURAL SITE PLAN

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Sheet No.
AS1.10

1 4

1 ARCHITECTURAL SITE PLAN
3/32" = 1'-0"

1. BUILDING SHALL BE CONSTRUCTED TO MEET THE REQUIREMENTS AND QUALITY LEVEL DESCRIBED IN THE MARRIOTT FULL SERVICE HOTEL DESIGN STANDARDS, DATED JANUARY 2011. PROVIDE APPROPRIATE MATERIALS AND LEVELS OF WORKMANSHIP TO MEET THIS STANDARD.

2. VERIFY DIMENSIONS, CONDITIONS AND FINISHES BEFORE PRICING AND/OR PROCEEDING WITH WORK. DO NOT SCALE FROM DRAWINGS. BRING ANY DISCREPANCIES TO THE ARCHITECT'S ATTENTION IMMEDIATELY.

3. COORDINATE LOCATIONS AND QUANTITY OF WORK WITH MECHANICAL, ELECTRICAL AND PLUMBING CONTRACTORS. 4. PIPING, CONDUIT AND RELATED MECHANICAL AND ELECTRICAL ITEMS

SHALL BE CONCEALED WITHIN GYPSUM BOARD FURRING IN FINISHED AREAS WHETHER SHOWN ON THE DRAWINGS OR NOT, UNLESS NOTED OTHERWISE. 5. REFER TO PARTITION SCHEDULE ON G0.60 FOR TYPICAL PARTITION

1/2-HOUR RATING. WALLS BETWEEN ADJACENT GUESTROOMS TO HAVE 1-HOUR RATING. 6. PROVIDE METAL PLATE BACKING AND/OR WOOD BLOCKING IN WALLS WHERE WALL-MOUNTED EQUIPMENT OR ARTWORK IS SHOWN ON PLANS

OR ELEVATIONS. VERIFY HEIGHT AND LENGTH WITH ACTUAL EQUIPMENT

TYPES. STAIR, ELEVATOR, MECHANICAL AND OTHER SHAFT WALLS TO HAVE 2-HOUR RATING. GUESTROOM FLOOR CORRIDOR WALLS TO HAVE

7. REMOVE CONSTRUCTION DEBRIS FROM THE CONSTRUCTION SITE DAILY AND PLACE IN THE APPROPRIATE REFUSE CONTAINER. WORK AREA SHALL BE KEPT CLEAN, FREE OF DUST, DIRT AND DEBRIS.

BUILDING ASSEMBLIES AND COMPONENTS

ROOF ASSEMBLY 1: FULLY ADHERED 60 MIL. NON-REINFORCED EPDM MEMBRANE POLYISOCYANURATE INSULATION W/SADDLES (R-20 AVG). PROVIDE TAPERED INSULATION AS INDICATED ON ROOF PLAN BITUMINOUS VAPOR RETARDER CONCRETE SLAB

ROOF ASSEMBLY 2: DECORATIVE BALLAST

OR ARTWORK.


2" THICK CONCRETE ROOF PAVERS AT PERIMETER OF ROOF AND SERVICE WALKS LOOSE LAID 60 MIL. NON-REINFORCED EPDM MEMBRANE POLYISOCYANURATE INSULATION W/SADDLES (R-20 AVG). PROVIDE TAPERED INSULATION AS INDICATED ON ROOF PLAN BITUMINOUS VAPOR RETARDER 5/8" GYPSUM SHEATHING (DENSDECK) METAL ROOF DECK

ROOF ASSEMBLY 3: DECORATIVE BALLAST

2" THICK CONCRETE ROOF PAVERS AT PERIMETER OF ROOF AND SERVICE WALKS LOOSE LAID 60 MIL. NON-REINFORCED EPDM MEMBRANE POLYISOCYANURATE INSULATION W/SADDLES (R-20 AVG). PROVIDE TAPERED INSULATION AS INDICATED ON ROOF PLAN BITUMINOUS VAPOR RETARDER **EXISTING WOOD DECK & STRUCTURE**

ROOF ASSEMBLY 4: FULLY ADHERED 60 MIL. NON-REINFORCED EPDM MEMBRANE POLYISOCYANURATE INSULATION W/SADDLES (R-20- AVG). PROVIDE TAPERED INSULATION AS INDICATED ON ROOF PLAN BITUMINOUS VAPOR RETARDER EXISTING WOOD DECK AND STRUCTURE

ROOF ASSEMBLY 5: KYNAR FINISHED ARCHITECTURAL STANDING SEAM METAL ROOFING (12" NO. 30 FELT UNDERLAYMENT NAILBASE INSULATION, 3/4" EXTERIOR PLYWOOD FACING, R-25 MIN. 5/8" GYPSUM SHEATHING (DENSDECK)

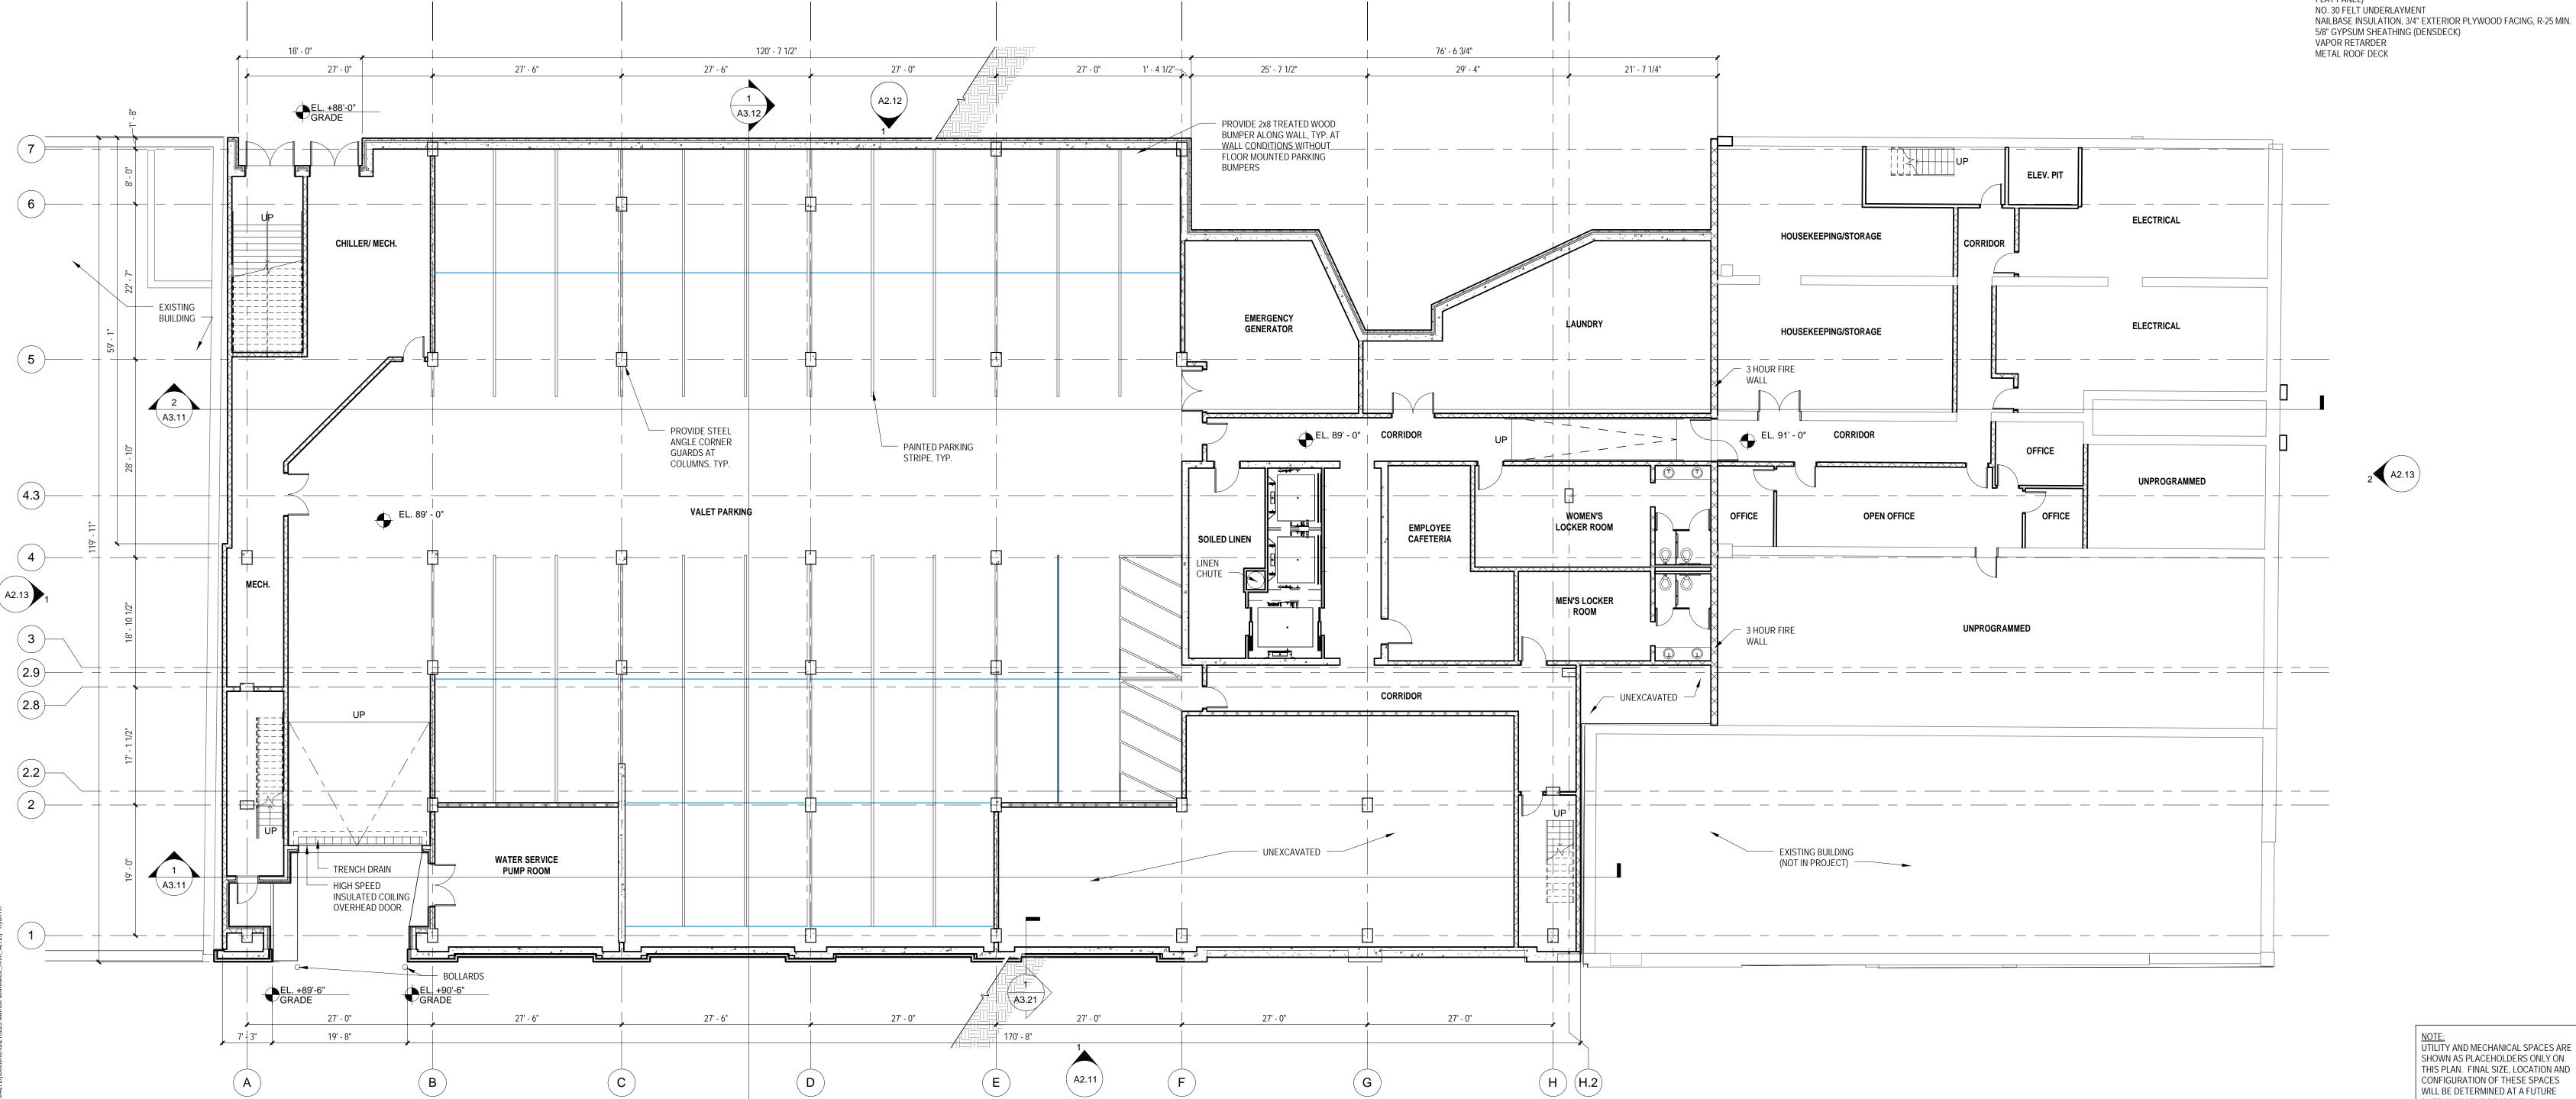

LOWER LEVEL FLOOR PLAN

SCHEMATIC DESIGN II

JULY 11, 2011

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LOWER LEVEL FLOOR PLAN

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A1.1LL

WILL BE DETERMINED AT A FUTURE DATE WHEN THE RESPECTIVE

CONSULTANTS JOIN THE PROJECT



BUILDING SHALL BE CONSTRUCTED TO MEET THE REQUIREMENTS AND QUALITY LEVEL DESCRIBED IN THE MARRIOTT FULL SERVICE HOTEL DESIGN STANDARDS, DATED JANUARY 2011. PROVIDE APPROPRIATE MATERIALS AND LEVELS OF WORKMANSHIP TO MEET THIS STANDARD.
 VERIFY DIMENSIONS, CONDITIONS AND FINISHES BEFORE PRICING AND/OR PROCEEDING WITH WORK. DO NOT SCALE FROM DRAWINGS. BRING ANY DISCREPANCIES TO THE ARCHITECT'S ATTENTION IMMEDIATELY.
 COORDINATE LOCATIONS AND QUANTITY OF WORK WITH MECHANICAL, ELECTRICAL AND PLUMBING CONTRACTORS.

4. PIPING, CONDUIT AND RELATED MECHANICAL AND ELECTRICAL ITEMS SHALL BE CONCEALED WITHIN GYPSUM BOARD FURRING IN FINISHED AREAS WHETHER SHOWN ON THE DRAWINGS OR NOT, UNLESS NOTED OTHERWISE.

5. REFER TO PARTITION SCHEDULE ON G0.60 FOR TYPICAL PARTITION TYPES. STAIR, ELEVATOR, MECHANICAL AND OTHER SHAFT WALLS TO HAVE 2-HOUR RATING. GUESTROOM FLOOR CORRIDOR WALLS TO HAVE 1/2-HOUR RATING. WALLS BETWEEN ADJACENT GUESTROOMS TO HAVE 1-HOUR RATING.

6. PROVIDE METAL PLATE BACKING AND/OR WOOD BLOCKING IN WALLS WHERE WALL-MOUNTED EQUIPMENT OR ARTWORK IS SHOWN ON PLANS OR ELEVATIONS. VERIFY HEIGHT AND LENGTH WITH ACTUAL EQUIPMENT OR ARTWORK.

7. REMOVE CONSTRUCTION DEBRIS FROM THE CONSTRUCTION SITE DAILY AND PLACE IN THE APPROPRIATE REFUSE CONTAINER. WORK AREA SHALL BE KEPT CLEAN, FREE OF DUST, DIRT AND DEBRIS.

BUILDING ASSEMBLIES AND COMPONENTS

ROOF ASSEMBLY 1:
FULLY ADHERED 60 MIL. NON-REINFORCED EPDM MEMBRANE
POLYISOCYANURATE INSULATION W/SADDLES (R-20 AVG).
PROVIDE TAPERED INSULATION AS INDICATED ON ROOF PLAN
BITUMINOUS VAPOR RETARDER
CONCRETE SLAB

ROOF ASSEMBLY 2: DECORATIVE BALLAST


2" THICK CONCRETE ROOF PAVERS AT PERIMETER OF ROOF AND SERVICE WALKS
LOOSE LAID 60 MIL. NON-REINFORCED EPDM MEMBRANE
POLYISOCYANURATE INSULATION W/SADDLES (R-20 AVG).
PROVIDE TAPERED INSULATION AS INDICATED ON ROOF PLAN
BITUMINOUS VAPOR RETARDER
5/8" GYPSUM SHEATHING (DENSDECK)
METAL ROOF DECK

ROOF ASSEMBLY 3: DECORATIVE BALLAST

2" THICK CONCRETE ROOF PAVERS AT PERIMETER OF ROOF AND SERVICE WALKS
LOOSE LAID 60 MIL. NON-REINFORCED EPDM MEMBRANE
POLYISOCYANURATE INSULATION W/SADDLES (R-20 AVG).
PROVIDE TAPERED INSULATION AS INDICATED ON ROOF PLAN
BITUMINOUS VAPOR RETARDER
EXISTING WOOD DECK & STRUCTURE

ROOF ASSEMBLY 4:
FULLY ADHERED 60 MIL. NON-REINFORCED EPDM MEMBRANE
POLYISOCYANURATE INSULATION W/SADDLES (R-20- AVG).
PROVIDE TAPERED INSULATION AS INDICATED ON ROOF PLAN
BITUMINOUS VAPOR RETARDER
EXISTING WOOD DECK AND STRUCTURE

ROOF ASSEMBLY 5:
KYNAR FINISHED ARCHITECTURAL STANDING SEAM METAL ROOFING (12" FLAT PANEL)
NO. 30 FELT UNDERLAYMENT
NAILBASE INSULATION, 3/4" EXTERIOR PLYWOOD FACING, R-25 MIN.
5/8" GYPSUM SHEATHING (DENSDECK)
VAPOR RETARDER
METAL ROOF DECK

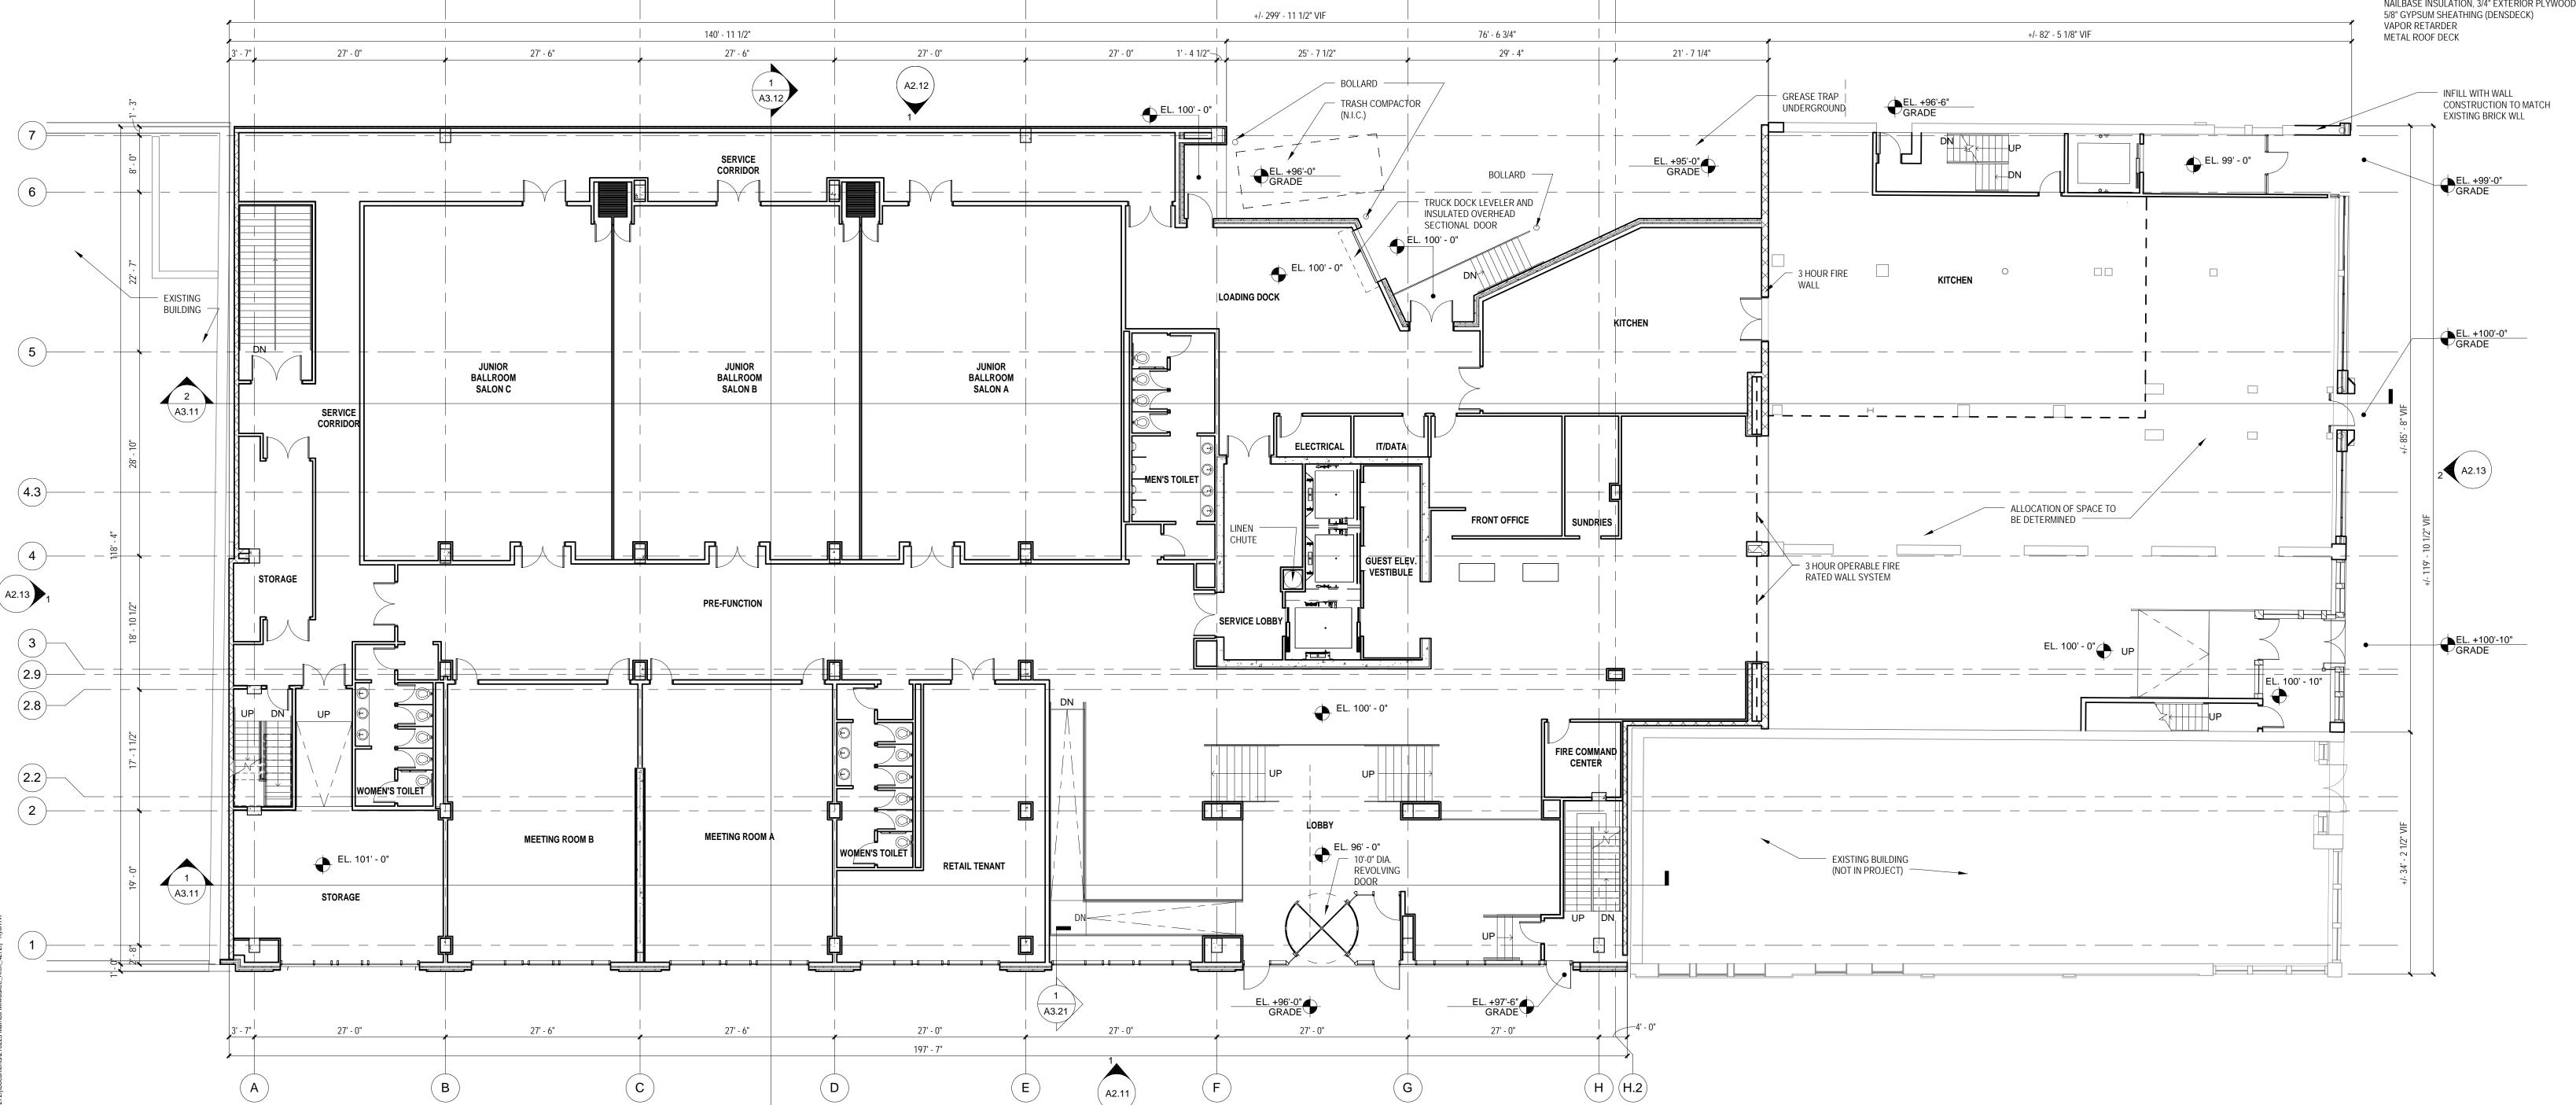

1st FLOOR PLAN

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SCHEMATIC DESIGN II

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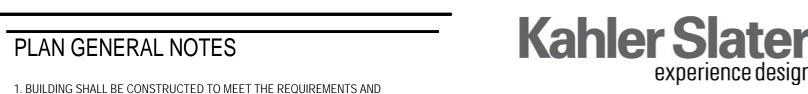
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1st FLOOR PLAN

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QUALITY LEVEL DESCRIBED IN THE MARRIOTT FULL SERVICE HOTEL DESIGN STANDARDS, DATED JANUARY 2011. PROVIDE APPROPRIATE MATERIALS AND LEVELS OF WORKMANSHIP TO MEET THIS STANDARD. 2. VERIFY DIMENSIONS, CONDITIONS AND FINISHES BEFORE PRICING AND/OR PROCEEDING WITH WORK. DO NOT SCALE FROM DRAWINGS. BRING ANY DISCREPANCIES TO THE ARCHITECT'S ATTENTION IMMEDIATELY. 3. COORDINATE LOCATIONS AND QUANTITY OF WORK WITH MECHANICAL, ELECTRICAL AND PLUMBING CONTRACTORS.

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TYPES. STAIR, ELEVATOR, MECHANICAL AND OTHER SHAFT WALLS TO HAVE 2-HOUR RATING. GUESTROOM FLOOR CORRIDOR WALLS TO HAVE 1/2-HOUR RATING. WALLS BETWEEN ADJACENT GUESTROOMS TO HAVE 1-HOUR RATING.

5. REFER TO PARTITION SCHEDULE ON G0.60 FOR TYPICAL PARTITION

6. PROVIDE METAL PLATE BACKING AND/OR WOOD BLOCKING IN WALLS WHERE WALL-MOUNTED EQUIPMENT OR ARTWORK IS SHOWN ON PLANS OR ELEVATIONS. VERIFY HEIGHT AND LENGTH WITH ACTUAL EQUIPMENT OR ARTWORK.

7. REMOVE CONSTRUCTION DEBRIS FROM THE CONSTRUCTION SITE DAILY AND PLACE IN THE APPROPRIATE REFUSE CONTAINER. WORK AREA SHALL BE KEPT CLEAN, FREE OF DUST, DIRT AND DEBRIS.

BUILDING ASSEMBLIES AND COMPONENTS

ROOF ASSEMBLY 1: FULLY ADHERED 60 MIL. NON-REINFORCED EPDM MEMBRANE POLYISOCYANURATE INSULATION W/SADDLES (R-20 AVG). PROVIDE TAPERED INSULATION AS INDICATED ON ROOF PLAN BITUMINOUS VAPOR RETARDER CONCRETE SLAB

ROOF ASSEMBLY 2: DECORATIVE BALLAST

2" THICK CONCRETE ROOF PAVERS AT PERIMETER OF ROOF AND SERVICE WALKS LOOSE LAID 60 MIL. NON-REINFORCED EPDM MEMBRANE POLYISOCYANURATE INSULATION W/SADDLES (R-20 AVG). PROVIDE TAPERED INSULATION AS INDICATED ON ROOF PLAN BITUMINOUS VAPOR RETARDER 5/8" GYPSUM SHEATHING (DENSDECK) METAL ROOF DECK


ROOF ASSEMBLY 3: DECORATIVE BALLAST

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ROOF ASSEMBLY 4: FULLY ADHERED 60 MIL. NON-REINFORCED EPDM MEMBRANE POLYISOCYANURATE INSULATION W/SADDLES (R-20- AVG). PROVIDE TAPERED INSULATION AS INDICATED ON ROOF PLAN BITUMINOUS VAPOR RETARDER EXISTING WOOD DECK AND STRUCTURE

ROOF ASSEMBLY 5: KYNAR FINISHED ARCHITECTURAL STANDING SEAM METAL ROOFING (12"

NAILBASE INSULATION, 3/4" EXTERIOR PLYWOOD FACING, R-25 MIN. 5/8" GYPSUM SHEATHING (DENSDECK)

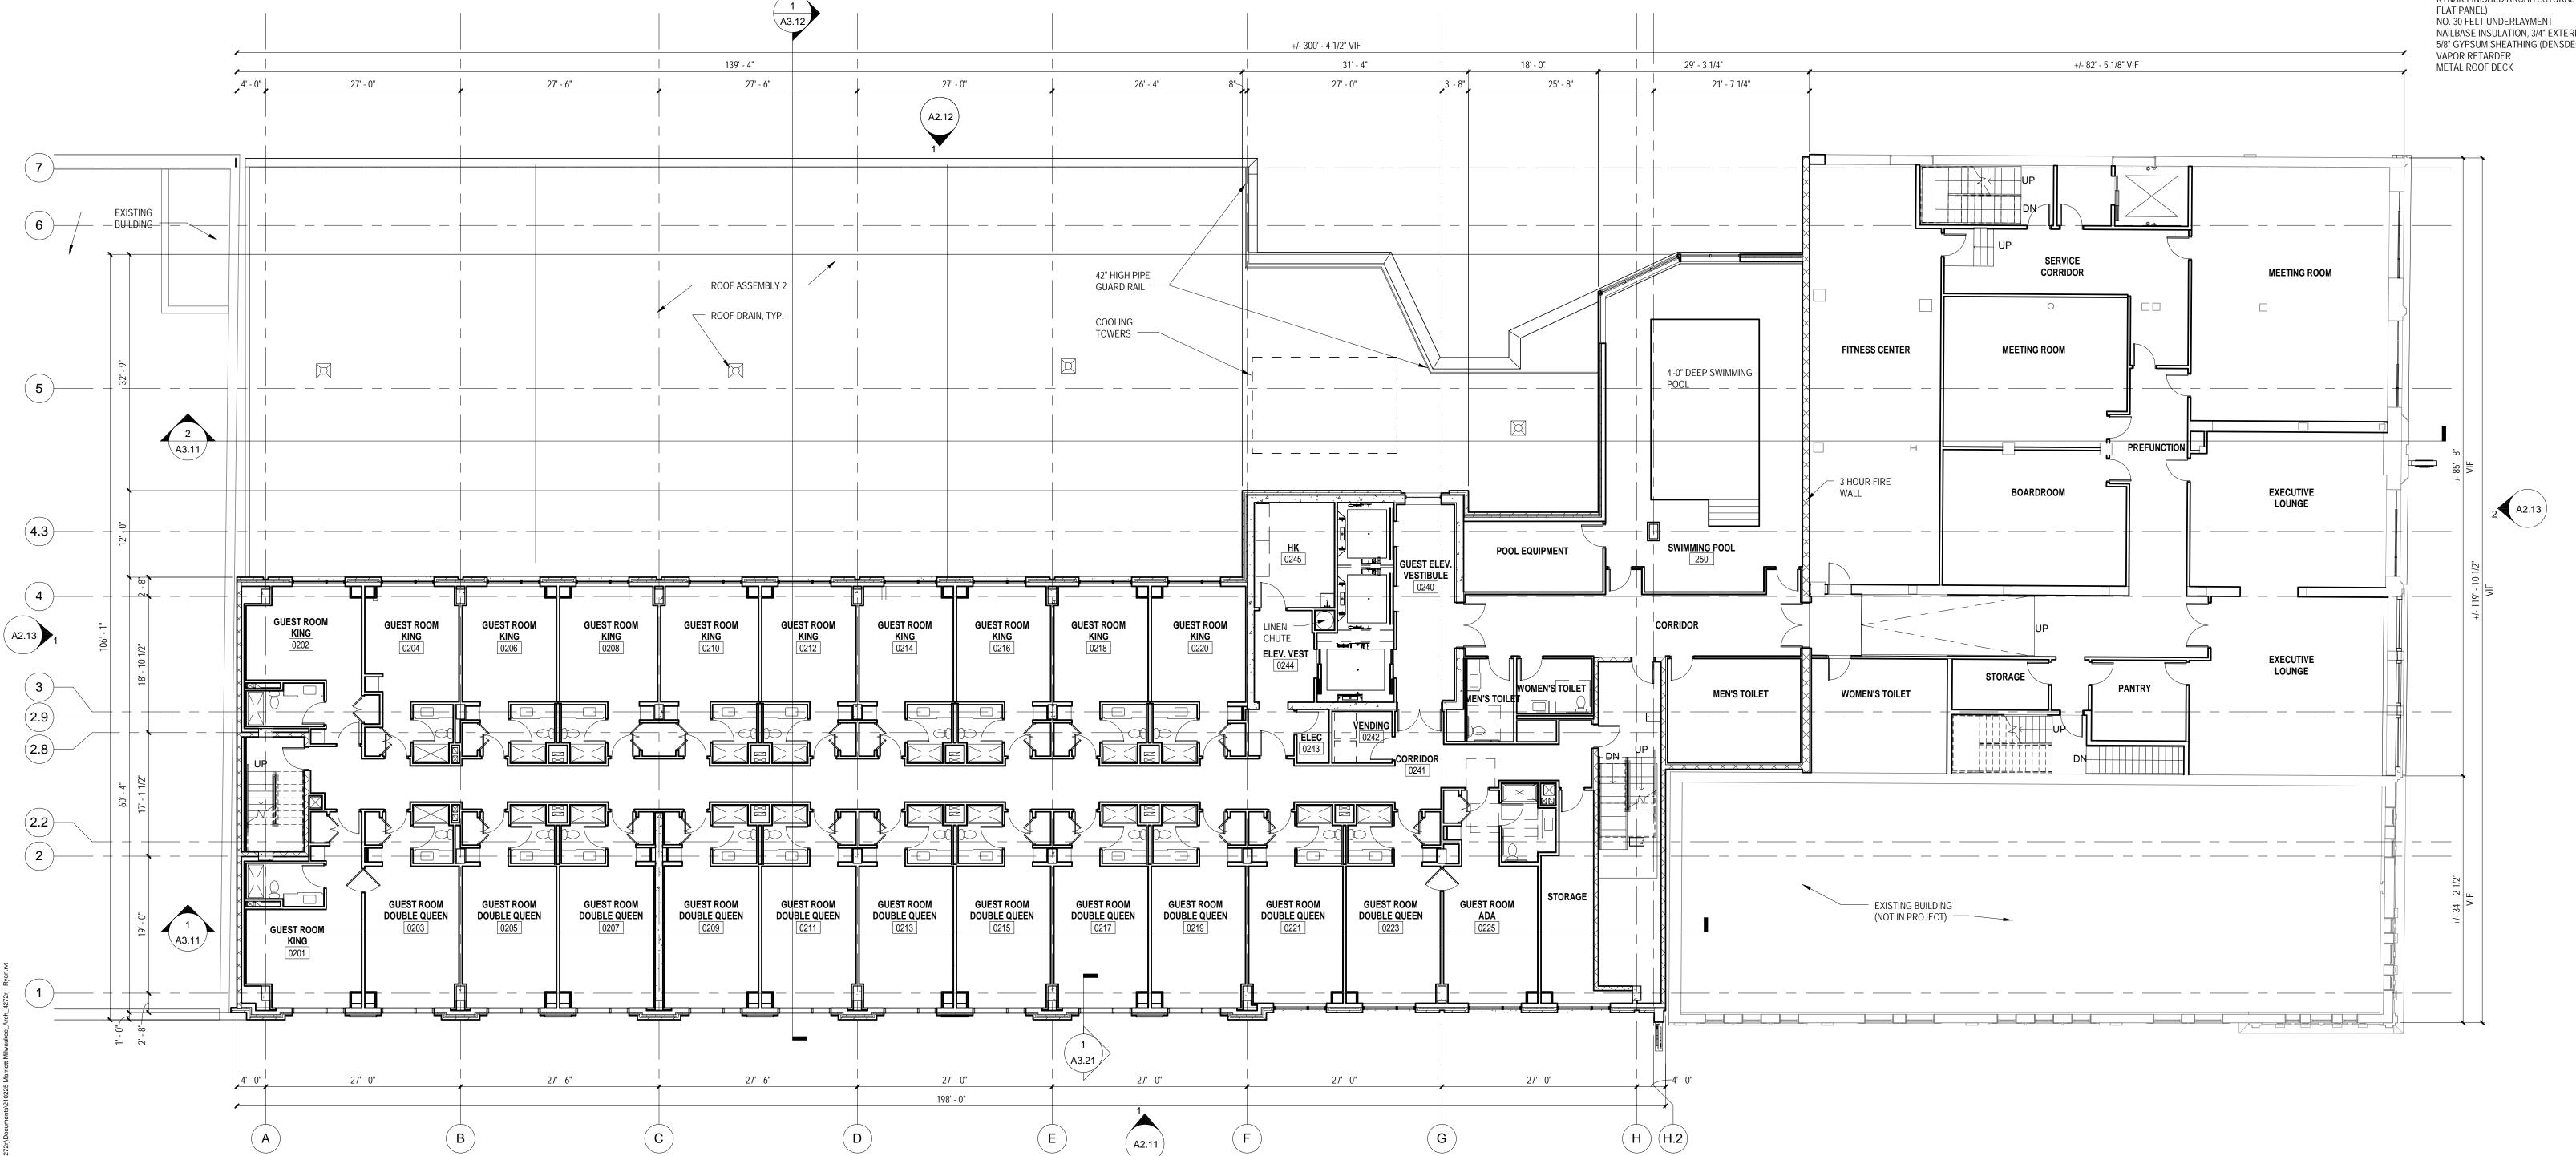

2nd FLOOR PLAN

SCHEMATIC DESIGN II

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1. BUILDING SHALL BE CONSTRUCTED TO MEET THE REQUIREMENTS AND QUALITY LEVEL DESCRIBED IN THE MARRIOTT FULL SERVICE HOTEL DESIGN STANDARDS, DATED JANUARY 2011. PROVIDE APPROPRIATE MATERIALS AND LEVELS OF WORKMANSHIP TO MEET THIS STANDARD. 2. VERIFY DIMENSIONS, CONDITIONS AND FINISHES BEFORE PRICING AND/OR PROCEEDING WITH WORK. DO NOT SCALE FROM DRAWINGS. BRING ANY DISCREPANCIES TO THE ARCHITECT'S ATTENTION IMMEDIATELY.

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BUILDING ASSEMBLIES AND COMPONENTS

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ROOF ASSEMBLY 2: DECORATIVE BALLAST

OTHERWISE.

2" THICK CONCRETE ROOF PAVERS AT PERIMETER OF ROOF AND SERVICE WALKS LOOSE LAID 60 MIL. NON-REINFORCED EPDM MEMBRANE POLYISOCYANURATE INSULATION W/SADDLES (R-20 AVG). PROVIDE TAPERED INSULATION AS INDICATED ON ROOF PLAN BITUMINOUS VAPOR RETARDER 5/8" GYPSUM SHEATHING (DENSDECK) METAL ROOF DECK


ROOF ASSEMBLY 3: DECORATIVE BALLAST

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ROOF ASSEMBLY 5: KYNAR FINISHED ARCHITECTURAL STANDING SEAM METAL ROOFING (12"

NAILBASE INSULATION, 3/4" EXTERIOR PLYWOOD FACING, R-25 MIN. 5/8" GYPSUM SHEATHING (DENSDECK)



3rd FLOOR PLAN
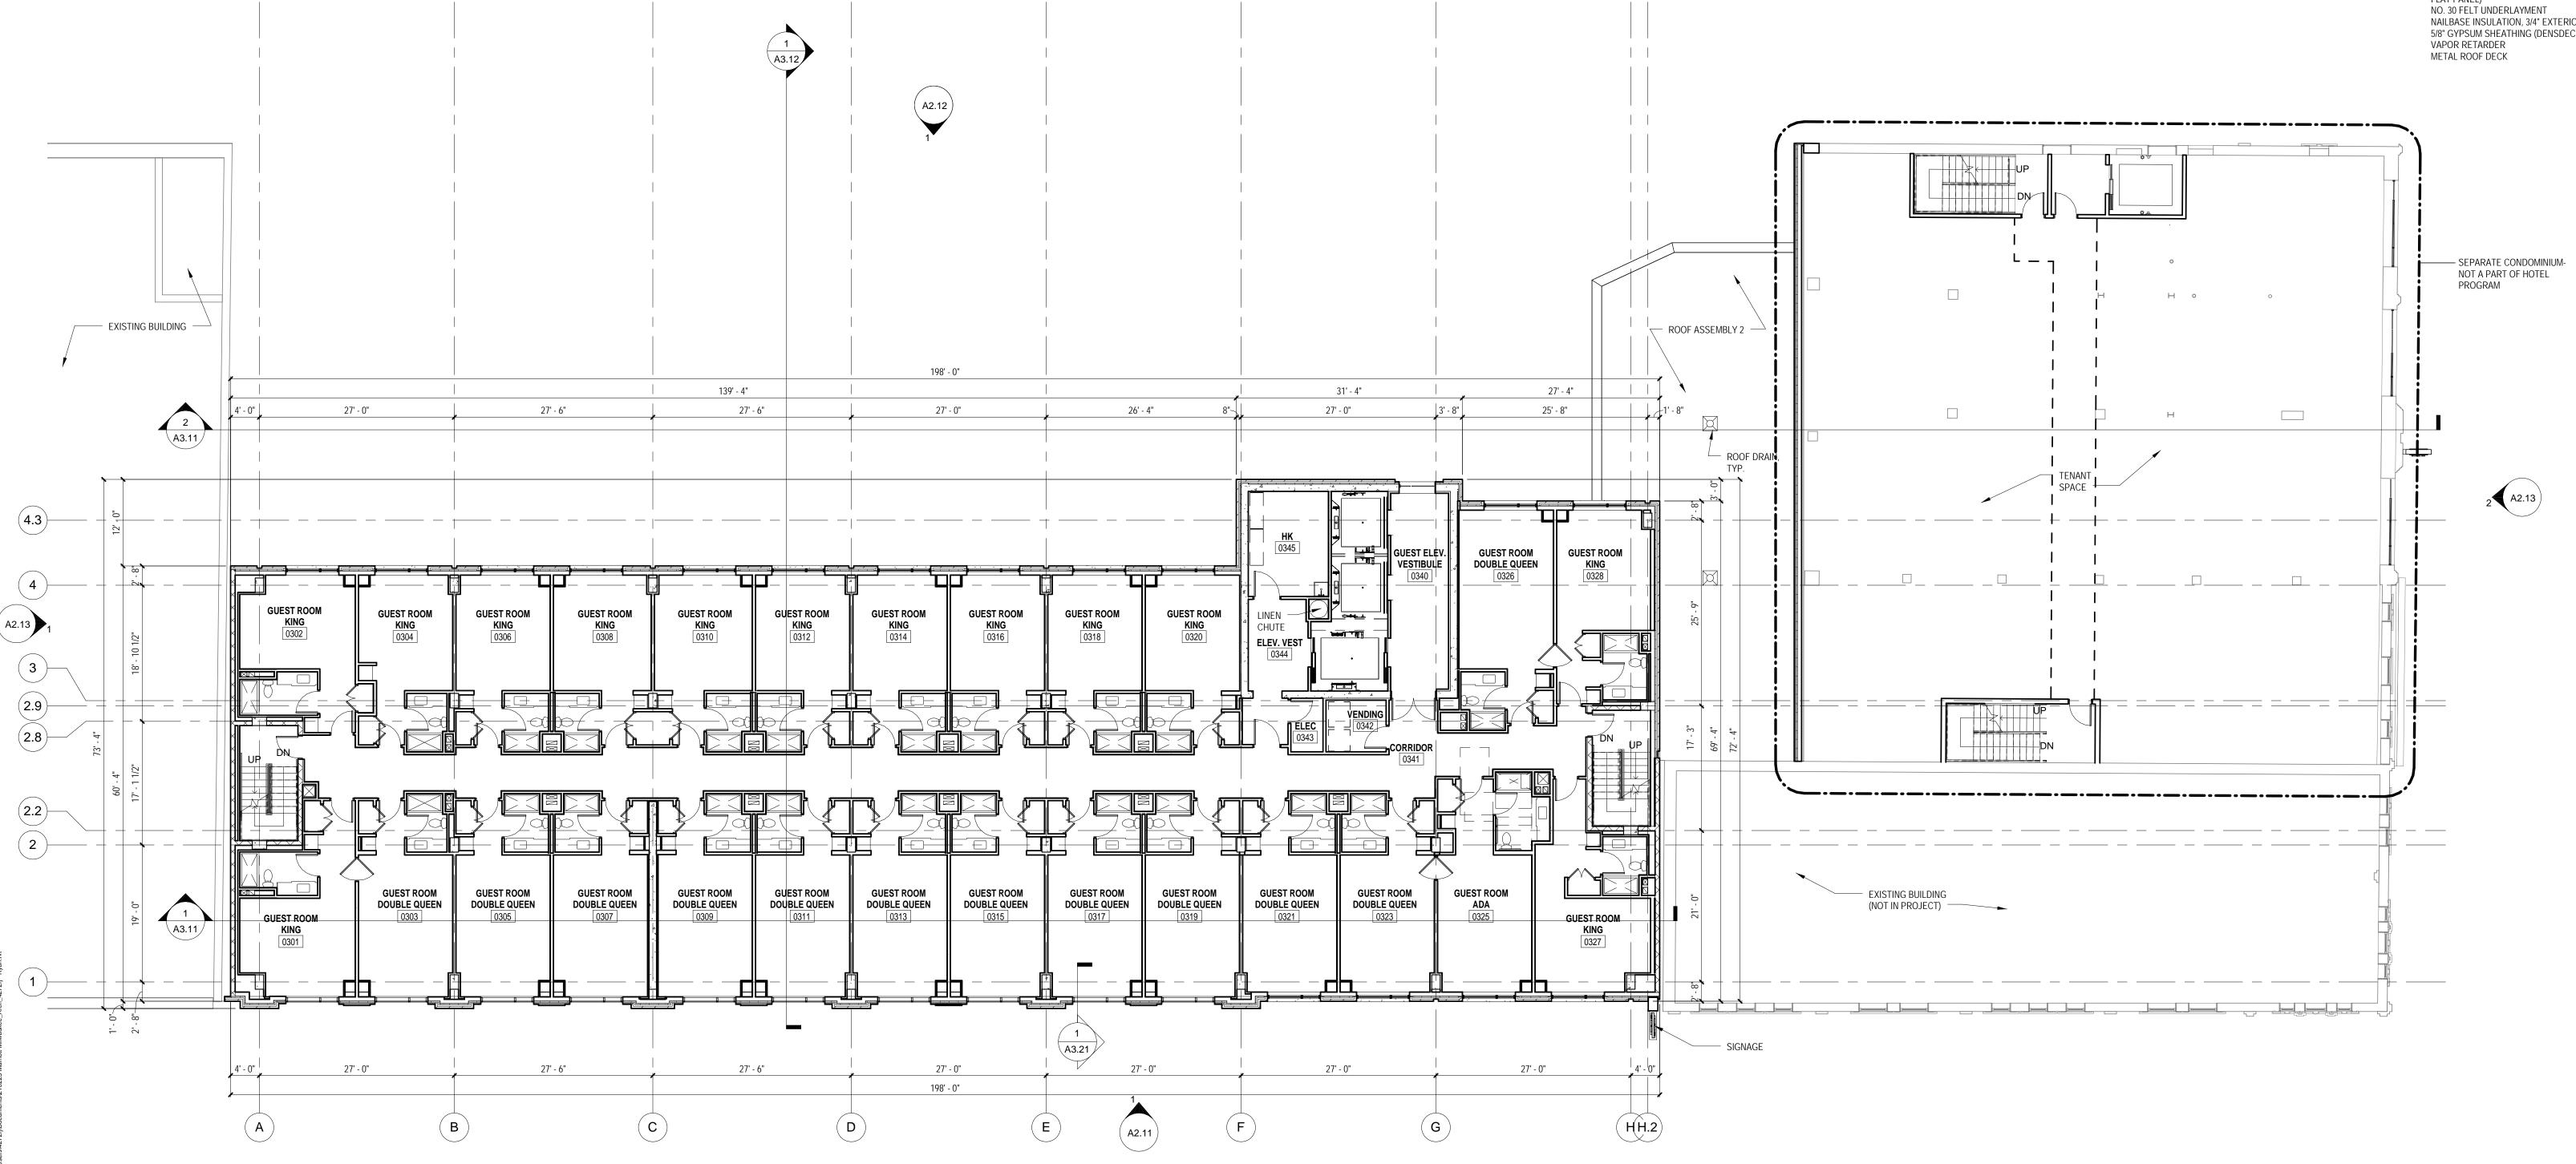
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3rd FLOOR PLAN

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HAVE 2-HOUR RATING. GUESTROOM FLOOR CORRIDOR WALLS TO HAVE 1/2-HOUR RATING. WALLS BETWEEN ADJACENT GUESTROOMS TO HAVE 1-HOUR RATING. 6. PROVIDE METAL PLATE BACKING AND/OR WOOD BLOCKING IN WALLS

5. REFER TO PARTITION SCHEDULE ON G0.60 FOR TYPICAL PARTITION TYPES. STAIR, ELEVATOR, MECHANICAL AND OTHER SHAFT WALLS TO

WHERE WALL-MOUNTED EQUIPMENT OR ARTWORK IS SHOWN ON PLANS OR ELEVATIONS. VERIFY HEIGHT AND LENGTH WITH ACTUAL EQUIPMENT OR ARTWORK.

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ROOF ASSEMBLY 2: DECORATIVE BALLAST


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ROOF ASSEMBLY 3: DECORATIVE BALLAST

2" THICK CONCRETE ROOF PAVERS AT PERIMETER OF ROOF AND SERVICE WALKS LOOSE LAID 60 MIL. NON-REINFORCED EPDM MEMBRANE POLYISOCYANURATE INSULATION W/SADDLES (R-20 AVG). PROVIDE TAPERED INSULATION AS INDICATED ON ROOF PLAN BITUMINOUS VAPOR RETARDER **EXISTING WOOD DECK & STRUCTURE**

ROOF ASSEMBLY 4: FULLY ADHERED 60 MIL. NON-REINFORCED EPDM MEMBRANE POLYISOCYANURATE INSULATION W/SADDLES (R-20- AVG). PROVIDE TAPERED INSULATION AS INDICATED ON ROOF PLAN BITUMINOUS VAPOR RETARDER EXISTING WOOD DECK AND STRUCTURE

ROOF ASSEMBLY 5: KYNAR FINISHED ARCHITECTURAL STANDING SEAM METAL ROOFING (12" NO. 30 FELT UNDERLAYMENT NAILBASE INSULATION, 3/4" EXTERIOR PLYWOOD FACING, R-25 MIN. 5/8" GYPSUM SHEATHING (DENSDECK)

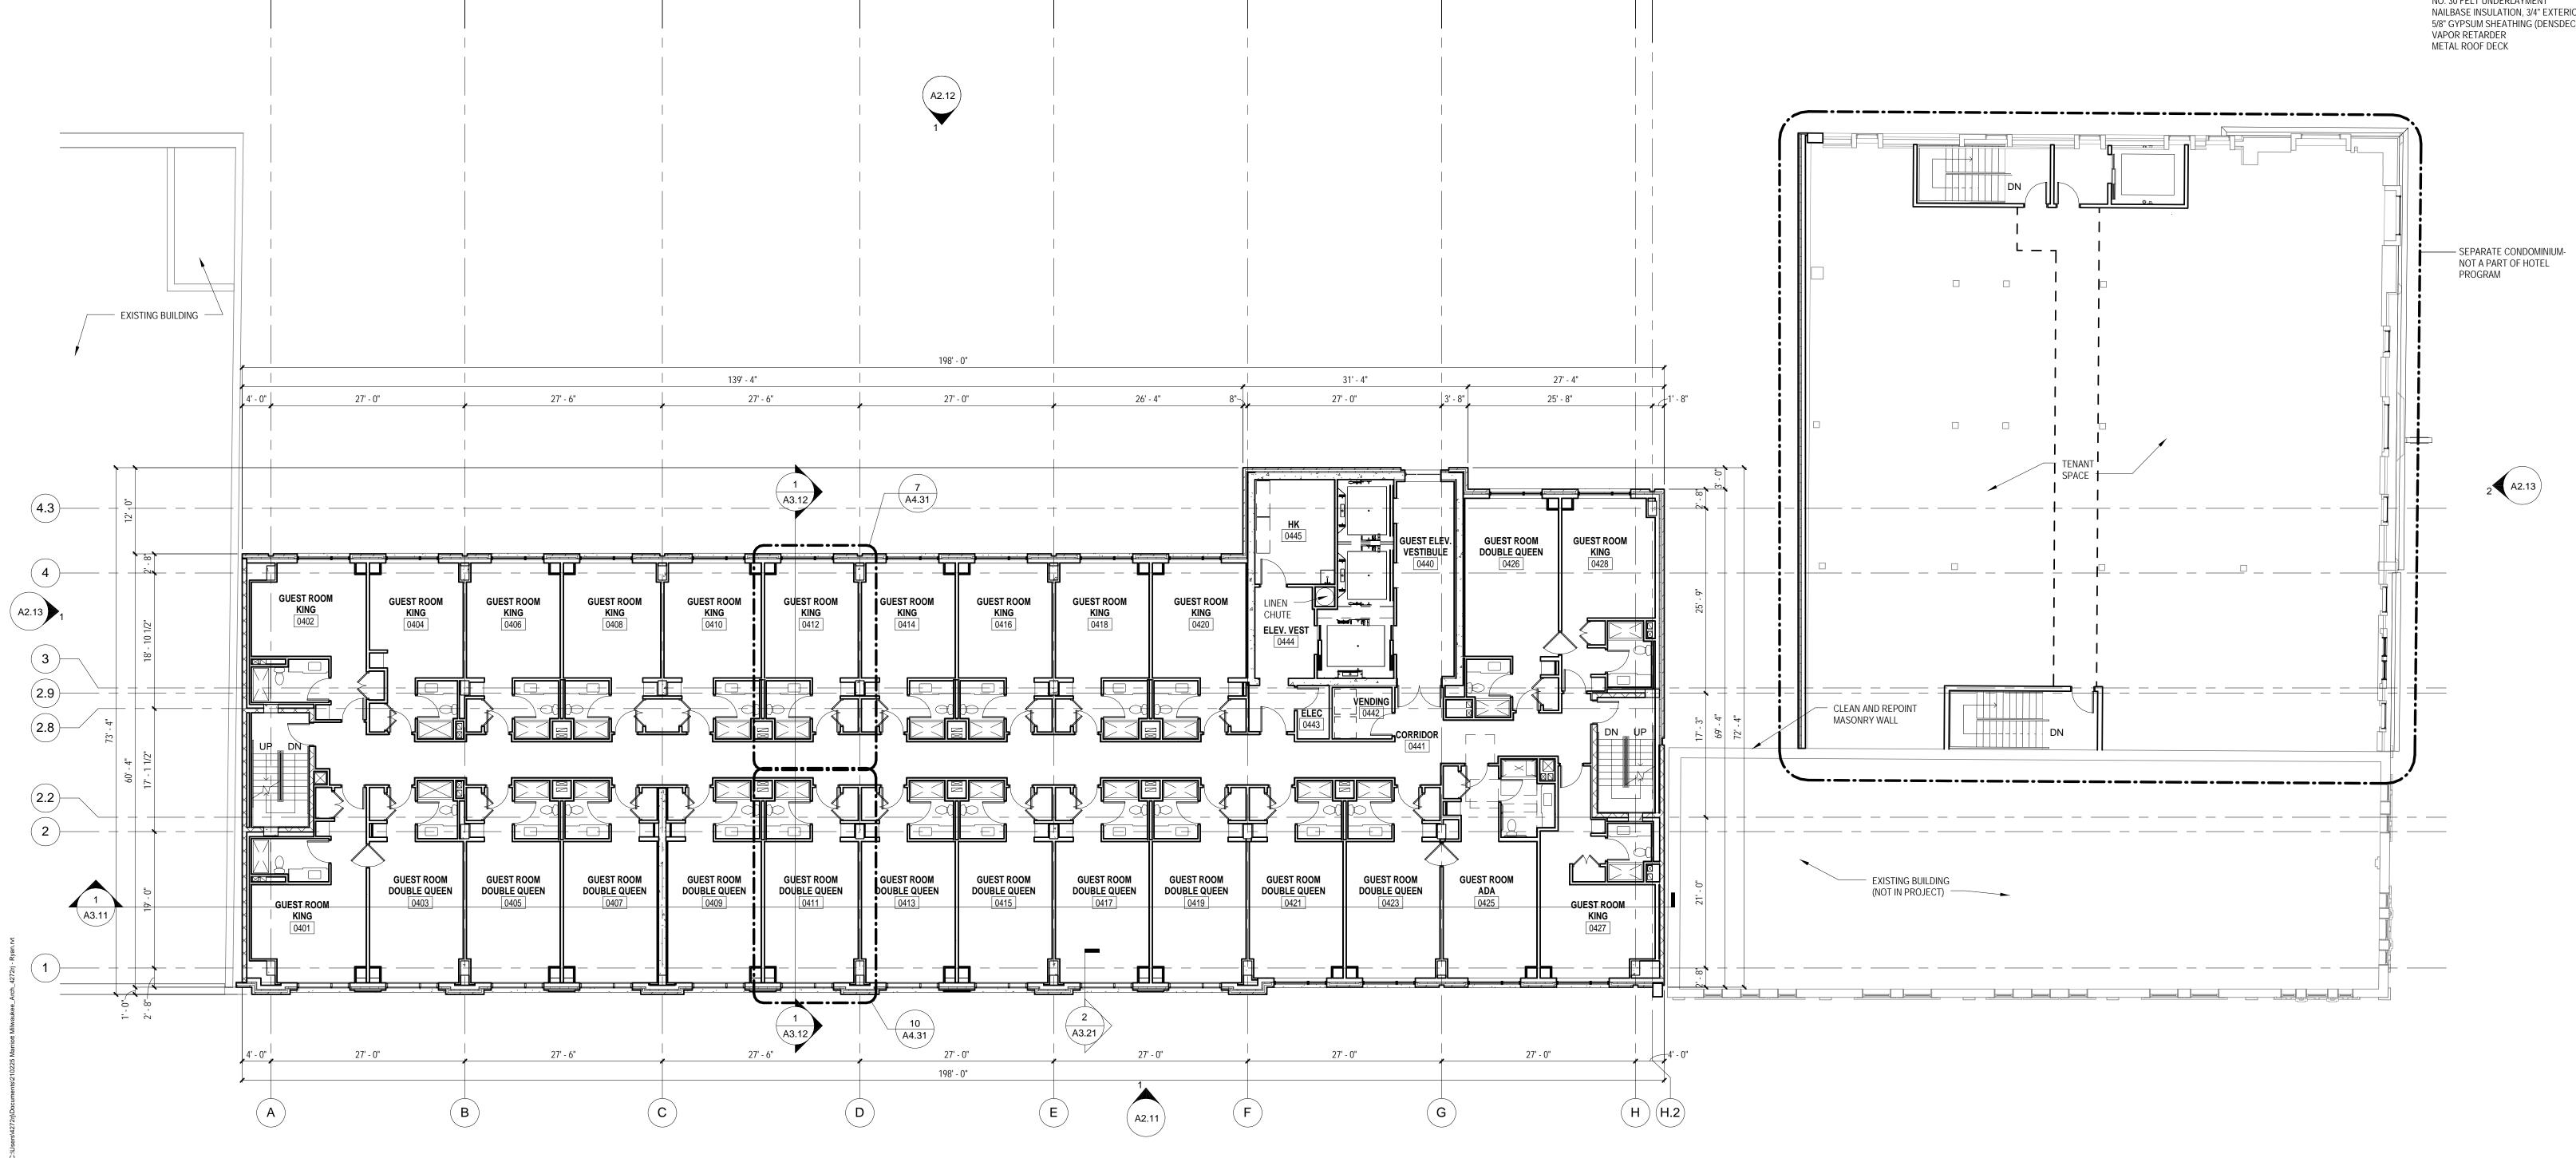

4th FLOOR PLAN

SCHEMATIC DESIGN II

JULY 11, 2011

MARRIOTT MILWAUKEE HOTEL

Milwaukee, WI 53202


210225.00

Sheet Title 4th FLOOR PLAN

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198' - 0" 139' - 4" 31' - 4" 27' - 4" 25' - 8" 27' - 0" 27' - 0" 27' - 0" 27' - 6" 27' - 6" 26' - 4" EXISTING BUILDING 4.3 **GUEST ROOM GUEST ROOM** DOUBLE QUEEN **GUEST ROOM GUEST ROOM** GUEST ROOM CHUTE 0618 ELEV. VEST 2.2 **GUEST ROOM GUEST ROOM GUEST ROOM GUEST ROOM** GUEST ROOM **GUEST ROOM GUEST ROOM GUEST ROOM GUEST ROOM** GUEST ROOM **GUEST ROOM GUEST ROOM** DOUBLE QUEEN GUEST ROOM GUEST ROOM 0619 27' - 6" 27' - 0" 27' - 0" 27' - 0" 27' - 0" 27' - 0" 198' - 0" \bigcirc D

2 6th FLOOR PLAN
3/32" = 1'-0"

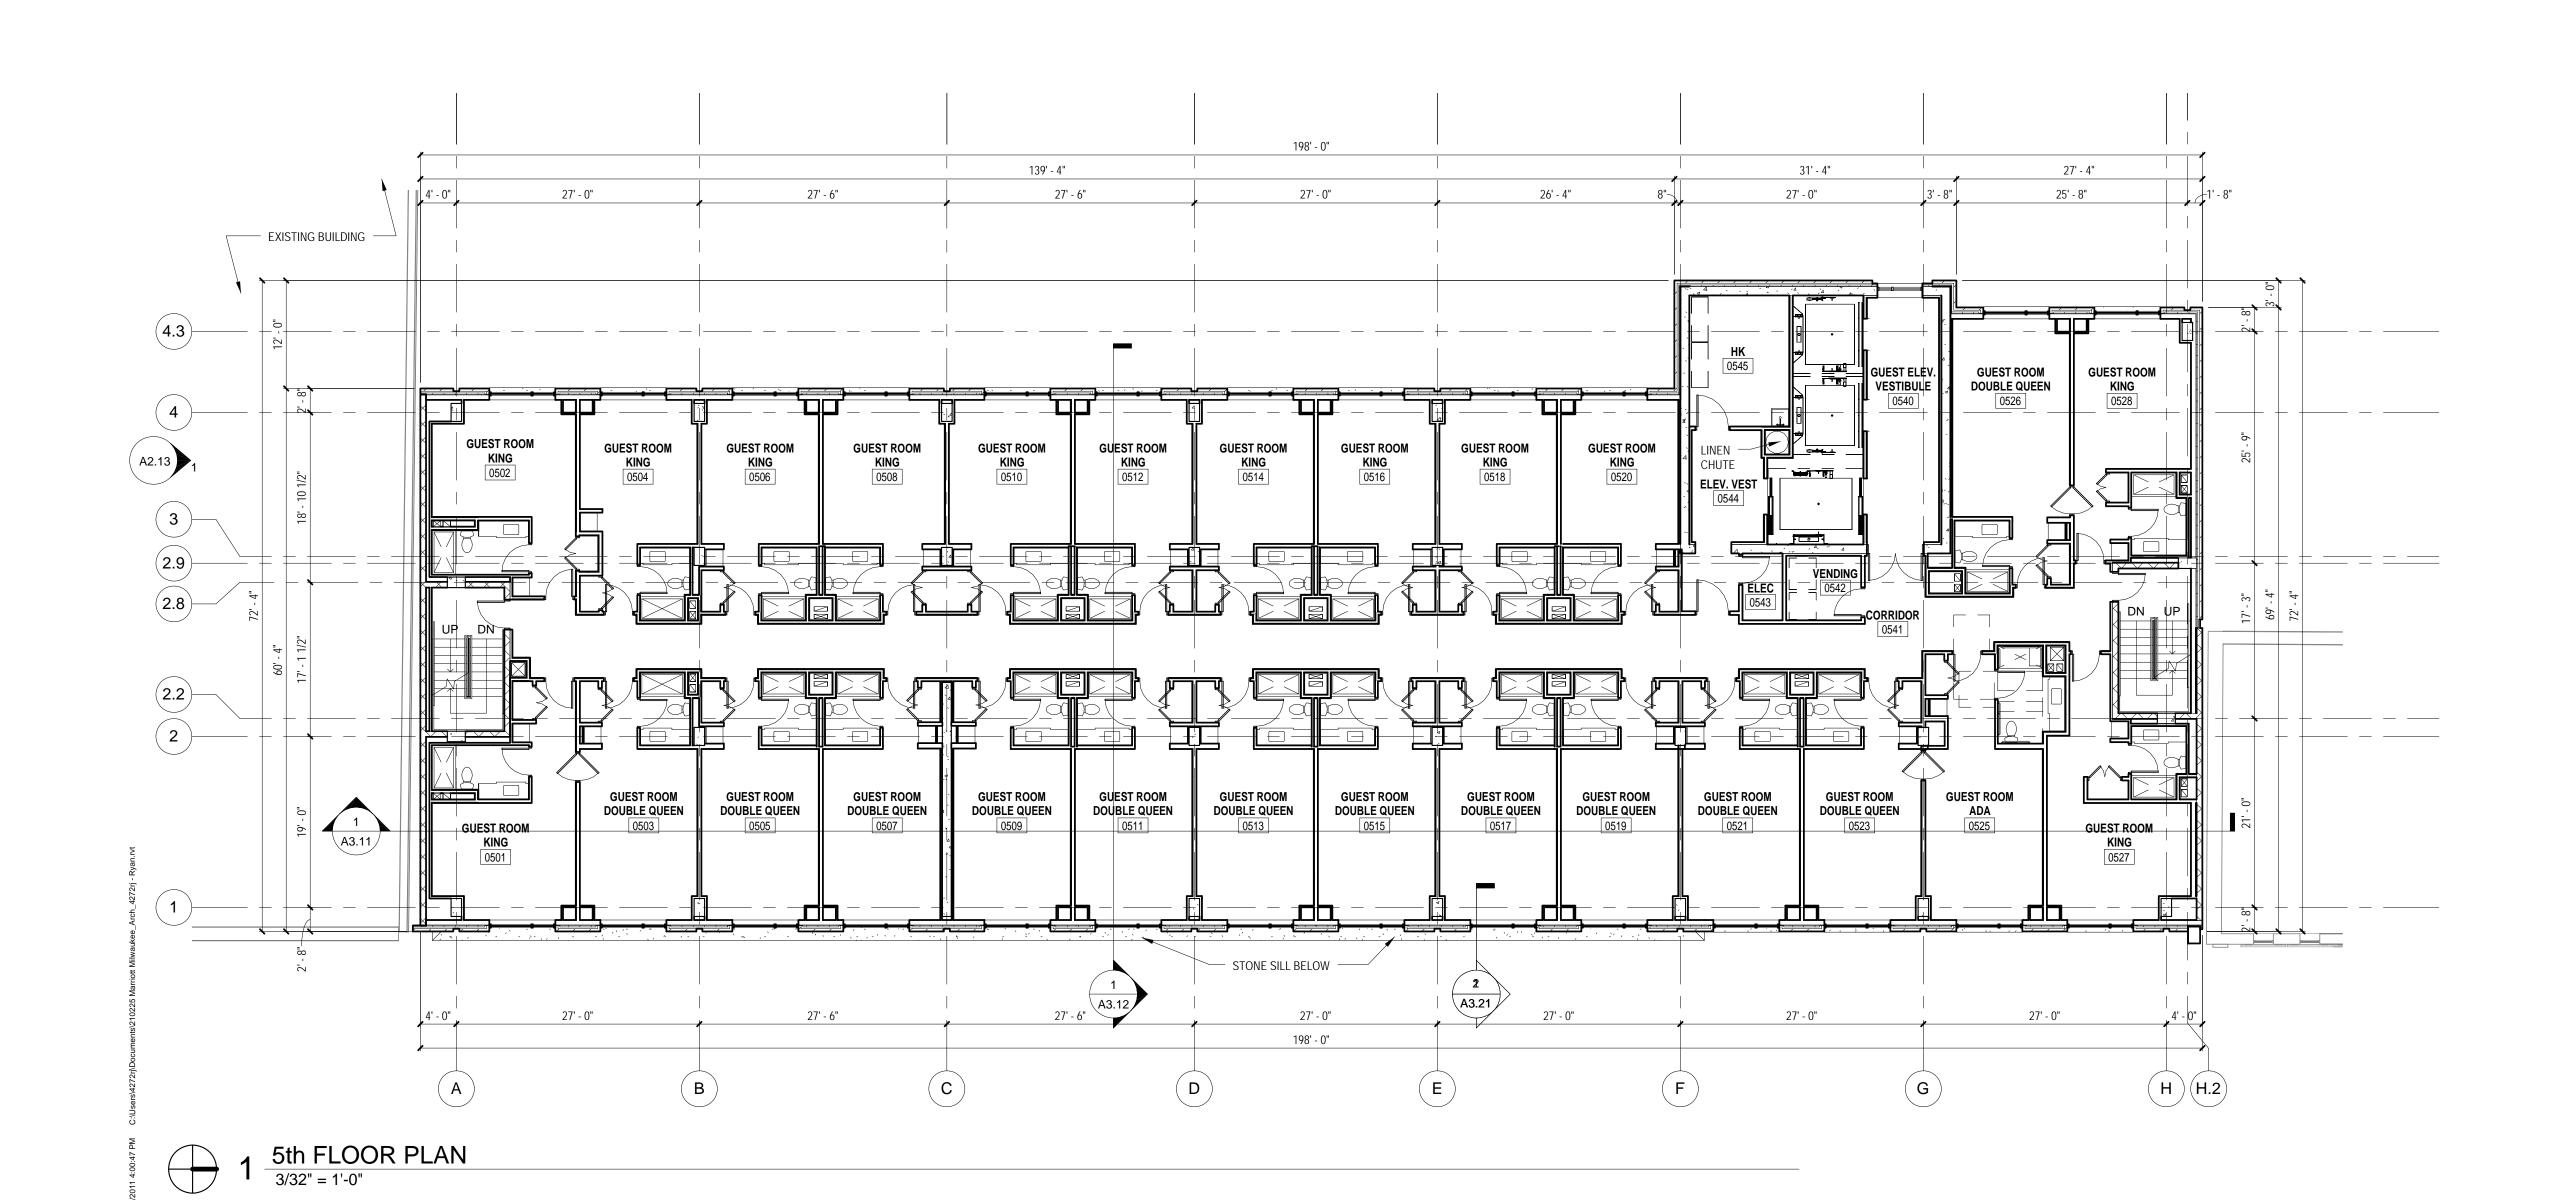

PLAN GENERAL NOTES

BUILDING SHALL BE CONSTRUCTED TO MEET THE REQUIREMENTS AND QUALITY LEVEL DESCRIBED IN THE MARRIOTT FULL SERVICE HOTEL DESIGN STANDARDS, DATED JANUARY 2011. PROVIDE APPROPRIATE MATERIALS AND LEVELS OF WORKMANSHIP TO MEET THIS STANDARD.
 VERIFY DIMENSIONS, CONDITIONS AND FINISHES BEFORE PRICING AND/OR PROCEEDING WITH WORK. DO NOT SCALE FROM DRAWINGS. BRING ANY DISCREPANCIES TO THE ARCHITECT'S ATTENTION IMMEDIATELY.
 COORDINATE LOCATIONS AND QUANTITY OF WORK WITH MECHANICAL, ELECTRICAL AND PLUMBING CONTRACTORS.

4. PIPING, CONDUIT AND RELATED MECHANICAL AND ELECTRICAL ITEMS SHALL BE CONCEALED WITHIN GYPSUM BOARD FURRING IN FINISHED AREAS WHETHER SHOWN ON THE DRAWINGS OR NOT, UNLESS NOTED OTHERWISE.

5. REFER TO PARTITION SCHEDULE ON G0.60 FOR TYPICAL PARTITION TYPES. STAIR, ELEVATOR, MECHANICAL AND OTHER SHAFT WALLS TO HAVE 2-HOUR RATING. GUESTROOM FLOOR CORRIDOR WALLS TO HAVE 1/2-HOUR RATING. WALLS BETWEEN ADJACENT GUESTROOMS TO HAVE 1 HOUR RATING.

6. PROVIDE METAL PLATE BACKING AND/OR WOOD BLOCKING IN WALLS WHERE WALL-MOUNTED EQUIPMENT OR ARTWORK IS SHOWN ON PLANS OR ELEVATIONS. VERIFY HEIGHT AND LENGTH WITH ACTUAL EQUIPMENT OR ARTWORK.

7. REMOVE CONSTRUCTION DEBRIS FROM THE CONSTRUCTION SITE DAILY AND PLACE IN THE APPROPRIATE REFUSE CONTAINER. WORK AREA SHALL BE KEPT CLEAN, FREE OF DUST, DIRT AND DEBRIS.

BUILDING ASSEMBLIES AND COMPONENTS

ROOF ASSEMBLY 1:
FULLY ADHERED 60 MIL. NON-REINFORCED EPDM MEMBRANE
POLYISOCYANURATE INSULATION W/SADDLES (R-20 AVG).
PROVIDE TAPERED INSULATION AS INDICATED ON ROOF PLAN
BITUMINOUS VAPOR RETARDER
CONCRETE SLAB

ROOF ASSEMBLY 2: DECORATIVE BALLAST

DECORATIVE BALLAST
2" THICK CONCRETE ROOF PAVERS AT PERIMETER OF ROOF AND SERVICE WALKS
LOOSE LAID 60 MIL. NON-REINFORCED EPDM MEMBRANE
POLYISOCYANURATE INSULATION W/SADDLES (R-20 AVG).
PROVIDE TAPERED INSULATION AS INDICATED ON ROOF PLAN
BITUMINOUS VAPOR RETARDER
5/8" GYPSUM SHEATHING (DENSDECK)
METAL ROOF DECK

ROOF ASSEMBLY 3: DECORATIVE BALLAST

2" THICK CONCRETE ROOF PAVERS AT PERIMETER OF ROOF AND SERVICE WALKS
LOOSE LAID 60 MIL. NON-REINFORCED EPDM MEMBRANE
POLYISOCYANURATE INSULATION W/SADDLES (R-20 AVG).
PROVIDE TAPERED INSULATION AS INDICATED ON ROOF PLAN
BITUMINOUS VAPOR RETARDER
EXISTING WOOD DECK & STRUCTURE

ROOF ASSEMBLY 4:
FULLY ADHERED 60 MIL. NON-REINFORCED EPDM MEMBRANE
POLYISOCYANURATE INSULATION W/SADDLES (R-20- AVG).
PROVIDE TAPERED INSULATION AS INDICATED ON ROOF PLAN
BITUMINOUS VAPOR RETARDER
EXISTING WOOD DECK AND STRUCTURE

ROOF ASSEMBLY 5:
KYNAR FINISHED ARCHITECTURAL STANDING SEAM METAL ROOFING (12" FLAT PANEL)
NO. 30 FELT UNDERLAYMENT
NAILBASE INSULATION, 3/4" EXTERIOR PLYWOOD FACING, R-25 MIN.
5/8" GYPSUM SHEATHING (DENSDECK)
VAPOR RETARDER
METAL ROOF DECK

Davisions

SCHEMATIC DESIGN II

Drawing Date
JULY 11, 2011

MARRIOTT MILWAUKEE HOTEL

Milwaukee, WI 53202

Project No. 210225.00

Sheet Title

5th AND 6th FLOOR
PLANS

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 COORDINATE LOCATIONS AND QUANTITY OF WORK WITH MECHANICAL, ELECTRICAL AND PLUMBING CONTRACTORS.

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5. REFER TO PARTITION SCHEDULE ON G0.60 FOR TYPICAL PARTITION TYPES. STAIR, ELEVATOR, MECHANICAL AND OTHER SHAFT WALLS TO HAVE 2-HOUR RATING. GUESTROOM FLOOR CORRIDOR WALLS TO HAVE 1/2-HOUR RATING. WALLS BETWEEN ADJACENT GUESTROOMS TO HAVE 1-HOUR RATING.

6. PROVIDE METAL PLATE BACKING AND/OR WOOD BLOCKING IN WALLS WHERE WALL-MOUNTED EQUIPMENT OR ARTWORK IS SHOWN ON PLANS OR ELEVATIONS. VERIFY HEIGHT AND LENGTH WITH ACTUAL EQUIPMENT OR ARTWORK.

7. REMOVE CONSTRUCTION DEBRIS FROM THE CONSTRUCTION SITE DAILY AND PLACE IN THE APPROPRIATE REFUSE CONTAINER. WORK AREA SHALL BE KEPT CLEAN, FREE OF DUST, DIRT AND DEBRIS.

BUILDING ASSEMBLIES AND COMPONENTS

ROOF ASSEMBLY 1:
FULLY ADHERED 60 MIL. NON-REINFORCED EPDM MEMBRANE
POLYISOCYANURATE INSULATION W/SADDLES (R-20 AVG).
PROVIDE TAPERED INSULATION AS INDICATED ON ROOF PLAN
BITUMINOUS VAPOR RETARDER
CONCRETE SLAB

ROOF ASSEMBLY 2: DECORATIVE BALLAST


2" THICK CONCRETE ROOF PAVERS AT PERIMETER OF ROOF AND SERVICE WALKS
LOOSE LAID 60 MIL. NON-REINFORCED EPDM MEMBRANE
POLYISOCYANURATE INSULATION W/SADDLES (R-20 AVG).
PROVIDE TAPERED INSULATION AS INDICATED ON ROOF PLAN
BITUMINOUS VAPOR RETARDER
5/8" GYPSUM SHEATHING (DENSDECK)
METAL ROOF DECK

ROOF ASSEMBLY 3: DECORATIVE BALLAST

2" THICK CONCRETE ROOF PAVERS AT PERIMETER OF ROOF AND SERVICE WALKS
LOOSE LAID 60 MIL. NON-REINFORCED EPDM MEMBRANE
POLYISOCYANURATE INSULATION W/SADDLES (R-20 AVG).
PROVIDE TAPERED INSULATION AS INDICATED ON ROOF PLAN
BITUMINOUS VAPOR RETARDER
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ROOF ASSEMBLY 4:
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POLYISOCYANURATE INSULATION W/SADDLES (R-20- AVG).
PROVIDE TAPERED INSULATION AS INDICATED ON ROOF PLAN
BITUMINOUS VAPOR RETARDER
EXISTING WOOD DECK AND STRUCTURE

ROOF ASSEMBLY 5:
KYNAR FINISHED ARCHITECTURAL STANDING SEAM METAL ROOFING (12"
FLAT PANEL)
NO. 30 FELT UNDERLAYMENT
NAILBASE INSULATION, 3/4" EXTERIOR PLYWOOD FACING, R-25 MIN.
5/8" GYPSUM SHEATHING (DENSDECK)
VAPOR RETARDER

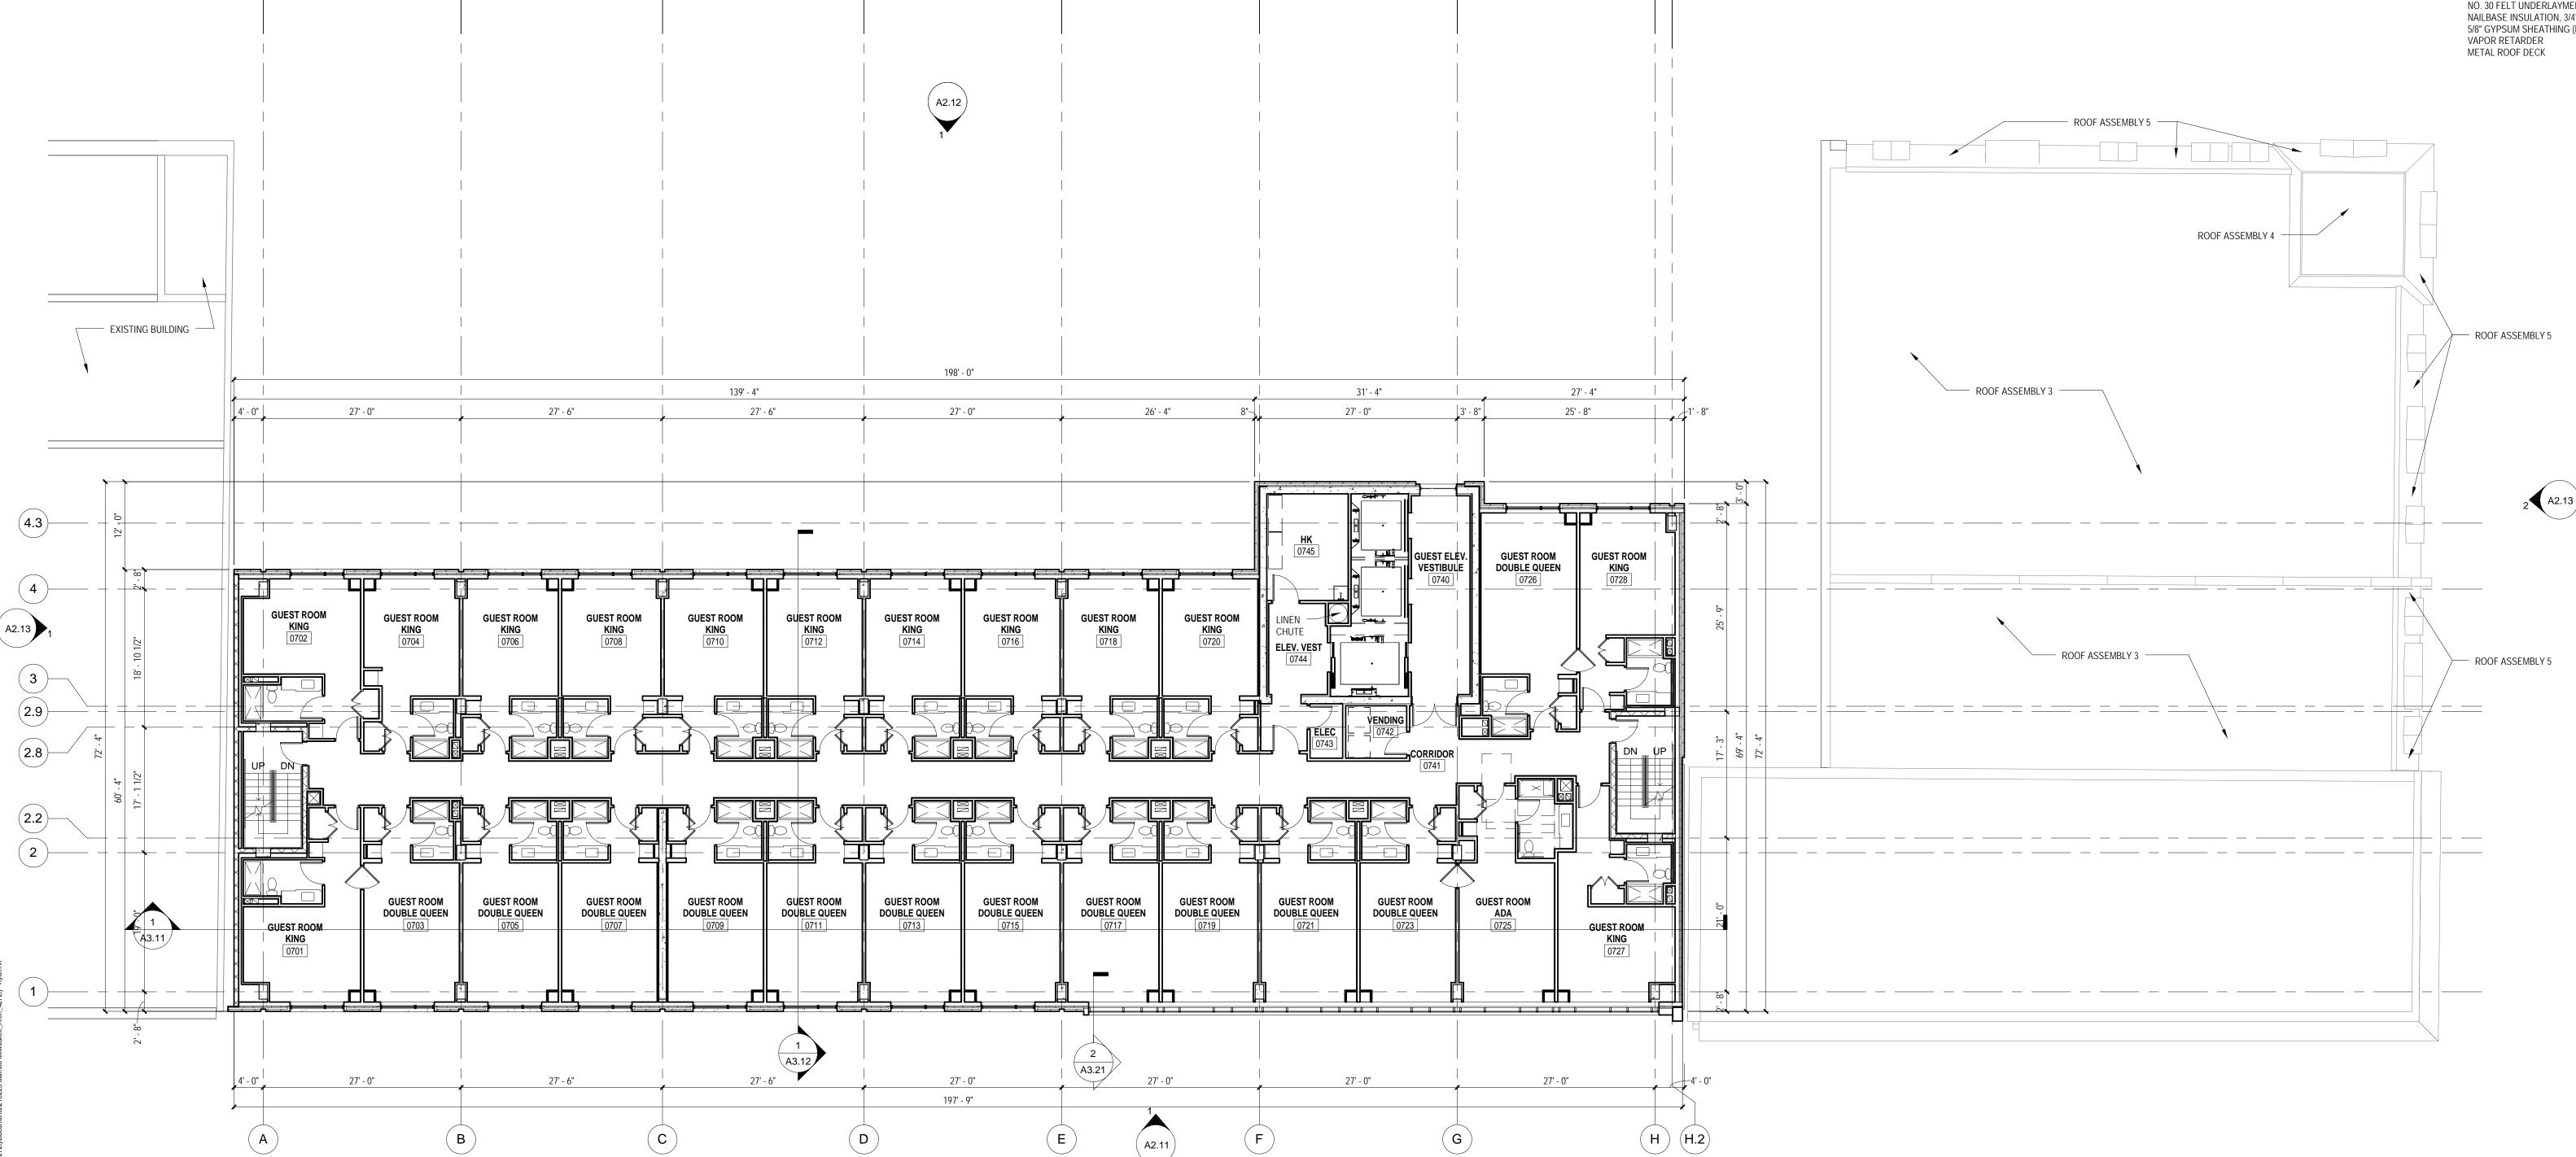

7th FLOOR PLAN

Revisions

SCHEMATIC DESIGN II

awing Date

JULY 11, 2011

MARRIOTT MILWAUKEE HOTEL

Milwaukee, WI 53202


Project No. 210225.00


7th FLOOR AND ROOF PLANS

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OTHERWISE. 5. REFER TO PARTITION SCHEDULE ON G0.60 FOR TYPICAL PARTITION TYPES. STAIR, ELEVATOR, MECHANICAL AND OTHER SHAFT WALLS TO HAVE 2-HOUR RATING. GUESTROOM FLOOR CORRIDOR WALLS TO HAVE 1/2-HOUR RATING. WALLS BETWEEN ADJACENT GUESTROOMS TO HAVE 1

AREAS WHETHER SHOWN ON THE DRAWINGS OR NOT, UNLESS NOTED

6. PROVIDE METAL PLATE BACKING AND/OR WOOD BLOCKING IN WALLS WHERE WALL-MOUNTED EQUIPMENT OR ARTWORK IS SHOWN ON PLANS OR ELEVATIONS. VERIFY HEIGHT AND LENGTH WITH ACTUAL EQUIPMENT
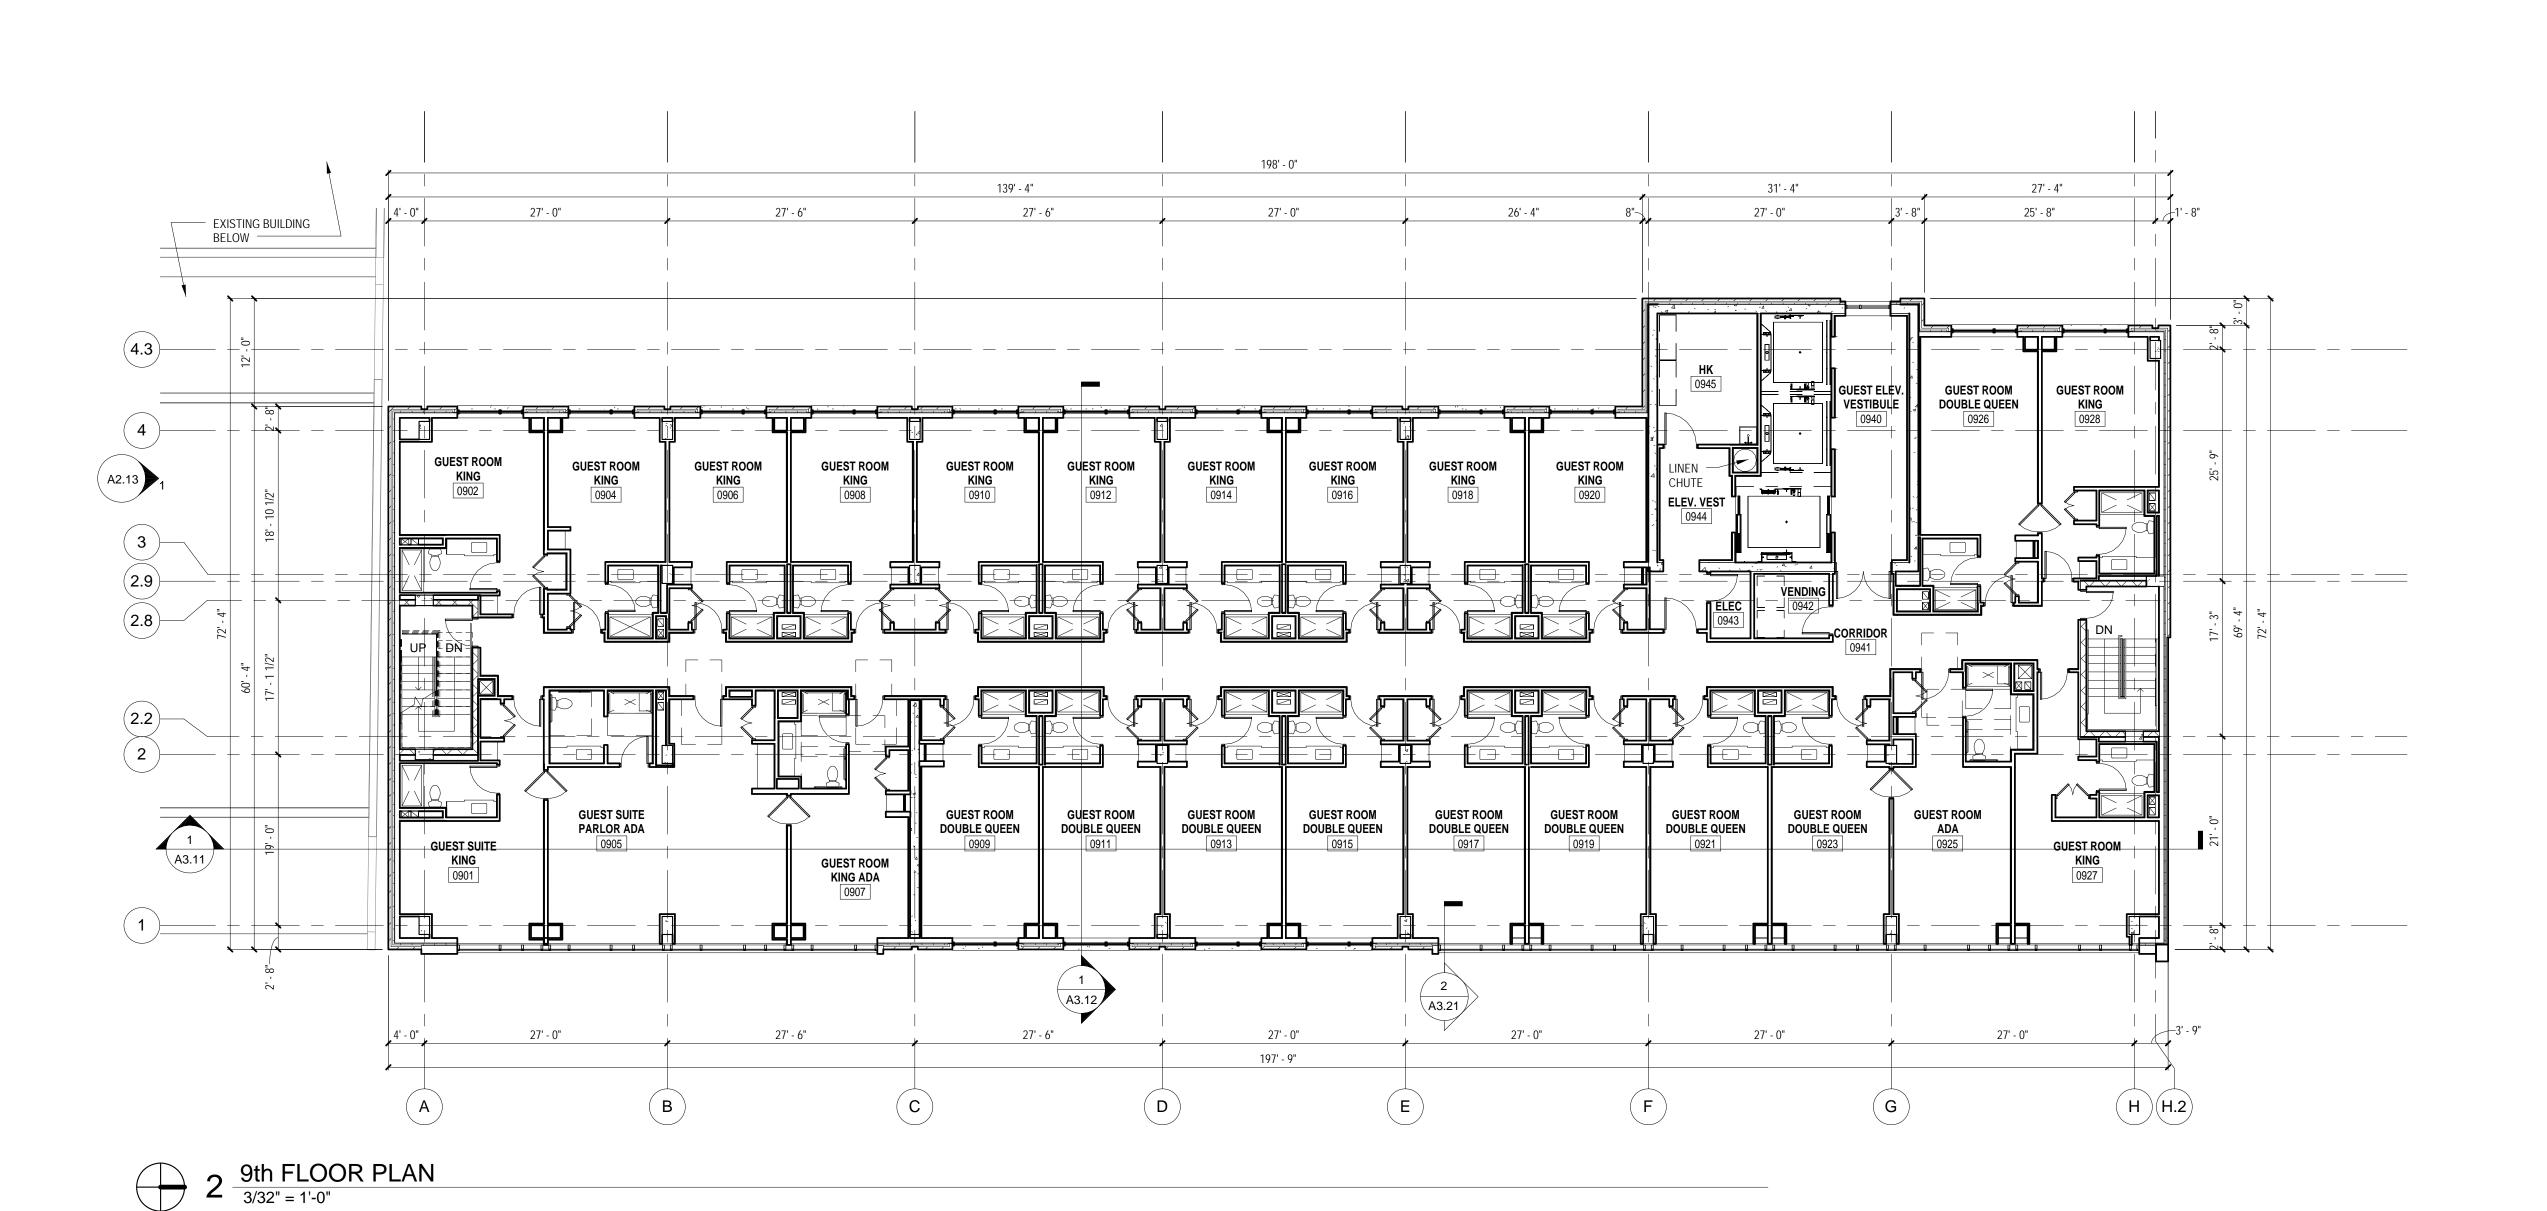
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BUILDING ASSEMBLIES AND COMPONENTS

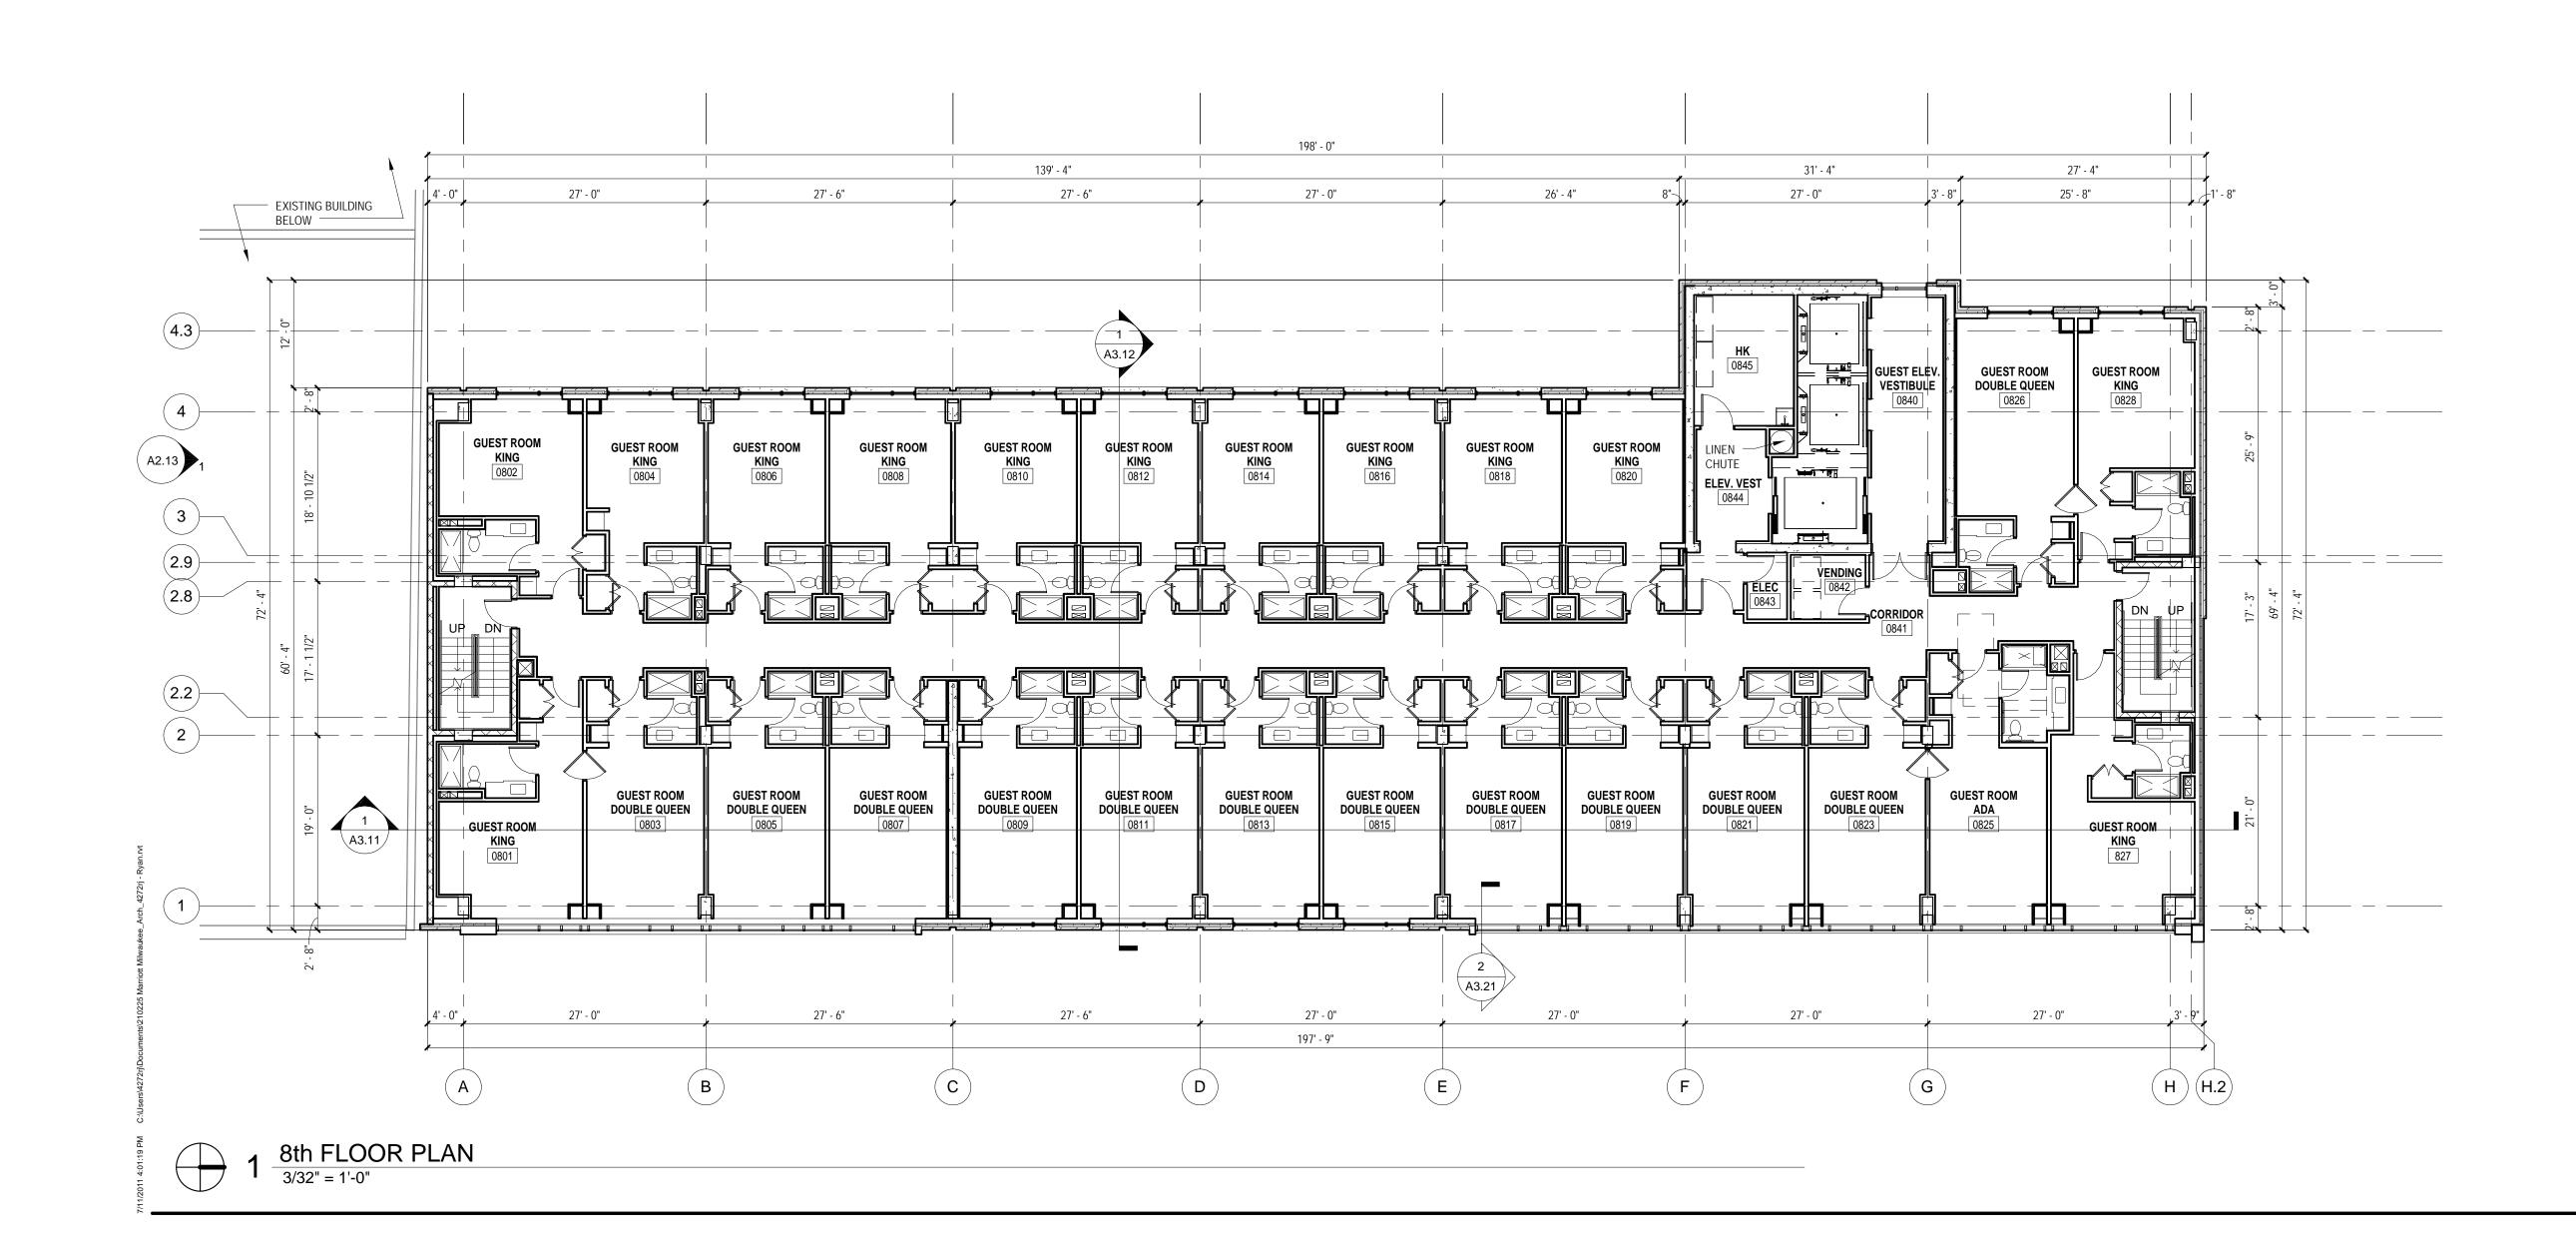ROOF ASSEMBLY 1: FULLY ADHERED 60 MIL. NON-REINFORCED EPDM MEMBRANE POLYISOCYANURATE INSULATION W/SADDLES (R-20 AVG). PROVIDE TAPERED INSULATION AS INDICATED ON ROOF PLAN BITUMINOUS VAPOR RETARDER CONCRETE SLAB

HOUR RATING.

OR ARTWORK.

ROOF ASSEMBLY 2: DECORATIVE BALLAST 2" THICK CONCRETE ROOF PAVERS AT PERIMETER OF ROOF AND SERVICE WALKS LOOSE LAID 60 MIL. NON-REINFORCED EPDM MEMBRANE POLYISOCYANURATE INSULATION W/SADDLES (R-20 AVG). PROVIDE TAPERED INSULATION AS INDICATED ON ROOF PLAN BITUMINOUS VAPOR RETARDER 5/8" GYPSUM SHEATHING (DENSDECK) METAL ROOF DECK

ROOF ASSEMBLY 3: DECORATIVE BALLAST

2" THICK CONCRETE ROOF PAVERS AT PERIMETER OF ROOF AND SERVICE WALKS LOOSE LAID 60 MIL. NON-REINFORCED EPDM MEMBRANE POLYISOCYANURATE INSULATION W/SADDLES (R-20 AVG). PROVIDE TAPERED INSULATION AS INDICATED ON ROOF PLAN BITUMINOUS VAPOR RETARDER EXISTING WOOD DECK & STRUCTURE

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ROOF ASSEMBLY 5: KYNAR FINISHED ARCHITECTURAL STANDING SEAM METAL ROOFING (12" NO. 30 FELT UNDERLAYMENT NAILBASE INSULATION, 3/4" EXTERIOR PLYWOOD FACING, R-25 MIN. 5/8" GYPSUM SHEATHING (DENSDECK) VAPOR RETARDER METAL ROOF DECK

SCHEMATIC DESIGN II

Drawing Date

JULY 11, 2011

MARRIOTT MILWAUKEE HOTEL


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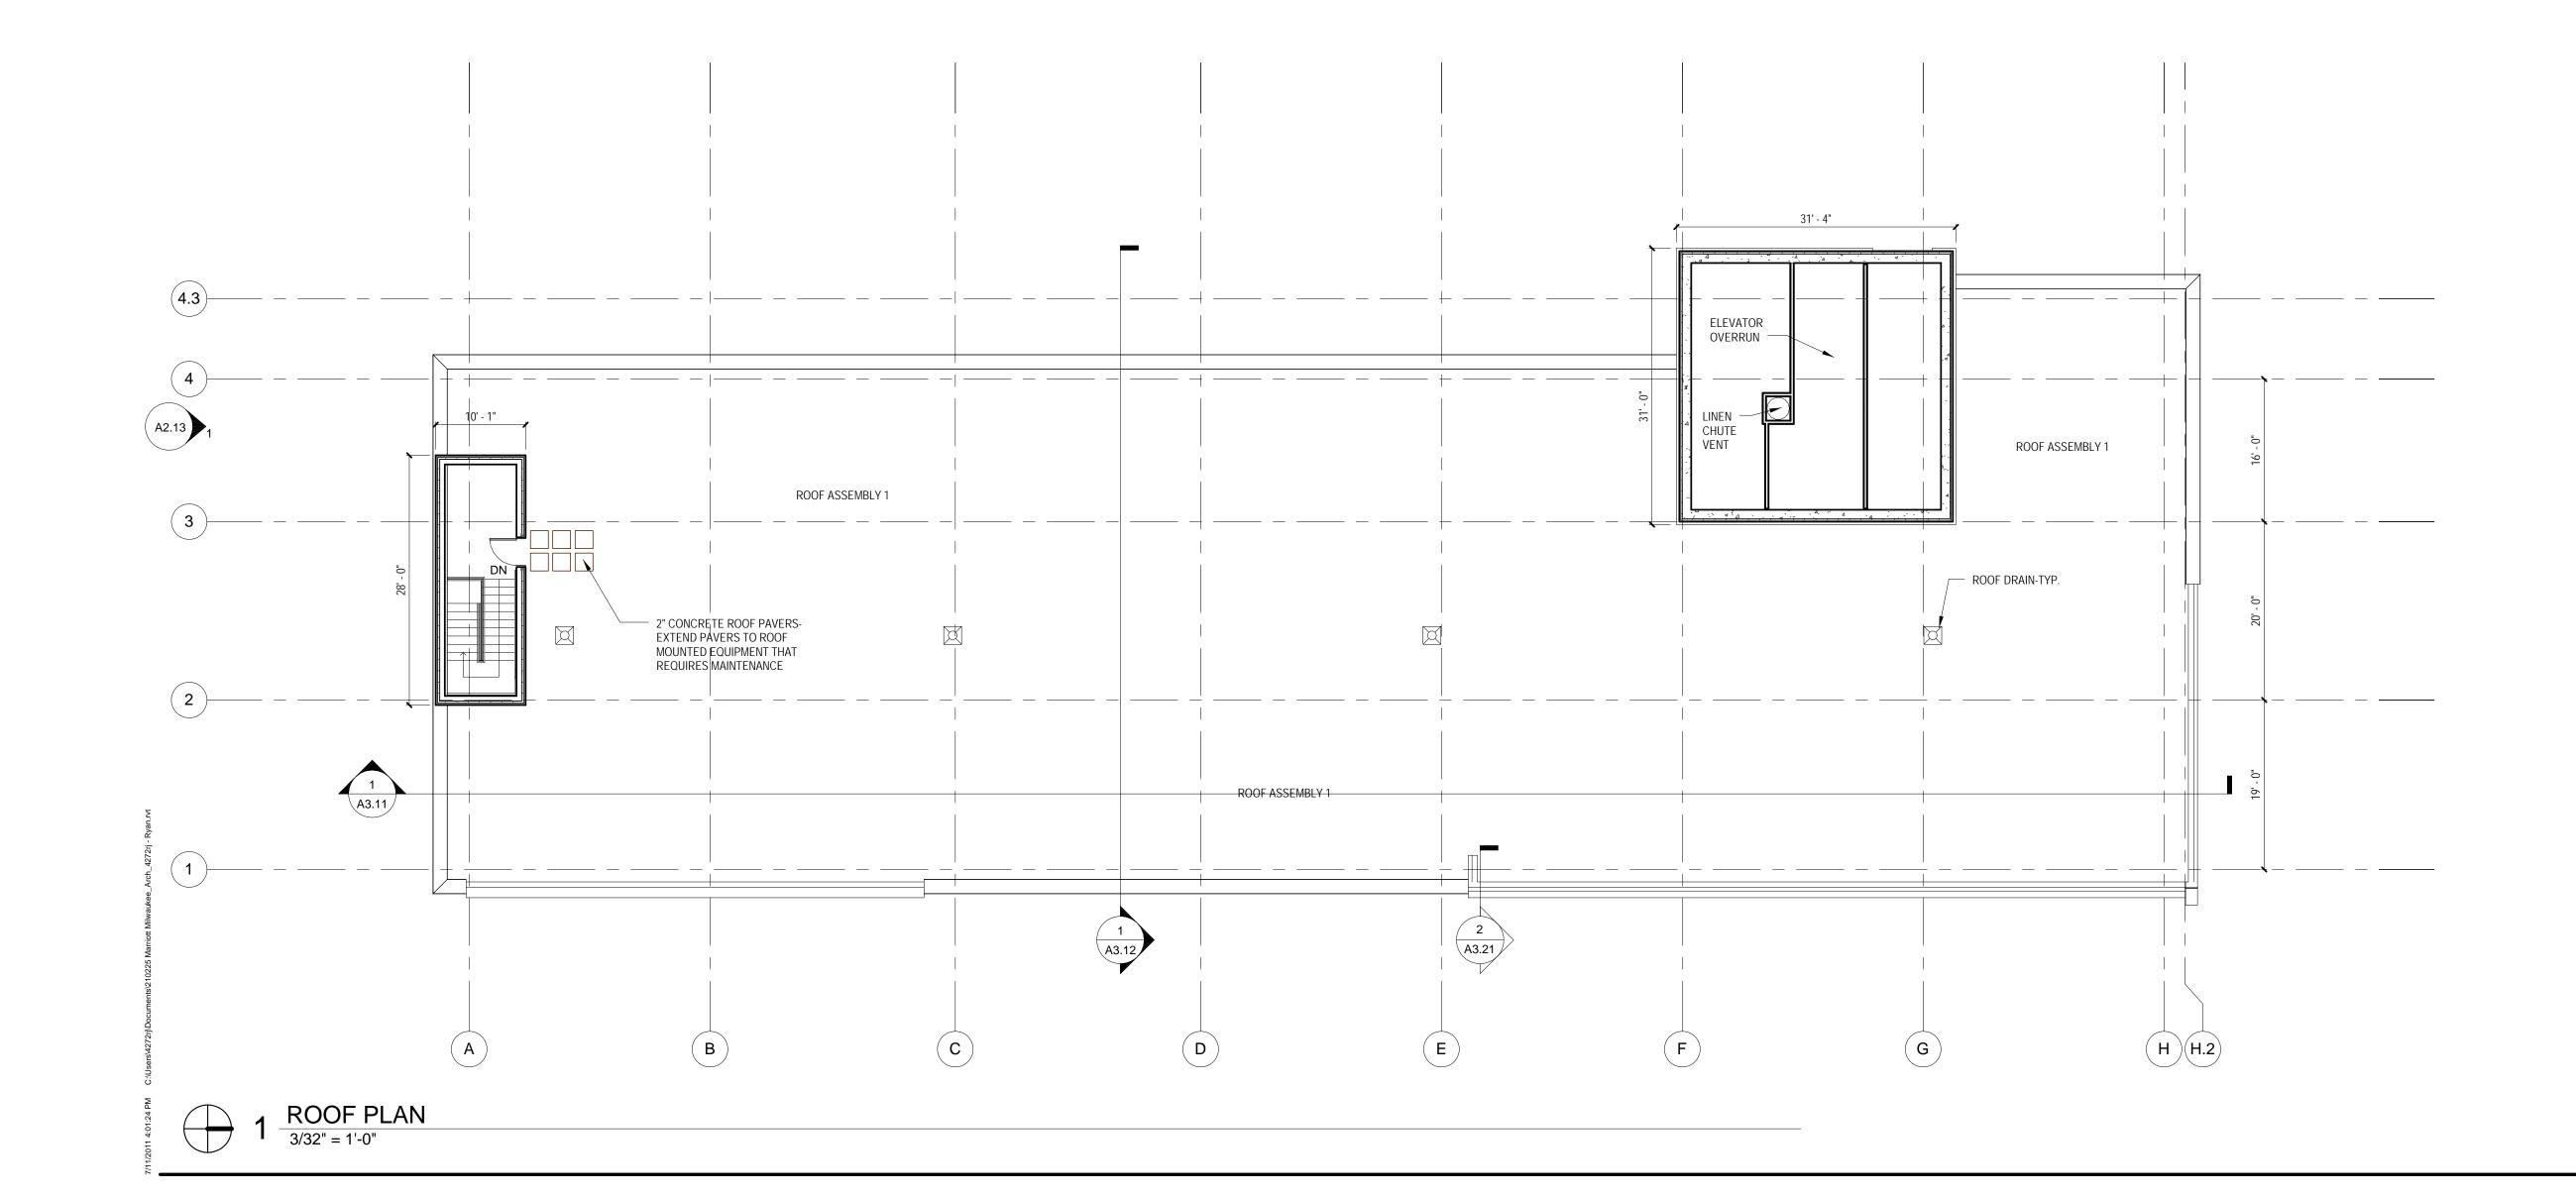
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Sheet Title 8th AND 9tH FLOOR **PLANS**

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ELECTRICAL AND PLUMBING CONTRACTORS.

OTHERWISE.

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3. COORDINATE LOCATIONS AND QUANTITY OF WORK WITH MECHANICAL,

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6. PROVIDE METAL PLATE BACKING AND/OR WOOD BLOCKING IN WALLS WHERE WALL-MOUNTED EQUIPMENT OR ARTWORK IS SHOWN ON PLANS OR ELEVATIONS. VERIFY HEIGHT AND LENGTH WITH ACTUAL EQUIPMENT OR ARTWORK.
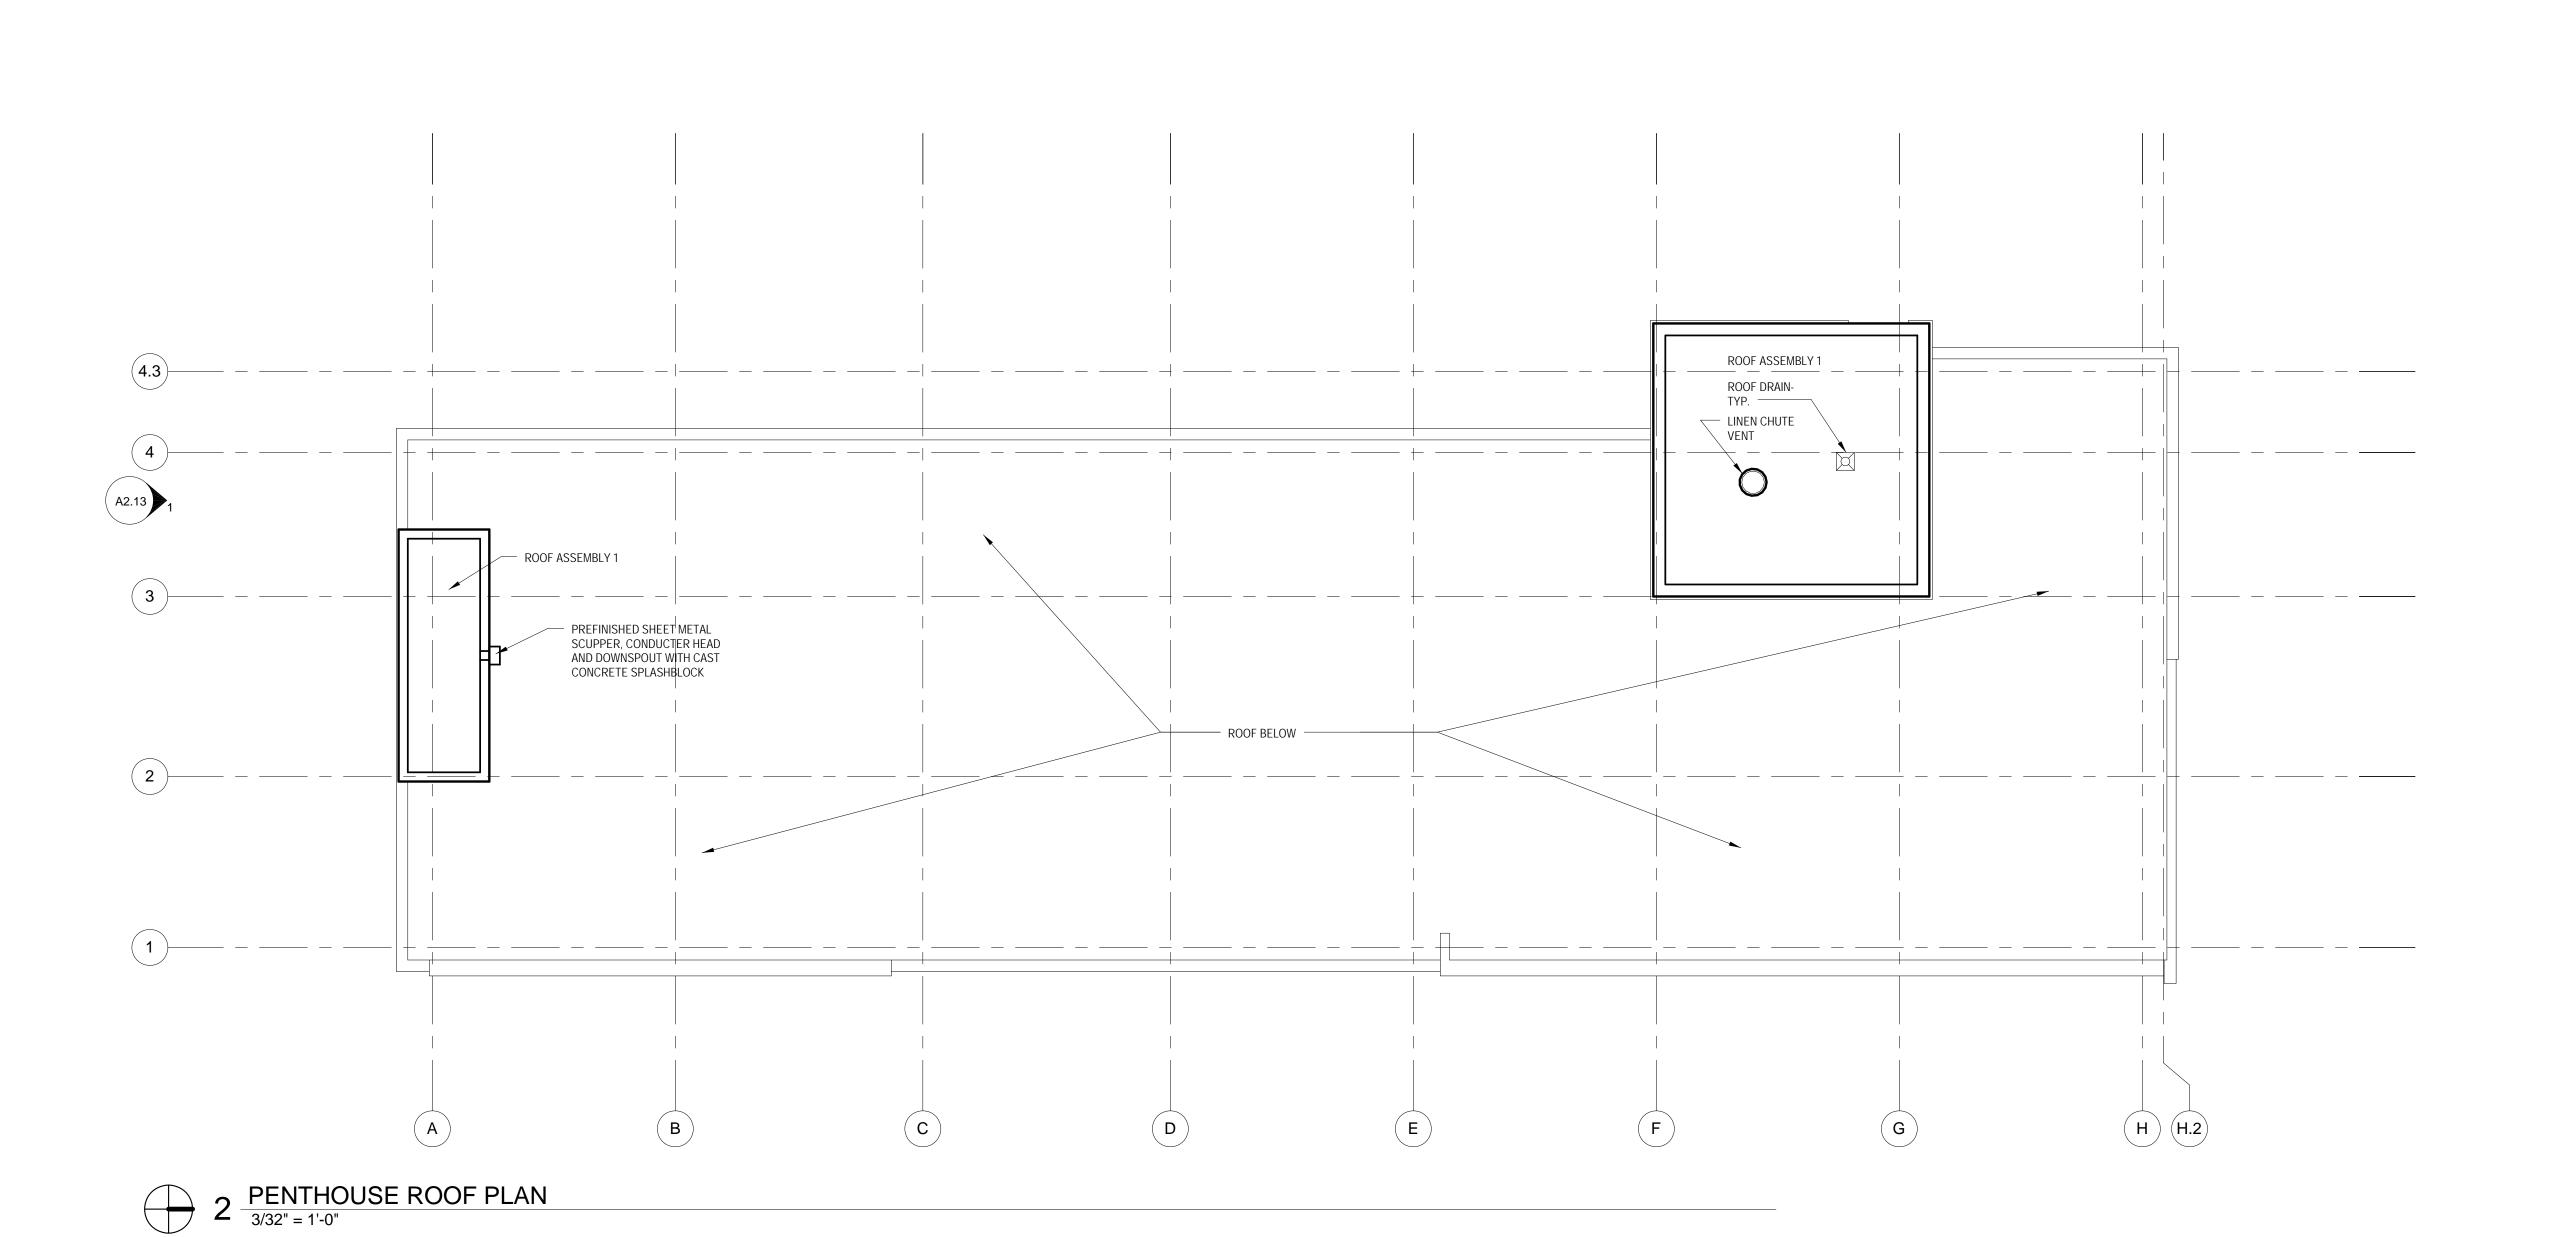
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BUILDING ASSEMBLIES AND COMPONENTS

ROOF ASSEMBLY 1:
FULLY ADHERED 60 MIL. NON-REINFORCED EPDM MEMBRANE
POLYISOCYANURATE INSULATION W/SADDLES (R-20 AVG).
PROVIDE TAPERED INSULATION AS INDICATED ON ROOF PLAN
BITUMINOUS VAPOR RETARDER

CONCRETE SLAB

ROOF ASSEMBLY 2:

ROOF ASSEMBLY 2:
DECORATIVE BALLAST
2" THICK CONCRETE ROOF PAVERS AT PERIMETER OF ROOF AND SERVICE WALKS

LOOSE LAID 60 MIL. NON-REINFORCED EPDM MEMBRANE
POLYISOCYANURATE INSULATION W/SADDLES (R-20 AVG).
PROVIDE TAPERED INSULATION AS INDICATED ON ROOF PLAN
BITUMINOUS VAPOR RETARDER
5/8" GYPSUM SHEATHING (DENSDECK)

EXISTING WOOD DECK & STRUCTURE

ROOF ASSEMBLY 3: DECORATIVE BALLAST

METAL ROOF DECK

DECORATIVE BALLAST
2" THICK CONCRETE ROOF PAVERS AT PERIMETER OF ROOF AND

SERVICE WALKS
LOOSE LAID 60 MIL. NON-REINFORCED EPDM MEMBRANE
POLYISOCYANURATE INSULATION W/SADDLES (R-20 AVG).
PROVIDE TAPERED INSULATION AS INDICATED ON ROOF PLAN
BITUMINOUS VAPOR RETARDER

ROOF ASSEMBLY 4:
FULLY ADHERED 60 MIL. NON-REINFORCED EPDM MEMBRANE
POLYISOCYANURATE INSULATION W/SADDLES (R-20- AVG).
PROVIDE TAPERED INSULATION AS INDICATED ON ROOF PLAN
BITUMINOUS VAPOR RETARDER

ROOF ASSEMBLY 5:
KYNAR FINISHED ARCHITECTURAL STANDING SEAM METAL ROOFING (12"
FLAT PANEL)

FLAT PANEL)

NO. 30 FELT UNDERLAYMENT

NAILBASE INSULATION, 3/4" EXTERIOR PLYWOOD FACING, R-25 MIN.

5/8" GYPSUM SHEATHING (DENSDECK)

VAPOR RETARDER METAL ROOF DECK

Revisions

SCHEMATIC DESIGN II

Drawing Date
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MARRIOTT MILWAUKEE HOTEL

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Sheet Title

PENTHOUSE AND ROOF PLANS

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28) TYP. TYP. 7' - 4" TYP. -0--0-+1'-0" +10" +1-0" +5"

2 DETAIL OF EAST ELEVATION

3/8" = 1'-0"

BUILDING ELEVATION GENERAL NOTES 1. ALL GLAZING TO BE CLEAR LOW-E, INSULATED GLASS, U.N.O.

2. FINAL SIZE, STYLE AND LOCATION OF LOUVERS TO BE COORDINATED WITH DESIGN-BUILD HVAC CONTRACTOR.

EXTERIOR BUILDING MATERIAL KEY NOTES WOOD CORNICE WITH DECORTIVE MOLDING - PROFILE TO MATCH JOHNSON BANK BUILDING (1) BRICK 1 - RUNNING BOND 2 BRICK 2 - STACK BOND (18) PREFINISHED ALUMINUM WINDOW UNIT IN EXISTING OPENING 3 BRICK 3 - RUNNING BOND - TO MATCH CREAM CITY BRICK (19) STONE 3 - DOLOMITE LIMESTONE TO MATCH JOHNSON BANK (4) GLASS TYPE 2 - INSULATED SPANDREL (20) CONCRETE MASONRY UNIT (5) COMPOSITE METAL PANEL (6) <u>INSULATED METAL PANEL</u> (7) PROJECTED BRICK SOLDIER COURSE BAND

PREFINISHED ALUMINUM WINDOW UNIT, DESIGN BASIS: EFCO 325X WITH 1" PERIMETER MULLION CAPS & 3" MULLION CAP AT INTERMEDIATE VERTICAL MEMBER. 22) PREFINISHED ALUMINUM WINDOW-WALL UNIT (23) EXPANSION JOINT

(24) PREFINISHED METAL COPING (25) <u>BUILDING SIGNAGE</u> (26) <u>FLAGPOLE</u>

(11) STONE SILL - STONE 1 (12) STONE COPING - STONE 1 (27) <u>BOLLARD</u> (13) <u>BUILDING MARQUEE - PREFINISHED METAL PANEL ON STEEL FRAMING</u> (28) <u>CONTROL JOINT</u> (14) PREFINISHED ALUMINUM STOREFRONT FRAMING

(8) STONE 1 - LIMESTONE

(10) PREFINISHED METAL PANEL SUNSHADE

(9) STONE 2 - GRANITE

(29) <u>REVOLVING DOOR</u> (15) WOOD WINDOW WITH INSULATED GLAZING $\underbrace{30} \quad \underbrace{\frac{\text{PAINTED WOOD STOREFRONT SYSTEM WITH INSULATED}}{\text{GLAZING}}}$ (16) DORMER RECLAD IN ORNAMENTAL SHEET METAL, PAINTED

(35) CAST STONE COPING (36) <u>LOUVER</u> (37) PREFINISHED METAL FLASHING (38) INSULATED OVERHEAD DOOR (39) CANOPY SUPPORT ROD (40) STANDING SEAM MANSARD ROOF (41) EXISTING GLASS BLOCK TO REMAIN (42) <u>REPOINT EXISTING MASONRY AS REQUIRED</u> REMOVE EXISTING LOUVER, PATCH OPENING WITH BRICK TO MATCH EXISTING

(44) PREFINISHED ALUMINUM DOWNSPOUT

(45) PATCH OPENING WITH BRICK TO MATCH EXISTING

(46) REMOVE PAINT FROM EXISTING MASONRY WITH CHEMICAL STRIPPER & CLEAN UNDERLYING MASONRY, REPOINT MASONRY AS REQUIRED

(31) REPAIR AND REPAINT ORNAMENTAL SHEET METAL CORNICE

(34) REPLACE EXISTING GLASS, PAINT DECORATIVE METAL WORK

PREFINISHED ALUMINUM WINDOW UNIT

(33) LIMESTONE TO MATCH EXISTING

(E) (2) (A3.21) A3.12 H(H.2) G (c)EXISTING MCGEOCH BUILDING ---TYP. AT HORIZONTAL ROW TYP. AT HORIZONTAL ROW
 - (28)

 TYP.

 TYP.

- (28)

 TYP.

- (28)
- TYP.
 -4[3] [5] & H(9) [4] [4] [9) [5 1 EAST ELEVATION

1/8" = 1'-0"

SCHEMATIC DESIGN II

Drawing Date JULY 11, 2011

MARRIOTT MILWAUKEE HOTEL

Milwaukee, WI 53202

Project No. 210225.00

Sheet Title **EXTERIOR ELEVATIONS**

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Sheet No. A2.11





BUILDING ELEVATION

GENERAL NOTES

1. ALL GLAZING TO BE CLEAR LOW-E, INSULATED GLASS, U.N.O. 2. FINAL SIZE, STYLE AND LOCATION OF LOUVERS TO BE

COORDINATED WITH DESIGN-BUILD HVAC CONTRACTOR.

EXTERIOR BUILDING MATERIAL KEY NOTES

(1) BRICK 1 - RUNNING BOND

(4) GLASS TYPE 2 - INSULATED SPANDREL

7) PROJECTED BRICK SOLDIER COURSE BAND

(5) COMPOSITE METAL PANEL

(6) <u>INSULATED METAL PANEL</u>

(8) STONE 1 - LIMESTONE

9 STONE 2 - GRANITE

(11) STONE SILL - STONE 1

(12) STONE COPING - STONE 1

- BRICK 2 STACK BOND BRICK 3 - RUNNING BOND - TO MATCH CREAM CITY BRICK
 - (19) STONE 3 DOLOMITE LIMESTONE TO MATCH JOHNSON BANK (20) CONCRETE MASONRY UNIT

 - 22) PREFINISHED ALUMINUM WINDOW-WALL UNIT
- 24) PREFINISHED METAL COPING (10) PREFINISHED METAL PANEL SUNSHADE
- (13) BUILDING MARQUEE PREFINISHED METAL PANEL ON STEEL FRAMING
- (14) PREFINISHED ALUMINUM STOREFRONT FRAMING
- 15) WOOD WINDOW WITH INSULATED GLAZING (16) DORMER RECLAD IN ORNAMENTAL SHEET METAL, PAINTED

- WOOD CORNICE WITH DECORTIVE MOLDING PROFILE TO MATCH JOHNSON BANK BUILDING
- 18 PREFINISHED ALUMINUM WINDOW UNIT IN EXISTING OPENING
- (34) REPLACE EXISTING GLASS, PAINT DECORATIVE METAL WORK (35) CAST STONE COPING PREFINISHED ALUMINUM WINDOW UNIT, DESIGN BASIS: EFCO 325X WITH 1" PERIMETER MULLION CAPS & 3" MULLION CAP AT INTERMEDIATE VERTICAL MEMBER. (36) <u>LOUVER</u> (37) PREFINISHED METAL FLASHING
- (23) <u>EXPANSION JOINT</u>
- (25) <u>BUILDING SIGNAGE</u> (26) <u>FLAGPOLE</u>
- (27) <u>BOLLARD</u>
- (28) <u>CONTROL JOINT</u>
- (29) <u>REVOLVING DOOR</u> 30 PAINTED WOOD STOREFRONT SYSTEM WITH INSULATED GLAZING
- (43) REMOVE EXISTING LOUVER, PATCH OPENING WITH BRICK TO MATCH EXISTING (44) PREFINISHED ALUMINUM DOWNSPOUT
 - (45) PATCH OPENING WITH BRICK TO MATCH EXISTING

(31) REPAIR AND REPAINT ORNAMENTAL SHEET METAL CORNICE

(32) PREFINISHED ALUMINUM WINDOW UNIT

(33) LIMESTONE TO MATCH EXISTING


(38) INSULATED OVERHEAD DOOR


(40) STANDING SEAM MANSARD ROOF

(41) EXISTING GLASS BLOCK TO REMAIN

(42) REPOINT EXISTING MASONRY AS REQUIRED

(39) CANOPY SUPPORT ROD

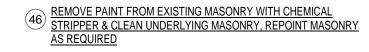

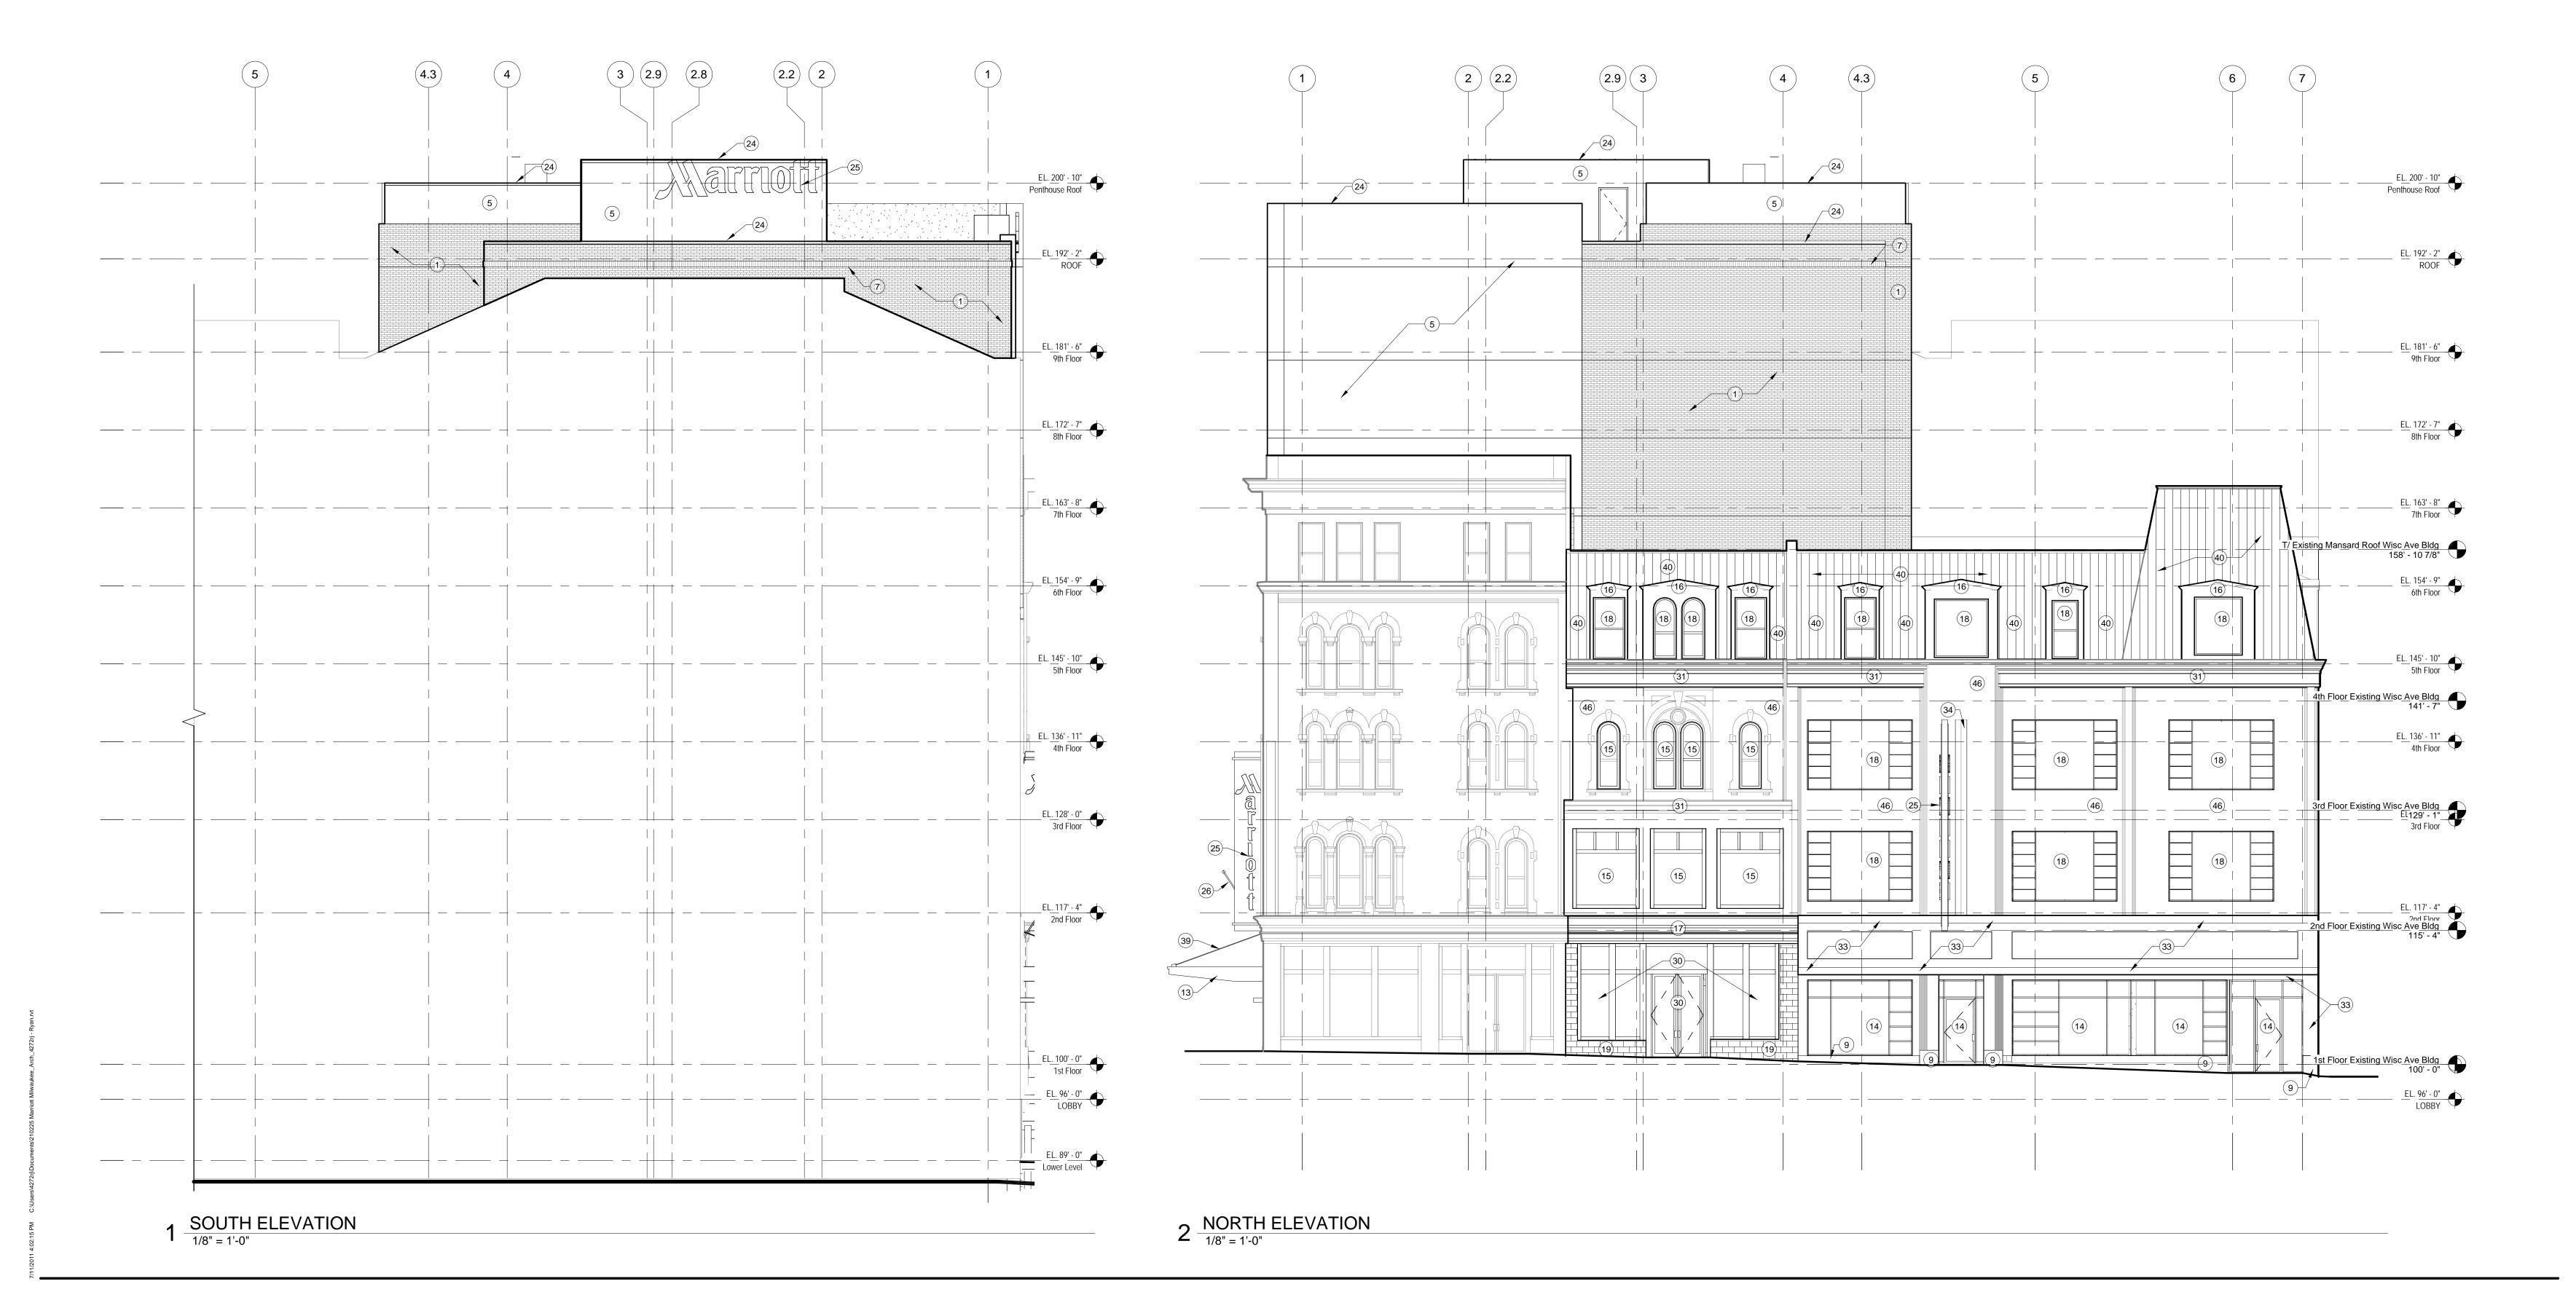

SCHEMATIC DESIGN II

JULY 11, 2011 MARRIOTT MILWAUKEE

Milwaukee, WI 53202


HOTEL

210225.00

Sheet Title **EXTERIOR ELEVATIONS**

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> Sheet No. A2.13

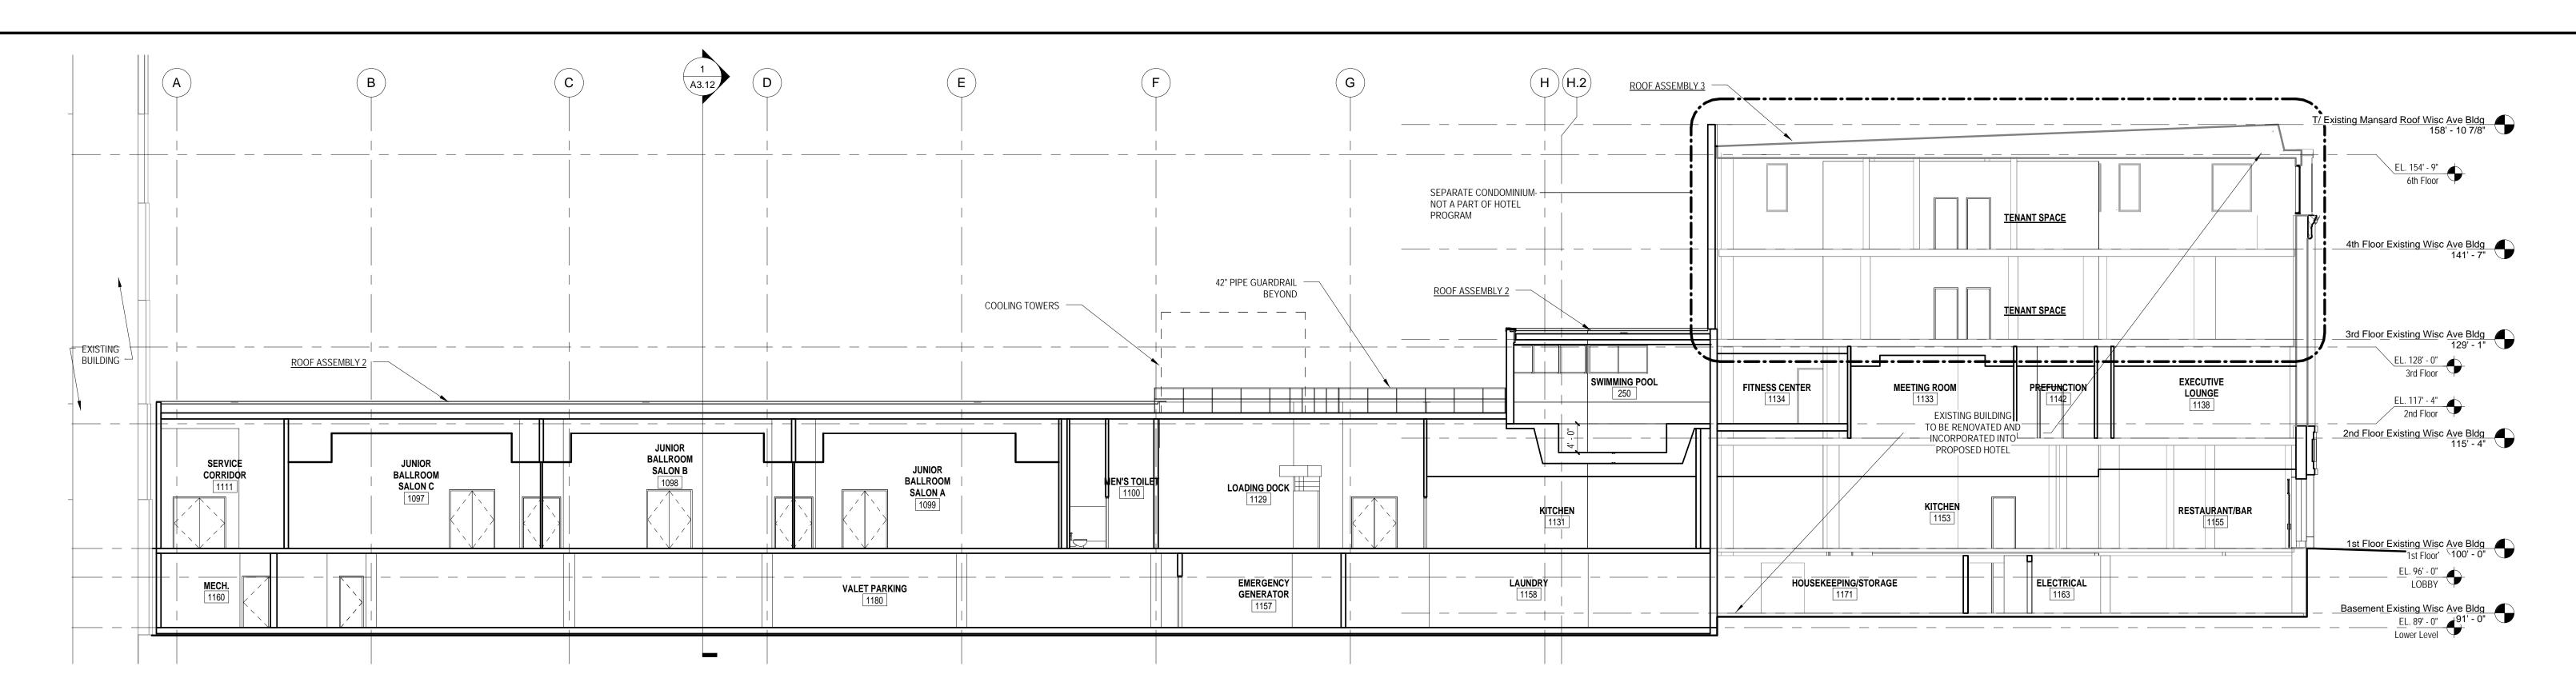


2 NORTH-SOUTH BUILDING SECTION 2

3/32" = 1'-0"

NORTH-SOUTH BUILDING SECTION 1

3/32" = 1'-0"

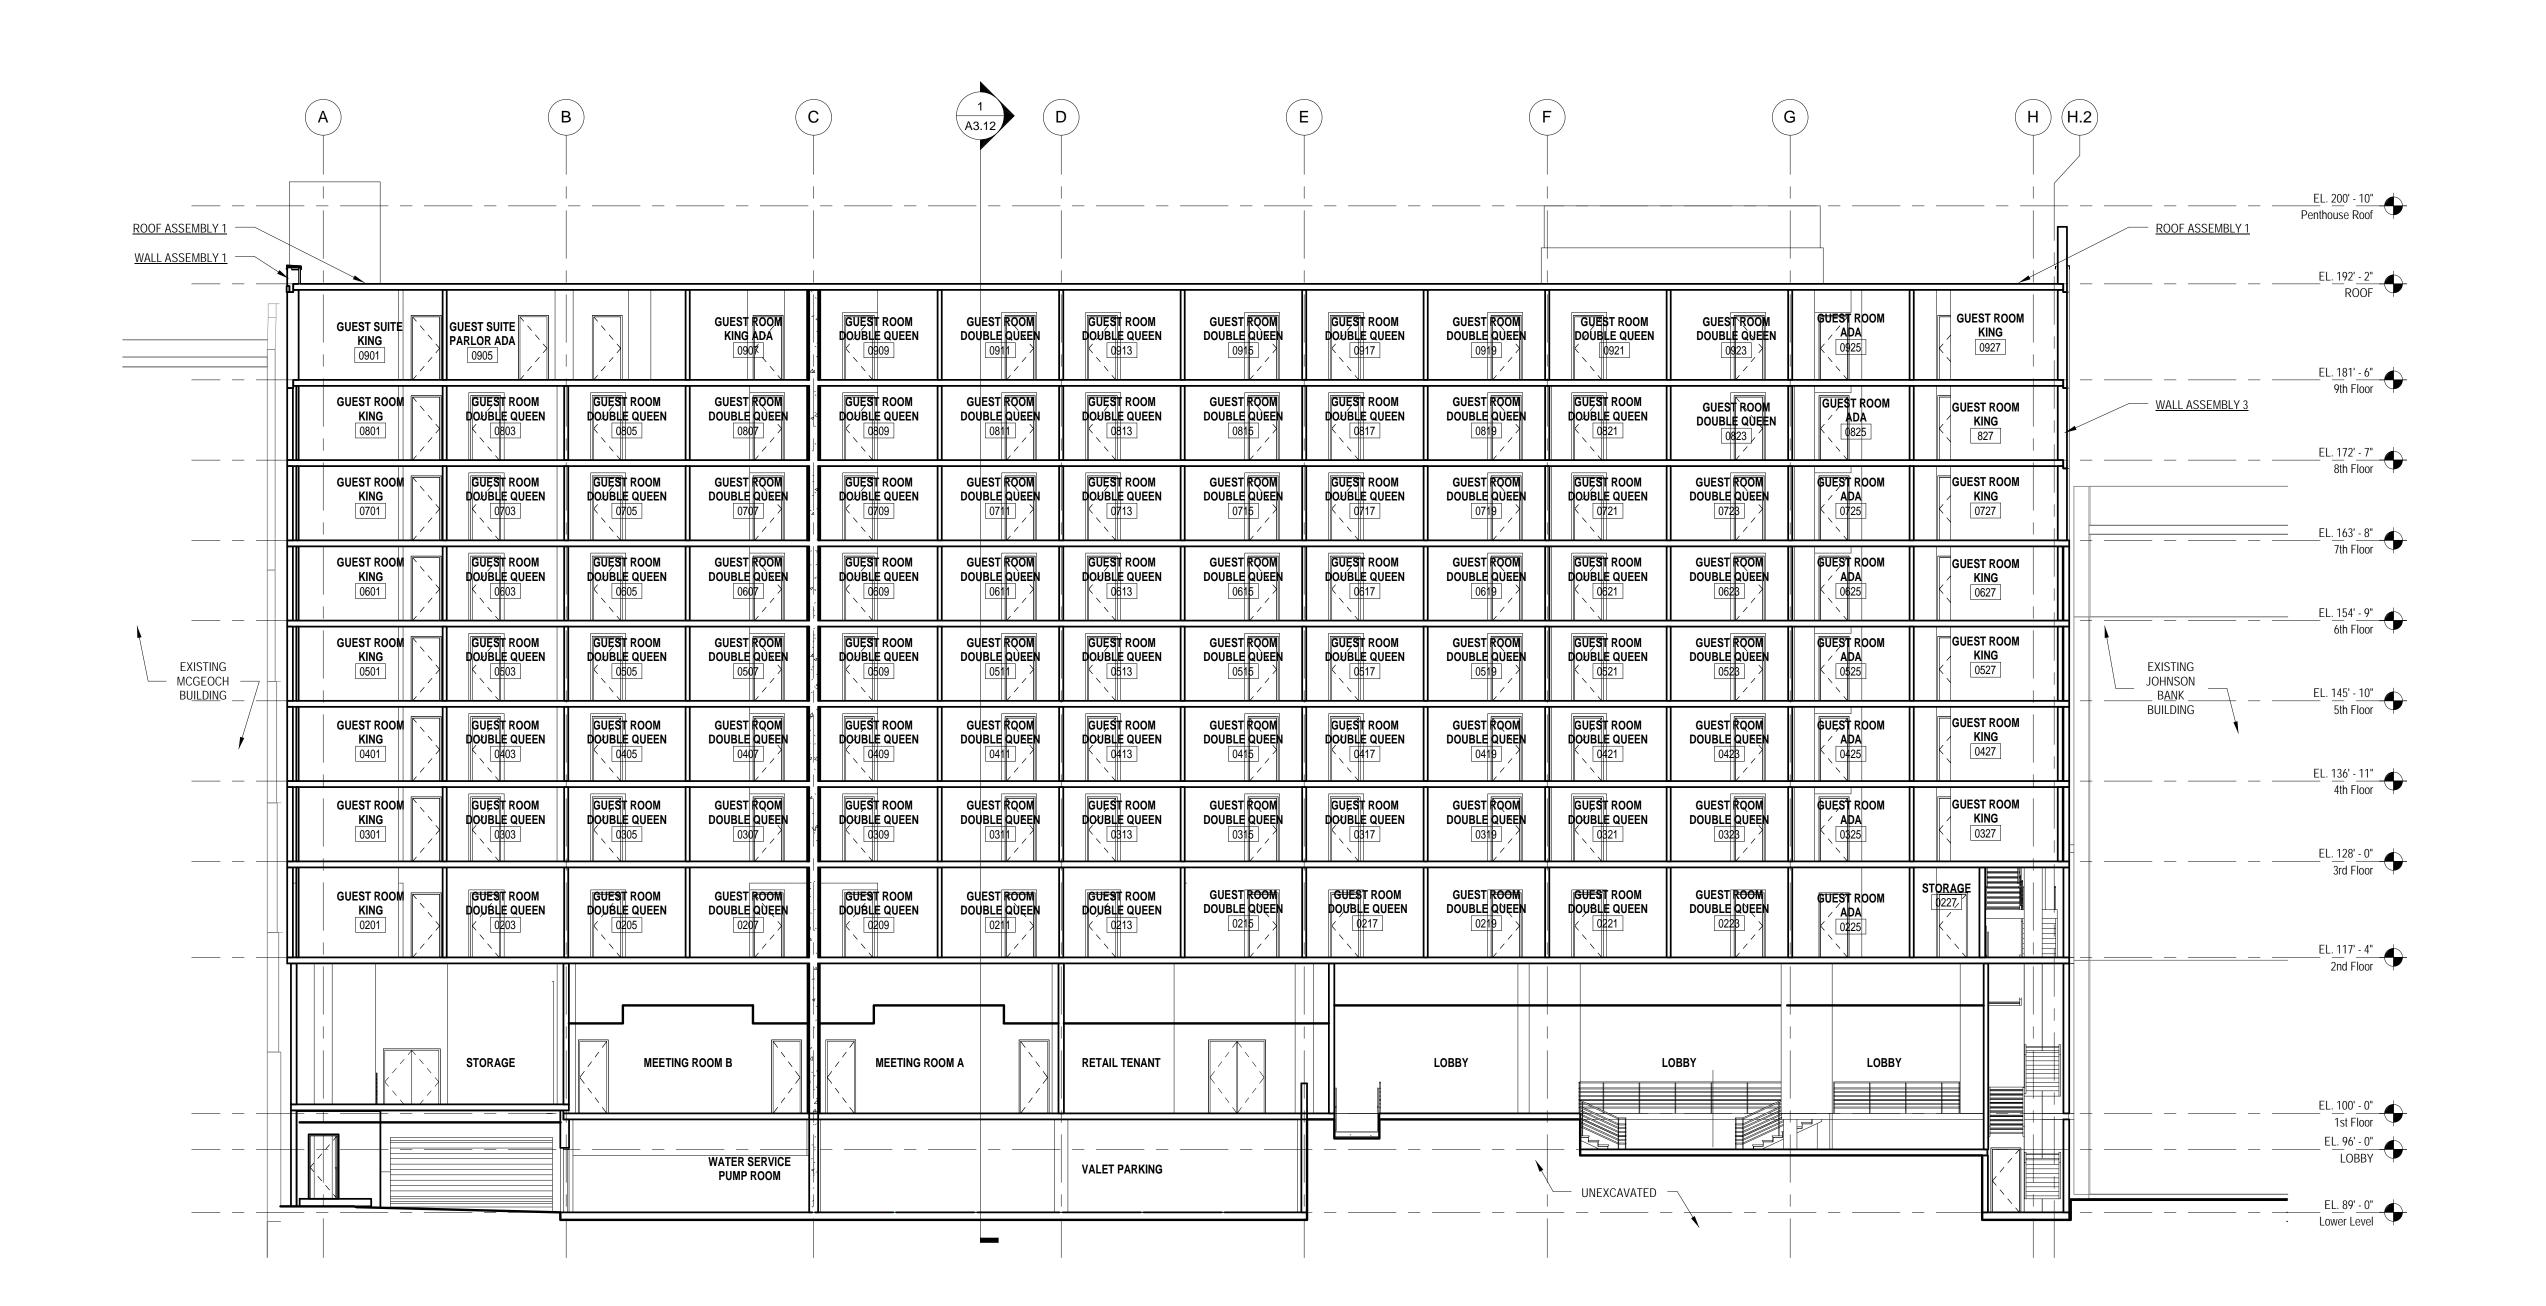

BUILDING ASSEMBLIES AND COMPONENTS

CANOPY TRELLIS 1:
PREFINISHED SHEET METAL ON STEEL FRAMING

COPING 1:
PREFINISHED ALUMINUM PARAPET CAP (FINISH TO MATCH METAL PANEL) WITH CONT. HOLD DOWN CLIPS OVER TREATED PLYWOOD OR 2X WOOD NAILERS ANCHORED TO COLD FORMED FRAMING. PROVIDE SEALANT AT UNDERSIDE OF DRIP.

GLAZING SYSTEM 1:
PRE-FINISHED ALUMINUM WINDOW WALL FRAMING SYSTEM (SIMILAR TO EFCO 2900 SERIES)
WITH 1" INSULATED LOW E GLASS UNITS (REFER TO ELEVATIONS FOR GLASS UNIT TYPE),
THERMAL BREAK, SILL FLASHING AND VARIABLE MULLION COVER DEPTHS

GLAZING SYSTEM 2:
PRE-FINISHED ALUMINUM WINDOW SYSTEM (SIMILAR TO EFCO 325X) WITH 1" INSULATED LOW E

GLASS UNITS, THERMAL BREAK, SILL FLASHING AND VARIABLE MULLION COVER DEPTHS

GLAZING SYSTEM 3: WOOD DOUBLE HUNG (FIXED) WINDOW WITH 7/8" INSULATED LOW E GLASS UNITS, CUSTOM-

<u>GLAZING SYSTEM 4:</u> CUSTOM-PROFILE WOOD STOREFRONT FRAMING SYSTEM WITH 1" INSULATED LOW E GLASS

PROFILE BRICK MOLD, HEAVY COMMERCIAL GRADE, FACTORY-PAINTED FINISH

GLAZING SYSTEM 5:
PRE-FINISHED ALUMINUM STOREFRONT FRAMING SYSTEM WITH 1" INSULATED LOW E GLASS UNITS, THERMAL BREAK AND SILL FLASHING

GLAZING SYSTEM 6:
PRE-FINISHED ALUMINUM WINDOW SYSTEM WITH 1" INSULATED LOW E GLASS UNITS, THERMAL BREAK AND SILL FLASHING. SIGHT LINE DIMENSIONS OF FRAMING MEMBERS TO MATCH EXISTING

GRAVEL STOP 1: CONT. PREFINISHED METAL PERFORATED GRAVEL STOP DETAIL STRIPPED INTO ROOF

ROOF ASSEMBLY 1:
FULLY ADHERED 60 MIL. NON-REINFORCED EPDM MEMBRANE
POLYISOCYANURATE INSULATION W/SADDLES (R-20 AVG).
PROVIDE TAPERED INSULATION AS INDICATED ON ROOF PLAN
BITUMINOUS VAPOR RETARDER

ROOF ASSEMBLY 2: DECORATIVE BALLAST

CONCRETE SLAB

UNITS, PAINTED FINISH

DECORATIVE BALLAST

2" THICK CONCRETE ROOF PAVERS AT PERIMETER OF ROOF AND SERVICE WALKS
LOOSE LAID 60 MIL. NON-REINFORCED EPDM MEMBRANE
POLYISOCYANURATE INSULATION W/SADDLES (R-20 AVG).
PROVIDE TAPERED INSULATION AS INDICATED ON ROOF PLAN

BITUMINOUS VAPOR RETARDER 5/8" GYPSUM SHEATHING (DENSDECK) METAL ROOF DECK

ROOF ASSEMBLY 3: DECORATIVE BALLAST

EXISTING WOOD DECK & STRUCTURE

DECORATIVE BALLAST
2" THICK CONCRETE ROOF PAVERS AT PERIMETER OF ROOF AND SERVICE WALKS
LOOSE LAID 60 MIL. NON-REINFORCED EPDM MEMBRANE
POLYISOCYANURATE INSULATION W/SADDLES (R-20 AVG).
PROVIDE TAPERED INSULATION AS INDICATED ON ROOF PLAN
BITUMINOUS VAPOR RETARDER

ROOF ASSEMBLY 4:
FULLY ADHERED 60 MIL. NON-REINFORCED EPDM MEMBRANE
POLYISOCYANURATE INSULATION W/SADDLES (R-20 AVG).
PROVIDE TAPERED INSULATION AS INDICATED ON ROOF PLAN
BITUMINOUS VAPOR RETARDER
EXISTING WOOD DECK & STRUCTURE

ROOF ASSEMBLY 5:
KYNAR FINISHED ARCHITECTURAL STANDING SEAM METAL ROOFING (12" FLAT PANEL)
NO. 30 FELT UNDERLAYMENT
NAILBASE INSULATION, 3/4" EXTERIOR PLYWOOD FACING, R-25 MIN.
5/8" GYPSUM SHEATHING (DENSDECK)

SOFFIT 1: RESINOUS COMPOSITE PANEL

VAPOR RETARDER

METAL ROOF DECK

WALL ASSEMBLY 1:

4" MODULAR CLAY BRICK VENEER WITH WEEP/VENTS MATCHED TO THE MORTAR COLOR REFER TO ELEVATIONS FOR DETAILS AND PATTERNS

2" RIGID INSULATION (POLYISOCYANURATE)
AIR/WATER BARRIER (GRACE PERM-A-BARRIER)
5/8" GYPSUM SHEATHING
6" COLD-FORMED METAL FRAMING @ 16" O.C. MAX.
5/8" GYPSUM BOARD AT EXPOSED LOCATIONS

WALL ASSEMBLY 2: 2" STONE VENEER

REFER TO ELEVATIONS FOR STONE TYPES AIRSPACE 2" RIGID INSULATION (POLYISOCYANURATE) AIR/WATER BARRIER (GRACE PERM-A-BARRIER) 5/8" GYPSUM SHEATHING

6" COLD-FORMED METAL FRAMING @ 16" O.C. MAX. 5/8" GYPSUM BOARD AT EXPOSED LOCATIONS

WALL ASSEMBLY 3:
COMPOSITE ALUMINUM METAL PANEL SYSTEM- DRY SEAL

2" RIGID INSULATION (POLYISOCYANURATE)
AIR/WATER BARRIER (GRACE PERM-A-BARRIER)
5/8" GYPSUM SHEATHING
6" COLD-FORMED METAL FRAMING @ 16" O.C. MAX.
5/8" GYPSUM BOARD AT EXPOSED LOCATIONS

WALL ASSEMBLY 4:
INSULATED METAL PANEL
AIR/WATER BARRIER (GRACE PERM-A-BARRIER)
5/8" GYPSUM SHEATHING
6" COLD-FORMED METAL FRAMING @ 16" O.C. MAX.

5/8" GYPSUM BOARD AT EXPOSED LOCATIONS

WALL ASSEMBLY 5:
2" STONE VENEER
REFER TO ELEVATIONS FOR STONE TYPES

AIRSPACE 2" RIGID INSULATION (EXTRUDED POLYSTYRENE) WATERPROOFING (GRACE PERM-A-BARRIER) CONCRETE WALL

WALL ASSEMBLY 6:

4" SPLIT FACE CONCRETE MASONRY UNITS
AIR SPACE

2" RIGID INSULATION (EXTRUDED POLYSTYRENE)
AIR/WATER BARRIER (GRACE PERM-A-BARRIER)

8" CONCRETE MASONRY UNITS

Revisions

SCHEMATIC DESIGN II

Drawing Date JULY 11, 2011

MARRIOTT MILWAUKEE HOTEL

Milwaukee, WI 53202

Project No. 210225.00

Sheet Title
BUILDING SECTIONS


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Sheet No.

A3.11



BUILDING ASSEMBLIES AND COMPONENTS

<u>CANOPY TRELLIS 1:</u>
PREFINISHED SHEET METAL ON STEEL FRAMING

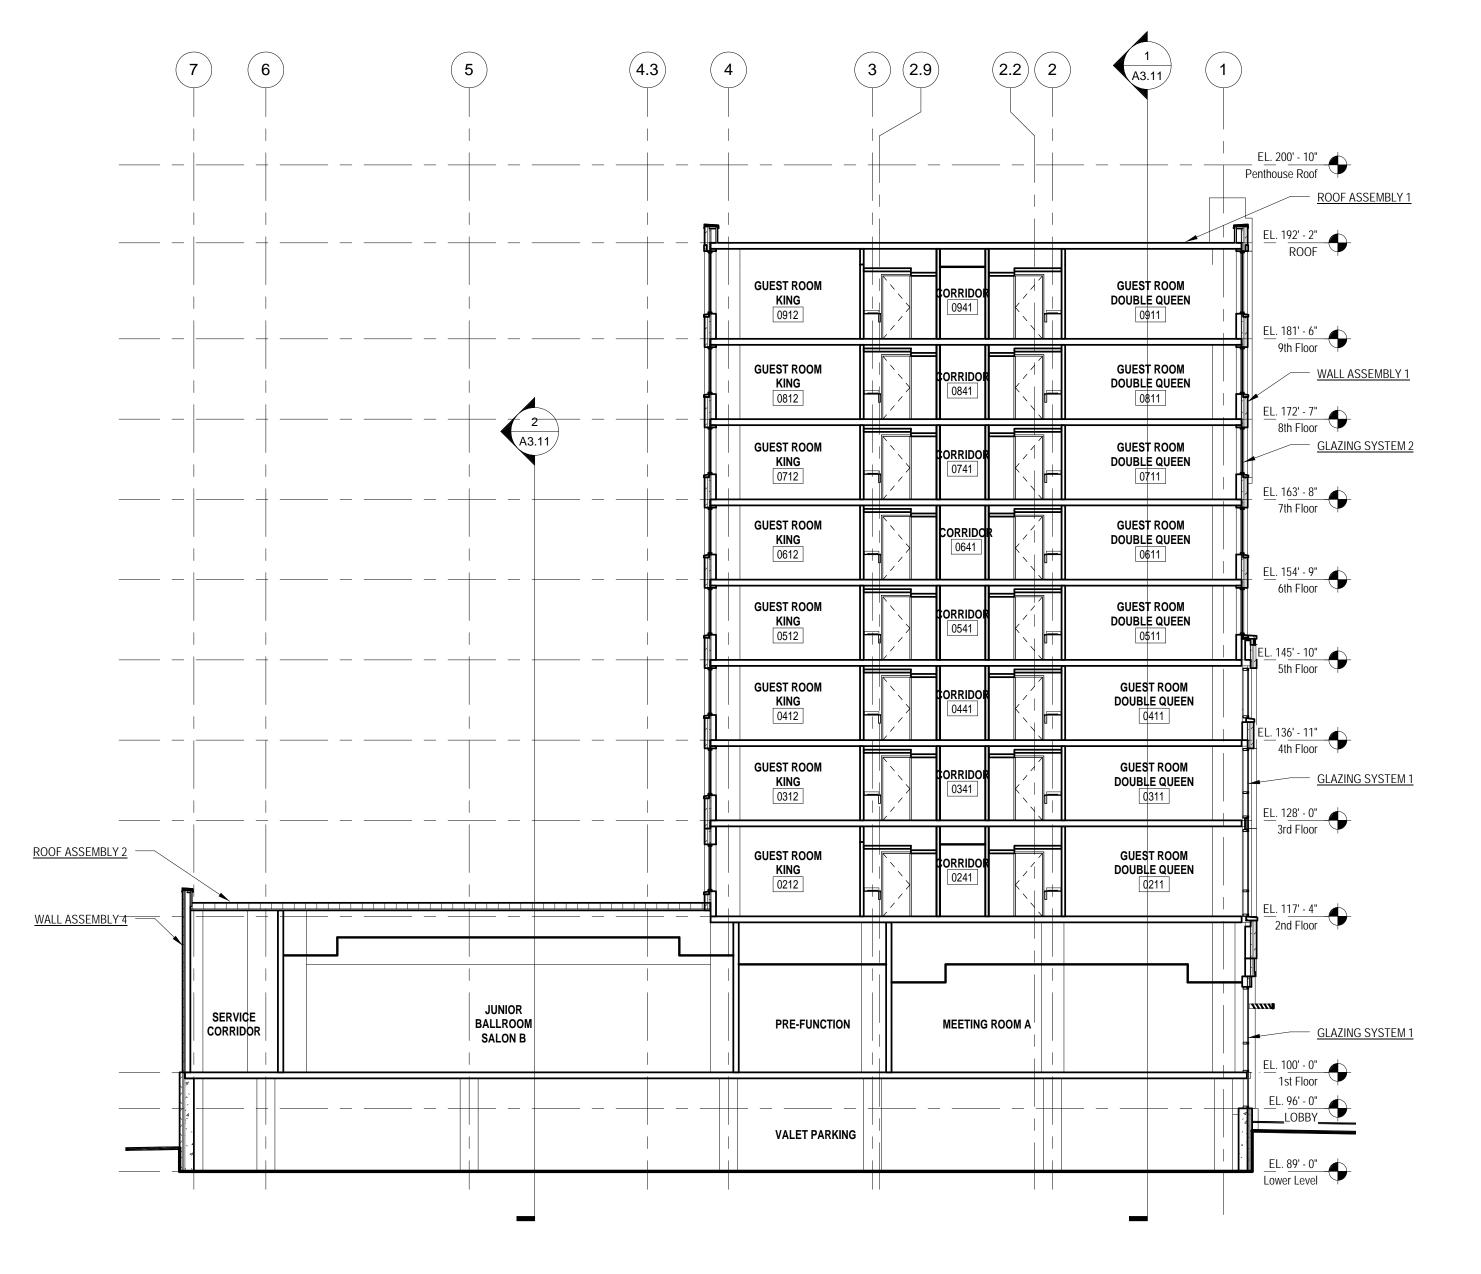COPING 1:
PREFINISHED ALUMINUM PARAPET CAP (FINISH TO MATCH METAL PANEL) WITH CONT. HOLD DOWN CLIPS OVER TREATED PLYWOOD OR 2X WOOD NAILERS ANCHORED TO COLD FORMED FRAMING. PROVIDE SEALANT AT UNDERSIDE OF DRIP.

GLAZING SYSTEM 1:
PRE-FINISHED ALUMINUM WINDOW WALL FRAMING SYSTEM (SIMILAR TO EFCO 2900 SERIES)
WITH 1" INSULATED LOW E GLASS UNITS (REFER TO ELEVATIONS FOR GLASS UNIT TYPE),
THERMAL BREAK, SILL FLASHING AND VARIABLE MULLION COVER DEPTHS

GLAZING SYSTEM 2: PRE-FINISHED ALUMINUM WINDOW SYSTEM (SIMILAR TO EFCO 325X) WITH 1" INSULATED LOW E GLASS UNITS, THERMAL BREAK, SILL FLASHING AND VARIABLE MULLION COVER DEPTHS

GLAZING SYSTEM 3:
WOOD DOUBLE HUNG (FIXED) WINDOW WITH 7/8" INSULATED LOW E GLASS UNITS, CUSTOM-PROFILE BRICK MOLD, HEAVY COMMERCIAL GRADE, FACTORY-PAINTED FINISH

<u>GLAZING SYSTEM 4:</u> CUSTOM-PROFILE WOOD STOREFRONT FRAMING SYSTEM WITH 1" INSULATED LOW E GLASS UNITS, PAINTED FINISH

GLAZING SYSTEM 5:
PRE-FINISHED ALUMINUM STOREFRONT FRAMING SYSTEM WITH 1" INSULATED LOW E GLASS

UNITS, THERMAL BREAK AND SILL FLASHING

GLAZING SYSTEM 6:

PRE-FINISHED ALUMINUM WINDOW SYSTEM WITH 1" INSULATED LOW E GLASS UNITS, THERMAL

BREAK AND SILL FLASHING. SIGHT LINE DIMENSIONS OF FRAMING MEMBERS TO MATCH EXISTING

GRAVEL STOP 1:
CONT. PREFINISHED METAL PERFORATED GRAVEL STOP DETAIL STRIPPED INTO ROOF

ROOF ASSEMBLY 1:
FULLY ADHERED 60 MIL. NON-REINFORCED EPDM MEMBRANE
POLYISOCYANURATE INSULATION W/SADDLES (R-20 AVG).
PROVIDE TAPERED INSULATION AS INDICATED ON ROOF PLAN
BITUMINOUS VAPOR RETARDER
CONCRETE SLAB

ROOF ASSEMBLY 2:
DECORATIVE BALLAST

2" THICK CONCRETE ROOF PAVERS AT PERIMETER OF ROOF AND SERVICE WALKS LOOSE LAID 60 MIL. NON-REINFORCED EPDM MEMBRANE POLYISOCYANURATE INSULATION W/SADDLES (R-20 AVG).
PROVIDE TAPERED INSULATION AS INDICATED ON ROOF PLAN BITUMINOUS VAPOR RETARDER 5/8" GYPSUM SHEATHING (DENSDECK)

ROOF ASSEMBLY 3: DECORATIVE BALLAST

METAL ROOF DECK

2" THICK CONCRETE ROOF PAVERS AT PERIMETER OF ROOF AND SERVICE WALKS LOOSE LAID 60 MIL. NON-REINFORCED EPDM MEMBRANE POLYISOCYANURATE INSULATION W/SADDLES (R-20 AVG).
PROVIDE TAPERED INSULATION AS INDICATED ON ROOF PLAN BITUMINOUS VAPOR RETARDER EXISTING WOOD DECK & STRUCTURE

ROOF ASSEMBLY 4:
FULLY ADHERED 60 MIL. NON-REINFORCED EPDM MEMBRANE
POLYISOCYANURATE INSULATION W/SADDLES (R-20 AVG).
PROVIDE TAPERED INSULATION AS INDICATED ON ROOF PLAN
BITUMINOUS VAPOR RETARDER
EXISTING WOOD DECK & STRUCTURE

ROOF ASSEMBLY 5:
KYNAR FINISHED ARCHITECTURAL STANDING SEAM METAL ROOFING (12" FLAT PANEL)
NO. 30 FELT UNDERLAYMENT
NAILBASE INSULATION, 3/4" EXTERIOR PLYWOOD FACING, R-25 MIN.
5/8" GYPSUM SHEATHING (DENSDECK)
VAPOR RETARDER
METAL ROOF DECK

SOFFIT 1: RESINOUS COMPOSITE PANEL

WALL ASSEMBLY 1:

4" MODULAR CLAY BRICK VENEER WITH WEEP/VENTS MATCHED TO THE MORTAR COLOR REFER TO ELEVATIONS FOR DETAILS AND PATTERNS

AIRSPACE

2" RIGID INSULATION (POLYISOCYANURATE)

AIR/WATER BARRIER (GRACE PERM-A-BARRIER) 5/8" GYPSUM SHEATHING 6" COLD-FORMED METAL FRAMING @ 16" O.C. MAX. 5/8" GYPSUM BOARD AT EXPOSED LOCATIONS

WALL ASSEMBLY 2: 2" STONE VENEER

2" STONE VENEER
REFER TO ELEVATIONS FOR STONE TYPES
AIRSPACE
2" RIGID INSULATION (POLYISOCYANURATE)
AIR/WATER BARRIER (GRACE PERM-A-BARRIER)
5/8" GYPSUM SHEATHING

5/8" GYPSUM BOARD AT EXPOSED LOCATIONS

WALL ASSEMBLY 3:
COMPOSITE ALUMINUM METAL PANEL SYSTEM- DRY SEAL
AIR SPACE
2" RIGID INSULATION (POLYISOCYANURATE)
AIR/WATER BARRIER (GRACE PERM-A-BARRIER)
5/8" GYPSUM SHEATHING

6" COLD-FORMED METAL FRAMING @ 16" O.C. MAX.

5/8" GYPSUM BOARD AT EXPOSED LOCATIONS

WALL ASSEMBLY 4:
INSULATED METAL PANEL

INSULATED METAL PANEL

AIR/WATER BARRIER (GRACE PERM-A-BARRIER)

5/8" GYPSUM SHEATHING

6" COLD-FORMED METAL FRAMING @ 16" O.C. MAX.

5/8" GYPSUM BOARD AT EXPOSED LOCATIONS

6" COLD-FORMED METAL FRAMING @ 16" O.C. MAX.

WALL ASSEMBLY 5: 2" STONE VENEER

REFER TO ELEVATIONS FOR STONE TYPES AIRSPACE 2" RIGID INSULATION (EXTRUDED POLYSTYRENE) WATERPROOFING (GRACE PERM-A-BARRIER) CONCRETE WALL

WALL ASSEMBLY 6:
4" SPLIT FACE CONCRETE MASONRY UNITS
AIR SPACE
2" RIGID INSULATION (EXTRUDED POLYSTYRENE)
AIR/WATER BARRIER (GRACE PERM-A-BARRIER)
8" CONCRETE MASONRY UNITS

Kahler Slater experience design

Revisions

SCHEMATIC DESIGN II

Drawing Date

JULY 11, 2011

MARRIOTT MILWAUKEE HOTEL

Milwaukee, WI 53202

Project No. 210225.00

Sheet Title
BUILDING SECTIONS

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Sheet No.
A3.12

EAST-WEST BUILDING SECTION 1
3/32" = 1'-0"



Revisions

SCHEMATIC DESIGN II

Drawing Date
JULY 11, 2011

MARRIOTT MILWAUKEE HOTEL

Milwaukee, WI 53202

Project No. 210225.00

Sheet Title


WALL SECTIONS


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SCHEMATIC DESIGN II

JULY 11, 2011

MARRIOTT MILWAUKEE HOTEL

Milwaukee, WI 53202

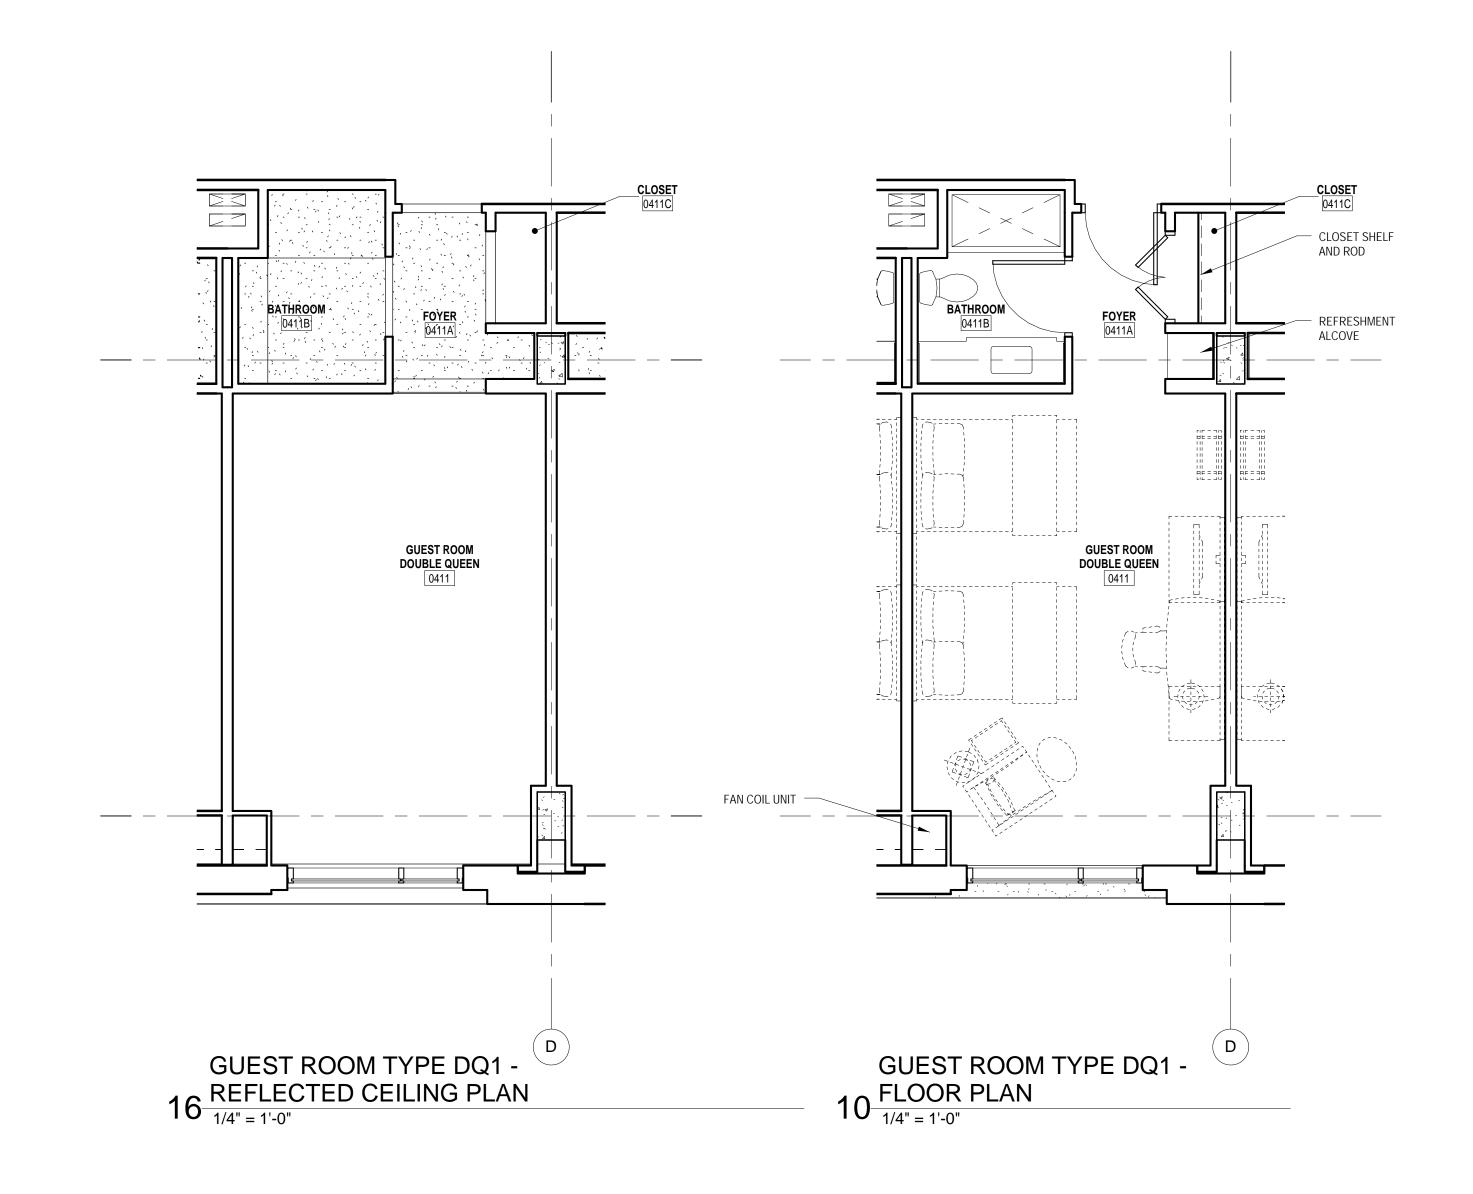210225.00

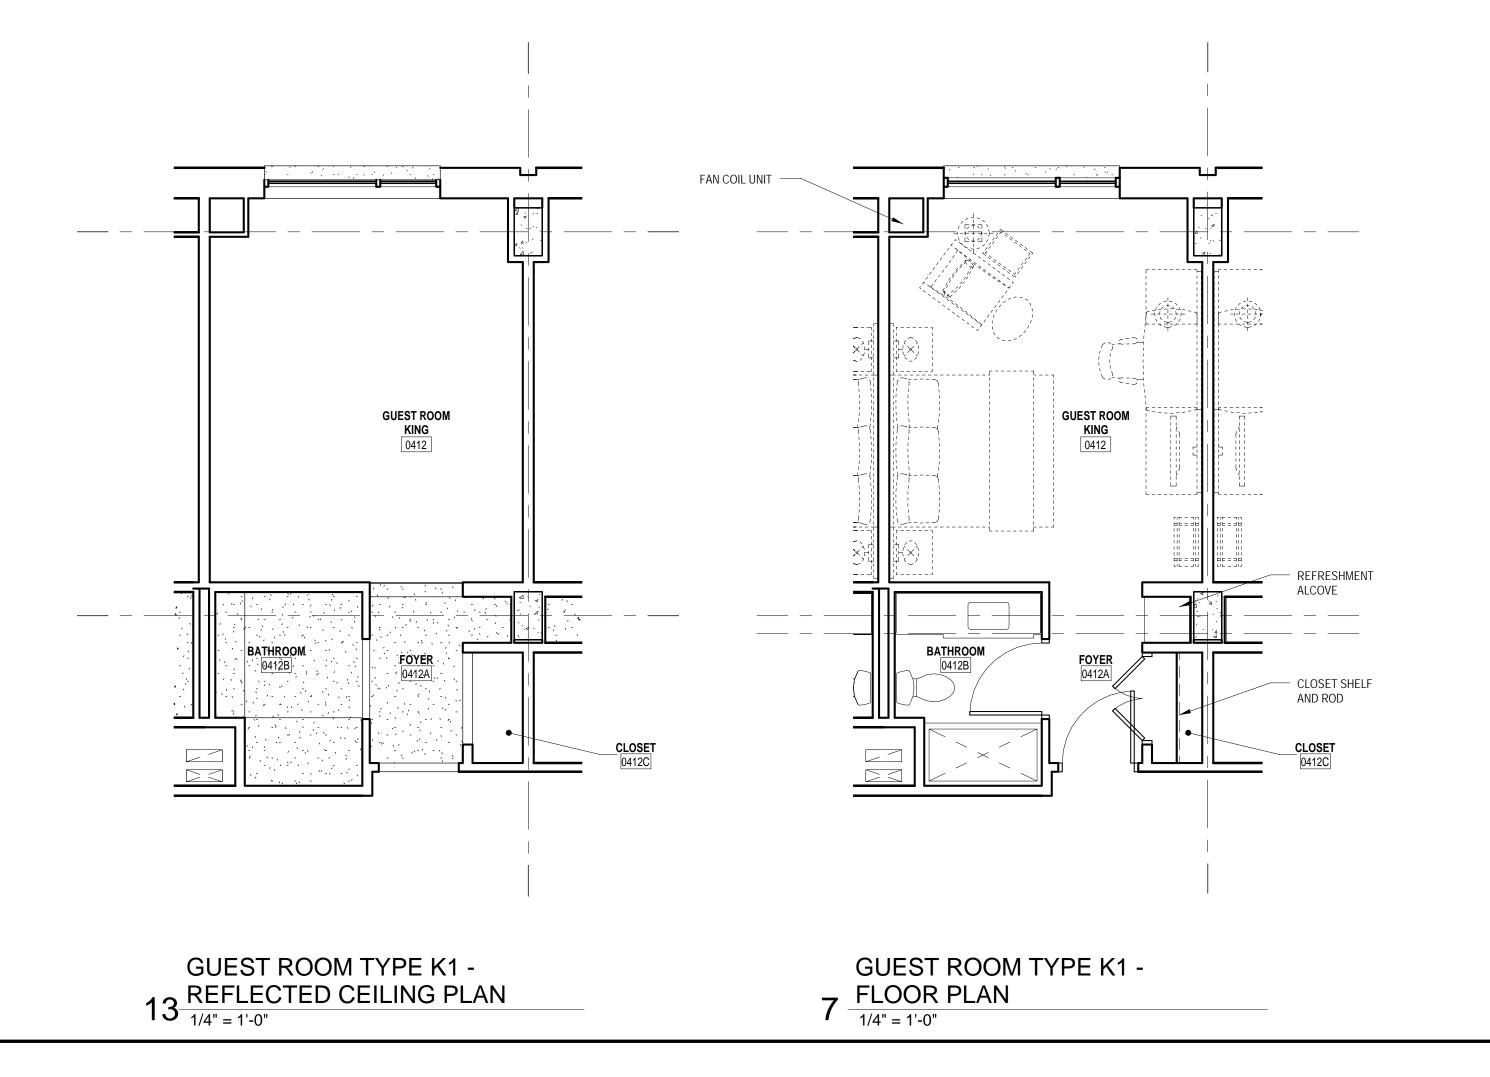
Sheet Title
ENLARGED GUEST
ROOM PLANS AND
ELEVATIONS

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Sheet No.
A4.31



<u>LEGEND</u>

---- SECTION 1/4 SECTION LINE PROPERTY LINE _ _ _ _ _ _ _ _ _ _ _ EASEMENT -x-x-x-CHAIN LINK FENCE TREE LINE OH -----OH ------ OVERHEAD UTILITY LINE E ELECTRIC T TELEPHONE FO — FO — FIBER OPTIC CTV——— CTV——— CABLE TV SAN ------ SAN ----- SANITARY SEWER FM ----- FM ---- FORCE MAIN ST— — — — ST— — — STEAM ST——ST—— STORM SEWER W------- WATER MAIN G — GAS EXISTING CONTOUR

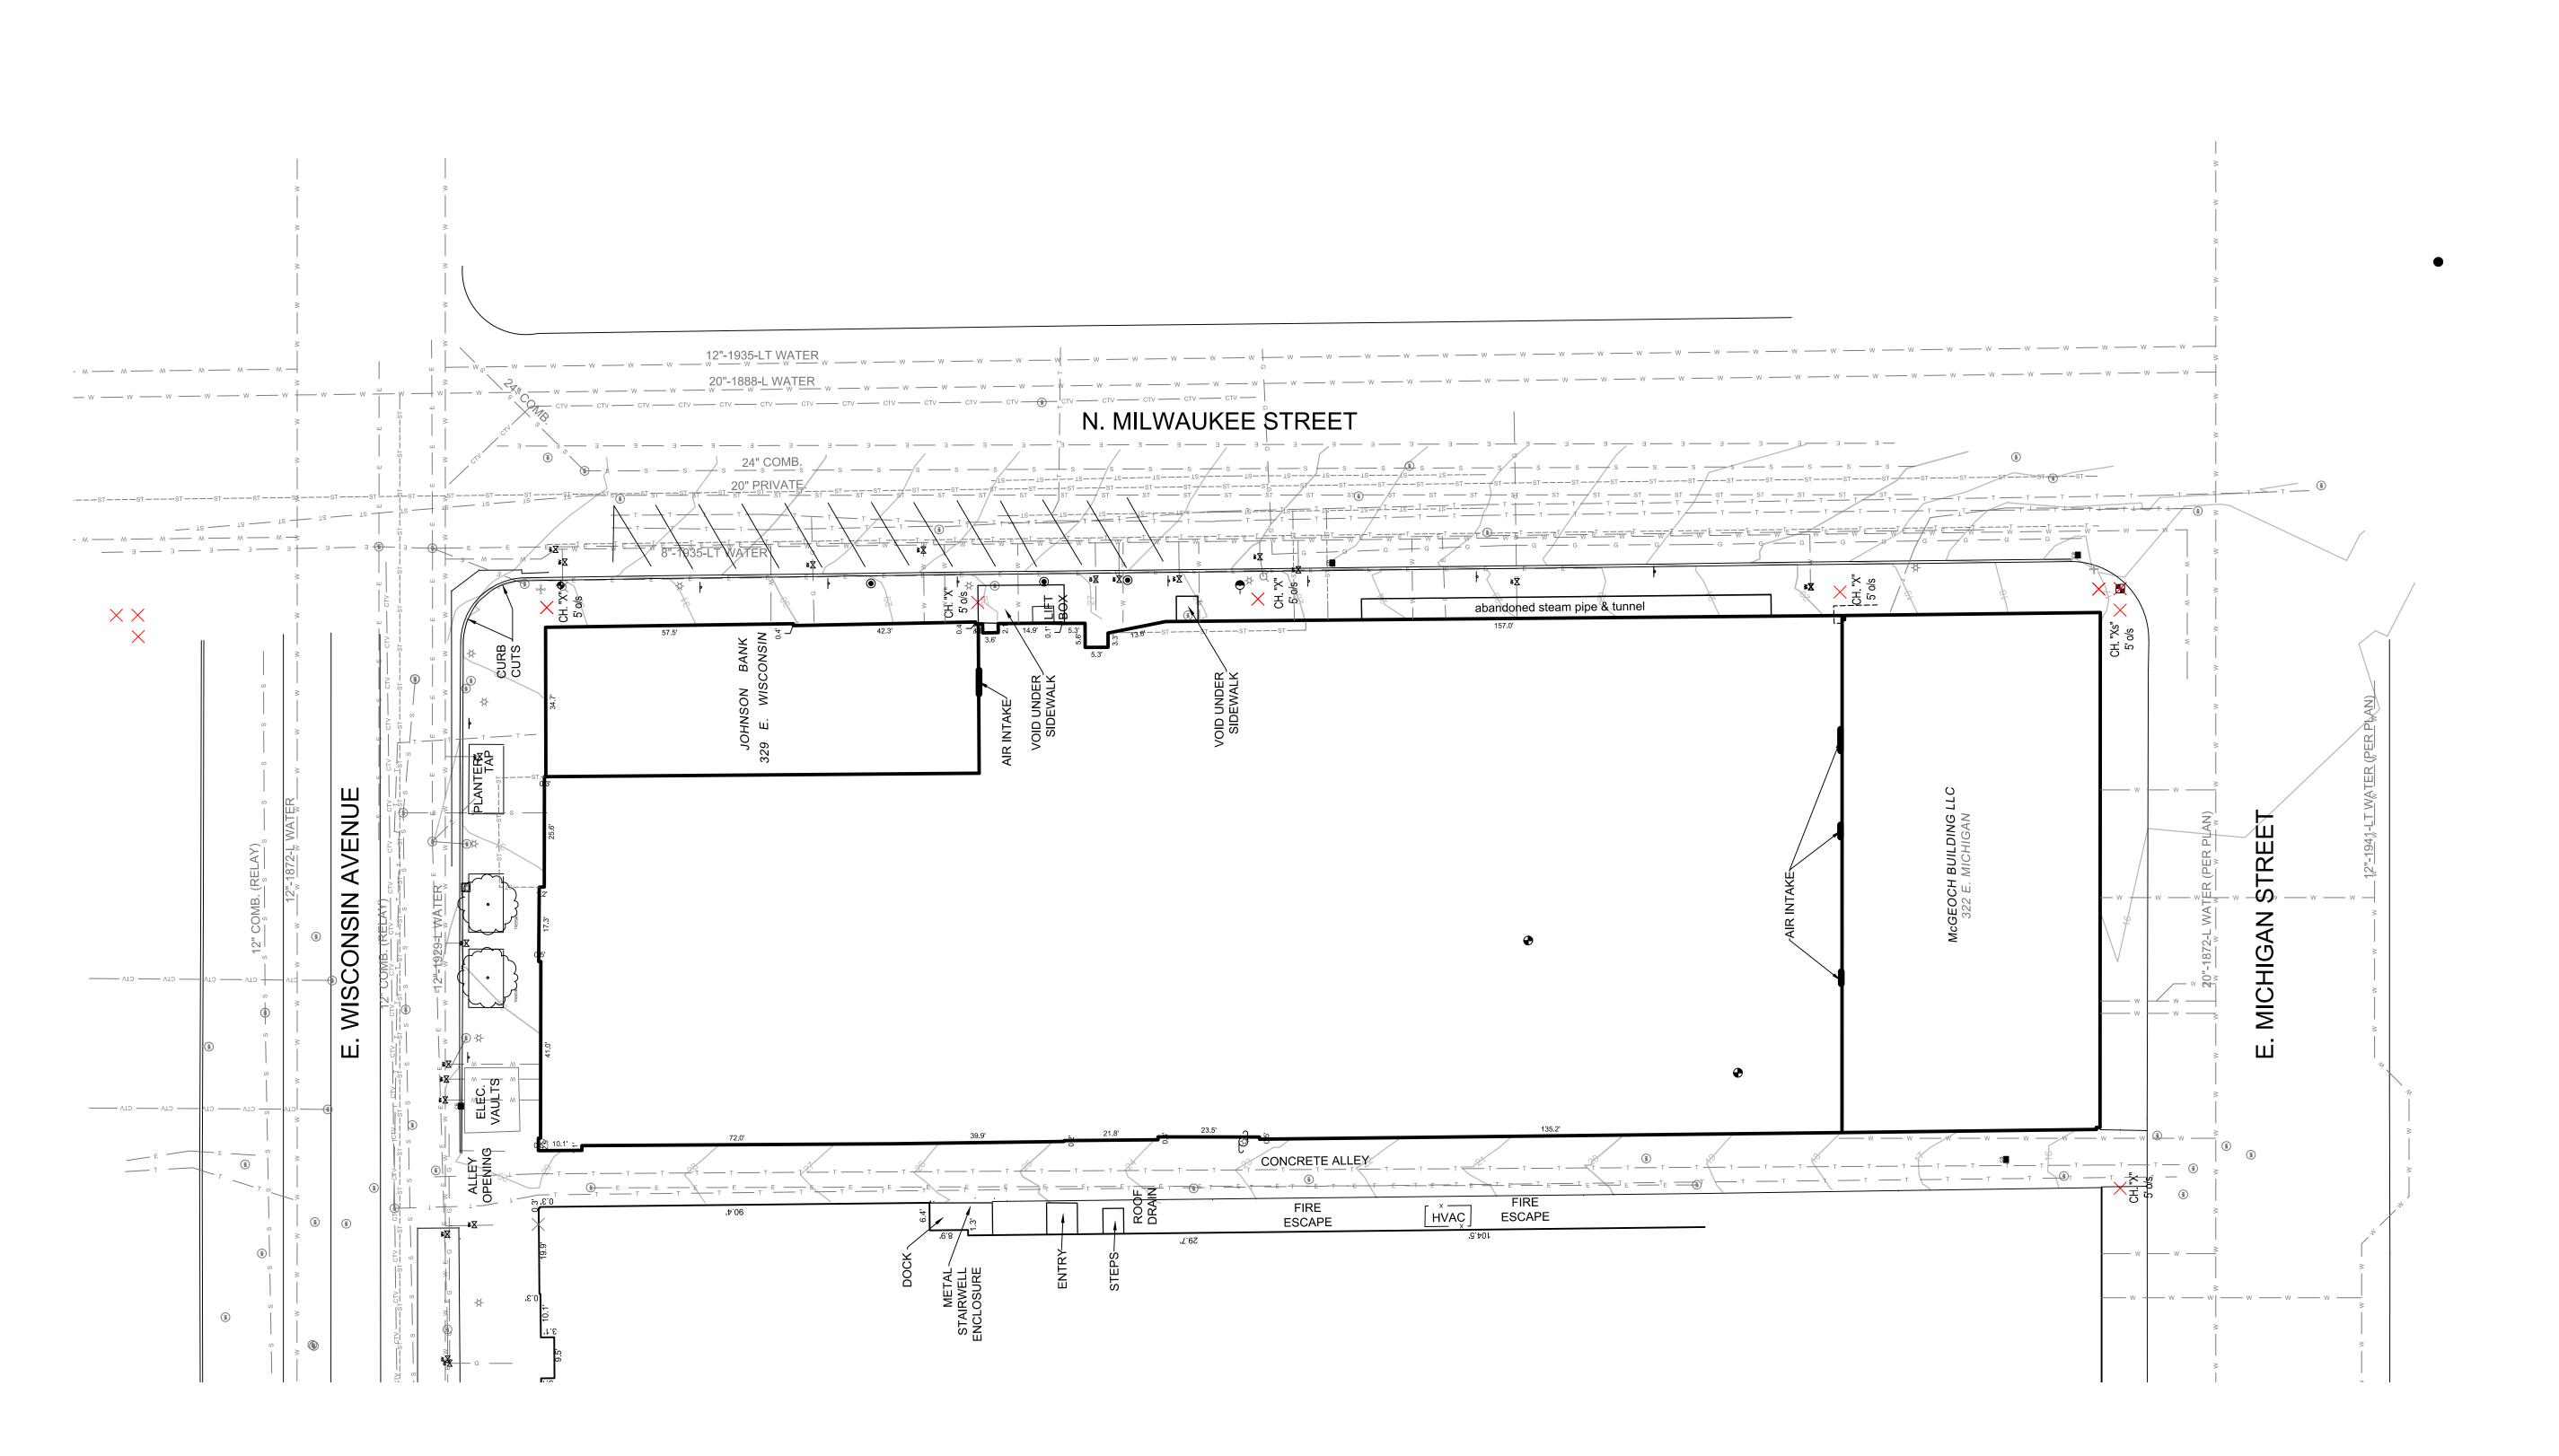MANHOLE 🖺 CATCH BASIN

● CATCH BASIN (ROUND) ⊗ CHISELED CROSS FOUND/SET ROOF DRAIN X HYDRANT ₩ WATER VALVE

₩ GAS VALVE \varnothing UTILITY POLE \leftarrow GUY WIRE GN GAS METER

CONIFEROUS TREE ■ ELECTRIC METER UTILITY PEDESTAL

TRAFFIC SIGNAL C LIGHT POLE

SOIL BORING

MONITORING WELL

ELEVATION BENCHMARKS CONVERSION FACTOR CITY OF MILWAUKEE TO NGVD 1929 = 580.60 REF. BM #1

TOP OF CAST IRON WATERTABLE

IRON PIPE FOUND/SET

REBAR FOUND/SET

SPIKE/NAIL

MONUMENT

BENCHMARK

DECIDUOUS TREE

-- SIGN

POST

⊕PK PK NAIL FOUND/SET

2.3' ABOVE TOP OF CONC. WALK AT 227 & 229 E. WISCONSIN AVE. 24.03' SE OF MONUMENT FOR W ¹/₄ SEC 28 T7N R22E NGVD 1929 ELEV. = 605.041 CITY OF MILWAUKEE ELEV. = 24.441 TOP NE FLANGE BOLT ON HYDRANT

AT THE SE CORNER OF E. WISCONSIN & N. BROADWAY NGVD 1928 ELEV. = 607.48 CITY OF MILWAUKEE ELEV. = 26.88

TOP NE FLANGE BOLT ON HYDRANT AT THE SW CORNER OF E. WISCONSIN & N. MILWAUKEE STREET MGVD 1929 ELEV. = 614.77 CITY OF MILWAUKEE ELEV. = 34.17


AT THE NE CORNER OF E. MICHIGAN & N. BROADWAY NGVD 1929 ELEV. = 598.04 CITY OF MILWAUKEE ELEV. = 17.44 AT THE NW CORNER OF 319-325 E. WISCONSIN AVE. AT THE ALLEY

1.55' ABOVE TOP CONC. WALK NGVD 1929 ELEV. = 611.00 CITY OF MILWAUKEE ELEV. = 30.40

ON THE MARBLE FACADE

TOP NE FLANGE BOLT ON HYDRANT

www.thesigmagroup.com 1300 West Canal Street Milwaukee, WI 53233 Phone: 414-643-4200 Fax: 414-643-4210

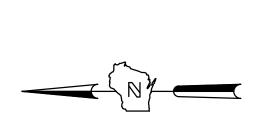

NO. REVISION DATE BY

GRAPHIC SCALE

DRAWING NO. ACAD-12528-V030-C.dwg DRAWN BY: KAS

DATE: MARCH 2, 2011 PROJECT NO: 12528

CHECKED BY: BMR APPROVED BY: JJN

SHEET NO .: