

Certificate of Appropriateness

Milwaukee Historic Preservation Commission/200 E. Wells Street/Milwaukee, WI 53202/phone 414-286-5712/fax 414-286-3004

Property

3138 W. KILBOURN AV.

Description of work Reconstruction of original north façade of the Concordia Gymnasium/Tthigwe Building with new accessible entrance at NE corner in the style of other approved accessible entries previously added within the campus. Masonry repairs are to be conducted in accordance with the conditions below. A sample of masonry work and mortar has already been approved. Conditions are applied only to the masonry approvals. All other features of the project are approved as drawn, including windows, rooftop solar solar array and rooftop mechanicals. 11/21/2022 PTS ID 115231 COA: DEMO/RECONSTRUCT POOL/GYM (TTHIGWE)

Date issued


In accordance with the provisions of Section 320-21 (11) and (12) of the Milwaukee Code of Ordinances, the Milwaukee Historic Preservation Commission has issued a certificate of appropriateness for the work listed above. The work was found to be consistent with preservation guidelines. The following conditions apply to this certificate of appropriateness:


New mortar must match the original mortar in terms of color, texture, grain size, joint width, and joint finish/profile. The compressive strength of the repointing mortar shall be equal or less than the compressive strength of the original mortar and surrounding brick or stone. The replacement mortar shall contain approximately the same ingredient proportions of the original mortar. Mortar that is too hard is subject to premature failure and could damage the masonry. See the city's books As Good As New or Good for Business, Masonry Chapters, for more information. In most cases, this means a lime mortar with natural hydraulic cement rather than Portland cement. No joint of a width less than 3/8" may be cleaned of damaged/decomposed mortar with power disc grinders. No over-cutting of the joints is permitted. Remove decomposed mortar back into the wall 2.5 times the height of the joint before repointing. When installing new flashing at a masonry feature, the flashing must be stepped or cut into the mortar joints. The bricks may not be cut to install flashing at an angle.

New brick/stone/terra cotta must match as closely as possible the color texture, size, and finish of the original.

A sample panel of the masonry materials and their mortar must be reviewed and approved by HPC staff prior to general installation of the material. UNDER NO CIRCUMSTANCES SHALL UNPAINTED MASONRY BE PAINTED, BE GIVEN A WATERPROOFING TREATMENT, OR CLEANED BY ABRASIVE MEANS; THIS STATEMENT SUPERSEDES ANY OTHER WORDING IN THIS DOCUMENT INDICATING THE CONTRARY.

All work must be done in a craftsman-like manner, and must be completed within one year of the date this certificate was issued. Staff must approve any changes or additions to this certificate before work begins. Work that is not completed in accordance with this certificate may be subject to correction orders or citations. If you require technical assistance, please contact hpc@milwaukee.gov. If permits are required, you are responsible for obtaining them from the Milwaukee Development Center. If you have questions about permit requirements, please consult the Development Center's web site, www.milwaukee.gov/build , or call (414) 286-8210.	
City of Milwaukee Historic Preserva Copies to: Development Center, Ald. Robert Bauman, Contractor, Inspector Dave Pedersen (286-2540)	tion Staff
11 pages total	

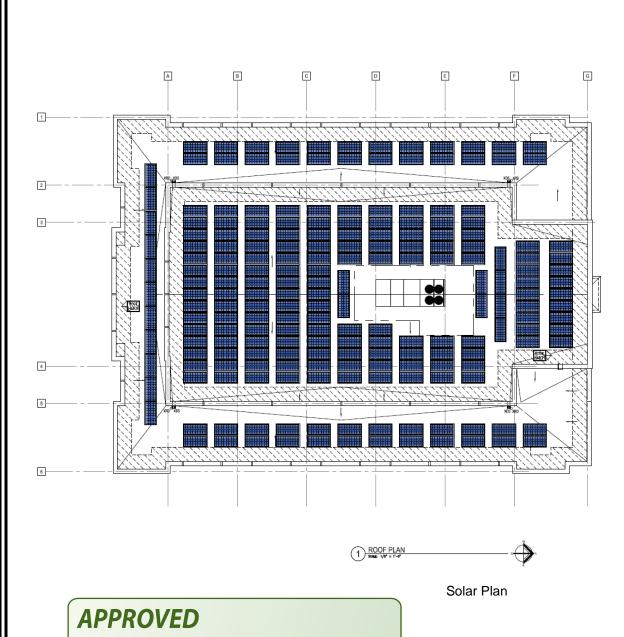

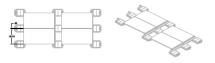



72 CELL MODULE
ECOFOOT2 PORTRAIT ELEVATION/ISO VIEWS

SOLAR PANEL MOUNTING SYSTEM EXAMPLE
SOLD NO SOLE





3 PRECEDENT IMAGE



PRECEDENT IMAGE

By Tim Askin - Milwaukee HPC at 1:31 pm, Nov 21, 2022

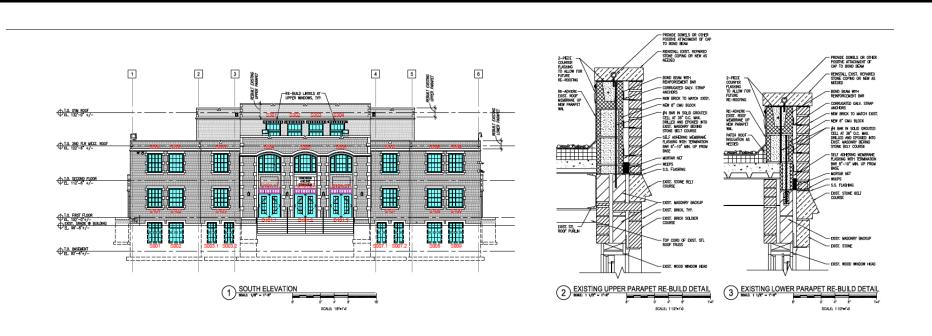

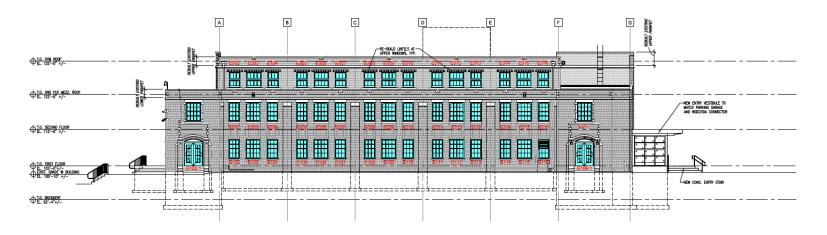

EAST ELEVATION

SOME 1/0" - 1'-0"

SCALE; 1/0" + 0'


SCALE; 1/0" + 0'


KEY: REPLACE

APPROVED

By Tim Askin - Milwaukee HPC at 1:31 pm, Nov 21, 2022

PROPOSED

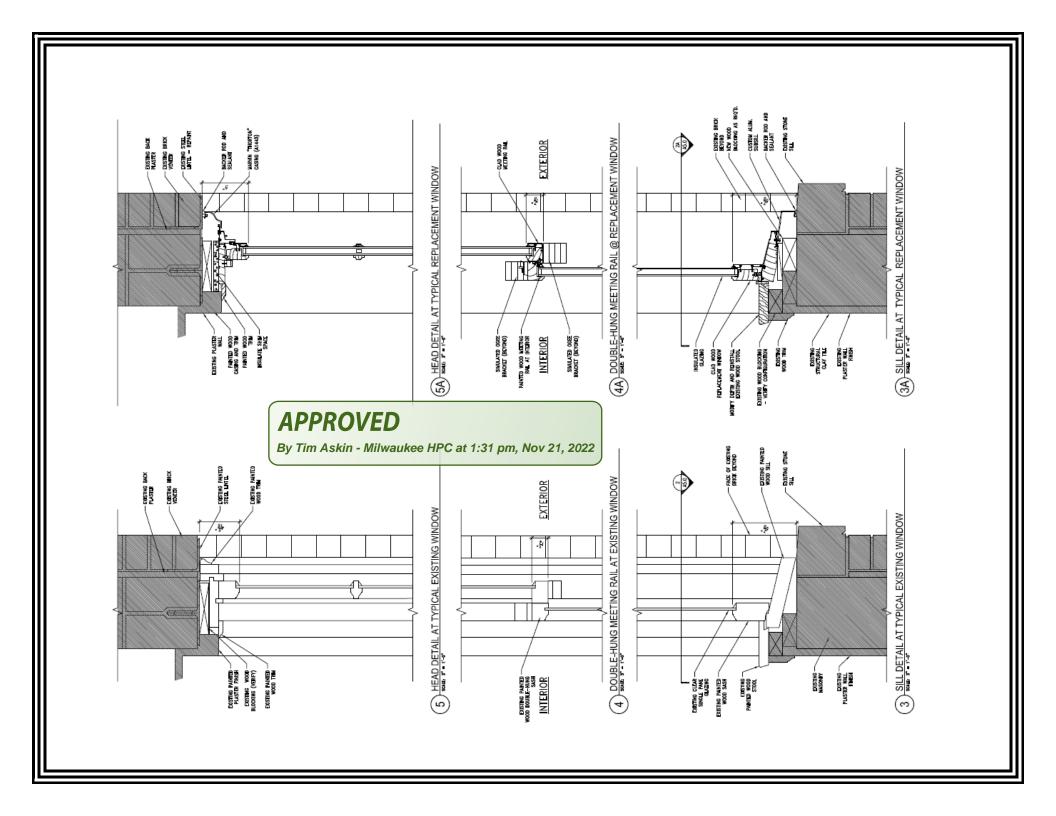

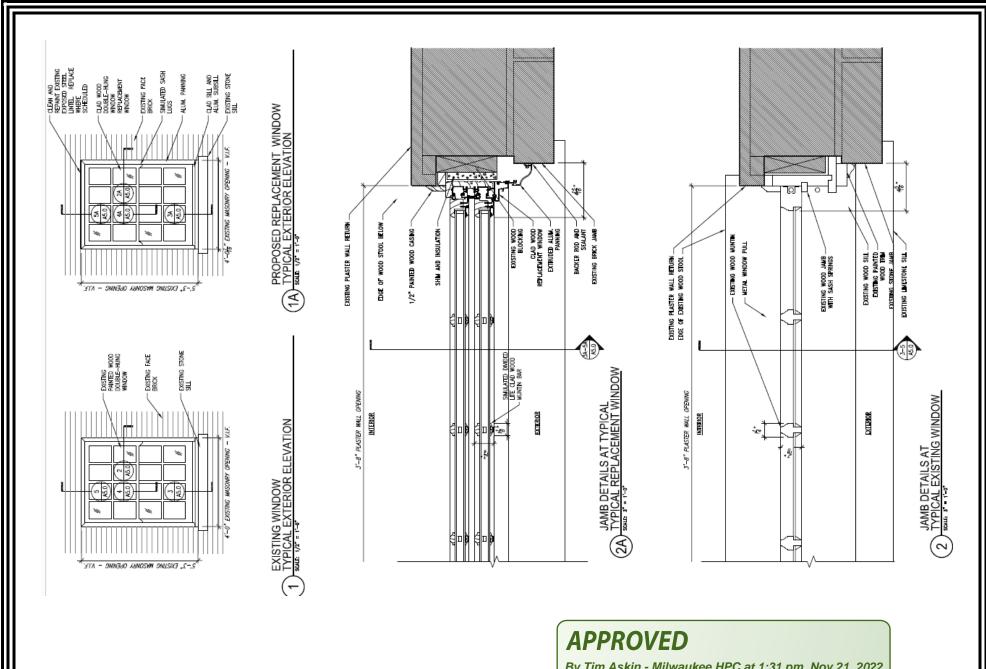

By Tim Askin - Milwaukee HPC at 1:31 pm, Nov 21, 2022

GENERAL NOTES

- FIELD CONDITIONS MAY VARY FROM DRAWINGS. REFINED SURVEY OF ACTUAL EXISTING CONDITIONS WILL NEED TO TAKE PLACE ONCE SCAFFOLDING IS ERECTED AND MASONRY CAN BE CLOSELY EVALUATED.
- 2. STONE TYPES: ALL ORNAMENTAL STONEWORK ARE COMPRISED OF INDIANA LIMESTONE.
- 3. MASK OFF ALL NON-MASONRY SURFACES THAT MAY BE DAMAGED DURING ENTIRE RESTORATION PROCESS.
- 4. MASONRY CONTRACTOR TO EVALUATE WITH ARCHITECT 100% OF THE EXISTING MORTAR FOR CUTTING AND REPOINTING OF ALL MASONRY SURFACES. BID TO INCLUDE REPOINTING AS NOTED PER BUILDING GENERAL NOTES.
- 5. REFER TO WRITTEN SPECIFICATION FOR SPECIFIC MATERIALS, PRACTICES, AND TECHNIQUES.
- 6. PROVIDE MOCK-UP SAMPLES ON THE BUILDING OF ALL RESTORATION TREATMENTS FOR ARCHITECT APPROVAL PRIOR TO IMPLEMENTATION, REFER TO WRITTEN SPECIFICATIONS FOR REQUIREMENTS.
- 7. TYPES OF STONE REPAIR A. EPOXY INJECTION (TO REPAIR LARGE

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- FRACTURES IN MASONRY UNITS), SEE SHEET
- B. DUTCHMAN (TO REPAIR LARGE CHIPS AND HOLES). SEE SHEET A5.0-1.
- C. RESTORATION MORTAR PATCH (TO REPAIR FACE DAMAGE, SPALLING OR OTHER STONE DECOMPOSITION, AS WELL AS DETAILED ORNAMENTAL WORK). SEE SHEET A5.0-1.

- D. SMALL SURFACE CRACKS MAY BE RESTORED WITH LIME INJECTION MORTARS OR EPOXY INJECTION MORTARS TO MATCH ADJACENT STONE.
- 8. TYPES OF BRICK REPAIR A. REPLACE ALL SPALLED BRICK. REPLACE ALL FRACTURED BRICK. C. USE MATCHING SALVAGED BRICK UNITS.
- INDIAN LIMESTONE TRIM: MORTAR JOINTS: 100% CUT AND REPOINTING. B. SPALLING: PATCH AREAS OF SPALLING WITH CUSTOM MATCHED NATURAL STONE RESTORATION MORTAR (LIME PUTTY BASED,
- NOT SYNTHETIC OR EPOXY). C. HAIRLINE CRACKS: REPAIR WITH CUSTOM
- COLORED DISPERSED LIME INJECTION.
- D. EFFLORESCENCE AND SUB-FLORESCENE: NEUTRALIZE SALTS.
- E. SKY JOINTS AT COPING AND TRIM: FINISH ALL JOINTS WITH APPROPRIATE SEALANT (EXAMPLE: SONNEBORN NP-1 COLORED TO MATCH THE STONE FINISHED WITH SAND). FOR A LONGER TERM FIX CONSIDER LEAD JOINTS.
- 10. BRICK: BRICK SHOULD BE CAREFULLY CLEANED TO REMOVE SURFACE GRIME. A. REPLACEMENT: THIS TYPE OF BRICK IS STILL MANUFACTURED TODAY AND MATCHING UNITS IN THIS SIZE MAY BE AVAILABLE.
- 11. MORTAR JOINTS: 100% CUT AND REPOINT. MORTAR IS DETERIORATED. LARGE VOIDS ARE EVIDENT BEHIND THE CURRENT FACE MORTAR.

B. REPLACE ALL SPALLED AND FRACTURED UNITS.

- A. BUTTER JOINTS MUST BE HAND REMOVED AS SAW CUTTING WOULD WIDEN THE JOINTS AND DAMAGE THE BRICK UNITS.
- 12. INSTALL A SOFT JOINT AT WALL FACE JUNCTIONS WITH PAVED SURFACES (SONNEBORN NP-1)
- 13. CLEANING: RECOMMEND CLEANING ALL MASONRY TO REMOVE ATMOSPHERIC SOILING AND ORGANIC MATTER: TESTING IS VITAL TO EXECUTE ON SITE PRIOR TO ESTABLISHING THE PROPER MATERIALS AND TECHNIQUES TO NOT DAMAGED OR ETCH THE
- 14. REMOVE ALL ANCHORS BRACKETS AND BOLTS NO LONGER ESSENTIAL AND PATCH HOLES.
- 15. REPOINT ALL MORTAR JOINTS JUST BELOW SILLS
- 16. SEE SHEET A5.0-1 FOR MASONRY REPAIR DETAILS
- 17. NEUTRALIZE SEVERE EFFLORESCENCE. SEE SPECIFICATIONS FOR GENERAL EFFLORESCENCE

CONSTRUCTION NOTES

- (1) NEW CONC. FOUNDATIONS OR RETAINING
- NEW CONC. ENTRY STAIR w/ MTL HANDRAILS
- RE-BUILD PARTIAL HEIGHT BRICK WALL. REINSTALL SALVAGED LIMESTONE CAPS AND
- (4) RE-BUILD PARAPET UP FROM LIMESTONE BELT COURSE. REINSTALL SALVAGED INTACT MASONRY. SPALLED AND FRACTURED BRICK SHALL NOT BE REUSED. MATCH CONSTRUCTION OF EXISTING PARAPET. REPAIR EXISTING LIMESTONE COPING AND REPLACE SEVERELY DAMAGED WITH NEW OR SALVAGED TO MATCH EXISTING. SEE ALSO SHEET A5.0-1.
- NEW FIXED LADDER w/ PARAPET PLATFORM AND ROOF SIDE RETURN TO ACCESS UPPER ROOF. SEE DETAIL 10/A5.0-1.
- NEW ROOF SCUPPER AND MTL DOWNSPOUT. REINSTALL ANY EXIST. CLEANED AND REFURBISHED LIMESTONE ELEMENTS.
- REINSTALL EXIST. ELECTRICAL EQUIPMENT AND/OR FIXTURE.

- 8 RE-BUILD EXISTING PARAPET UP FROM EXIST. WINDOW HEAD. REINSTALL SALVAGED INTACT MASONRY AND LIMESTONE. SPALLED AND FRACTURED BRICK SHALL NOT BE REUSED. MATCH CONSTRUCTION OF EXISTING PARAPET. REPAIR EXISTING LIMESTONE COPING AND REPLACE SEVERELY DAMAGED WITH NEW OR SALVAGED TO MATCH EXISTING. SEE ALSO SHEET A5.0-1.
- 9 INSTALL NEW LINTELS ABOVE WINDOWS, SEE STRUCTURAL
- (10) REINSTALL EXIST. REFURBISHED LIMESTONE OVERFLOW SCUPPER. REPLACE SEVERELY DAMAGED LIMESTONE ELEMENTS w/NEW LIMESTONE TO MATCH EXIST.
- (11) NEW CONC. RAMP w/ MTL GUARD AND HANDRAIL.
- 12) NEW ENTRY VESTIBULE PART OF FUTURE BID PACKAGE #2.
- (13) NEW FENCE TO MATCH EXIST. 14) NEW TRASH ENCLOSURE BEYOND, SEE
- (15) INFILL OPENING IN FOUNDATION WHERE DOOR AND FRAME HAS BEEN REMOVED

SHEET L2.0-1

- (16) NEW CONC. SLAB AT LOADING DOCK (17) NEW STANDING SEAM MTL ROOF AT
- MECHANICAL DOGHOUSE. (18) NEW MECHANICAL GRILLE
- (19) ASSESS CONDITION OF NEWLY EXPOSED BRICK VENEER AT NORTH WALL AFTER REC. CENTER HAS BEEN DEMOLISHED. PATCH,

THE CONDITIONS MATCH THE PARAPETS ON

THE ADJACENT WALLS DISMANTLE PARAPET

DOWN TO LIMESTONE BAND AND REFER TO

REMOVING WALL INFILL AT THESE LOCATIONS

ENCLOSURE FOR BUILDING SECURITY AND

PROTECTION FROM WEATHER INFILTRATION.

22A) NEW ALUM. CLAD WOOD WINDOW w/ CLEAR

CONSTRUCTION NOTE 4 OTHERWISE SEE

(22) NEW WINDOWS TO BE INSTALLED AS PART

PROVIDE A TEMPORARY OPENING

OF FUTURE BID PACKAGE #2. AFTER

CONSTRUCTION NOTE 19.

GLAZING. MATCH EXIST.

- CLEAN AND TUCK POINT BRICK VENEER. (24) REPAIR CRACKED OR SPALLED LIMESTONE. 20 INFILL MASONRY WALL TO MATCH EXIST. CONSTRUCTION WHERE DOORS HAVE BEEN REMOVED.
- (25) REPAIR CRACKING AND/OR STEP CRACKING IN BRICK. REPLACE FRACTURED, SPALLED (21) ACCESS CONDITION OF THE PARAPET AFTER AND/OR MISSING BRICK. REC. BUILDING HAS BEEN DEMOLISHED. IF
 - (26) REPAIR DAMAGED BRICK AT PREVIOUS LIGHT FIXTURE LOCATION.

LIMESTONE REPAIR METHOD.

22B NEW ALUM. CLAD WOOD WINDOW W/

22C NEW ALUM FIXED WINDOW W/ CLEAR

GLAZING. MATCH EXIST.

OPAQUE GLAZING. MATCH EXIST.

(23) REINSTALL SALVAGED LIMESTONE COPING

CAPS FROM PREVIOUSLY REMOVED REC.


SEE GENERAL NOTE #7 FOR SPECIFIC


BUILDING AT NEWLY EXPOSED NORTH WALL.

- (27) REPAIR HOLES IN MASONRY, SEE ALSO CONSTRUCTION NOTE 25.
- (28) CLEAN TAR OFF OF LIMESTONE WINDOW
- (29) CLEAN TAR OFF OF BRICK
- (30) REPLACE SPALLED LOWER COPING LIMESTONE w/ NEW OR SALVAGED FROM REC. BUILDING TO MATCH EXIST.

- 31) NEW WORK NORTH OF GYM BUILDING TO BE PART OF FUTURE BID PACKAGE 2.
- (32) NEW MECHANICAL LOUVER AT TOP HALF OF WINDOW OPENING. NON-OPERABLE ALUM CLAD. WOOD WINDOW w/ CLEAR GLASS ON LOWER HALF OF OPENING.
- (33) NEW ALUM. CLAD WOOD WINDOW w/ MAPES INSULATED MTL PANELS AT BOTH UPPER AND LOWER SASHES TO ALLOW FOR MECH. DUCT PENETRATION. MATCH EXIST WINDOW
- (34) REMOVE MISMATCH MASONRY OR CMU INFILL FROM PREVIOUS OPENING. RE-INFILL OPENING TO MATCH ADJACENT BRICK AND CMU FOUNDATION AS NEEDED.
- 35) REPLACE EXIST. LIMESTONE BELT COURSE
- w/ NEW LIMESTONE TO MATCH EXIST. (36) REBUILD MISSING WALL w/ 8" THICK BRICK
- OPENING. MATCH EXIST. BRICK
- (37) REUSE EXIST. WINDOW LINTEL IF IT REMAINS AND IS IN GOOD CONDITION. REPLACE w/ NEW STL LINTEL IF NEEDED.

WALL TO BOTTOM OF HISTORIC LOUVER

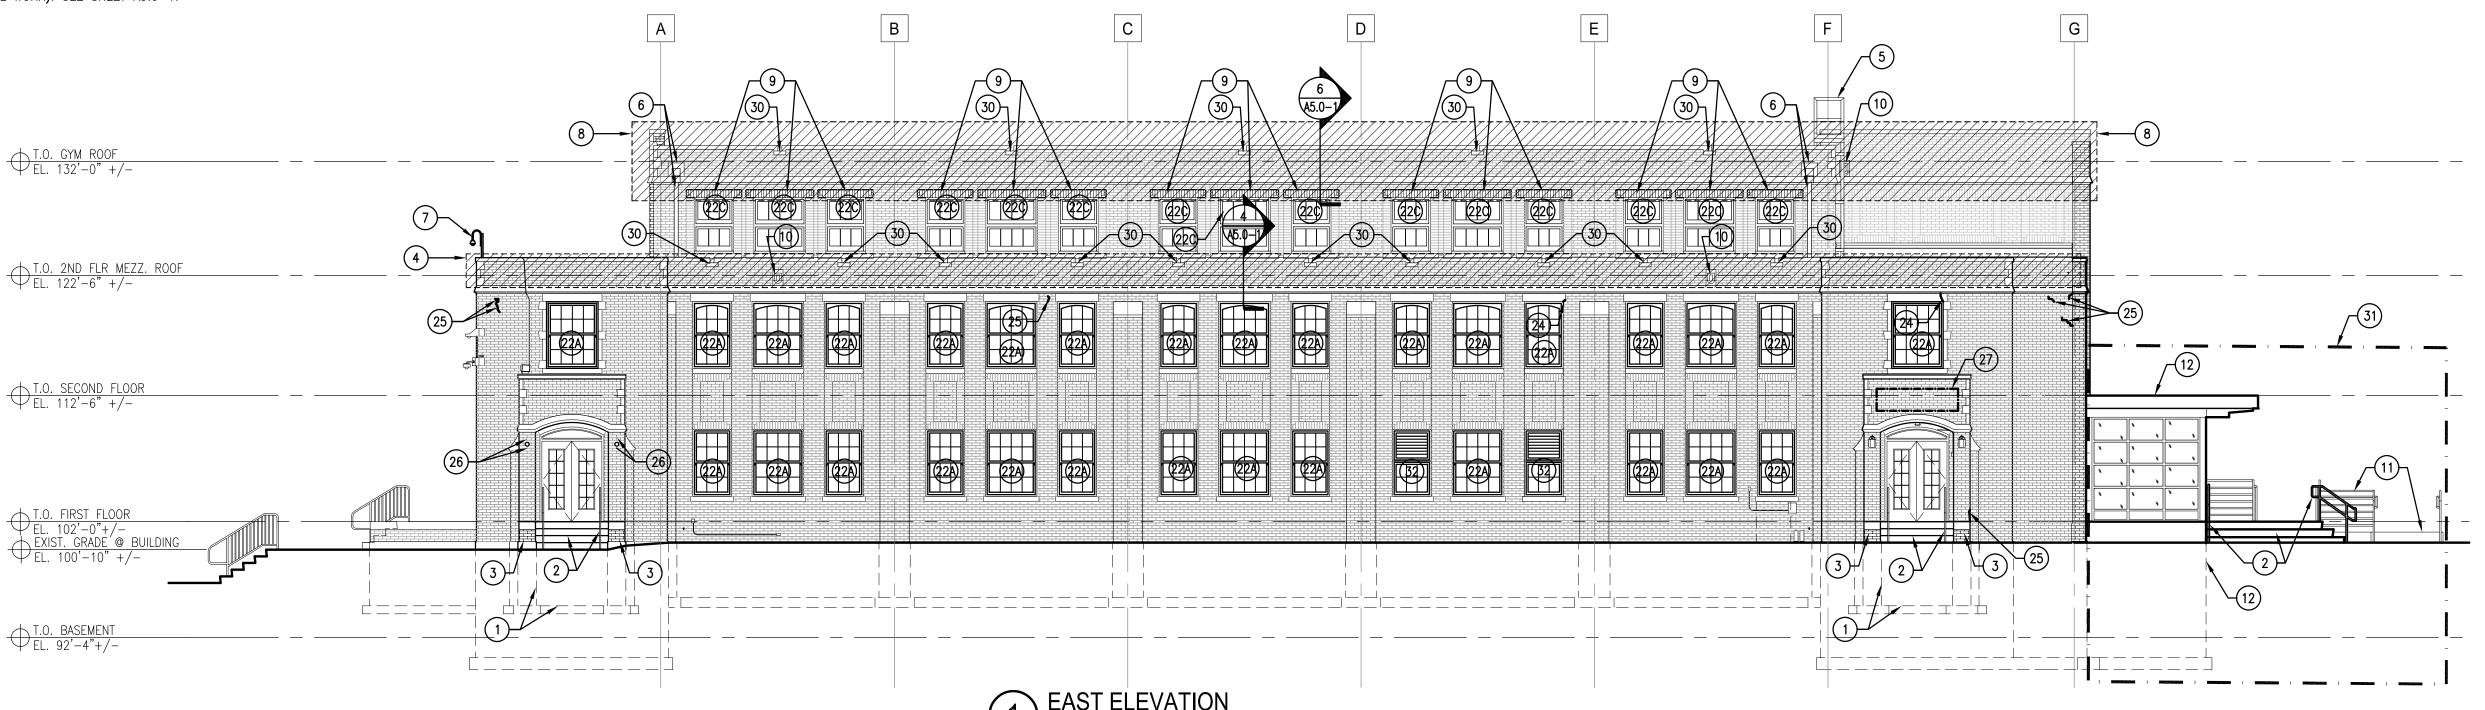

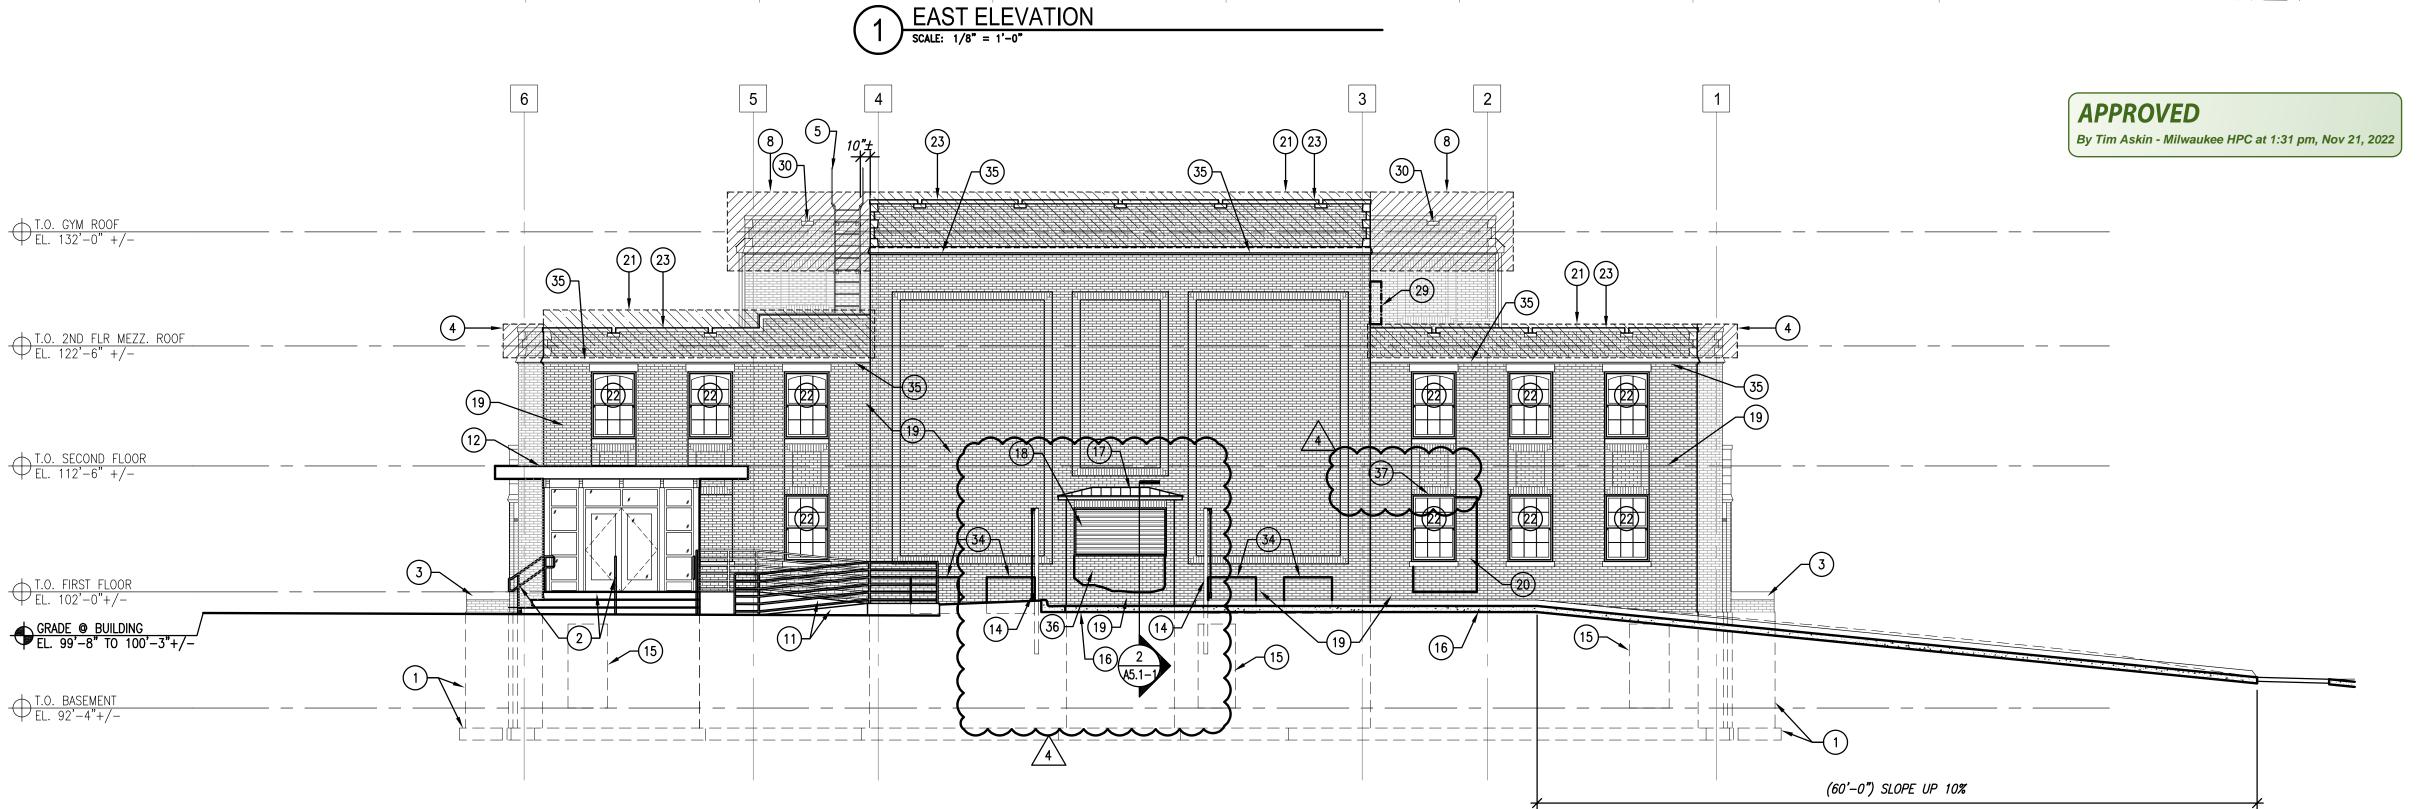

NORTH ELEVATION

SCALE: 1/8" = 1'-0"

10DEL R STABILIZATION EM OR SAMPUS BUILDING GE 1 - EXTE

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FOREST COUNTY

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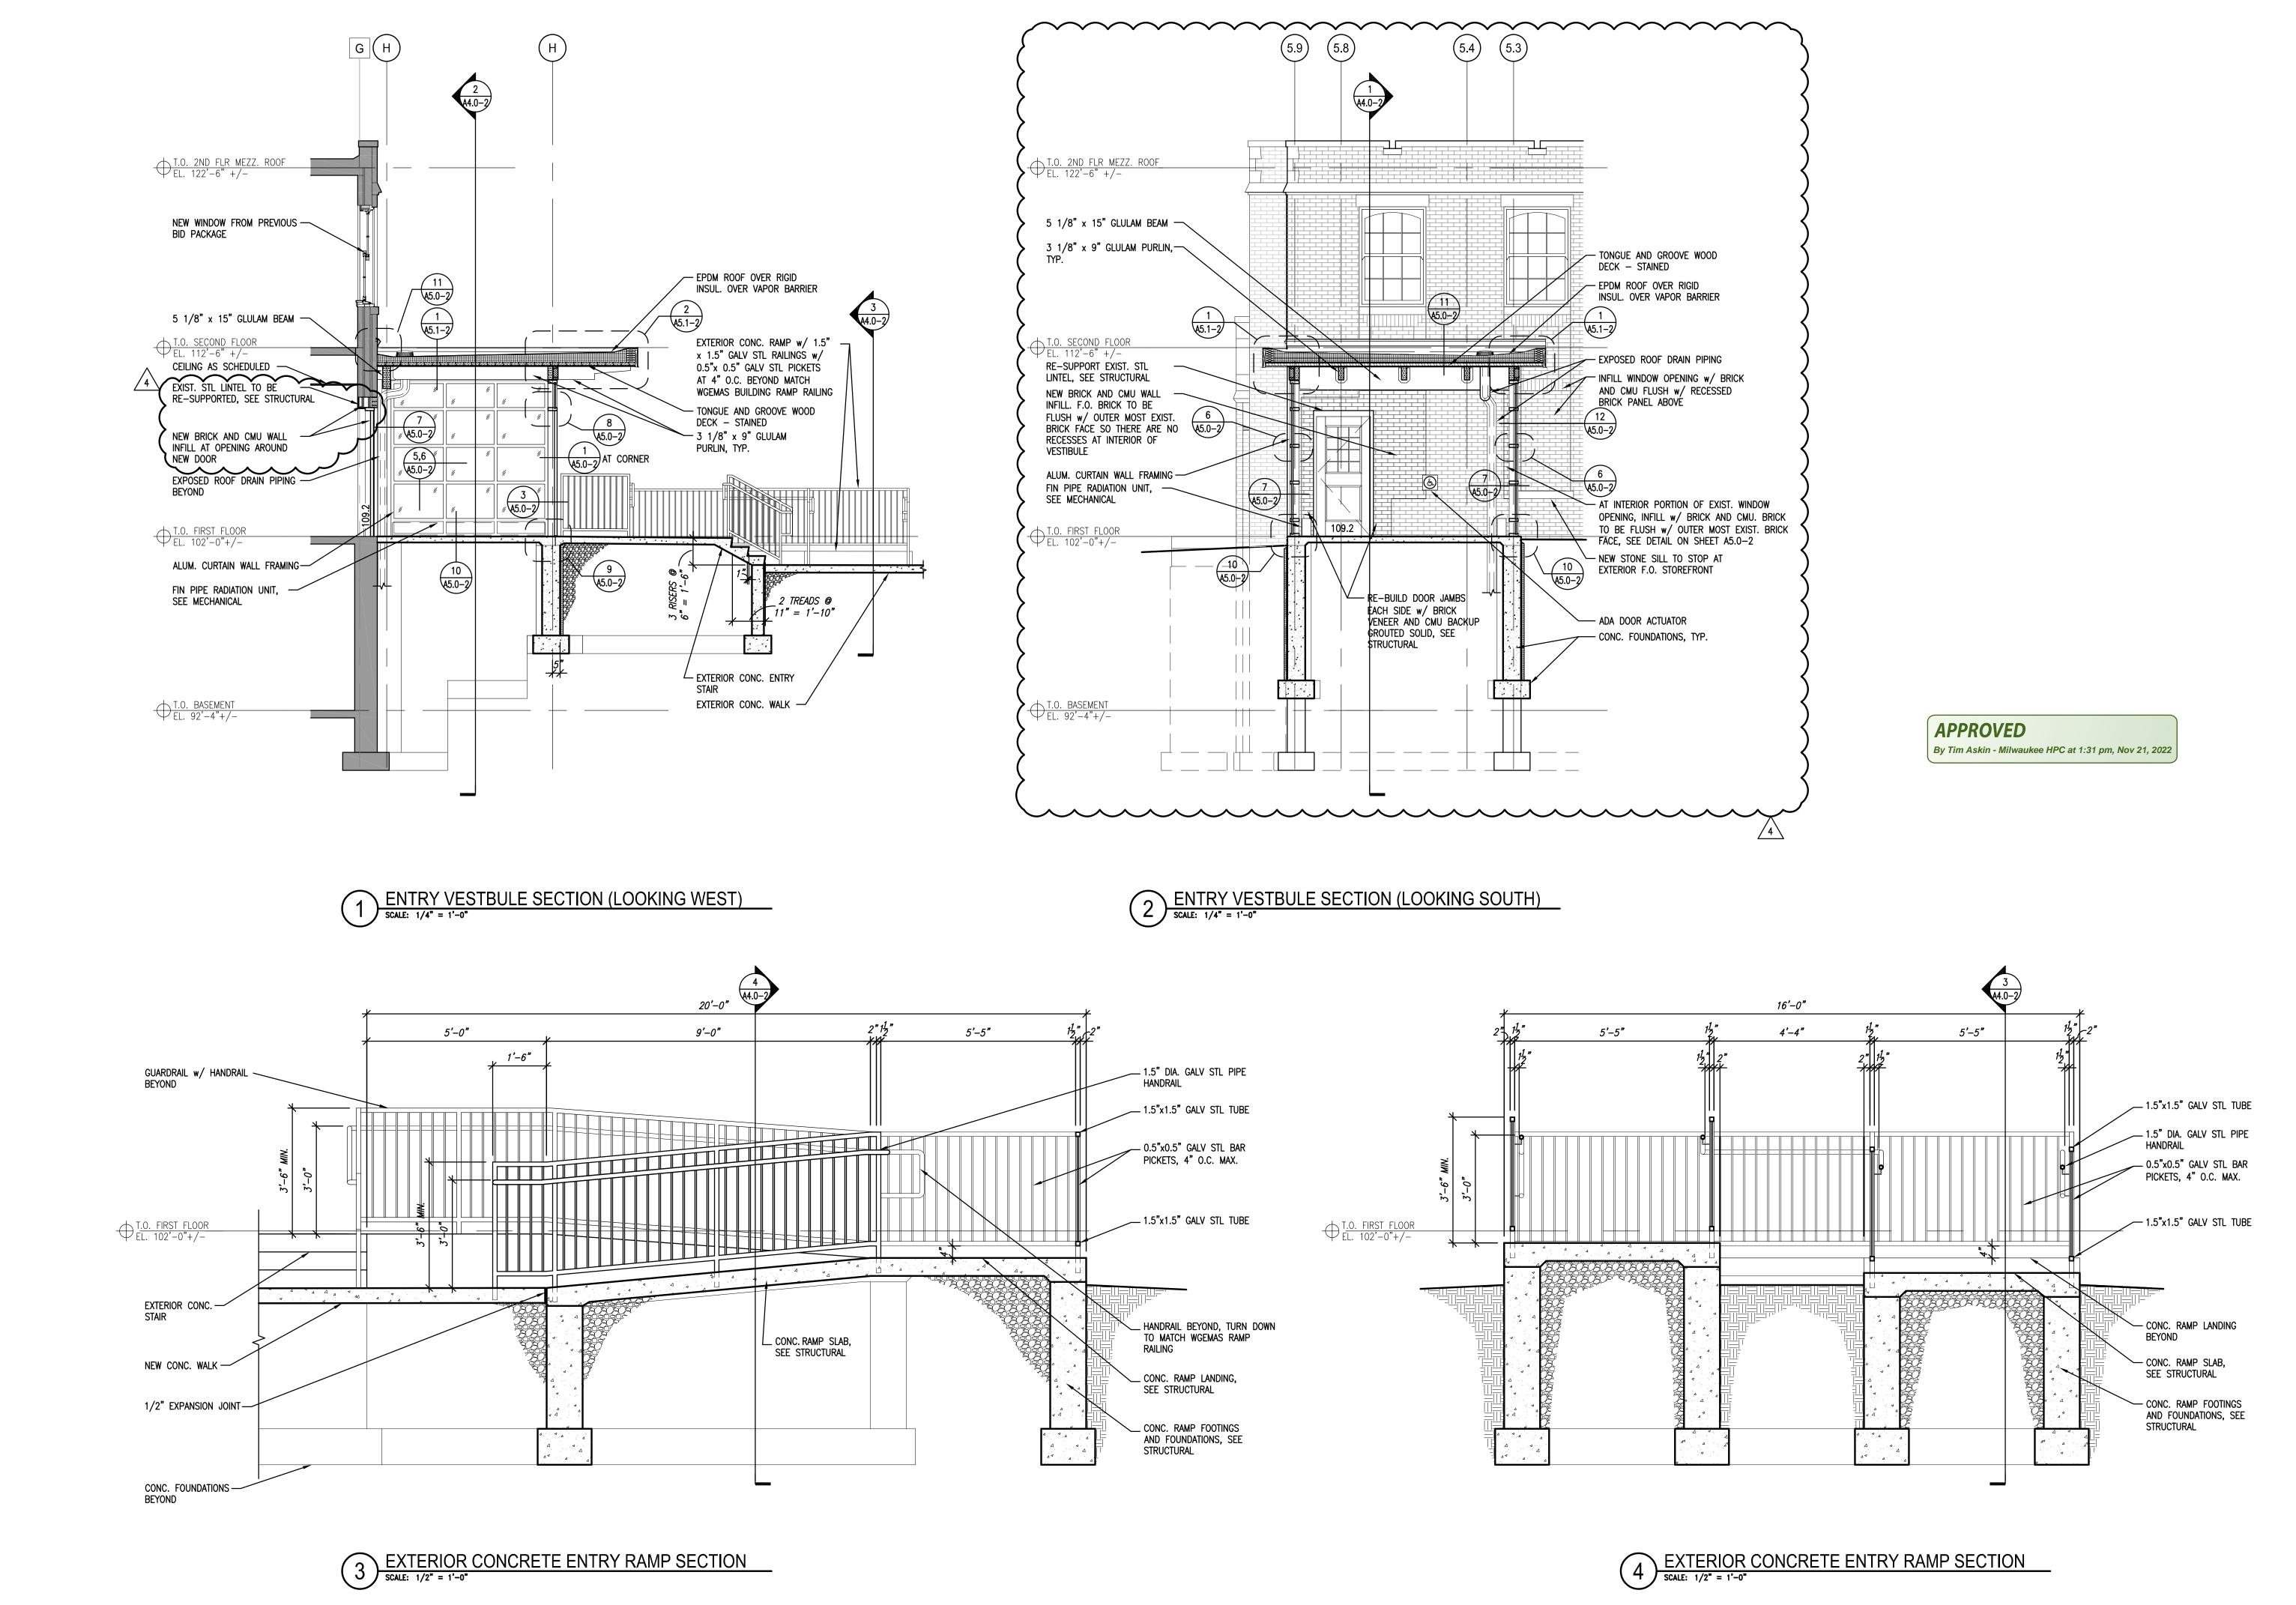
CONSTRUCTION DOCUMENTS 06/03/2022 CONSTRUCTION BULLETIN #1 08/10/2022 RFI #005 09/22/2022

Sheet Name: EXTERIOR ELEVATIONS

04/05/2022 Drawn By: CLR/CGH

Project No.: 15014.02

Sheet No.



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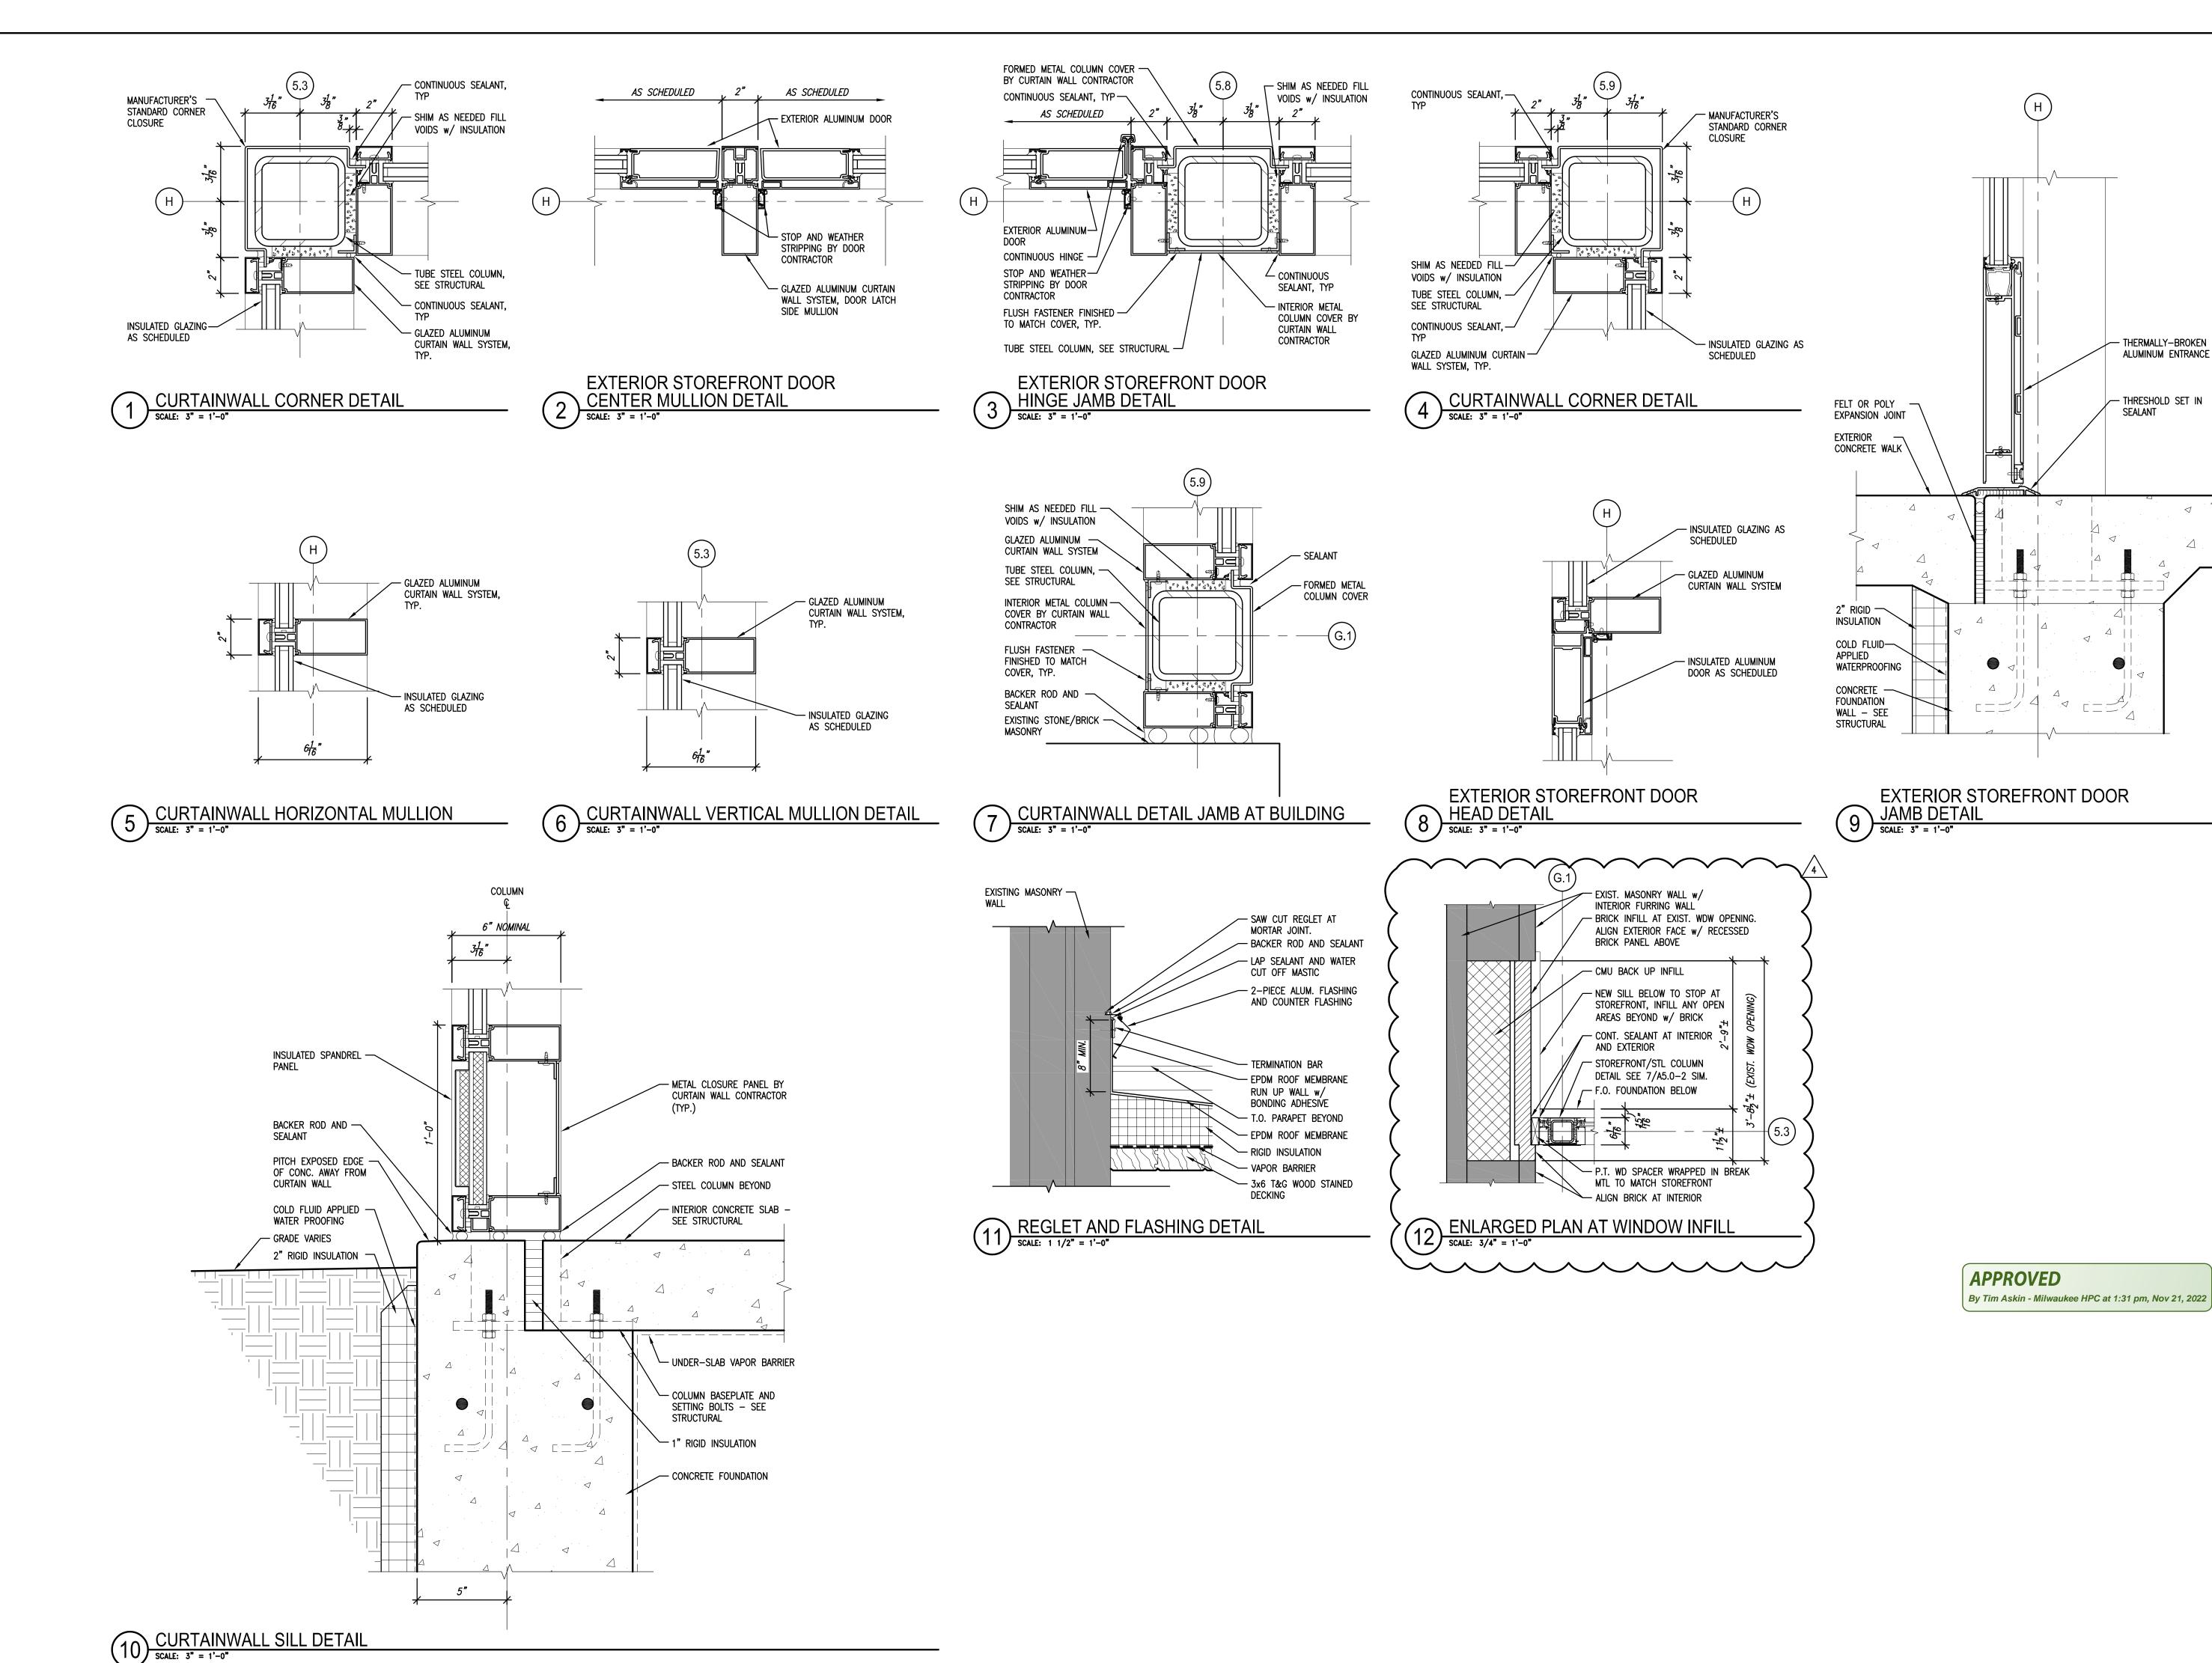
REMODEL ING RENOVATION CAMPUS E BUILDING RE AGE 2 - BUILDIN WGEMA TTHIGWE

Revisions: RFI #005 09/22/2022

Sheet Name: **BUILDING SECTIONS**

06/03/2022 Date: Drawn By: CLR/CGH Project No.: 15014.02

Sheet No.



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THERMALLY-BROKEN

- THRESHOLD SET IN

ALUMINUM ENTRANCE DOOR

REMODEL ING RENOVATION SAMPUS BUILDING RE GE 2 - BUILDIN C WGEM/ TTHIGV BID PAC

Sheet Name: EXTERIOR DETAILS


Revisions:

RFI #005 09/22/2022

06/03/2022 Date: Drawn By: CLR/CGH

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WGEMA CAMPUS TTHIGWE BUILDING REMODEL BID PACKAGE 1 - EXTERIOR STABILIZATION

APPROVED

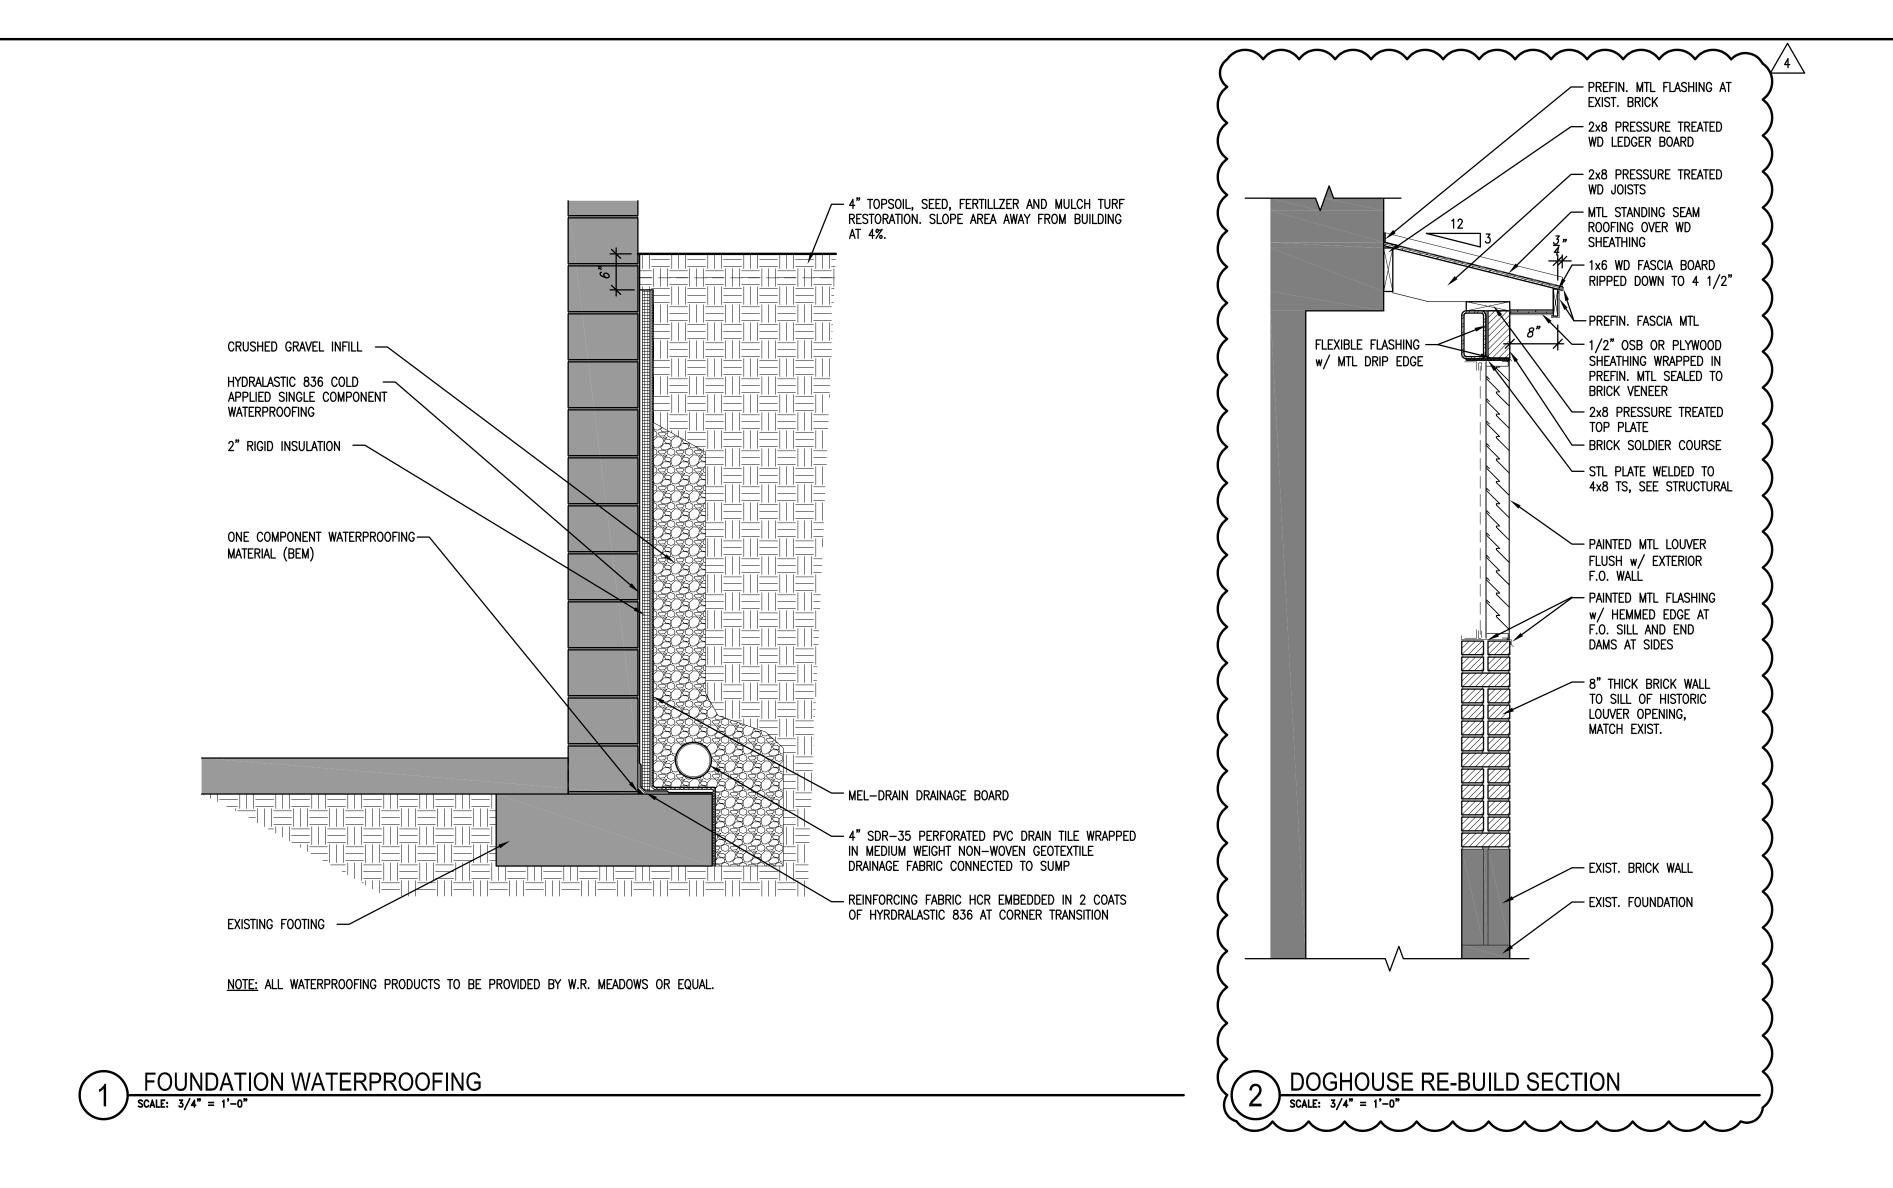By Tim Askin - Milwaukee HPC at 1:31 pm, Nov 21, 2022

Revisions:

CONSTRUCTION BULLETIN #1
08/10/2022

RFI #005
09/22/2022

Sheet Name:
EXTERIOR DETAILS


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 04/05/2022

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 CLR/CGH


 Project No.:
 15014.02

Sheet No.

A5 1-1

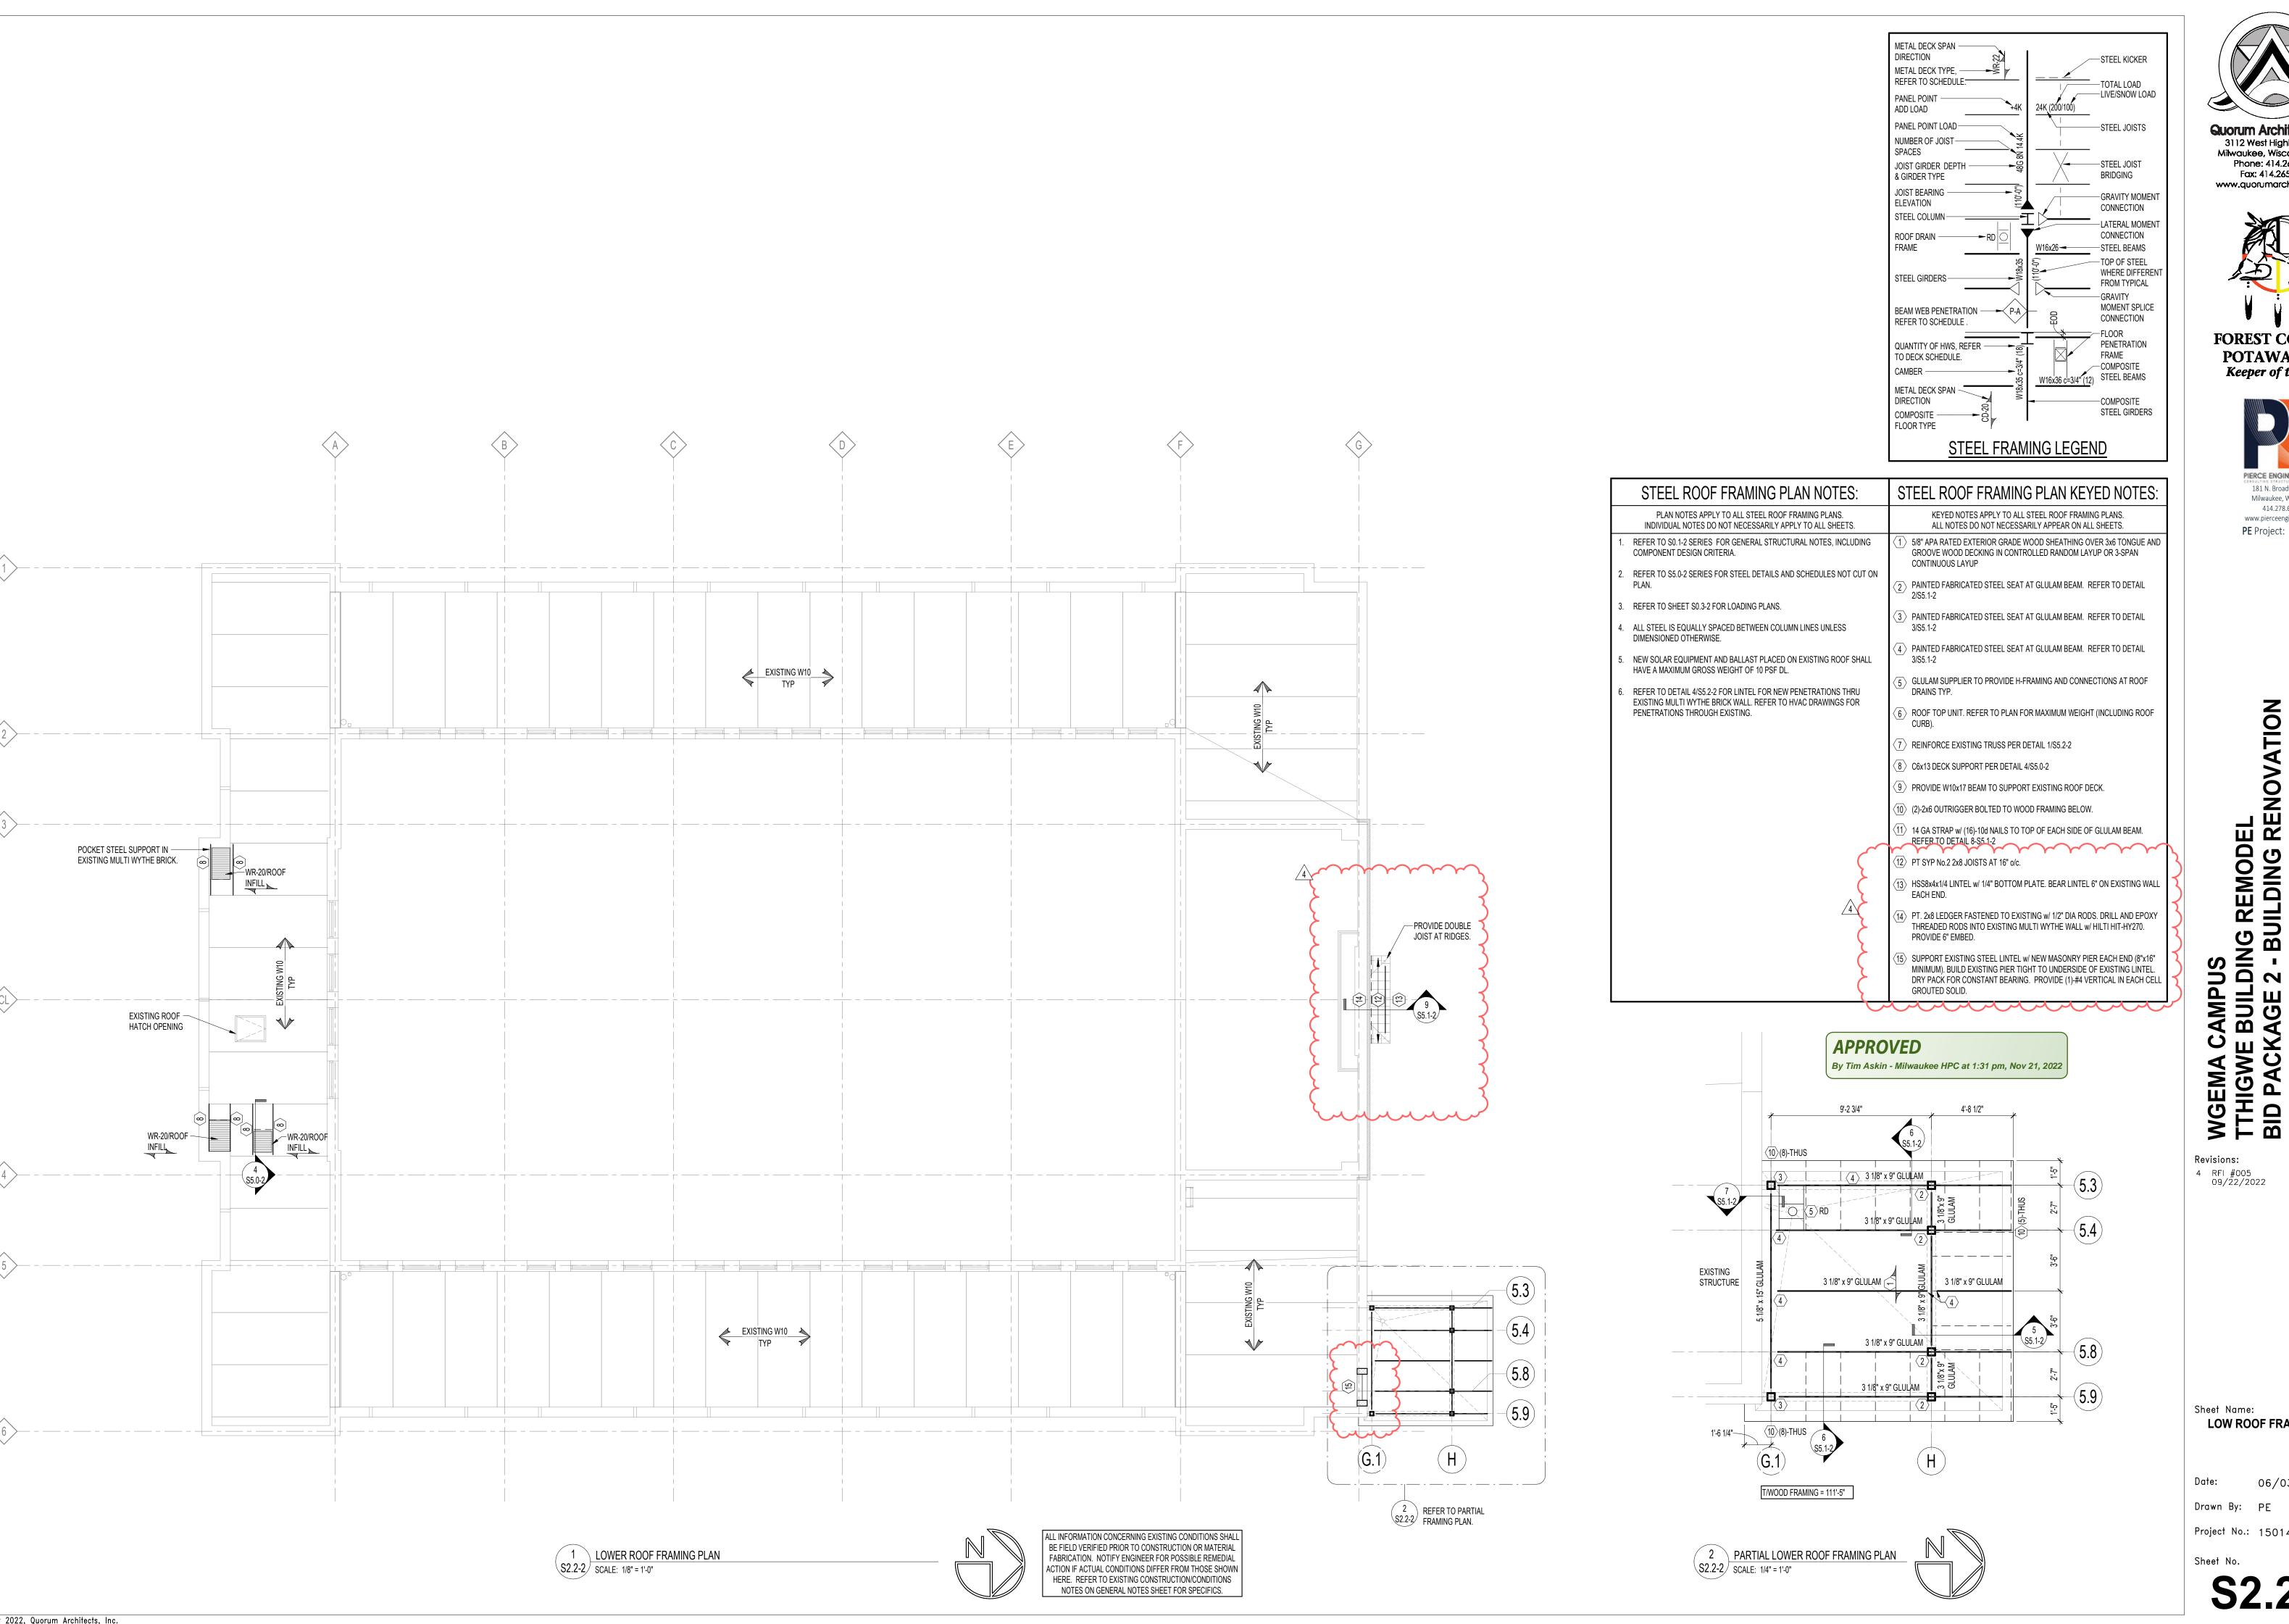



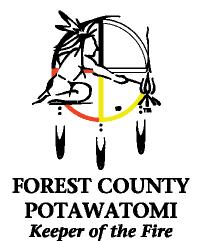



www.pierceengineers.com **PE** Project: 15273

Sheet Name: LOW ROOF FRAMING PLAN

06/03/2022

Project No.: 15014.02