

Certificate of Appropriateness

Milwaukee Historic Preservation Commission/200 E. Wells Street/Milwaukee, WI 53202/phone 414-286-5712/fax 414-286-3004

Property1534 N. FarwellPaul Weise BuildingDescription of
workMetal canopy on primary façade as shown. This approval relates only to the canopy.
Other approvals for this project are under separate cover. 7 oversize pages follow.Date issued11/10/2022PTS IDN/A

In accordance with the provisions of Section 320-21 (11) and (12) of the Milwaukee Code of Ordinances, the Milwaukee Historic Preservation Commission has issued a certificate of appropriateness for the work listed above. The work was found to be consistent with preservation guidelines. The following conditions apply to this certificate of appropriateness:


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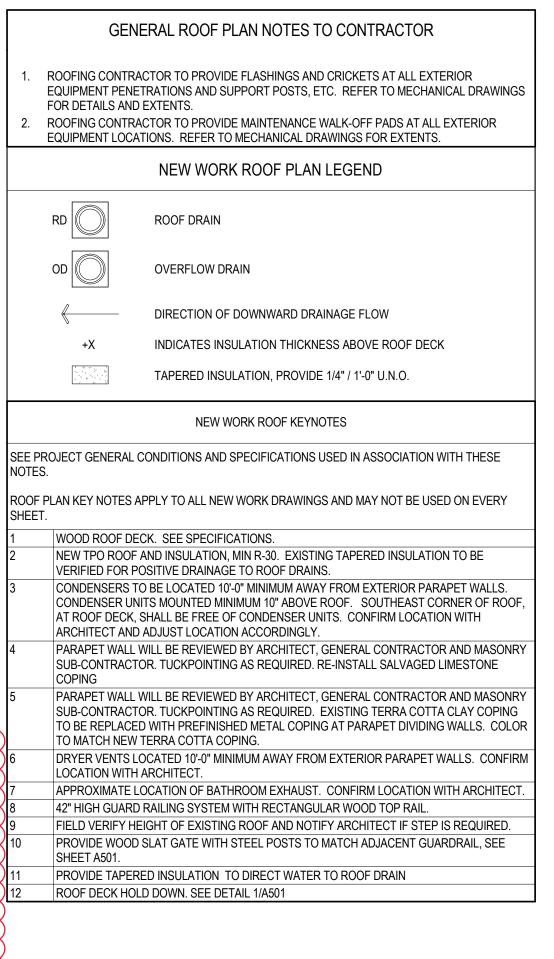
All work must be done in a craftsman-like manner, and must be completed within one year of the date this certificate was issued. Staff must approve any changes or additions to this certificate before work begins. Work that is not completed in accordance with this certificate may be subject to correction orders or citations. If you require technical assistance, please contact Historic Preservation staff as follows: Phone: (414) 286-5712 E-mail: hpc@milwaukee.gov.

If permits are required, you are responsible for obtaining them from the Milwaukee Development Center. If you have questions about permit requirements, please consult the Development Center's web site, <u>www.milwaukee.gov/lms</u>, or call (414) 286-8210.


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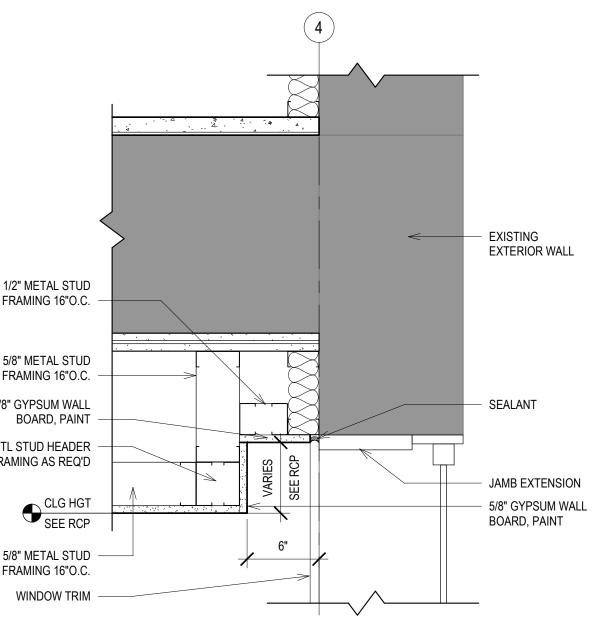




THIS DRAWIN SPECIFICATIO THE CIVIL ANI DRAWINGS. I INFORMATION	NERAL FLOOR PLAN NOTES TO CONTRA G IS FURTHER SUPPORTED BY INFORMATION CONTA INS. D STRUCTURAL DRAWINGS ARE SUPPLEMENTARY TO T SHALL BE THE RESPONSIBILITY OF THE CONTRACT I CONTAINED IN ALL THE DRAWINGS BEFORE THE INS	INED IN THE THE ARCHITECTURAL OR TO COORDINATE THE	225 E S	BEYER ARCH St. Paul ave Ukee WI, 532 9-8267	, STE 303
THE JOB SITE FINISH FLOOF OTHERWISE I CONTRACTOF PLATES, WAL OF CASEWOF OR SUSPEND ALL MECHANI BY GENERAL CONTRACTOF	RS SHALL JOINTLY PROVIDE AND INSTALL ALL STIFFE L BLOCKING AND SUPPORTING BRACKETS REQUIRED KK, TOILET ACCESSORIES, PARTITIONS. MILLWORK, A ED BY ALL TRADES. CAL, ELECTRICAL, PLUMBING, AND FIRE PROTECTION CONTRACTOR. GC IS RESPONSIBLE FORCOORDINAT RS. LLS TO BE VERIFIED IN FIELD. IT IS ASSUMED ALL EXI ING.	DOR MATERIAL UNLESS NERS, BRACING, BACKING D FOR THE INSTALLATION ND ALL WORK MOUNTED I WORK IS DESIGN BUILD ING WORK OF ALL SUB			
			CONSULTAN	TS:	
~~~~~	EXISTING, TO REMAIN MASONRY PARTITION, SEE PARTITION TYPES FO	R DETAILS			
SEE GENERAL IN INFORMATION.	METAL STUD PARTITION, SEE PARTITION TYPES				
ES. WORK PLAN KEY	NEW WORK PLAN KEYNOTES				
INFILL EXIST WITH DIAGO EXISTING ELI	EEL COLUMN. EXPOSED COLUMNS SHALL BE PAINTE NG FLOOR OPENING, SEE STRUCTURAL. APPROXIM/ VAL HATCH PATTERN. EVATOR PIT TO RECEIVE NEW CONCRETE FLOOR, SE ECIEVE 1/4" SOUND MAT AND 1 1/4" GYPCRETE UNDEF	ATE EXTENTS SHOWN E STRUCTURAL.			
EXISTING DO	D HAVE INTEGRAL CONTROL SOLUTION. OR TO REMAIN. REPAIR DOOR AS NEEDED FOR COM ROVIDE NEW HARDWARE INCLUDING STRIKE , LATCH ARDWARE.				
CHAIN LINK S NEW PLUMBI PROPOSED L LOCATION A UNDERGROL TOP OF EXIS LEVEL EXIST NEW PRE-FIN PROVIDE WH EXISTING FIF	TORAGE UNITS 6'-0" IN HEIGHT. NG STACK TO ROOF DRAIN. OCATION OF STANDPIPE. LOCATION AT BASEMENT I LEVEL 01 THRU LEVEL 03. PIPE WILL NEED TO RUN ND TO CONNECT TO INTERMEDIATE LANDING AT LEV ING PARAPET WALL TO BE LEFT EXPOSED AT STAIR NG BRICK WITH MORTAR. IISHED ALUMINUM WINDOW BELOW EXISTING LEADEI ITE WIRE SHELF AND ROD. EPLACE RELOCATED AND RECONSTRUCTED.	OUTSIDE OF BUILDING /EL 01. B. GRIND SMOOTH AND			
NEW WALL M PROVIDE WC	ED STAIR PLANS FOR MORE INFORMATION. OUNTED METAL HANDRAIL, PAINTED PT-X. T.O. HANI OD TRIM AT WINDOW, SEE 11/A900 FOR MORE INFOR VITY. SEE 5/A900 FOR MORE INFORMATION.				
PROVIDE 2X EXISTING 1 1/2" DIAMET	WOOD SLEEPERS AND 3/4" PLYWOOD SHEATHING TO ER STEEL PIPE GATE ASSEMBLY WITH CLOSER AND	180* SWING HARDWARE			
CHANGE IN E	OWER ENCLOSURE TO MEET ANSI 117.1. THRESHOLD LEVATION COLUMN. EXPOSED COLUMNS SHALL BE PAINTED. LAYER 1/2" GYP BD TO EXISTING EXTERIOR WALL	O TO BE LESS THAN 1/2"			
	5 4 4 7 2 7 2 1 5 5 6 7 2 1 5 5 6 7 2 1 5 5 5 5 5 5 5 5 5 5 5 5 5	(G)	DING RENOVATION		
3 • • • •	ELEV EL-00 FEC-22 STOR 007 2FB 2FB 2FB 2FB 2FB 2FB 2FB 2FB 2FB 2FB		DAUL WEISE BUILDING RENOVATIO	1534 N FARWELL AVE. MILWAUKEE, WISCONSIN	SHEET TITLE: NEW WORK PLANS
	FEC-22 FEC-22 STOR 007 007 007 007			1534 N FARWELL AVE. MILWAUKEE, WISCONSIN	SHEET TITLE: NEW WORK PLANS
3 • • • •	BIKE STORAGE			1534 N FARWELL AVE. MILWAUKEE, WISCONSIN	SHEET TITLE:
3 • • • •	BIKE STORAGE		REVISIONS:	1534 N FARWELL AVE. MILWAUKEE, WISCONSIN	SHEET TITLE:
3 • • • •	BIKE STORAGE		REVISIONS:	VARIES	
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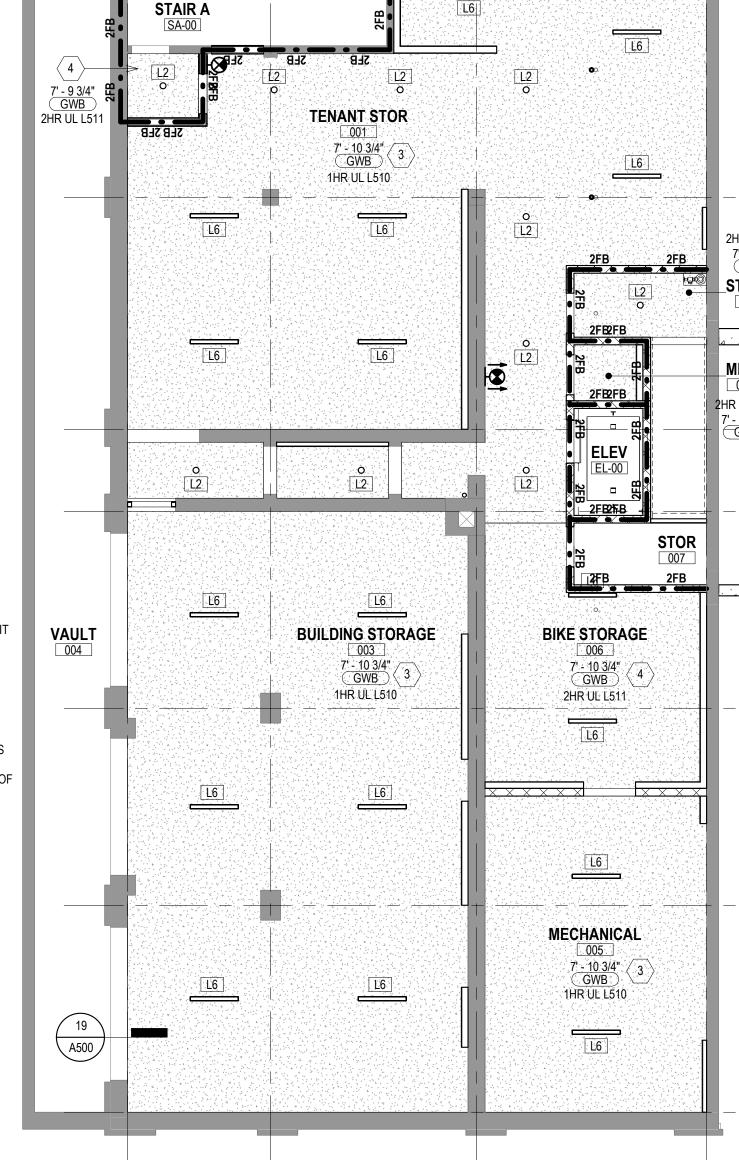


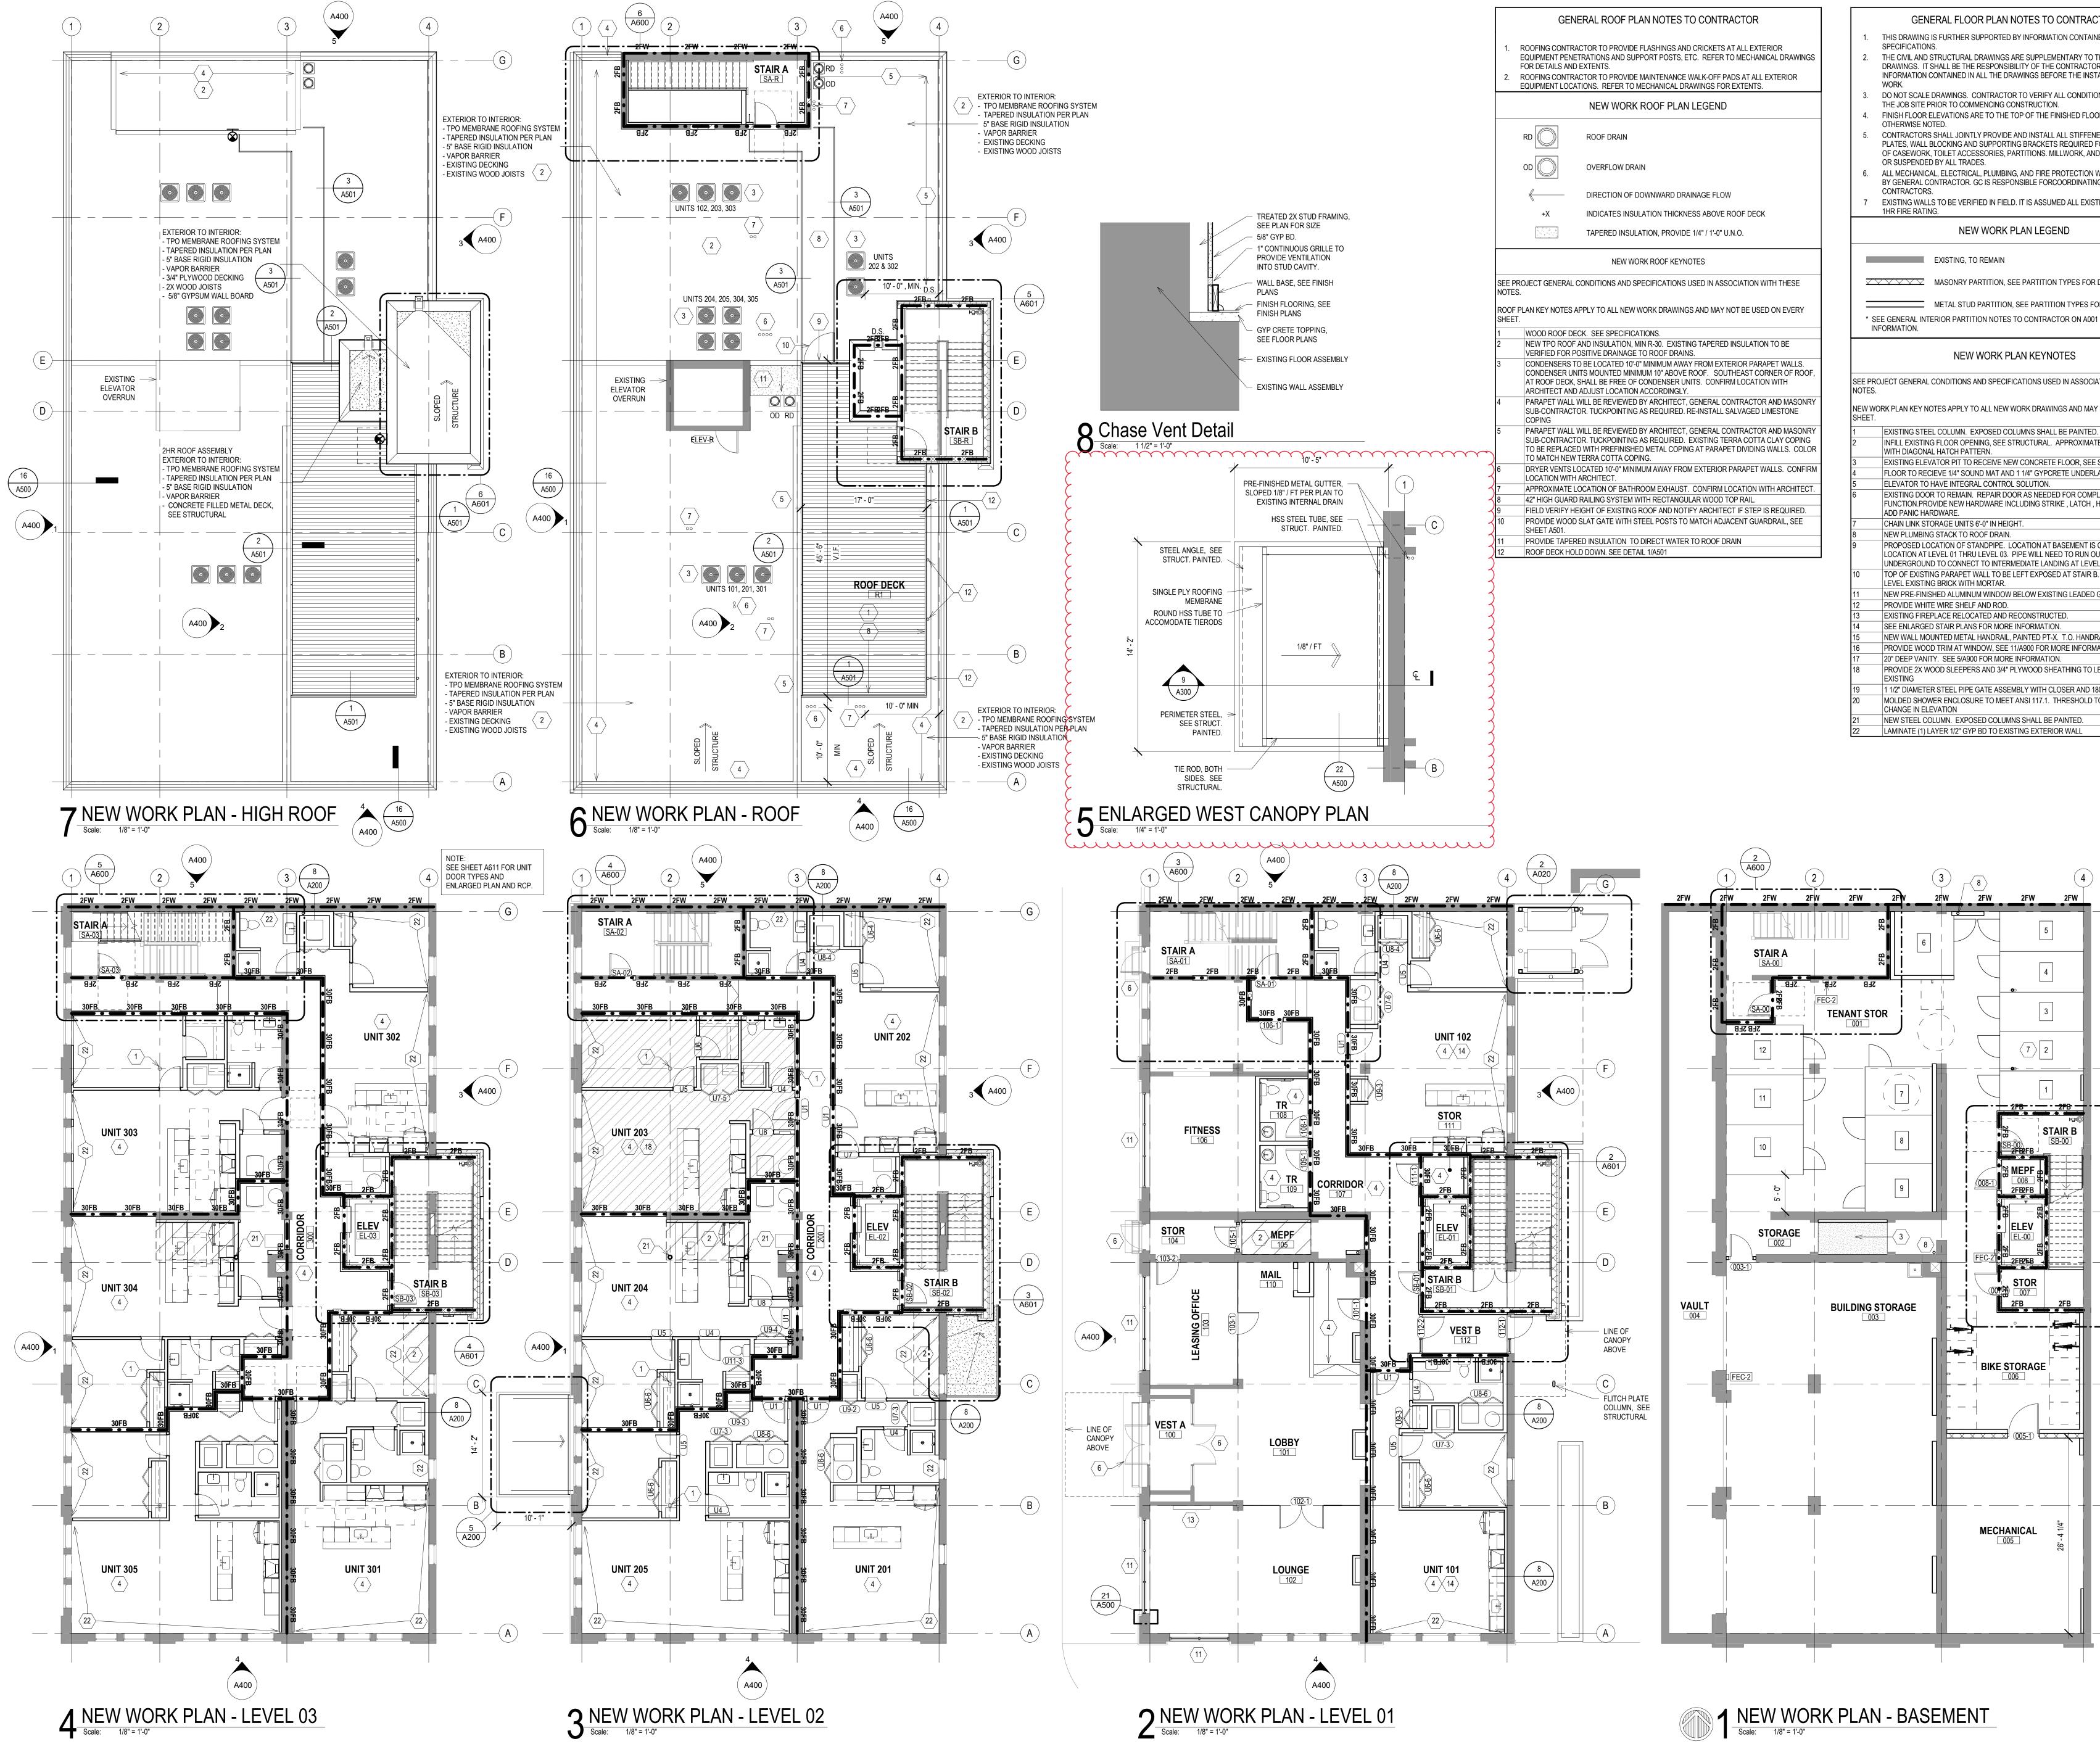4 REFLECTED CEILING PLAN - LEVEL 03 Scale: 1/8" = 1'-0"

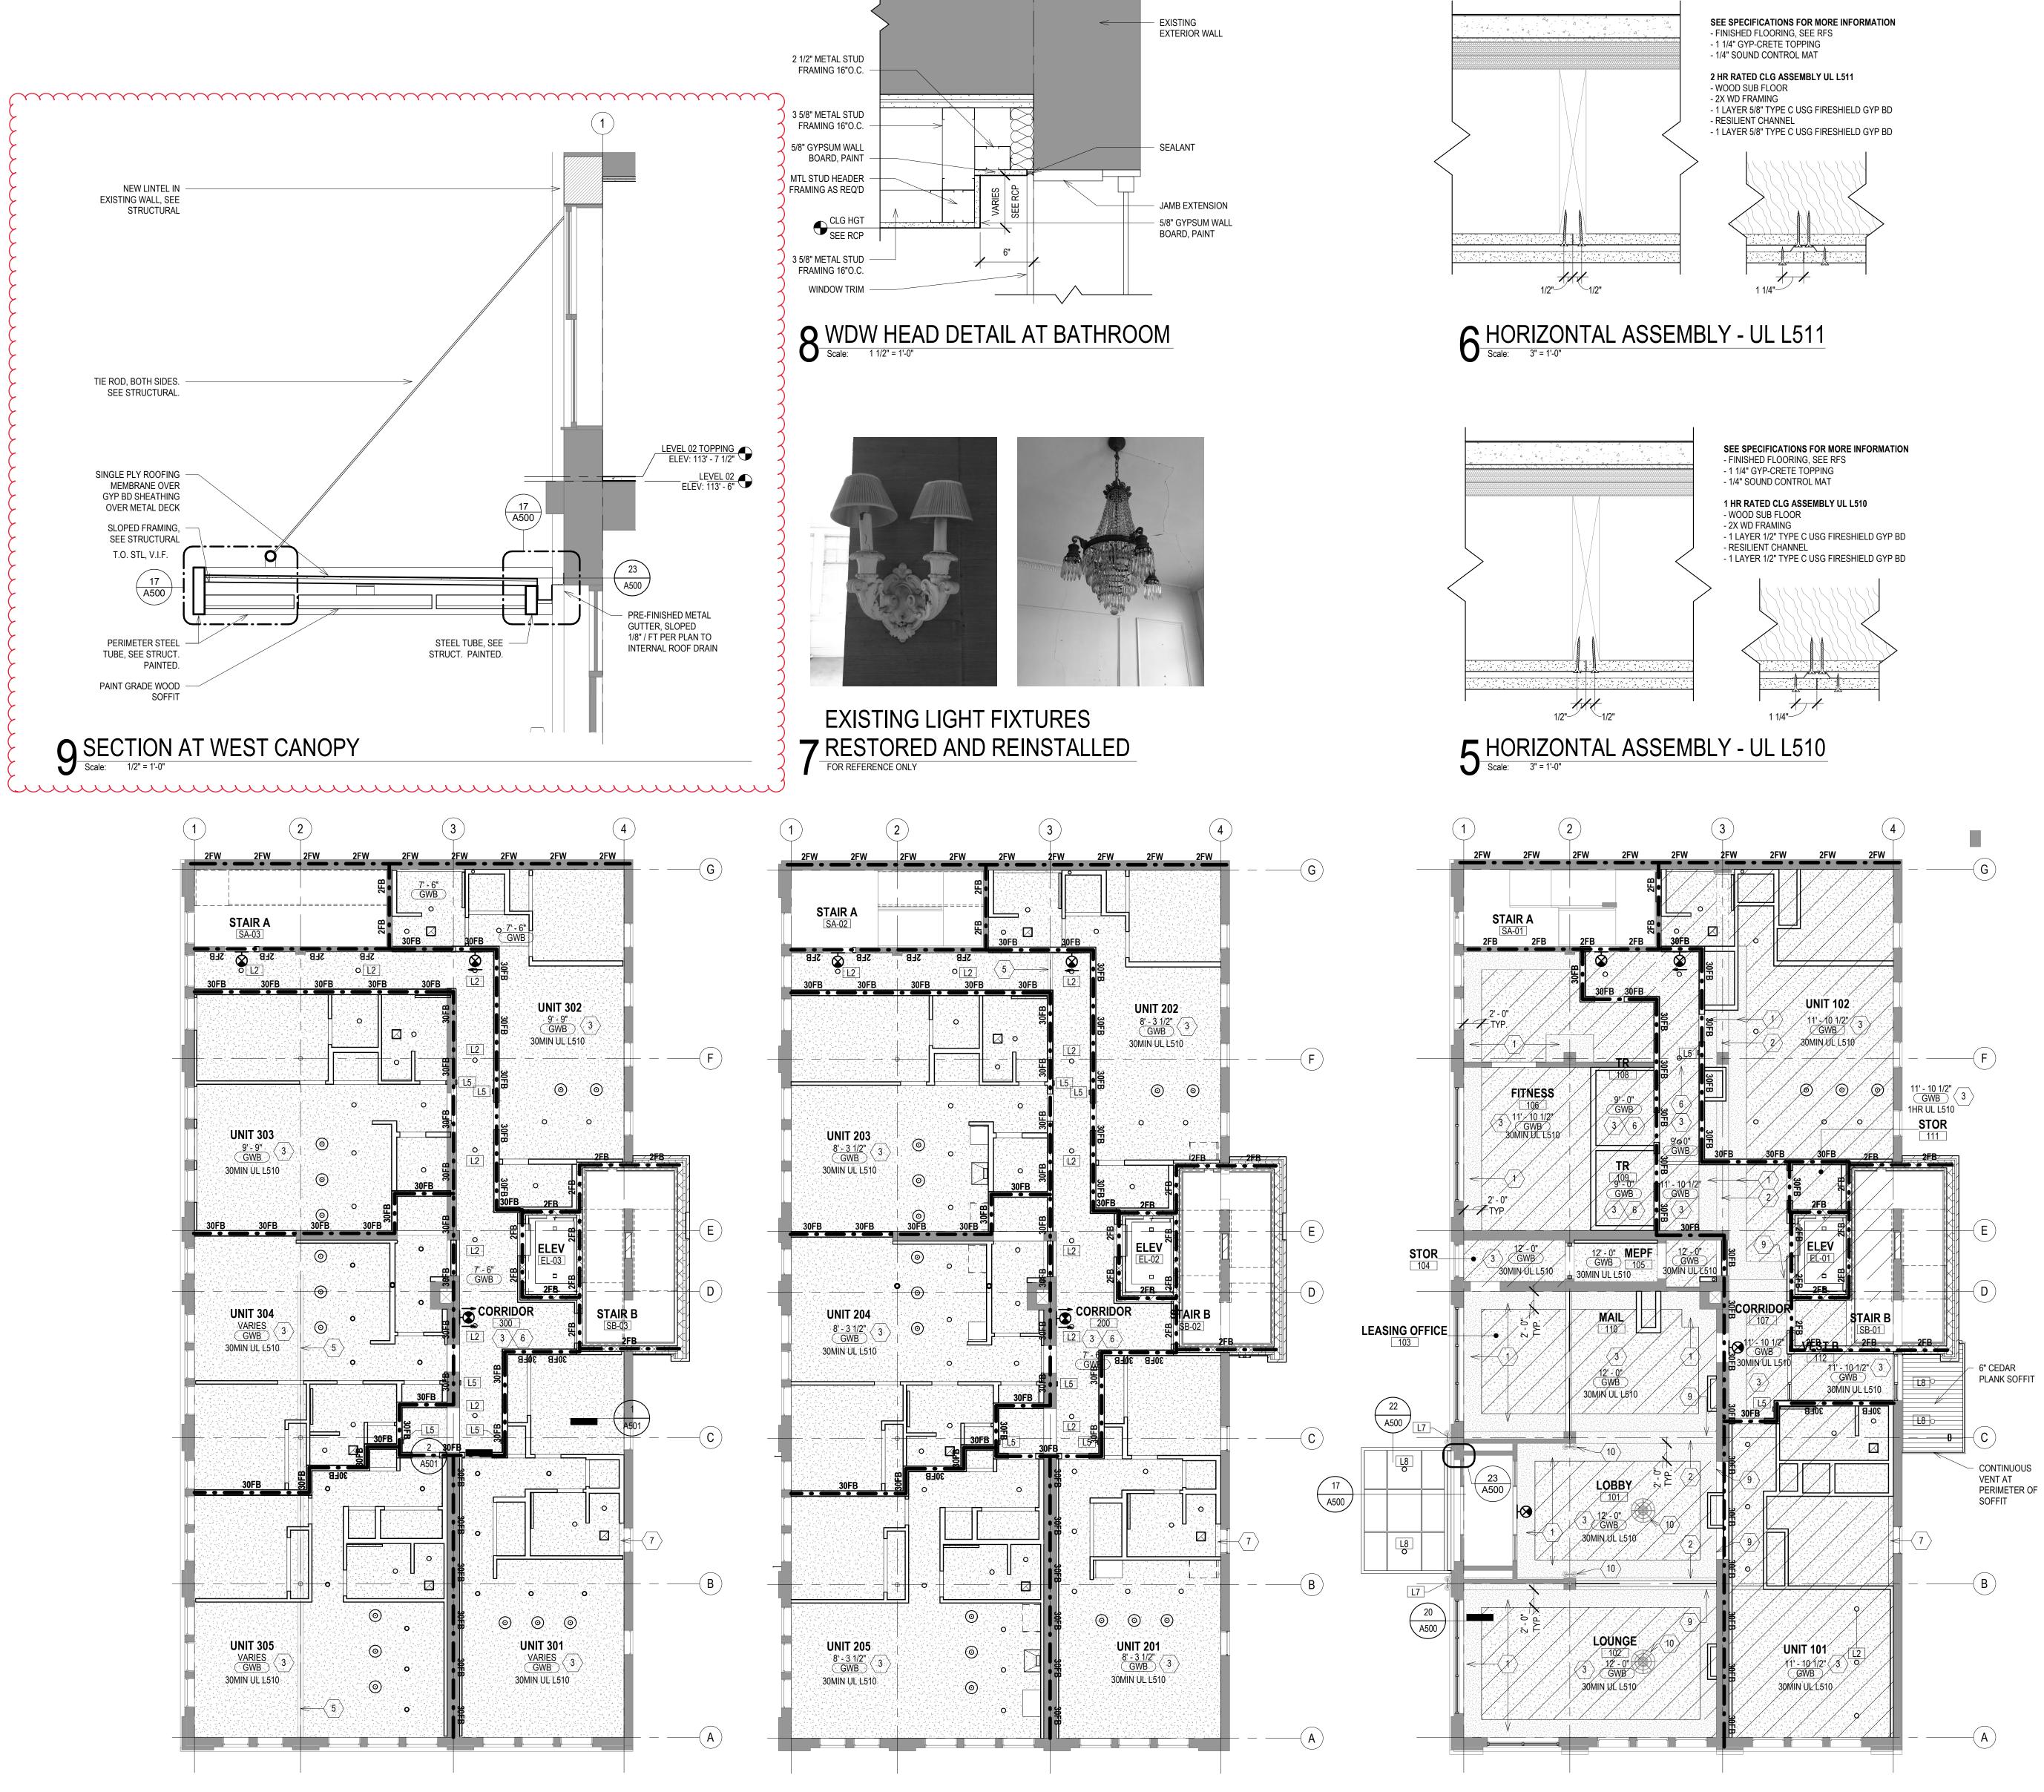

## 3 REFELCTED CEILING PLAN - LEVEL 02 Scale: 1/8" = 1'-0"

### 2 REFLECTED CEILING PLAN - LEVEL 01 Scale: 1/8" = 1'-0"



1.	THIS PLAN SHALL BE USED TO ESTABLISH THE LOCATIONS OF THE MAJOR CEILING PENETRATIONS INCLUDING: LIGHTING, HVAC, ACCESS PANEL, SPRINKLERS, SPEAKERS, ETC. SEE M.E.P. DRAWINGS FOR MORE SPECIFIC INFORMATION REGARDING EACH DISCIPLINE. IF CONFLICTS ARE DISCOVERED REGARDING LOCATION OF CEILING PENETRATIONS, CONTACT ARCHITECT FOR FURTHER INFORMATION.
2.	ALL DEVICES SHOWN IN CEILING TILE SHALL BE LOCATED IN THE CENTER OF THAT TILE UNLESS OTHERWISE NOTED.
3.	ALL DIMENSIONS TO CEILING FIXTURES ARE TO CENTER OF FIXTURE.
4	LIGHTING IS THE RESPONSIBILITY OF ELECTRICAL DESIGN BUILD CONTRACTOR. PROIVDE AVERAGE OF 30 FOOT CANDLES AT COMMON SPACES. PROVIDE PHOTOMETRIC INFORMATION OF ALL COMMONS SPACES FOR ARCHITECT REVIEW.
	REFLECTED CEILING PLAN KEY
	GYPSUM WALL BOARD CEILING SEE ROOM FINISH SCHEDULE AND SPECIFICATIONS FOR MORE INFORMATION
F	2X2 ACOUSTICAL CEILING TILE
	SEE ROOM FINISH SCHEDULE AND
	SPECIFICATIONS FOR MORE INFORMATION
	EXPOSED CEILING SEE ROOM FINISH SCHEDULE
	EXIT SIGN
	REFLECTED CEILING PLAN KEYNOTES
SEE F	PROJECT GENERAL CONDITIONS AND SPECIFICATIONS USED IN ASSOCIATION WITH THESE
NOTE	
	ECTED CEILING PLAN KEY NOTES APPLY TO ALL NEW WORK DRAWINGS AND MAY NOT BE USI /ERY SHEET.
1	EXISTING CEILING AND PLASTER MOULDING TO REMAIN, SHOWN WITH DIAGONAL HATCH OVERLAY. SEE DEMO PLAN FOR REFERENCE.
2	EXISTING BEAM, PLASTER, AND MOULDING TO REMAIN.
3	CLEAR HEIGHT TO BE VERIFIED IN FIELD. PROVIDE UL L510 PER DETAIL 5/A300 AT ENTIRE FLOOR UNLESS NOTED OTHERWISE.
4	CLEAR HEIGHT TO BE VERIFIED IN FIELD. PROVIDE UL L511 PER DETAIL 6/A300.
5	EXISTING STEEL BEAM, WHERE EXPOSED, TO BE PAINTED.
6	PROVIDE DROPPED CEILING UNDER FLOOR ASSEMBLY AT HEIGHT SHOWN. HEIGHT SHO IS CLEAR HEIGHT ABOVE NEW FINISHED FLOOR.
7	PROVIDE POCKET AT WINDOW HEAD, SEE 8/A300.
8	EXPOSED DUCTWORK, PAINTED. SHOWN WITH DIAGONAL HATCH.
9	EXISTING CORBEL TO BE REINSTALLED.
10	EXISTING LIGHT FIXTURE TO BE REFURBISHED. SEE DETAIL 7/A300.
	LIGHT FIXTURE SCHEDULE
BUILD	DULE IS GENERIC LIGHTING LAYOUT TO BE USED FOR DESIGN INTENT ONLY. ELECTRIC DESI O CONTRACTOR IS RESPONSIBLE FOR DESIGNING THE LIGHTING WITH ADEQUATE LIGHT LEVE FIXTURES THAT ARE APPROVED BY OWNER.
BUILD AND F	CONTRACTOR IS RESPONSIBLE FOR DESIGNING THE LIGHTING WITH ADEQUATE LIGHT LEVE IXTURES THAT ARE APPROVED BY OWNER.
BUILD	CONTRACTOR IS RESPONSIBLE FOR DESIGNING THE LIGHTING WITH ADEQUATE LIGHT LEVE

PENDANT LIGHTS.

SCONCE

2FW

2FW

2FW

2FW

2FW

2FW

SURFACE WALL MOUNTED VANITY LIGHT.

EXISTING EXTERIOR WALL SCONCE, REFURBISH


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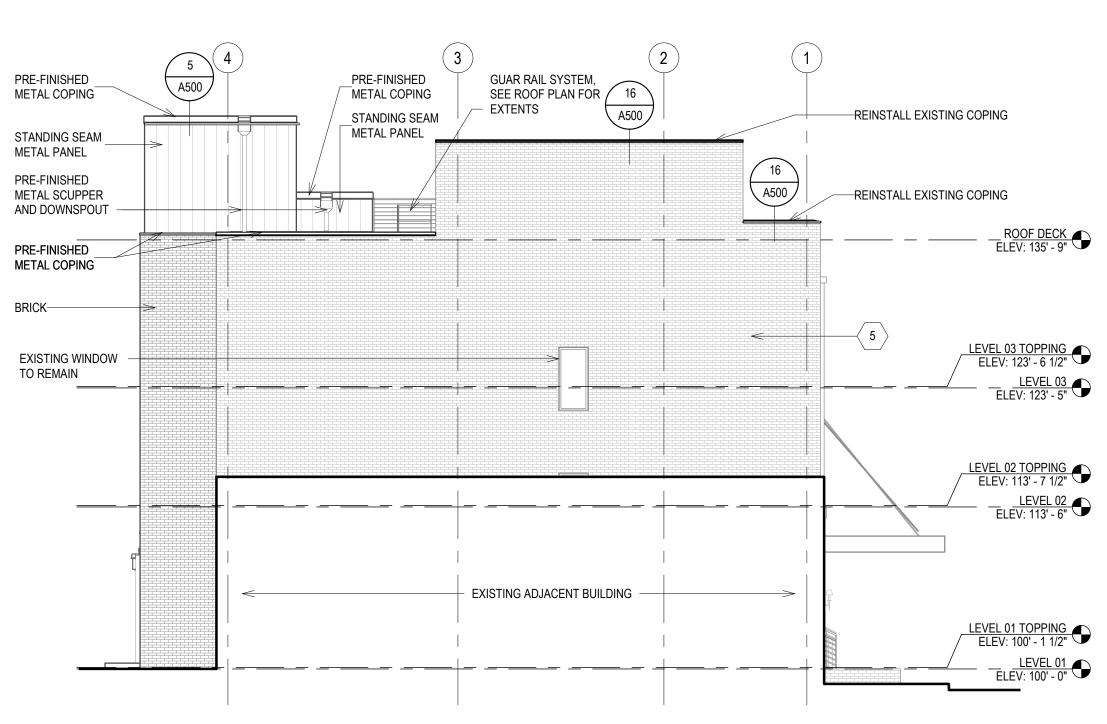
SURFACE MOUNTED UTILITY LIGHT.


EXTERIOR RECESSED CAN LIGHT

 REFLECTED CEILING PLAN - BASEMENT

 Scale:
 1/8" = 1'-0"




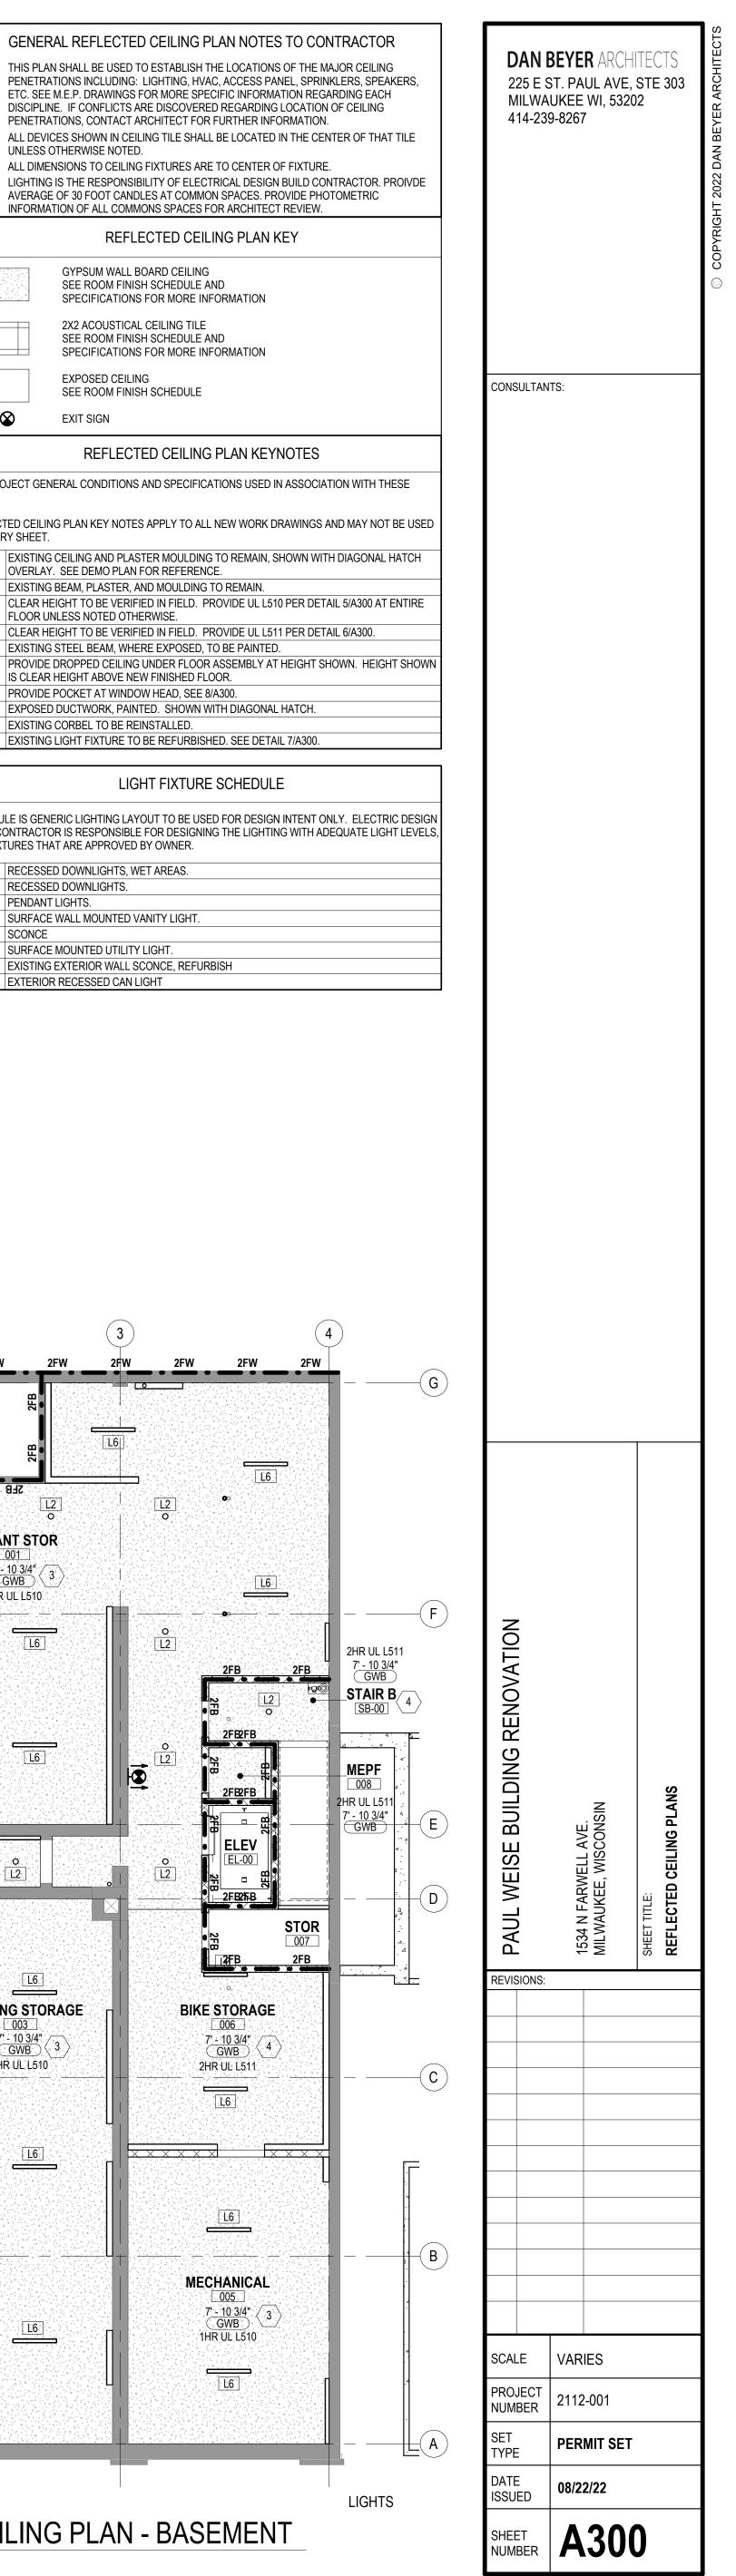


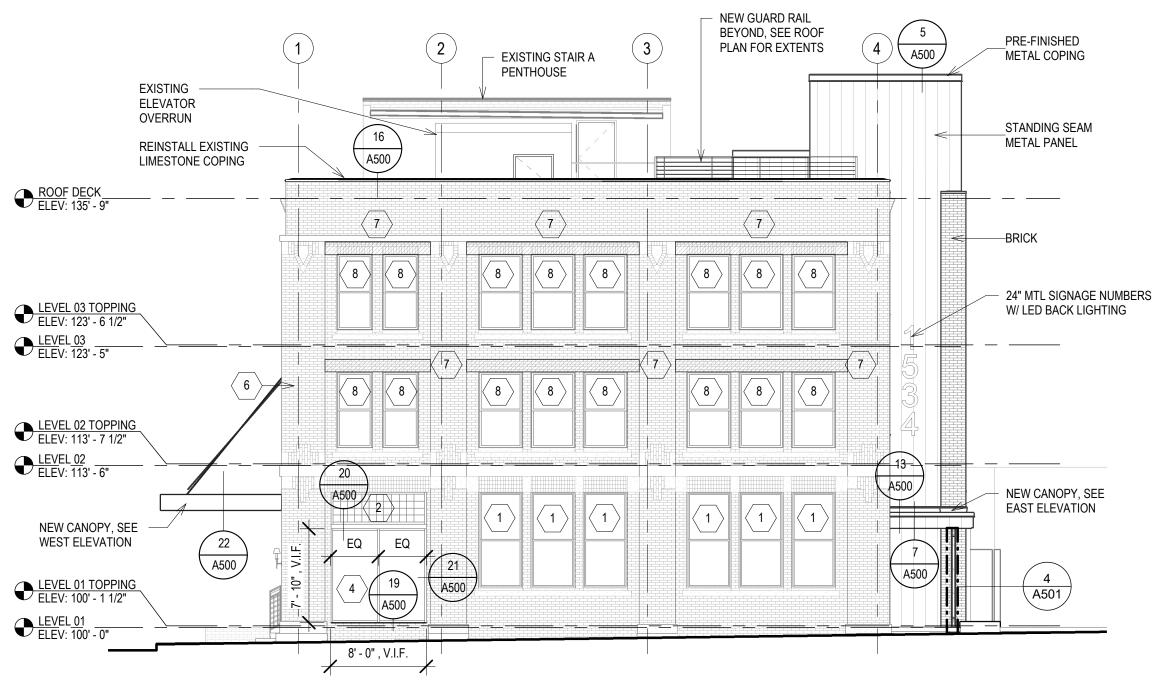


#### 4 SOUTH ELEVATION Scale: 1/8" = 1'-0"

#### 5 NORTH ELEVATION Scale: 1/8" = 1'-0"

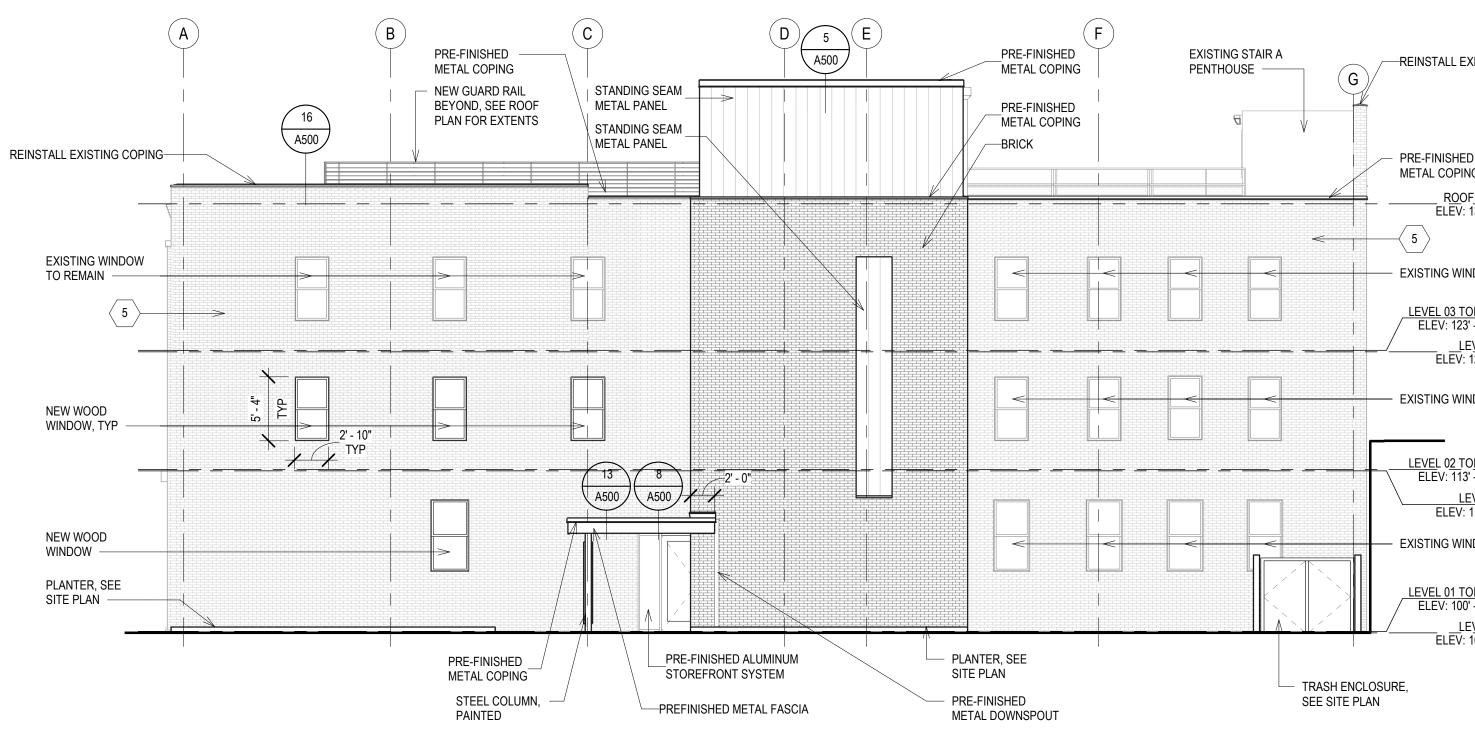

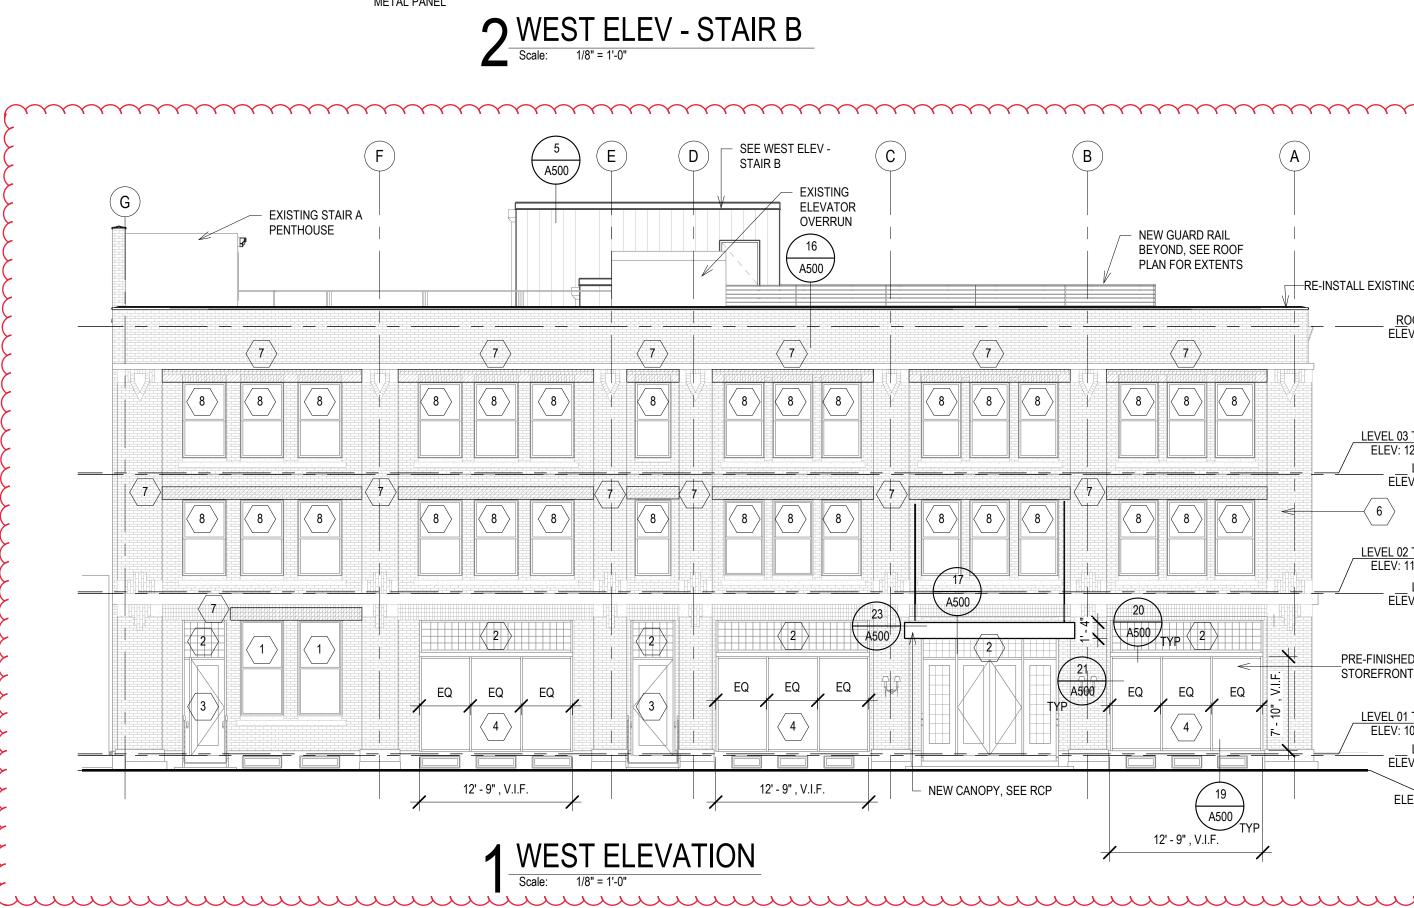

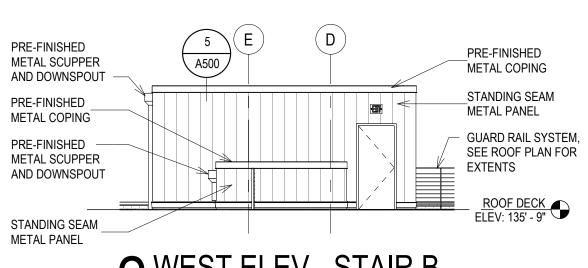




	EXTERIOR ELEVATION KEYNOTES
SEE PROJ	ECT GENERAL CONDITIONS AND SPECIFICATIONS THAT ARE USED IN ASSOCIATION WITH THESE NOTES.
NEW WOF	RK PLAN KEY NOTES APPLY TO ALL NEW WORK DRAWINGS AND MAY NOT BE USED ON EVERY SHEET.
1	EXISTING WOOD WINDOW TO BE RESTORED.
2	EXISTING LEADED GLASS TRANSOM TO BE CLEANED AND BROKEN PANES REPLACED TO MATCH EXISTING.
3	EXISTING WOOD DOOR TO BE RESTORED AND REGLAZED.
4	NEW ALUMINUM STOREFRONT WINDOW SYSTEM AT LOWER PORTION ONLY.
5	CLEAN, TUCKPOINT, AND PAINT EXISTING BRICK.
6	CLEAN AND TUCKPOINT ALL EXISTING BRICK AND STONE.
7	REPLACE EXISTING LINTEL WITH NEW STEEL LINTEL, SEE STRUCTURAL. SALVAGE AND RE-INSTALL MASORNY TO MATCH EXISTING CONDITION. PROVIDE STAINLESS STEEL FLASHING. PRIOR TO COMPLETING WORK, REVIEW CONDITION WITH GC, ARCHITECT AND STRUCTURAL ENGINEER.
8	EXISTING WINDOW TO REMAIN

EXISTING COPING ED NG DF DECK 135' - 9" $\bigcirc$ NDOW TO REMAIN $\frac{OPPING}{123' - 5"} \bigcirc$ NDOW TO REMAIN			
$\begin{array}{c} 0 \\ 0 \\ 3' - 7 \\ 1/2'' \\ 113' - 6'' \\ 113' - 6'' \\ 0 \\ 0 \\ 0 \\ 0 \\ 0 \\ 0 \\ 0 \\ 0 \\ 0 \\$			
	PAUL WEISE BUILDING RENOVATION	1534 N FARWELL AVE. MILWAUKEE, WISCONSIN	SHEET TITLE: EXTERIOR ELEVATIONS
IG LIMESTONE COPING DO <u>F DECK</u> V: 135' - 9" ①	REVISIONS:	1534 MILV	SHEE
<u>TOPPING</u> 23' - 6 1/2" L <u>EVEL 03</u> V: 123' - 5"			
LEVEL 02 V: 113' - 6"			
D ALUMINUM T SYSTEM	SCALE BROJECT	VARIES	
TOPPING 00' - 1 1/2" L <u>EVEL 01</u> V: 100' - 0"		2112-001 PERMIT SET	
V: 100' - 0" GRADE EV: 98' - 9"		08/22/22	
·····	SHEET	A40	0

DAN BEYER ARCHI 225 E ST. PAUL AVE, STE 303 MILWAUKEE WI, 53202 414-239-8267

CONSULTANTS:

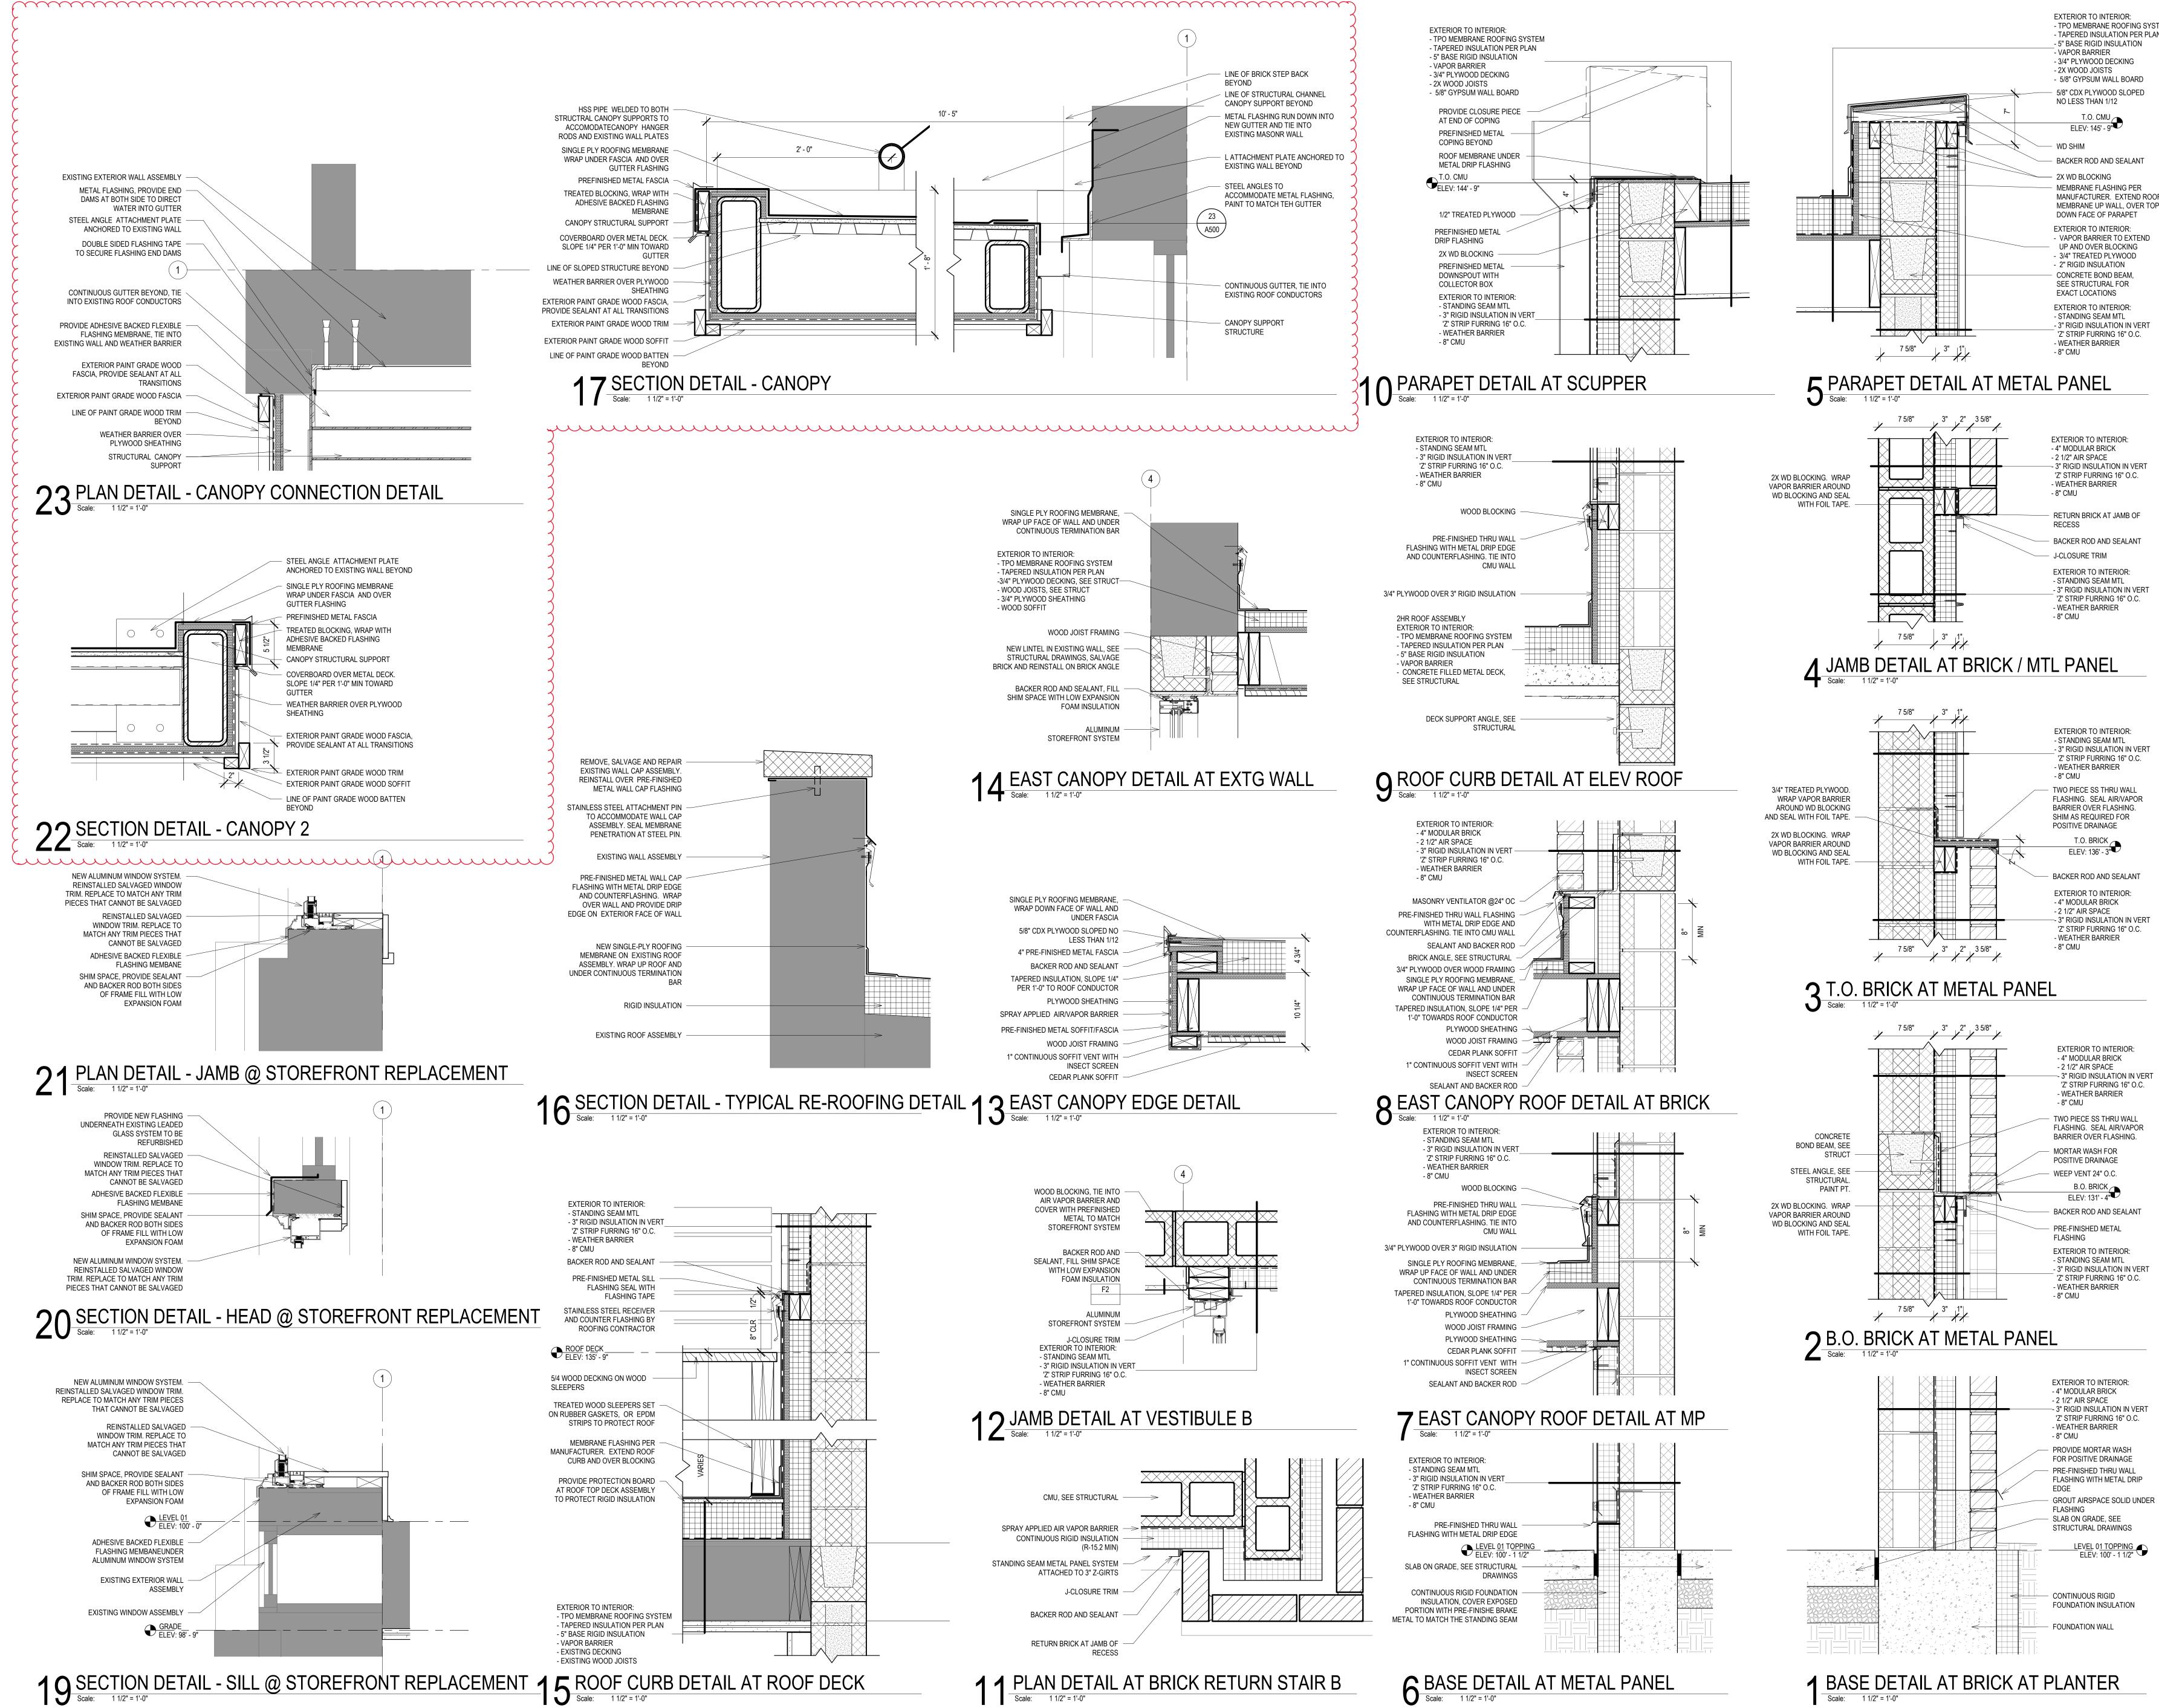



LEVEL 0<u>1 TOPPING</u> ELEV: 100' - 1 1/2"

PRE-FINISHED THRU WALL FLASHING WITH METAL DRIP

-- 3" RIGID INSULATION IN VERT 'Z' STRIP FURRING 16" O.C.

- 3" RIGID INSULATION IN VERT 'Z' STRIP FURRING 16" O.C.

BACKER ROD AND SEALANT

TWO PIECE SS THRU WALL FLASHING. SEAL AIR/VAPOR BARRIER OVER FLASHING.

EXTERIOR TO INTERIOR: - 3" RIGID INSULATION IN VERT 'Z' STRIP FURRING 16" O.C.

-- 3" RIGID INSULATION IN VERT 'Z' STRIP FURRING 16" O.C.

'Z' STRIP FURRING 16" O.C. TWO PIECE SS THRU WALL FLASHING. SEAL AIR/VAPOR BARRIER OVER FLASHING.

- 3" RIGID INSULATION IN VERT



- 3" RIGID INSULATION IN VERT Z' STRIP FURRING 16" O.C.

RETURN BRICK AT JAMB OF

-- 3" RIGID INSULATION IN VERT 'Z' STRIP FURRING 16" O.C.

CONCRETE BOND BEAM, SEE STRUCTURAL FOR - 3" RIGID INSULATION IN VERT 'Z' STRIP FURRING 16" O.C.

BACKER ROD AND SEALANT MEMBRANE FLASHING PER MANUFACTURER. EXTEND ROOF MEMBRANE UP WALL, OVER TOP, AN DOWN FACE OF PARAPET - VAPOR BARRIER TO EXTEND UP AND OVER BLOCKING 3/4" TREATED PLYWOOD

CONSULTANTS:

- 3/4" PLYWOOD DECKING

- TPO MEMBRANE ROOFING SYSTEM - TAPERED INSULATION PER PLAN - 5" BASE RIGID INSULATION - 5/8" GYPSUM WALL BOARD 5/8" CDX PLYWOOD SLOPED

> **(**) EVISIONS SCALE VARIES PROJECT 2112-001 NUMBER PERMIT SET TYPE DATE 08/22/22 ISSUED **A500** SHEET NUMBER

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