




LEGAL DESCRIPTION

PARCEL A AND PARCEL B IN CERTIFIED SURVEY MAP NUMBER 1821, IN THE NORTHWEST 1/4 OF SECTION 10, TOWNSHIP 8 NORTH, RANGE 21 EAST, IN THE CITY OF MILWAUKEE, MILWAUKEE COUNTY, WISCONSIN.

CONTAINS: 13.227 ACRES



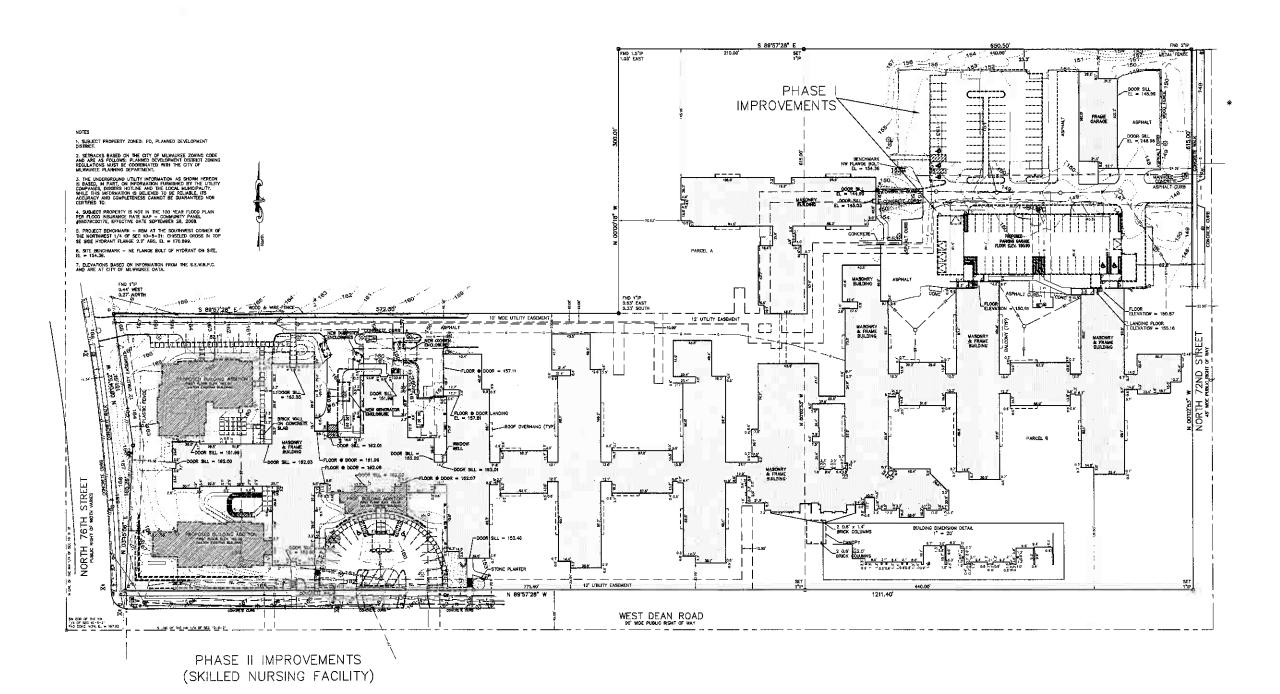

LEGEND

LEGING CONTROL MATERIAL STATE

STATE CONTROL STATE

CONTROL STATE

CONTROL STATE

CONTRO


AB J COSTEY THAT I MAY SUPERIOR THE ABOVE DESCRIBED PROPERTY. AND THE ABOVE MAY BE AT DUTL REPRESENTATION THEREOF AND SHOWS THE SIZE AND LOCATION OF THE PROPERTY. ITS EXTENDE BOUNDAMES. THE LOCATION AND LOCATION OF THE PROPERTY OF THE PRO



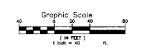

PLAT OF SURVEY FOR TRINITY VILLAGE 7500 WEST DEAN ROAD MILWAUKEE, WI


Drawn By:	ммс	Date: MAY 29, 2010
Chacked By:	CAJ	Drawing No. P-0
CSE Job No.:	10-040	Sheet 1 of 1
Y		

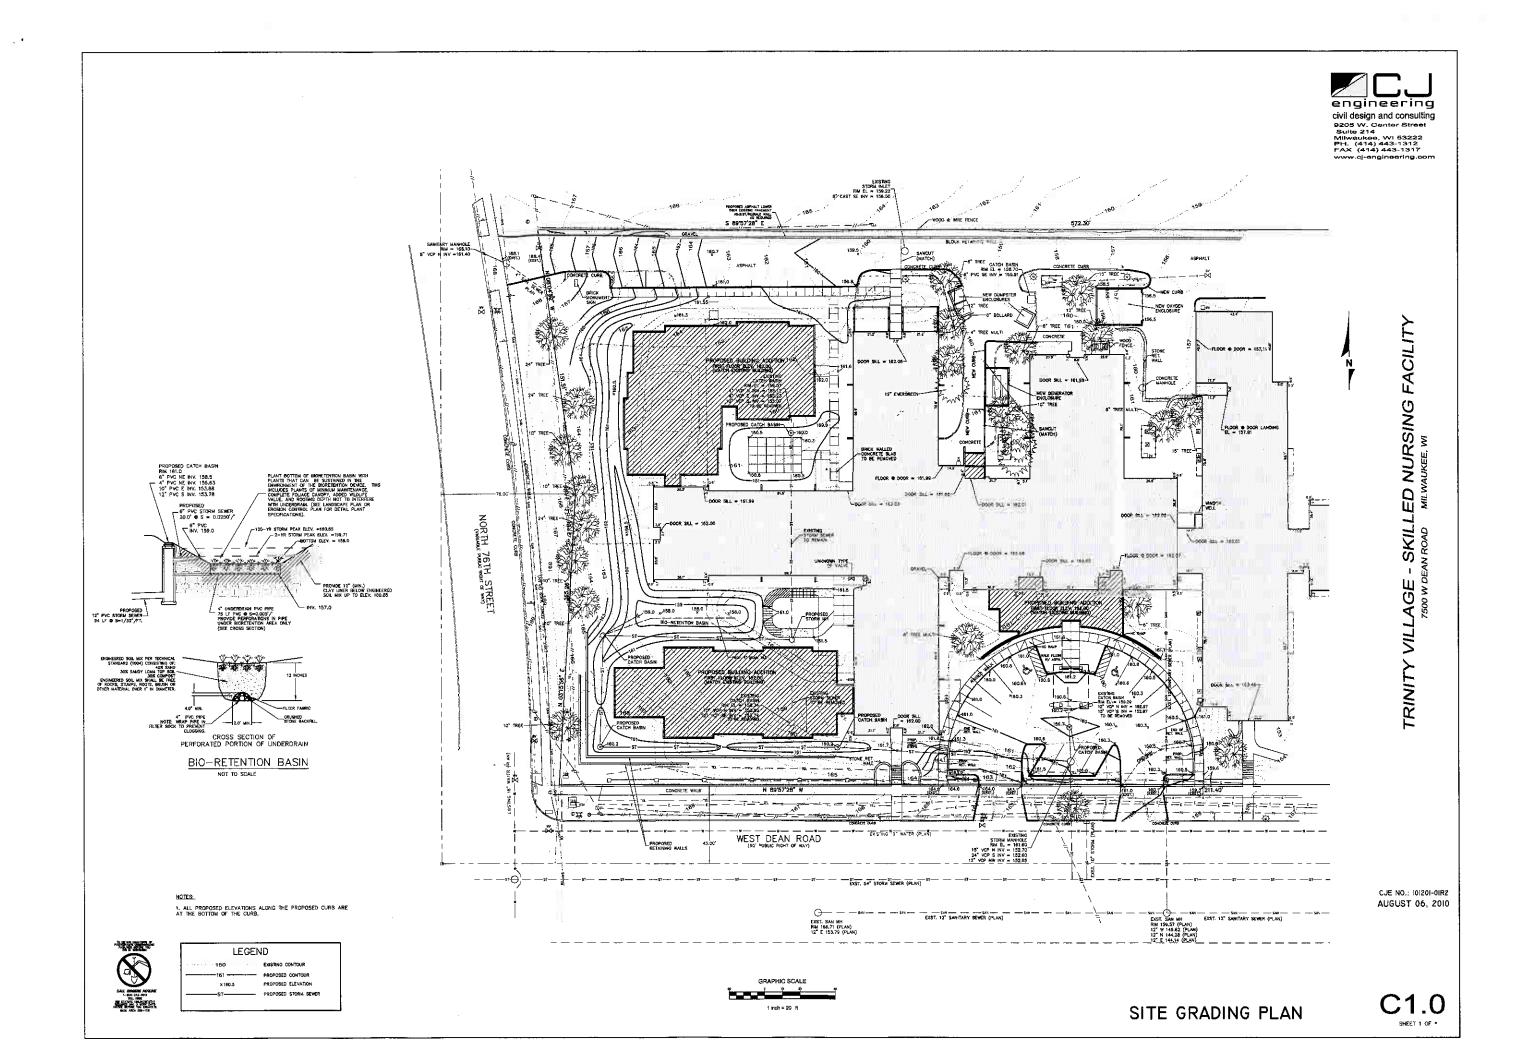



civil design and consulting 9205 W. Center Street Suite 214 Milwaukee, WI 53222 PH. (414) 443-1312 FAX (414) 443-1317 www.c)-engineering.com




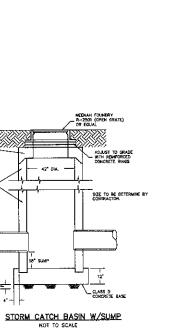

NOTE: PROMDE MANHOLE STEPS 18" O.C. FOR DEPTHS GREATER THAN 4"-0"


4. PROPOSED WATER MAIN SHALL HAVE A MINIMUM 6 FEET OF COVER. 5. THE CONTRACTOR SHALL VERIFY ALL SEVER AND WATER CONNECTIONS PRIOR UTILITY CONSTRUCTION, NOTIFY THE ENGINEER WITH ANY DISCREPANCIES.

LEGEND			
——————————————————————————————————————	EXISTING STORM SEWER		
st	PROPOSED STORM SEWER		
	EXISTING SANITARY SEWER		
	PROPOSED SANITARY SEWER		
	EXISTING WATER MAIN		
	PROPOSED WATER MAIN		

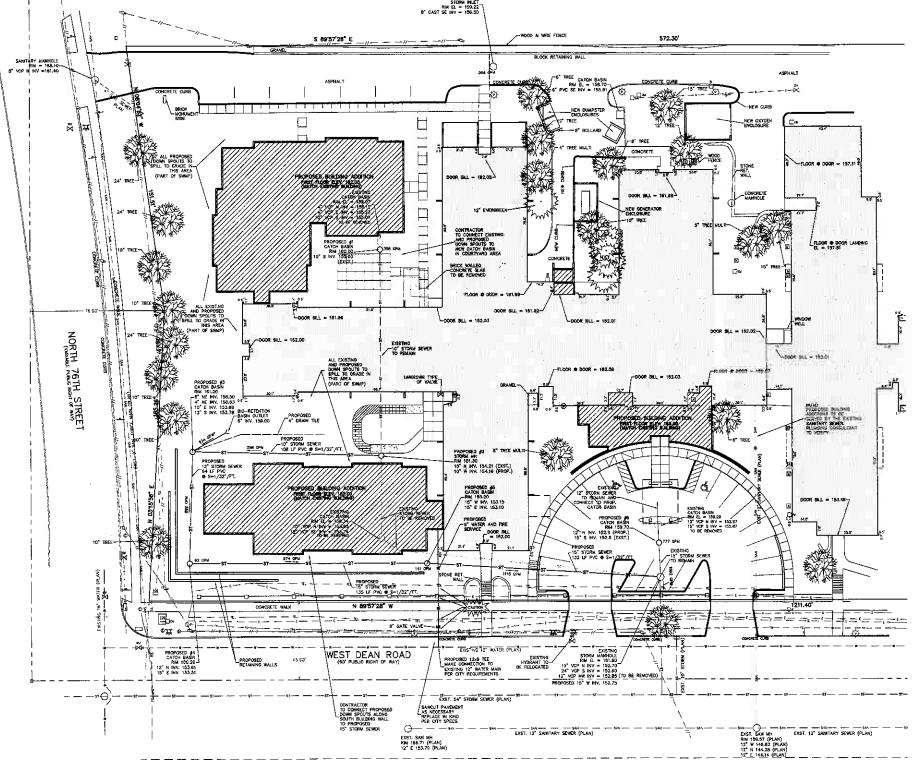

CJE NO.: 101201-01R2 AUGUST 06, 2010

TRINITY VILLAGE - SKILLED NURSING FACILITY

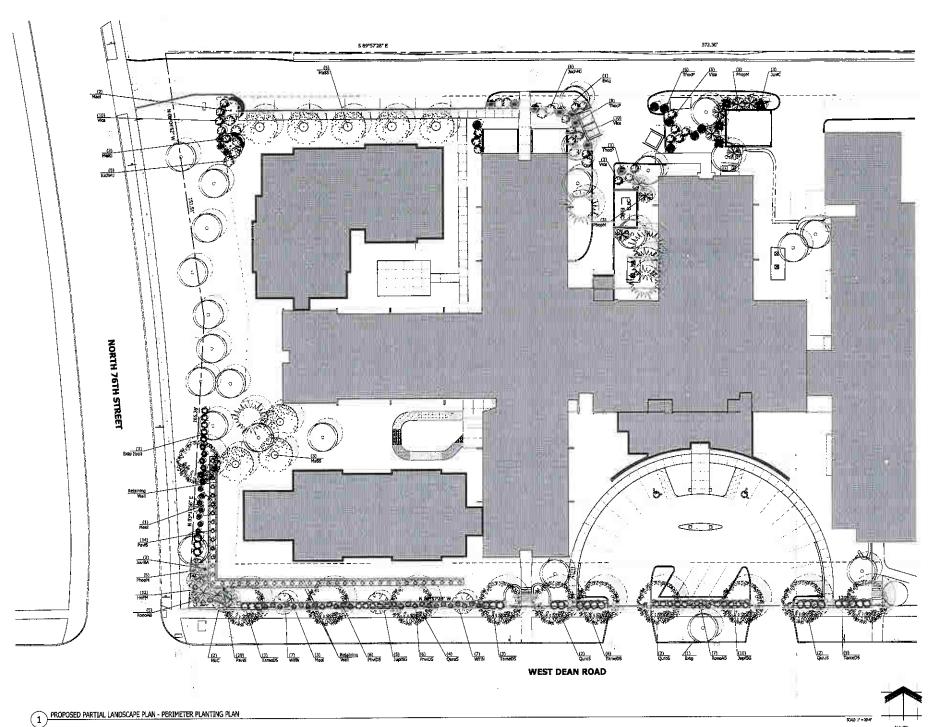

Perimeter Plant Material Table

Quantity	Code Name	Symbol	Scientific Name	Common Name	Planting Size	Comme
24	Extg	0	Existing	Existing	Existing	
6	Mael	- 3	Megnotic 'Elizabeth'	Elizabeth Magnolia	2"-Ca1 - 86B	
2	MaC	(à)	Melus x 'Coralburst'	Corafburst Crabappie	1 1/2" Cal - B&B	${}^{-}$
8	Mass	0	Melus x "Spring Snow"	Spring Snow Crebappie	3"-Cal - B&B	
11	Quro\$	Ō	Quercus robur 'Skymaster'	Skymeeter English Oek	2 1/2"-Cal - 88B	
Conifer Everg	reen Trec					
Quantity	Code Name	Symbol	Scientific Name	Common Name	Planting Size	Comme
5	Extg		Existing	Existing	Existing	
4	JUNIC .	*	Juniperus virginana "Cupressifolia"	Hilispire Juniper	5' · 6' - 86B	
2	JuviBA	*	Juniperus virginiana 'Blue Arrow'	Skie Arrow Juniper	5' - 6' - 888	
15	ThocP		Thuja occidentalis Pyramidalis	Pyramidal Arborvitae	5' - 6' - 66B	T
Conifer Evero	neen Shrub					
Quentity	Code Name	Symbol	Scientific Marne	Common Name	Planting State	Comme
11	3uchM3	Ö	Juniperus chinensis 'Hint Julep'	Mint Mee Juniper	24" + 30" - B&B	
20	JupfSG	ő	Juniperus x ofizerlena 'Mon5no'	Sea of Gold Juniper	18" - 24" - B6.8	
24	TameD5	Ō	Taxus x media 'Densformis Salect'	Select Dense Spreading Yew	15 · 24 · BSB	
Sconding Dec	Schools Shrub					-
Quantity	Code Name	Symbol	Scientific Name	Common Name	Planting Size	Comme
1B	PhylDS		Philadelphus x virginalis 'Owarf Snowflake'	Dwarf Snowfiske Mock Orange	18" - 24"-Cont	
13	PhopM	•	Physocarpus opulifolius 'Monio'	Diebolo Ninebark	2' - 3' - 868	
23	Vica	Ö	Yiburnum carlesii	Korean Spice Vibumum	30" - 36" - 888	
21	WARN		Weigela florida 'Variegeta Hana'	Varigated Dwarf Wegela	1-Gal - Cont	1
Broadleaf De	iduous Ground C	over Shrub				
Quantity	Code Name	Symbol	Scientific Name	Common Name	Planting Size	Commo
12	BAonoR	4	Rose x 'Moarnel'	Hower Carpet Appliableseom Rose	18" - Cont	
erannial Gra	<u> </u>					
Quentity	Code Name	Symbol	Scientific Name	Common Name	Planting Size	Comme
3	MIsKS	*	Piscanthus sineneis 'Grazicile'	Grazielia Malden Grass	1-Gal - Cont	
43	PaviS	٥	Penicum virgetum 'Shenandoeh'	Shenandosh Switch Grass	1-Gal - Cont	
Perennial						
	Code Name	Symbol	Scientific Name	Common Nems	Planting Size	Comme
Quantity						

LANDSCAPE PLAN GENERAL NOTES

* * PLANT MATERIAL SHOWN ON LANDSCAPE PLAN IS DEPICTED AT MATURE GROWTH, * *

TIME THAT SHALLOWS WELLANDSCAPE RAN IS DEPICTED AT MATURE GROWTH. **

AT LEAST SENSITY-TWO MOURS PRIOR TO ANY EXCANATION, CONTRACTOR SHALL VERBY UTILITY LOCATIONS AS GIVEN BY THE ELECTRIC, GAS, TELEPHONE WATER, SEMEN, AND CALL TELEPHONE WATER, SEMEN, AND CLIERTING, SITE GROWNING, STEE RECOMMEND, AND ALL COMPRESS OF CONTRACTORS OF THE STEE RECOMMEND OF THE STEE RECOMMEND. THE STEE RECOMMEND AND ALL CONTRACTORS OF THE STEE RECOMMEND, AND ALL CONTRACTORS OF THE STEE RECOMMEND. THE CONTRACTORS OF THE STEE RECOMMEND, AND ALL COMPRESS OF THE STEE RECOMMEND. AND ALL CONTRACTORS OF THE STEE RECOMMEND, AND ALL CONTRACTORS OF THE STEE RECOMMEND. AND ALL CONTRACTORS OF THE STEE AND ALL CONTRACTORS OF THE ADDRESS OF THE STEE AND ALL CONTRACTORS OF THE ADDRESS OF THE STEE AND ALL CONTRACTORS AND ALL CONTRACTORS OF THE ADDRESS OF THE A

ALL PLANTS MUST BE 310 AND SELECTED PER THE SPECIES SPECIFIED ON THE PLANS. THE SIZES OF PLANT MATERIAL LISTED HEREIN IS A MINIMUM ACCEPTABLE SIZE. ADDITIONALLY, IF EXCESSIVE PRUNTING REDUCES THE CROWN THE PLANT SHALL BE REPLACED.

ACCEPTABLE SIZE, ADDITIONALLY, IF EXCESSIVE PROJUNG REDUCES THE CHORN THE PURPLE POWER POWER.

PROTECT PUBLIC PROM CONSTRUCTION WITH BARRIESE NA GRAZICADES.

ALL AREAS THAT WERE DISTURBED DURING CONSTRUCTION AND AREAS NOT CONFIRM WITH PAVENENT; BUILDING, PLANTING SEDS, OR TREE PITS ARE TO BE TOORSICLED FORE (MIN.) AND SHALL BE SOCKEDED WITH SPECIFIED LAWN CRASS. LANGSCAPE CONTRACTOR SHALL INCLUDE COST PRI SQUARE YARD FOR ADDITIONAL SECO PREPAIRS OF THE PROPERTY OF THE PROPE

CONTRACTOR IS RESPONSIBLE FOR FURNISHING ALL MATERIALS, TOOLS, EQUIPMENT, LABOR, AND PLANTS NECESSARY FOR PROPER PLANTING AND INSTALLATION OF ALL LANDSCAPE MATERIAL.

INSTALLATION OF ALL LANDSCAPE MATERIAL.

QUARITITIS ON HARM TARTERIALS THAT FOR CONVEMIENCE OF BIDDING ONLY. CONTRACTOR IS RESPONSIBLE FOR ALL PLANTS SHOWN ON LANDSCAPE PLANS AND COMPRISE OF THE LAND THE THAT LIST IN ALL CASE.

CONTRACTION IS RESPONSIBLE FOR ALL ESTIMATION AND BOOMER, ALL AREAS, QUARITITIES METHALS SHOULD BE FREID VERIFIED WITH SITE CONDITIONS. WHERE DISCREPANCES COLD RETWEEN THE LANDSCAPE PLANS AND/OR ARCHITECTURAL AND/OR THE CIVIL DRAWINGS (AND ANY OTHER SITE DRAWINGS). THE DISCREPANCES NUTLE OF BOOMER'S AND ANY OTHER SITE DRAWINGS.

THE DISCREPANCES NUTLE OF BOOMER'S TO THE LANDSCAPE ARCHITECTS THAT THOSE PART CONDITIONS.

THE MEMBERSHALES THAT IS REMOVED TO THE WHILE HE ARE THE THAT THE CONTINUENT AND RESOLUTION. AND CONTINUENT TO THE START OF CONSTRUCTION AND CURRING THE MINITENANCE PRICE.

CHECK THE MIN

ALL LAWN AND PLANTING AREAS SHALL SLOPE TO DRAIN A MINIMUM OF 2% UNLESS NOTED OTHERWISE AND REVIEWED WITH OWNER'S REPRESENTATIVE FOR FINAL APPROVAL.

ALL LAWA AND PLANTING AREAS SHALL SLOPE TO DRAIN A MINIMAL OF 24 MILLESS NOTED OTHERWISE ARD REVIEWED WITH OWNERS REPRESENTATIVE FOR FIRM. AMENIAL, AND MAIL AND GOOD COVER AREAS TO RECEIVE A BLEND OF ORGANIC SOIL AND MEDIA TO PLANTING. THAT THE RECEIVE MAIL THE RECEIVE AND ADDRESS REPRESENTATIVE FOR FIRM STATE AND ADDRESS RECEIVE AND ADDRESS REPRESENTATIVE FOR PROBLEMS FROM TO PLANTING. THAT THE REPRESENTATIVE PROBLEMS FROM THE CONTROL OF PROBLEMS FROM THE PLANTING. THAT THE REPRESENTATIVE PROBLEMS FROM THE PLANTING FROM THE PLA

DAMMAR ON COMER FLANTS, REPER TO LISTLE FOR PRINTING INFORMATION.

LAWN INSTRULATION: CONTRACTOR TO FLANDES AND REPREAE TOPPOSIT, (2" MEN) AND SEED BED (REMOVE ALL STONES I "OR LARGER), APPLY STRATER FERTILIZES AND SEED LINFORMATY, PROVIDE A MULCH COVERING SUITABLE TO GERINANTE AND ESTABLISH TURF. EROSION CONTROL MERH SHOULD BE BED IN SYMMETS AND SEED DESIGN SWIEDER WHERE APPLICABLE, NETHONO OF INSTRULATION HAVE YEAR THE DISCOSTORY OF CONTROL OF CONTROL TO ITS HISHMER RESPONSIBILITY TO ESTABLISH AND GUARANTEE A SMOOTH, UNHFORM, QUALITY TURF. "S STRAW MULCH IS USED AS A COVERING, A TACKFIER MAY BE RECESSION!" TO A TOPO WHIGH DAMAGE.

RESPONSE TO FETABLES AND GLARANTER A SHOOTE, QUICTLY TURE, F. STRAW MILLER IS USED AS A CONSIGNA, A RACHEM MY RESPONSE AND THE CONSIGNATION OF THE PROPERTY OF

DESIGN IRRIGATION SYSTEM TO BE DESIGNED FOR A OVERLAPPING ZONED SPRINKLER HEAD SYSTEM IN ALL LAWA AND ISLAND AREAS AND A DRIP SYSTEM FOR ALL FOUNDATION PLANTING AREAS.

COMPRISTOR MOTE

GENERATION MOTE

GENERATION MOTE

GENERATION MOTE

GENERATION OF THE STANSO DEMOLITION IS TO BROID FOR PROPOSED NOW PAVEMENT, THE AREA IS TO BE STANSO AND ALL TREE AND SHRUSS THAT ARE TO

BEYONG SITE GRADUATED BY TAGGED BY LANDSCAPE ARCHITECT AND RELOCATED BY LANDSCAPE CONTRACTOR. IF REQUIRED A TREE PRESERVATION PLAN

WILL BE PRODUCED AND CONDITIONED WITH CITY THAT THE PRESERVATION PLAN

MILL BY THOUGHED AND CONDITIONED WITH CITY THAT THE PRESERVATION PLAN

DEMOLITION CONTRACTOR TO COORDINATE W/L LANDSCAPE ARCHITECT, OWNER AND LANDSCAPE CONTRACTOR.



WISCONSIN STATUTE 187.0175 (1974) REQUIRES A MINIMUM OF 3 DAYS NOTICE BEFORE YOU EXCAVATE (NOT INCLUDING SATURDAY, SURDAY OR LISGAL HOLIDAYS

THE LOCATIONS OF DUSTING UTILITY INSTALLATIONS AS SHOWN ON THIS SURVEY ARE APPROXIMATE. THERE MAY BE OTHER UNDERGROUND UTILITY INSTALLATIONS WITHIN THE PROJECT AREA THAT ARE NOT SHOWN.

UNDERGROUND SEWER AND UTILITY INFORMATION AS SHOWN IS OBTAINED FROM THE RECORDS OF MUNICIPALITY AND LOCAL UTILITY COMPANIES. THE ACCURACY OF WHICH CAN NOT EDE GUARANTEED ON CORTIFIED TO.

Owner's Approval I HAVE REVIEWED THESE DOCUMENTS FOR DESIGN INTENI AND I HAVE AUTHORIZED INSIGN LINGSCAPE DISIGN, INC. TO PROCEED WITH THE NEXT PHASE OF THE PROJECT SASED ON Signature Date Printed Name Title



11525 W. North Avenue Suite 1B Wauwatosa, WI 59226 Tel (414) 476-1204

Project:

TRINITY VILLAGE

7300 WEST DEAN RD. MILWAUKEE, WI

Issuance and Revisions:

Date Number Description 07/22/10 City Submittal


City Plan Commission Submittal

Sheet Title:

PROPOSED LANDSCAPE PLAN GENERAL NOTES AND PLANT MATERIAL TABLE

Date of Drawing: 08/06/10 1" = 20'-0" MCD Job Number: L09-070 Sheet Number:

LSP1.2

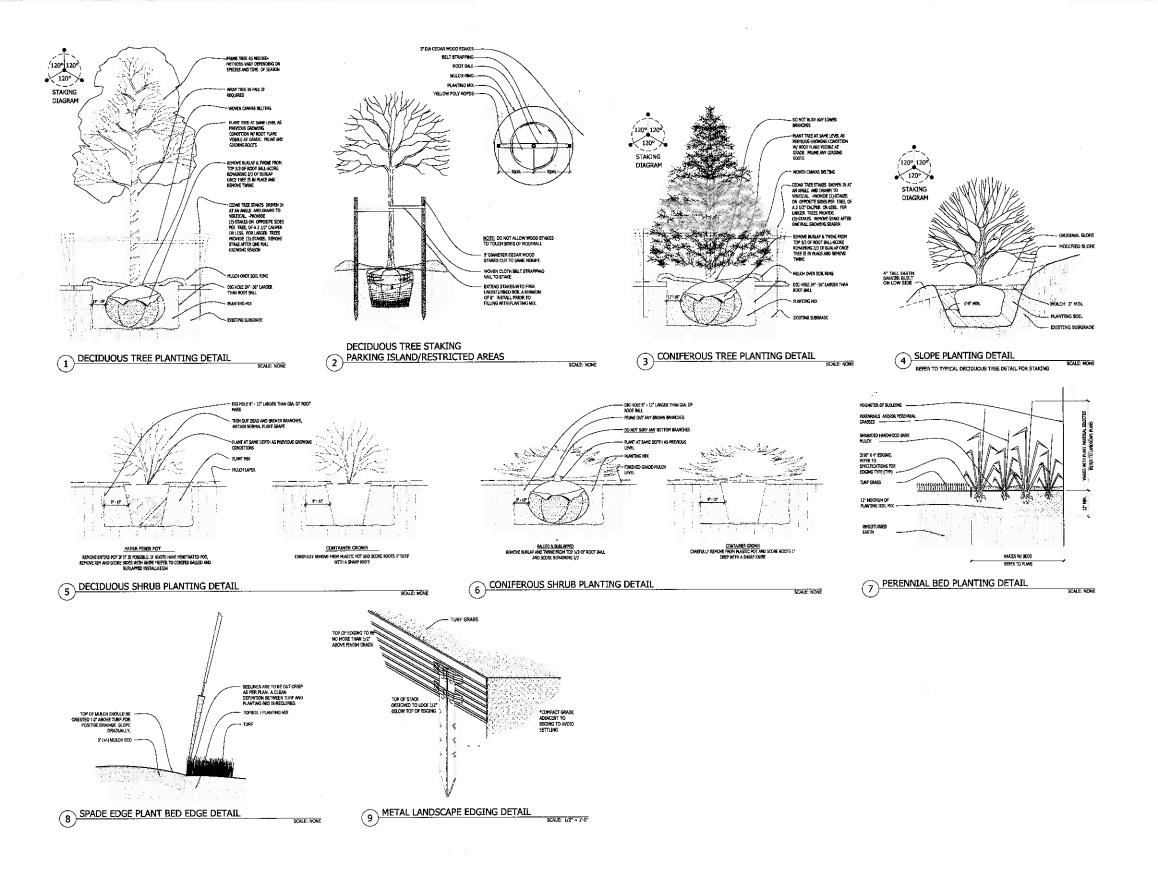

INSTE LANDSCAPE DESIGN

and Master Planning Design Services
and Master Planning Design Services
11525 W. North Avenue Suite 1B
Wauwatosa, WI 53226
Tel (414) 475-1204
www.insitelandscape.com
mdavis@insitelandscape.com

Projec

TRINITY VILLAGE

7300 WEST DEAN RD. MILWAUKEE, WI

Issuance and Revision

Date Number Description
07/22/10 City Submittal

City P Comm Subm

DPYRIGHT Insite Landscape Design Inc.: ALL RUCHTS RESERVED IIS DRAWING IS NOT TO BE REPRODU HANGED, COPIED OR ASSIGNED TO A PHIED PARTY IN ANY FORM OR MANN

Sheet 1

PROPOSED LANDSCAPE & GENERAL NOTES

OWNER'S Approval


I MUY ROTINNED PLESS DOCUMENTS FOR DESIGN INTENT
AND I HAM AUTHORIZED DISAS ENDICATE DOCUMENTS.

PROCEED WITH THE NEXT PLASS OF THE PROJECT SASED ON
THESE APPROVED DOCUMENTS.


Signature Date

Date of Drawing:	08/06/10
Scale:	As Noted
Drawn By:	MCD
Jab Number:	L09-070
Sheet Number:	
Sheet Number:	

LSP1.3

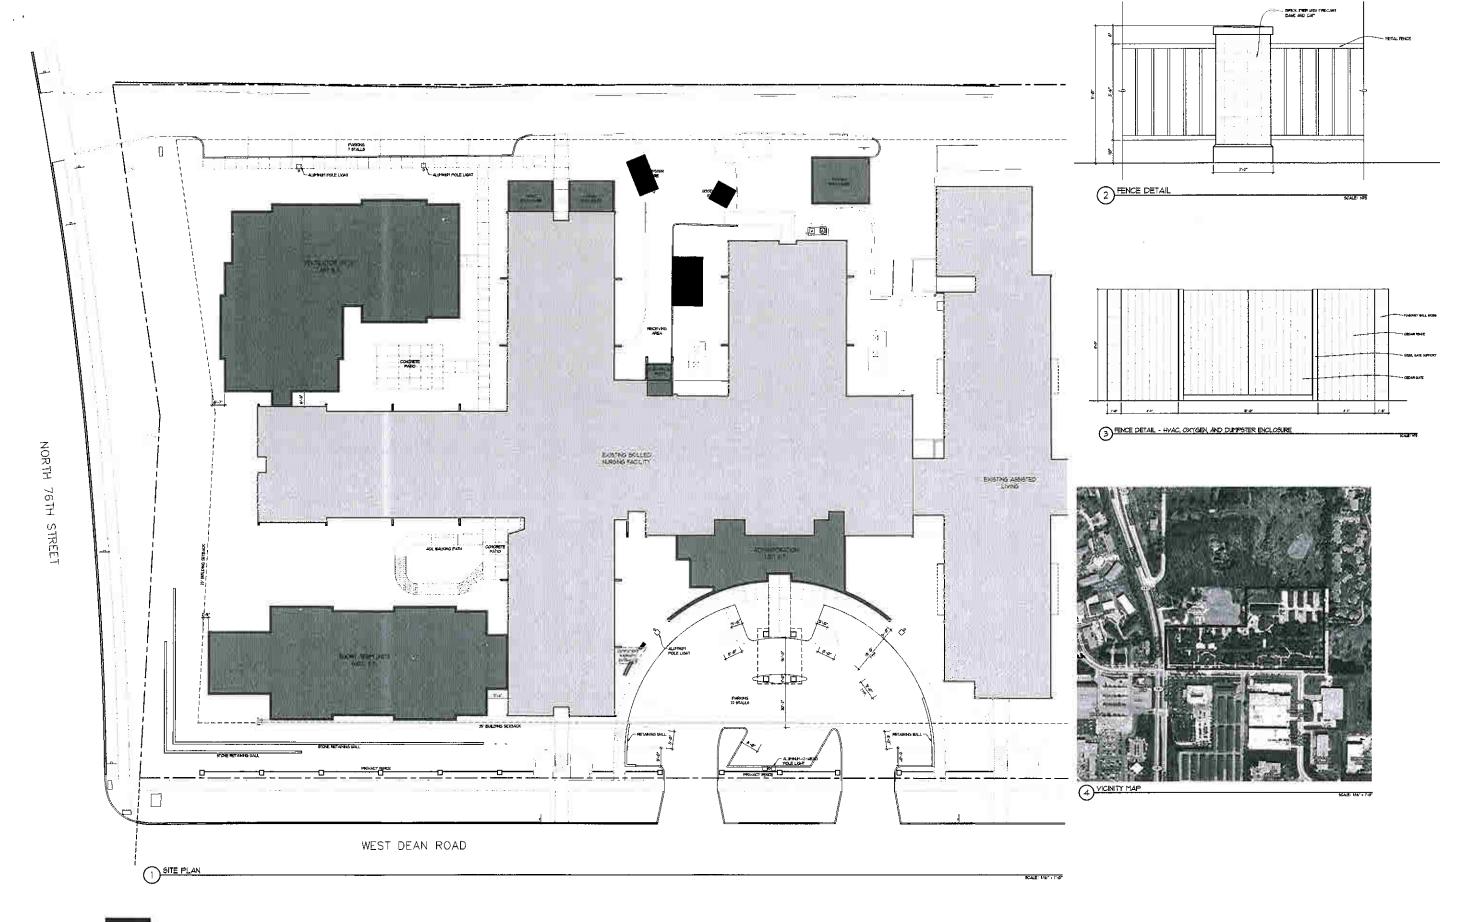



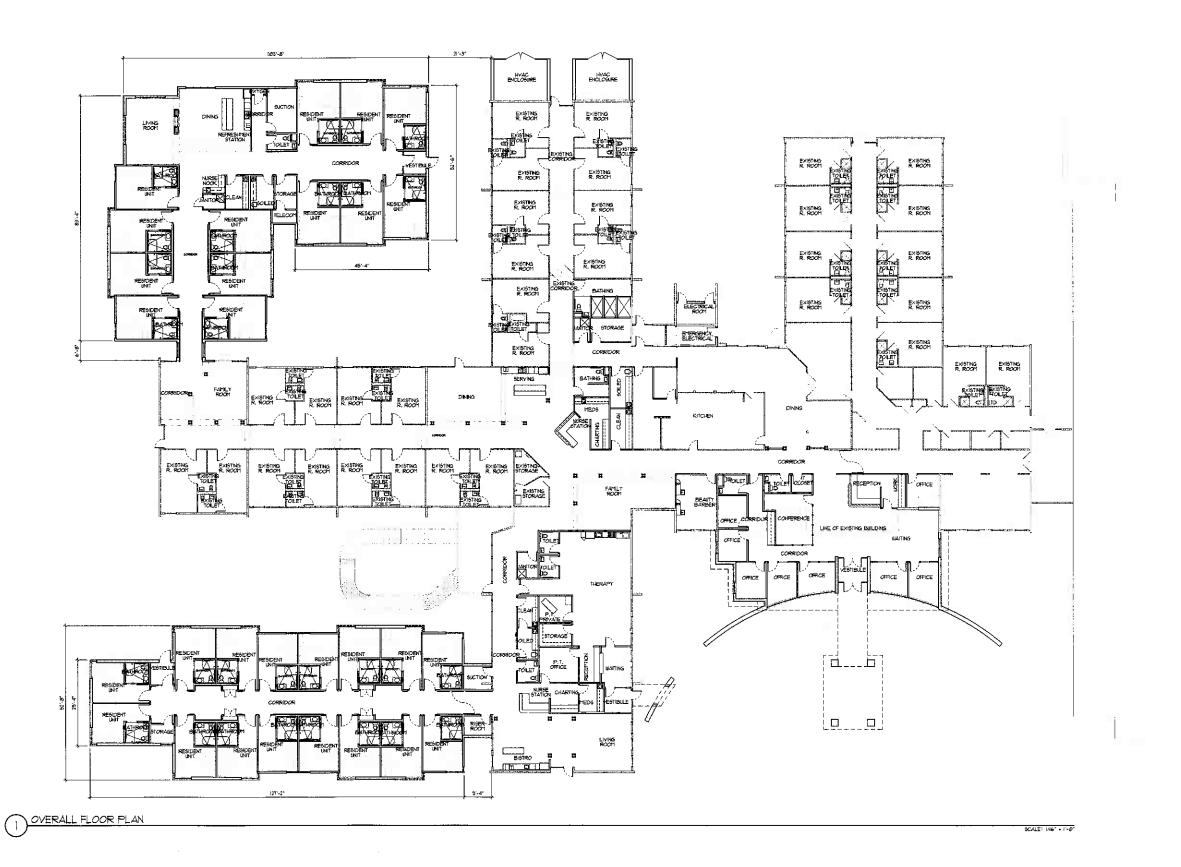













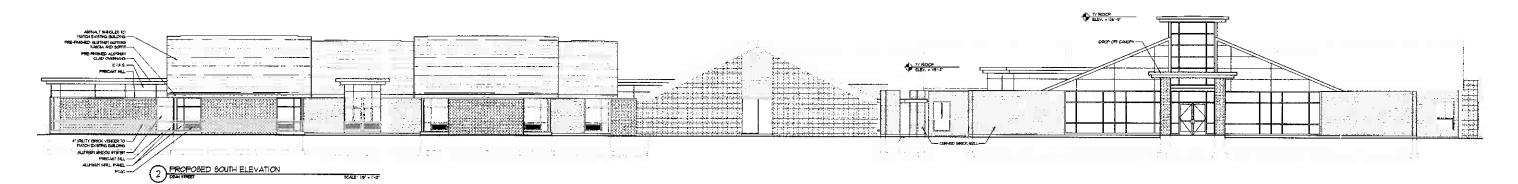

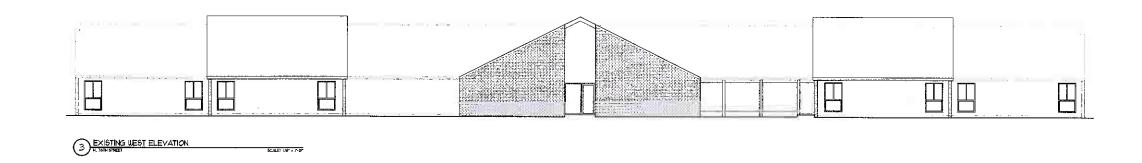


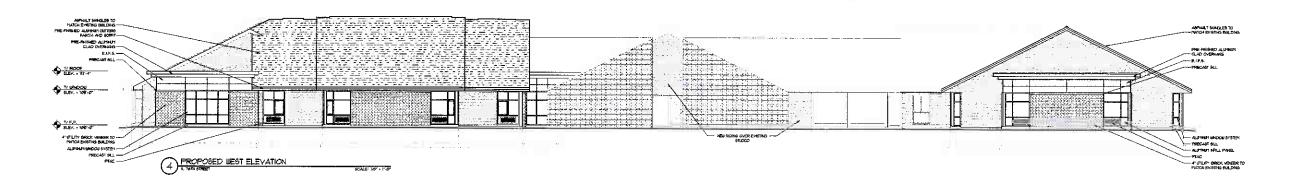





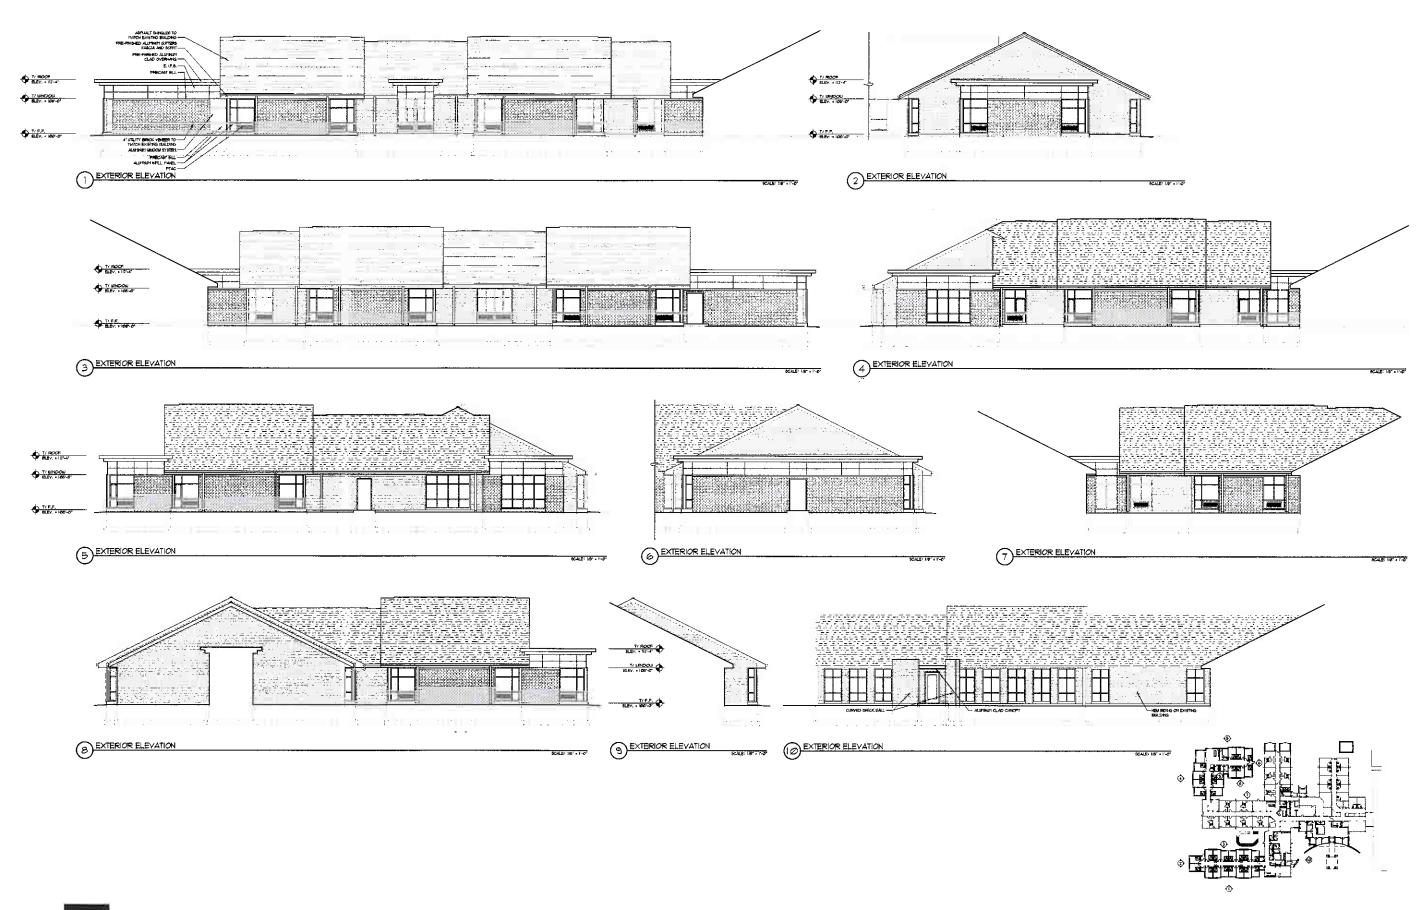




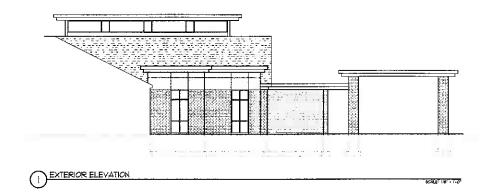

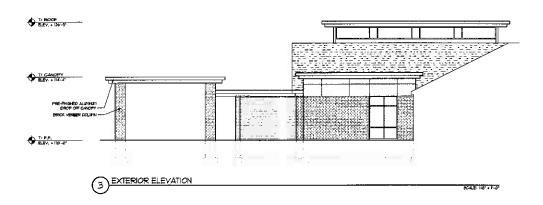

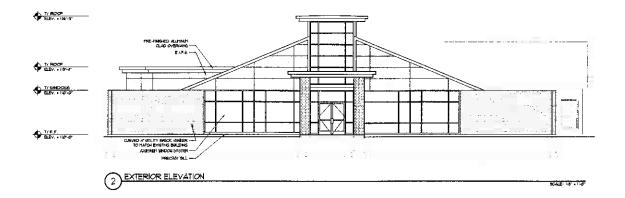

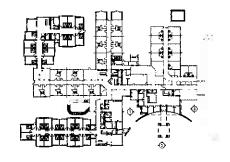




LEGAL DESCRIPTION

PARCEL A AND PARCEL B IN CERTIFIED SURVEY MAP NUMBER 1821, IN THE NORTHWEST 1/4 OF SECTION 10, TOWNSHIP 8 NORTH, RANGE 21 EAST, IN THE CITY OF MILWAUKEE, MILWAUKEE COUNTY, WISCONSIN.

CONTAINS: 13.227 ACRES



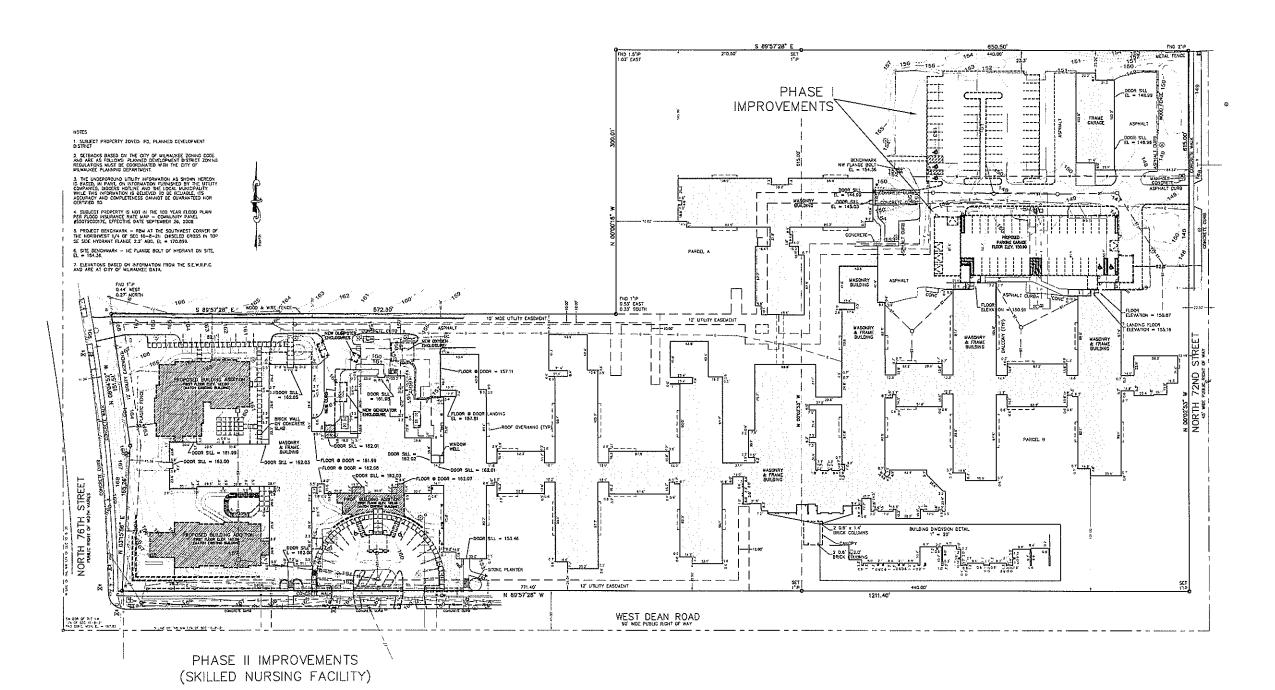


DEPART CONTROL CONTROL

I CREPT THAT I HAVE SUPERING TO A APPLY ESSENSED PROPERTY, AND THE ADDRESSANT AND THE ADDRESSANT ON THESE ON A DONOT THE ZET AND LOCATION OF THE PROPERTY, ITS EXTENDE BOUNDARDS, THE LOCATION AND DEPUISORS OF TALK USBELL STRUCTURES THEFOLD, BOWNDAMY EXCESS, APPARENT EASTWAYS AND ROLAWAYS AND MEBLE DICROLOMOTIS, IF ANY, THE STRUCTURES OF THE RECOUNT OF SUPERING AND RECOUNT OF ANY ASSO THOSE WAS THOSE OF THE RECOUNT OF THE CONTROL OF THE THE THEFOLD, WHEN ONE (1) THAT FROM DATE THEORY.

AUGUST 6, 2010

CHRISTOPHER A JACKSON, R.L.S. REGISTERED LAND SURVEYOR 5-2851



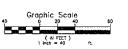


PLAT OF	SURVEY				
FOR					
TRINITY VILLAGE					
7500 WEST DEAN ROAD MILWAUKEE, WI					

Drown By:	ммс	Date:	MA	λΥ 29,	2010	200
Checked By:	CAJ	Drowleg 1	ło.	Р	-0	WANTED BY
CSE Job No.:	10-040	Sheet	1	o!	1	

SV1.0



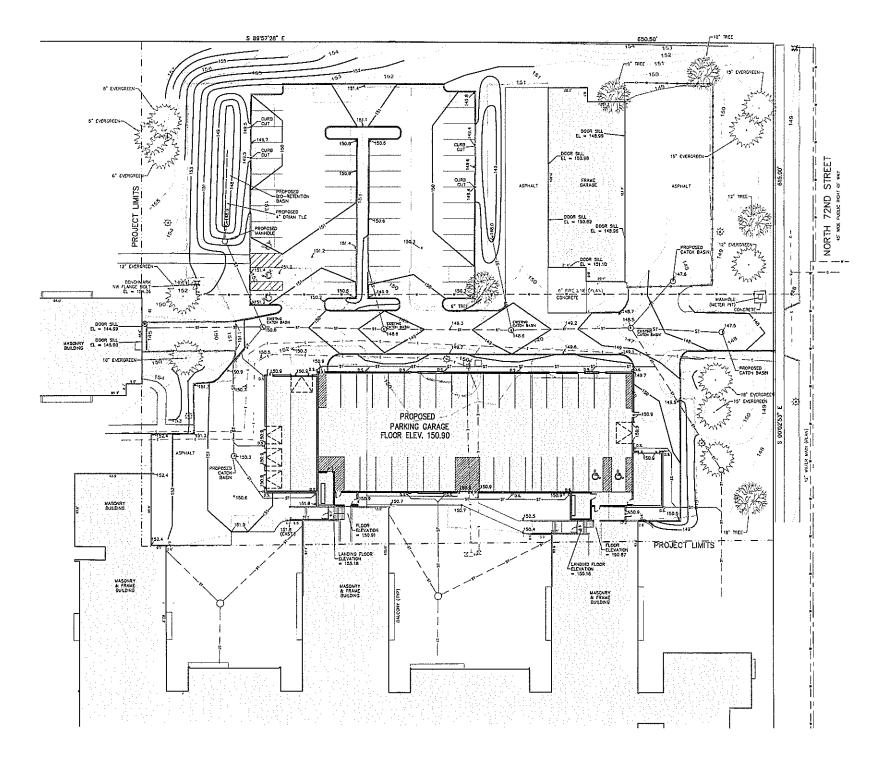


TRINITY VILLAGE 7300 W. DEAN RD. MILWAUKEE, WI

CJE NO.: 1012R2 JULY 16, 2010



LEGEND				
	44	EXISTING CONTOUR		
	885	PROPOSED CONTOUR		
× 590.5		PROPOSED SLEVATION		
	st	PROPOSED STORM SEWER		



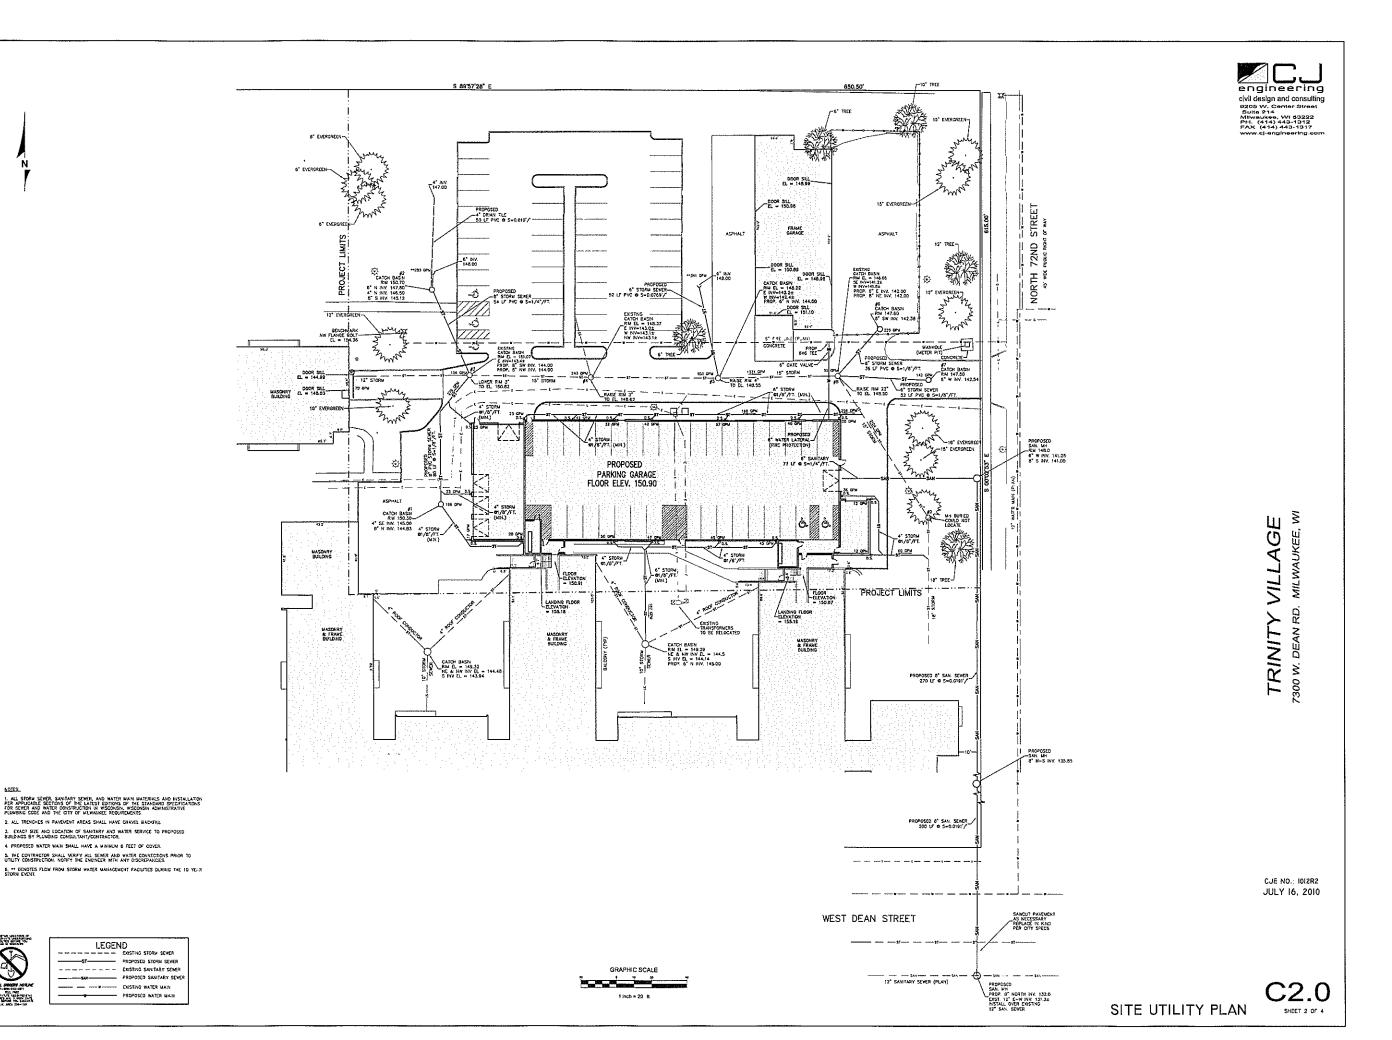

Plant Material Table

Quantity	- Code Name	Symbol .	Scientific Name	Common Hame	Planting Size	Comments
4	AcceG4	•	Aper Sappharum 'Green Mountain'	Green Mountain Sugar Maple	2 1/2"-Cal - 248	1
3	MASS	<u> </u>	Makus x "Spring Snow"	Spring Snow Crabappie	3"-Cai - 853	
8	PytaC	. 0	Pyrus calleryana 'Chanticlees'	Chantideer Pear	2 1/2"-Cal - B&B	
6	Quras	0	Quercus robur 'Skymaster'	Skymester English Dak	2 1/2"-Cal - 98.8	
9	. Extg	. 0	Existing	Existing	Existing	1
Conifer Every	preen				·	
Quantity	: Code Name	Symbol	Scientific Name	Common Name	Planting Size	Comments
7).rrC	#	Juniperus virginana 'Cupressifolia'	Hilispire Juniper	5'-6'-658	1
11	: Extg	. 0	Existing	Existing	Existing	1
45	JuptSG	. 0	Juniperus x prizerlana 'MonSan'	Sea of Gold Juniper	15 - 74" - 859	1
63	TameOS	0	Taxus x media 'Densformis Select'	Sciect Dense Spreading Year	18 - 24" - 53.5	1
Proactical De	ciduous Shrub					
Quartity	Code Name	: Symbol	Scientific Hame	Common Name	Planting Site	Comments
39	thul	•	Ligustrum vulgare Todense'	Lodense Privet	18° - 24"-Cont	1
20	PhviD5	•	Philadelphus a virginalis 'Dwarf Snowfiske'	Dwarf Snowflake Mock Drange	18* 74"-Cont	1
16	· PofiG		Potentiža fruticosa 'Goldfinger'	Goldfinger Potentilla	18" - 24"-Cont	1

LANDSCAPE PLAN GENERAL NOTES

- * * PLANT MATERIAL SHOWN ON LAUDSCAPE PLAN IS DEPICTED AT MATURE GROWTH. * *
- ** ELECT PALIFIES LESSING ON LANDSCAPE PLAN IS DEPICTED AT HATCHE GROWTH, ** **

 AT LEAST SEVENT-TWO HOUSE PROBE TO ANY EXCANATION, CONTRACTOR SHALL YERFOUTHING LOCATIONS AS GOVERN'S THE ELECTRIC, CAS, TELEPHONE,
 WATER, SEVEN, AND CASE. TELEPHONE SHORT PLAN IN LITHES OR DETITIES. REVIEW WITH CONTRACTS REPRESENTATE SITE INCOMING, STE
 ELECTRICAL AND LIGHTING, SITE GRADING AND DRAINES, SITE BRIGATION AND ALL OTHER DAWNINGS PRITAINING. TO LIDEOSCROUND UTILITIES
 CONTROL SECOND SET OF PROPHARION THE SAME AS IN POSSESSION OF OWNERS AS USEFER SHIPTIVE. AND DRAVEN OWNERS THAN SETTO OF ALL OF
 LOCATIONS REPORT AND DRAINE CONTROLTON. SEPARA ON DOWNERS, HARA ALL SOOD UTILITIES ON THE SITE PLANS TO COMPANION. COMPANIONS WITH
 OWNER SEFORE AND DRAINE CONTROLTON. SEPARA ON DOWNERS, HARA ALL SOOD UTILITIES ON THE SITE PLANS FOR CONTROLTON.

 ALL PLANTINGS SHALL CORPAY WITH SYMDAMORS OF RESCRIBED IN APPROXICAL STRANDOR OF INSERTY STOCK ONLY ZOOD 1986.

 DEVALUTIONS FROM THESE PLANS SHALL BERK ONTO ON THE RECORD DRAWING BY THE CONTRACTOR AND ONLY WITH PRIOR LAPPROXICAL OF THE LANDSCAPE
 ARCHITECT AND DOWNERS REPRESENTATIVE. YEARLA ARREPARENTS OR REVISIONS WITHOUT A CHARGE ORDER WILL NOT BE RECOGNIZED BY LANDSCAPE
 ARCHITECT AND DOWNERS.

- AND ITTECT AND OWNES.

 ALL PAINTS PLOTS BE BID AND SELECTED FOR THE SPECIES SPECIFED ON THE PLANS. THE SIZES OF PLANT MATERIAL LISTED HEREIN IS A MIXIMUM ACCEPTABLE STEE. ADDITIONALITY, IF DECESSIVE PRUNING REDUCES THE CHOWN THE PLANT SHALL BE REPLACED.

 PROTECT PUBLIC FROM CONSTRUCTION WITH BARRIESS AND BARRICADES.

 ALL LARGES THAT WERE DISTURBED DURING CONSTRUCTION AND AREAS HOT COVERED WITH PROPERTY, BUILDING, PLANTING BEDS, OR THEE PITS ARE TO BE TOPOGLED 6" DEEP PUBLIC AND SHALL BE SOODED/SEEDED WITH SPECIFED LAWN GRASS. LARGES/ACCONTRACTOR SHALL INCLIDE COST PER SQUARE WARD FOR A DOTTONAL SEED OPERATIONS AS WERE POSSELY REQUIRED TO RESTAULISH AUDICENT THAT GRASS AREAS WHOCH HAY RECOME DAMAGED DURING THE CONSTRUCTION PROCESS OR TO REPAIR DAMAGED DONE BY OTHERS.

- 7. CONTRACTOR IS RESPONSIBLE FOR PURISHING ALL MATERIAS. TOOLS, EQUIPMENT, LASOR, AND PLANTS RECESSARY FOR PROPER PLANTING AND INSTALLATION OF ALL LANDSCAPE MATERIAL.

 QUANTITIES OF HAATH REMINEL SETS ARE FOR CONVENENCE OF BIDDING DRIVY. CONTRACTOR IS RESPONSIBLE FOR ALL PLANTS SHOWN ON LANDSCAPE MAY AND CONCENTRACTOR IS RESPONSIBLE FOR ALL PRIVATE WAY AND CONCENTRATION OF THE MAY AND CONCENTRATION OF THE CONCENTRACTOR OF THE CONCENTRACTOR OF THE MAY AND CONCENTRACTOR OF THE CONCENTRA

- OURING THE PAINTENANCE PRIZOD.

 CARRAGE CONTACTOR SHALL LEAVE THE STIE FREE OF CONSTRUCTION DEBALS.

 SERVING CONTACTOR SHALL LEAVE THE STIE FREE OF CONSTRUCTION DEBALS.

 INTEH GRADES FOR SHALL BLOW THE STIE FREE OF CONSTRUCTION DEBALS.

 INTEH CALL SHAN THE SHALL SHALL SHALL SHALL BE READ IT DELOW TOP OF ADJACENT PAVEMENTS AND CURBS, UNLESS NOTED OTHERWISE AND REVIEWED WITH DONSERS REPRESENTATIVE FOR HIML AND RUNTING AREAS SHALL SLOPE TO DAMIN A MINIMUM OF 2% UNLESS NOTED OTHERWISE AND REVIEWED WITH DONSERS REPRESENTATIVE FOR HIML ANDROMAL.

 LE ALL PREPARAL, MINIMUM, AND GROUND COPER AREAS TO RECEIVE A BURD OF ORGANIC SOIL AVERDMENTS PRICOR TO PLANTING. THE THE POLLOPHING MATERIALS HIGH DEBALS THE ORGANIC SOIL AVERDMENT SHIGH TO PLANTING. THE THE POLLOPHING MATERIALS HIGH DEBALS TO RECEIVE ADJUSTMENT OF PRICORS OF THE CONTITION OF EXISTING SOIL. REPER TO LIFE 12 FOR FRANCE INFORMATION.

- MATERIAS INTO ESISTING TOPSOIL TO A DEPTH OF APPROPRIATELY SF. A DEPTH OF LY 'NI TIES FITS, PROPORTIONS AND QUANTITIES MAY REQUIRE ADJUSTMENT OFFENDRA OF THE CONTINUE OF ENISTRIES DOL. REFER TO LIFE I TOR REPHER EMPORATION.

 PER LYCEL TO SQUARE FEET AND CONTINUES OF THE CONTINU

NECESSARY TO AND WIND DAMAGE.

PROCESSARY TO AND PART OF THE PROPERTY OF THE GRASS 20% AUTHOR ENTHOCY BLUE GRASS 20% LANGARA KEMITODY BLUE GRASS 20% UNION COUNTRY ORDINION STREET OF THE PROPERTY OF THE GRASS 20% UNION COUNTRY FOR THE PROPERTY OF THE GRASS 20% UNION COUNTRY FOR COUNTRY OF THE GRASS 20% UNION COUNTRY OF THE GRASS 20% UNION

SALT TOLERANT GRASS SEED MIX REINDERS 1-252-785-3100 25% FLITS ALVALIGASS 10% SPA LINC CEEPING RED FESCUE 20% KERBLUE KENTLICKY BLUE GRASS 15% SPARTAN HAID FESCUE 20% QUEBE PERBINALIA MIX GRASS

- During the initial "maintenance period" the landscape contractor is required to provide and on-going measant visual environment whereas any paant which is not responding to transparting or fireving simil envirately be replaced. New lawing shall watered and reparible and weeds must constraint be removed, no exceptions will be granted and
- LANDSCAPE / SITE DEMOLITION CONTRACTOR TO VERIFY LOCATIONS OF EXISTING TREES AND SHRUBS BE SALVAGED AND CLEARLY TAG THEM WITH MARKING TARE AND CONSTRUCTION FENCE.
- LANDSCAPE / SITE DEMOLITION CONTRACTOR TO VERIFY LOCATIONS OF EXISTING TREES AND SHRIPS TO BE RELOCATED. ALL PLANT HATERIAL TO BE RELOCATED IS TO BE CLERKLY TRACED WITH MARKING TARE MOVED BEFORE AND SITE DEMOLITION IS TO BEGIN.

 DESIGN RIPIGATION STATTED TO BE DESIGNED FOR A OVERLAPPING ZONED SPRINGLER HEAD SYSTEM IN ALL LAWIN AND ISLAND AREAS AND A DRIP SYSTEM FOR ALL FOUNDATION PARTITION FACES.

TOR ALL FOUNDMENT PARTITIONS OF THE PROPOSED HAVE PROPOSED HAVE PROPOSED. THE AREA IS TO BE STAVED AND ALL TIME AND SPERIS THAT ARE TO BE PROPOSED HAVE AND ALL TIME AND SPERIS THAT ARE TO BE PRESENTED ARE TO BE TAGGED BY LANGUAGE ADDITION AND RELOCATED BY LANGUAGE CONTRACTOR. IF REQUIRED A TIME PRESENTATION FLAN WILL BE PRODUCED AND COORDINATE WITH CHIT SHAPE.

OFFICIENT OF CONTRACTOR TO COORDINATE WILL WHOSCAPE ARCHITECT, OWNER AND MICROSOPE CONTRACTOR.

TO DETAIN LOCATION OF PARTICUPANTS UPGERGROUND FACILITIES REFORE YOU 1-800-242-8511

yeścizasin statute (1928) 73 (1974) requires a minimum of 3 dató notre Pore you excavate (not dioloding saturday, surgay or legal holidays)

THE LOCATIONS OF EXISTING UTILITY INSTALLATIONS AS SHOWN ON THIS SURVEY ARE APPROXIMATE. THERE MAY BE OTHER UNDERGROUND UTILITY INSTALLATIONS WITHIN THE PROJECT AREA THAT ARE NOT SHOWN.

Underground sewer and utility information as shown is obtained from the records of municipality and local utility companies. The accuracy of which can not be guaranteed or certified to.

Landscape Architecture and Master Planning Design Services

11525 W. North Avenue Suite 1B Wauwatosa, WI 53226 Tel (414) 476-1204

Project:

TRINITY VILLAGE

7300 WEST DEAN RD. MILWAUKEE, WI

07/22/10

Issuance and Revisions: Date Number Description


Sheet Title:

PROPOSED LANDSCAPE PLAN GENERAL NOTES AND PLANT MATERIAL TABLE




Date of Drawing:	
	07/22/1
Scale;	1" = 20'-
Drawn By:	MC
Job Number:	L09-07
Sheet Number:	

LSP1.1

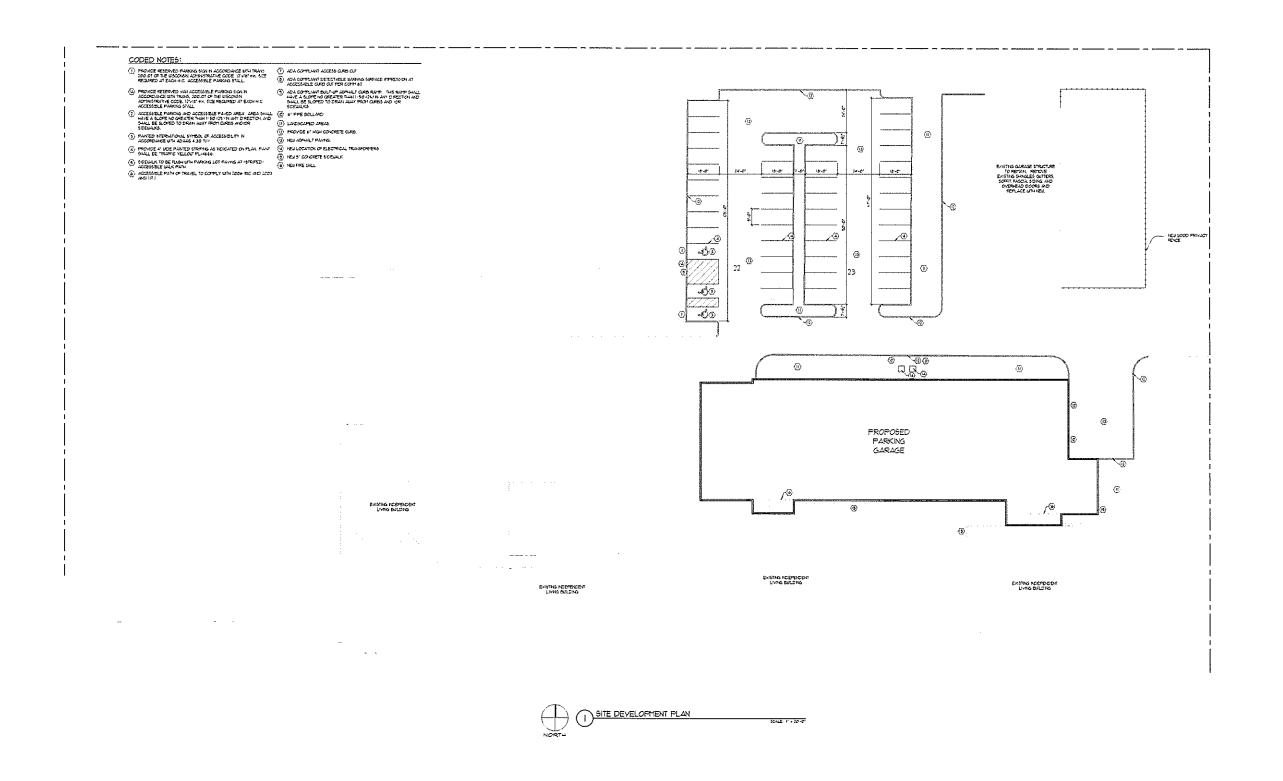



TRINITY VILLAGE - GARAGE SITE PLAN

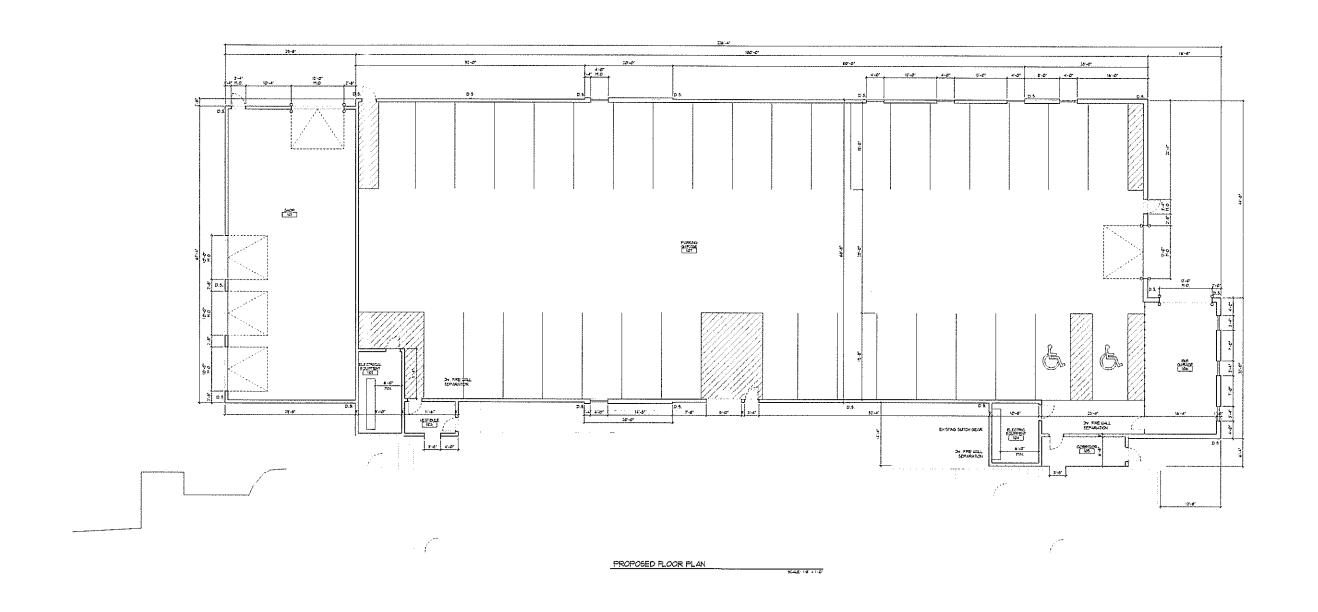

ELEVATION CODED NOTES:

BROWNER

BROWNER

WOODDONG WITH COME


BY HAVE DO VIDER


GRANTO ONE

MALLITO ONE

MALL

© © © Ø

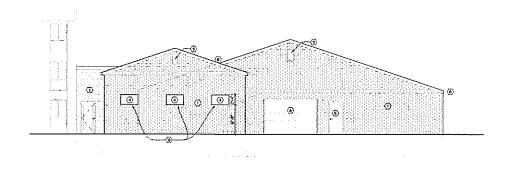

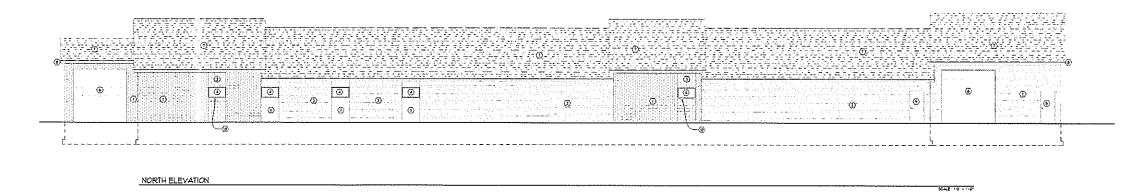

EAST ELEVATION

