NOMAD - Cafe

1668 N. Warren Ave. Milwaukee, WI 53202

Project Information

<u>Froject ii</u>		<u>auur</u>										
Applicable Codes:		The Wisconsin Commercial Building IEBC 2015 Edition				Interior Finish Class :	T803.9	Corridors:	es & Passage V losed Spaces:	•	Class C(a) Class B Class C	, Class B(b)
		The Wisconsin Commercial Building IBC 2015 Edition	Code -			Emergency Lighting:			hting provided			1
		National Fire Protection Association, NFPA 101 Life Safety Code, latest ed	dition					in all corridors	and enclosed			
		American with Disabilities Act and IC A117.1 – 2009, Accessible Buildings		S		Fire Protection Systems	re Protection Systems 903.2.1.2 Non-Sprinklered Group B use controls entire building as mixed-u non-separated occupancies					ıse,
		City of Milwaukee, WI - Codes				Isolation Of Hazards:		•	chanical equipm	ent w	nere provide	ed.
Permit Action Requeste	۵.	The request is for the alteration of the	o around love	al of an aviating	. O otomi			utilizes sealed combustion – no rated enclosu required				
building (former residence w/ small ground-level commercial space) to a new cafe, along with the construction of a new elevated patio space.						Separate Facilities:	2902.2(2)	·				
		Any required MEP/FP work to be De	y required MEP/FP work to be Design-Build.					fewer (Toilets not required for public customer area per 2902.3(2))				
Use & Occupancy:	303.1.2	B Small Assembly - Cafe The following rooms and spaces shall not 1. A room or space used for assen less than 50 persons and accesso as a Group B occupancy.	Employee & Public Toilet Facilities:	2902.3(2)	Public toilet facilities shall not be required in structures and tenant spaces intended for quick transactions, including takeout, pickup and drop-off having a public access area less than or equal to 300sq. ft. (<i>Public Cafe Space = 200sq. ft.</i>)				o-off,			
	304.1	B Business - Backcounter/Bac	kroom/Offic	е		Toilet Facilities Beguired:	T2002 1					
	508 508.3	Mixed Use & Occupancy Non-Separaed Occupancies				Toilet Facilities Required:	. 12902.1		Me	'n	Women	
	508.3.2 508.3.3	Allowable building area and height - Separation - No separation is require		on-senarated c	occupancies	B - Small Asse	embly (Cafe/O	ffice)	1 - 1 -	1	1 -	1
				o., oopa, a.oa o	, o o a p a o . o o	Total			1 - 1 -	1	1 -	1
Class of Construction	602.5 T601	V-B							ervice Sink Fountains Lavatories Urinals	Closets	Lavatories Urinals	Closets
Number of Stories:	T504.3 T504.4	(2)-Story [2 Permitted]	40'-0" maxir	num height					Servic Drinking Fou Lava	Water C	<u>~</u>	Water C
Allowable Building Area, (SF):	T506.2 506.1	(2)-Story Building, Use Group B B, Non-Sprinklered		9,000 SF					Drink		•	
		Dagament		4 075 05		Toilet Facilities Provided:						
Actual Building Area, (SF):		Basement Ground Floor		1,075 SF 1,075 SF					Me	n	Women	
		Second Floor Tota	I	850 SF 3,000 SF		B - Small Asse	embly (Cafe/O	ffice)	1 - 2 -	2		2
Occupant Load:	T1004.1.1		<u>SF</u>	SF/ Occ	# of Occ.				ns ms	its	es als	
		<u>First Floor</u> B Cafe	 200 SF						rvice Sink Fountains Lavatories Uninals	Closets	Lavatories Urinals	Closets
		Backcounter Backroom	96 SF 343 SF	15 net 100 gross 100 gross	14 1 4				Service Sink Drinking Fountains Lavatories Urinals	Water (Water (
		New Porch - Bar-Rail New Porch - Pickup Queue	24' L 55 SF	24"/Occ. 5 net	<u>12</u> 11	Zoning Information:			Orin			
		Second Floor	Fir	st Floor Total	42				EN PART OF HIST SINESS DISTRICT		RADY ST. OV	ERLAY DISTRIC
		B Office	630 SF	100 gross	<u>7</u>			Setbacks Requi				
		_	Secon	d Floor Total	7			Min. Front Setba Max. Front Setba Min. Side Street	ack:		None Average None	
			Overall E	Building Total	49			Max. Side Street Min./Max. Rear S	Setback:		None None	
Fine Batinana	T004	Diana Charles France		O LID				Min./Max. Side S Min./Max. Rear S	Setback:		None None	
Fire Ratings, Building Elements:	T601 T602	Primary Structural Frame Bearing Walls (Exterior) Bearing Walls (Interior)		0 HR 0 HR 0 HR				Min. Building Hei Max. Building He			18' 60'	
		Nonbearing Walls and Partitions (E Nonbearing Walls and Partitions (Ir	nterior)	0 HR 0 HR				Min. Glazed Area Min. Glazed Area	a (Primary St.) a (Secondary St.)		60% 15%	
Floor Construction and Secondary Members 0 HR Roof Construction and Secondary Members 0 HR					Min. Build-out (P Max. Build-out (S			30% None				
		Fire Separation Distance x<5 Fire Separation Distance 10<=x<=3	30	1 HR 0 HR				Max. Signage An	ea		18 sq. ft.	


PERMIT/BID SET

August 07, 2020

OWNER

Nomadic Ventures

Mike Eitel tel: 414.350.7557 email: uncledude@mac.com

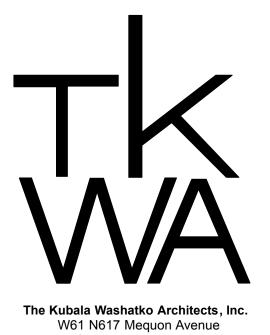

Cedarburg, WI 53012 p: 262.377.6039 | f: 262.377.2954

Chris Socha AIA email: csocha@tkwa.com website: www.tkwa.com



TKWA Job Number: 219617.01

CONSULTANTS

Structural SPIRE ENGINEERING, INC 305 N Plankinton Ave., Suite 101 Milwaukee, WI 53203

tel: 414.278.9200

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HITECTURAL		
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	Plat of Survey Code Plans Code Plans IITECTURAL Basement Demolition Plan Ground Floor Demolition Plan Demolition Elevations Site Plan	Plat of Survey S1.1 Code Plans Code Plans S2.0 IITECTURAL Basement Demolition Plan Ground Floor Demolition Plan Demolition Elevations Site Plan


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ABBREVIATIONS


@	AT	CORR	CORRIDOR	НС	HANDICAPPED	R.C.	ROOF CONDUCTOR
		CRS	COURSE	HDR	HEADER	R.D.	ROOF DRAIN
ADJ	ADJUSTABLE	CTR	COUNTER	HM	HOLLOW METAL	REF	REFRIGERATOR
AFF	ABOVE FINISHED FLOOR			HR	HOUR	R.I.	ROUGH IN
AL	ALUMINUM	DS	DOWNSPOUT	HT	HEIGHT	R.O.	ROUGH OPENING
ACT	ACOUSTICAL CEILING TILE	DTL	DETAIL	HVAC	HEATING, VENTILATING &		
ACP	ACOUSTICAL CEILING PANEL	DWG	DRAWING		AIR CONDITIONING	SAN	SANITARY SEWER
						SDS	SOAP DISPENSER
BL	BRICK LEDGE			ΙE	INVERT ELEVATION	SH	SHELF
BITUM	BITUMINOUS	EL	ELEVATION	INSUL	INSULATION	ST	STORM SEWER
BLDG	BUILDING	ELEC	ELECTRIC	I.C.	IN CONTRACT	STL	STEEL
BRG	BEARING	ELEV	ELEVATOR			STR	STRUCTURAL
		EQUIP	EQUIPMENT	LAV	LAVATORY	SS	STAINLESS STEEL
С	CONDUIT	EXIST	EXISTING	LL	LOWER LEVEL	SUSP	SUSPENDED
CAB	CABINET						
СВ	CATCH BASIN	FD	FLOOR DRAIN	MFG	MANUFACTURER	T/C	TOP OF CONCRETE
СН	COAT HOOK	FE	FIRE EXTINGUISHER	МН	MANHOLE	TDS	TOWEL DISPENSER
CI	CAST IRON	FEC	FIRE EXTINGUISHER	MO	MASONRY OPENING	TEL	TELEPHONE
CJ	CONTROL JOINT		CABINET W/ FE	MTD	MOUNTED	T/S	TOP OF STEEL
CKT	CIRCUIT	FIN	FINISHED	MTG	MOUNTING	TLT	TOILET
CPT	CARPET LINE	FLR	FLOOR			TYP	TYPICAL
C/L	CENTER LINE	FNDTN	FOUNDATION	N.I.C.	NOT IN CONTRACT	• • •	
CLG	CEILING	FUT	FUTURE			UL	UNDERWRITER'S LABOR
CL.	CLOSET			O.C.	ON CENTER	UNO	UNLESS NOTED OTHERV
CMU	CONCRETE MASONRY UNIT	GA	GAUGE	O.D.	OUTSIDE DIAMETER		C. LECO NOTED OTTEN
COL	COLUMN	GALV	GALVANIZED	0.5.	55.515E 517 WILLER	V.I.F.	VERIFY IN FIELD
CONC	CONCRETE	GB	GRAB BAR	PL	POLE	V	
CONN	CONNECTION	GYP BRD		PNT	PAINT	W/	WITH
CONTR	CONTRACTOR	GWB	GYPSUM WALL BOARD	PTD	PAINTED	WC	WATER CLOSET
30	33	3	5 55 W.LE 25/11/2			WM	WATER MAIN
						WWF	WELDED WIRE FABRIC
						*****	THE PLD WINE INDINO

GENERAL LOCATION MAP




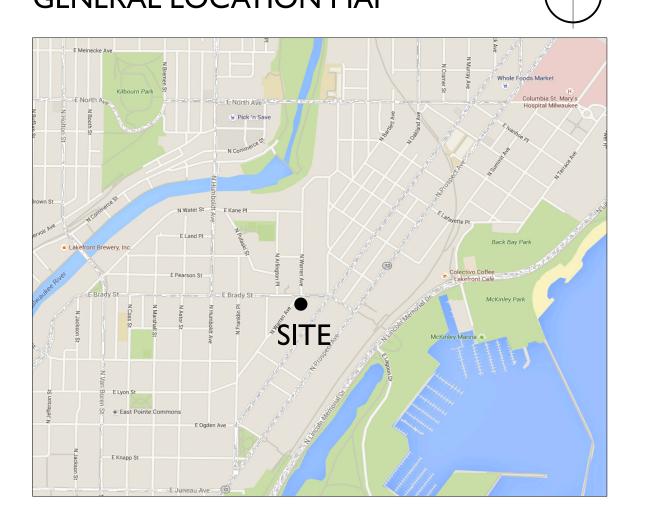

SITE MAP

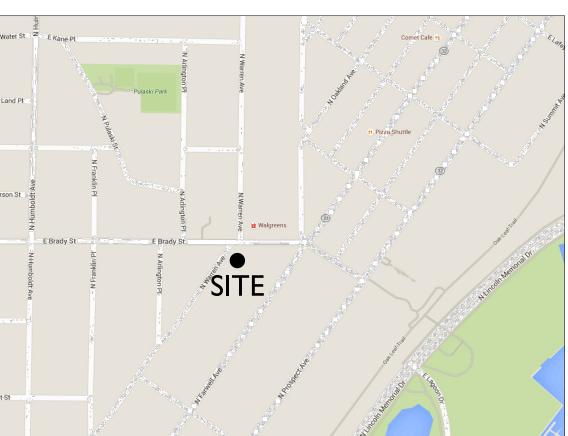




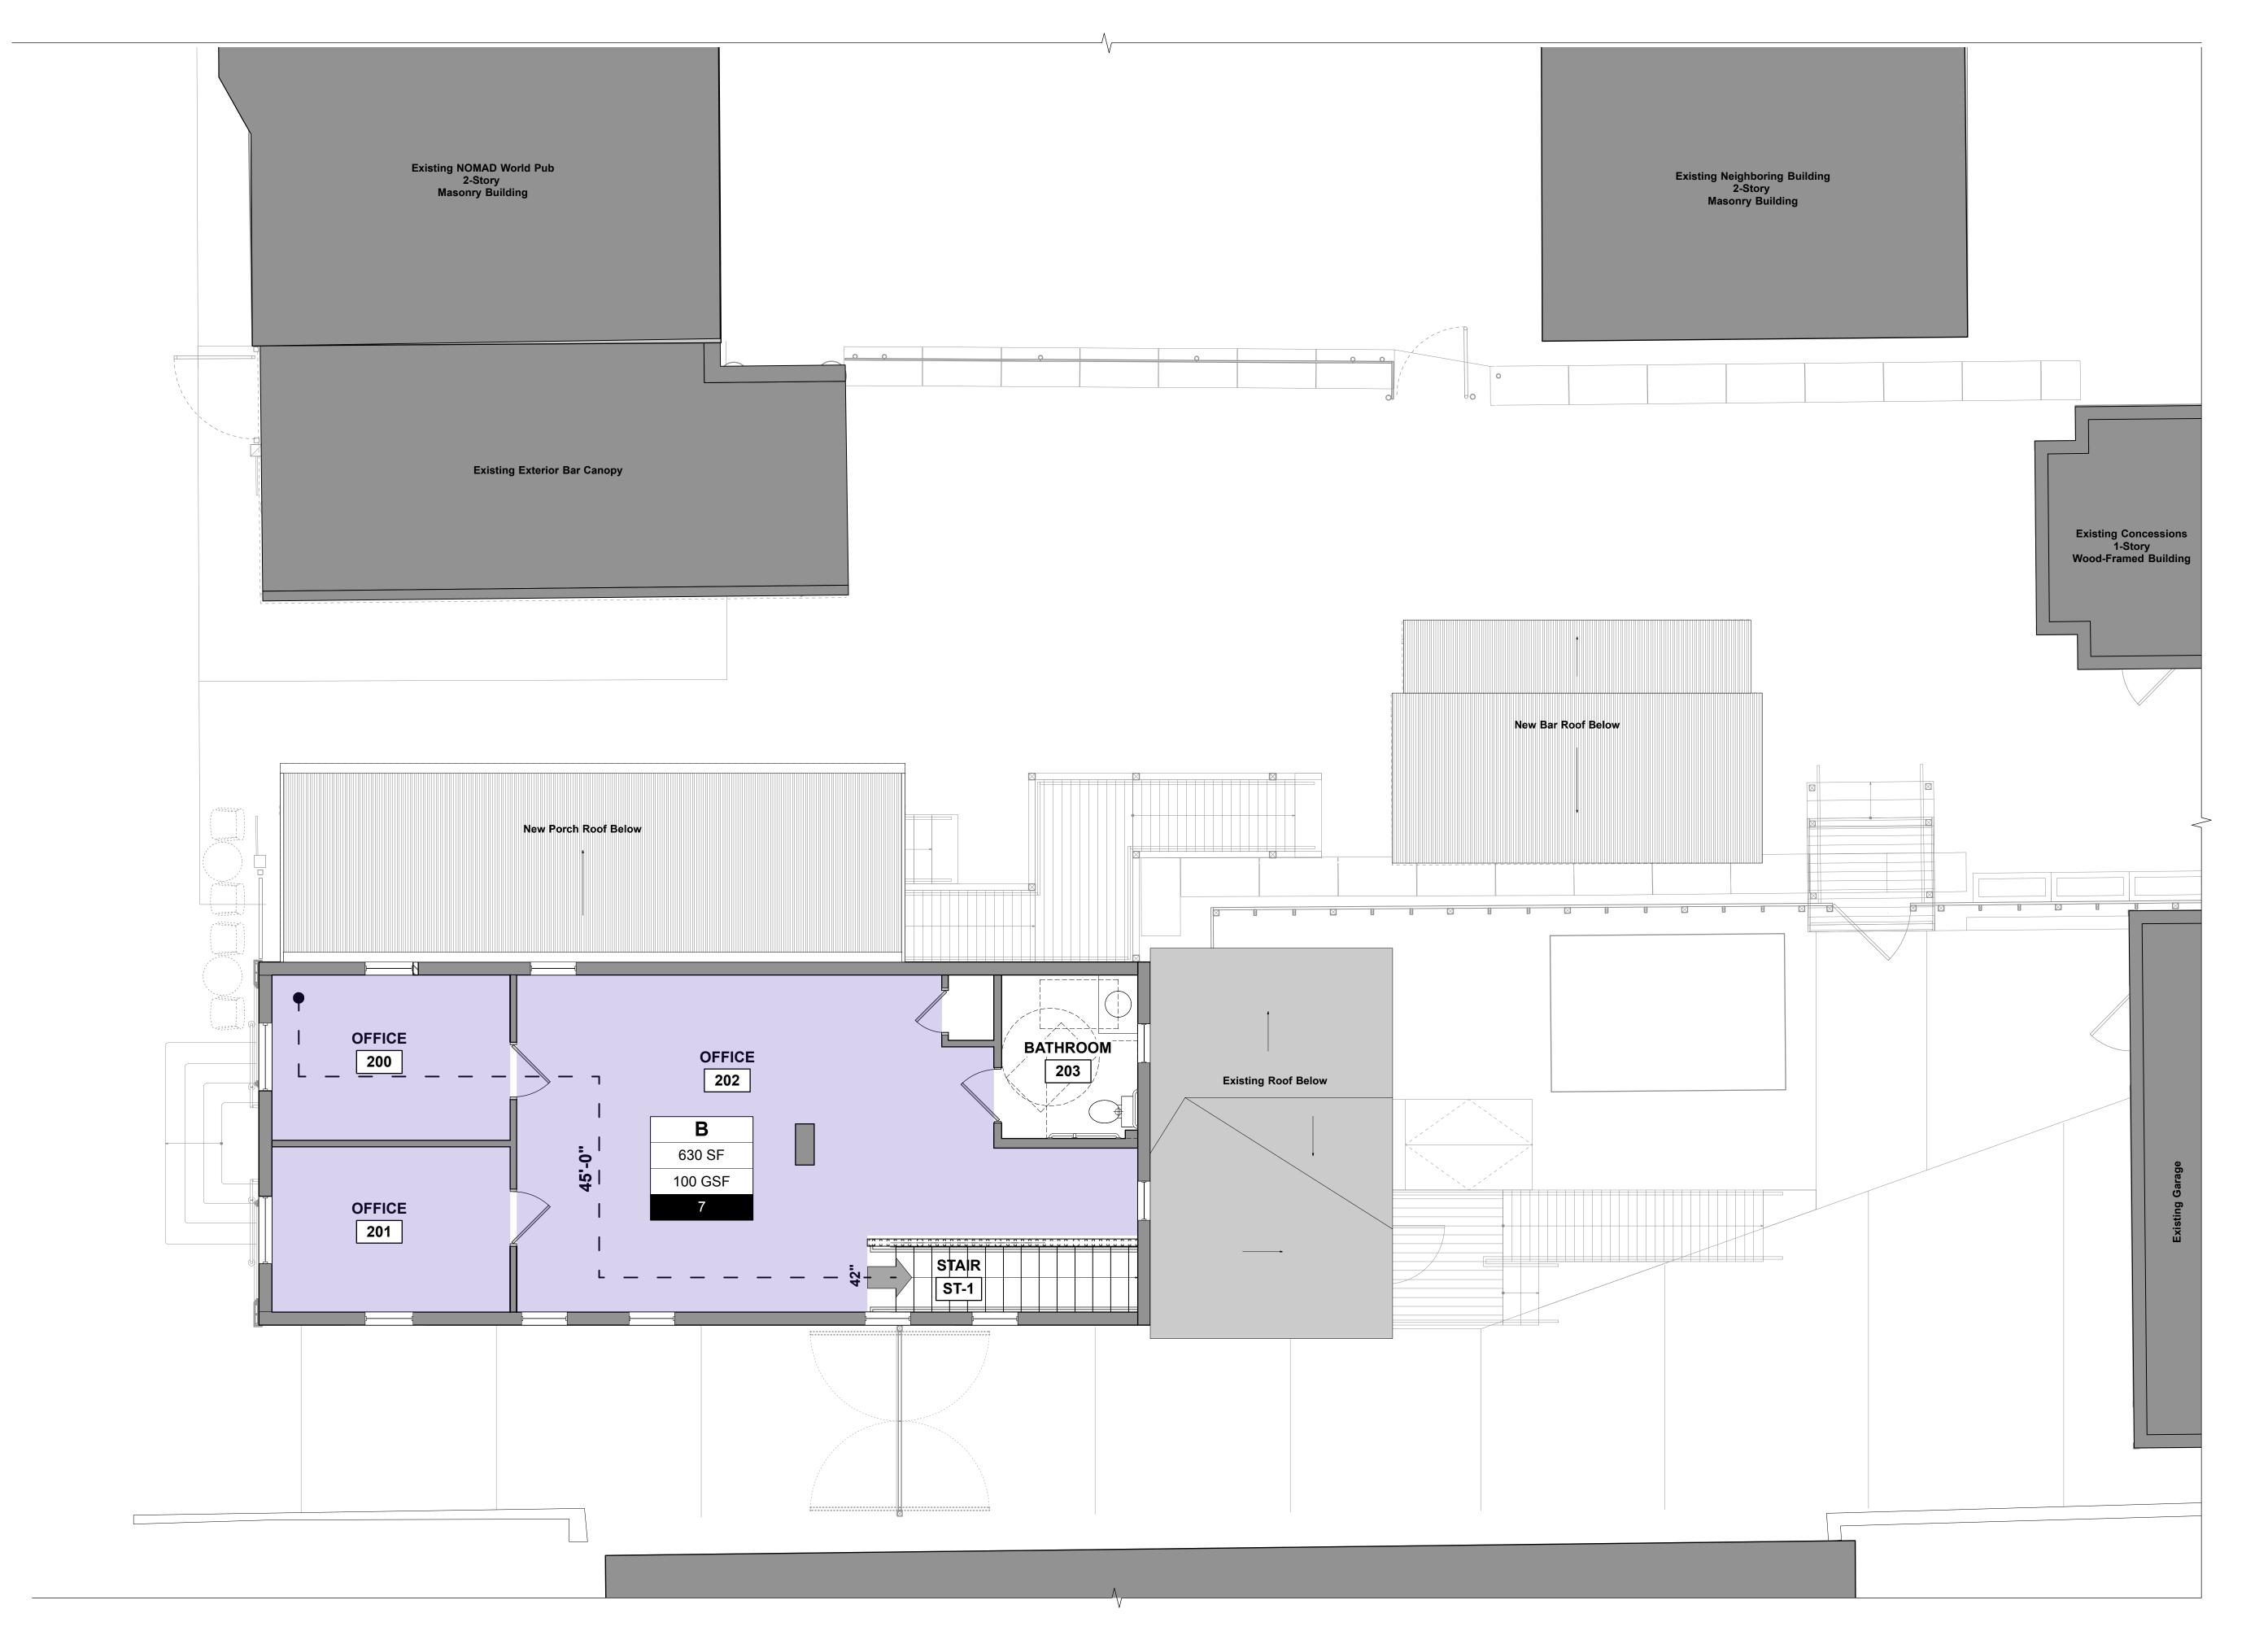

GENERAL NOTE: NO WORK ON SECOND FLOOR - EXISTING CONDITIONS TO REMAIN





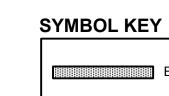

EXISTING CONSTRUCTION PROPOSED CONSTRUCTION

The Kubala Washatko Architects, Inc. W61 N617 Mequon Avenue Cedarburg, WI 53012 p: 262.377.6039 | f: 262.377.2954

PROJECT

Nomad - Cafe

Addition & Remodel

1668 N Warren Ave. Milwaukee, WI 53202

OWNER NOMADIC VENTURES INC. 1401 E. Brady St. Milwaukee, WI 53202 p: 414.224.8111

STRUCTURAL ENGINEER

SPIRE ENGINEERING, INC 305 N. Plankinton Ave., Suite 101 Milwaukee, WI 53203 p: 414.278.9200

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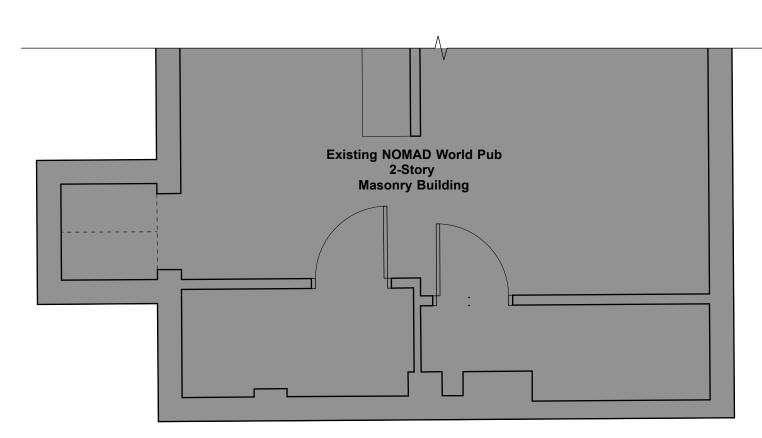
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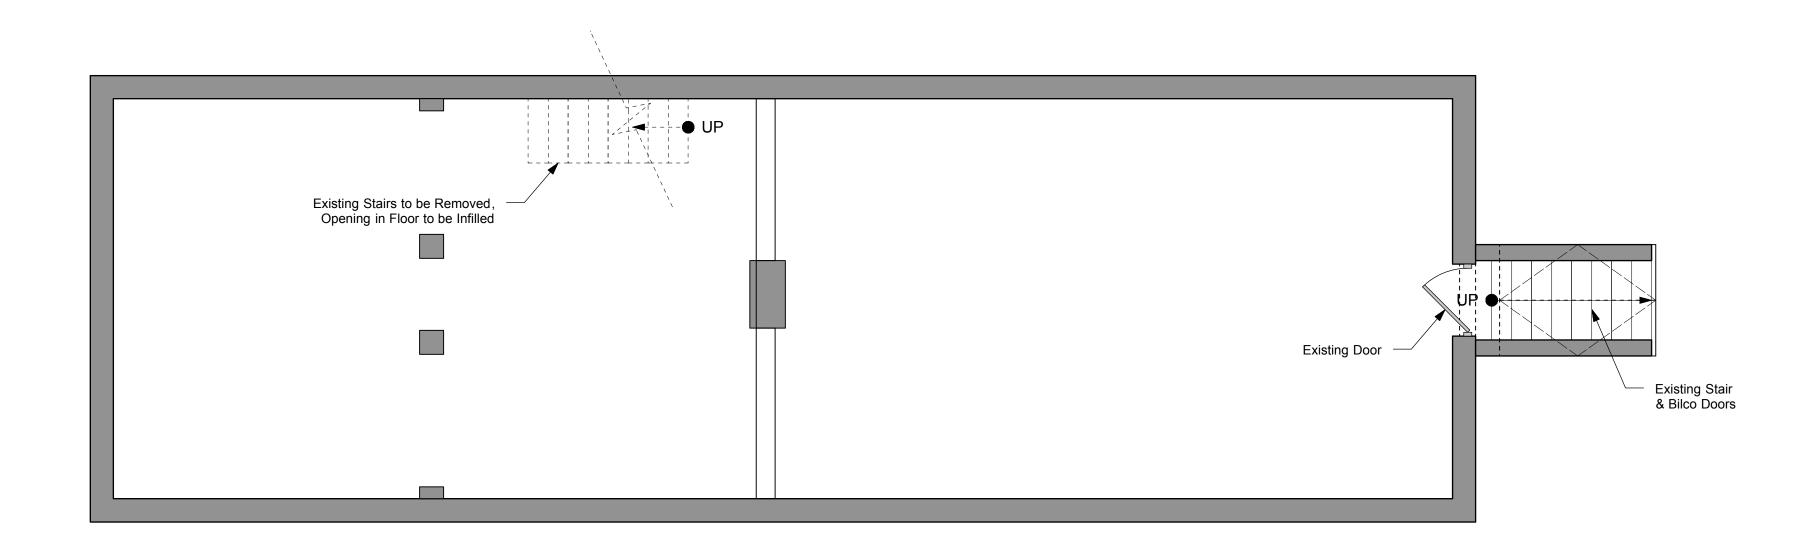
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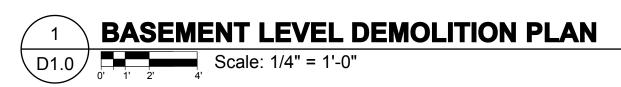
219617.01

SHEET TITLE

Code Plans










GENERAL DEMO NOTES

1. ALL INFORMATION CONCERNING EXISTING CONDITIONS SHALL BE FIELD VERIFIED PRIOR TO CONSTRUCTION OR MATERIAL FABRICATION. NOTIFY ARCHITECT AND OWNER FOR POSSIBLE REMEDIAL ACTION IF ACTUAL CONDITIONS DIFFER FROM THOSE SHOWN HERE.

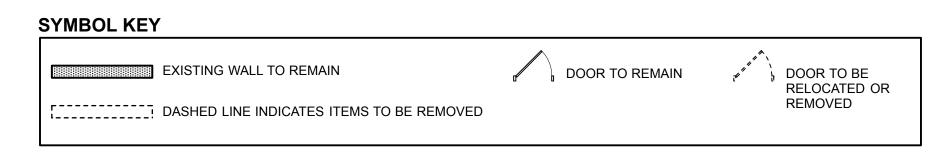



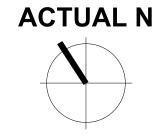

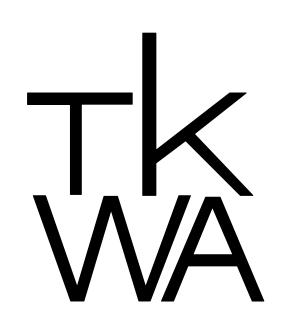

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PROJECT

Nomad - Cafe

Addition & Remodel

1668 N Warren Ave. Milwaukee, WI 53202

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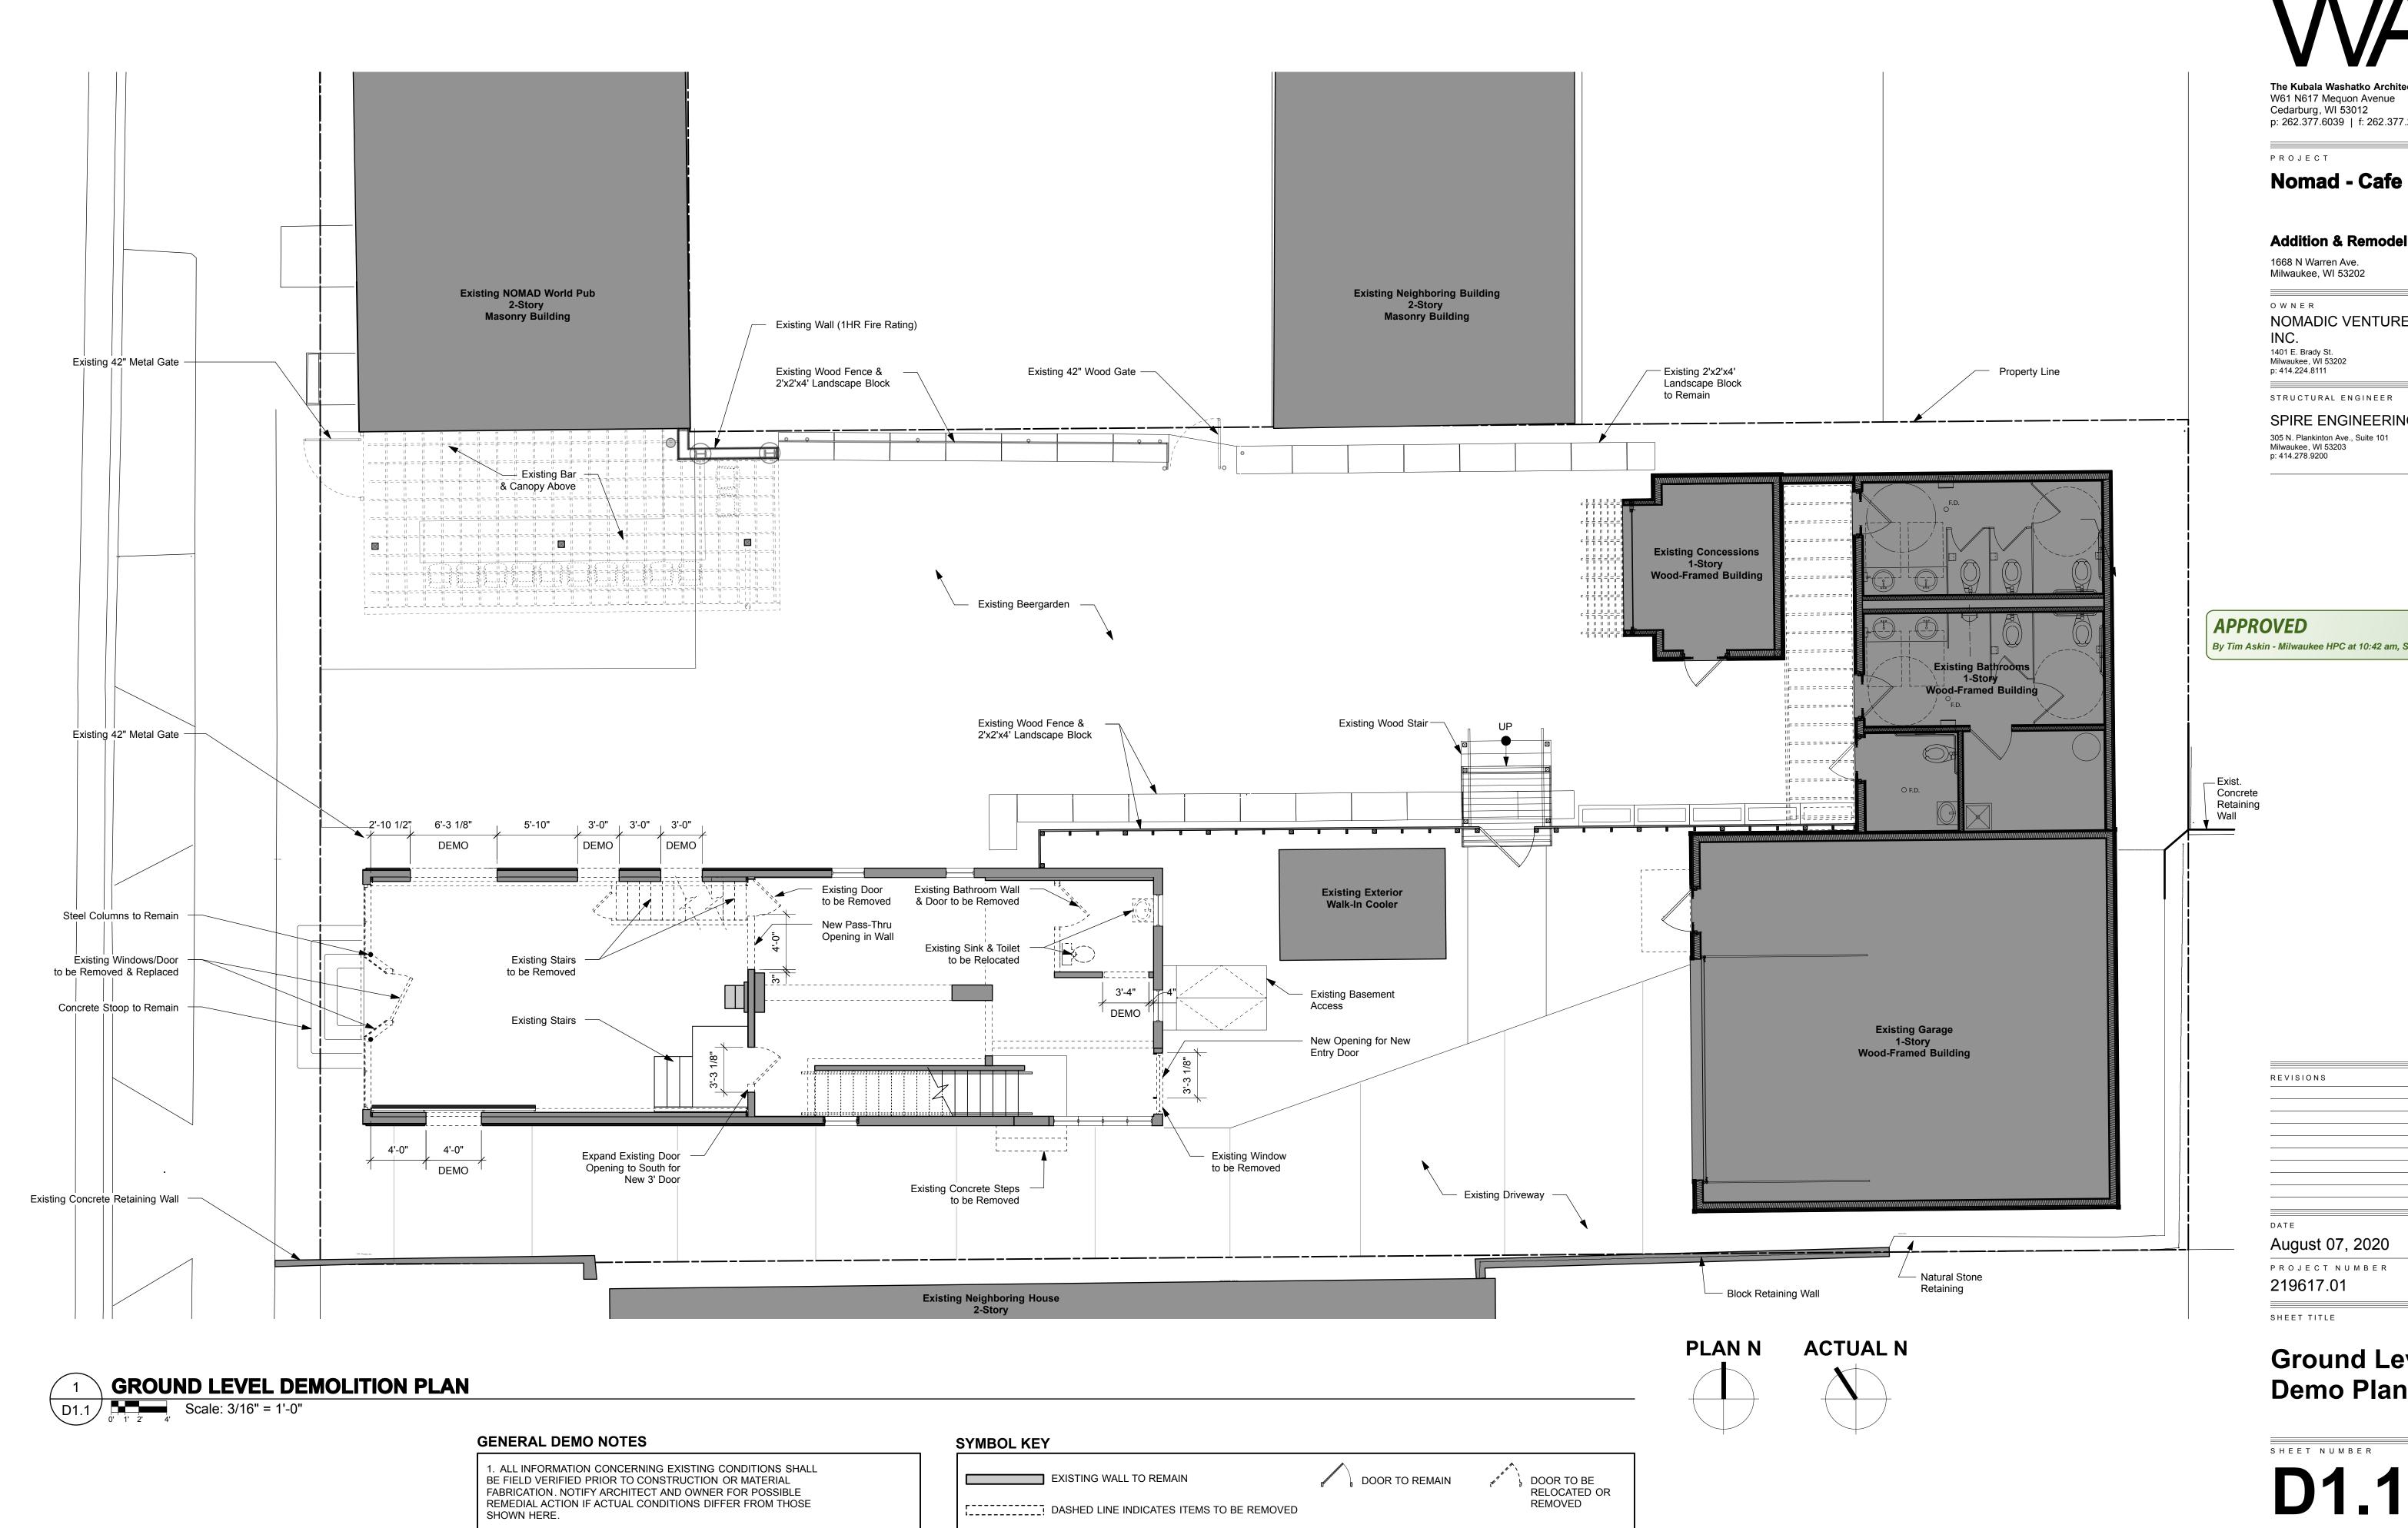
SHEET TITLE

Basement Level Demo Plan

SHEET NUMBER

D100

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Addition & Remodel

1668 N Warren Ave.

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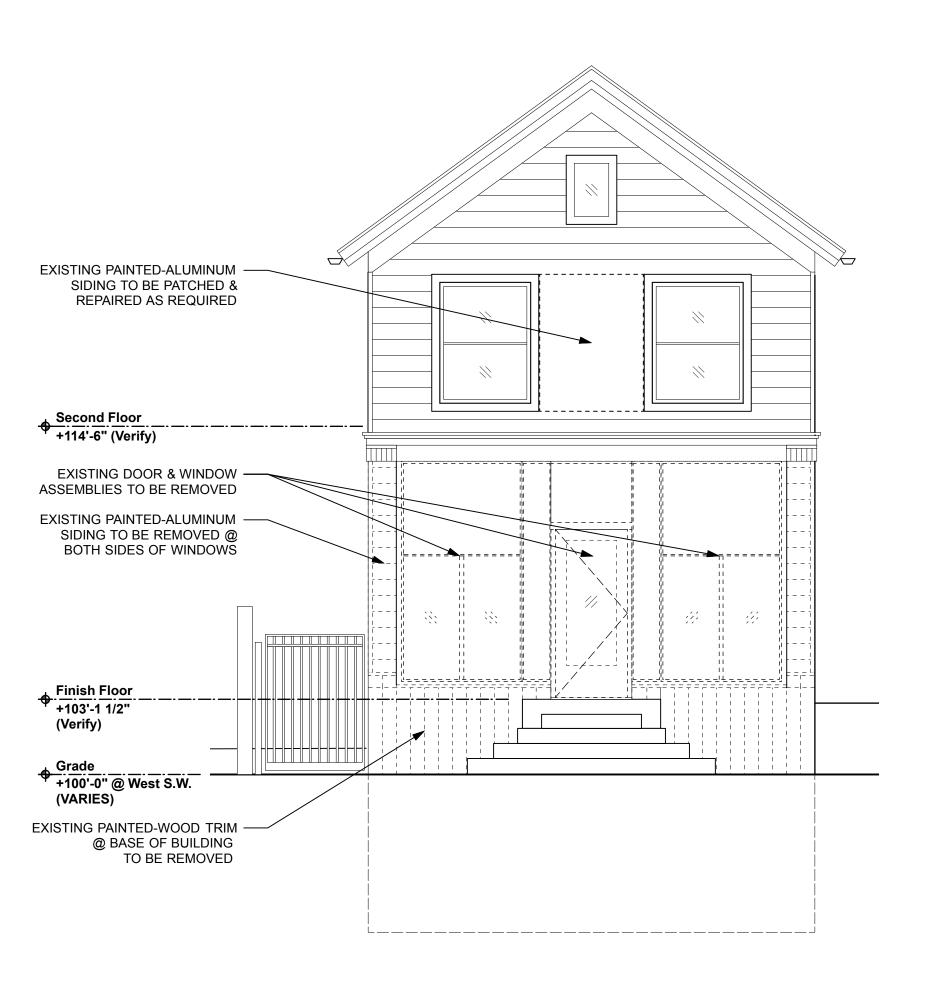
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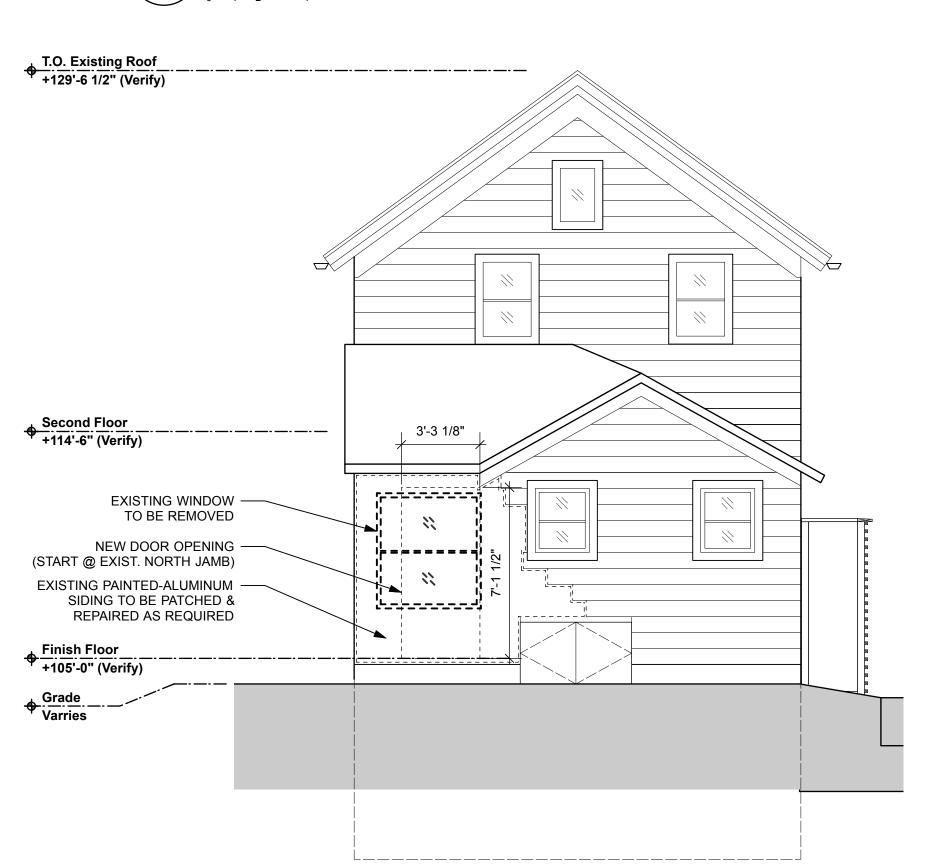
Ground Level Demo Plan

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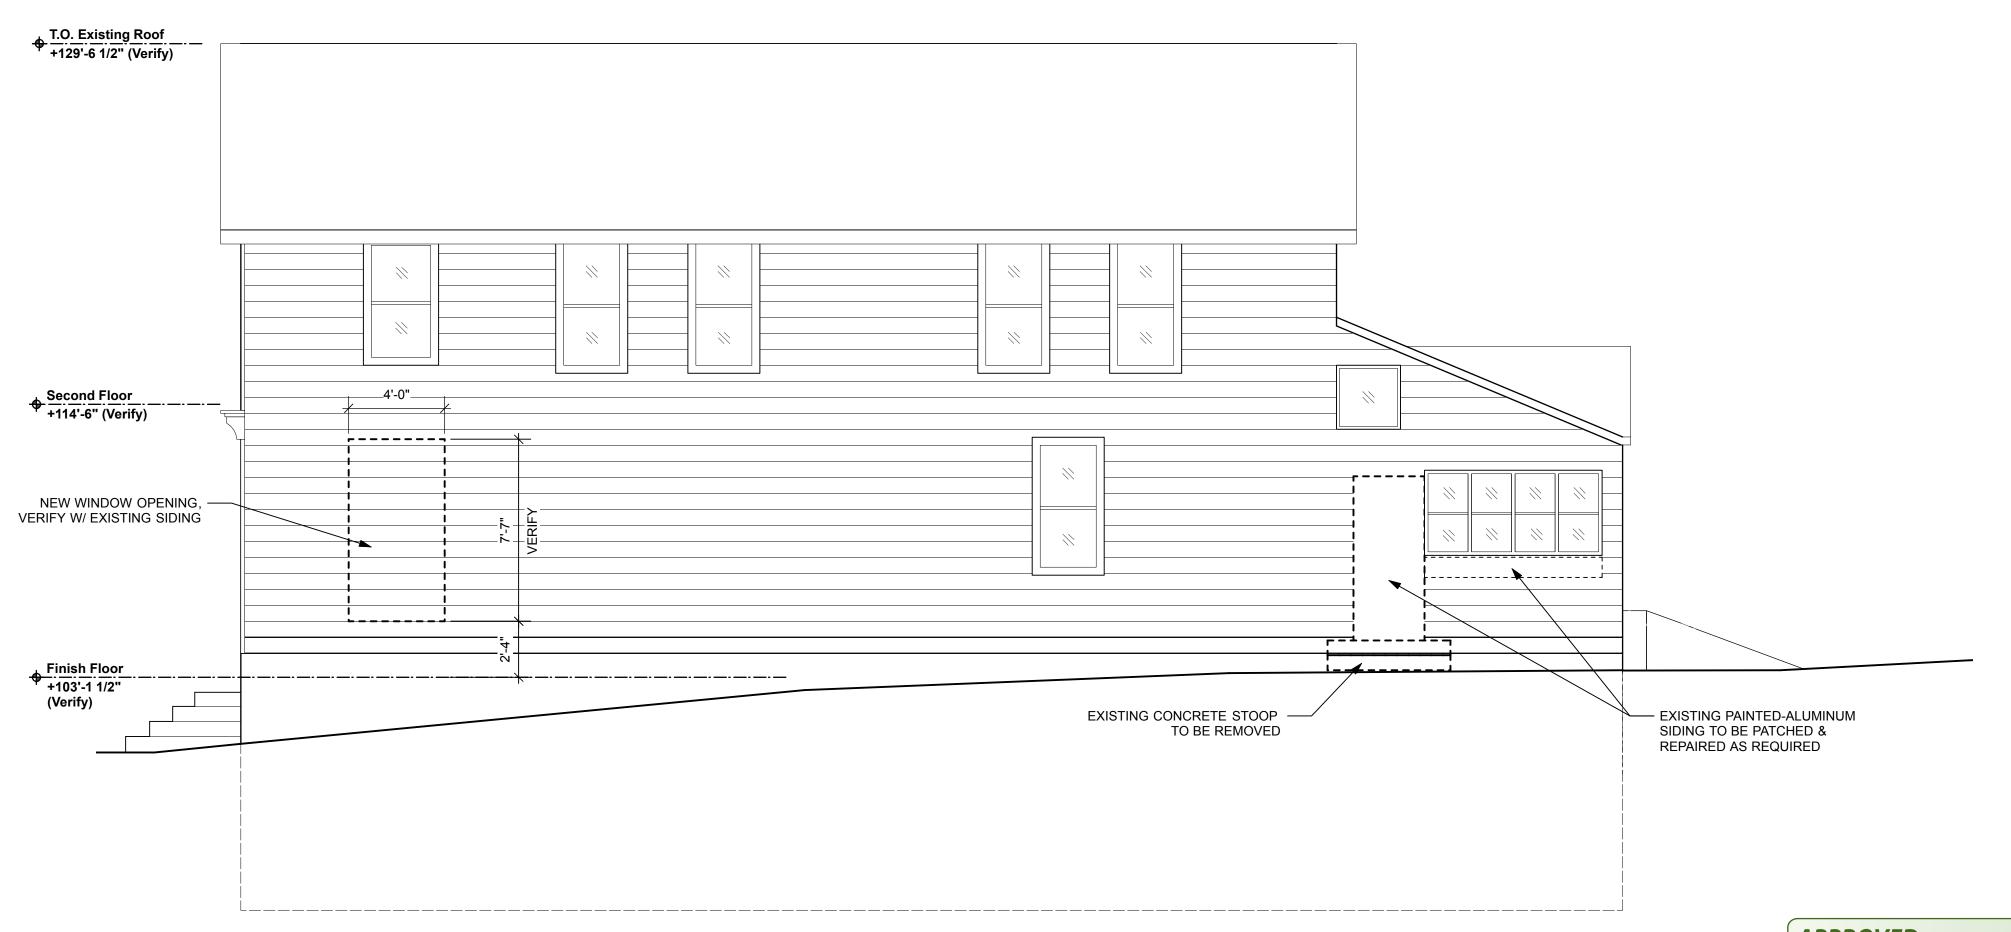


BUILDING DEMO ELEVATION - WEST

O3.0 Scale: 1/4" = 1'-0"



2 BUILDING DEMO ELEVATION - EAST
D3.0 Scale: 1/4" = 1'-0"



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PROJECT

Nomad - Cafe

Addition & Remodel

1668 N Warren Ave.

Milwaukee, WI 53202

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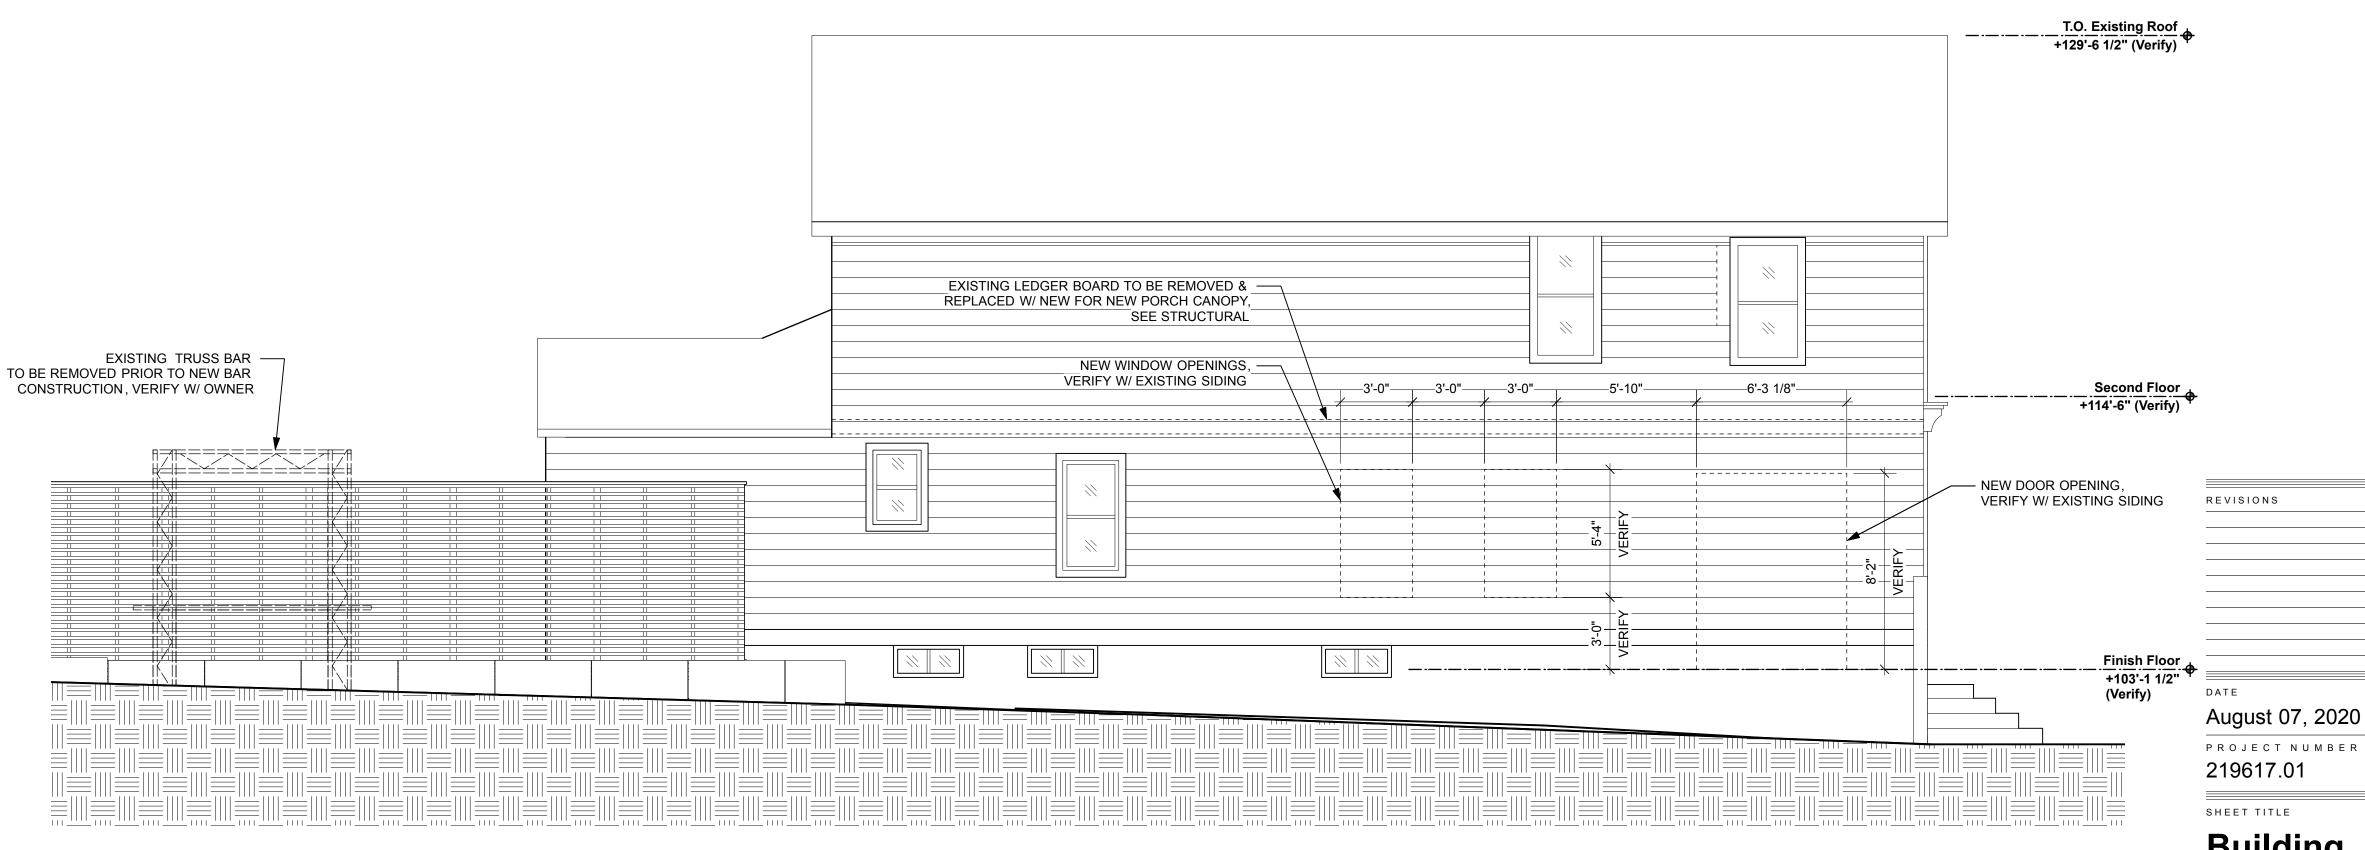
p: 414.278.9200

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BUILDING DEMO ELEVATION - SOUTH

D3.0 Scale: 1/4" = 1'-0"



GENERAL DEMO NOTES

1 BUILDING DEMO ELEVATION - NORTH
D3.0 Scale: 1/4" = 1'-0"


1. ALL INFORMATION CONCERNING EXISTING CONDITIONS SHALL BE FIELD VERIFIED PRIOR TO CONSTRUCTION OR MATERIAL FABRICATION. NOTIFY ARCHITECT AND OWNER FOR POSSIBLE REMEDIAL ACTION IF ACTUAL CONDITIONS DIFFER FROM THOSE SHOWN HERE.

SYMBOL KEY

EXISTING ITEMS TO REMAIN

DASHED LINE INDICATES ITEMS TO BE REMOVED

Building Demo Elevations

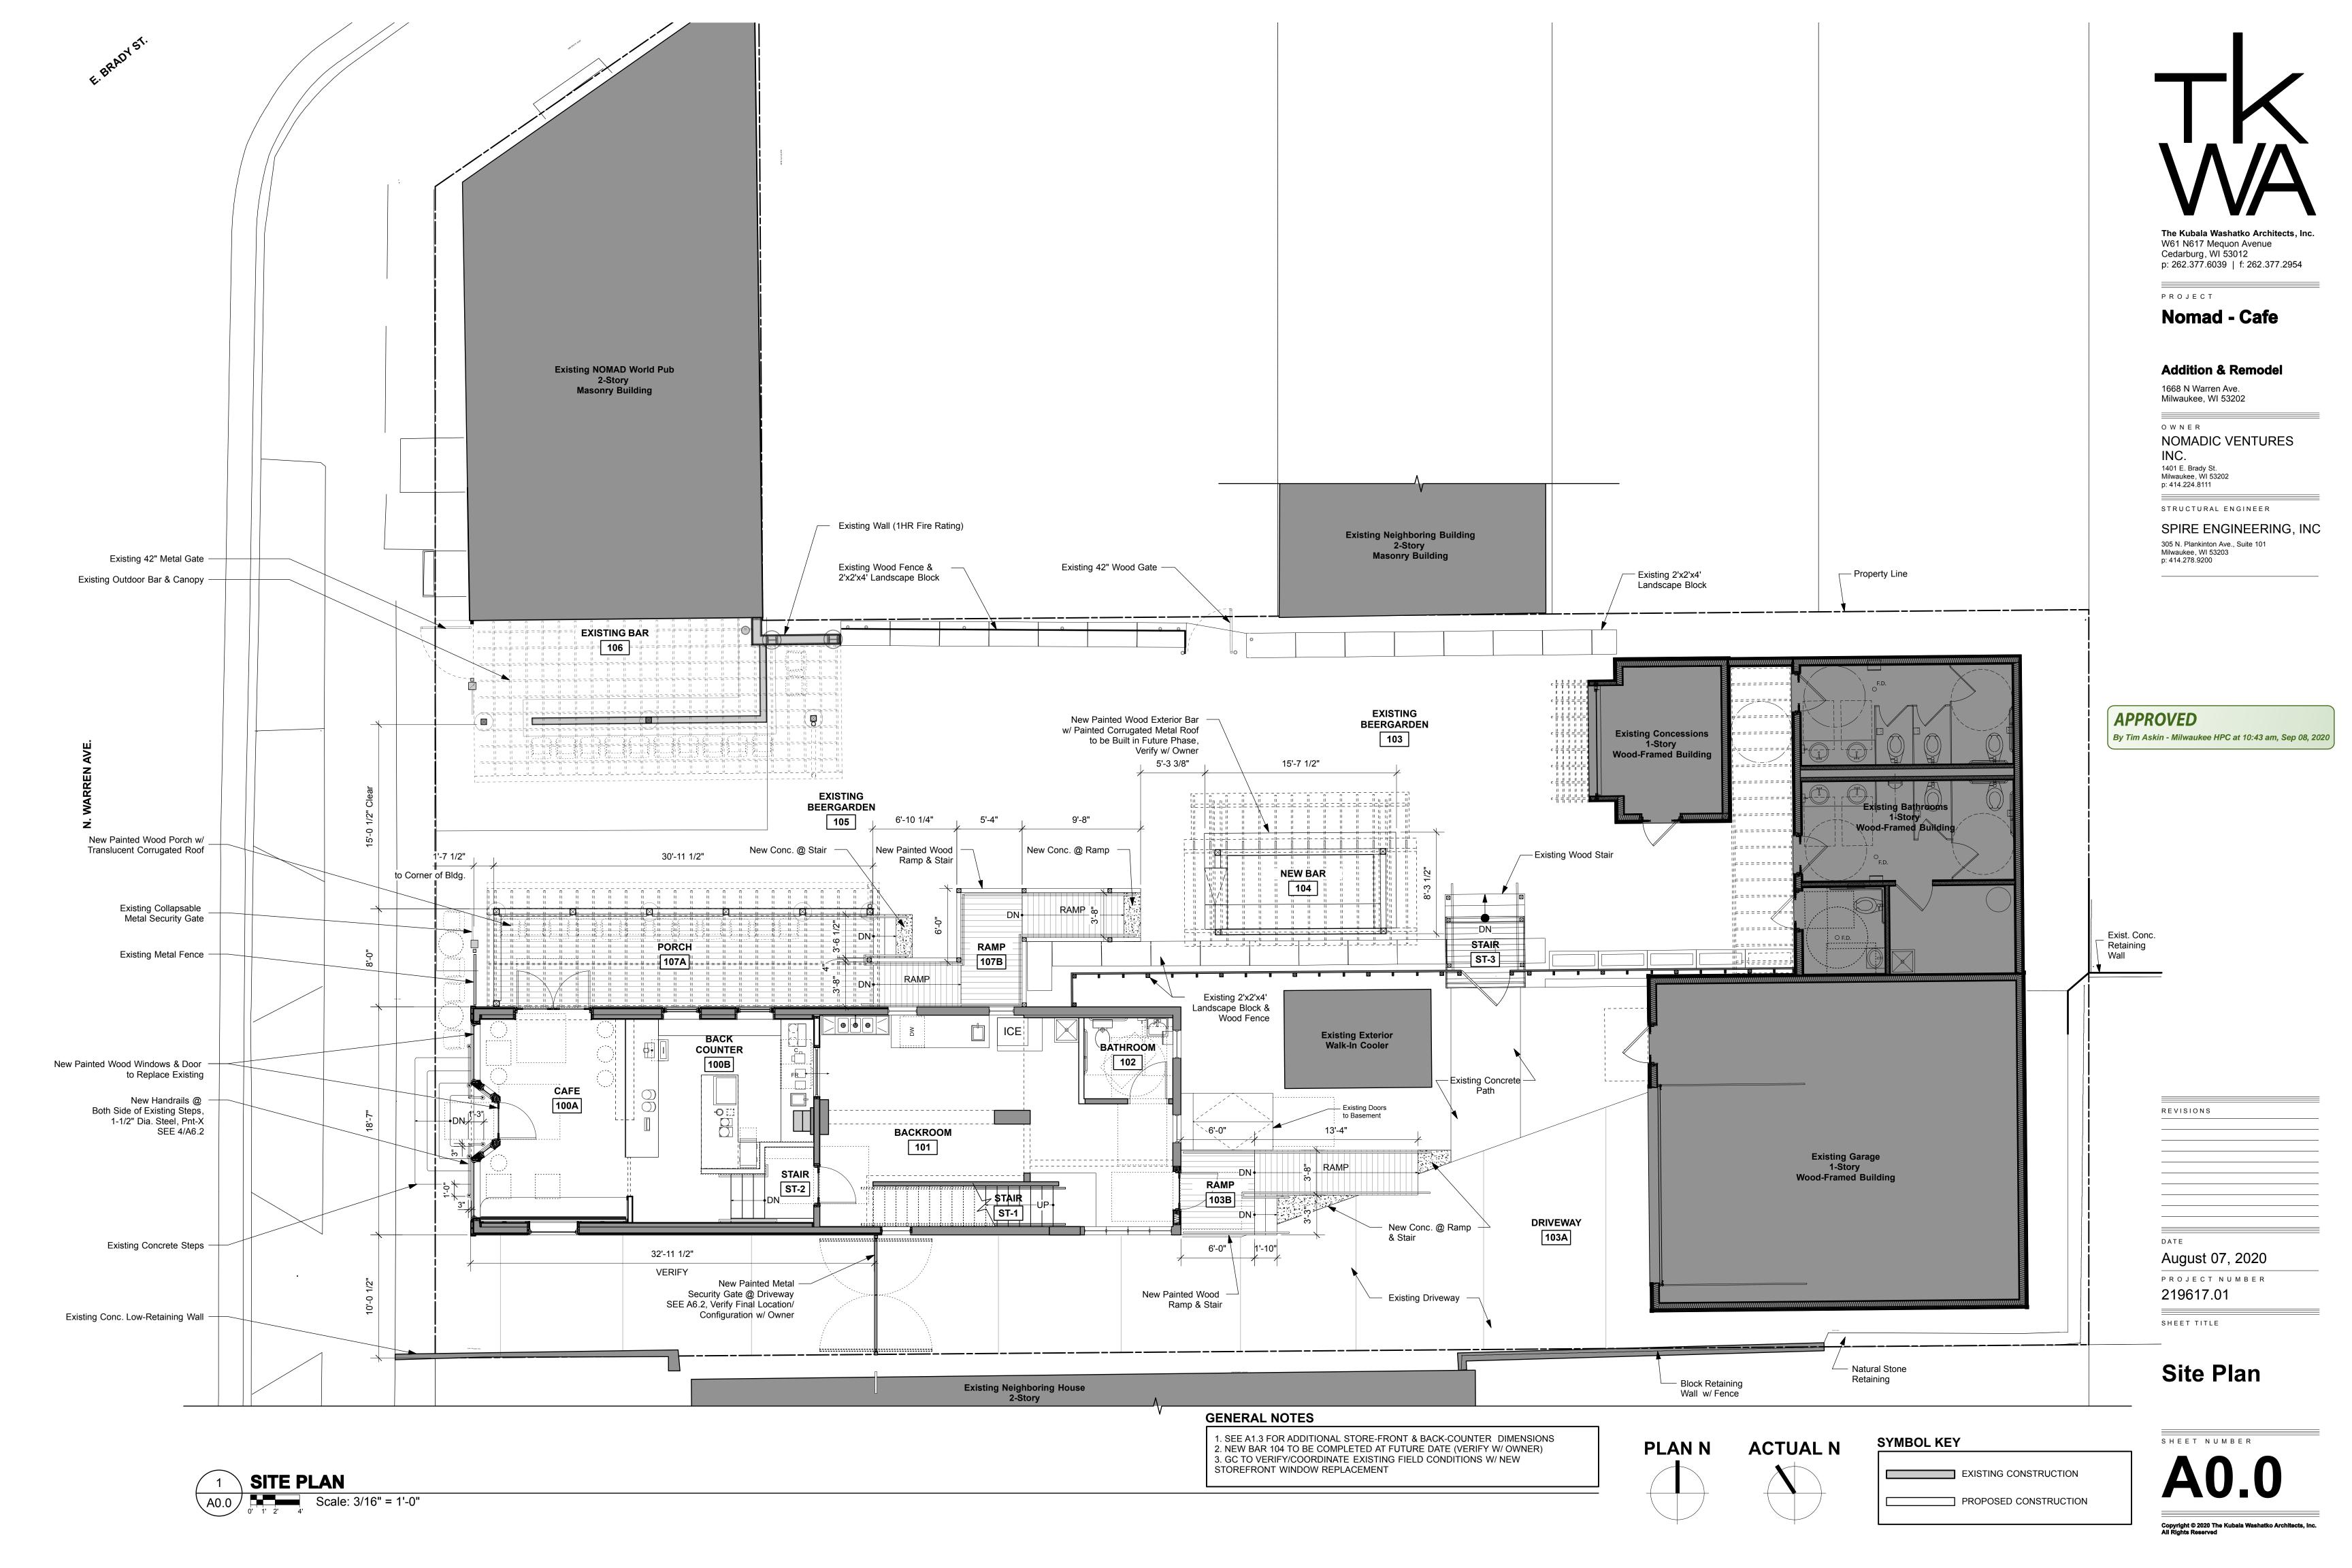


PLAN N



SYMBOL KEY EXISTING CONSTRUCTION PROPOSED CONSTRUCTION


Site & Erosion **Control Plan**

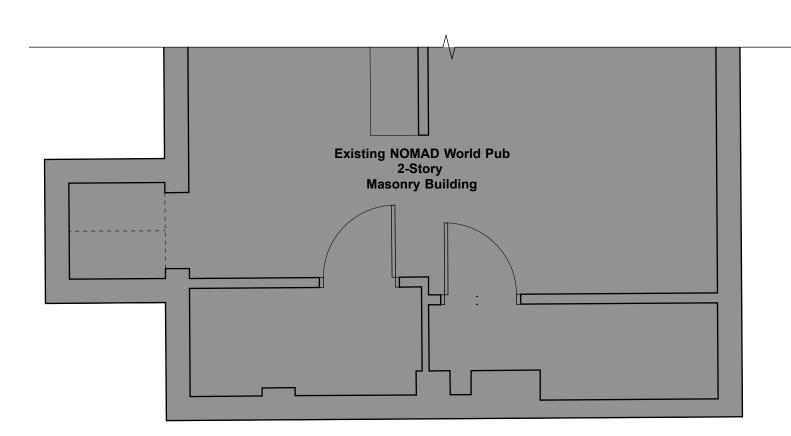

12

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OPENING FOR EXISTING BASEMENT STAIRS —— TO BE INFILLED W/ NEW JOISTS & FLOORING, SEE STRUCTURAL EXISTING STAIR ST-B1 BASEMENT EXISTING WOOD FRAMING——
FOR CONCRETE STOOP B100 B101 EXISTING STAIR TO EXTERIOR TO REMAIN 10"X2" NOM. WD JOISTS,— 1'-6" O.C. TYP.

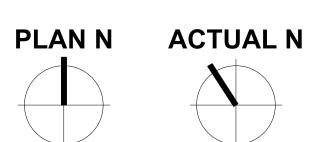

SYMBOL KEY

EXISTING CONSTRUCTION PROPOSED CONSTRUCTION

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PROJECT

Nomad - Cafe

Addition & Remodel

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OWNER NOMADIC VENTURES INC. 1401 E. Brady St. Milwaukee, WI 53202 p: 414.224.8111

STRUCTURAL ENGINEER


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August 07, 2020 PROJECT NUMBER 219617.01

Basement Floor Plan

SHEET TITLE



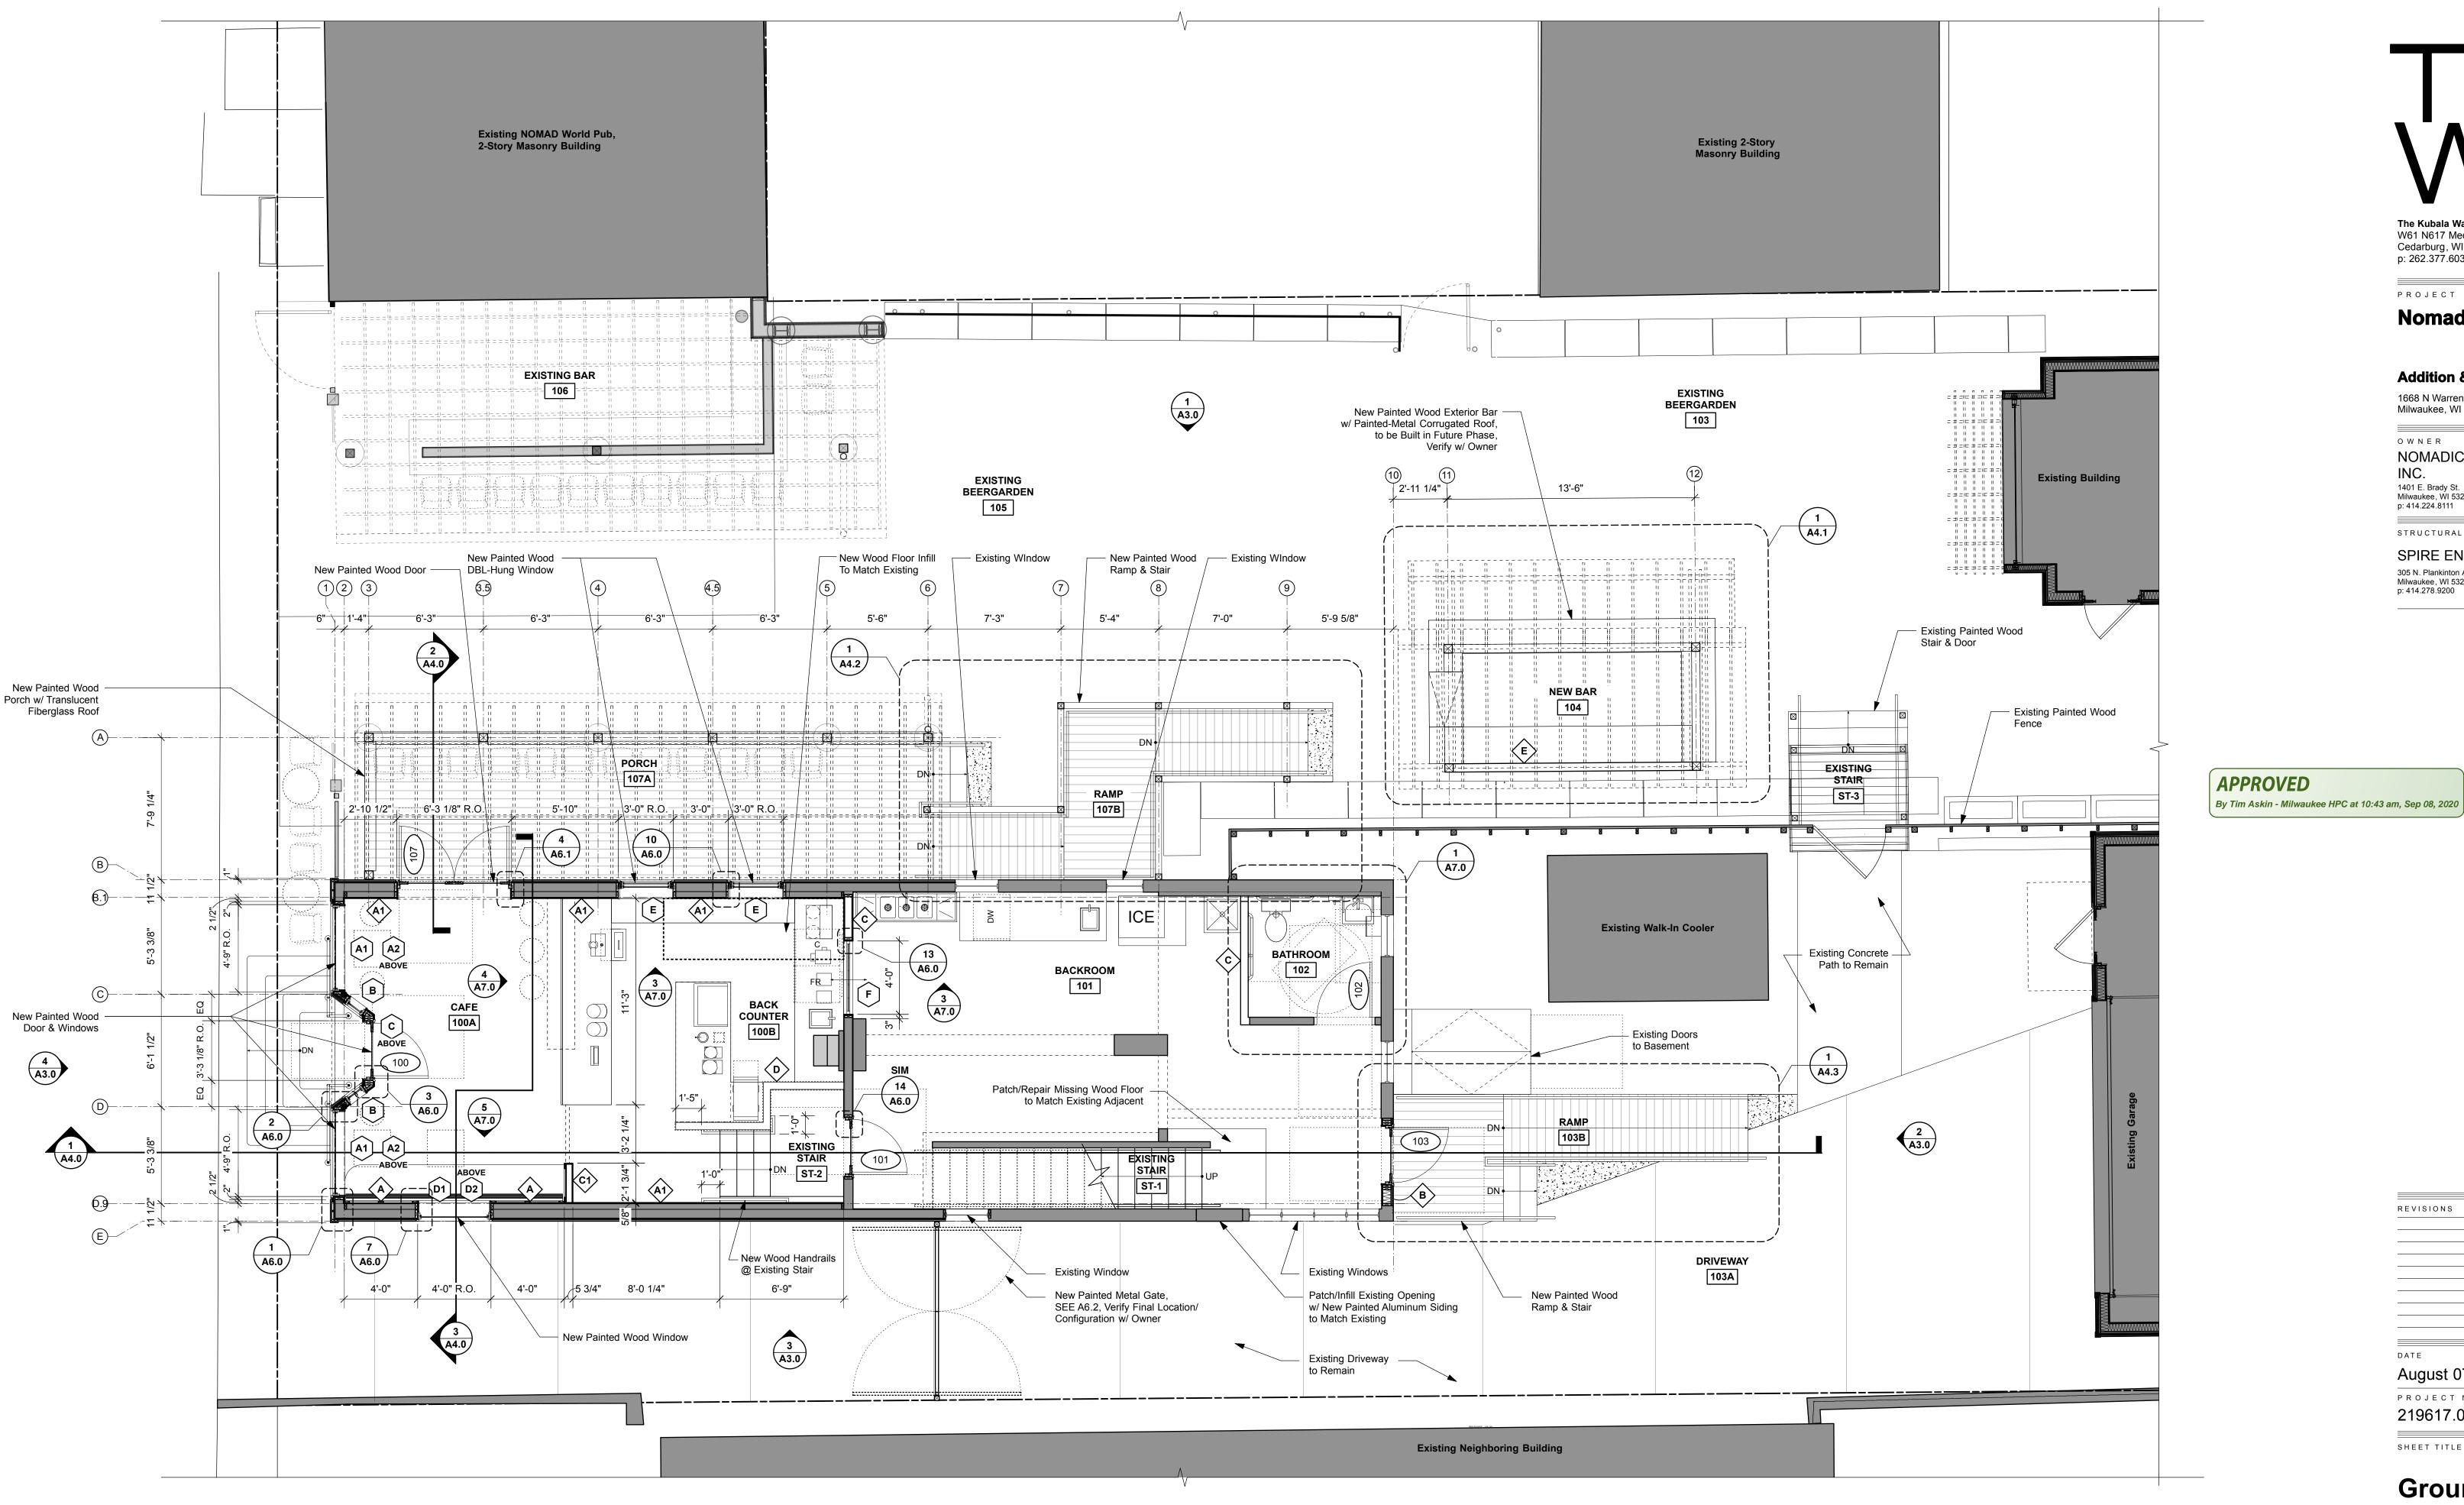

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REVISIONS

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SHEET TITLE

Ground Floor Plan

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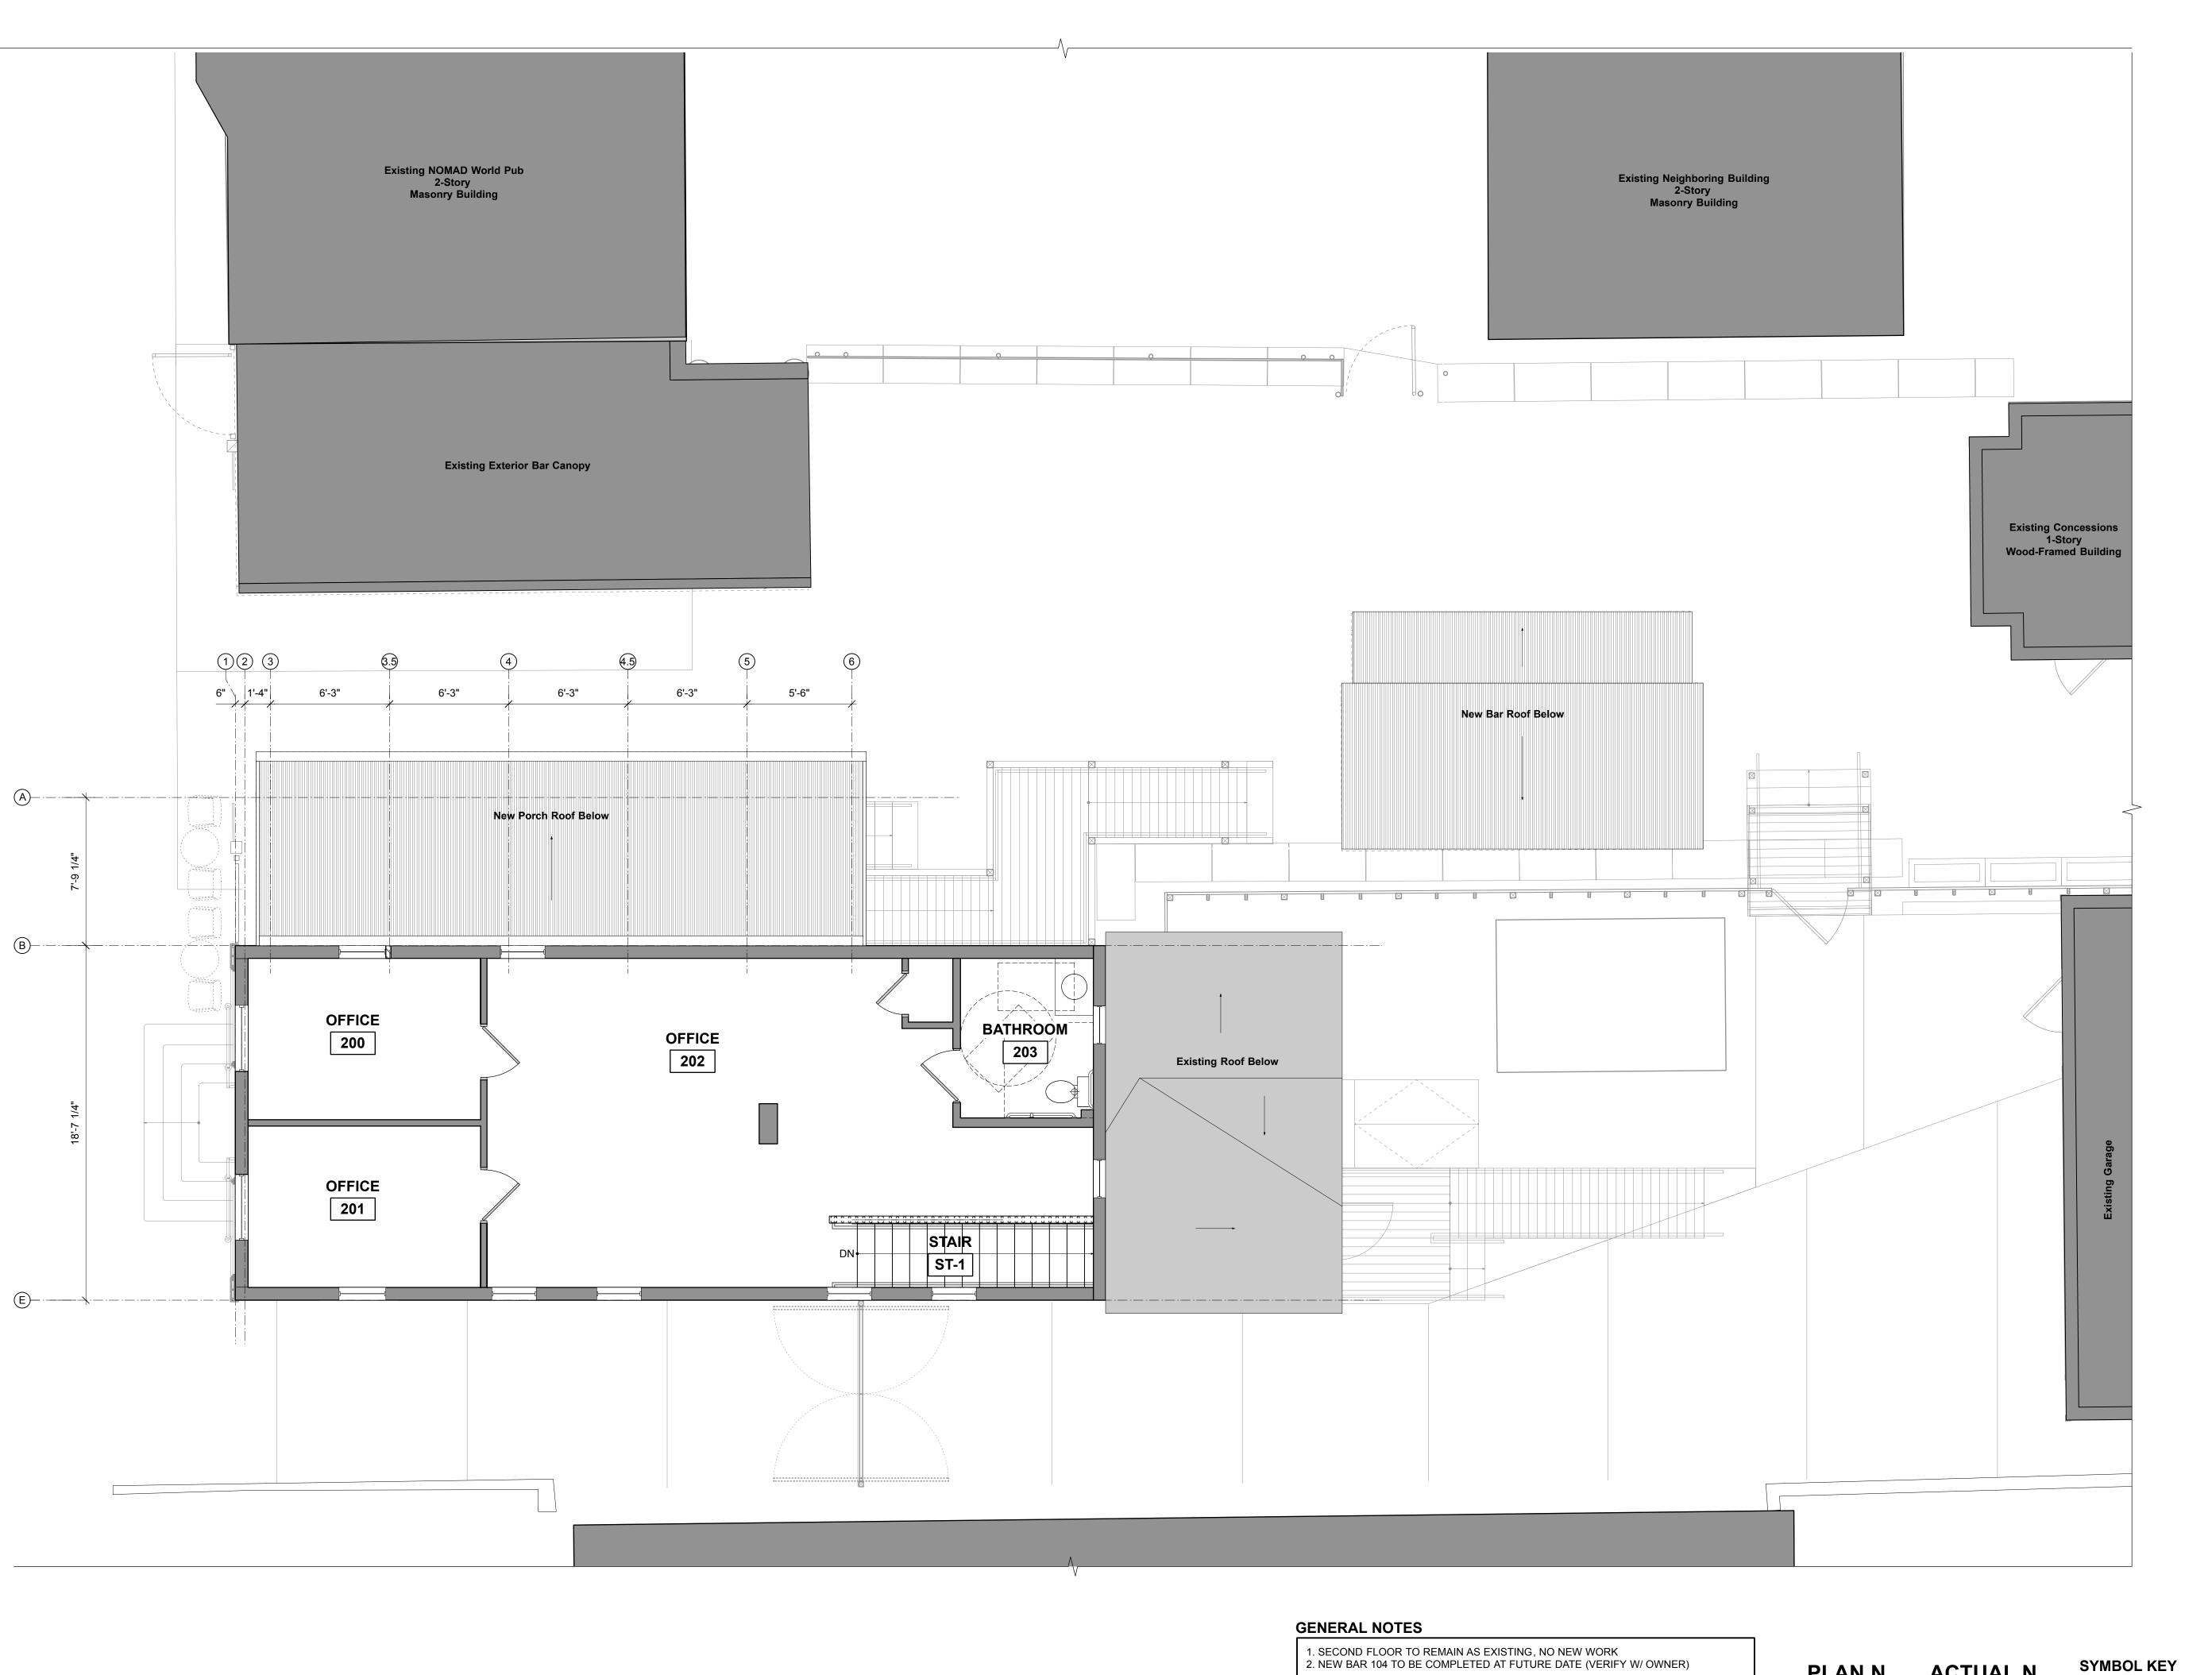
GENERAL NOTES

1. SEE A1.3 FOR ADDITIONAL STORE-FRONT & BACK-COUNTER DIMENSIONS 2. NEW BAR 104 TO BE COMPLETED AT FUTURE DATE (VERIFY W/ OWNER) 3. GC TO VERIFY/COORDINATE EXISTING FIELD CONDITIONS W/ NEW STOREFRONT WINDOW REPLACEMENT



EXISTING CONSTRUCTION PROPOSED CONSTRUCTION

SYMBOL KEY



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PROJECT

Nomad - Cafe

Addition & Remodel

1668 N Warren Ave.

Milwaukee, WI 53202

OWNER

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SHEET TITLE

Second Floor


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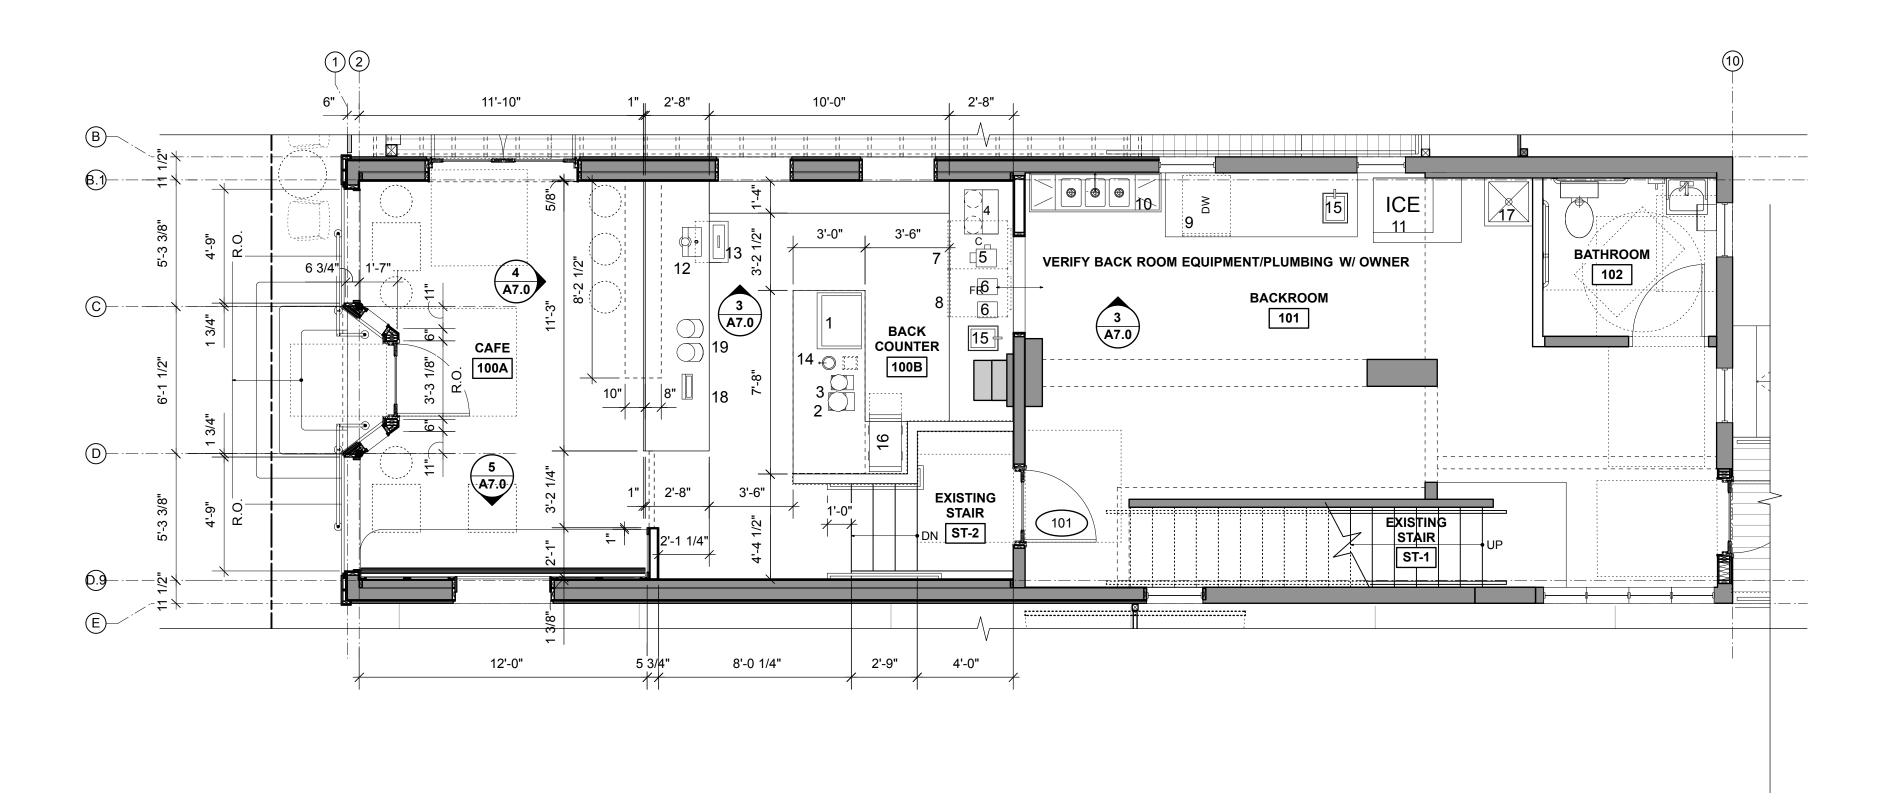
SHEET NUMBER

1 SECOND FLOOR PLAN
A1.2 Scale: 1/4" = 1'-0"

2. NEW BAR 104 TO BE COMPLETED AT FUTURE DATE (VERIFY W/ OWNER)







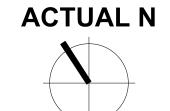

GENERAL NOTES


1. GC TO VERIFY/COORDINATE EXISTING FIELD CONDITIONS W/ NEW STOREFRONT WINDOW REPLACEMENT 2. EQUIPMENT SHOWN FOR REFERENCE ONLY, VERIFY FINAL EQUIPMENT LIST/LAYOUT W/ OWNER

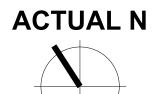


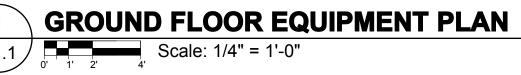


*VERIFY EQUIPMENT/PLUMBING W/ OWNER



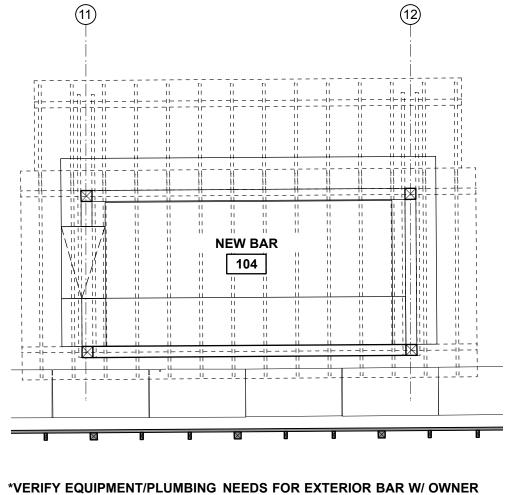

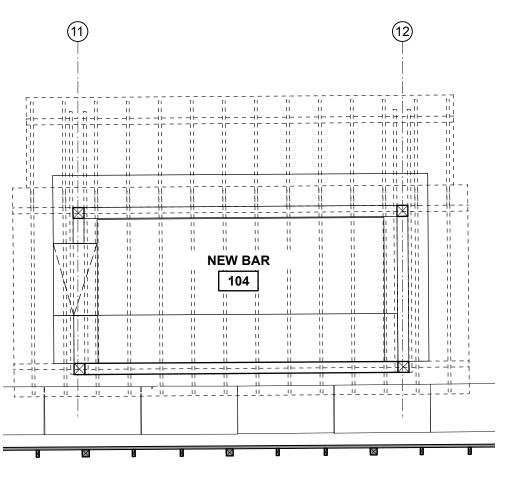

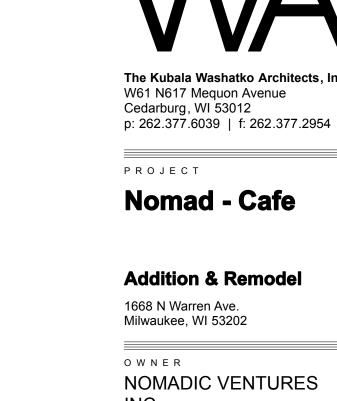


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NEW BAR EQUIPMENT PLAN Scale: 1/4" = 1'-0"




SYMBOL KEY							
	EXISTING CONSTRUCTION						
	PROPOSED CONSTRUCTION						

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Augi			

Equipment Plan & Schedule

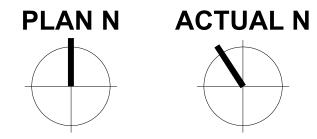SHEET NUMBER

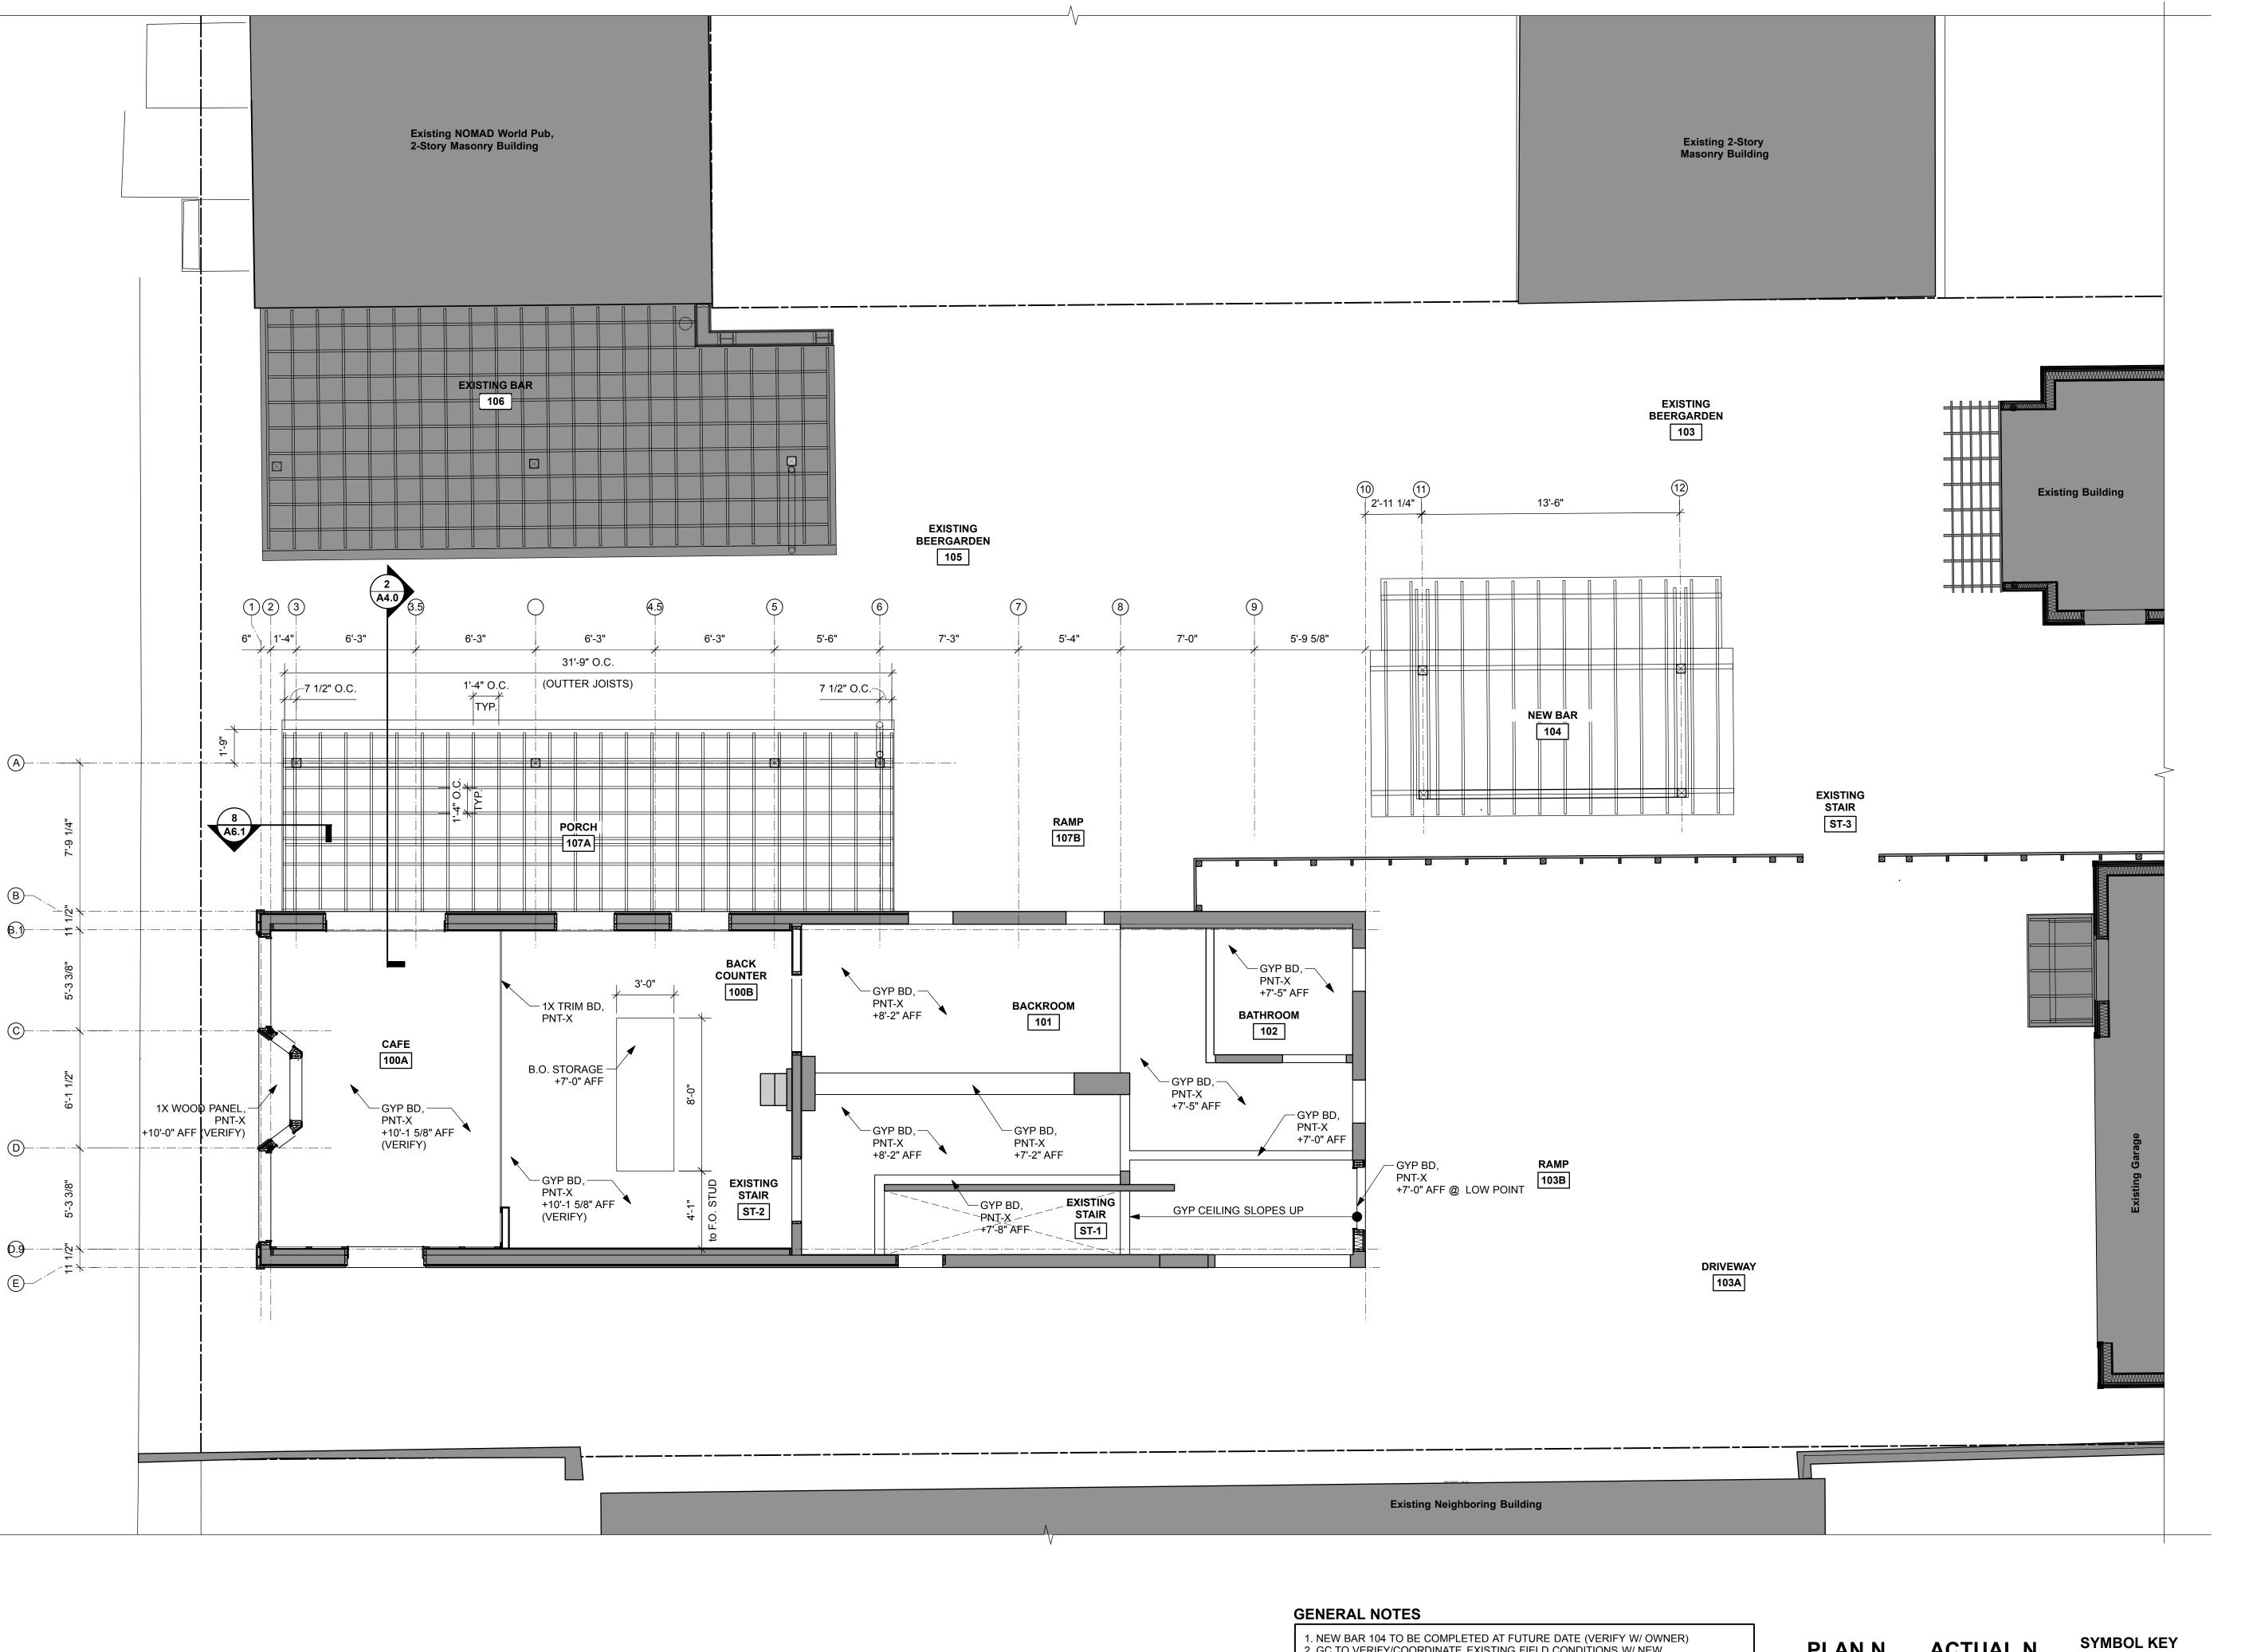

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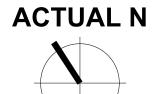
Ground Floor Reeflected **Ceiling Plan**


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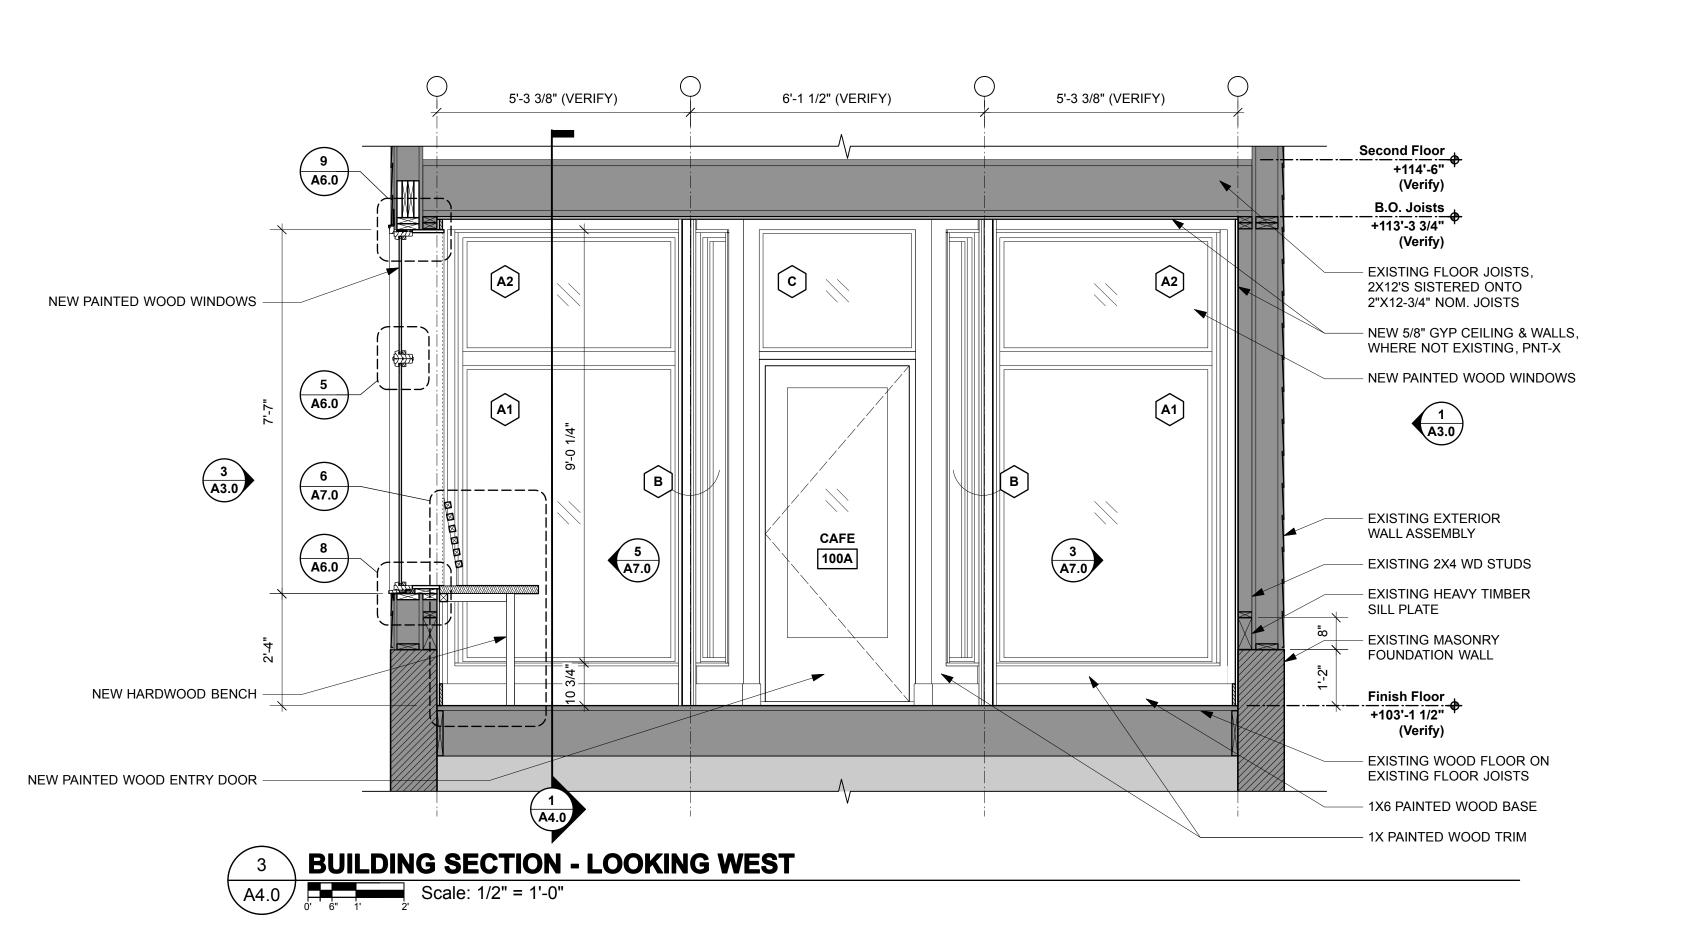
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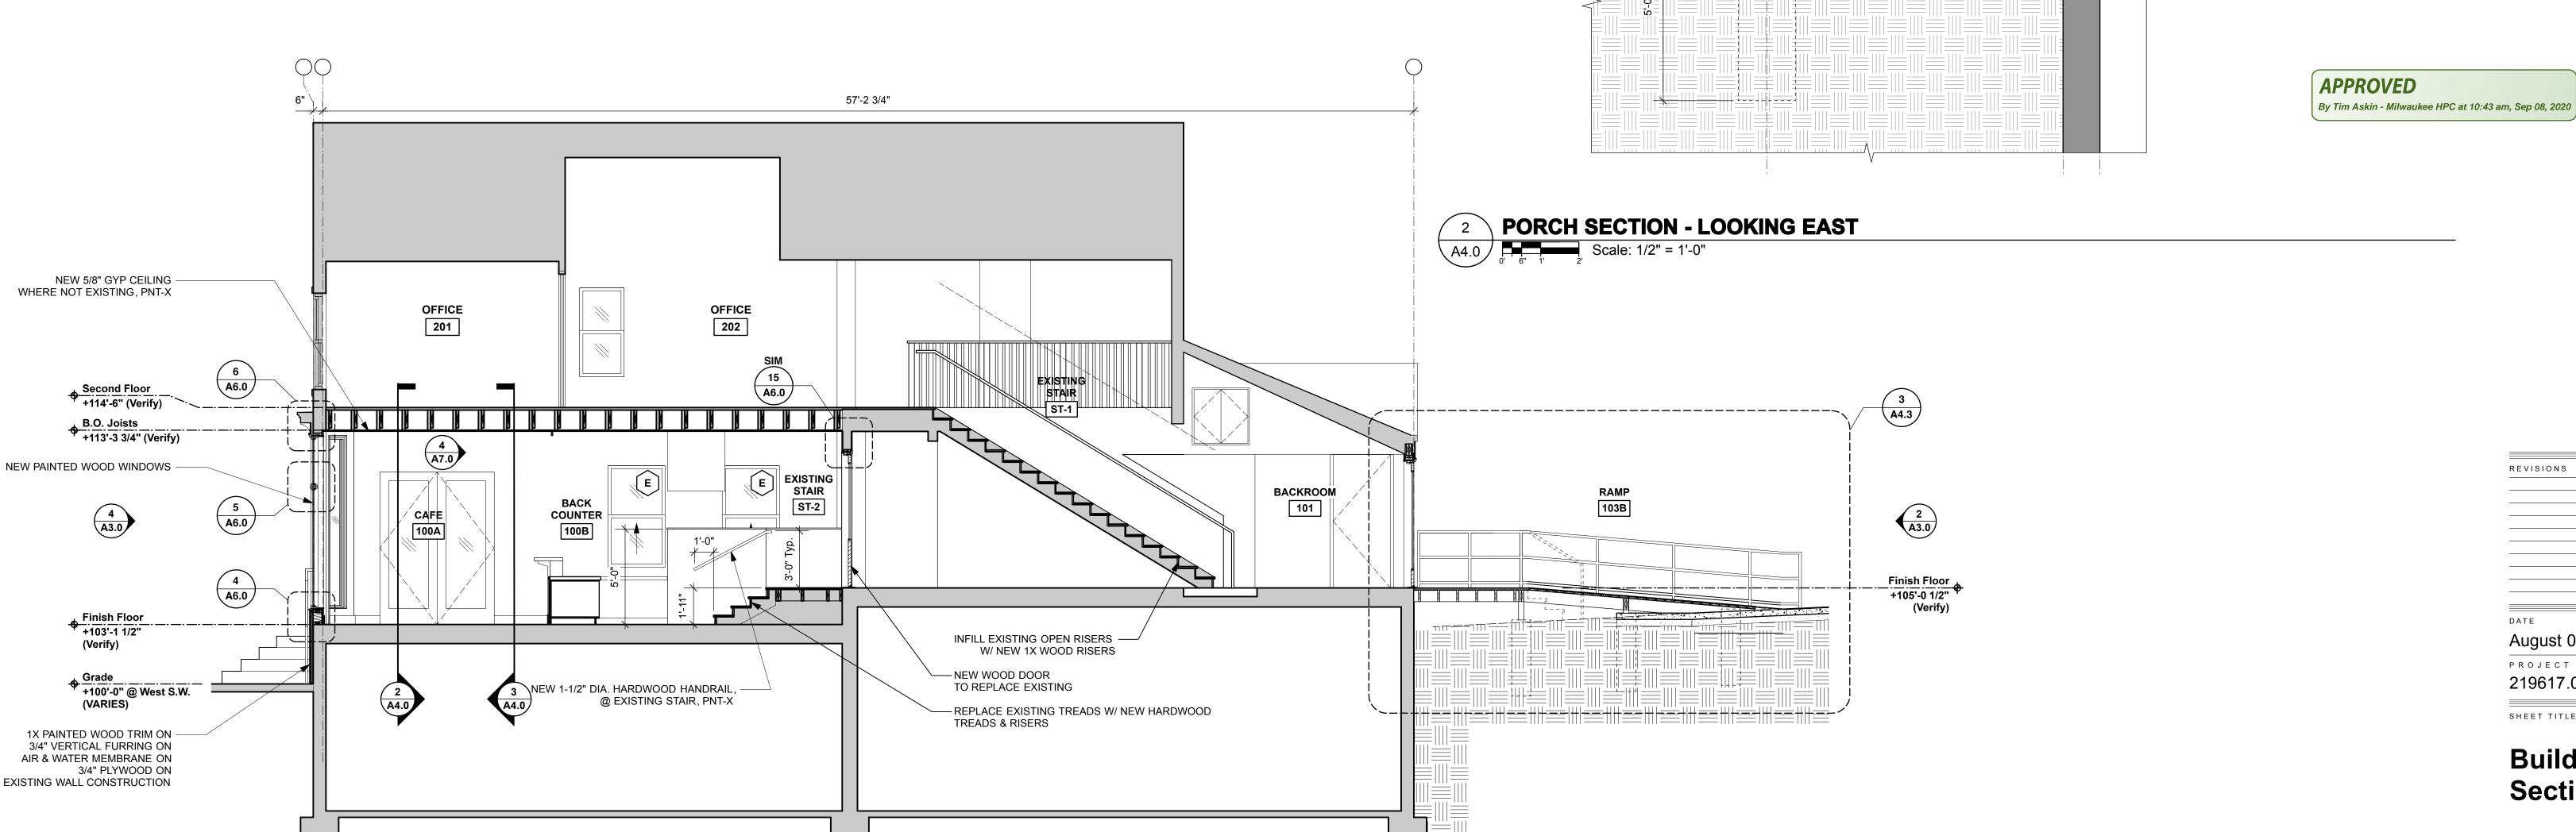
1. NEW BAR 104 TO BE COMPLETED AT FUTURE DATE (VERIFY W/ OWNER)
2. GC TO VERIFY/COORDINATE EXISTING FIELD CONDITIONS W/ NEW
STOREFRONT WINDOW REPLACEMENT









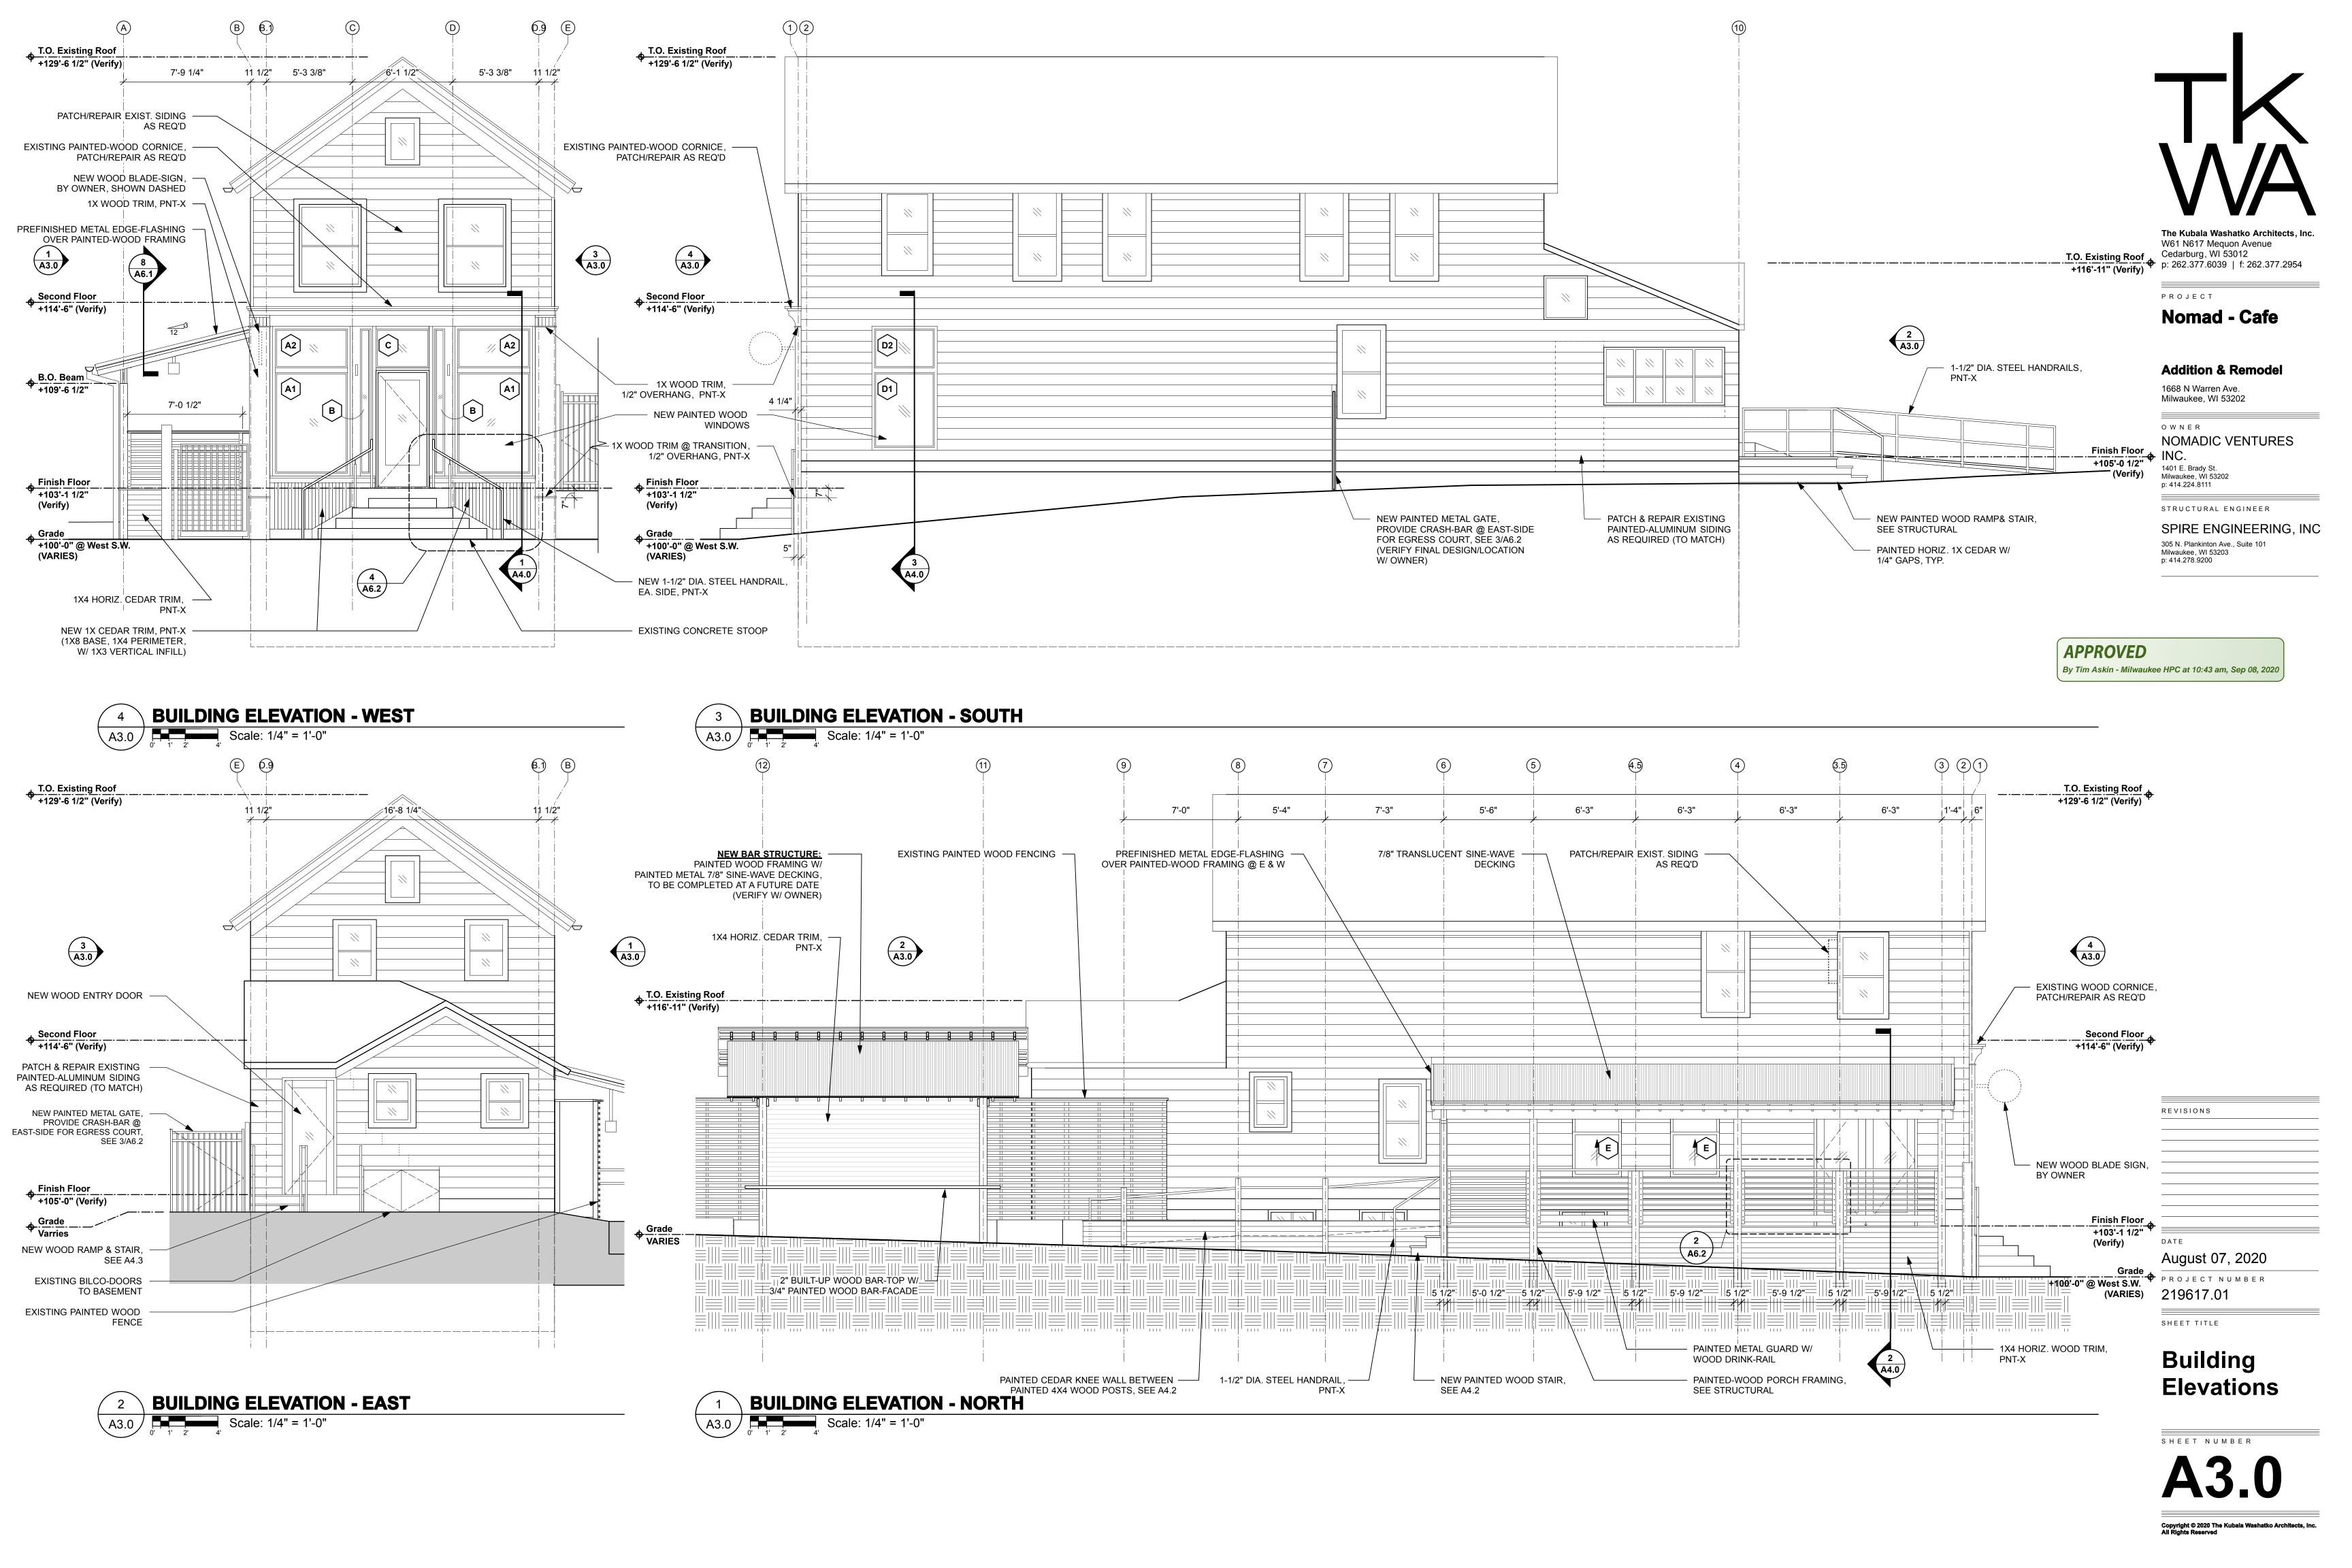

7'-9 1/4" 2X10 PT CONT. LEDGER @ EXISTING WALL, (REPLACE EXIST. 2X8, @ EXIST. T.O. LEDGER ELEV.) SEE STRUCTURAL 9 A6.1 7/8" TRANSLUCENT SINEWAVE DECKING (DIPCRAFT #22 OR EQ) ON 2X2 PT SLEEPERS @ 16" OC. ON 2X6 DFL NO 1 @ 16" OC. T.O. Exist. Ledger +112'-10" (Verify) The Kubala Washatko Architects, Inc. W61 N617 Mequon Avenue Cedarburg, WI 53012 T.O. Door R.O. p: 262.377.6039 | f: 262.377.2954 +1-3'-7 114" 4" HALF-ROUND GUTTER & DOWNSPOUT PROJECT B.O. Beam +109'-6 1/2" Nomad - Cafe (3)2X12 PAINTED WOOD BEAM, PORCH **Addition & Remodel** SEE STRUCTURAL 107A 100A 1668 N Warren Ave. Milwaukee, WI 53202 PAINTED METAL GUARD W/ 1 - INFRA-RED HEATER, COORD. MOUNTING WOOD DRINK-RAIL OWNER LOCATION/HEIGHT W/ OWNER & MFR'S REQ'S NOMADIC VENTURES - NEW PAINTED WOOD DOORS **EXISTING** INC. W/ GLASS-LITE BEERGARDEN 1401 E. Brady St. 105 Milwaukee, WI 53202 p: 414.224.8111 CEDAR DECKING -STRUCTURAL ENGINEER Finish Floor +103'-1 1/2" SPIRE ENGINEERING, INC 1X4 PAINTED HORIZ. CEDAR TRIM, unda una vina una una una una una una una una una vina vina vina una vina una vina sina sina sina 🕿 1/4" GAP TYP., ON 2X WD FRAMING 305 N. Plankinton Ave., Suite 101 Milwaukee, WI 53203 p: 414.278.9200 A6.2 NEW WOOD PORCH FRAMING, SEE STRUCTURAL Grade VARIES

August 07, 2020

PROJECT NUMBER

219617.01


SHEET TITLE

Building Sections


SHEET NUMBER

BUILDING SECTION - LOOKING NORTH


A4.0 Scale: 1/4" = 1'-0"

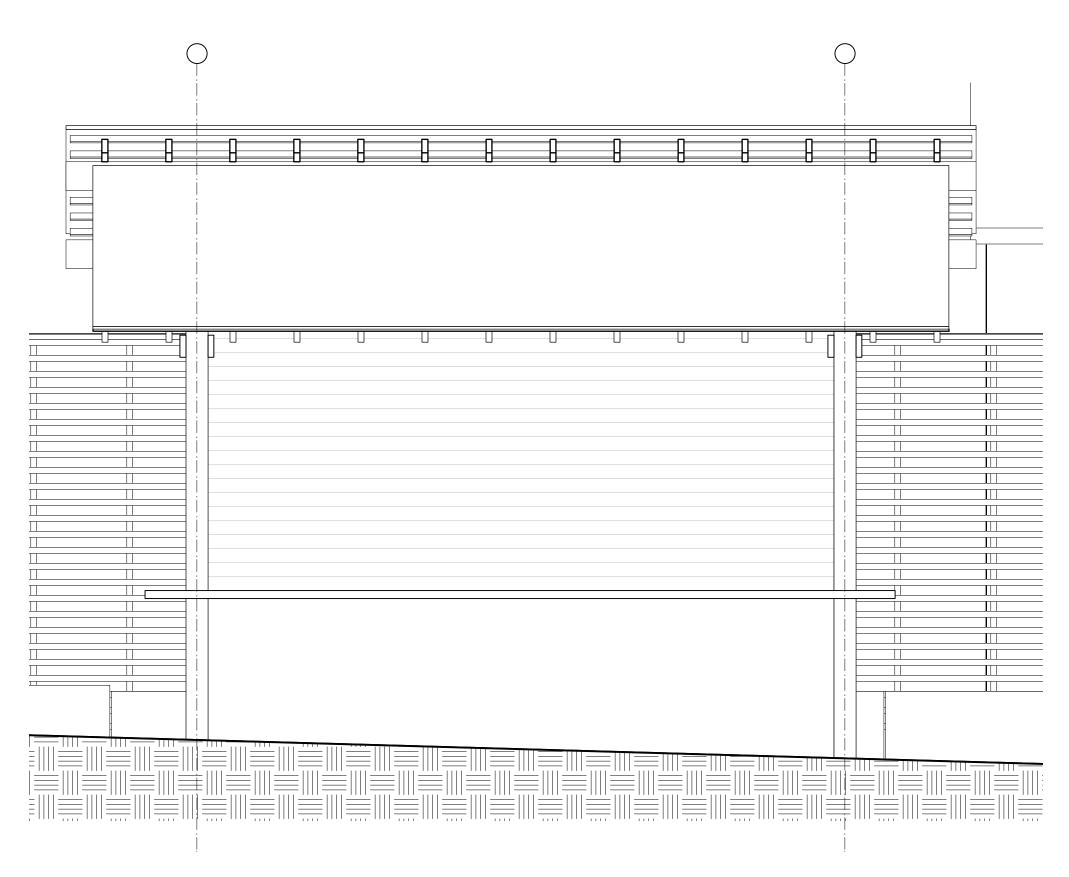

A4.1 Scale: 1/2" = 1'-0"

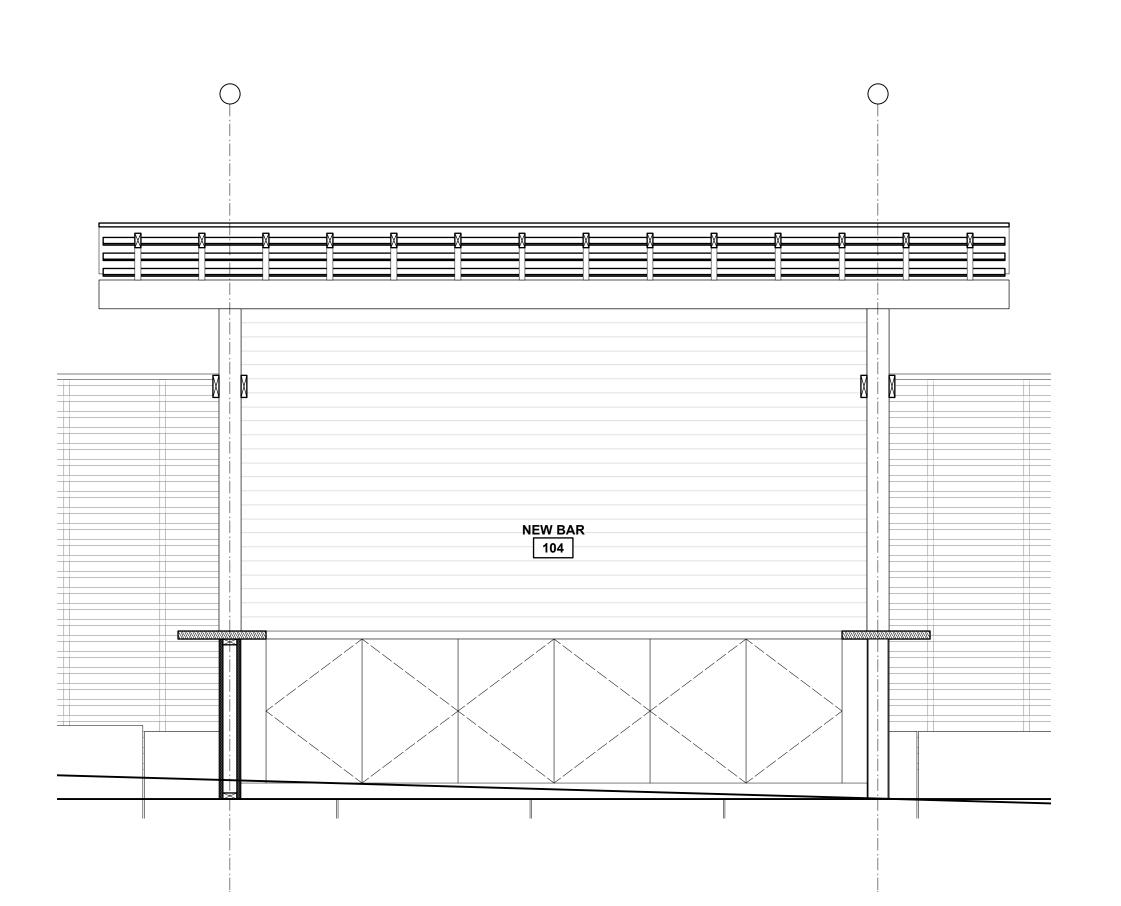


2 **NOT USED**A4.1 Scale: 1/2" = 1'-0"

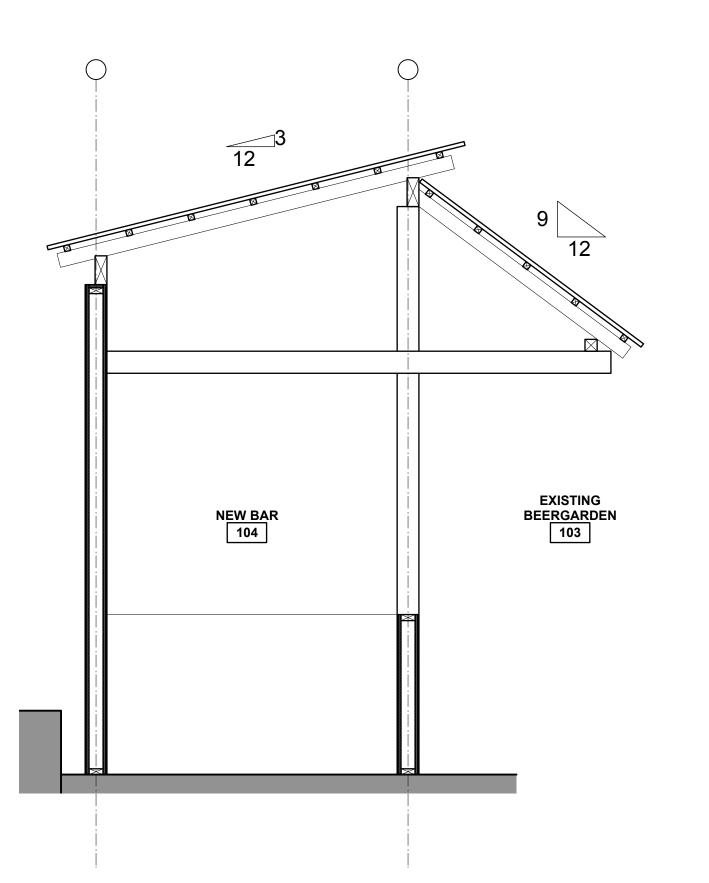

NEW BAR SECTION - LOOKING WEST

A4.1

O' 6" 1' 2' Scale: 1/2" = 1'-0"

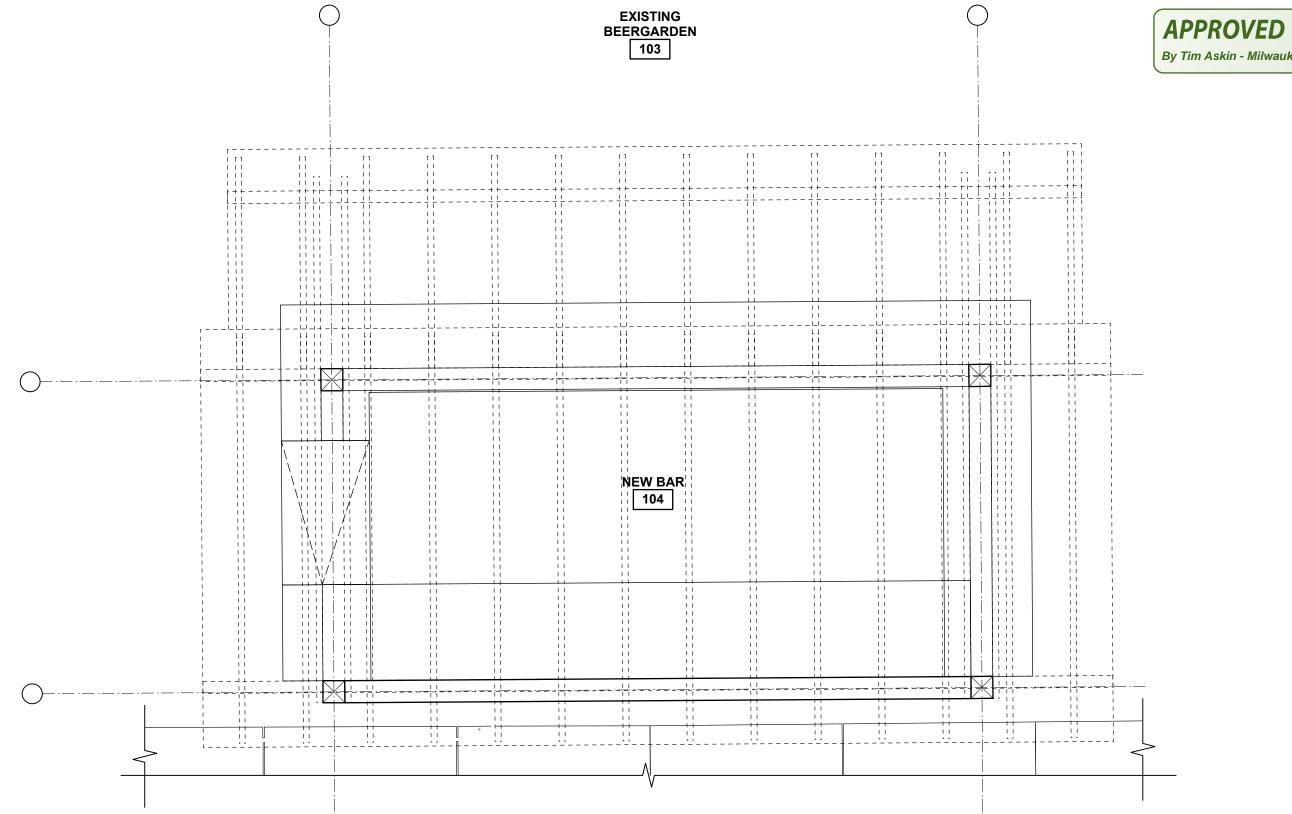

1 NEW BAR - ENLARGED PLAN

A4.1 Scale: 1/2" = 1'-0"

PLAN N

ACTUAL N

New Bar Sections -Reference

GENERAL NOTES

1. NEW BAR 104 TO BE COMPLETED AT FUTURE DATE (VERIFY W/ OWNER), CURRENT A4.1 DRAWINGS FOR REFERENCE ONLY

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W61 N617 Mequon Avenue
Cedarburg, WI 53012
p: 262.377.6039 | f: 262.377.2954

P R O J E C T

Nomad - Cafe

Addition & Remodel

1668 N Warren Ave. Milwaukee, WI 53202

p: 414.224.8111

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NOMADIC VENTURES
INC.

1401 E. Brady St.
Milwaukee, WI 53202

STRUCTURAL ENGINEER

SPIRE ENGINEERING, INC 305 N. Plankinton Ave., Suite 101 Milwaukee, WI 53203 p: 414.278.9200

By Tim Askin - Milwaukee HPC at 10:43 am, Sep 08, 2020

REVISIONS

August 07, 2020


PROJECT NUMBER **219617.01**

SHEET TITLE

Reference

SHEET NUMBER

A4.1

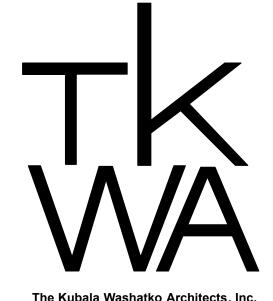

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PROJECT

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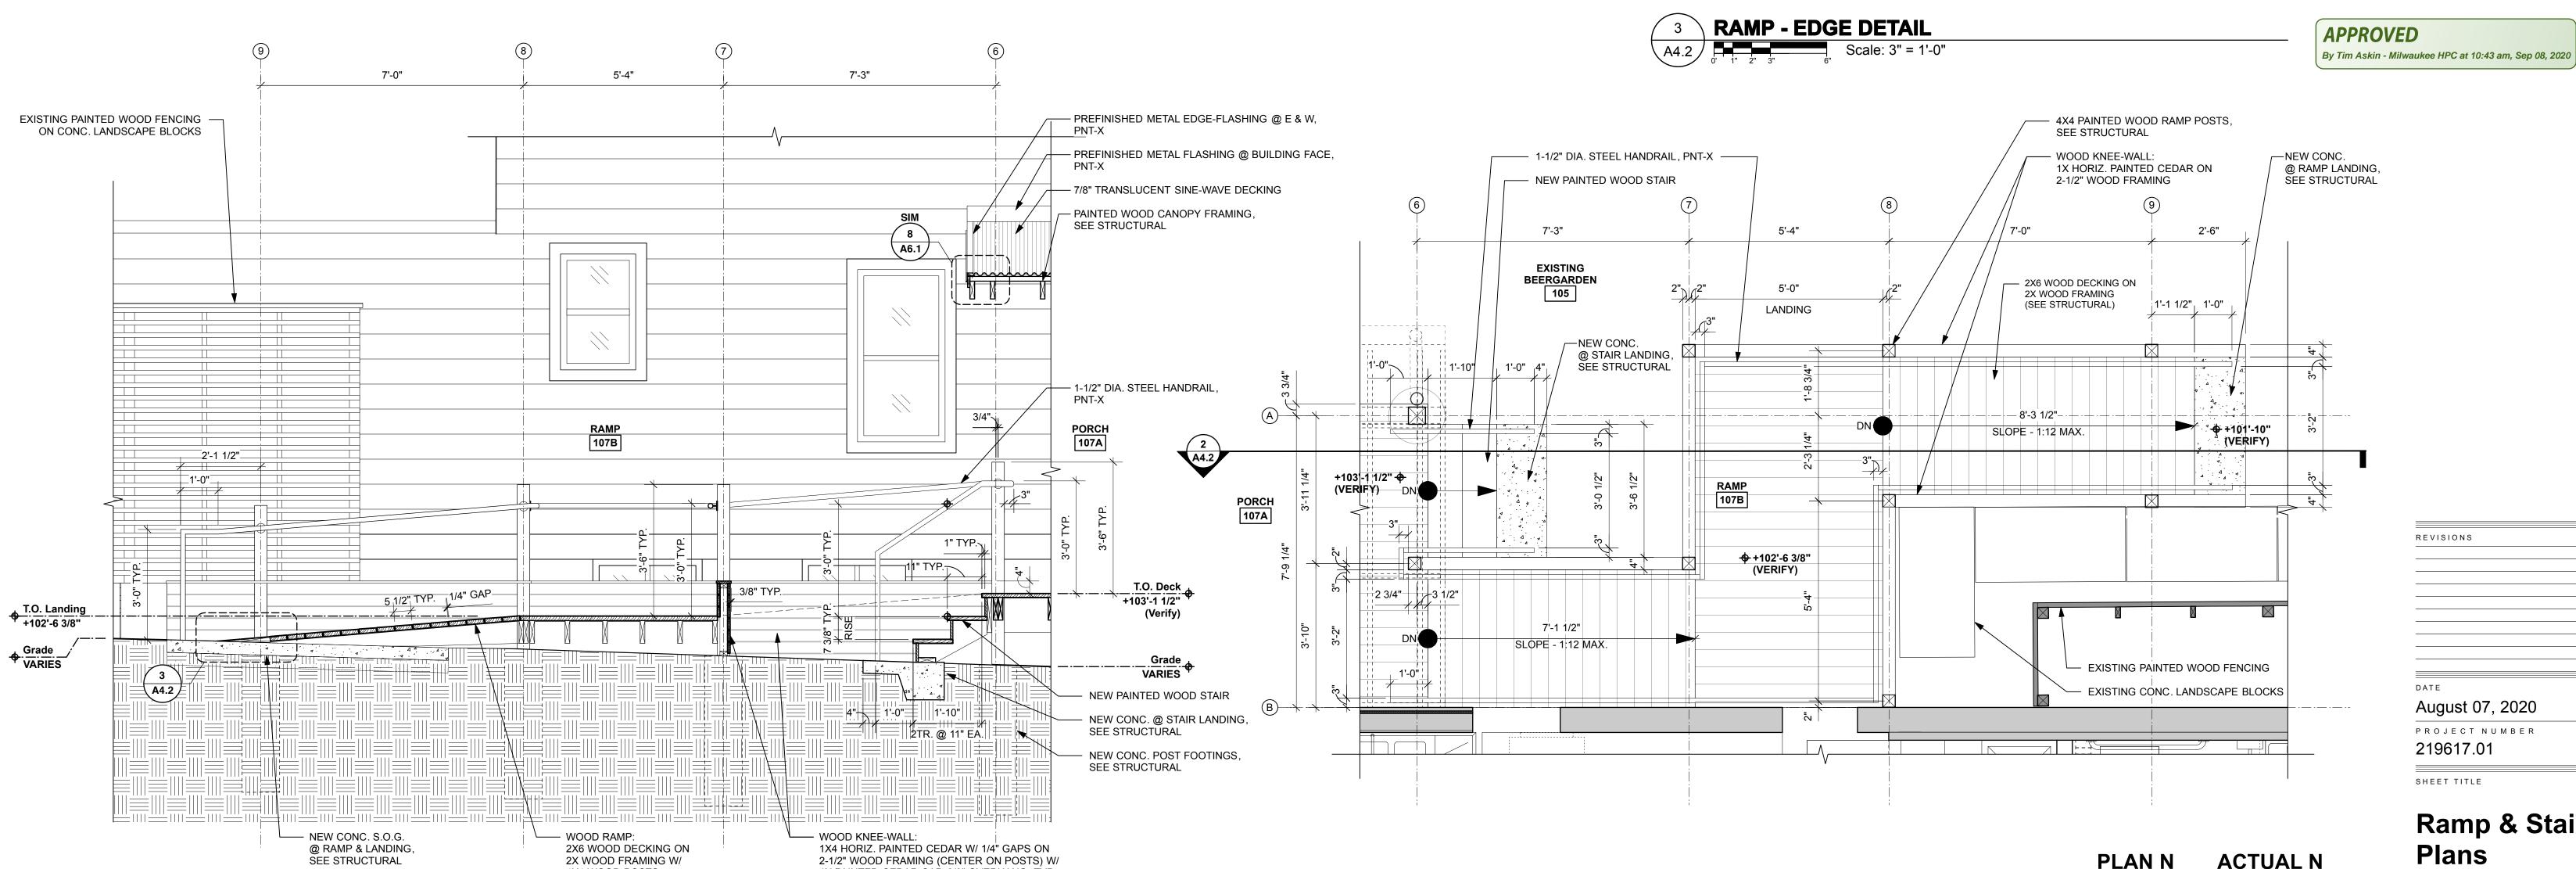
PLATE-STEEL THRESHOLD @ RAMP END-TRANSITION ON TAPERED BLOCKING

2X6 WOOD DECKING ON — 2X RAMP FRAMING,

SEE STRUCTURAL

4X4 WOOD POST BEYOND, -

SEE STRUCTURAL



ENLARGED RAMP PLAN

Scale: 1/2" = 1'-0"

2X6 WOOD DECKING ON

2X WOOD FRAMING W/ 4X4 WOOD POSTS (SEE STRUCTURAL)

RAMP SECTION - LOOKING SOUTH

Scale: 1/2" = 1'-0"

1X4 HORIZ. PAINTED CEDAR W/ 1/4" GAPS ON

2-1/2" WOOD FRAMING (CENTER ON POSTS) W/ 1X PAINTED CEDAR CAP, 3/8" OVERHANG, TYP.

REVISIONS August 07, 2020 PROJECT NUMBER

219617.01


SHEET TITLE

ACTUAL N


PLAN N

Ramp & Stair **Plans**

SHEET NUMBER

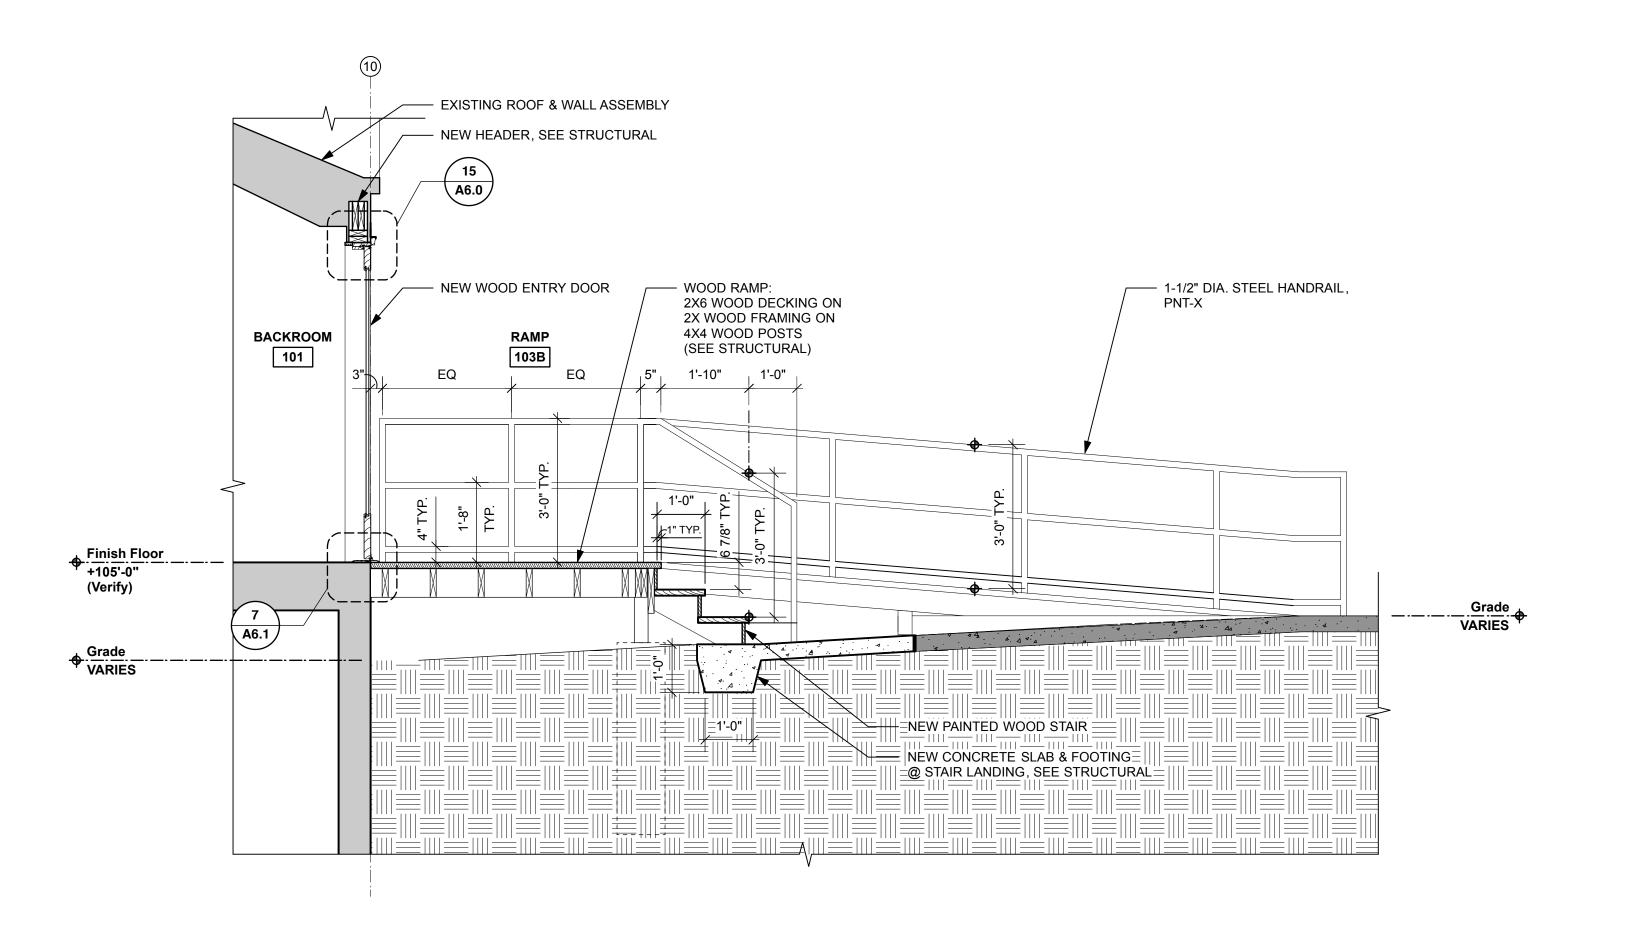


A4.3 Scale: 1/2" = 1'-0"

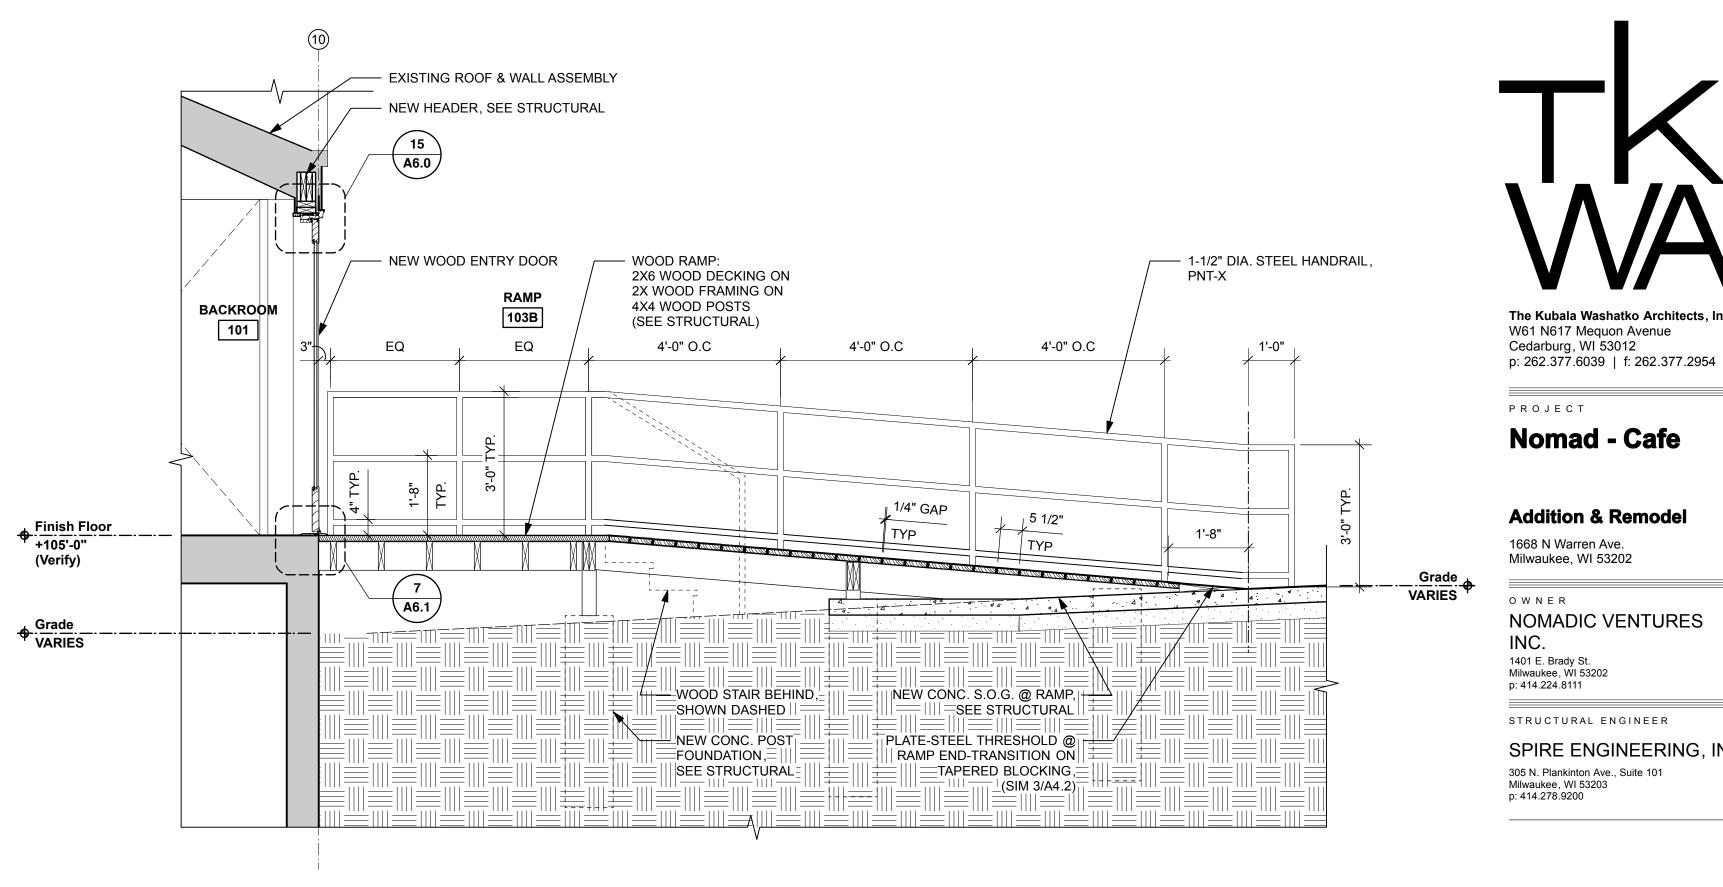


RAMP SECTION - LOOKING NORTH

A4.3 Scale: 1/2" = 1'-0"

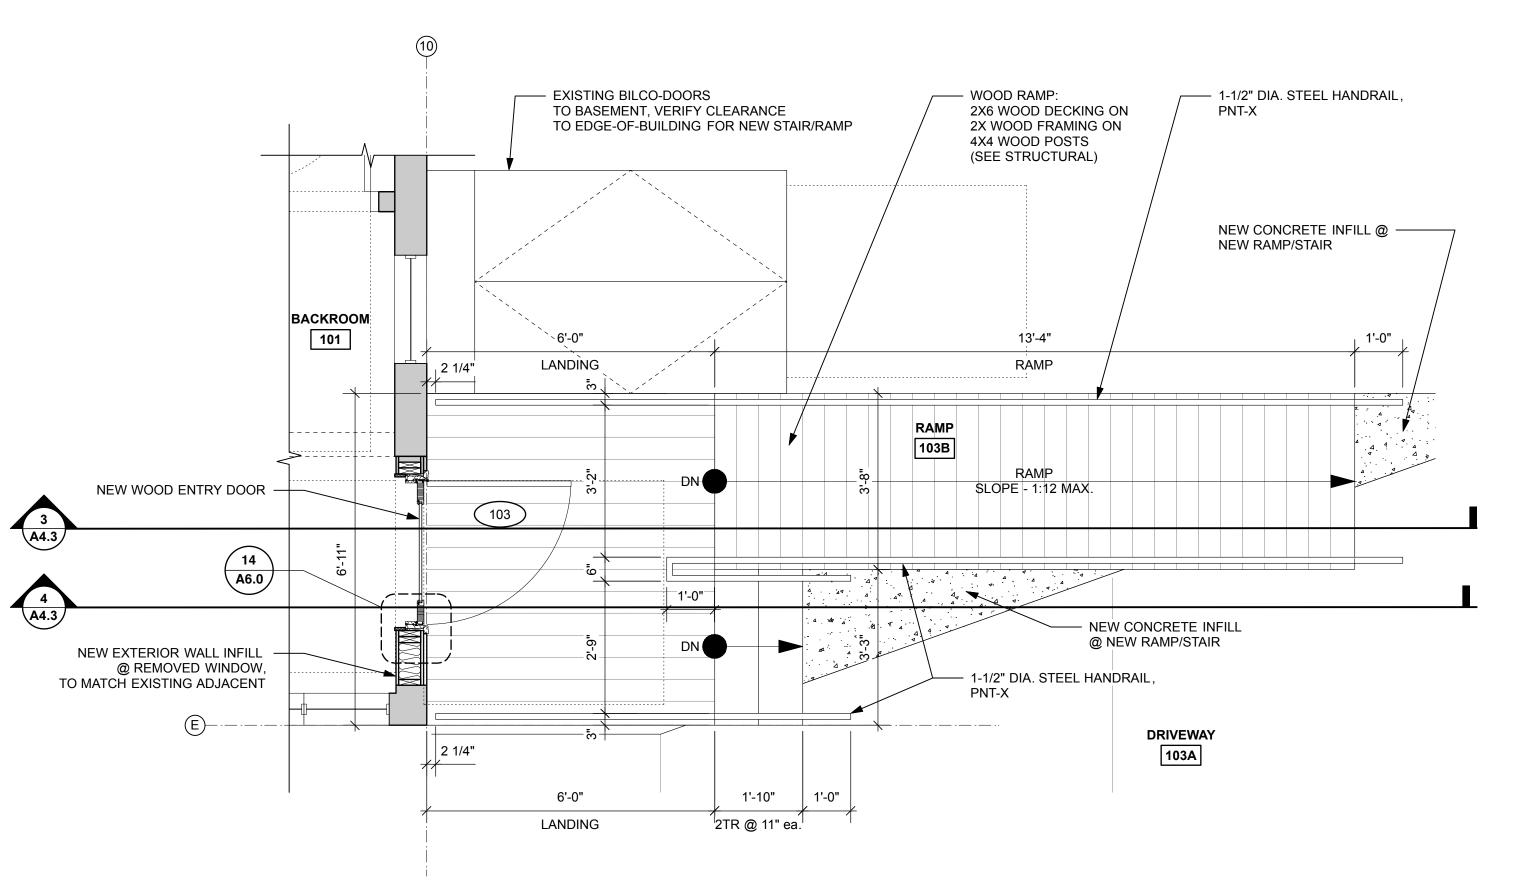



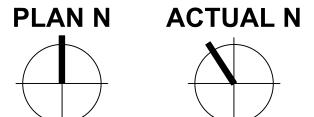

REVISIONS August 07, 2020 PROJECT NUMBER 219617.01

The Kubala Washatko Architects, Inc.

W61 N617 Mequon Avenue

Addition & Remodel

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INC.

1401 E. Brady St. Milwaukee, WI 53202

Cedarburg, WI 53012


Ramp & Stair **Plans**


SHEET TITLE

SHEET NUMBER

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NOT USED Scale: 1/2" = 1'-0"



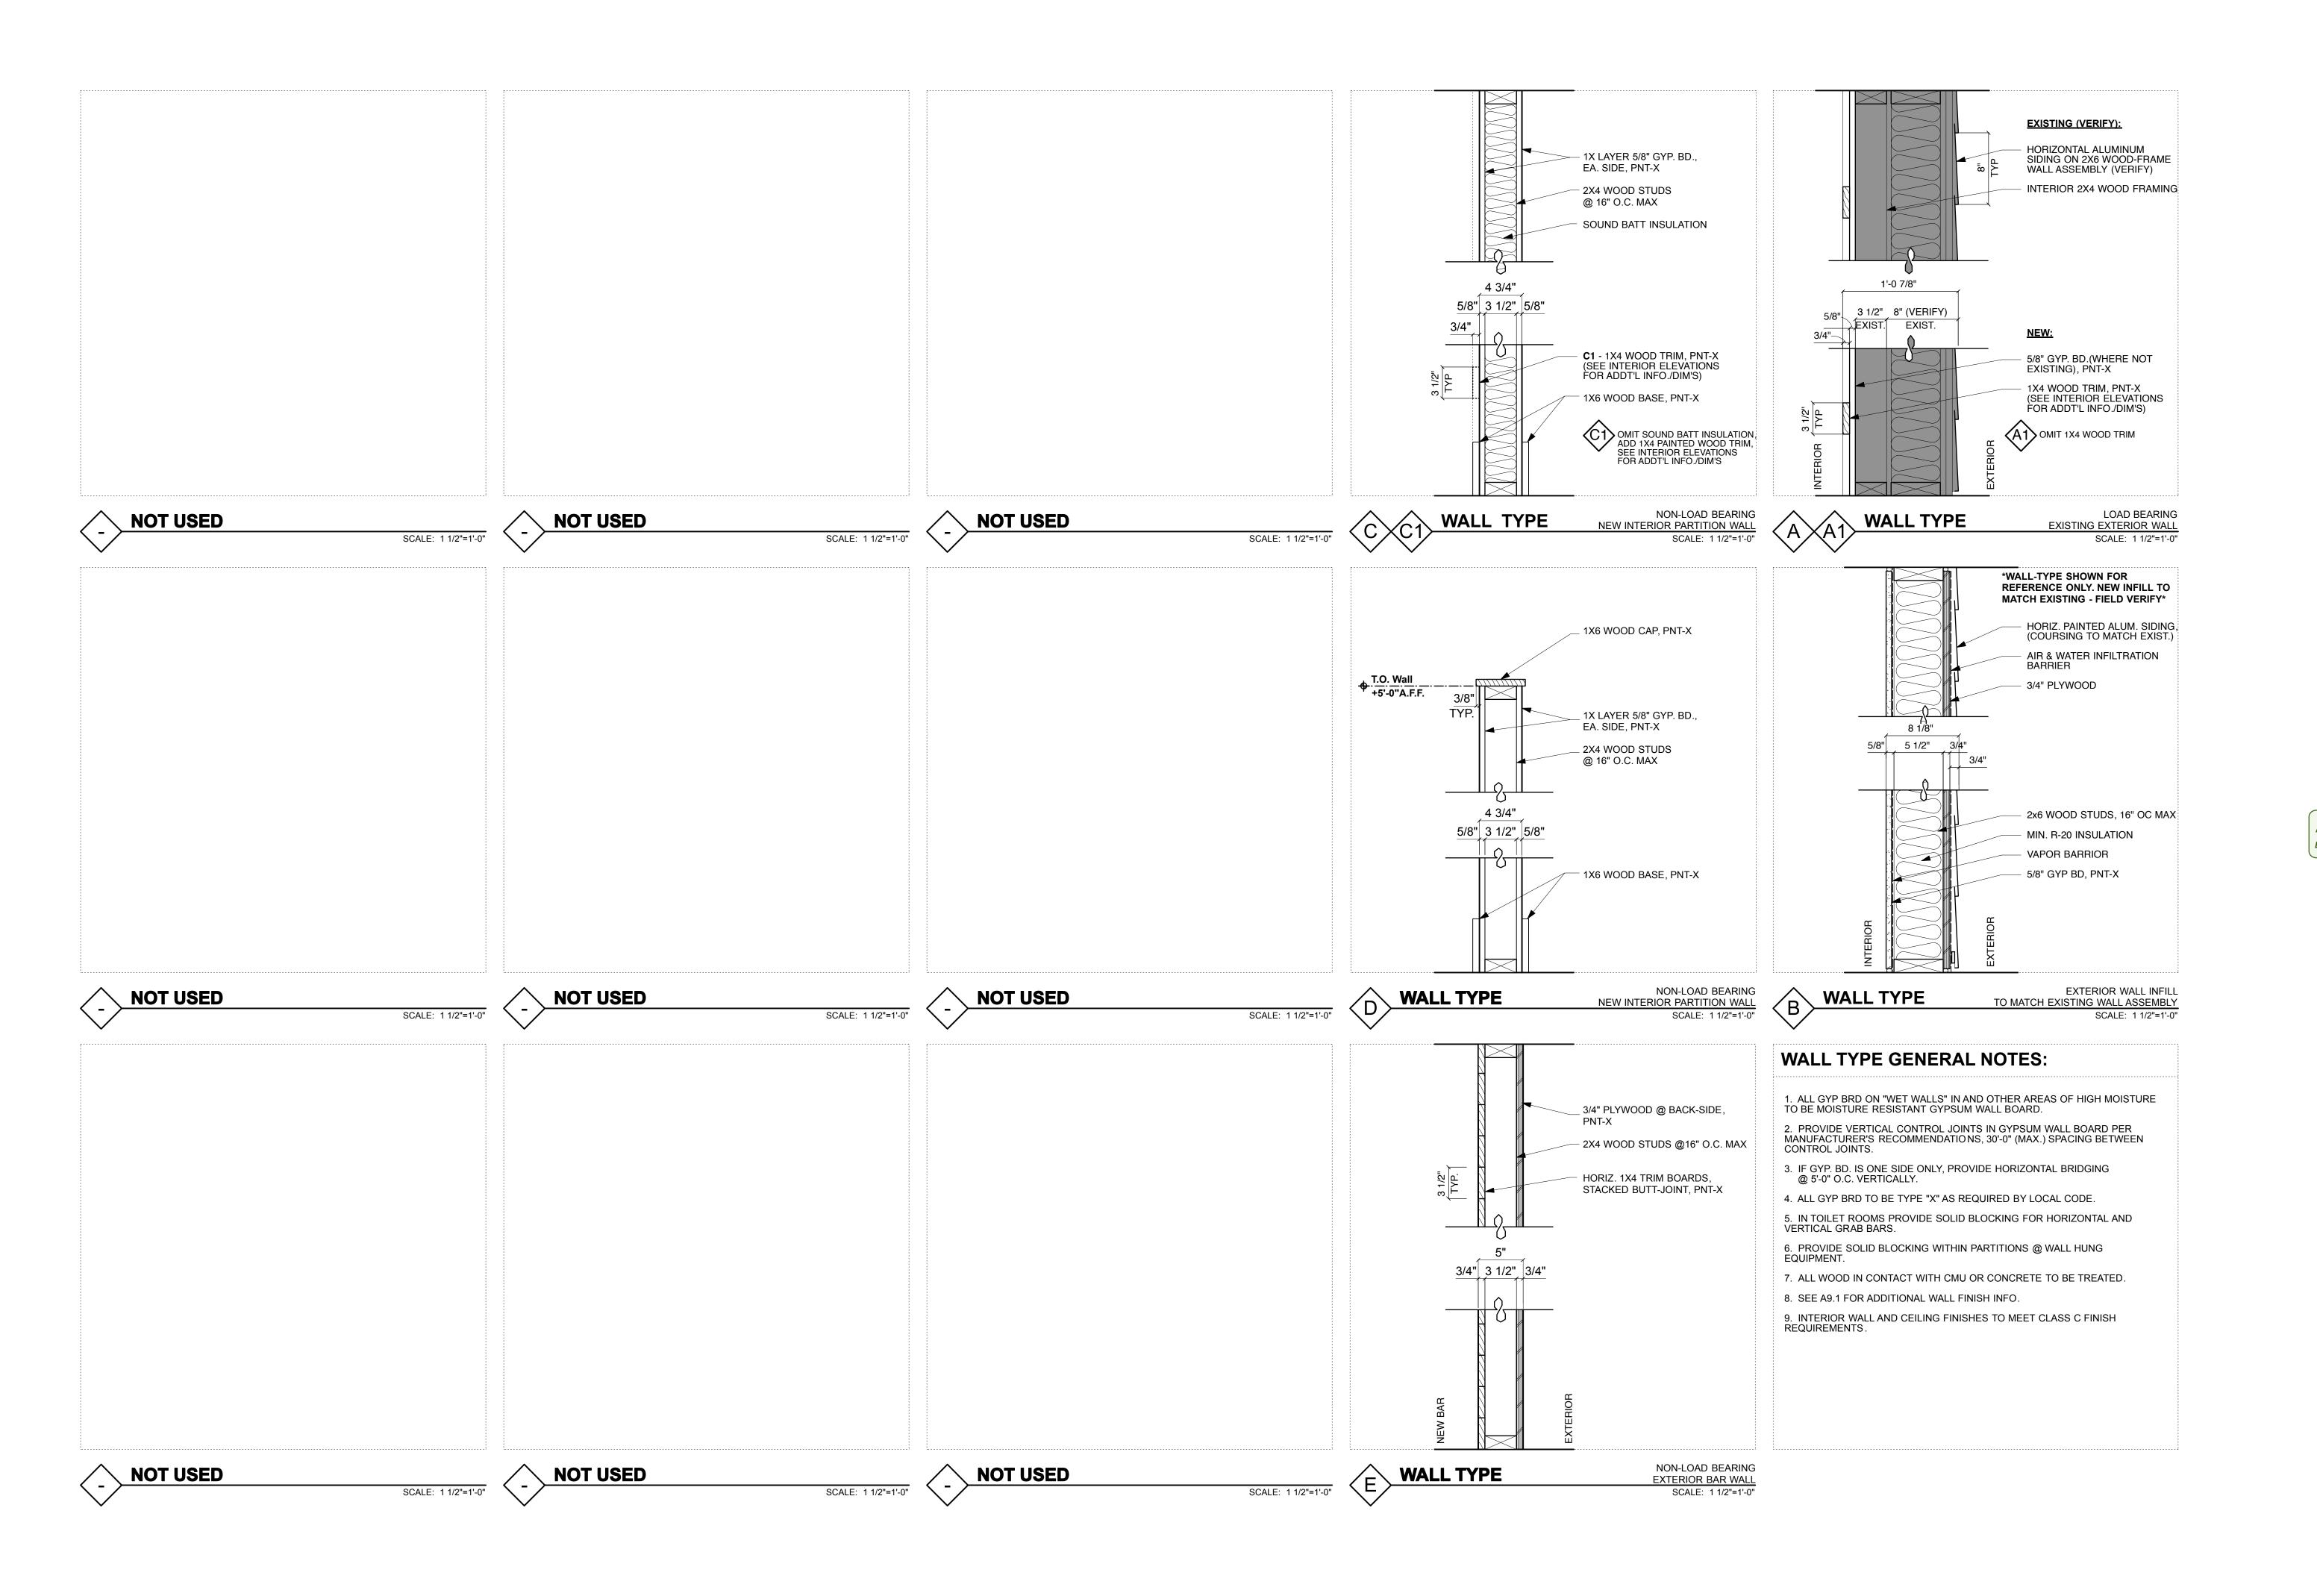
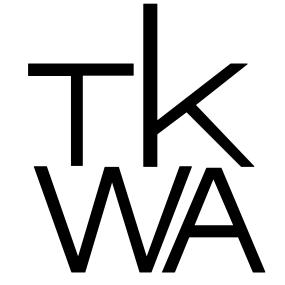
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PROJECT

Nomad - Cafe

Addition & Remodel

1668 N Warren Ave. Milwaukee, WI 53202

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Milwaukee, WI 53202 p: 414.224.8111

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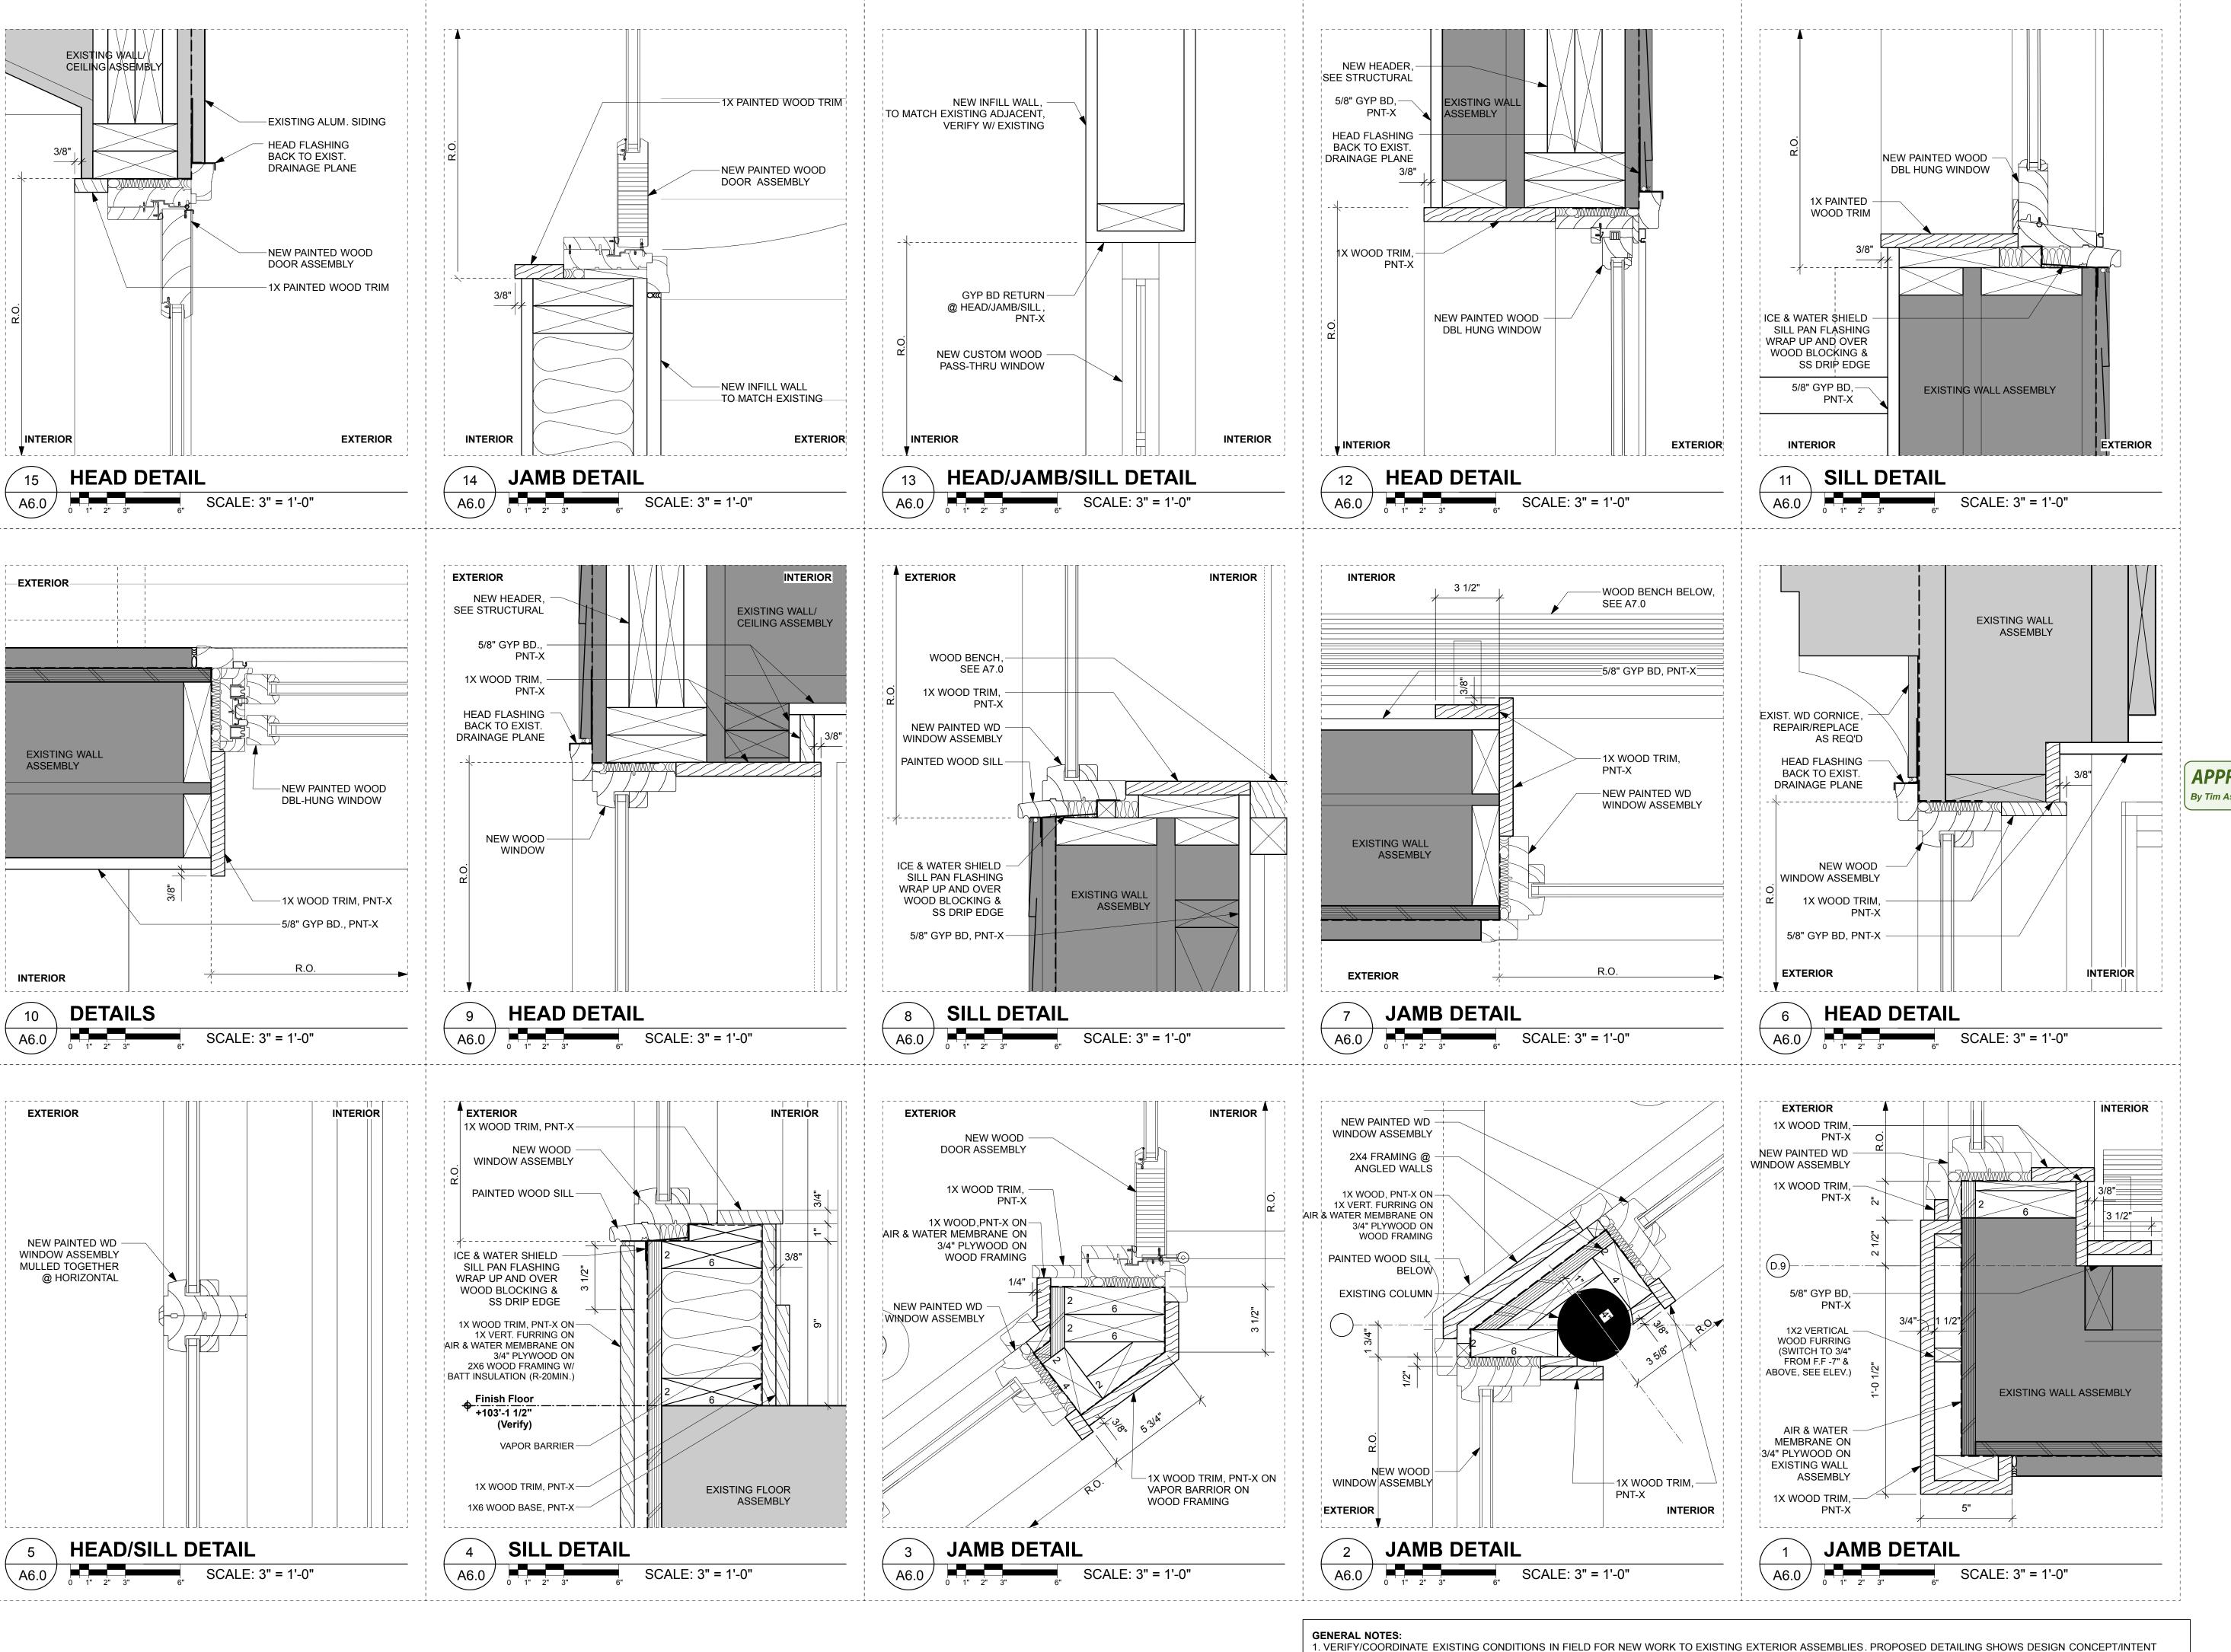
219617.01

SHEET TITLE

Wall Types

A5.0

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ONLY, ACTUAL CONDITIONS MAY VARY.

2. WINDOWS AND DOORS TO BE INSTALLED PER MFR'S RECOMMENDATIONS, GC TO VERIFY DETAILING

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PROJECT

Nomad - Cafe

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DATE

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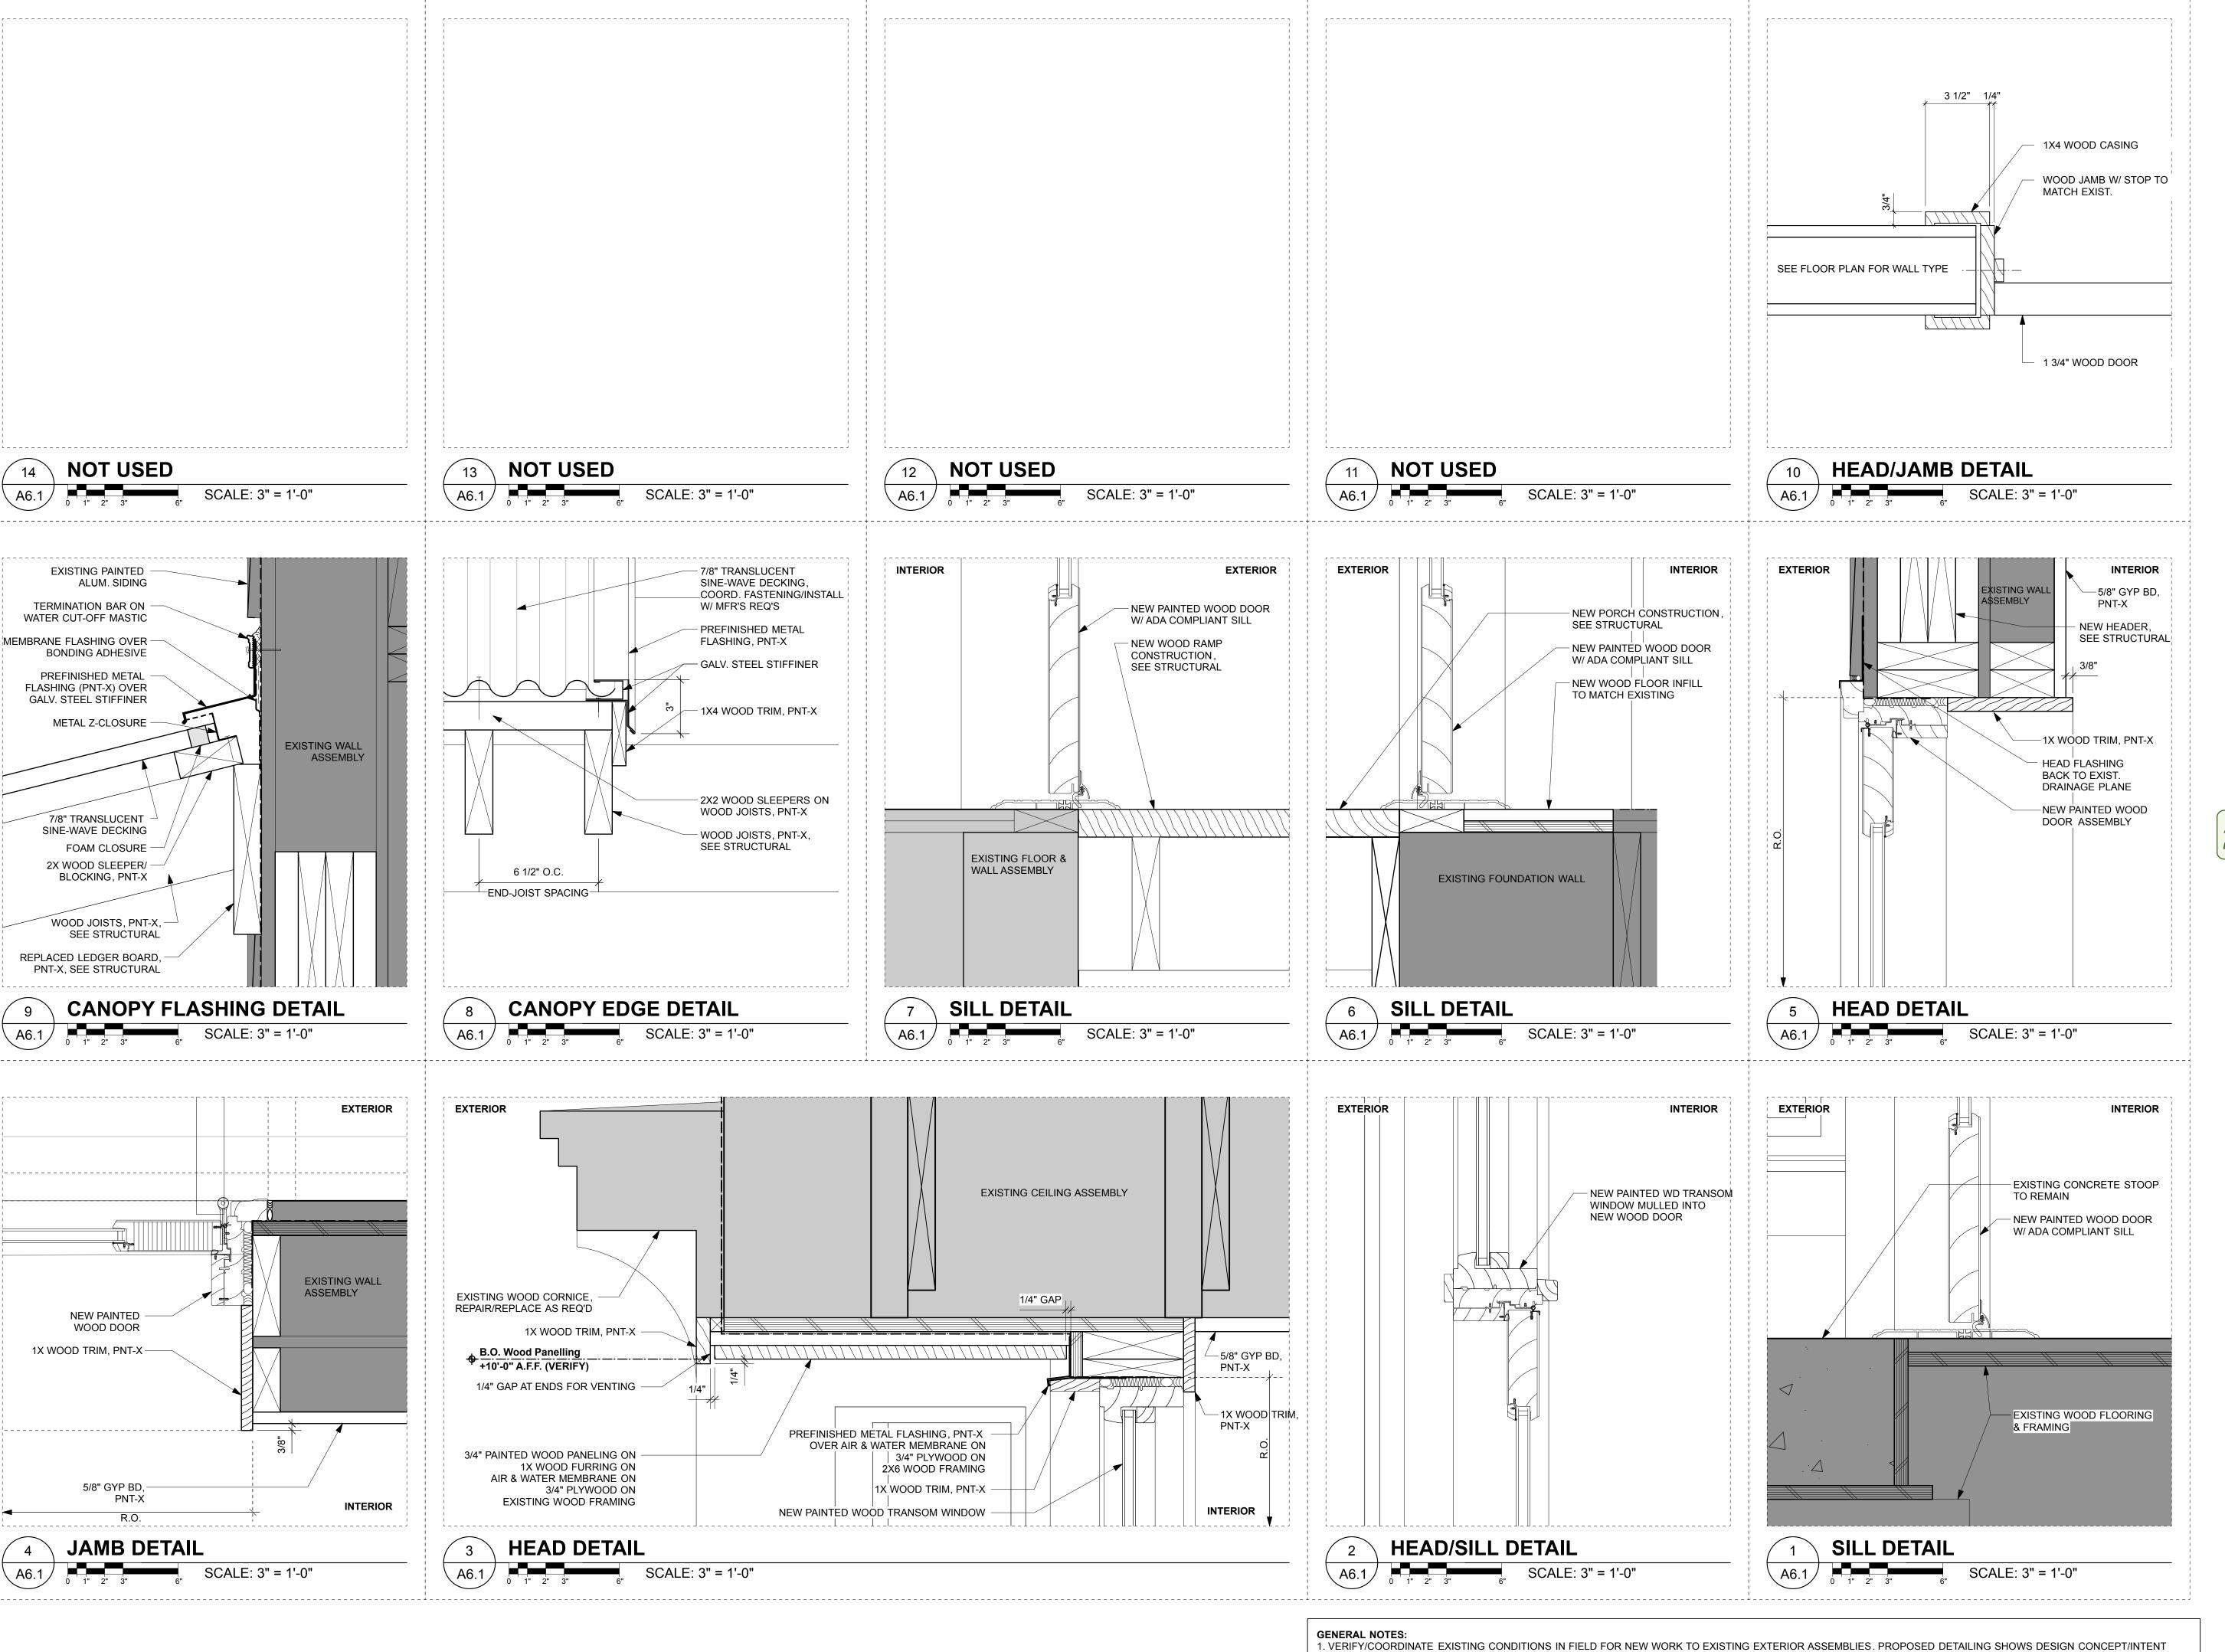
PROJECT NUMBER

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SHEET TITLE

sheet number

A6.0



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Nomad - Cafe

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Addition & Remodel

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PROJECT NUMBER


Details

219617.01

SHEET TITLE

A6.1

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9'-2" VERIFY 4'-6" GATE 4'-6" GATE VERIFY **VERIFY** 3"X3" STEEL POSTS FOR GATE HINGING, 1-1/2"X1-1/2" STEEL, PNT-X PROVIDE CRASH BAR @ EAST-SIDE OF NORTH GATE FOR EGRESS COURT ⁻ 3/4"X3/4" STEEL, PNT-X 1-1/2"X1-1/2" STEEL, PNT-X 4" O.C. TYP.

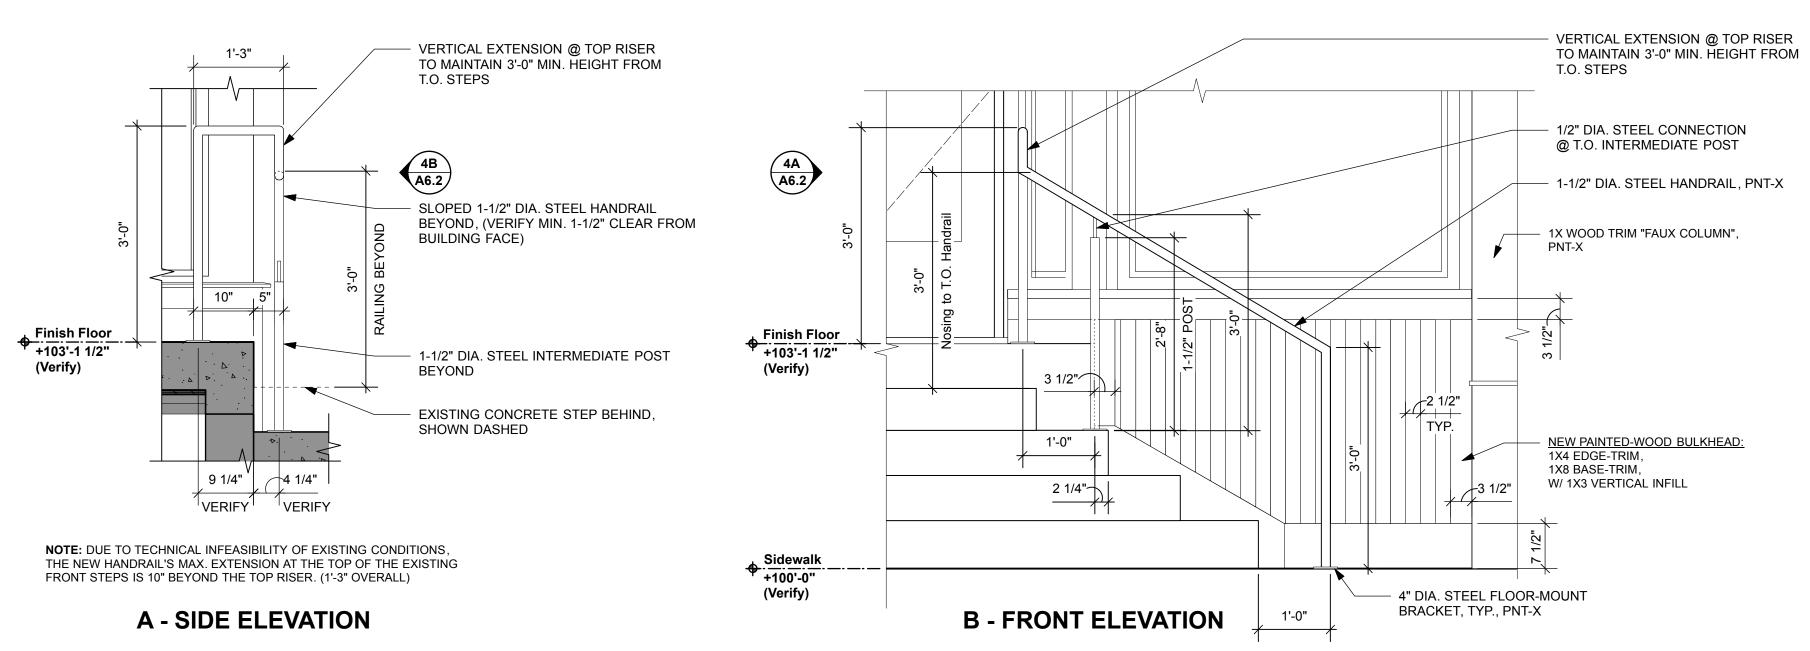W61 N617 Mequon Avenue Cedarburg, WI 53012 p: 262.377.6039 | f: 262.377.2954 PROJECT Nomad - Cafe **Addition & Remodel** 1668 N Warren Ave. Milwaukee, WI 53202 OWNER NOMADIC VENTURES 1401 E. Brady St. Milwaukee, WI 53202


> SPIRE ENGINEERING, INC 305 N. Plankinton Ave., Suite 101 Milwaukee, WI 53203 p: 414.278.9200


STRUCTURAL ENGINEER

p: 414.224.8111

ENTRY HAND-RAIL

SOUTH HANDRAIL SHOWN, NORTH HANDRAIL IS SIM./MIRRORED

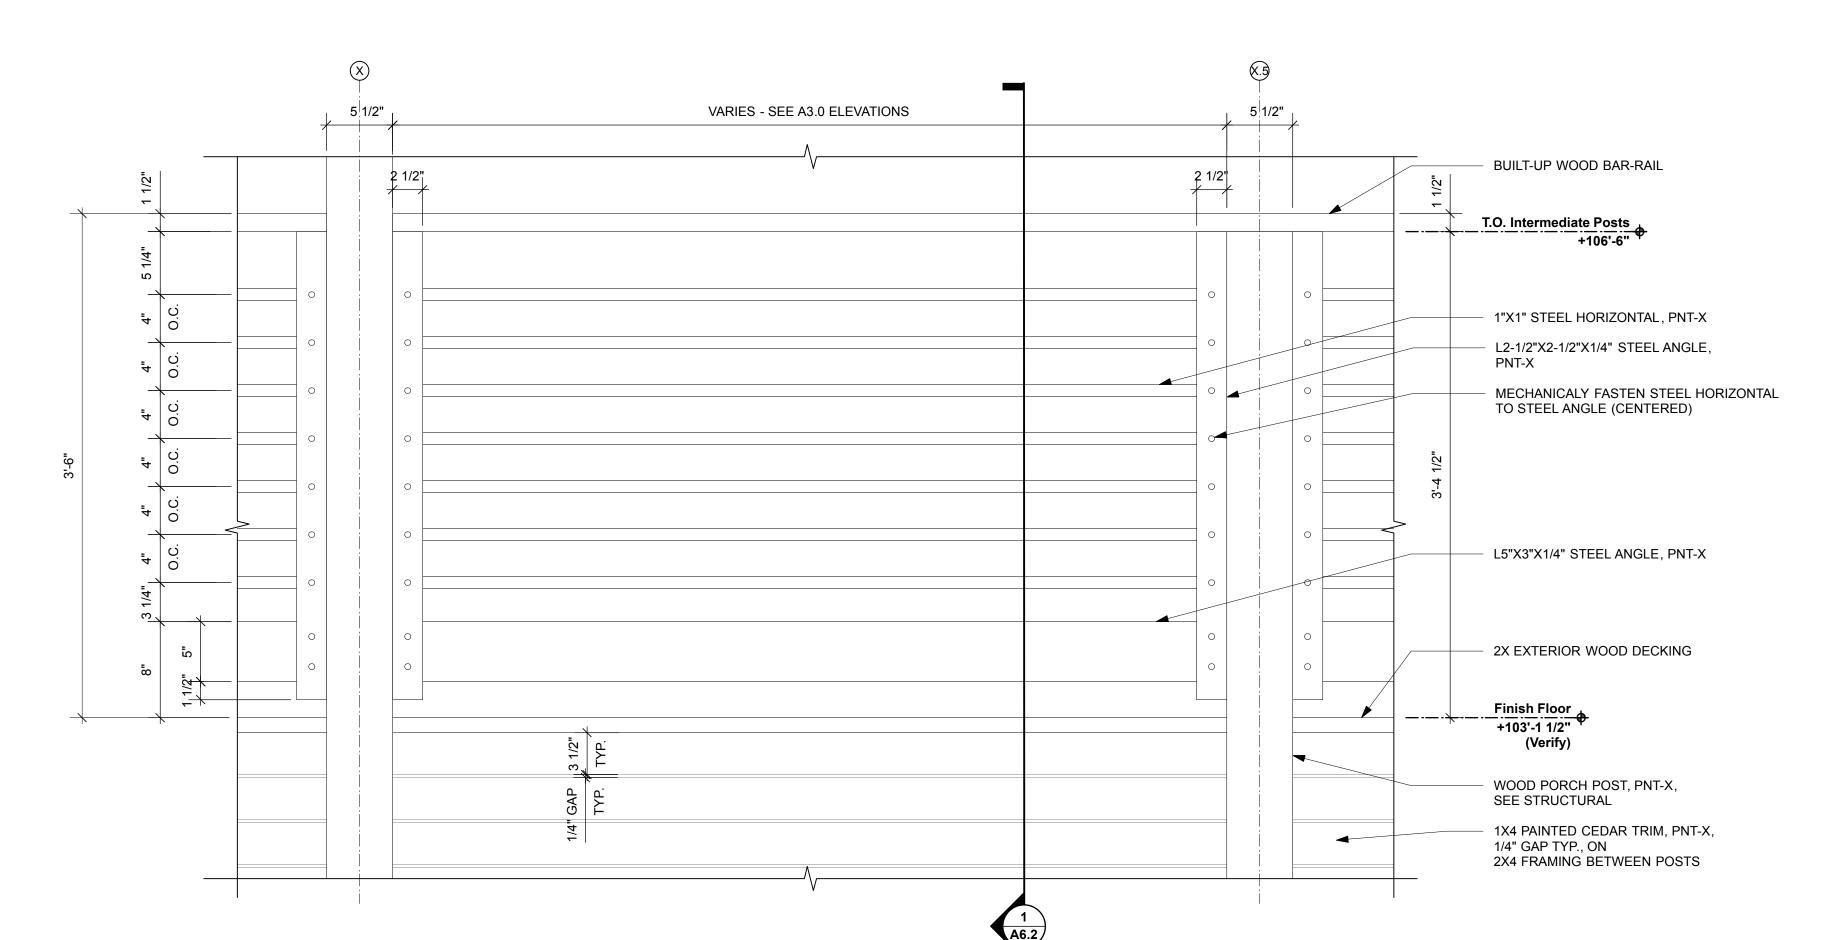

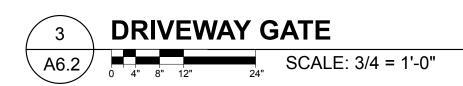

PORCH GUARD DETAIL

APPROVED By Tim Askin - Milwaukee HPC at 10:43 am, Sep 08, 2020 1 1/2" 2 1/2" BUILT-UP WOOD BAR-RAIL PAINTED GUTTER BEYOND, SHOWN DASHED WOOD PORCH POST BEYOND, PNT-X, SEE STRUCTURAL 1"X1" STEEL HORIZONTAL, PNT-X L2-1/2"X2-1/2"X1/4" STEEL ANGLE, REVISIONS BEYOND, PNT-X L5"X3"X1/4" STEEL ANGLE, PNT-X - 1-1/2" DIA. STEEL HANDRAIL BEYOND, PNT-X 2X EXTERIOR WOOD DECKING Finish Floor +103'-1 1/2" 5 1/2" August 07, 2020 PROJECT NUMBER 219617.01 SHEET TITLE WOOD PORCH FRAMING, SEE STRUCTURAL 1X4 PAINTED CEDAR TRIM,

DRIVEWAY GATE SHOWNFOR DESIGN CONCEPT ONLY, VERIFY FINAL DESIGN/LOCATION W/ OWNER


A6.2 SCALE: 1-1/2" = 1'-0"

1/4" GAPS TYP., PNT-X ON 2X4 FRAMING BETWEEN POSTS **Details**

SHEET NUMBER

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PORCH GUARD ELEVATION A6.2 0 2" 4" 6" SCALE: 1-1/2" = 1'-0"



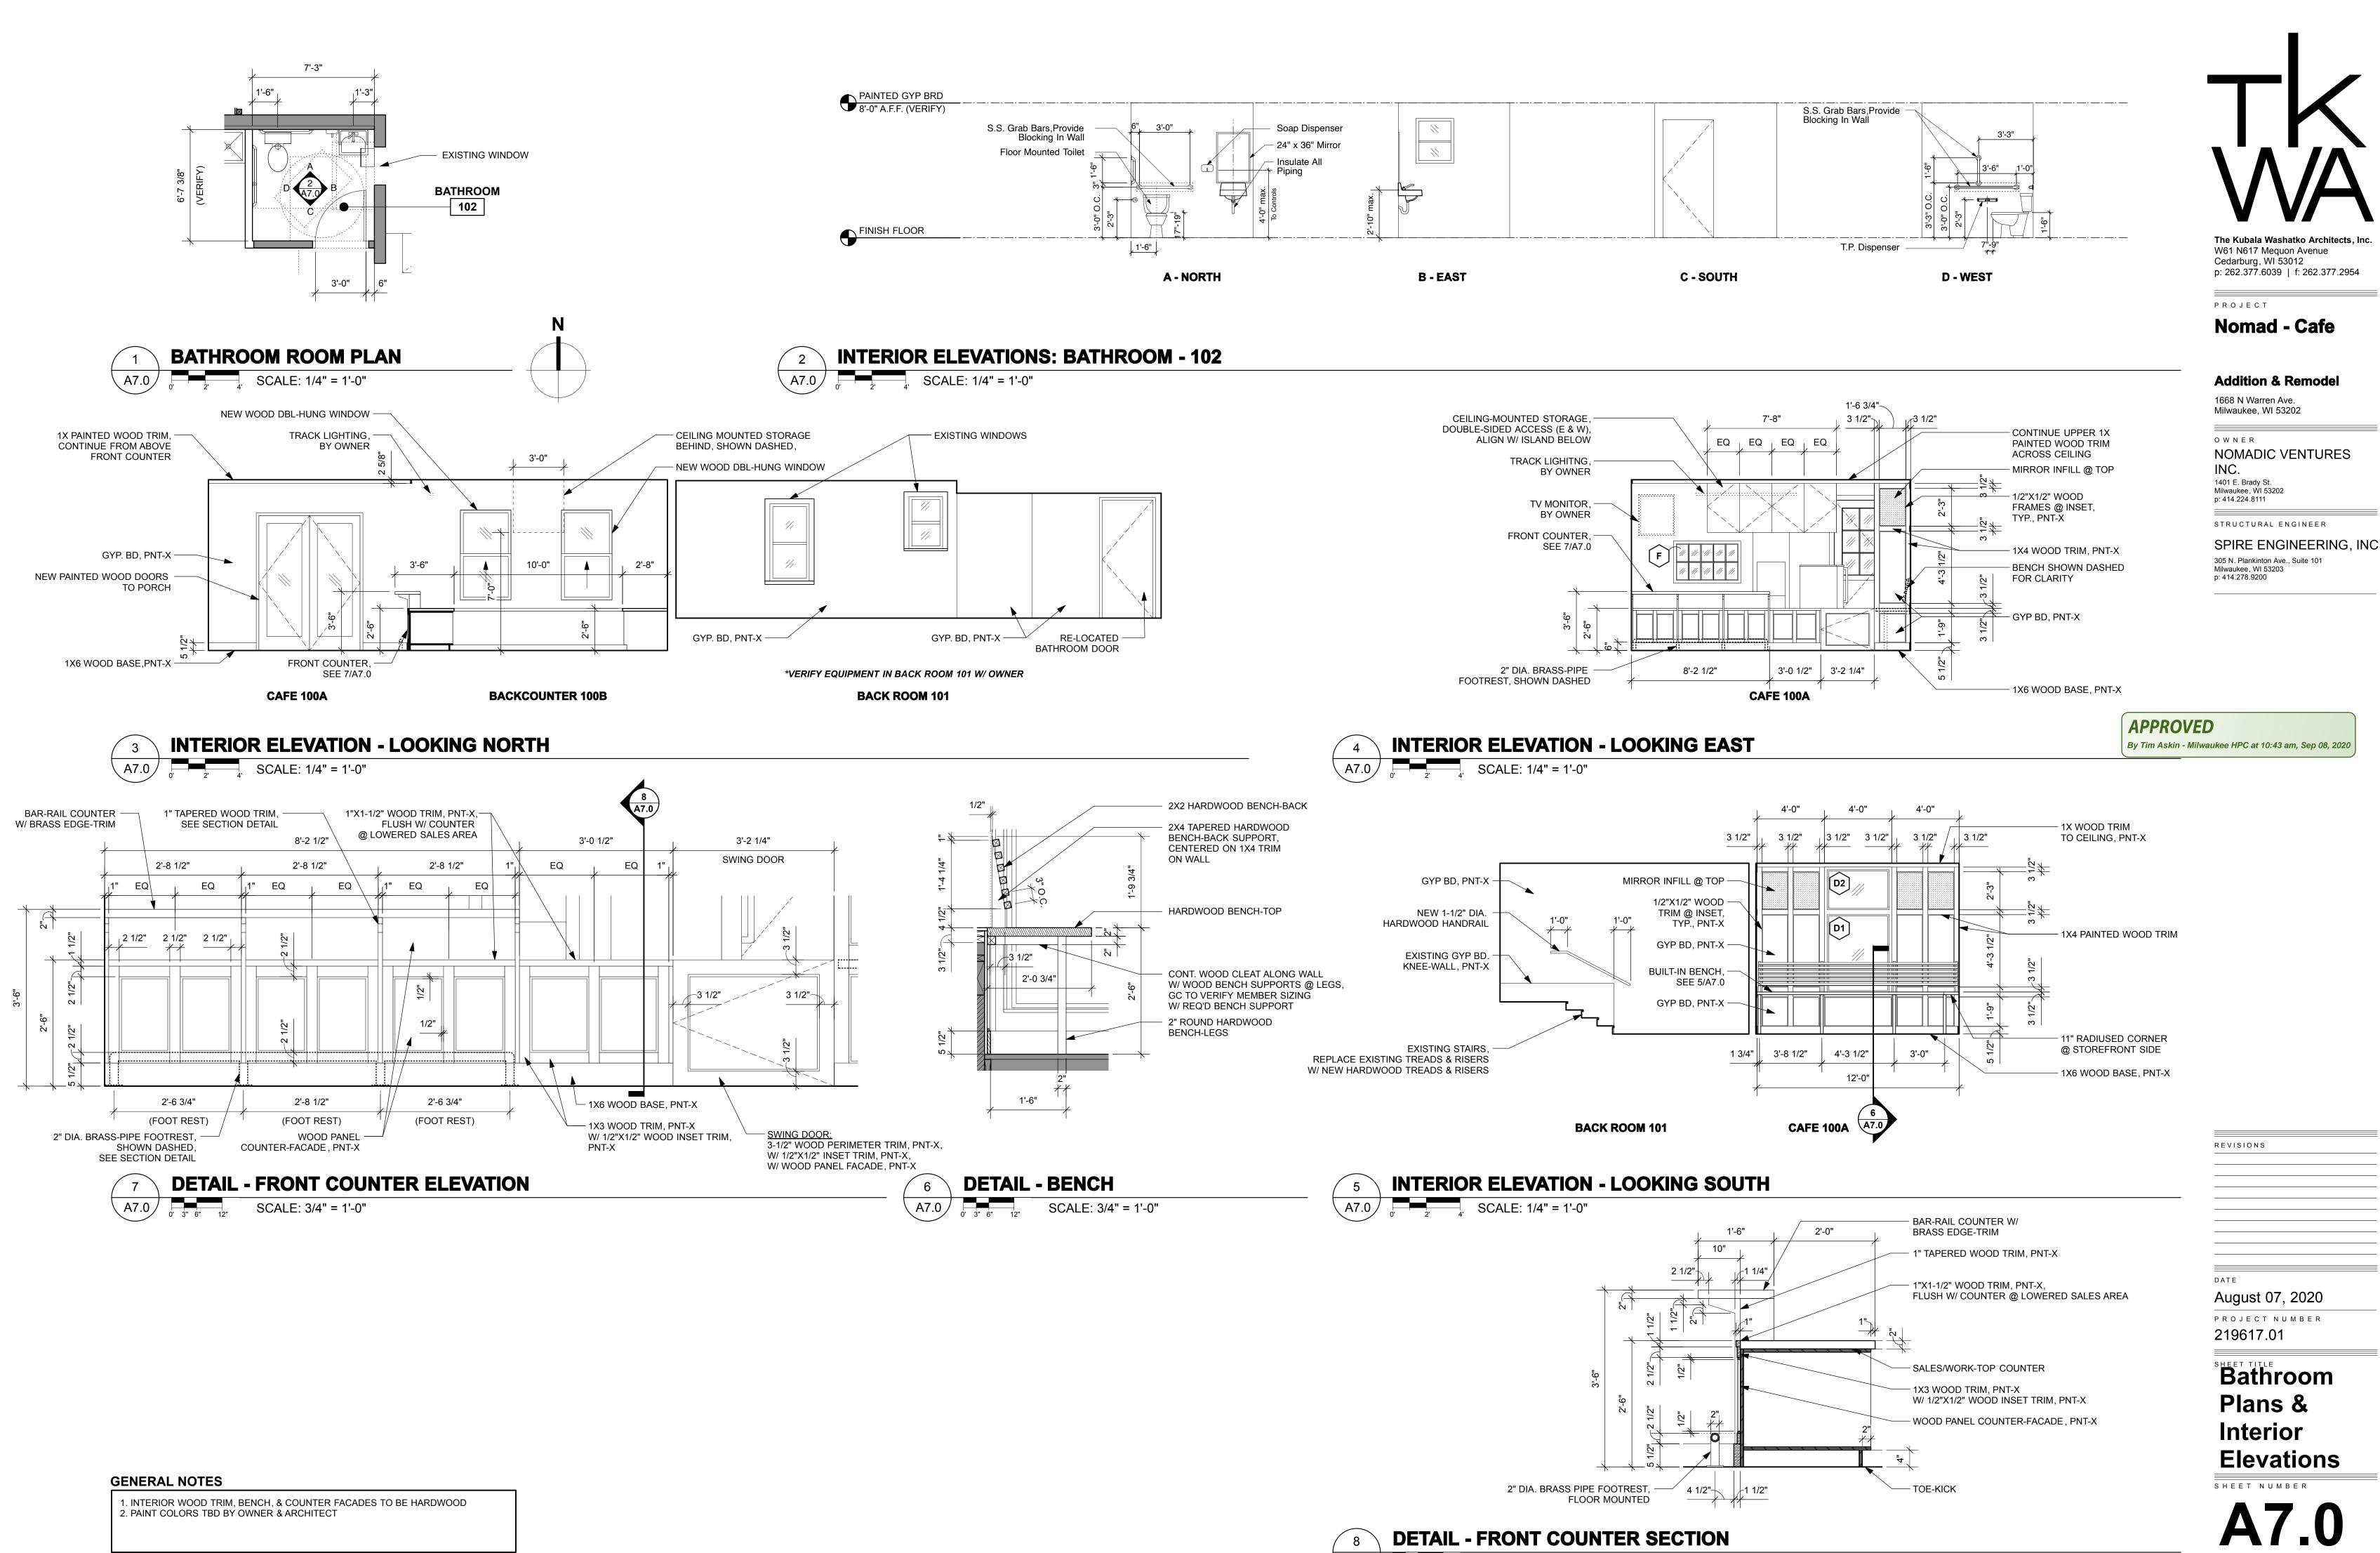









2 CAFE INTERIOR - FRONT COUNTER
A7.1 SCALE: NTS

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August 07, 2020

project number 219617.01

SHEET TITLE


Reference 3D Views

SHEET NUMBER


GENERAL NOTES

1. MODEL VIEWS SHOWN FOR REFERENCE/CLARIFICATION OF INTENT ONLY. REFER TO DRAWINGS FOR DETAILS/DIMENSIONS.

DOOR TYPES

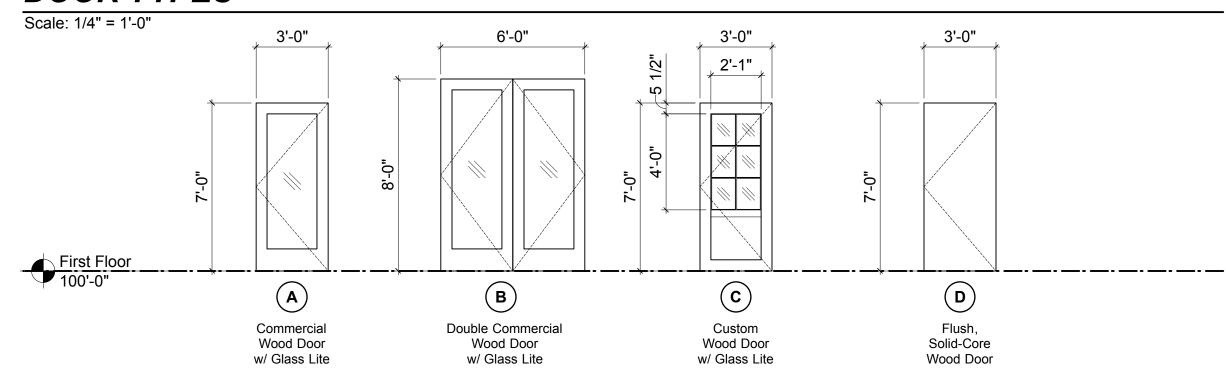

WINDOW TYPES

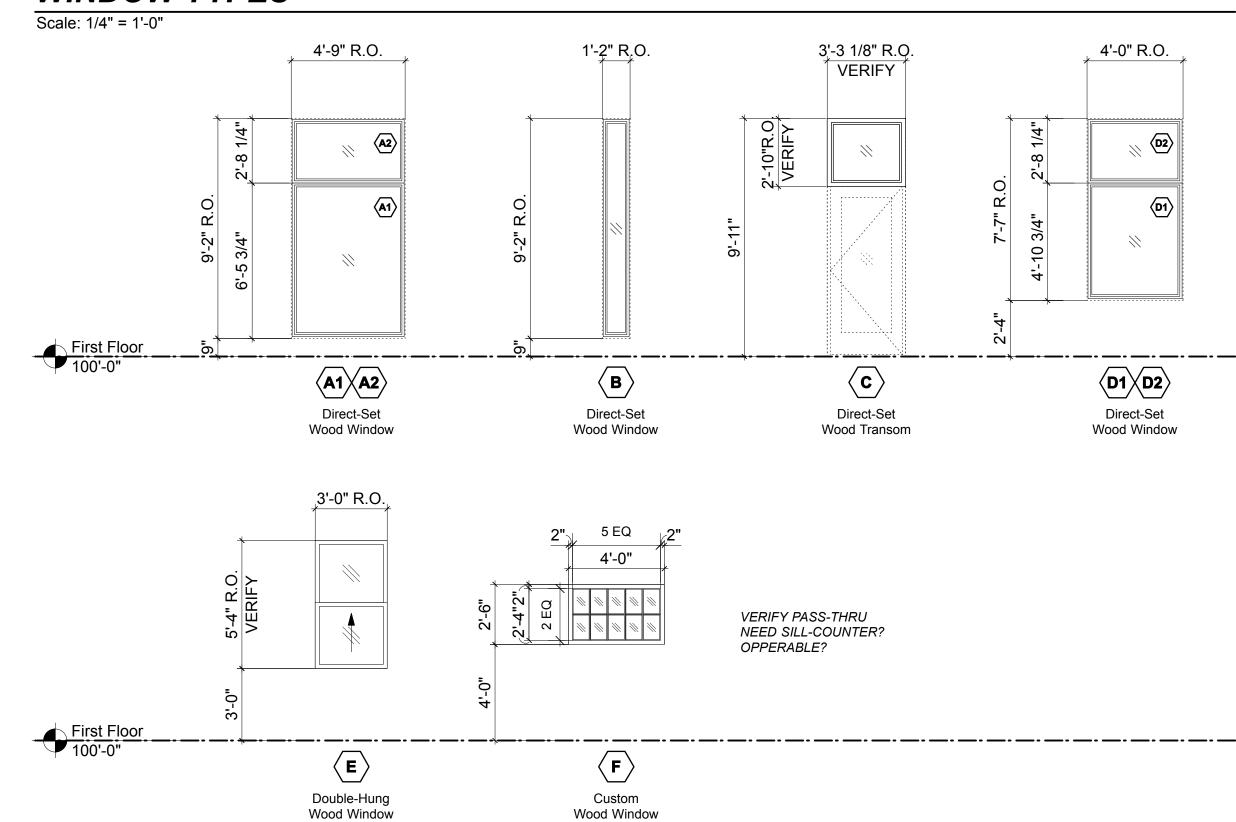

DOOR SCHEDULE

	LOCATION			DOOR						FRAME					INFORMATION		
				SIZE									DETAIL NO.				
DOOR No.	ROOM NAME OR DESCRIPTION	ROOM No.	WIDTH	HEIGHT	1	DOOR TYPE	MATERIAL	FINISH	GLAZING	TYPE	MAT.	HEAD	JAMB	SILL	LABEL	HDWR GROUP	SCHED. NOTES
100	CAFE	100A	3'-0"	7'-0"		Α	WOOD	PNT	ISG	WD	WD	2/A6.1	3/A6.0	1/A6.1		2	
101	BACK ROOM	101	3'-0"	7'-0"		С	WOOD	PNT	ISG	WD	WD	15/A6.0	14/A6.0 <i>SIM</i>			4	
102	BATHROOM	102	3'-0"	7'-0"		D	WOOD	STN		WD	WD	10/A6.1	10/A6.1			5	
103	RAMP	103B	3'-0"	7'-0"		Α	WOOD	PNT	ISG	WD	WD	15/A6.0	14/A6.0	7/A6.1		1	
107	PORCH	107A	6'-0"	8'-0"		В	WOOD	PNT	ISG	WD	WD	5/A6.1	4/A6.1	6/A6.1		3	

DOOR HARDWARE:

*VERIFY HARDWARE W/ OWNER

- 1. EXIT DEVICE (DOG OPEN CAPABLE), CYLINDER, DEADLATCH, PULL, CLOSER, FLOORSTOP, THRESHOLD, DOOR SHOE, WEATHER STRIP, PROXIMITY READER, ELEC. STRIKE, KICKPLATE
- 2. EXIT DEVICE (DOG OPEN CAPABLE), CYLINDER, DEADLATCH, PULL, CLOSER, FLOORSTOP, THRESHOLD, DOOR SHOE, WEATHER STRIP, KICKPLATE
- 3. BUTTS, LOCKSET: PRIVACY, CYLINDER, DEADLATCH, CLOSER, THRESHOLD, DOOR SHOE, WEATHER STRIP, KICKPLATE, WALLSTOP
- 4. BUTTS, LOCKSET: STORAGE, CLOSER, KICKPLATE, WALL STOP
- 5. BUTTS, LOCKSET: PRIVACY(THUMBTURN DEADBOLT W/ OCCUPANCY INDICATOR), PUSH/PULL, CLOSER(DELAY
- ACTION), KICKPLATE, WALL STOP

NOTES: KEY INTO OWNER'S GRAND MASTER KEY SYSTEM,

- ALL DOORS USED IN CONNECTION WITH EXITS SHALL BE SO ARRANGED AS TO BE READILY OPENED WITHOUT THE USE OF A KEY FROM THE SIDE FROM WHICH EGRESS IS MADE.
- GENERAL FINISHES: STAINLESS STEEL
- MANUFACTURERS:
- PUSH/PULLS ASSA ABLOY MCKINNEY, HAGER CO, HIAWATHA INC, IVES EXIT DEVICE - ASSA ABLOY CORBIN RUSSWIN, DORMA, VON DUPRIN
- CLOSERS ASSA ABLOY NORTON, DOMRA, LCN

GENERAL DOOR NOTES:

- A. VERIFY ALL R.O. SIZES IN FIELD
- **B.** GLAZING: ISG INSULATED SAFETY GLASS, DOUBLE PANE C. EXTERIOR DOORS TO HAVE WEATHER STRIPPING
- **D.** DOORS TO HAVE FLUSH BOTTOM, NOT GROOVED
- **E.** DOOR/FRAME FINISHES: ANOD - ANODIZED PNT - PAINT
- PRE PREFINISHED STN - STAINED/SEALED MFR - BY MANUFACTURER
- F. VERIFY COLORS W/ ARCHITECT G. DOORS TO BE INSTALLED ACCORDING TO MFR'S
- RECOMMENDATIONS, GC TO VERIFY DETAILING.

SCHEDULE NOTES:

INC. 1401 E. Brady St. Milwaukee, WI 53202

STRUCTURAL ENGINEER

SPIRE ENGINEERING, INC 305 N. Plankinton Ave., Suite 101 Milwaukee, WI 53203

The Kubala Washatko Architects, Inc.

p: 262.377.6039 | f: 262.377.2954

W61 N617 Mequon Avenue Cedarburg, WI 53012

Nomad - Cafe

Addition & Remodel

NOMADIC VENTURES

1668 N Warren Ave.

Milwaukee, WI 53202

OWNER

p: 414.224.8111

p: 414.278.9200

PROJECT

WINDOW SCHEDULE

							DETAILS		
WINDOW TYPE	MANUFACTURER/ BASIS OF DESIGN	SERIES/ TYPE	COLOR / FINISH	ROUGH OPENING	GLAZING	HEAD	JAMB	SILL	SCHEDULE NOTES
A1	MARVIN	WOOD FIXED	PNT	4'-9" W x 9'-2" H	ISG	5/A6.0	1&2/A6.0	4/A6.0	
A2	MARVIN	WOOD FIXED	PNT	4'-9" W x 9'-2" H	ISG	6/A6.0	1&2/A6.0	5/A6.0	
В	MARVIN	WOOD FIXED	PNT	1'-2" W x 9'-2" H	ISG	6/A6.0	2&3/A6.0	4/A6.0	
С	MARVIN	WOOD FIXED	PNT	3'-3 1/8" W x 2'-10" H	ISG	3/A6.1	3/A6.0 SIM	2/A6.1	1
D1	MARVIN	WOOD FIXED	PNT	4'-0" W x 7'-7" H	ISG	5/A6.0	7/A6.0	8/A6.0	
D2	MARVIN	WOOD FIXED	PNT	4'-0" W x 7'-7" H	ISG	9/A6.0	7/A6.0	5/A6.0	
Е	MARVIN	WD DBL HUNG	PNT	3'-0" W x 5'-4" H	ISG	12/A6.0	10/A6.0	11/A6.0	2
F	CUSTOM	CUSTOM	PNT	4'-0" W x 2'-6" H	ISG	13/A6.0	13/A6.0	13/A6.0	3

SCHEDULE NOTES:

- 1. TRANSOM WINDOW MULLED INTO DOOR BELOW, MATCH WIDTH OF DOOR
- VERIFY W/ NEW DOOR.
- VERIFY R.O. HEIGHT W/ EXISTING SIDING COURSING.
 VERIFY FINAL WINDOW DESIGN/REQUIREMENTS W/ OWNER.

GENERAL WINDOW NOTES: A. CONTRACTOR TO VERIFY ALL DIMENSIONS IN THE FIELD.

- **B.** GLASS (SEE SPECIFICATIONS)
- C. PROVIDE SAFETY GLAZING WHERE REQUIRED BY CODE.

 D. WINDOWS TO BE INSTALLED ACCORDING TO MFR'S RECOMMENDATIONS, GC TO VERIFY DETAILING.

GLASS KEY

	IG	1" INSULATED GLASS UNITS
	ISG	1" INSULATED SAFETY GLASS

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REVISIONS


August 07, 2020

PROJECT NUMBER 219617.01

SHEET TITLE

Door & Window **Schedules**

SHEET NUMBER

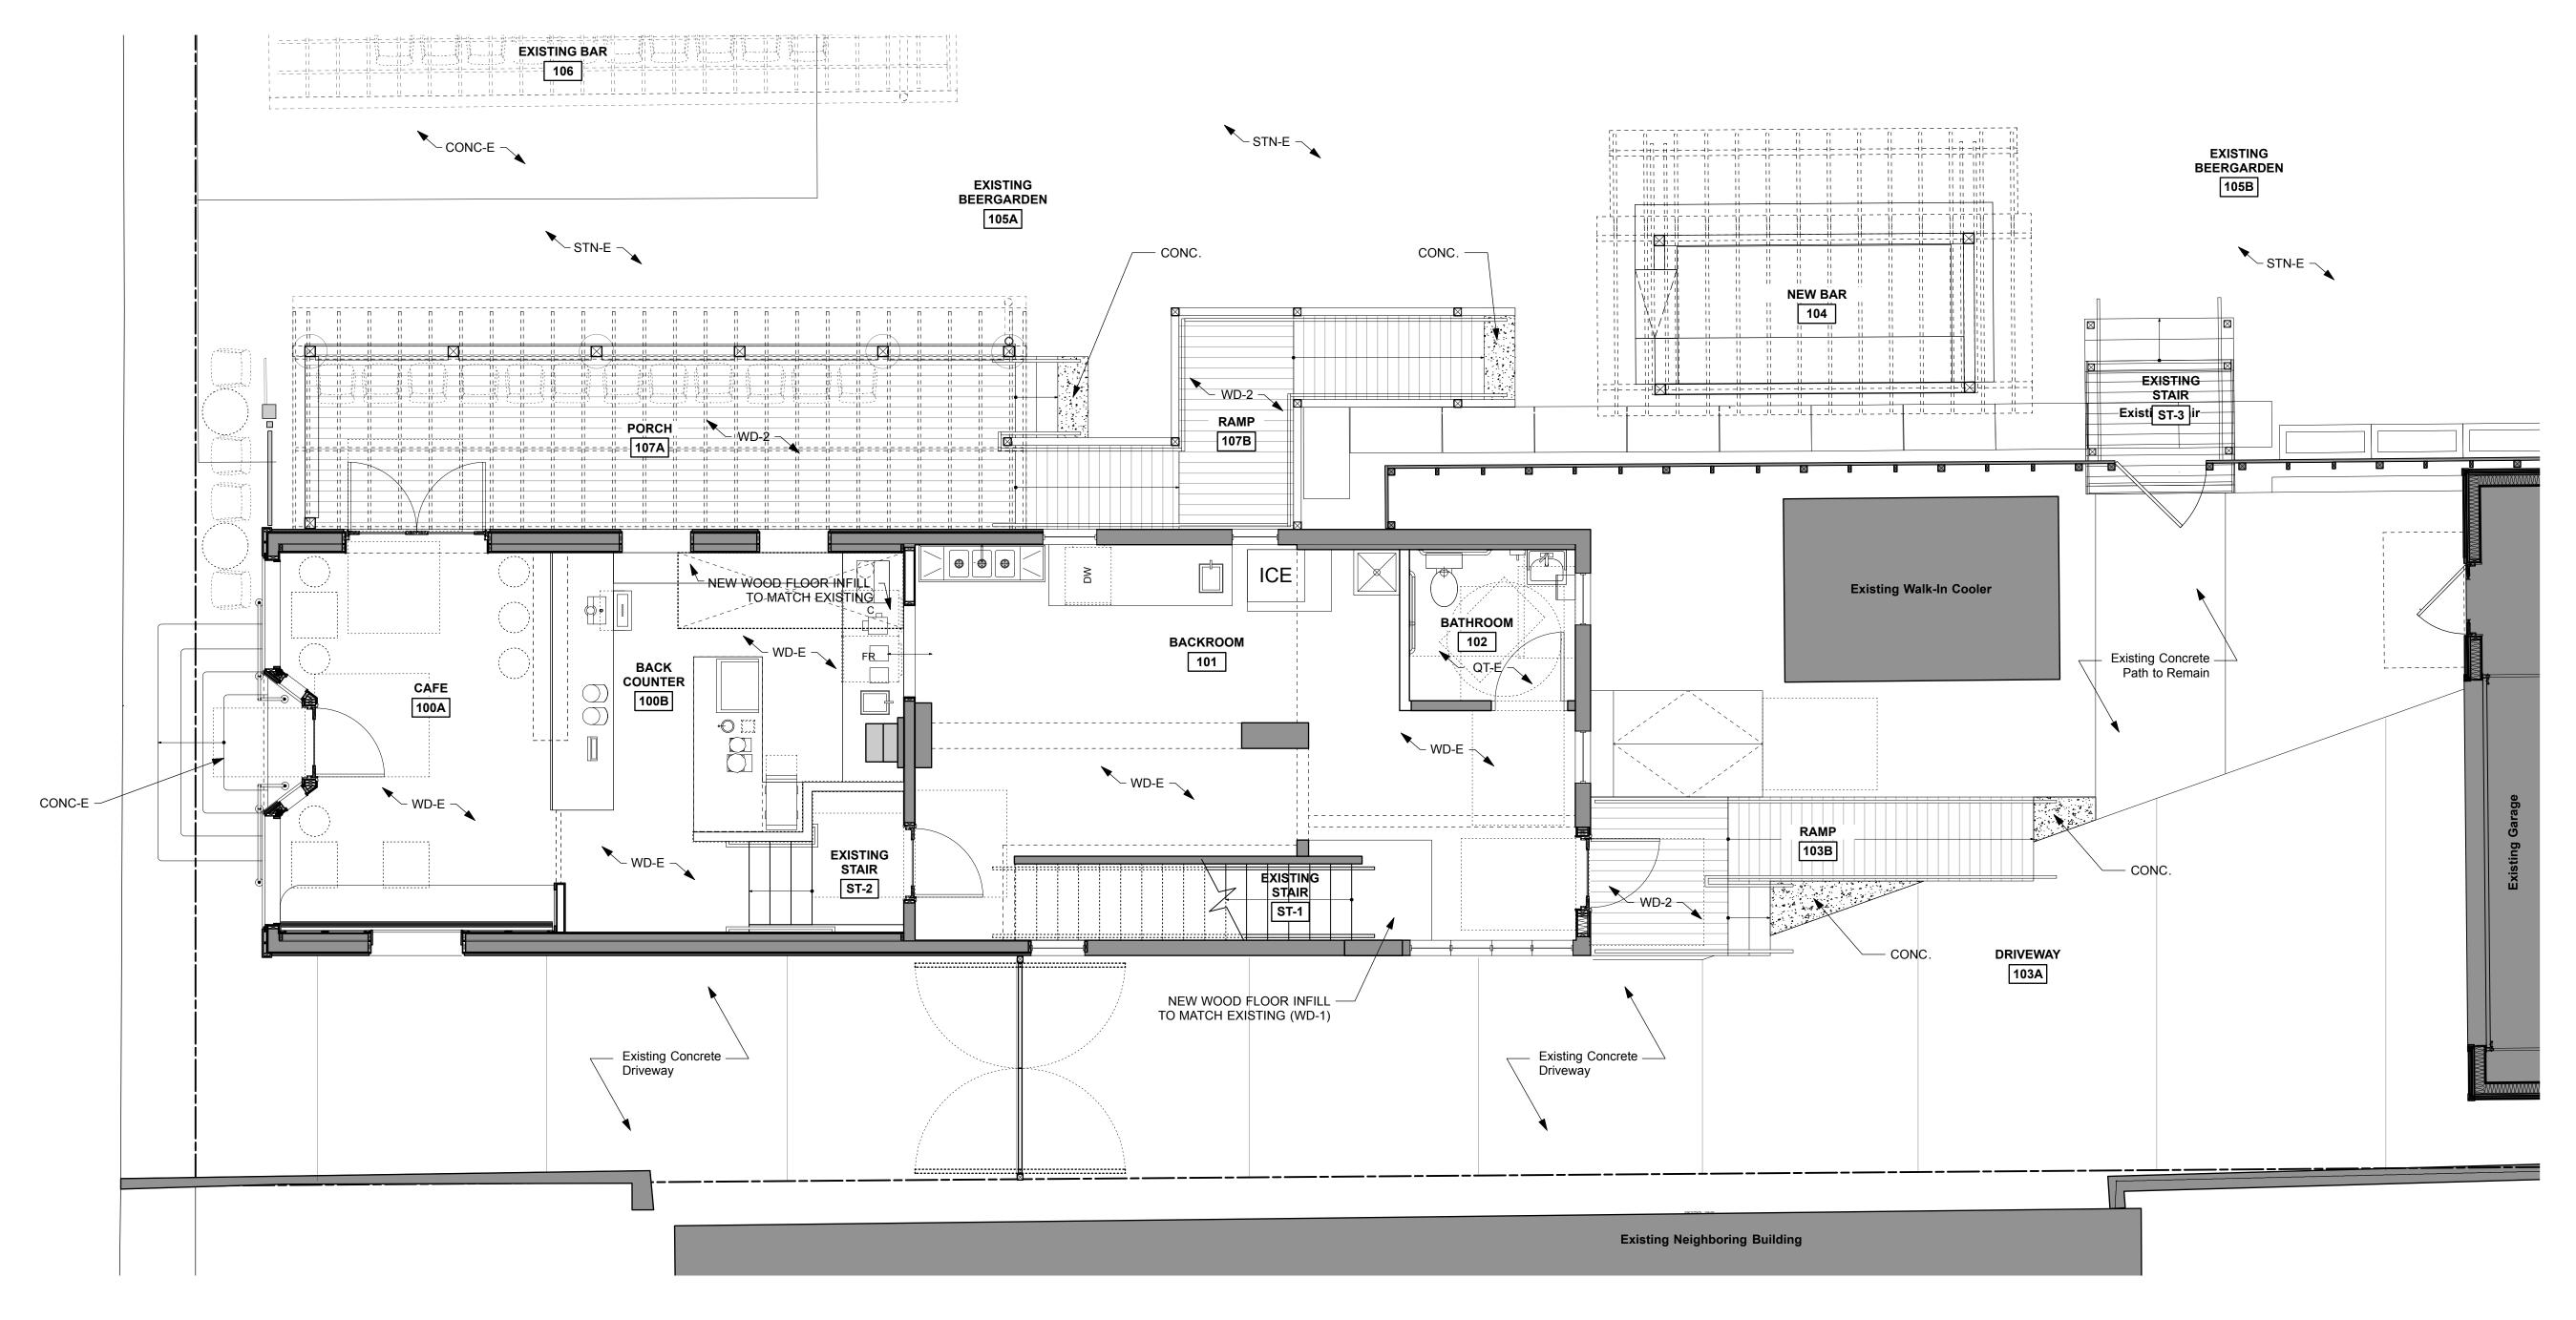



W61 N617 Mequon Avenue Cedarburg, WI 53012 p: 262.377.6039 | f: 262.377.2954

PROJECT

Nomad - Cafe

Addition & Remodel

1668 N Warren Ave. Milwaukee, WI 53202

OWNER NOMADIC VENTURES

1401 E. Brady St. Milwaukee, WI 53202 p: 414.224.8111

p: 414.278.9200

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APPROVED

By Tim Askin - Milwaukee HPC at 10:43 am, Sep 08, 2020

FINISH SCHEDULE

	311 GGITEBGEE									
	LOCATION	BASE	FLOOR	WALLS				CEII	LING	REMARKS
ROOM No.	ROOM NAME OR DESCRIPTION			NORTH	SOUTH	WEST	EAST	MAT'L	FINISH	

FIRST	FLOOR									
100A	CAFE	WB	WD-E	GYP	GYP/WD-3	GYP/WD-3	GYP/WD-3	GYP	PNT	
100B	BACK COUNTER	EB	WD-E	GYP	GYP	-	GYP	GYP	PNT	
101	BACK ROOM	WB	WD-E	GYP/FRP	GYP	GYP/FRP	GYP	GYP	PNT	
102	BATHROOM	WB	QT-E	GYP	GYP	GYP	GYP	GYP	PNT	
103A	DRIVEWAY	-	CONC-E	EXIST	-	-	-	-	-	1
103B	RAMP	-	WD-2	-	-	EXIST	-	-	-	
104	NEW BAR	-	STN-E	-	WD-4	-	-	EXP	PNT	
105A	EXISTING BEERGARDEN	-	STN-E	EXIST	WD-4	-	-	-	-	1
105B	EXISTING BEERGARDEN	-	STN-E	EXIST	EXIST	-	-	-	-	1
106	EXISTING BAR	-	CONC-E	EXIST	_	-	-	EXIST	EXIST	1
107A	PORCH	-	WD-2	GYP	GYP	GYP	GYP	EXP	PNT	
107B	RAMP	-	WD-2	GYP	GYP	GYP	GYP	-	-	
ST-1	EXISTING STAIR	-	EXIST	GYP	GYP	GYP	-	EXIST	PNT	3
ST-2	EXISTING STAIR	WB	WD-E	GYP	GYP	GYP	GYP	GYP	PNT	2
ST-3	EXISTING STAIR	-	EXIST	-			-	-	-	1

GENERAL FINISH NOTES:

- A. NO WORK IN BASEMENT
- B. MATERIAL/PAINT COLOR SELECTIONS TBD BY OWNER & ARCHITECT C. MATERIALS SHALL NOT EXCEED CLASS C FLAME-
- SPREAD RATING AND SMOKE DEVELOPED 0-450.

FINISH SCHEDULE REMARKS:

1. EXISTING CONDITIONS TO REMAIN, NO WORK

2. REPLACE EXISTING STAIR TREADS W/ NEW HARDWOOD TREADS & RISERS 3. NEW HARDWOOD RISERS WHERE MISSING

FINISH SPECIFICATIONS

CONC-E EXISTING EXTERIOR CONCRETE

CONC NEW EXTERIOR CONCRETE INFILL, COORD. ELEVATIONS W/ EXISTING ADJACENT CONCRETE

EPOXY BASE, 6" H

EXISTING CONDITIONS TO REMAIN EXPOSED STRUCTURE ABOVE

FIBER REINFORCED PANEL: VERIFY COLOR W/ OWNER

GYPSUM BOARD

PNT PAINT

EXISTING QUARRY TILE, PATCH/REPAIR AS REQ'D

STAINLESS STEEL

STN-E EXISTING CRUSHED STONE

WOOD BASE: 1X6 PAINTED POPLAR EXISTING WOOD FLOOR, PATCH/REPAIR AS REQ'D

NEW WOOD FLOORING, TO MATCH EXISTING

NEW 2X6 EXTERIOR CEDAR DECK/RAMP, 1/4" GAPS TYP.

1X WOOD TRIM, PNT-X (COLOR TBD BY ARCH), SEE INT. ELEVATIONS

HORIZONTAL 1X4 CEDAR SIDING, 1/4" GAPS TYP., PNT-X

August 07, 2020 PROJECT NUMBER 219617.01

SHEET TITLE

Ground Floor Finish Plan & Schedule


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SHEET NUMBER


SYMBOL KEY








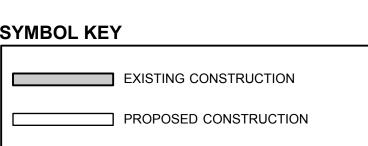

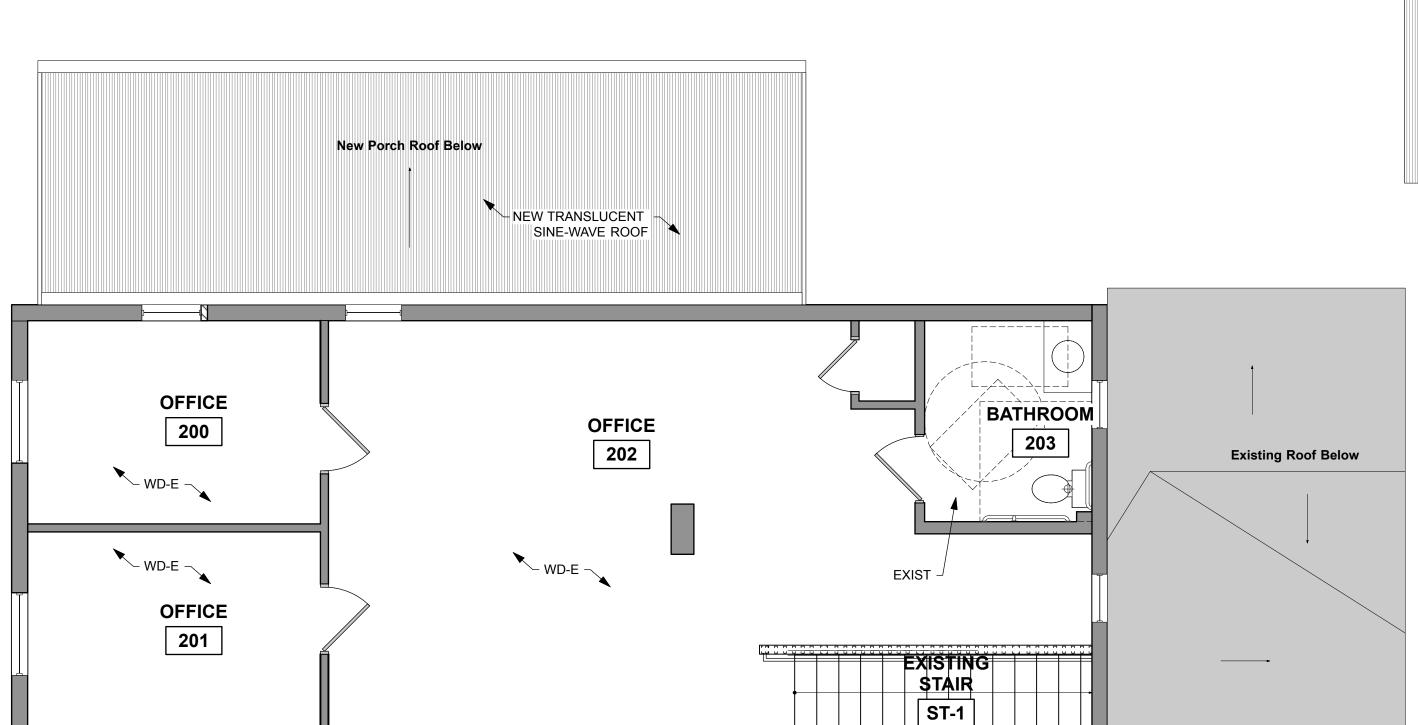

FINISH SCHEDULE REMARKS:

1. NO WORK

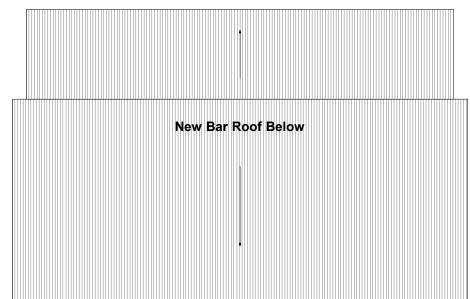

Existing Neighboring Building

FINISH SCHEDULE

	LOCATION	BASE	FLOOR		WA	LLS		CEI	LING	REMARKS
ROOM No.	ROOM NAME OR DESCRIPTION			NORTH	SOUTH	WEST	EAST	MAT'L	FINISH	
SECO	ND FLOOR									
200	OFFICE	EXIST	1							
201	OFFICE	EXIST	1							
202	OFFICE	EXIST	1							
203	BATHROOM	EXIST	1							

GENERAL FINISH NOTES:

- A. NO WORK IN BASEMENT
- B. MATERIAL/PAINT COLOR SELECTIONS TBD BY OWNER & ARCHITECT
- C. MATERIALS SHALL NOT EXCEED CLASS C FLAME-
- SPREAD RATING AND SMOKE DEVELOPED 0-450.

FINISH SPECIFICATIONS

CONC-E EXISTING EXTERIOR CONCRETE

CONC NEW EXTERIOR CONCRETE INFILL, COORD. ELEVATIONS W/ EXISTING ADJACENT CONCRETE

EPOXY BASE, 6" H

EXISTING CONDITIONS TO REMAIN

EXPOSED STRUCTURE ABOVE FIBER REINFORCED PANEL: VERIFY COLOR W/ OWNER

GYPSUM BOARD

PNT PAINT

EXISTING QUARRY TILE, PATCH/REPAIR AS REQ'D

STAINLESS STEEL STN-E EXISTING CRUSHED STONE

WOOD BASE: 1X6 PAINTED POPLAR

EXISTING WOOD FLOOR, PATCH/REPAIR AS REQ'D

NEW WOOD FLOORING, TO MATCH EXISTING

NEW 2X6 EXTERIOR CEDAR DECK/RAMP, 1/4" GAPS TYP.

1X WOOD TRIM, PNT-X (COLOR TBD BY ARCH), SEE INT. ELEVATIONS

HORIZONTAL 1X4 CEDAR SIDING, 1/4" GAPS TYP., PNT-X



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PROJECT

Nomad - Cafe

Addition & Remodel

1668 N Warren Ave.

Milwaukee, WI 53202

Milwaukee, WI 53202

p: 414.224.8111

OWNER NOMADIC VENTURES 1401 E. Brady St.

STRUCTURAL ENGINEER

SPIRE ENGINEERING, INC

305 N. Plankinton Ave., Suite 101 Milwaukee, WI 53203 p: 414.278.9200


August 07, 2020 PROJECT NUMBER

219617.01

SHEET TITLE Second Floor Finish Plan & Schedule

SHEET NUMBER

PLAN N

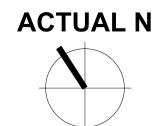

REINFORCING NOTES

- 1. REINFORCING SHALL BE DETAILED IN ACCORDANCE WITH ACI 315 (CURRENT EDITION).
- 2. ALL LAPS SHALL BE CLASS 'B' PER ACI 318 UNLESS OTHERWISE NOTED ON THE DESIGN DRAWINGS, OR UNLESS THE DETAILER TAKES SPECIAL CARE TO PROVIDE STAGGERED LAPS. USE TOP BAR LAP LENGTHS FOR ALL HORIZONTAL WALL BARS AND FOR TOP BARS IN SLABS AND BEAMS OVER 12 INCHES DEEP.
- 3. LAP LENGTH SHALL BE SPECIFICALLY NOTED ON PLACING DRAWINGS WHERE MORE THAN ONE BAR MAKES UP A CONTINUOUS STRING.
- 4. CORNER BARS WITH CLASS 'B' PER ACI 318 LAPS SHALL BE PROVIDED AT ALL WALL CORNERS AND INTERSECTIONS PER DETAIL 1/S2.0.
- 5. HORIZONTAL BARS, EXCEPT FOR CONTINUOUS STRINGS FROM ONE CORNER OF OPENING TO ANOTHER, SHALL BE DETAILED TO SHOW THE DISTANCE FROM AT LEAST ONE END OF THE BAR TO THE NEAREST BUILDING GRID LINE OF WALL.
- 6. WELDED WIRE FABRIC SHALL BE LAPPED AND/OR ANCHORED TO DEVELOP Fy PER ACI 315.



7. PROVIDE MINIMUM COVER PER ACI318, 7.7.1.

COLD WEATHER CONCRETING NOTES

- 1. SNOW, FROST, AND ICE SHALL BE REMOVED FROM ALL SURFACES, INCLUDING REINFORCING, AGAINST WHICH THE CONCRETE IS TO BE PLACED.
- 2. DO NOT PLACE CONCRETE ON FROZEN SUBGRADE.
- 3. THE MINIMUM PLACEMENT AND PROTECTION TEMPERATURE OF CONCRETE SHALL BE AS FOLLOWS:

	MINIMUM TEMP OF CONCRETE
	AS PLACED AND MAINTAINED
	DURING PROTECTION PERIOD
LEAST DIMENSION OF SECTION	(DEGREES FAHRENHEIT)
LESS THAN 12"	55
12" TO LESS THAN 36	50
36" TO 72"	45
GREATER THAN 72"	40

- 4. TEMPERATURES OF CONCRETE SHALL BE MEASURED AT THE CONCRETE SURFACE.
- 5. HEATED AIR TEMPERATURES SHALL NOT EXCEED THE REQUIRED CONCRETE TEMPERATURES LISTED IN TABLE ABOVE BY MORE THAN 20 DEGREES.
- 6. CONCRETE SHALL BE CURED AND PROTECTED AGAINST DAMAGE FROM FREEZING FOR A MINIMUM PERIOD OF 3 DAYS.
- 7. DURING PERIODS NOT DEFINED AS COLD WEATHER, BUT WHEN FREEZING TEMPERATURES MAY OCCUR, PROTECT CONCRETE SURFACES FROM FREEZING FOR THE FIRST 24 HOURS AFTER
- 8. IF TEMPERATURE REQUIREMENTS DURING PROTECTION PERIOD ARE NOT MET, BUT CONCRETE WAS PREVENTED FROM FREEZING, CONTACT STRUCTURAL ENGINEER FOR EXTENT OF ADDITIONAL PROTECTION TIME REQUIRED.

HOT WEATHER CONCRETING NOTES

- 1. CONCRETE MIXES TO BE PLACED DURING DRY AND WINDY CONDITIONS SHALL BE MODIFIED BY THE ADDITION OF RETARDING ADMIXTURES OR SLOWER CURING CEMENT SUBSTITUTES TO MINIMIZE THE EFFECTS OF ACCELERATED CURING.
- 2. WATER SHALL NOT BE ADDED TO CONCRETE MIXES ON SITE FOR WORKABILITY. MID OR HIGH RANGE WATER REDUCERS SHALL BE APPROVED BY STRUCTURAL ENGINEER BEFORE ADDING TO CONCRETE MIX FOR INCREASED WORKABILITY.
- INGREDIENTS USED IN CONCRETE MIXES SHALL BE COOLED TO MAINTAIN A CONCRETE TEMPERATURE BELOW 90 DEGREES FAHRENHEIT AT TIME OF PLACEMENT.
- 4. CHILLED WATER AND CHOPPED ICE MAY BE USED IN CONCRETE MIXTURES TO CONTROL CONCRETE TEMPERATURES. AMOUNT OF CHOPPED ICE SHALL NOT EXCEED THE EQUIVALENT AMOUNT OF MIXING WATER REQUIRED FOR THE DESIGN MIX.
- 5. RETARDING ADMIXTURES SHALL NOT BE USED IN CONCRETE MIXES WITHOUT THE APPROVAL OF THE STRUCTURAL ENGINEER.

CAST-IN-PLACE CONCRETE NOTES

- 1. ALL WORK TO BE DONE IN ACCORDANCE WITH ACI 318 BUILDING CODE REQUIREMENTS FOR REINFORCED CONCRETE (MOST CURRENTLY ADOPTED EDITION).
- 2. CONTRACTOR SHALL NOTIFY THE STRUCTURAL ENGINEER AT LEAST 48 HOURS PRIOR TO PLACING CONCRETE TO FACILITATE ON SITE OBSERVATION OF REBAR.
- 3. ARRANGEMENT AND BENDING OF REINFORCING STEEL SHALL BE IN ACCORDANCE WITH ACI DETAILING MANUAL (ACI SP-66), LATEST EDITION.
- 4. WHEN THE AVERAGE TEMPERATURE FROM MIDNIGHT TO MIDNIGHT IS EXPECTED TO DROP BELOW 40 DEGREES FAHRENHEIT FOR THREE SUCCESSIVE DAYS, COLD WEATHER CONCRETING REQUIREMENTS SHALL BE FOLLOWED (REFER TO ACI 306R). SEE ALSO COLD WEATHER
- WHEN AMBIENT AIR OR CONCRETE TEMPERATURES EXCEED 90 DEGREES FAHRENHEIT, STEEL REINFORCING AND/OR FORMING SURFACES ARE ABOVE 120 DEGREES, OR WHEN WIND VELOCITY, HUMIDITY, OR SOLAR RADIATION CREATE CONDITIONS OF ACCELERATED MOISTURE LOSS AND INCREASED RATE OF HYDRATION, HOT WEATHER CONCRETING REQUIREMENTS SHALL BE FOLLOWED (REFER TO ACI 305R). SEE ALSO HOT WEATHER CONCRETING NOTES.
- 6. ALL CONCRETE SURFACES SHALL BE FORMED UNO OR APPROVED BY THE STRUCTURAL
- 7. PROVIDE A 3/4" CHAMFER ON EXPOSED CORNERS OF CONCRETE UNO. TOP EDGES OF FINISHED WALLS SHALL BE TOOLED UNO.
- 8. CONTROL JOINTS SHALL BE PLACED IN SLAB ON GRADE CONSTRUCTION WITHIN 24 HOURS OF
- 9. SLEEVES, CONDUITS, OR PIPES THROUGH SLABS AND WALLS SHALL BE PLACED AT THREE DIAMETERS ON CENTER, OR 4" MINIMUM...
- 10. ALUMINUM CONDUIT OR PIPING SHALL NOT BE CAST IN CONCRETE.

CONCRETING NOTES.

MILD REINFORCING STEEL MINIMUM CLEAR COVER

WIED IVENIA STORY	
CONCRETE CAST AGAINST EARTH AND PERMANENTLY EXPOSED TO EARTH: FOOTINGS:	3"
CONCRETE EXPOSED TO EARTH OR WEATHER: WALLS, SONOTUBES:	
UP THROUGH #5 BARS	1 ½"
#6 THRU #18 BARS	2"
(DIMENSIONS ABOVE ARE MINIMUMS, UNLESS NOTED OTHERWISE IN DET	AILS)

MATERIAL DESIGN PROPERTIES

CONCRETE STRENGTHS: FOOTINGS SLAB ON GRADE	fc = 3000 psi fc = 4000 psi
REINFORCING STEEL STRENGTHS:	
BARS (ASTM A 615, grade 60)	Fy = 60,000 psi
WWF (ASTM A 185)	Fy = 65,000 psi
STRUCTURAL STEEL STRENGTHS:	
WF SHAPES (ASTM A992)	Fy = 50,000 psi
ANGLES, CHANNELS, PLATES, & BARS (ASTM A36)	Fy = 36,000 psi
SQUARE & RECTANGULAR TS OR HSS SECTIONS	Fy = 46,000 psi
(ASTM A500, grade B)	•
ROUND HSS SECTIONS (ASTM A500, grade B)	Fy = 42,000 psi
STEEL PIPE (ASTM A53, grade B)	Fy = 35,000 psi
HIGH STRENGTH BOLTS (ASTM A325)	
ANCHOR BOLTS (ASTMF1554)	Fy=36,000 psi
WELD ELECTRODES	E70XX
HEADED WELDED STUDS (ASTM A108)	Fu=55,000 psi
HP PILES (ASTM A572, GRADE 50)	Fy=50,000 psi
WOOD OTDENOTUO	
WOOD STRENGTHS:	
WOOD MEMBERS USED FOR THIS PROJECT SHALL BE OF THE	
AT A MINIMUM. HIGHER GRADES INDICATED IN PLANS OR SCH	1EDULES GOVERN OVER THESE

WUM. HIGHER GRADES INDICATED IN PLANS OR SCHEDULES GOVERN OVER THESE MINIMUMS. DIMENSIONAL LUMBER:

WALL STUDS AND HEADERS SEE PLAN AND SCHEDULES INTERIOR BEAMS AND JOISTS SPECIES: DOUGLAS FIR-LARCH GRADE: STRENGTH PROPERTIES E = 1,600 ksi Fb = 900 psi Fv = 180 psi Fc (perp) = 625 psi EXTERIOR PATIO BEAMS AND JOISTS SPECIES: SOUTHERN PINE (PRESSURE TREATED) GRADE: No.1 LAMINATED VENEER LUMBER: E = 1,900 ksi

> Fb = 2,600 psi Fv = 285 psi

Fv = 400 psi

#4 29

43

CONCRETE REINF. SPLICE LENGTH TABLE NOTES:

ALL REINFORCEMENT ASSUMED UNCOATED.

2. FOR COMPRESSION LAPS ONLY, Fy ≤ 60,000 PSI, F'c ≥ 3,000 PSI

GENERALLY NOT PERMITTED

3. F'c = 3,000 PSI4. F'c = 4,000 PSI

Fc(perp) = 750 psi

Fc(para) = 1,950 psi

Fc(perp) = 750 psi

Fc(para) = 2,510 psi

PARALLEL STRAND LUMBER: E = 2,000 ksi

Fb = 2,900 psiFv = 290 psi Fc(perp) = 750 psiFc(para) = 2,900 psi LAMINATED STRAND LUMBER: E = 1,500 ksiFb = 2,250 psi

DESIGN DATA

1.00

SUBMITTAL NOTES

ENGINEER FOR REVIEW. ONE ELECTRONIC (PDF) OR THREE HARD COPIES SHALL BE SUBMITTED IN A

TIMELY MANNER PRIOR TO MATERIAL FABRICATION OR CONSTRUCTION TO ALLOW FOR A MINIMUM

THE FOLLOWING INFORMATION SHALL BE SUBMITTED TO THE ARCHITECT AND STRUCTURAL

CERTIFIED COPIES OF MIX DESIGNS FOR EACH CONCRETE CLASS SPECIFIED

1. SUBMIT SHOP DRAWINGS FOR FABRICATION, BENDING AND PLACEMENT OF CONCRETE

REINFORCEMENT SHOWING BAR SCHEDULES, STIRRUP SPACING, DIAGRAMS OF BENT

BARS, SPLICING ARRANGEMENT AND ASSEMBLIES AS REQUIRED FOR THE FABRICATION

DESIGN CODE:
2015 IBC WITH 2018 WISCONSIN AMENDMENTS

BUILDING OCCUPANCY CATEGORY

WIND LOAD IMPORTANCE FACTOR (Iw)

PERIOD OF TEN WORKING DAYS FOR REVIEW.

CONCRETE REINFORCEMENT SHOP DRAWINGS:

INCLUDING COMPRESSIVE STRENGTH TEST REPORTS.

AND PLACEMENT OF CONCRETE REINFORCEMENT.

WIND LOAD INFORMATION BASIC WIND SPEED

WIND EXPOSURE

CONCRETE MIX DESIGNS

CONCRETE REINFORCING SPLICE LENGTH TABLE

CONCRETE REINFORCING SPLICE LENGTH TABLE PER ACI 318-05 - (INCHES)

FTG⁽³⁾ GRADE BEAM⁽⁴⁾ GRADE BEAM⁽⁴⁾ WALL⁽⁴⁾ WALL⁽⁴⁾ WALL⁽⁴⁾ SLAB⁽⁴⁾ BEAM⁽⁴⁾ (TOP) (BOTT)

CONCRETE MEMBER

18 | 18 | 18 | 24 | 18 | 12

25 | 25 | 25 | 32 | 25 | 15

31 | 31 | 31 | 40 | 31 | 19

37 37 37 48 37 23

62 | 62 | 62 | 80 | 62 | 30

70 70 70 90 70 34

77 | 77 | 77 | 100 | 77 | 38

85 85 85 110 85 41

(1) (1) (1) (1) 53

(1) (1) (1) (1) 68

SNOW LOAD INFORMATION: GROUND SNOW LOAD (Pg) SNOW EXPOSURE FACTOR (Ce) SNOW LOAD IMPORTANCE FACTOR (Is) THERMAL FACTOR (Ct)

FLAT ROOF SNOW LOAD (Pf) DESIGN/BALANCED SNOW LOAD (Ps) SOIL LOAD INFORMATION:

ALLOWABLE NET SOIL BEARING PRESSURE

Qa = 2500 psf

30 psf

1.00

1.00

25 psf

30 psf

(TO BE FIELD VERIFIED)

(APPLY TO ALL FRAMING DRAWINGS)

1. ARCHITECT AND CONTRACTOR SHALL DETAIL AND CONSTRUCT BUILDING FINISHES TO ACCOMMODATE $\frac{3}{16}$ " TO $\frac{3}{8}$ " OF EXPECTED WOOD SHRINKAGE PER FLOOR OF WOOD CONSTRUCTION. LUMBER SHALL NOT BE STORED IN STANDING WATER AND INSTALLED LUMBER THAT HAS BEEN EXPOSED TO THE ELEMENTS SHALL BE DRIED SUFFICIENTLY BEFORE INTERIOR OR EXTERIOR FINISHES ARE APPLIED TO AVOID CRACKING/CRUSHING.

WOOD FRAMING NOTES

- 2. ROOF SHEATHING: 5/8" TONGUE AND GROOVE APA RATED WOOD SHEATHING (PLYWOOD OR OSB). ATTACH SHEATHING TO ROOF FRAMING MEMBERS WITH 8d (2½") COMMON OR BOX NAILS @ 6" O.C. ALONG PANEL EDGES 12" O.C. ALONG INTERMEDIATE MEMBERS. DISTANCE OF NAILS FROM EDGE OF SHEATHING SHALL BE 3/8". STAGGER ALL SHEATHING JOINTS.
- 3. ALL CONNECTIONS SHALL COMPLY WITH IBC 2009 TABLE 2304.9.1 FASTENING SCHEDULE, SEE SHEET SO.1. DETAILS IN DRAWINGS WITH MORE EXTENSIVE CONNECTIONS SHALL GOVERN OVER THOSE SHOWN IN TABLE.
- 4. FOR ALL WOOD MEMBERS THAT FRAME INTO OTHER MEMBERS AND WHERE NOT SPECIFICALLY DETAILED OR SPECIFIED IN THE DRAWINGS, USE AN APPROPRIATE SIMPSON STRONG TIE HANGER SELECTED FOR ACTUAL END REACTION. CONTACT ENGINEER FOR END REACTION IF NECESSARY.

LOCATION

FASTENING

3 - 8d COMMON

TOENAIL

IBC 2009 TABLE 2304.9.1MINIMUM FASTENING SCHEDULE, UNO

CONNECTION TYPE

JOIST TO SILL OR GIRDER

١.	JOIOT TO GILL OIL GINDLIN.	IOLIVAIL	3 - 00 OOMMON
2.	BRIDGING TO JOIST.	TOENAIL EA END	2 - 8d COMMON
3.	1"x6" SUBFLOOR OR LESS TO EACH JOIST.	FACE NAIL	2 - 8d COMMON
4.	WIDER THAN 1"x6" SUBFLOOR TO EACH JOIST.	FACE NAIL	3 - 8d COMMON
5.	2" SUBFLOOR TO JOIST OR GIRDER.	BLIND AND FACE NAIL	2 - 16d COMMON
6.	SOLE PLATE TO JOIST OR BLOCKING. SOLE PLATE TO JOIST OR BLOCKING.	TYPICAL FACE NAIL AT BRACED WALL PANELS	16d @ 16" OC 3 - 16d @ 16" OC
7.	TOP PLATE TO STUD.	END NAIL	2 - 16d COMMON
8.	STUD TO SOLE PLATE.	TOENAIL END NAIL	4 - 8d COMMON 2 - 16d COMMON
9.	DOUBLE STUDS.	FACE NAIL	16d @ 24" OC
10.	DOUBLE TOP PLATES. DOUBLE TOP PLATES.	TYPICAL FACE NAIL LAP SPLICE	16d @ 16" OC 8 - 16d COMMON, U.N.O.
11.	BLOCKING BETWEEN JOISTS OR RAFTERS TO TOP PLATE.	TOENAIL	3 - 8d COMMON
12.	RIM JOIST TO TOP PLATE.	TOENAIL	8d @ 6" OC
13.	TOP PLATES, LAPS & INTERSECTIONS.	FACE NAIL	2 - 16d COMMON
14.	CONTINUOUS HEADER, TWO PIECES.	16" OC ALONG EDGE	16d COMMON
15.	CEILING JOISTS TO PLATE.	TOENAIL	3 - 8d COMMON
16.	CONTINUOUS HEADER TO STUD.	TOENAIL	4 - 8d COMMON
17.	CEILING JOISTS, LAPS OVER PARTITIONS.	FACE NAIL	3 - 16d COMMON, MINIMUM
18.	CEILING JOISTS TO PARALLEL RAFTERS.	FACE NAIL	3 - 16d COMMON, MINIMUM
19.	RAFTER TO PLATE.	TOENAIL	3 - 8d COMMON
20.	1" DIAGONAL BRACE TO EACH STUD AND PLATE.	FACE NAIL	2 - 8d COMMON
21.	1"x8" SHEATHING TO EACH BEARING WALL.	FACE NAIL	2 - 8d COMMON
22.	WIDER THAN 1"x8" SHEATHING TO EACH BEARING.	FACE NAIL	3 - 8d COMMON
23.	BUILT-UP CORNER STUDS.	24" OC	16d COMMON
24.	BUILT-UP GIRDER & BEAMS.	FACE NAIL AT T&B STAGGERED ON OPPOSITE SIDES FACE NAIL AT ENDS & AT EACH SPLICE	20d COMMON @ 32" OC 2 - 20d COMMON
25.	2" PLANKS.	AT EACH BEARING	16d COMMON
26.	COLLAR TIE TO RAFTER.	FACE NAIL	3 - 10d COMMON
27.	JACK RAFTER TO HIP.	TOENAIL FACE NAIL	3 - 10d COMMON 2 - 16d COMMON
28.	ROOF RAFTER TO 2x RIDGE BEAM.	TOENAIL FACE NAIL	2 - 16d COMMON 2 - 16d COMMON
29.	JOIST TO BAND JOIST.	FACE NAIL	3 - 16d COMMON
30.	LEDGER STRIP.	FACE NAIL	3 - 16d COMMON
31.	WOOD STRUCTURAL PANELS AND PARTICLEBOARD (NAILS SPACED @ 6" OC EDGES & 12" OC FIELD): SUBFLOOR, ROOF AND WALL SHEATHING (TO FRAMING):	1/2" AND LESS 19/32" TO 3/4" 7/8" TO 1" 1 1/8" TO 1 1/4"	6d COMMON 8d OR 6d COMMON 8d COMMON 10d COMMON
	SINGLE FLOOR (COMBINATION SUBFLOOR-UNDERLAYMENT TO FRAMING):	3/4" AND LESS 7/8" TO 1" 1 1/8" TO 1 1/4"	6d DEFORMED SHANK 8d DEFORMED SHANK 10d COMMON
32.	PANEL SIDING (TO FRAMING). (USE CORROSION-RESISTANT SIDING OR CASING NAIL)	1/2" AND LESS 5/8"	6d 8d
33.	FIBERBOARD SHEATHING: (NAILS SPACED @ 3" OC EDGES & 6" OC FIELD)	1/2" 25/32"	6d COMMON NAIL 8d COMMON NAIL
34.	INTERIOR PANELING. (NAILS SPACED @ 6" OC EDGES & 12" OC FIELD)	1/4" 3/8"	4d CASING OR FINISH 6d CASING OR FINISH

NAILING PER SCHEDULE ABOVE IS TO BE USED WHERE NAILING IS NOT SPECIFIED ON PLANS OR DETAILS. NAILING PER PLANS & DETAILS SUPERSEDES THIS NAILING SCHEDULE UNLESS APPROVED BY THE ENGINEER OF RECORD.

2. COMMON OR BOX NAILS MAY BE USED EXCEPT WHERE OTHERWISE NOTED.

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PROJECT

Nomad - Cafe

Addition & Remodel 1668 N Warren Ave.

Milwaukee, WI 53202

p: 414.224.8111

OWNER NOMADIC VENTURES INC. 1401 E. Brady St. Milwaukee, WI 53202

STRUCTURAL ENGINEER



PROJECT NUMBER 219617.01 SHEET TITLE

August 07, 2020

REVISIONS

Structural Notes

SHEET NUMBER

KEYED NOTES

MARK	DESCRIPTION
1	2 x12 LEDGER BOARD ATTACHED TO EXISTING FOUNDATIO WALL w/ $\frac{5}{16}$ "Øx $\frac{3}{8}$ " ANCHOR w/ HTY-HY 270 EPOXY AT 12"O
2	SISTER EXISTING TRUE 2x10 JOIST w/ NEW 2x12 SPF No.1/N w/ (2) 10d NAILS @ 12"OC STAGGERED
3	2x10 LEDGER BOARD ATTACHED TO EXISTING WOOD BEAN

(2) %"Ø x 5" LONG LAG SCREWS AT 12"OC (2) 2x8 SPF No.1/No.2 HEADER OVER EXISTING FOUNDATION

WINDOW PT 2x10 LEDGER BOARD ATTACHED TO EXISTING FDN WALL w/ 5/16"Øx31/8" ANCHOR w/ HTY-HY 270 EPOXY AT 12"OC PT 2x12 STAIR STRINGERS w/GALVANIZED SIMPSON A35 CLIP ANGLE AT HEADER.

ALL PRESSURE TREATED WOOD TO BE S PINE No.1 AS A

MINIMUM.

ATTACH BEAM TO EXISTING BRICK FOUNDATION WALL w/ SIMPSON HU28-2 ATTACHED WITH (10) 1/4" x1 3/4" TITEN 2 TO WALL AND (4) 10d NAAILS TO BEAM

WOOD POST SCHEDULE

MARK	TYPE	POST BASE	REMARKS
WP-44	4x4 S.PINE No.1	SIMPSON CB-44	
WP-66	6x6 S.PINE No.1	SIMPSON CB-66Z	

WOOD BEAM SCHEDULE

MARK	TYPE	END POST, UNO	REMARKS
B1	(3) - 2x12 S.PINE No.1		
B2	(2) - 2x8 S.PINE No.1		FACE MOUNT TO POST w/ SIMPSON HUC28-2
	·		·

1. LOCATE BEAMS BELOW WOOD POSTS OR SHOULDER STUDS FROM FLOOR ABOVE.

- 2. BEAMS ARE IN ADDITION TO REGULARLY SPACED JOISTS.

3. CARRY END POSTS DOWN TO PRECAST STRUCTURE AT SECOND FLOOR.

HEADER SCHEDULE

MARK	TYPE	REMARKS
H1	(2) 2x8 SPF No.1/No.2	
H2	(2) 2x10 SPF No.1/No.2	
Н3	(2) 2x12 SPF No.1/No.2	

- 1. SEE DETAIL 5/S2.0 FOR TYPICAL HEADER FRAMING INFORMATION. 2. PROVIDE FULL HEIGHT SPF NO.1/NO.2 KING STUDS ADJACENT TO EACH HEADER LOCATION ACCORDING TO THE FOLLOWING:
 - OPENINGS < 6'-0" 6'-0" < OPENINGS < 9'-0" 2 STUDS
 - 9'-0" < OPENINGS < 12'-0" 3 STUDS
- 3. AT CONTRACTOR'S OPTION, LARGER MEMBERS w/ EQUAL OR BETTER DESIGN PROPERTIES MAY BE SUBSTITUTED FOR SIZES LISTED ABOVE PROVIDED IT DOES NOT CHANGE THE STRUCTURAL OR ARCHITECTURAL DESIGN INTENT.
- SHOULDER STUDS TO BE 2x4 SPF No.1/No.2
- WHERE HEADER PLIES ARE LESS THAN THE CORRESPONDING WALL WIDTH, THE HEADER SHALL BE MODIFIED ACCORDING TO DETAIL 4/S2.0.

FOUNDATION LEGEND

	TOP OF COLUMN FOOTING ELEVATION COLUMN FOOTING MARK F1 96'-0" P1 100'-0"
	PIER MARK— TOP OF PIER ELEVATION
	COLUMN MARK————————————————————————————————————
	TOP OF WALL ELEVATION TOP OF LEDGE ELEVATION TW 100'-0"
v/	STRIP FOOTING MARK w/TOP OF FOOTING ELEVATION W2 96'-0"
V/	FOOTING STEP MARKER
	SLAB-ON-GRADE CONTROL OR CONSTRUCTION JOINT CJ

FOUNDATION PLAN NOTES

- 1. CONTRACTOR SHALL PROVIDE FROST AND MOISTURE PROTECTION FOR FOOTINGS EXPOSED DURING CONSTRUCTION.
- REFER TO ARCHITECTURAL DRAWINGS OR PLUMBING DRAWINGS FOR SPECIFIC FLOOR DRAIN LOCATIONS & ELEVATIONS.
- 3. FOOTING EXCAVATIONS SHALL BE EXAMINED BY THE GEOTECHNICAL ENGINEER TO CONFIRM THAT THE SOILS AT THE BOTTOM OF THE EXCAVATION ARE CAPABLE OF PROVIDING THE ALLOWABLE SOIL BEARING PRESSURE AS INDICATED IN THE DESIGN DATA. CONTACT ARCH/ENGINEER IF UNABLE TO ATTAIN THIS SOIL BEARING PRESSURE.
- 4. CENTER COLUMN AND WALL FOOTINGS ON SUPPORTED MEMBER CENTERLINES UNO.
- 5. NO PROVISION HAS BEEN MADE FOR FUTURE EXPANSION.
- 6. REFER TO S0.1 FOR ALL STRUCTURAL NOTES & SCHEDULES. REFER TO S2.0 FOR MISCELLANEOUS DETAILS NOT CUT ON PLAN.
- 7. ALL EXISTING CONDITIONS SHALL BE FIELD VERIFIED PRIOR TO CONSTRUCTION OR MATERIAL FABRICATION. NOTIFY ENGINEER FOR POSSIBLE REMEDIAL ACTION IF ACTUAL CONDITIONS DIFFER FROM THOSE SHOWN HERE.

FOOTING SCHEDULE

	1 00 THO OUTEDOLL						
MARK	DIMENSIONS		IS	REINFORCEMENT	DEMADKS		
IVIANN	WIDTH	LENGTH	DEPTH				KEWAKKO
S1	0'-8"	-	5'-0"	(4) #4 VERTICAL			
S2	1'-0"	-	5'-0"	(4) #5 VERTICAL w/ #3 TIES @ 12"OC			
S3	1'-6"	-	5'-0"	(4) #7 VERTICAL w/ #3 TIES @ 12"OC			

GENERAL NOTES: LW = LONG WAY SW = SHORT WAY EW = EACH WAY T = TOP

B = BOTTOM CONT. = CONTINUOUS

The Kubala Washatko Architects, Inc. W61 N617 Mequon Avenue Cedarburg, WI 53012

p: 262.377.6039 | f: 262.377.2954

PROJECT

Nomad - Cafe

Addition & Remodel

1668 N Warren Ave.


Milwaukee, WI 53202 p: 414.224.8111

Milwaukee, WI 53202

OWNER NOMADIC VENTURES INC. 1401 E. Brady St.

STRUCTURAL ENGINEER




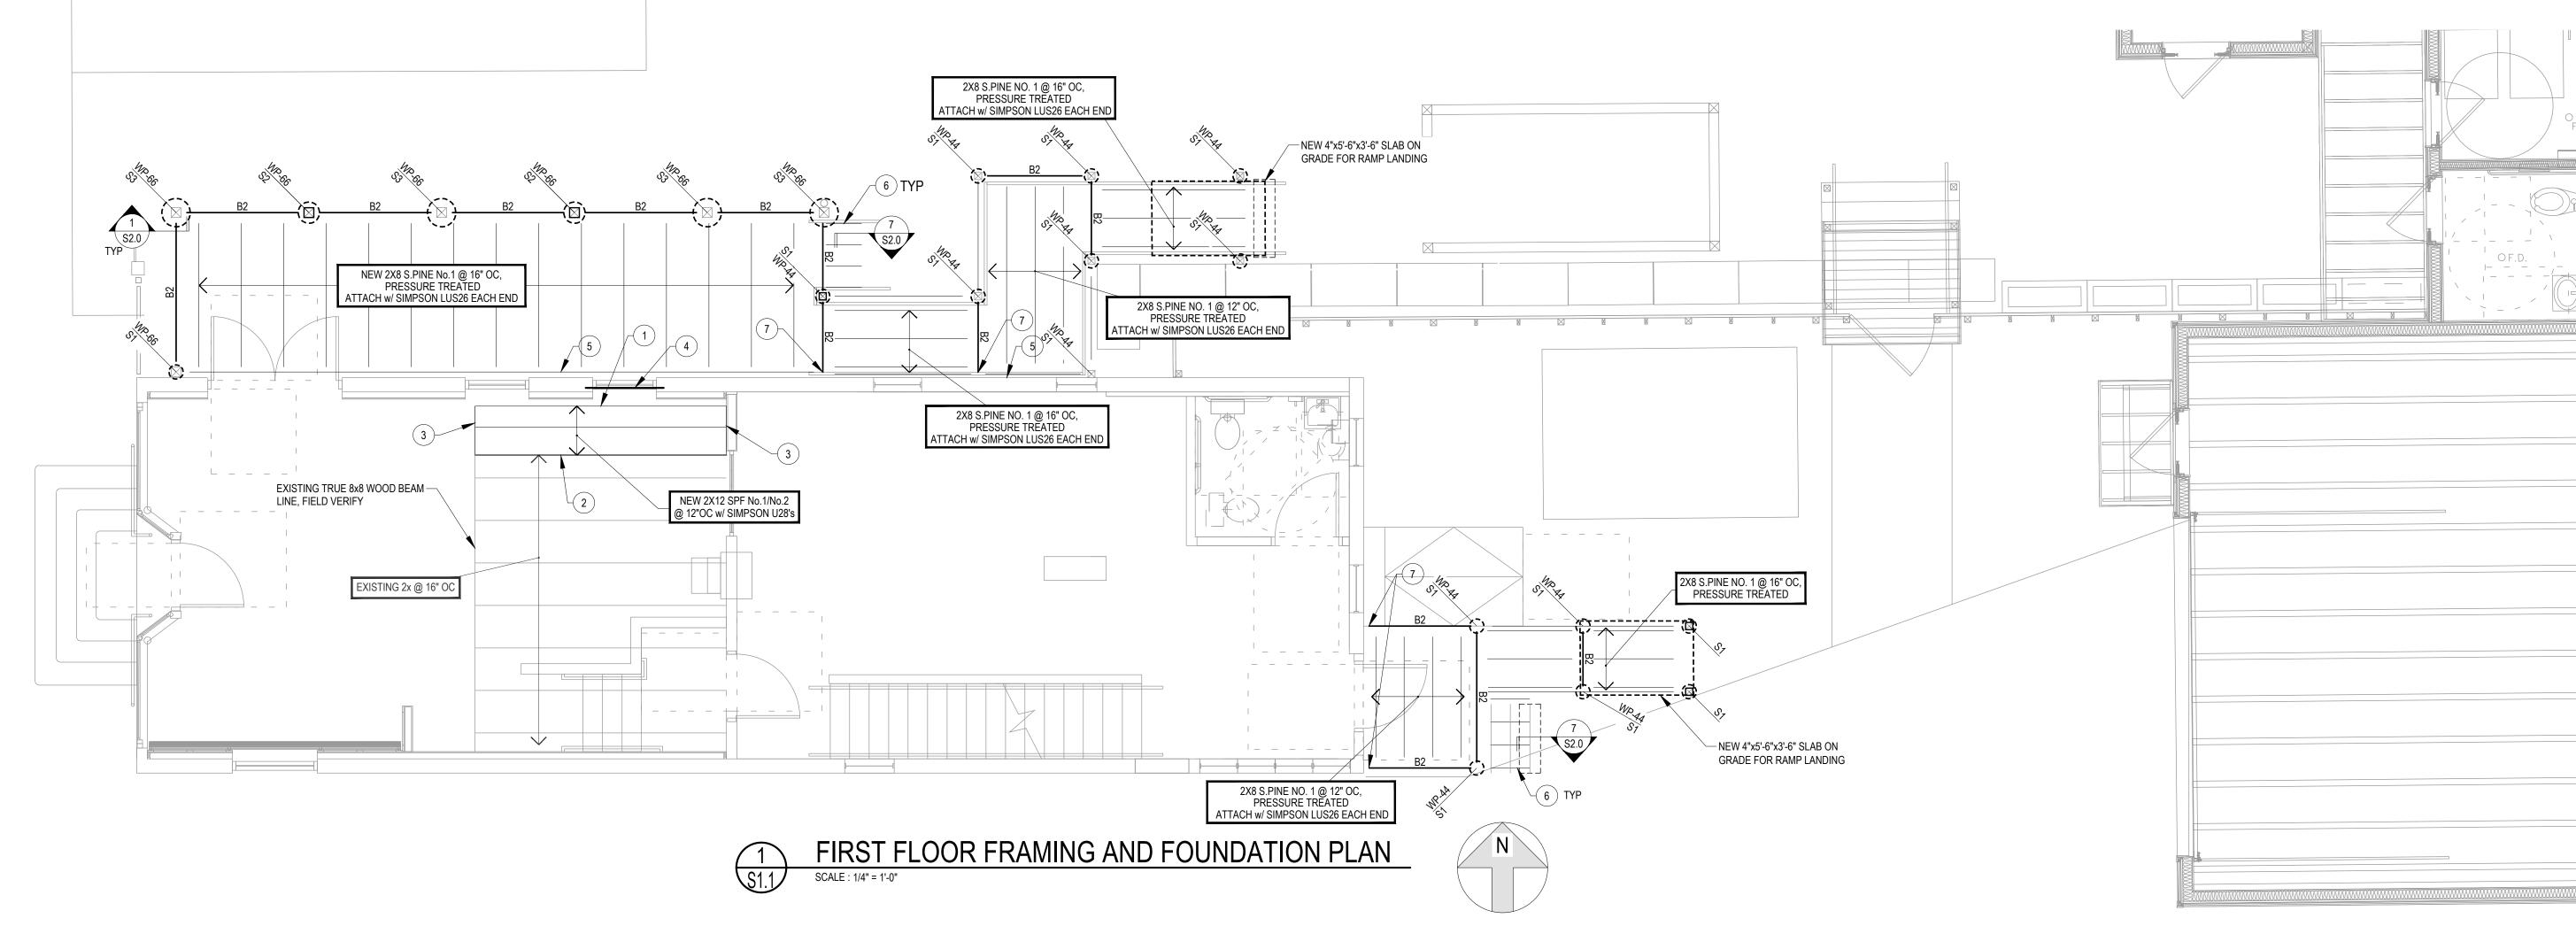


REVISIONS August 07, 2020 PROJECT NUMBER 219617.01 SHEET TITLE First Floor /

Plan SHEET NUMBER

Foundation

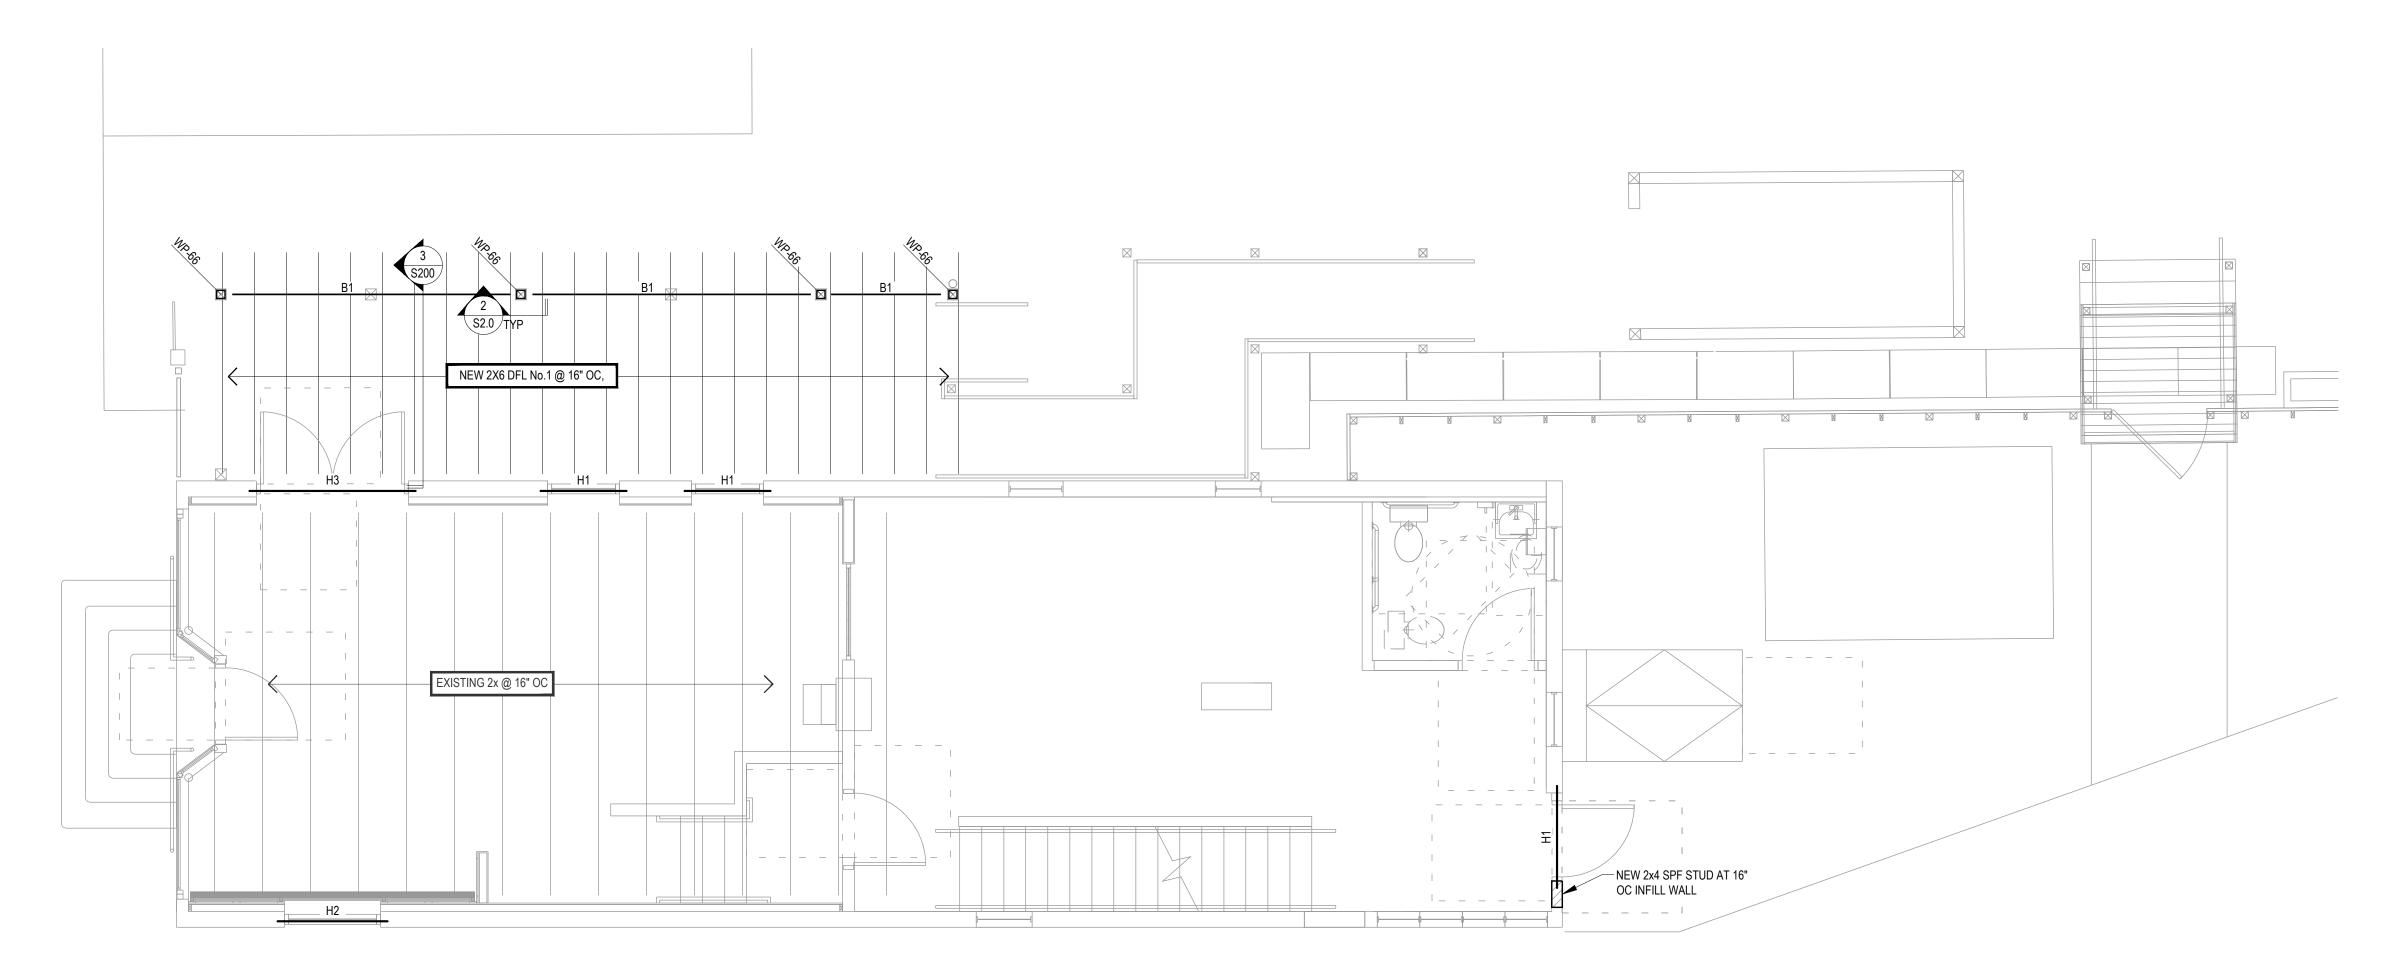



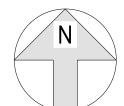

WOOD POST SCHEDULE

MARK	TYPE	POST BASE	REMARKS
WP-44	4x4 S.PINE No.1	SIMPSON CB-44	
WP-66	6x6 S.PINE No.1	SIMPSON CB-66Z	

WOOD BEAM SCHEDULE

MARK	TYPE	END POST, UNO	REMARKS
B1	(3) - 2x12 S.PINE No.1		
B2	(2) - 2x8 S.PINE No.1		FACE MOUNT TO POST w/ SIMPSON HUC28-2
	· ,		


1. LOCATE BEAMS BELOW WOOD POSTS OR SHOULDER STUDS FROM FLOOR ABOVE.

- 2. BEAMS ARE IN ADDITION TO REGULARLY SPACED JOISTS.
- 3. CARRY END POSTS DOWN TO PRECAST STRUCTURE AT SECOND FLOOR.

HEADER SCHEDULE

MARK	TYPE	REMARKS
H1	(2) 2x8 SPF No.1/No.2	
H2	(2) 2x10 SPF No.1/No.2	
НЗ	(2) 2x12 SPF No.1/No.2	

- 1. SEE DETAIL 5/S2.0 FOR TYPICAL HEADER FRAMING INFORMATION. 2. PROVIDE FULL HEIGHT SPF NO.1/NO.2 KING STUDS ADJACENT TO EACH HEADER LOCATION ACCORDING TO THE FOLLOWING:
 - OPENINGS < 6'-0" 2 STUDS 6'-0" < OPENINGS < 9'-0" 9'-0" < OPENINGS < 12'-0" 3 STUDS
- 3. AT CONTRACTOR'S OPTION, LARGER MEMBERS w/ EQUAL OR BETTER DESIGN PROPERTIES MAY BE SUBSTITUTED FOR SIZES LISTED ABOVE PROVIDED IT DOES NOT CHANGE THE STRUCTURAL OR ARCHITECTURAL DESIGN INTENT.
- 4. SHOULDER STUDS TO BE 2x4 SPF No.1/No.2 5. WHERE HEADER PLIES ARE LESS THAN THE CORRESPONDING WALL WIDTH, THE HEADER SHALL BE MODIFIED ACCORDING TO DETAIL 4/S2.0.

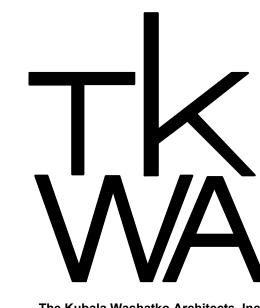

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PROJECT

Nomad - Cafe

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p: 414.224.8111

Milwaukee, WI 53202 OWNER

NOMADIC VENTURES INC. 1401 E. Brady St. Milwaukee, WI 53202

STRUCTURAL ENGINEER




August 07, 2020 PROJECT NUMBER


219617.01

SHEET TITLE

Low Roof / Second Floor Framing Plan

SHEET NUMBER

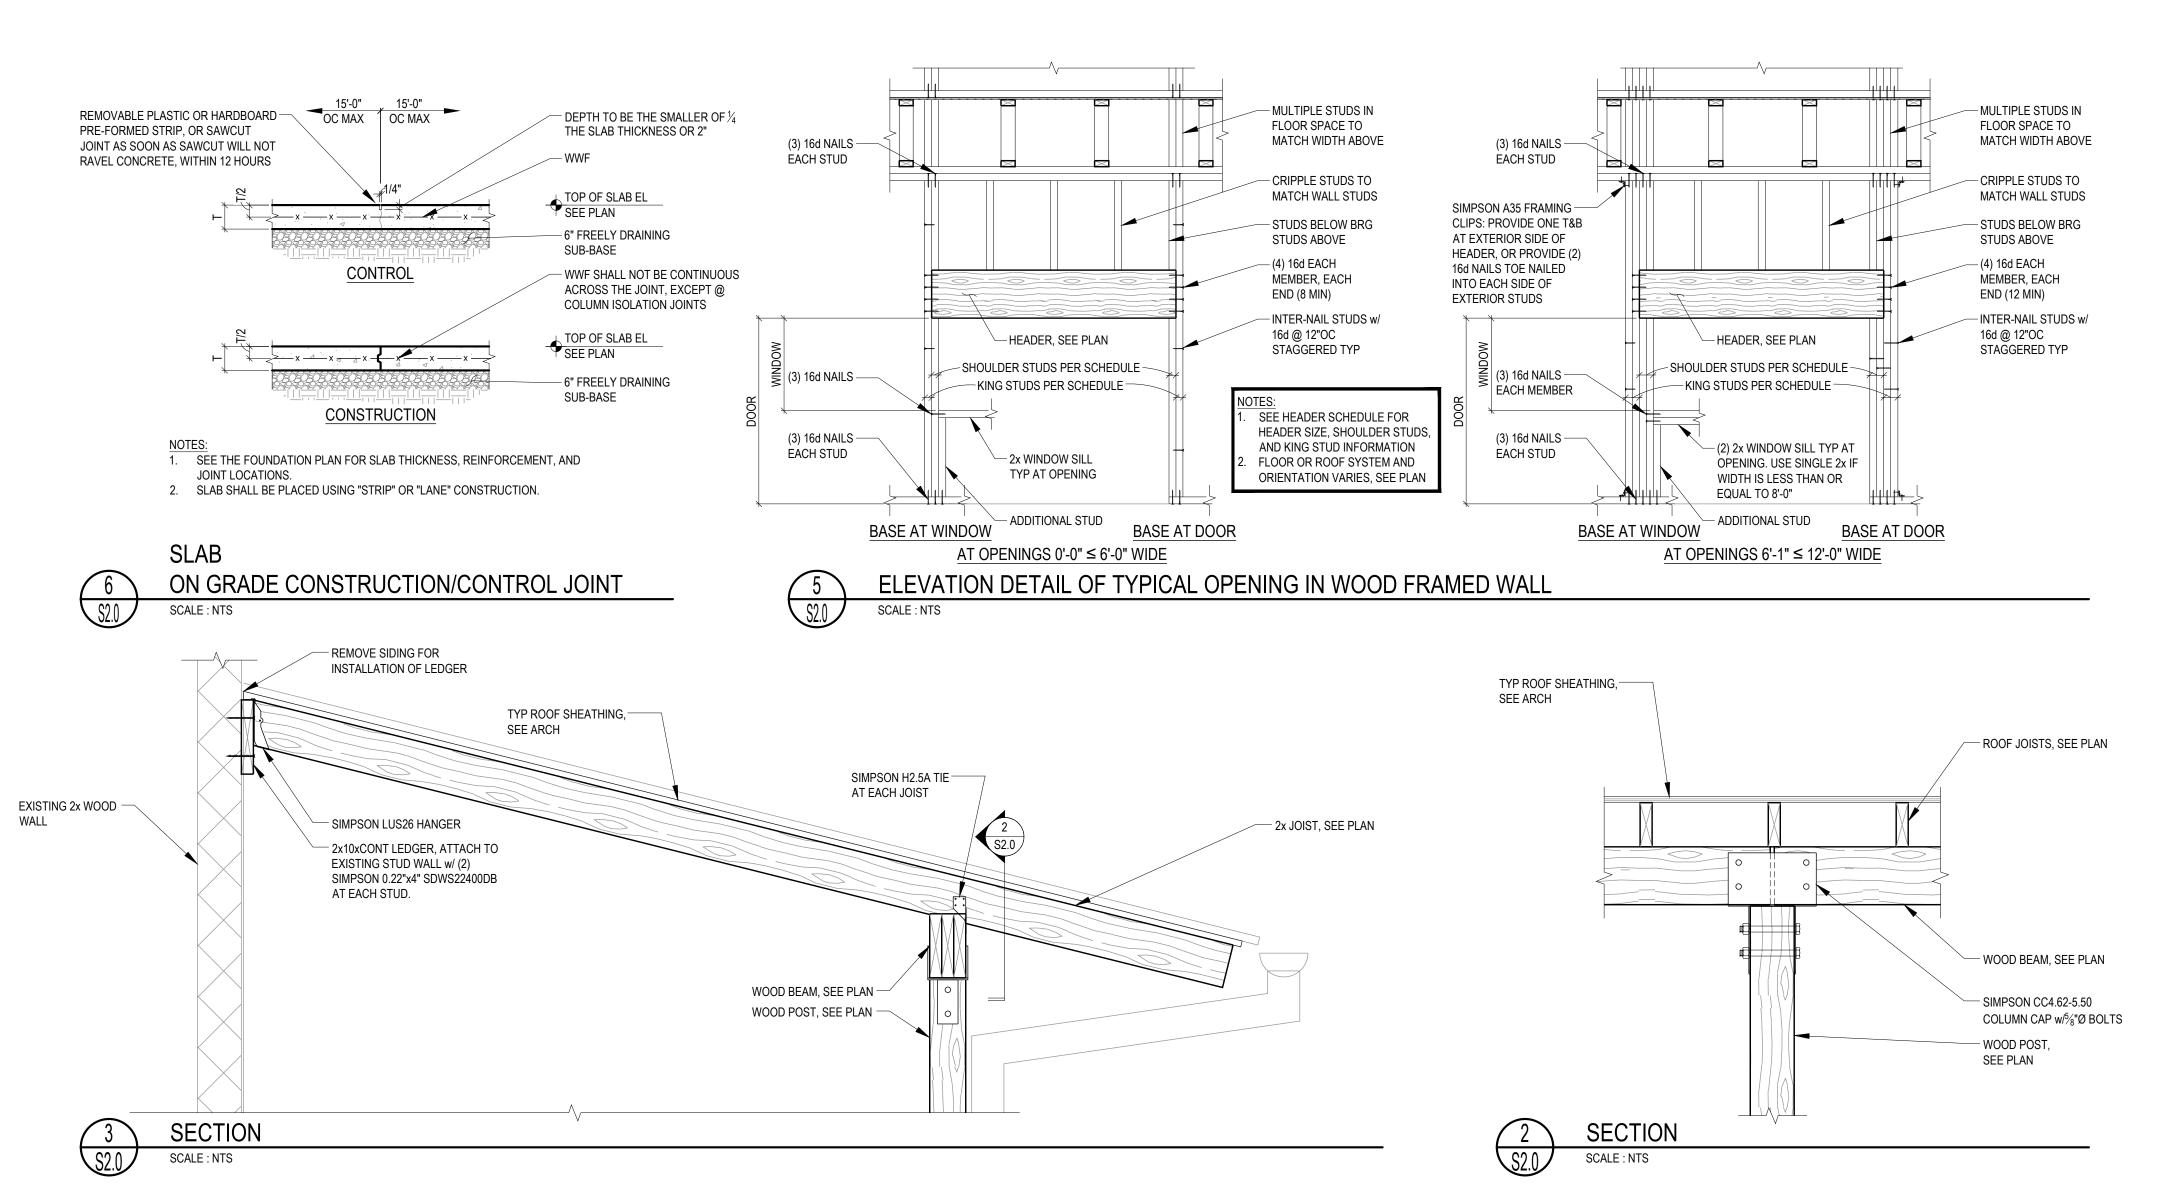

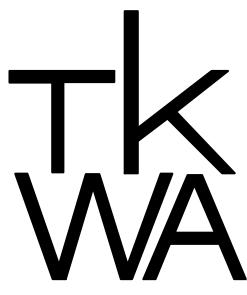

The Kubala Washatko Architects, Inc. W61 N617 Mequon Avenue Cedarburg, WI 53012 p: 262.377.6039 | f: 262.377.2954

PROJECT

Nomad - Cafe

Addition & Remodel

1668 N Warren Ave. Milwaukee, WI 53202

1401 E. Brady St. Milwaukee, WI 53202

— SLAB ON GRADE

TOP OF SLAB EL SEE PLAN OWNER NOMADIC VENTURES INC.

p: 414.224.8111



GENERAL NOTE:

1. THIS DETAIL SHOULD BE USED ONLY FOR STRUCTURAL INFORMATION ONLY. SEE ARCHITECTURAL DRAWINGS FOR ALL STAIR LOCATIONS, DIMENSIONS, RISERS, RUNS, AND NOSING REQUIREMENTS.

___x ___x ___x ___x ___x ___x ___x

THICKENED SLAB ON GRADE AT STAIR

SCALE : NTS


STAIR STRINGER BY -

2x TREATED PLATE & KICKER —


 $\text{w}/5_{8}$ "Ø EXPANSION ANCHOR $\text{w}/5_{2}$ " MINIMUM EMBED

STAIR SUPPLIER

(2) #4xCONT -

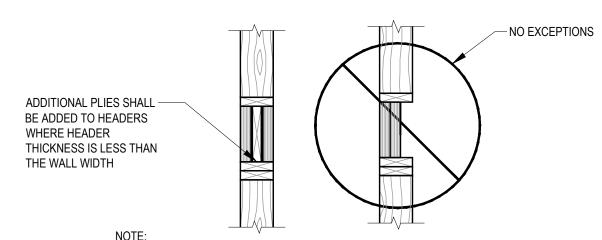

ACCEPTABLE MODIFICATIONS TO ACHIEVE REQUIRED HEADER THICKNESS INCLUDE THE ADDITION OF LVL, 2x DIMENSIONAL LUMBER, AND OR PLYWOOD OF MATCHING (OR BETTER) GRADE & SPECIES OF THE CORRESPONDING HEADER AND WALL STUDS.

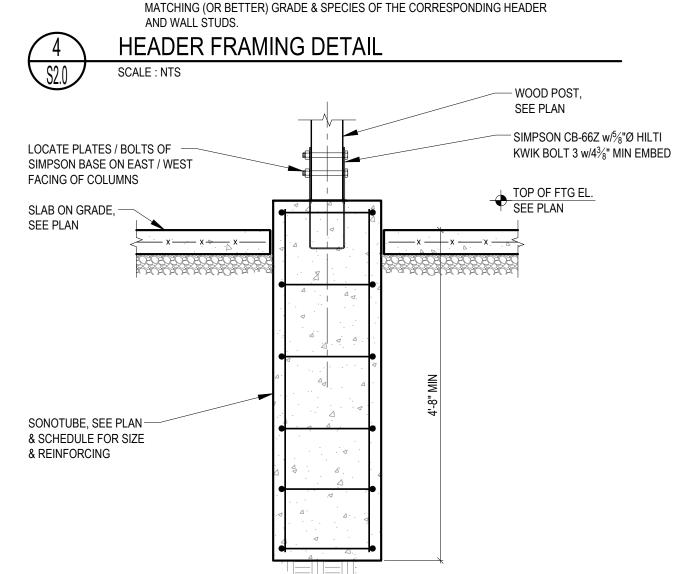

SECTION

SCALE: NTS

DATE
August 07, 2020
PROJECT NUMBER
219617.01

Structural Details

SHEET TITLE

SHEET NUMBER