

PHASE I
Elderly Independent
Living Apartments

**The Living Circle
Campus**

PHASE I
Three Oaks Circle Inc.
1000 East Main Street
Baltimore, MD 21202

Architect
Kubala Washartko
Architects Inc.
1000 East Main Street
Baltimore, MD 21202

Client
Three Oaks Circle Inc.
1000 East Main Street
Baltimore, MD 21202

Landscaper
Landscape Architecture
1000 East Main Street
Baltimore, MD 21202

Engineer
Structural Engineering
1000 East Main Street
Baltimore, MD 21202

DATE
11/14/99

FILED
11/14/99

DATE
Friday, June 15, 2007

PROJECT
BULLDOG
ELEVATIONS

SCALE
AS SHOWN


PROJECT
BULLDOG
ELEVATIONS

SCALE
AS SHOWN

SCALE
AS SHOWN

WINDOW SCHEDULE

Window No.	Description	Height	Opening	Masonry	Opening	Grate	Head	Sill	L	Remarks
1	CH1344	6'-0" W	4'-2" H	NO	NO	NO	4'-2"	0'-0"	15'-0"	SIL. ON 1" S. PRESB. ONLY
2	CH1344	6'-0" W	4'-2" H	NO	NO	NO	4'-2"	0'-0"	15'-0"	SIL. ON 1" S. PRESB. ONLY
3	CH1344	6'-0" W	4'-2" H	NO	NO	NO	4'-2"	0'-0"	15'-0"	SIL. ON 1" S. PRESB. ONLY
4	CH1344	6'-0" W	4'-2" H	NO	NO	NO	4'-2"	0'-0"	15'-0"	SIL. ON 1" S. PRESB. ONLY
5	CH1344	6'-0" W	4'-2" H	NO	NO	NO	4'-2"	0'-0"	15'-0"	SIL. ON 1" S. PRESB. ONLY
6	CH1344	6'-0" W	4'-2" H	NO	NO	NO	4'-2"	0'-0"	15'-0"	SIL. ON 1" S. PRESB. ONLY
7	CH1344	6'-0" W	4'-2" H	NO	NO	NO	4'-2"	0'-0"	15'-0"	SIL. ON 1" S. PRESB. ONLY
8	CH1344	6'-0" W	4'-2" H	NO	NO	NO	4'-2"	0'-0"	15'-0"	SIL. ON 1" S. PRESB. ONLY
9	CH1344	6'-0" W	4'-2" H	NO	NO	NO	4'-2"	0'-0"	15'-0"	SIL. ON 1" S. PRESB. ONLY
10	CH1344	6'-0" W	4'-2" H	NO	NO	NO	4'-2"	0'-0"	15'-0"	SIL. ON 1" S. PRESB. ONLY
11	CH1344	6'-0" W	4'-2" H	NO	NO	NO	4'-2"	0'-0"	15'-0"	SIL. ON 1" S. PRESB. ONLY
12	CH1344	6'-0" W	4'-2" H	NO	NO	NO	4'-2"	0'-0"	15'-0"	SIL. ON 1" S. PRESB. ONLY
13	CH1344	6'-0" W	4'-2" H	NO	NO	NO	4'-2"	0'-0"	15'-0"	SIL. ON 1" S. PRESB. ONLY
14	CH1344	6'-0" W	4'-2" H	NO	NO	NO	4'-2"	0'-0"	15'-0"	SIL. ON 1" S. PRESB. ONLY
15	CH1344	6'-0" W	4'-2" H	NO	NO	NO	4'-2"	0'-0"	15'-0"	SIL. ON 1" S. PRESB. ONLY
16	CH1344	6'-0" W	4'-2" H	NO	NO	NO	4'-2"	0'-0"	15'-0"	SIL. ON 1" S. PRESB. ONLY
17	CH1344	6'-0" W	4'-2" H	NO	NO	NO	4'-2"	0'-0"	15'-0"	SIL. ON 1" S. PRESB. ONLY
18	CH1344	6'-0" W	4'-2" H	NO	NO	NO	4'-2"	0'-0"	15'-0"	SIL. ON 1" S. PRESB. ONLY
19	CH1344	6'-0" W	4'-2" H	NO	NO	NO	4'-2"	0'-0"	15'-0"	SIL. ON 1" S. PRESB. ONLY
20	CH1344	6'-0" W	4'-2" H	NO	NO	NO	4'-2"	0'-0"	15'-0"	SIL. ON 1" S. PRESB. ONLY
21	CH1344	6'-0" W	4'-2" H	NO	NO	NO	4'-2"	0'-0"	15'-0"	SIL. ON 1" S. PRESB. ONLY
22	CH1344	6'-0" W	4'-2" H	NO	NO	NO	4'-2"	0'-0"	15'-0"	SIL. ON 1" S. PRESB. ONLY
23	CH1344	6'-0" W	4'-2" H	NO	NO	NO	4'-2"	0'-0"	15'-0"	SIL. ON 1" S. PRESB. ONLY
24	CH1344	6'-0" W	4'-2" H	NO	NO	NO	4'-2"	0'-0"	15'-0"	SIL. ON 1" S. PRESB. ONLY
25	CH1344	6'-0" W	4'-2" H	NO	NO	NO	4'-2"	0'-0"	15'-0"	SIL. ON 1" S. PRESB. ONLY
26	CH1344	6'-0" W	4'-2" H	NO	NO	NO	4'-2"	0'-0"	15'-0"	SIL. ON 1" S. PRESB. ONLY
27	CH1344	6'-0" W	4'-2" H	NO	NO	NO	4'-2"	0'-0"	15'-0"	SIL. ON 1" S. PRESB. ONLY
28	CH1344	6'-0" W	4'-2" H	NO	NO	NO	4'-2"	0'-0"	15'-0"	SIL. ON 1" S. PRESB. ONLY
29	CH1344	6'-0" W	4'-2" H	NO	NO	NO	4'-2"	0'-0"	15'-0"	SIL. ON 1" S. PRESB. ONLY
30	CH1344	6'-0" W	4'-2" H	NO	NO	NO	4'-2"	0'-0"	15'-0"	SIL. ON 1" S. PRESB. ONLY
31	CH1344	6'-0" W	4'-2" H	NO	NO	NO	4'-2"	0'-0"	15'-0"	SIL. ON 1" S. PRESB. ONLY
32	CH1344	6'-0" W	4'-2" H	NO	NO	NO	4'-2"	0'-0"	15'-0"	SIL. ON 1" S. PRESB. ONLY
33	CH1344	6'-0" W	4'-2" H	NO	NO	NO	4'-2"	0'-0"	15'-0"	SIL. ON 1" S. PRESB. ONLY
34	CH1344	6'-0" W	4'-2" H	NO	NO	NO	4'-2"	0'-0"	15'-0"	SIL. ON 1" S. PRESB. ONLY
35	CH1344	6'-0" W	4'-2" H	NO	NO	NO	4'-2"	0'-0"	15'-0"	SIL. ON 1" S. PRESB. ONLY
36	CH1344	6'-0" W	4'-2" H	NO	NO	NO	4'-2"	0'-0"	15'-0"	SIL. ON 1" S. PRESB. ONLY
37	CH1344	6'-0" W	4'-2" H	NO	NO	NO	4'-2"	0'-0"	15'-0"	SIL. ON 1" S. PRESB. ONLY
38	CH1344	6'-0" W	4'-2" H	NO	NO	NO	4'-2"	0'-0"	15'-0"	SIL. ON 1" S. PRESB. ONLY
39	CH1344	6'-0" W	4'-2" H	NO	NO	NO	4'-2"	0'-0"	15'-0"	SIL. ON 1" S. PRESB. ONLY
40	CH1344	6'-0" W	4'-2" H	NO	NO	NO	4'-2"	0'-0"	15'-0"	SIL. ON 1" S. PRESB. ONLY
41	CH1344	6'-0" W	4'-2" H	NO	NO	NO	4'-2"	0'-0"	15'-0"	SIL. ON 1" S. PRESB. ONLY
42	CH1344	6'-0" W	4'-2" H	NO	NO	NO	4'-2"	0'-0"	15'-0"	SIL. ON 1" S. PRESB. ONLY
43	CH1344	6'-0" W	4'-2" H	NO	NO	NO	4'-2"	0'-0"	15'-0"	SIL. ON 1" S. PRESB. ONLY
44	CH1344	6'-0" W	4'-2" H	NO	NO	NO	4'-2"	0'-0"	15'-0"	SIL. ON 1" S. PRESB. ONLY
45	CH1344	6'-0" W	4'-2" H	NO	NO	NO	4'-2"	0'-0"	15'-0"	SIL. ON 1" S. PRESB. ONLY
46	CH1344	6'-0" W	4'-2" H	NO	NO	NO	4'-2"	0'-0"	15'-0"	SIL. ON 1" S. PRESB. ONLY
47	CH1344	6'-0" W	4'-2" H	NO	NO	NO	4'-2"	0'-0"	15'-0"	SIL. ON 1" S. PRESB. ONLY
48	CH1344	6'-0" W	4'-2" H	NO	NO	NO	4'-2"	0'-0"	15'-0"	SIL. ON 1" S. PRESB. ONLY
49	CH1344	6'-0" W	4'-2" H	NO	NO	NO	4'-2"	0'-0"	15'-0"	SIL. ON 1" S. PRESB. ONLY
50	CH1344	6'-0" W	4'-2" H	NO	NO	NO	4'-2"	0'-0"	15'-0"	SIL. ON 1" S. PRESB. ONLY

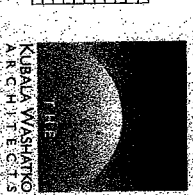

The Living Circle Campus
PHASE I
 Elderly Independent Living Apartments
PHASE II
 Senior Center

DATE: JUNE 15, 2001
 DRAWING NO: 111498

PHASE I
 Three Oaks Circle, Inc.
 5000 Lake Land Drive
 The Falls, Blauvelt
 11316 - 0100
 349-5500
 349-5500

DATE: JUNE 15, 2001
 DRAWING NO: 111498




SCALE: 1/8" = 1'-0"

WINDOW TYPES

CH1344 CH1344 CH1344 CH1344 CH1344 CH1344

NOTES

1. WHEN NOT SET, SINGLE WINDOW WITH MANUFACTURED DIVIDED LIGHTS.
2. HORIZONTAL SCREENS FOR OPERABLE WINDOWS.
3. STANDARD GLAZING, 1/2" THICK LOW E ALUMINUM CASSEBELD UNITS.
4. SET DETAILS FOR JAMB, HEAD AND SILL CONDITIONS.

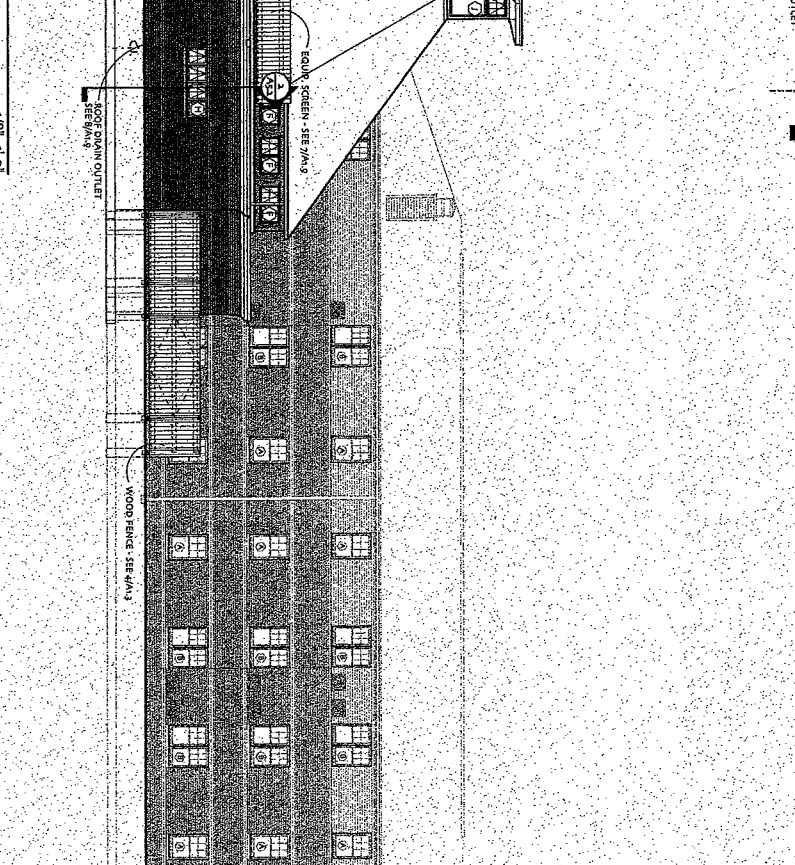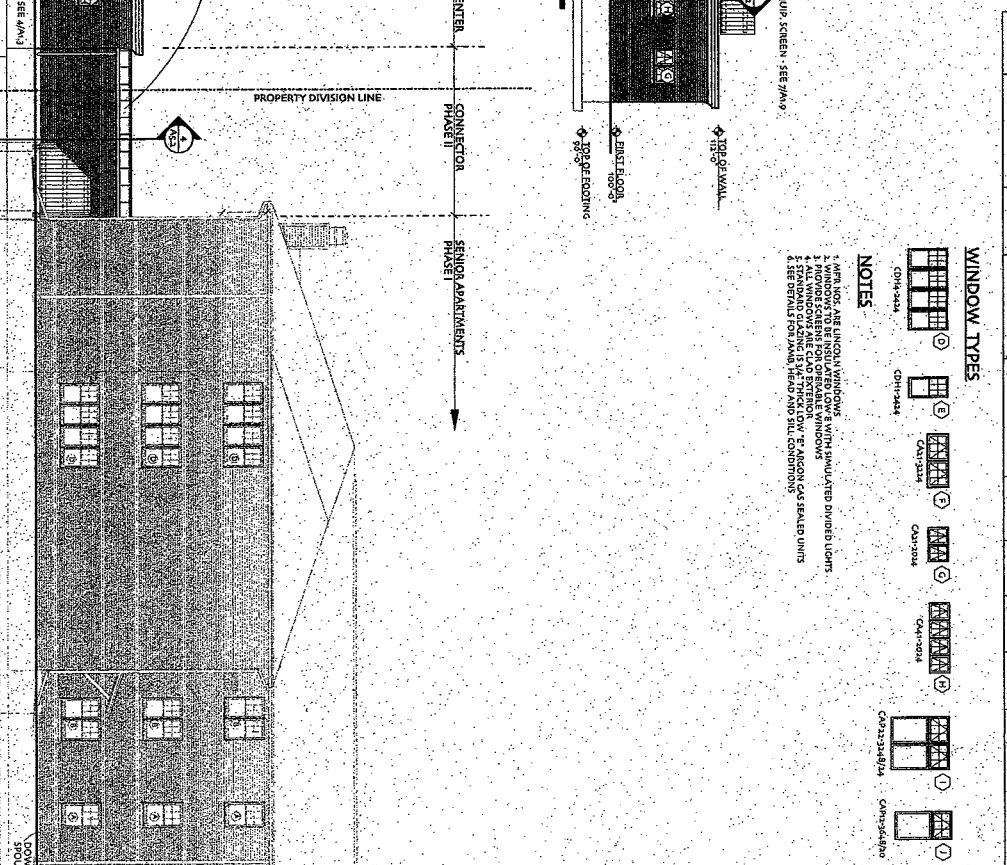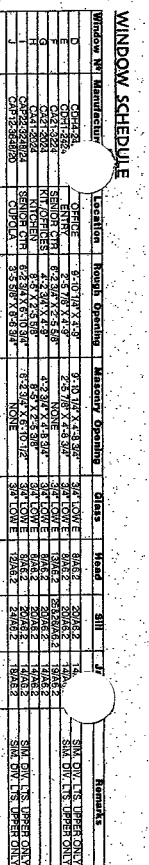

PROPERTY DIVISION LINE

SENIOR APARTMENTS PHASE I
 CONNECTOR PHASE I
 SENIOR CENTER PHASE II

PROPERTY DIVISION LINE

SENIOR APARTMENTS PHASE I
 CONNECTOR PHASE I
 SENIOR CENTER PHASE II

- ASPHALT SHINGLES
- SHEET METAL, CUTTERS AND DOWNSPOUTS
- GLASS WOOD WINDOWS
- EXT. INSUL. & FINISH SYSTEM
- STONE BAND
- BRICK VENEER
- TYPON CORNER
- TIMBER KOCH FRAMING, SEE DWG. 3
- CONCRETE FOUNDATION
- ROOF DRAIN OUTLET
- SEE DWG. 3

- ASPHALT SHINGLES
- PINK LINER
- SHEET METAL, CUTTERS AND DOWNSPOUTS
- GLASS WOOD WINDOWS
- EXT. INSUL. & FINISH SYSTEM
- BRICK VENEER
- TYPON CORNER
- SHEET METAL ROOFING
- ROOF SQUIPETS
- ROOF DRAIN OUTLET
- SEE DWG. 3

- ASPHALT SHINGLES
- SHEET METAL, CUTTERS AND DOWNSPOUTS
- GLASS WOOD WINDOWS
- EXT. INSUL. & FINISH SYSTEM
- BRICK VENEER
- TYPON CORNER
- SHEET METAL ROOFING
- ROOF SQUIPETS
- ROOF DRAIN OUTLET
- SEE DWG. 3

3 WEST ELEVATION
 1/8" = 1'-0"

4 EAST ELEVATION
 1/8" = 1'-0"

7 EAST ELEVATION
 1/8" = 1'-0"

3 WEST ELEVATION
 1/8" = 1'-0"

1 SOUTH ELEVATION
 1/8" = 1'-0"

2 NORTH ELEVATION
 1/8" = 1'-0"