TRASH ENCLOSURE 77' - 0" 11' - 4" 8' - 6" 1'-6" 5'-2" 5'-2" GENERATOR 33' - 0" MEETING STORAGE & 10' - 6" 2 **A**2.11 PREFUNCTION C RECEIVING 129 A3.10 A2.10 2 7' - 2" 3' - 8" 9' - 2" 2' - 0" 2 EQ TREADS 4' - 10" 4' - 6" LOUNGE 110 HOME OFFICE 12' - 1" 2 EQ TREADS E-(A2.10)

GENERAL NOTES - FLOOR PLAN

- 1 BUILDING SHALL BE CONSTRUCTED TO MEET THE REQUIREMENTS AND QUALITY LEVEL DESCRIBED IN THE HOMEWOOD SUITES BY
- HILTON DESIGN STANDARDS. PROVIDE APPROPRIATE MATERIALS AND LEVELS OF WORKMANSHIP TO MEET THIS STANDARD. VERIFY DIMENSIONS, CONDITIONS AND FINISHES BEFORE PRICING AND/OR PROCEEDING WITH WORK. DO NOT SCALE FROM DRAWINGS. BRING ANY DISCREPANCIES TO THE ARCHITECT'S
- ATTENTION IMMEDIATELY. COORDINATE LOCATIONS AND QUANTITY OF WORK WITH
- MECHANICAL, ELECTRICAL AND PLUMBING DRAWINGS. PIPING, CONDUIT AND RELATED MECHANICAL AND ELECTRICAL ITEMS SHALL BE CONCEALED WITHIN GYPSUM BOARD FURRING IN FINISHED AREAS WHETHER SHOWN ON THE DRAWINGS OR NOT,
- UNLESS NOTED OTHERWISE. PROVIDE METAL PLATE BACKING AND/OR FIRE TREATED WOOD BLOCKING IN WALLS WHERE WALL-MOUNTED EQUIPMENT OR ARTWORK IS SHOWN ON PLANS OR ELEVATIONS. VERIFY HEIGHT AND LENGTH WITH ACTUAL EQUIPMENT OR ARTWORK.
- REFER TO ENLARGED PLANS FOR FURTHER DESCRIPTION,
- DIMENSIONS AND WALL TYPES ALL INTERIOR PARTITIONS TO BE 0HD UNLESS OTHERWISE NOTED

KEYED NOTES

- 100 METAL PAN STAIR WITH CONCRETE TREADS 101 PROVIDE ELEVATORS - FINAL HOIST WAY DIMENSIONS TO BE DETERMINED PER MANUFACTURER'S REQUIREMENTS
- 102 INFILL EXISTING OPENING WITH BRICK TO MATCH, ALIGN FINISH FACE OF NEW WALL PARTITION WITH FINISH FACE OF EXISTING WALL PARTITION- PATCH AND REPAIR AS REQUIRED
- 106 LINEN CHUTE COORDINATE FLOOR OPENING WITH STRUCTURAL
- 114 MOP SINK SEE PLUMBING DRAWINGS
- 115 PROVIDE 10' DIAMETER REVOLVING DOOR ASSEMBLY 116 CHECK-IN DESK CASEWORK PER HILTON STANDARDS
- 117 SUNDRIES CASEWORK PER HILTON STANDARDS 118 FOOD AND BEVERAGE COOLERS BY OTHERS.
- 120 DOUBLE SIDED GAS FIREPLACE. VENT TO EAST EXTERIOR WALL. COORDINATE WITH MEP DRAWINGS.
- 121 RAISED FLOOR FOR LOUNGE SEATING GLASS PANEL AND METAL RAILING @ PERIMETER
- 122 PANTRY CASEWORK PER HILTON STANDARDS 123 FOOD SERVICE EQUIPMENT BY OTHERS
- 124 ALUMINUM FLOOR HATCH. SEE STRUCTURAL DRAWINGS FOR OPENING FRAMING.
- 125 INFILL EXISTING FLOOR SLAB OPENING SEE STRUCTURAL DWG 127 EXHAUST PENETRATION AS REQUIRED FOR LAUNDRY EQUIPMENT-
- VERIFY SIZE AND LOCATION W/ MECHANICAL 128 WOOD BENCH
- 129 CONCRETE STAIRS WITH GLASS AND METAL RAILINGS
- 130 CONCRETE RAMP WITH GLASS AND METAL RAILINGS
- WOOD SCREEN WALL AROUND ELECTRICAL EQUIPMENT AND TRASH **ENCLOSURE**
- 133 DROP-OFF LANE 134 EXISTING BRICK BEARING WALL TO REMAIN EXPOSED
- 140 NEW RAISED FLOOR TO MATCH EXISTING FIRST FLOOR LEVEL.
- 141 MODIFY EXISTING STOREFRONT TO INSTALL NEW HORIZONTAL MULLION AT 1'-8" A.F.F. INSTALL NEW SPANDREL PANELS BELOW NEW MULLION. INSTALL NEW GLAZING ABOVE NEW MULLION
- 142 REPLACE EXISTING WOOD ENTRY DOORS WITH NEW ALUMINUM DOORS TO MATCH INTERIOR VESTIBULE DOORS. EXISTING
- ALUMINUM FRAME TO REMAIN. 143 PATCH EXISTING CONCRETE STAIR AND STOOP. PROVIDE NEW
- 154 NEW CONCRETE STAIRS SEE FINISH PLAN FOR FINISHES
- 155 NEW ALUMINUM STOREFRONT ENTRY SYSTEM 157 NEW CLEAR INSULATED GLASS IN EXISTING FRAMES
- 159 RAISED CONCRETE PLANTER160 CANOPY OVERHEAD

PLAN LEGEND

○FD FLOOR DRAIN

FEC FIRE EXTINGUISHER CABINET (FEC) ○ FE FIRE EXTINGUISHER (FE)

ALIGN ALIGN FACE OF WALLS

INDICATES ACCESSIBLE GUESTROOM

INDICATES HEARING IMPAIRED GUESTROOM

DESIGN DEVELOPMENT

Drawing Date OCTOBER 15, 2015

BUTTON BLOCK BUILDING - HOTEL

500 N. WATER ST. MILWAUKEE, WI 53202

215021.00

Sheet Title

FLOOR PLAN - FIRST **FLOOR**

Copyright © 2015 Kahler Slater, Inc. All rights reserved. 111 West Wisconsin Avenue, Milwaukee, Wisconsin 53203 Telephone 414.272.2000 Fax 414.272.2001 44 East Mifflin Street, Suite 700, Madison, Wisconsin 53703 Telephone 608.283.6300 Fax 608.283.6317

Sheet No.

1st FLOOR PLAN
1/8" = 1'-0"

GENERAL NOTES - FLOOR PLAN

- 1 BUILDING SHALL BE CONSTRUCTED TO MEET THE REQUIREMENTS
 AND QUALITY LEVEL DESCRIBED IN THE HOMEWOOD SUITES BY
 HILTON DESIGN STANDARDS. PROVIDE APPROPRIATE MATERIALS
- VERIFY DIMENSIONS, CONDITIONS AND FINISHES BEFORE PRICING AND/OR PROCEEDING WITH WORK. DO NOT SCALE FROM DRAWINGS. BRING ANY DISCREPANCIES TO THE ARCHITECT'S ATTENTION IMMEDIATELY.

AND LEVELS OF WORKMANSHIP TO MEET THIS STANDARD.

- 3 COORDINATE LOCATIONS AND QUANTITY OF WORK WITH
- MECHANICAL, ELECTRICAL AND PLUMBING DRAWINGS.

 4 PIPING, CONDUIT AND RELATED MECHANICAL AND ELECTRICAL ITEMS SHALL BE CONCEALED WITHIN GYPSUM BOARD FURRING IN FINISHED AREAS WHETHER SHOWN ON THE DRAWINGS OR NOT, UNLESS NOTED OTHERWISE.
- 5 PROVIDE METAL PLATE BACKING AND/OR FIRE TREATED WOOD BLOCKING IN WALLS WHERE WALL-MOUNTED EQUIPMENT OR ARTWORK IS SHOWN ON PLANS OR ELEVATIONS. VERIFY HEIGHT
- AND LENGTH WITH ACTUAL EQUIPMENT OR ARTWORK.

 REFER TO ENLARGED PLANS FOR FURTHER DESCRIPTION,
- DIMENSIONS AND WALL TYPES

 7 ALL INTERIOR PARTITIONS TO BE 0HD UNLESS OTHERWISE NOTED

KEYED NOTES

100 METAL PAN STAIR WITH CONCRETE TREADS
101 PROVIDE ELEVATORS - FINAL HOIST WAY DIMENSIONS TO BE

- DETERMINED PER MANUFACTURER'S REQUIREMENTS

 106 LINEN CHUTE COORDINATE FLOOR OPENING WITH STRUCTURAL
- DRAWINGS

 125 INFILL EXISTING FLOOR SLAB OPENING SEE STRUCTURAL DWG
- 134 EXISTING BRICK BEARING WALL TO REMAIN EXPOSED
 135 FURR OUT EXISTING WALL TO ALIGN WITH PLANE OF EXISTING PLASTER FURRING REMOVED DURING DEMOLITION
- NEW WINDOW IN EXISTING OPENING. EXTERIOR WOOD TRIM TO REMAIN IN PLACE. SALVAGED WOOD TRIM ON INTERIOR TO BE RE-INSTALLED. WHERE EXISTING WOOD TRIM WAS MISSING OR DAMAGED BEYOND REPAIR, NEW WOOD TRIM TO MATCH IS TO BE INSTALLED
- 137 EXISTING WOOD TRIM SALVAGED FROM DEMO TO BE RE-INSTALLED ON NEW FURRED WALL. WHERE EXISTING WOOD TRIM WAS MISSING OR DAMAGED BEYOND REPAIR, NEW WOOD TRIM TO MATCH IS TO BE
- INSTALLED

 138 NEW WINDOWS IN NEW OPENINGS.

PLAN LEGEND

FEC FIRE EXTINGUISHER CABINET (FEC

INDICATES ACCESSIBLE GUESTROOM

INDICATES HEARING IMPAIRED GUESTROOM

GUESTROOM TYPE % - TOTAL

○ FE FIRE EXTINGUISHER (FE)

ALIGN FACE OF WALLS

DOUBLE QUEEN SUITE

KING STUDIO - ADA

KING STUDIO SUITE

KING SUITE - ADA

KING SUITE

DOUBLE QUEEN SUITE - ADA

○FD FLOOR DRAIN

161 PAINTED STEEL BEAM AND MONOLITHIC GLASS CANOPY - WELDED TO STEEL CHANNEL AND THROUGH-BOLTED TO EXISTING BRICK WALL ASSEMBLY

NOT FOR CONSTRUCTION

Revisions

DESIGN DEVELOPMENT

Drawing Date

OCTOBER 15, 2015

BUTTON BLOCK BUILDING - HOTEL

500 N. WATER ST. MILWAUKEE, WI 53202

Project No.

215021.00

82%

12%

1% 100% Sheet Title


TYPICAL GUEST
FLOOR PLAN

Copyright © 2015 Kahler Slater, Inc. All rights reserved.

111 West Wisconsin Avenue, Milwaukee, Wisconsin 53203
Telephone 414.272.2000 Fax 414.272.2001

44 East Mifflin Street, Suite 700, Madison, Wisconsin 53703
Telephone 608.283.6300 Fax 608.283.6317

Sheet No.
A1.12

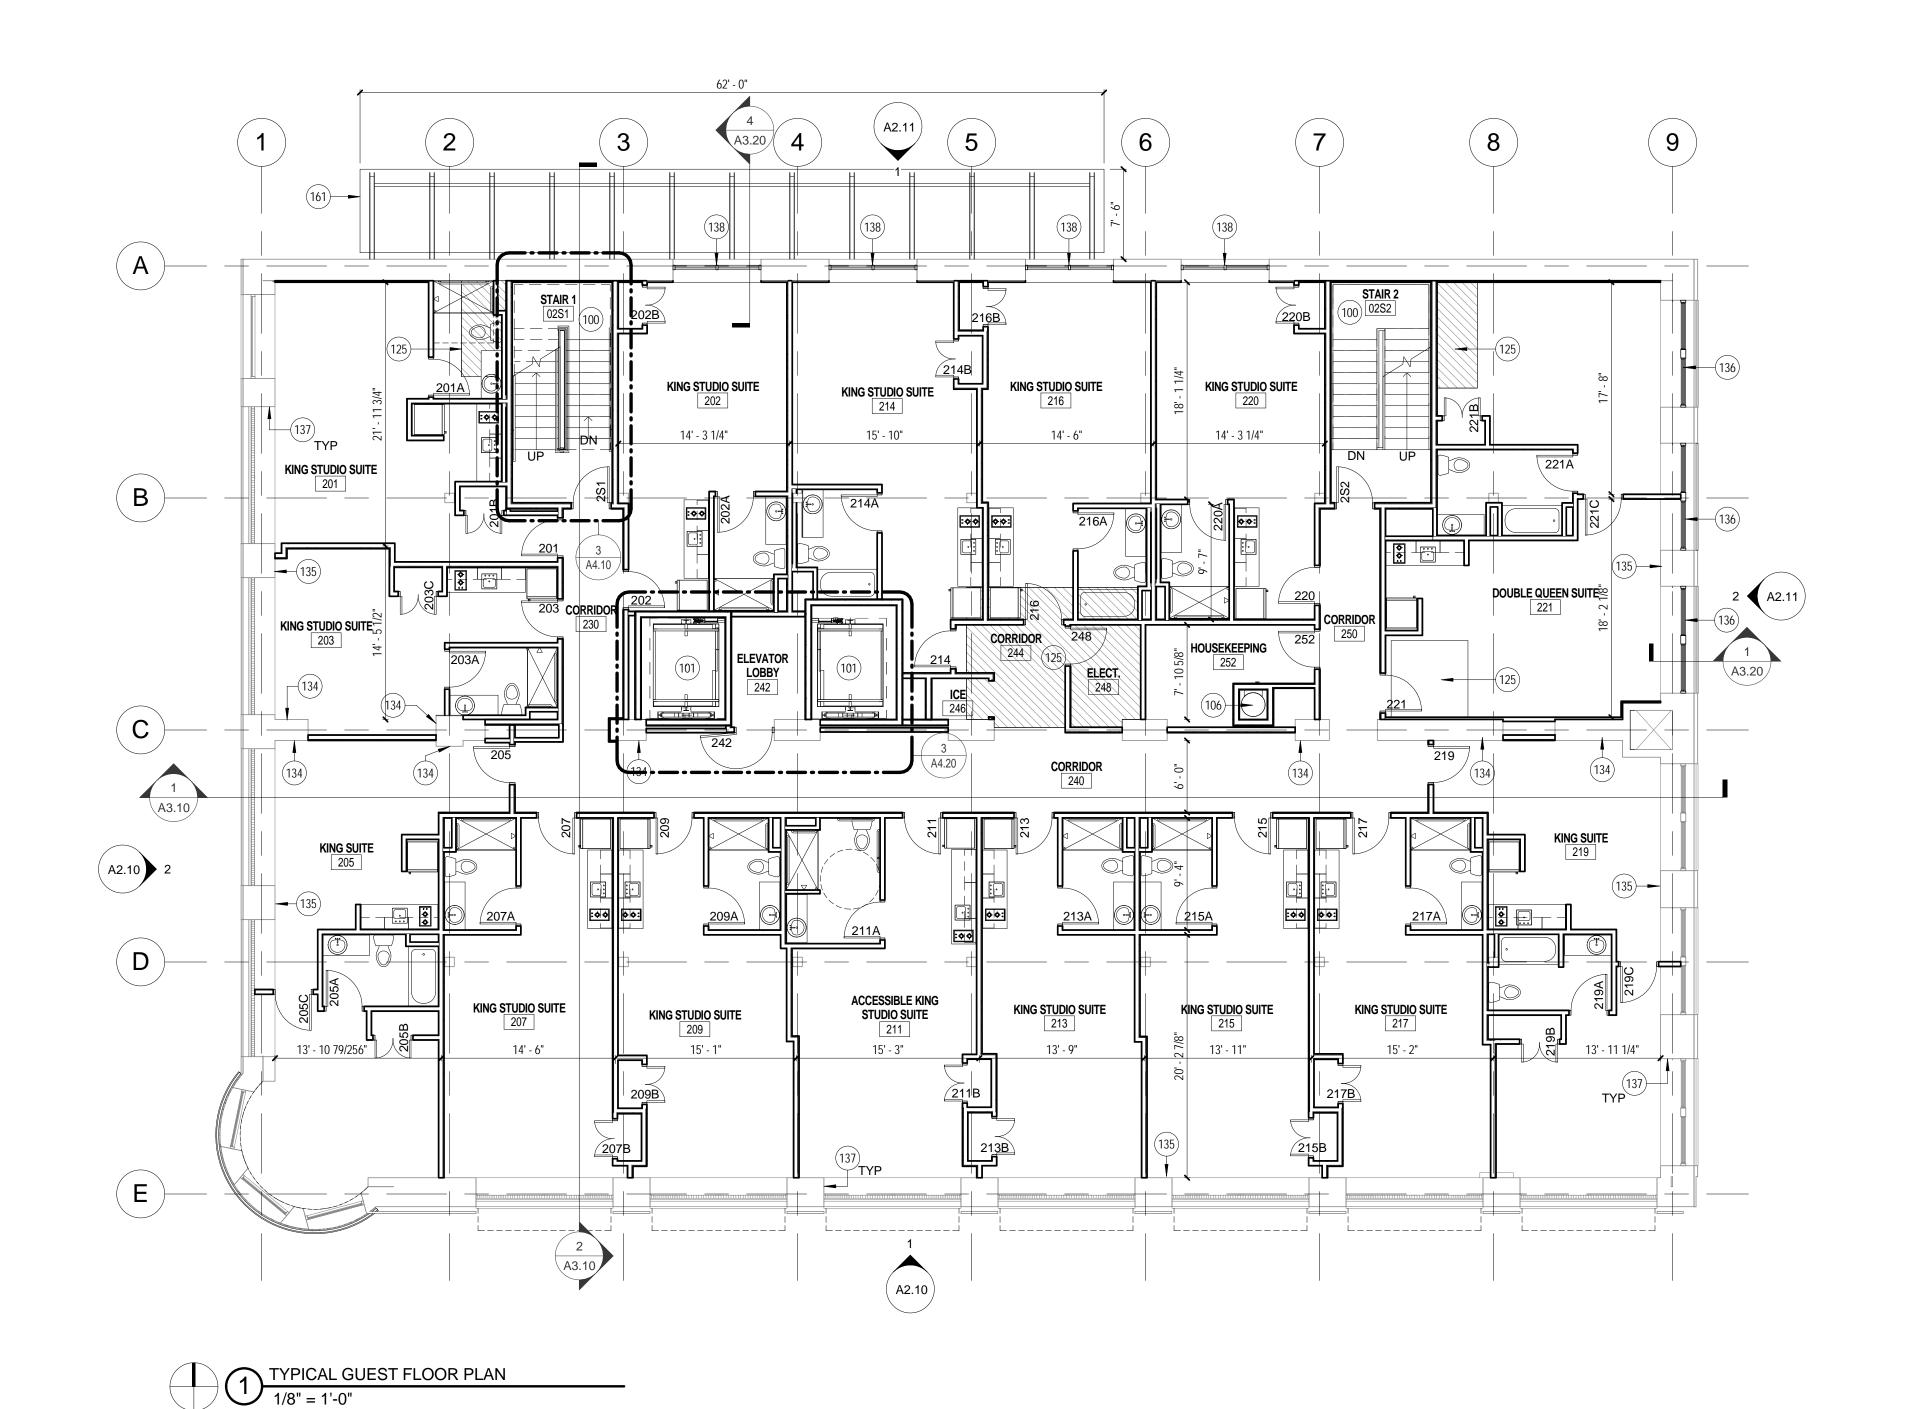

1 COORDINATE LOCATION AND SIZE OF ALL OPENINGS THROUGH ROOF WITH MECHANICAL CONTRACTOR. PROVIDE APPROPRIATE FLASHING

AS REQUIRED TO MAKE WATERTIGHT.

2 PROVIDE ROOF INSULATION SADDLES AT ANY ROOF INTERFERENCES.

SLOPE ON SADDLE TO BE 1/2" PER FOOT.



KEYED NOTES

144 ROOF WITH NEW EPDM ROOFING SYSTEM (ROOF ASSEMBLY 1) - PROVIDE MIN R-24 ROOF INSULATION

145 PROVIDE NEW GUTTER AND DOWNSPOUTS146 ROOF ACCESS HATCH

147 ELEVATOR HOIST WAY ROOF (ROOF ASSEMBLY 2

148 LINEN CHUTE VENT CAP

151 GUARDRAIL - 1 1/2" PIPE AT 3'-6" WITH INTERMEDIATE RAIL - MOUNTED TO SIDE OF PARAPET WALL
 156 REPLACE EXISTING ASPHALT SHINGLES OF TURRET ROOF WITH NEW

SIMILAR SHINGLES.

158 NEW 10' FLAGPOLE SECURELY MOUNTED IN TURRET ROOF FRAMING.

NOI FOR CONSTRUCTION

Revisions

DESIGN DEVELOPMENT

Drawing Date
OCTOBER 15, 2015

BUTTON BLOCK BUILDING - HOTEL

500 N. WATER ST. MILWAUKEE, WI 53202

Project No.

215021.00 Sheet Title


ROOF PLAN

Copyright © 2015 Kahler Slater, Inc. All rights reserved.

111 West Wisconsin Avenue, Milwaukee, Wisconsin 53203
Telephone 414.272.2000 Fax 414.272.2001

44 East Mifflin Street, Suite 700, Madison, Wisconsin 53703
Telephone 608.283.6300 Fax 608.283.6317

Sheet No.

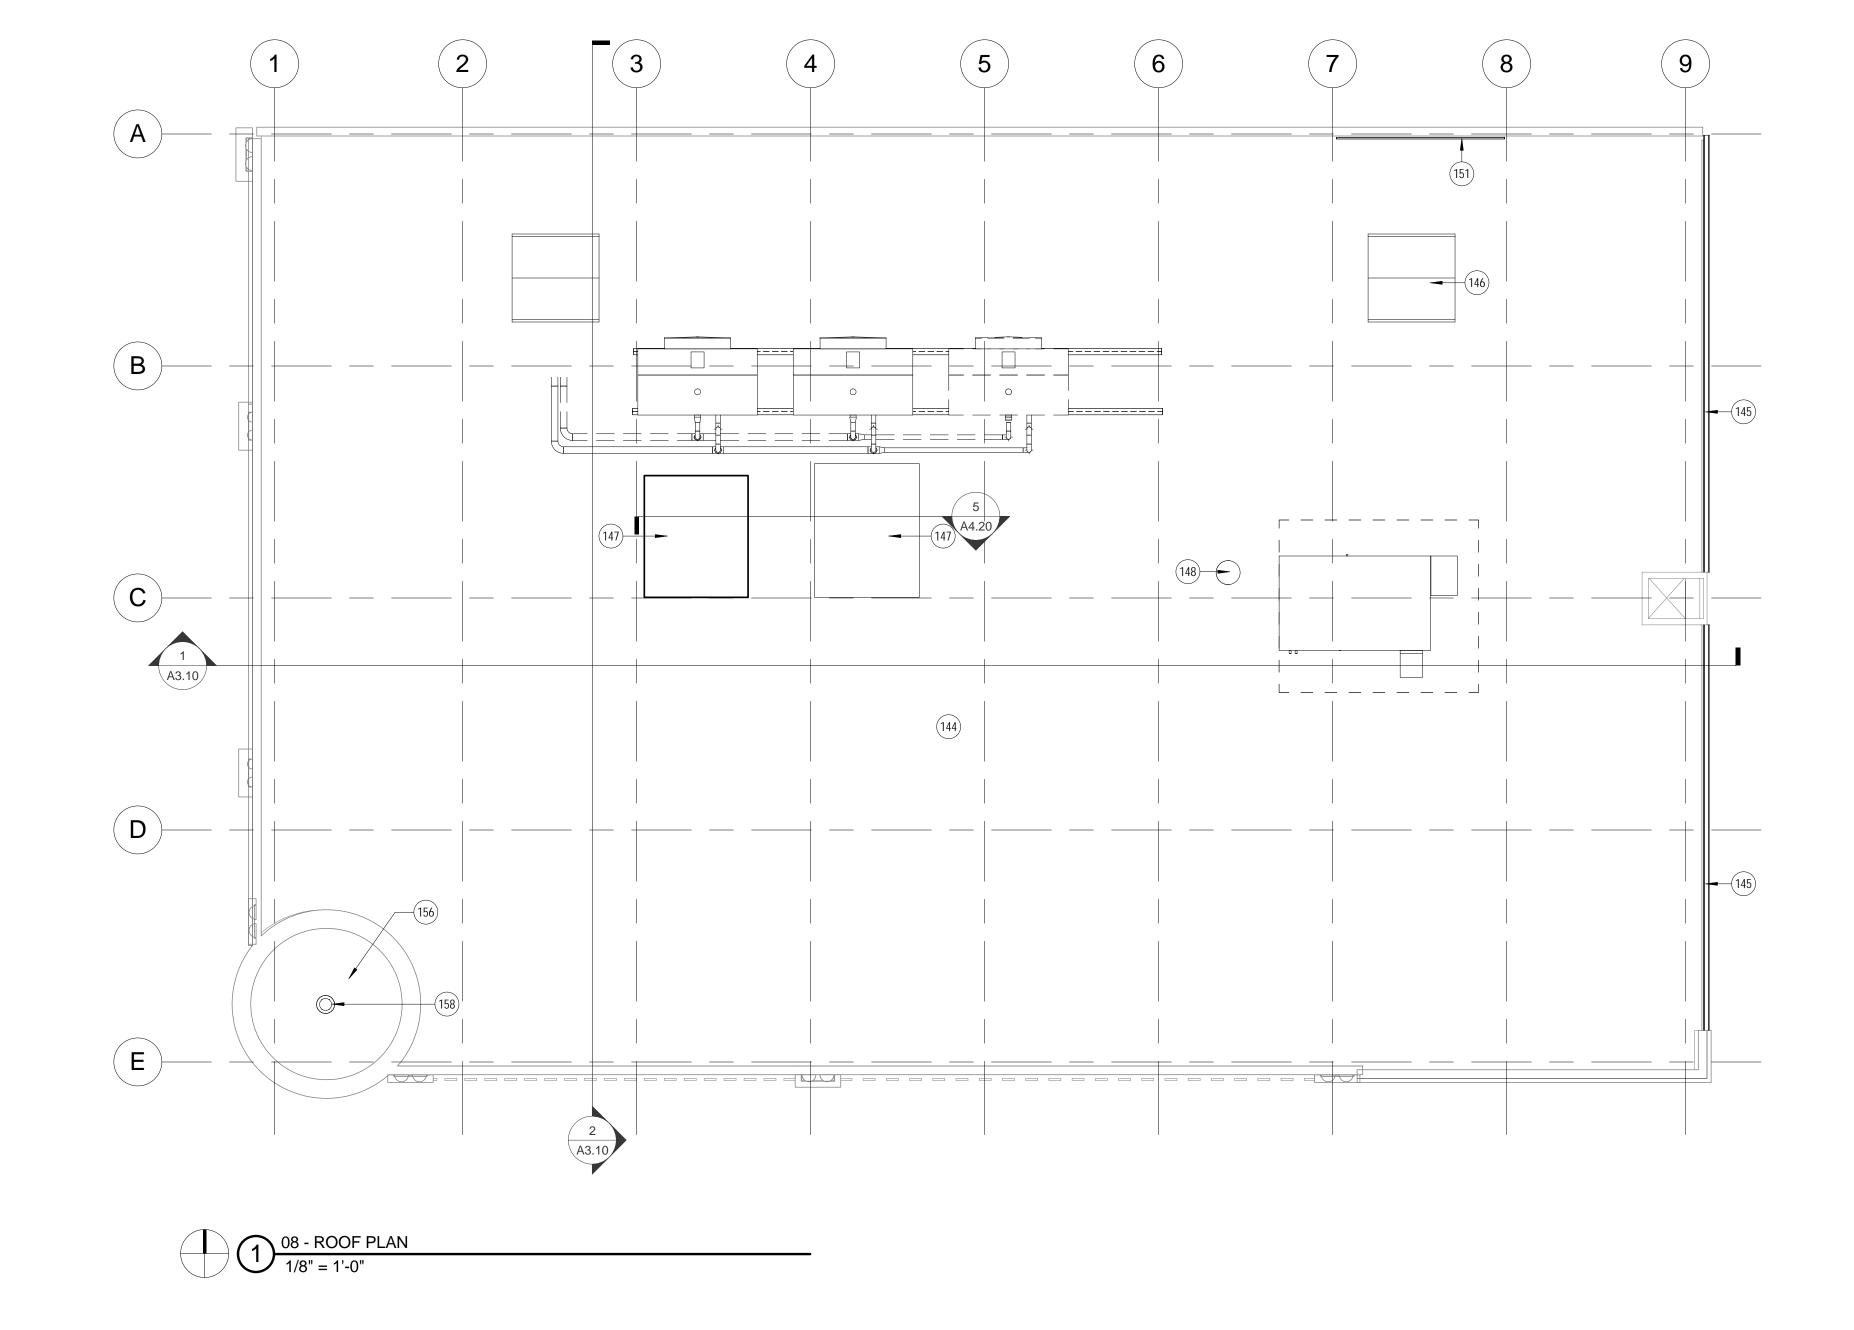



ASSEMBLIES AND COMPONENTS

AWNINGS - NEW FABRIC AWNING OVER EXISTING METAL FRAME



A3.10

4 SCREEN WALL VIEW FACING SOUTHEAST

FLAGPOLE 01

DOWNSPOUT 01

SEVENTH FLOOR
182' - 4"

SIXTH FLOOR 169' - 11"

BUILDING SIGN 01 -

FIFTH FLOOR 157' - 6"

FOURTH FLOOR 145' - 1"

THIRD FLOOR 131' - 10"

SECOND FLOOR 118' - 7"

GROUND LEVEL 100' - 0"

2 EAST ELEVATION

1/8" = 1'-0"

MTL PANEL 01—



CANOPY VIEW FACING SOUTHEAST

—<u>GUTTER 01</u>

-DOWNSPOUT 01

— <u>HISTORIC MASONRY REPOINTING</u>

— GLAZING ASSEMBLY 02A

—<u>CANOPY 01</u>———

—<u>CONCRETE 01</u>

MTL PANEL 01

MTL PANEL 01

— GLAZING ASSEMBLY 01A

LOUVER 01

—<u>WOOD 01</u>






BUTTON BLOCK

BUILDING - HOTEL

ELEVATIONS

Copyright © 2015 Kahler Slater, Inc. All rights reserved. 111 West Wisconsin Avenue, Milwaukee, Wisconsin 53203 Telephone 414.272.2000 Fax 414.272.2001 44 East Mifflin Street, Suite 700, Madison, Wisconsin 53703 Telephone 608.283.6300 Fax 608.283.6317

Sheet No. A2.11

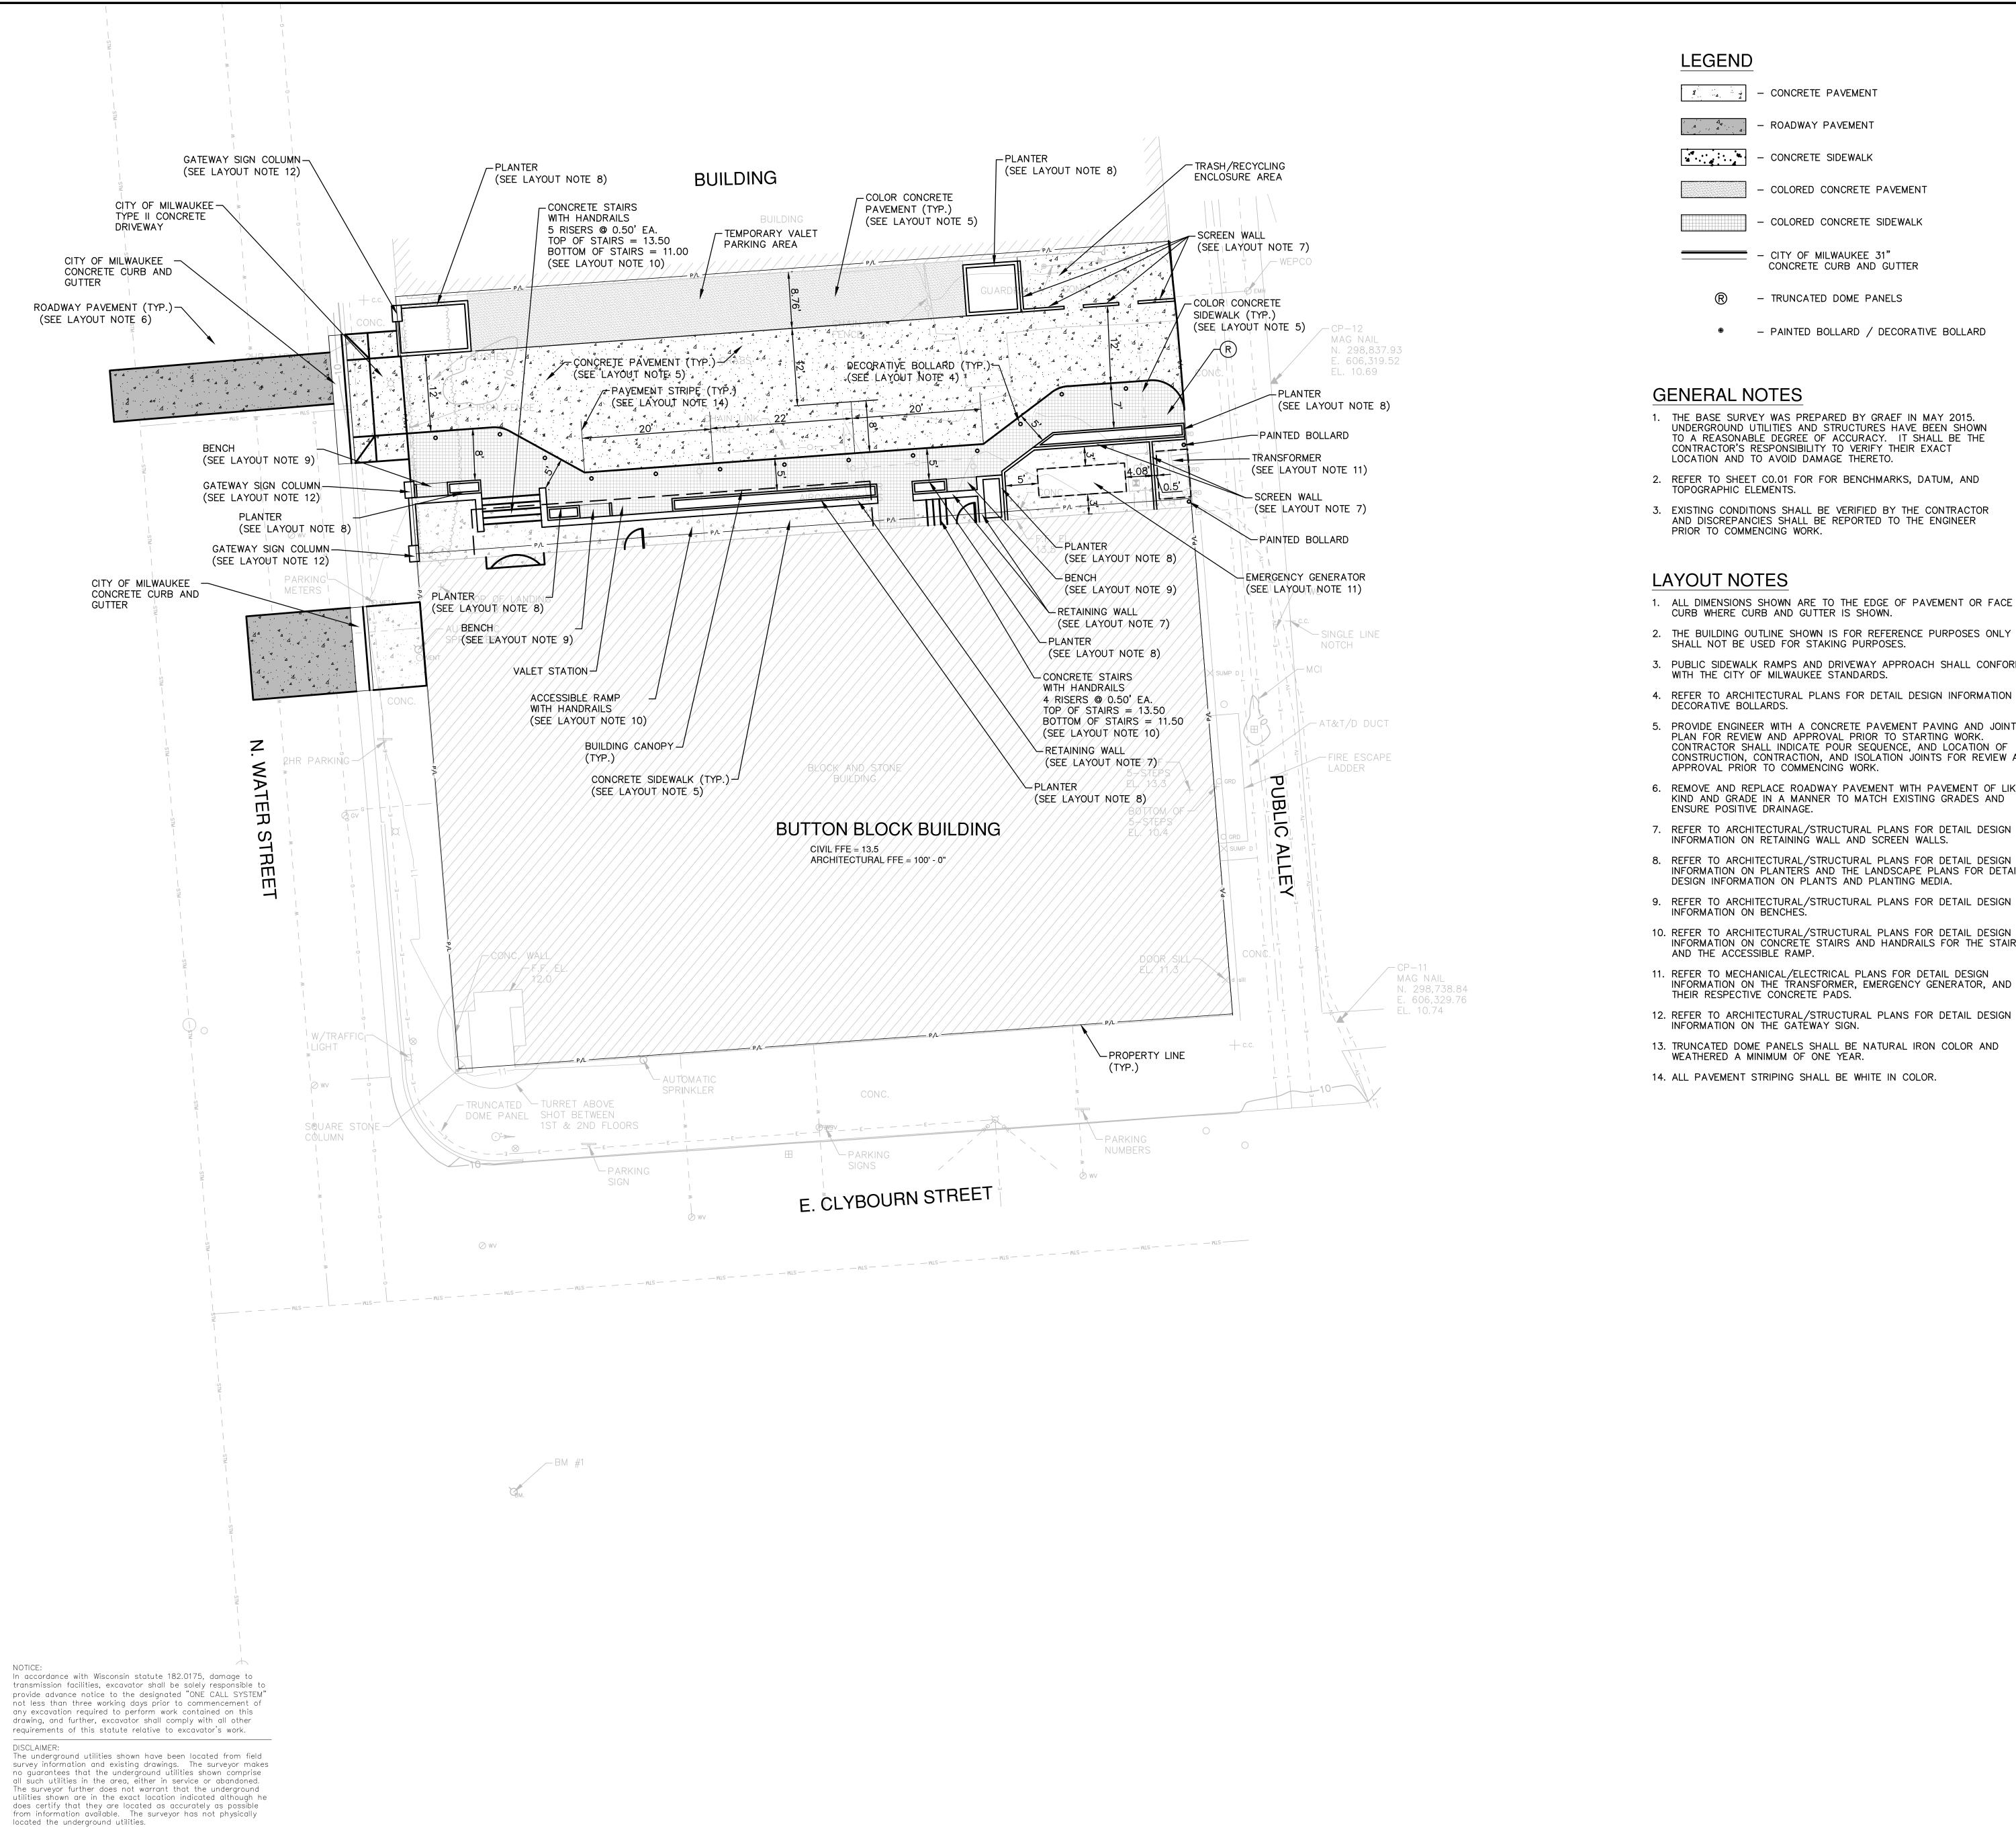



CONCRETE PAVEMENT

- ROADWAY PAVEMENT

- CONCRETE SIDEWALK

- COLORED CONCRETE PAVEMENT

- COLORED CONCRETE SIDEWALK — – CITY OF MILWAUKEE 31" CONCRETE CURB AND GUTTER

TRUNCATED DOME PANELS

● - PAINTED BOLLARD / DECORATIVE BOLLARD

GENERAL NOTES

1. THE BASE SURVEY WAS PREPARED BY GRAEF IN MAY 2015. UNDERGROUND UTILITIES AND STRUCTURES HAVE BEEN SHOWN TO A REASONABLE DEGREE OF ACCURACY. IT SHALL BE THE CONTRACTOR'S RESPONSIBILITY TO VERIFY THEIR EXACT LOCATION AND TO AVOID DAMAGE THERETO.

- 2. REFER TO SHEET CO.01 FOR FOR BENCHMARKS, DATUM, AND TOPOGRAPHIC ELEMENTS.
- 3. EXISTING CONDITIONS SHALL BE VERIFIED BY THE CONTRACTOR AND DISCREPANCIES SHALL BE REPORTED TO THE ENGINEER PRIOR TO COMMENCING WORK.

LAYOUT NOTES

1. ALL DIMENSIONS SHOWN ARE TO THE EDGE OF PAVEMENT OR FACE OF CURB WHERE CURB AND GUTTER IS SHOWN.

- 2. THE BUILDING OUTLINE SHOWN IS FOR REFERENCE PURPOSES ONLY AND SHALL NOT BE USED FOR STAKING PURPOSES.
- 3. PUBLIC SIDEWALK RAMPS AND DRIVEWAY APPROACH SHALL CONFORM WITH THE CITY OF MILWAUKEE STANDARDS.
- 4. REFER TO ARCHITECTURAL PLANS FOR DETAIL DESIGN INFORMATION ON DECORATIVE BOLLARDS.
- 5. PROVIDE ENGINEER WITH A CONCRETE PAVEMENT PAVING AND JOINTING PLAN FOR REVIEW AND APPROVAL PRIOR TO STARTING WORK. CONTRACTOR SHALL INDICATE POUR SEQUENCE, AND LOCATION OF CONSTRUCTION, CONTRACTION, AND ISOLATION JOINTS FOR REVIEW AND APPROVAL PRIOR TO COMMENCING WORK.
- 6. REMOVE AND REPLACE ROADWAY PAVEMENT WITH PAVEMENT OF LIKE KIND AND GRADE IN A MANNER TO MATCH EXISTING GRADES AND ENSURE POSITIVE DRAINAGE.
- 7. REFER TO ARCHITECTURAL/STRUCTURAL PLANS FOR DETAIL DESIGN INFORMATION ON RETAINING WALL AND SCREEN WALLS.
- 8. REFER TO ARCHITECTURAL/STRUCTURAL PLANS FOR DETAIL DESIGN INFORMATION ON PLANTER'S AND THE LANDSCAPE PLANS FOR DETAIL DESIGN INFORMATION ON PLANTS AND PLANTING MEDIA.
- 9. REFER TO ARCHITECTURAL/STRUCTURAL PLANS FOR DETAIL DESIGN INFORMATION ON BENCHES.
- 10. REFER TO ARCHITECTURAL/STRUCTURAL PLANS FOR DETAIL DESIGN INFORMATION ON CONCRETE STAIRS AND HANDRAILS FOR THE STAIRS
- AND THE ACCESSIBLE RAMP. 11. REFER TO MECHANICAL/ELECTRICAL PLANS FOR DETAIL DESIGN
- THEIR RESPECTIVE CONCRETE PADS. 12. REFER TO ARCHITECTURAL/STRUCTURAL PLANS FOR DETAIL DESIGN
- INFORMATION ON THE GATEWAY SIGN.
- 13. TRUNCATED DOME PANELS SHALL BE NATURAL IRON COLOR AND WEATHERED A MINIMUM OF ONE YEAR.





One Honey Creek Corporate Center 125 South 84th Street, Suite 401 Milwaukee, WI 53214-1470 414 / 259 1500 414 / 259 0037 fax

www.graef-usa.com

SCALE: 1" = 10'

DESIGN DEVELOPMENT

Drawing Date

OCTOBER 14, 2015

BUTTON BLOCK -BUILDING HOTEL

500 N. WATER ST.

MILWAUKEE, WI

215021.00

Sheet Title

SITE LAYOUT PLAN

111 West Wisconsin Avenue, Milwaukee, Wisconsin 53203 Telephone 414.272.2000 Fax 414.272.2001 44 East Mifflin Street, Suite 700, Madison, Wisconsin 53703

Telephone 608.283.6300 Fax 608.283.6317

C2.00

-PLANT SIZES SPECIFIED ARE MINIMUM ACCEPTABLE

GROUND COVER / ORNAMENTAL GRASS / PERENNIAL PLANTING DETAIL

requirements of this statute relative to excavator's work.

The underground utilities shown have been located from field survey information and existing drawings. The surveyor makes

no guarantees that the underground utilities shown comprise

all such utilities in the area, either in service or abandoned. The surveyor further does not warrant that the underground utilities shown are in the exact location indicated although he does certify that they are located as accurately as possible from information available. The surveyor has not physically

DISCLAIMER:

located the underground utilities.

LANDSCAPE LEGEND

LIMIT OF LANDSCAPE CONSTRUCTION


ORNAMENTAL TREE



ORNAMENTAL GRASS





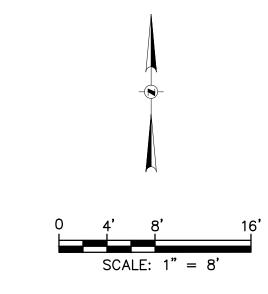

GENERAL NOTES

- 1. THE BASE SURVEY WAS PREPARED BY GRAEF IN MAY 2015. UNDERGROUND UTILITIES AND STRUCTURES HAVE BEEN SHOWN TO A REASONABLE DEGREE OF ACCURACY. IT SHALL BE THE CONTRACTOR'S RESPONSIBILITY TO VERIFY THEIR EXACT LOCATION AND TO AVOID DAMAGE THERETO.
- 2. REFER TO SHEET CO.01 FOR FOR BENCHMARKS, DATUM, AND TOPOGRAPHIC ELEMENTS.
- 3. EXISTING CONDITIONS SHALL BE VERIFIED BY THE CONTRACTOR AND DISCREPANCIES SHALL BE REPORTED TO THE ENGINEER PRIOR TO COMMENCING WORK.

PLANT LIST					
SYMBOL	BOTANICAL NAME	COMMON NAME	SIZE	SPACING	MATURE SIZE
ORNAMEN	TAL TREES				
APS	Acer pseudo-sieboldiana	Korean Maple	8'-10' clump BB	as shown	20'H X 15'W
PERENNIAI	LS				
HFW	Hosta sieboldiana 'Frances Williams'	Frances Williams Hosta	1 gal.	24"	30"h x 24"w
ORNAMEN	TAL GRASSES & SEDGES				
CEB	Carex elata 'Bowles Golden'	Bowles Golden Sedge	1 gal.	24"	24"h x 24"w
VINES/CLII	MBERS				
PTR	Parthenocissus tricuspidata	Boston lvy	1 gal.	as shown	30'-50' tall

LANDSCAPING NOTES:

- 1. BECOME AWARE OF ALL RELATED EXISTING AND PROPOSED CONDITIONS, UTILITIES, PIPES AND STRUCTURES, ETC. PRIOR TO BIDDING AND CONSTRUCTION.
- 2. INSPECT THE SITE PRIOR TO COMMENCING WORK. DOCUMENT IN WRITING AND PHOTOGRAPH ALL EXISTING CONDITIONS WITHIN, AND IN AREAS ADJACENT TO, THE LIMITS OF CONSTRUCTION. DIGITAL COPIES OF PHOTOGRAPHS SHALL BE PROVIDED TO THE LANDSCAPE ARCHITECT. THE LANDSCAPE CONTRACTOR SHALL BE HELD RESPONSIBLE FOR ANY DAMAGES NOT DOCUMENTED IN THE SUBMITTAL PRIOR TO COMMENCEMENT OF DEMOLITION ACTIVITIES.
- 3. CONTACT ALL UTILITY COMPANIES FOR FIELD LOCATION OF ALL PUBLIC UNDERGROUND UTILITY LINES, INCLUDING DEPTHS OF SAID, WITHIN THE LIMITS OF CONSTRUCTION. THE LANDSCAPE CONTRACTOR SHALL BE RESPONSIBLE FOR CONTACTING THE OWNER'S REPRESENTATIVE FOR FIELD LOCATION OF ALL PRIVATE UTILITIES WITHIN THE LIMITS OF CONSTRUCTION. LANDSCAPE CONTRACTOR SHALL TAKE SOLE RESPONSIBILITY FOR ANY AND ALL COST OR OTHER LIABILITIES INCURRED DUE TO DAMAGE OF SAID UTILITIES/STRUCTURES/ETC.
- 4. DO NOT WILLFULLY PROCEED WITH CONSTRUCTION AS DESIGNED WHEN IT IS APPARENT THAT UNKNOWN OBSTRUCTIONS AND/OR GRADE DIFFERENCES EXIST THAT MAY NOT HAVE BEEN KNOWN DURING DESIGN. SUCH CONDITIONS SHALL BE IMMEDIATELY BROUGHT TO THE ATTENTION OF THE OWNER'S REPRESENTATIVE FOR CLARIFICATION. THE LANDSCAPE CONTRACTOR SHALL ASSUME FULL RESPONSIBILITY FOR ALL LIABILITIES, INCLUDING NECESSARY REVISIONS DUE TO FAILURE TO GIVE SUCH NOTIFICATION.
- 5. COMMENCEMENT OF WORK CONSTITUTES ACCEPTANCE OF SITE CONDITIONS, BOTH SURFACE AND SUBSURFACE. NO EXTRA PAYMENT SHALL ACCRUE BY VIRTUE OF UNKNOWN CONDITIONS FOR DIFFICULTIES IN PERFORMING THE CONTRACTED SCOPE OF WORK.
- 6. COORDINATE WITH SUBCONTRACTORS AS REQUIRED TO ACCOMPLISH LANDSCAPE WORK, PLANTING WORK, AND RELATED OPERATIONS WITHIN THE CONTRACTED SCOPE.
- 7. REFER TO GEOTECHNICAL REPORT FOR INFILTRATION AND SOIL TYPES / CONDITIONS.
- 8. SEE SPECIFICATIONS AND DETAILS FOR PLANTING METHODS, REQUIREMENTS, SOIL TESTING, MATERIALS, EXECUTION AND PLANT PROTECTION, PLANT STAKING METHODS, PLANT PIT DIMENSIONS, BACKFILL AND OTHER RELATED REQUIREMENTS.
- 9. THE ACCEPTABLE TOLERANCES FOR THIS PROJECT ARE MINIMAL AND SPECIFIC LAYOUT IS REQUIRED AS SHOWN ON THE LAYOUT, PLANTING, AND OTHER PLANS. PLANTS SHALL BE SPACED AS PER PLANS.
- 10. PLANT NAMES MAY BE ABBREVIATED ON THE DRAWINGS. SEE PLANT LIST FOR SYMBOLS, ABBREVIATIONS, BOTANICAL/COMMON NAMES, SIZES, ESTIMATED QUANTITIES (IF GIVEN) AND OTHER REMARKS.
- 11. FURNISH ALL PLANT MATERIALS FREE OF PESTS OR PLANT DISEASES. MAINTAIN AND WARRANT ALL PLANT MATERIALS PER THE SPECIFICATIONS FOR ONE COMPLETE GROWING SEASON FOLLOWING INSTALLATION AND OWNER'S ACCEPTANCE. ALL PLANTS SHALL BE SUBJECT TO OWNER'S ACCEPTANCE PRIOR TO INSTALLATION.
- 12. ALL PLANT BEDS AND TREE PLANTING PITS ARE TO RECEIVE 3" DEEP LAYER OF SHREDDED HARDWOOD BARK MULCH AS DEFINED IN WRITTEN SPECIFICATIONS.
- 13. FORM 72-INCH, OR AS OTHERWISE INDICATED, WATERING BASIN AROUND ALL TREES NOT INSTALLED IN PAVED AREAS.
- 14. FINE GRADE, RAKE AND BE RESPONSIBLE FOR POSITIVE DRAINAGE AWAY FROM ALL STRUCTURES AND THROUGHOUT SITE WITHIN THE LIMITS OF CONSTRUCTION, WITH ACCURATELY SET FLOW LINES. NO LOW SPOTS OR PONDING OF SURFACE WATER WILL BE ACCEPTED IN THE FINAL WORK. NO ROCKS OR DEBRIS WILL BE ACCEPTED. FINAL GRADE TOLERANCES ARE +/-0.1 FOOT MAXIMUM.
- 15. WHERE PROVIDED, AREA TAKEOFFS AND PLANT QUANTITY ESTIMATES ARE FOR INFORMATION ONLY. LANDSCAPE CONTRACTOR IS RESPONSIBLE TO CONDUCT QUANTITY TAKE—OFFS FOR ALL PLANT MATERIALS AND SIZES SHOWN ON PLANS. THE PLANS (PLANT SYMBOLS) TAKE PRECEDENCE IN CASE OF ANY DISCREPANCIES BETWEEN CALLOUTS, THE PLANT LIST, AND THE PLANS.
- 16. COORDINATE WITH OTHER TRADES THE INSTALLATION OF PLANT MATERIAL WITH INSTALLATION OF ALL ADJACENT PAVEMENTS, DRAINAGE CURB AND RELATED STRUCTURES. DAMAGE CAUSED DURING LANDSCAPE INSTALLATION TO EXISTING CONDITIONS AND IMPROVEMENTS IS THE RESPONSIBILITY OF THE LANDSCAPE CONTRACTOR.
- 17. UNLESS OTHERWISE INDICATED: ALL SHRUBS, PERENNIALS AND ORNAMENTAL GRASSES SHALL BE PLACED IN STRAIGHT ROWS, EQUALLY SPACED; AND ALL PLANTING AREAS, INCLUDING PLANTING BEDS, SHALL RECEIVE SOIL AMENDMENTS AS DESCRIBED IN WRITTEN SPECIFICATIONS.
- 18. "RESTORE" ALL AREAS OF THE SITE, OR ADJACENT AREAS, WHERE DISTURBED.
- 19. TAKE NECESSARY SCHEDULING AND OTHER PRECAUTIONS TO AVOID WINTER, CLIMATIC, OR OTHER DAMAGE TO PLANTS.
- 20. PLANT SUBSTITUTIONS WILL NOT BE PERMITTED UNLESS IT CAN BE VERIFIED UNEQUIVOCALLY THAT THE PLANTS ARE NOT AVAILABLE FROM NURSERY SOURCES LOCATED A REASONABLE DISTANCE FROM THE PROJECT SITE. IF THIS SHOULD HAPPEN, ANY PROPOSED PLANT SUBSTITUTION WILL REQUIRE PRIOR REVIEW AND ACCEPTANCE BY THE PROJECT LANDSCAPE ARCHITECT.
- 21. CONTRACTOR SHALL DETERMINE THE NEED FOR TREE STAKING. IF DETERMINED NECESSARY, PROVIDE TREE STAKING AS DESCRIBED IN WRITTEN SPECIFICATIONS.
- 22. SEE WRITTEN SPECIFICATIONS FOR DETAILED SCHEDULE OF SERVICES.

SET ROOT BALL ONTO UNDISTURBED SOIL

TREE PLANTING DETAIL

Kahler Slater



One Honey Creek Corporate Center 125 South 84th Street, Suite 401 Milwaukee, WI 53214-1470 414 / 259 1500 414 / 259 0037 fax

www.graef-usa.com

DESIGN DEVELOPMENT

Drawing Date OCTOBER 14, 2015

BUTTON BLOCK -**BUILDING HOTEL**

500 N. WATER ST.

MILWAUKEE, WI

215021.00

Project No.

Sheet Title

SITE LANDSCAPE PLAN

111 West Wisconsin Avenue, Milwaukee, Wisconsin 53203 Telephone 414.272.2000 Fax 414.272.2001

44 East Mifflin Street, Suite 700, Madison, Wisconsin 53703

Telephone 608.283.6300 Fax 608.283.6317

L1.00