

220519 BRIA TRINITY VILLAGE VISUAL SEPERATION WALL

7500 W DEAN RD, MILWAUKEE, WI 53223

BUILDING PERMIT

ISSUE DATE - JULY 19, 2022

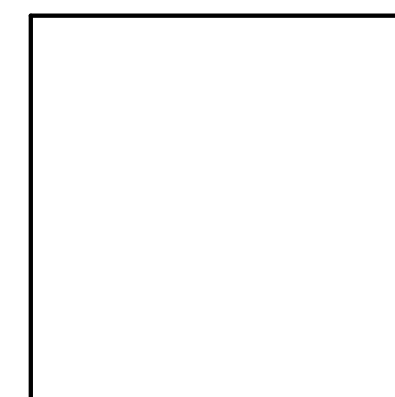
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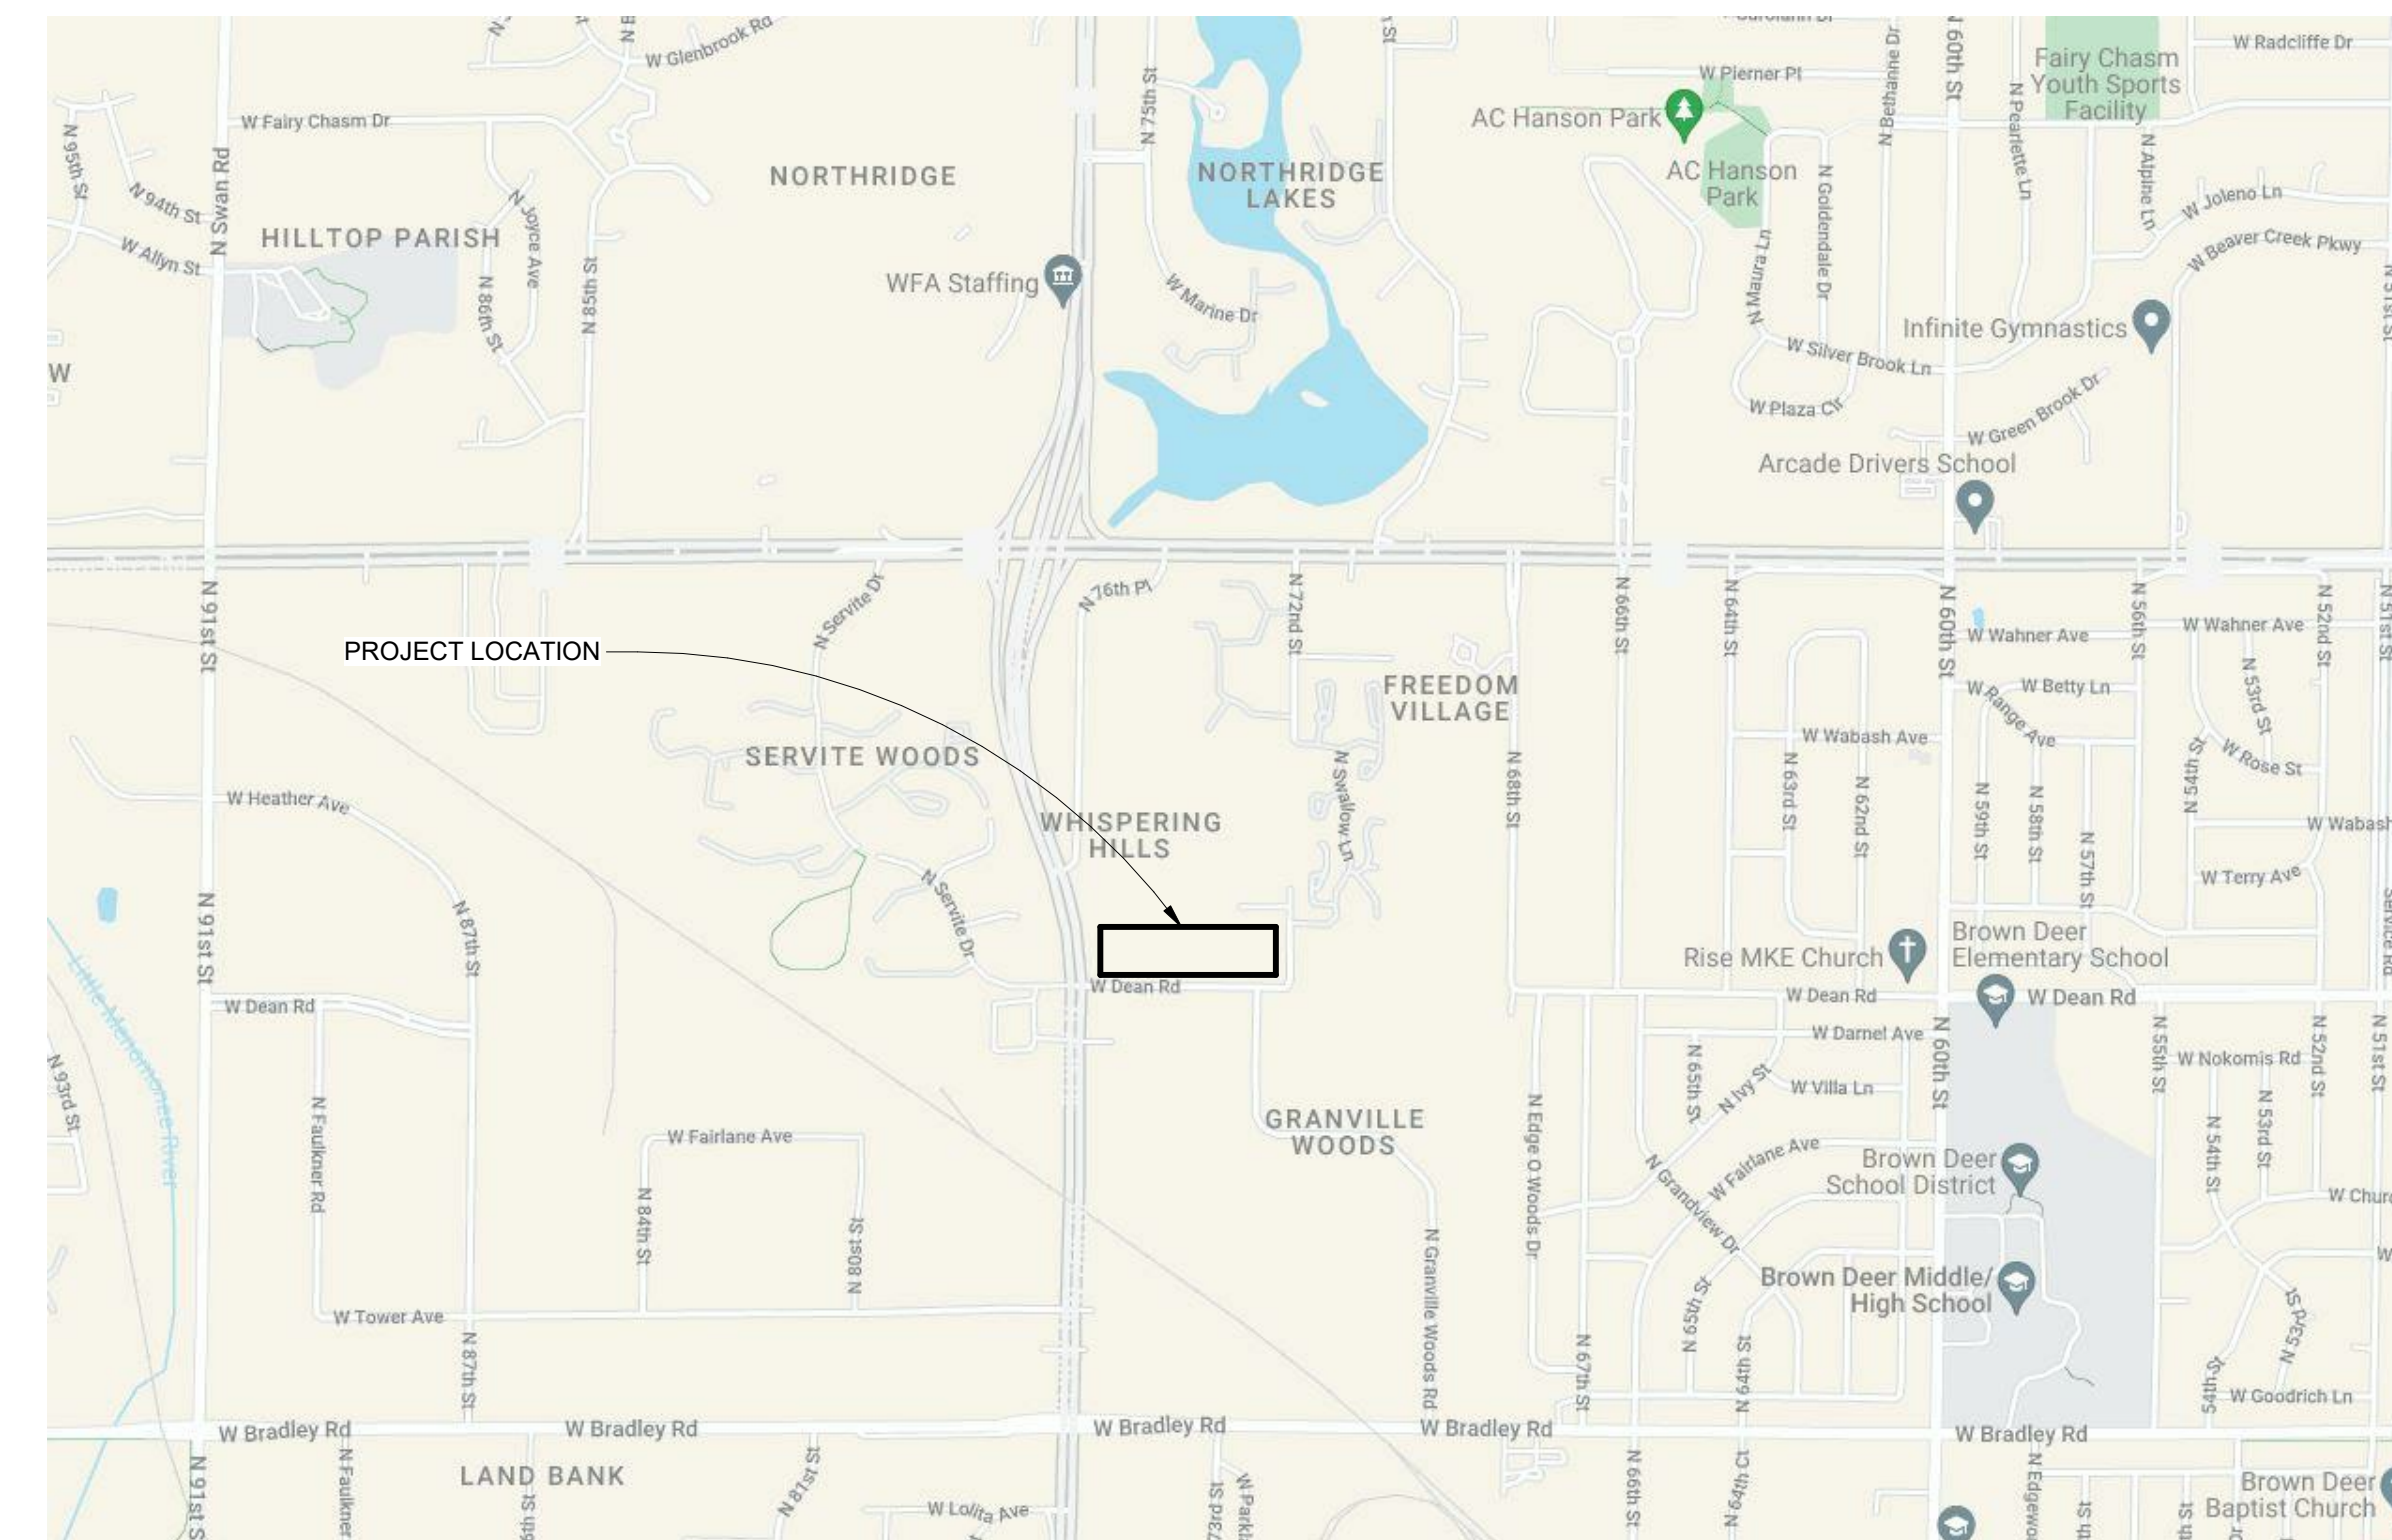
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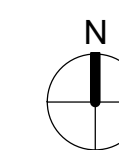


ARCHITECT
RINKA CHUNG ARCHITECTURE INC.
756 N MILWAUKEE STREET
SUITE 250
MILWAUKEE, WI 53202
(414) 431-8101

△ Revisions



PROJECT LOCATION MAP



BUILDING PERMIT

BRIA TRINITY VILLAGE

7500 W DEAN RD, MILWAUKEE, WI 53223

Date Issued: 07/19/22

RINKA project #: 220519

Sheet Title

TITLE SHEET AND PROJECT INFORMATION

Sheet #

G1-01

SYMBOL IDENTIFICATION	
NEW STRUCTURAL GRIDLINE REFERENCE <p>NUMBER OR LETTER GRID LINE</p>	CEILING HEIGHT REFERENCE <p>CEILING HEIGHT CEILING ASSEMBLY TYPE - REFER TO SHEET A0-01</p>
EXISTING STRUCTURAL GRIDLINE REFERENCE <p>NUMBER OR LETTER GRID LINE</p>	DETAIL REFERENCE <p>DRAWING NUMBER SHEET NUMBER</p>
FINISH FLOOR ELEVATION - HEIGHT TAG <p>ELEVATION IN FEET/INCHES</p>	SECTION REFERENCE <p>DRAWING NUMBER SHEET NUMBER</p>
ROOM REFERENCE <p>ROOM NAME ROOM NUMBER</p>	ELEVATION REFERENCE <p>DRAWING NUMBER SHEET NUMBER</p>
ARCHITECTURAL WALL ASSEMBLY / PARTITION TYPE REFERENCE <p>PARTITION TYPE ARCHITECTURAL WALL</p>	WINDOW TAG <p>WINDOW TYPE WINDOW MARK</p>
BUILDING SECTION TARGET ELEVATION <p>LEVEL ANNOTATION TARGET ELEVATION</p>	FIRE EXTINGUISHER FE-1; FIRE EXTINGUISHER & CABINET FE-2; FIRE EXTINGUISHER & BRACKET <p>TYPE</p>
REVISION REFERENCE <p>REVISION NUMBER</p>	REVISION CLOUD
	CENTERLINE
	FINISH TAG
	DOOR TAG
	FLOOR TAG

MATERIAL IDENTIFICATION		
	CONCRETE	
	PRE CAST CONCRETE (SECTION)	
	GYP SUM WALL BOARD	
	PLYWOOD	
	SPRAY APPLIED FOAM INSULATION / VAPOR BARRIER	
	WOOD SECTION	

ABBREVIATIONS							
AC	AIR CONDITIONING	CORR	CORRIDOR	HVAC	HEATING, VENTILATION & AIR CONDITIONING	RCP	REFLECTED CEILING PLAN
AB	ANCHOR BOLT	CU FT	CUBIC FOOT	IB	INSIDE DIAMETER	RD	ROOF DRAIN
ABY	ABOVE	CU YD	CUBIC YARD	INCL	INCLUDED (ENG)	REF	REFRIGERATOR, REFERENCE
AC	ACOUSTIC	DEMO	DEMOLISH	INFO	INFORMATION	REQD	REQUIRED
ACT	ACOUSTICAL CEILING TILE	DEPT	DEPARTMENT	INSUL	INSULATION	RL	ROOM LEADER
AD	AREA DRAIN	DET	DETAIL	INT	INTERIOR	RM	ROOM
ADD	ADDENDUM	DF	DRINKING FOUNTAIN	JAN CLO	JANITOR CLOSET	RO	ROUGH OPENING
ADJ	ADJUSTABLE	DI	DIAMETER	KIT	KITCHEN	ROW	RIGHT OF WAY
ADMIN	ADMINISTRATION	DIA	DIAGONAL	KO	KNOCKOUT	S	SOUTH
AUF	ABOVE FINISHED FLOOR	DM	DIMENSION	LAB	LABORATORY	SC	SOLID CORE
AGGR	AGGREGATE	DVY	DIVISION	LAM	LAMINATE	SD	STORM DRAIN
AL	ALUMINUM	DS	DOWNSPOUT	LAU	LAUNDRY	SECT	SECTION
ALT	ALTERNATE	E	EAST	LAV	LAVATORY	SF	SQUARE FEET
ANOD	ANODIZED	EA	EACH	LF	LINEAR FEET	SIM	SIMILAR
APPROX	APPROXIMATELY	EFS	EXTERIOR INSULATION & FINISH SYSTEM	LVR	LOUVER	SPEC	SPECIFICATION
ARCH	ARCHITECTURAL	EJ	EXPANSION JOINT	MANT	MAINTENANCE	SPKR	SPEAKER
ASB	ASBESTOS	EL	ELEVATION	MATL	MATERIAL	SQ	SQUARE
ASPH	ASPHALT	ELEC	ELECTRICAL	MAX	MAXIMUM	SS	STAINLESS STEEL
AUTO	AUTOMATIC	ELEV	ELEVATOR	MCH	MECHANICAL	STD	STANDARD
AUX	AUXILIARY	ENCL	ENCLOSED	MEZZ	MEZZANINE	STOR	STORAGE
AV	AUDIOVISUAL	EOS	EDGE OF SLAB	MFG	MANUFACTURING	SUSP	SUSPENDED
AVG	AVERAGE	EQ	EQUIP	MFR	MANUFACTURER	SYS	SYSTEM
B.O.	BOTTOM OF (ITEM)	EQUIP	EQUIPMENT	MIN	MINIMUM	T	TREAD
B.O.S.	BOTTOM OF STEEL	ETR	EXISTING TO REMAIN	MISC	MISCELLANEOUS	T.O.	TOP OF
BO	BOARD	EWG	ELECTRIC WATER COOLER	MO	MASONRY OPENING	TEL	TELEPHONE
BG	BUMPER GUARD	EXIST	EXISTING	MR	MOISTURE RESISTANT	TEMP	TEMPORARY
BH	BULKHEAD	EXP JT	EXPANSION JOINT	MTD	MOUNTED	TF	TOP OF FINISH FLOOR
BHMK	BENCHMARK	EXT	EXTERIOR	MTG	MOUNTING	THK	THICKNESS
BTUM	BITUMINOUS	F/F	FACE TO FACE	MTL	METAL	THRU	THROUGH
BJ	BUTT JOINT	FD	FLOOR DRAIN	N	NORTH	TO	TOP OF
BL	BUILDING LINE	FE	FIRE EXTINGUISHER	NIC	NOT IN CONTRACT	YOB	TOP OF BEAM
BLDG	BUILDING	FEC	FIRE EXTINGUISHER CABINET	NOM	NOMINAL	TOC	TOP OF CONCRETE CURB
BLK	BLOCK	FF EL	FINISH FLOOR ELEVATION	NON COMB	NON-COMBUSTIBLE	TOF	TOP OF FOOTING
BLKG	BLOCKING	FHC	FIRE HOSE CABINET	NTS	NOT TO SCALE	TOJ	TOP OF JOIST
BM	BEAM	FIN FLR	FINISHED FLOOR	OC	ON CENTER	TOM	TOP OF MASONRY
BO	BY OTHERS	FLR	FLOOR FILLER	OD	OUTSIDE DIAMETER	TOP	TOP OF PARTLET
BOT	BOTTOM	FOC	FACE OF CURB	OPP	OPPOSITE	TOS	TOP OF SLAB
BPD	BOARD	FOP	FACE OF FINISH	OPT	OPTIONAL	TOW	TOP OF WALL
BRG	BEARING	FOM	FACE OF MASONRY	PCF	POUNDS PER CUBIC FEET	TRTD	TREATED
BRK	BRICK	FOS	FACE OF SLAB	PLAM	PLASTIC LAMINATE	TV	TELEVISION
BS	BOTH SIDES	FOW	FACE OF WALL	PLF	POUNDS PER LINEAR FEET	TYP	TYPICAL
BSMT	BASEMENT	FT	FOOT FEET	PLYWD	PLYWOOD	UL	UNDERWRITERS LABORATORIES
BTWN	BETWEEN	FTG	FOOTING	PNL	PANEL	UNO	UNLESS NOTED OTHERWISE
BVL	BEVEL	FURN	FURNISH FURNITURE	PS	PAPER	VERT	VERTICAL
BW	BOTH WAYS	GA	GAGE	PREFAB	PREFABRICATED	VEST	VESTIBULE
CAB	CABINET	GALV	GALVANIZED	PREFIN	PREFINISH	VIF	VERIFY IN FIELD
CJ	CONTROL JOINT	GC	GENERAL CONTRACTOR	PRKG	PARKING	W	WEST WIRE
CL	CENTER LINE	GWB	GYP SUM WALL BOARD	PSF	POUNDS PER SQUARE FOOT	WI	WITH
CLG	CEILING	GYP BD	GYP SUM BOARD	PSI	POUNDS PER SQUARE INCH	W/O	WITHOUT
CLG HT	CEILING HEIGHT	GYP PLAS	GYP SUM PLASTER	PT	POST-TENSIONED, PRE-TREATED	WW	WALL TO WALL
CLO	CLOSET	HC	HANDCAP	PTD	PAINT, PAINTED	WC	WATER CLOSET
CLR	CLEARANCE	HD	HEAVY DUTY	PVC	POLYVINYL CHLORIDE (PLASTIC)	WD	WOOD
CMU	CONCRETE MASONRY UNIT	HWWD	HARDWOOD	QTR	QUARTER	WP	WORKING POINT, WATERPROOFING
COL	COLUMN	HWWR	HARDWARE	QTY	QUANTITY	WR	WATER REPELLENT
CONC	CONCRETE	HM	HOLLOW METAL	R	RADIUS, RISER	WT	WEIGHT
CONF	CONFERENCE	HORIZ	HORIZONTAL			WWF	WELDED WIRE FABRIC
CONT	CONTINUE, CONTINUOUS	HT	HEIGHT			YD	YARD

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BRIA TRINITY VILLAGE

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RINKA project #: 220519
Sheet Title

ABBREVIATIONS & SYMBOLS

Sheet # **G1-02**

INTERIOR PARTITION TYPES

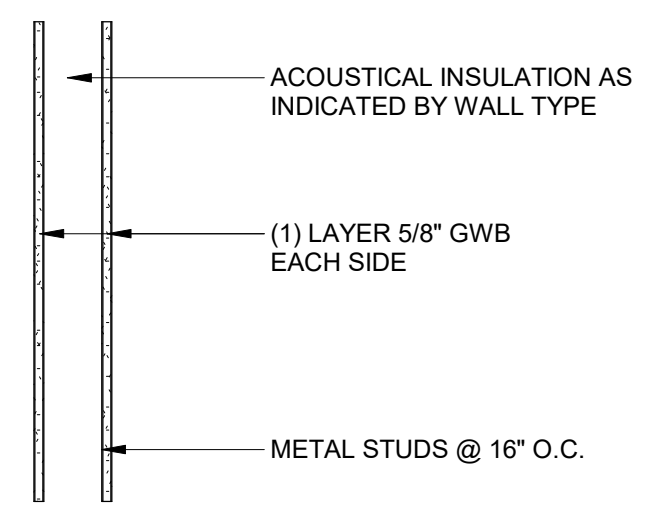
D SERIES

INTERIOR METAL STUD WALL
NON-COMBUSTIBLE

AVAILABLE FIRE RESISTANCE: 1-HR PER UL DES NO U419

ENTIRE RATED WALL ASSEMBLIES, INCLUDING DRYWALL, SHALL CONTINUE UNINTERRUPTED PAST ANY INTERSECTING WALLS

ALL WALLS USE HEAD OF WALL DETAIL 'E' UNLESS NOTED OTHERWISE



ACOUSTICAL INSULATION AS INDICATED BY WALL TYPE

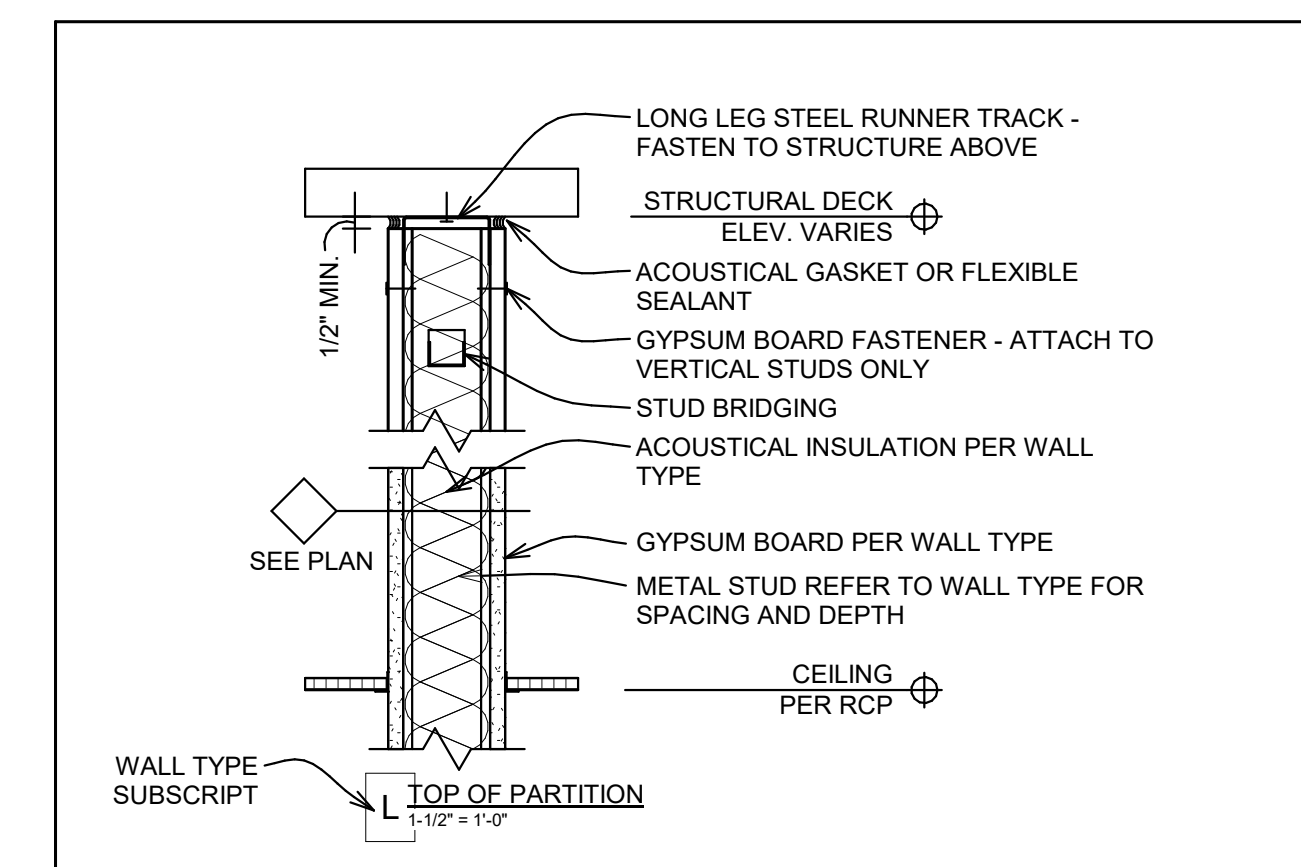
(1) LAYER 5/8" GWB EACH SIDE

METAL STUDS @ 16" O.C.

PARTITION TYPE	STUD WIDTH	PARTITION WIDTH	1HR CONSTRUCTION TESTS	ACOUSTICAL		ACOUSTICAL TESTS
				INSUL	STC	
D3	3 5/8"	4 7/8"	UL DES NO U419	--	40	RAL-TL11-125
D4	3 5/8"	4 7/8"	UL DES NO U419	3"	49	SA-870717
D5	6"	7 1/4"	UL DES NO U419	--	N/A	N/A
D6	6"	7 1/4"	UL DES NO U419	3"	N/A	N/A

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WALL HEAD CONDITIONS



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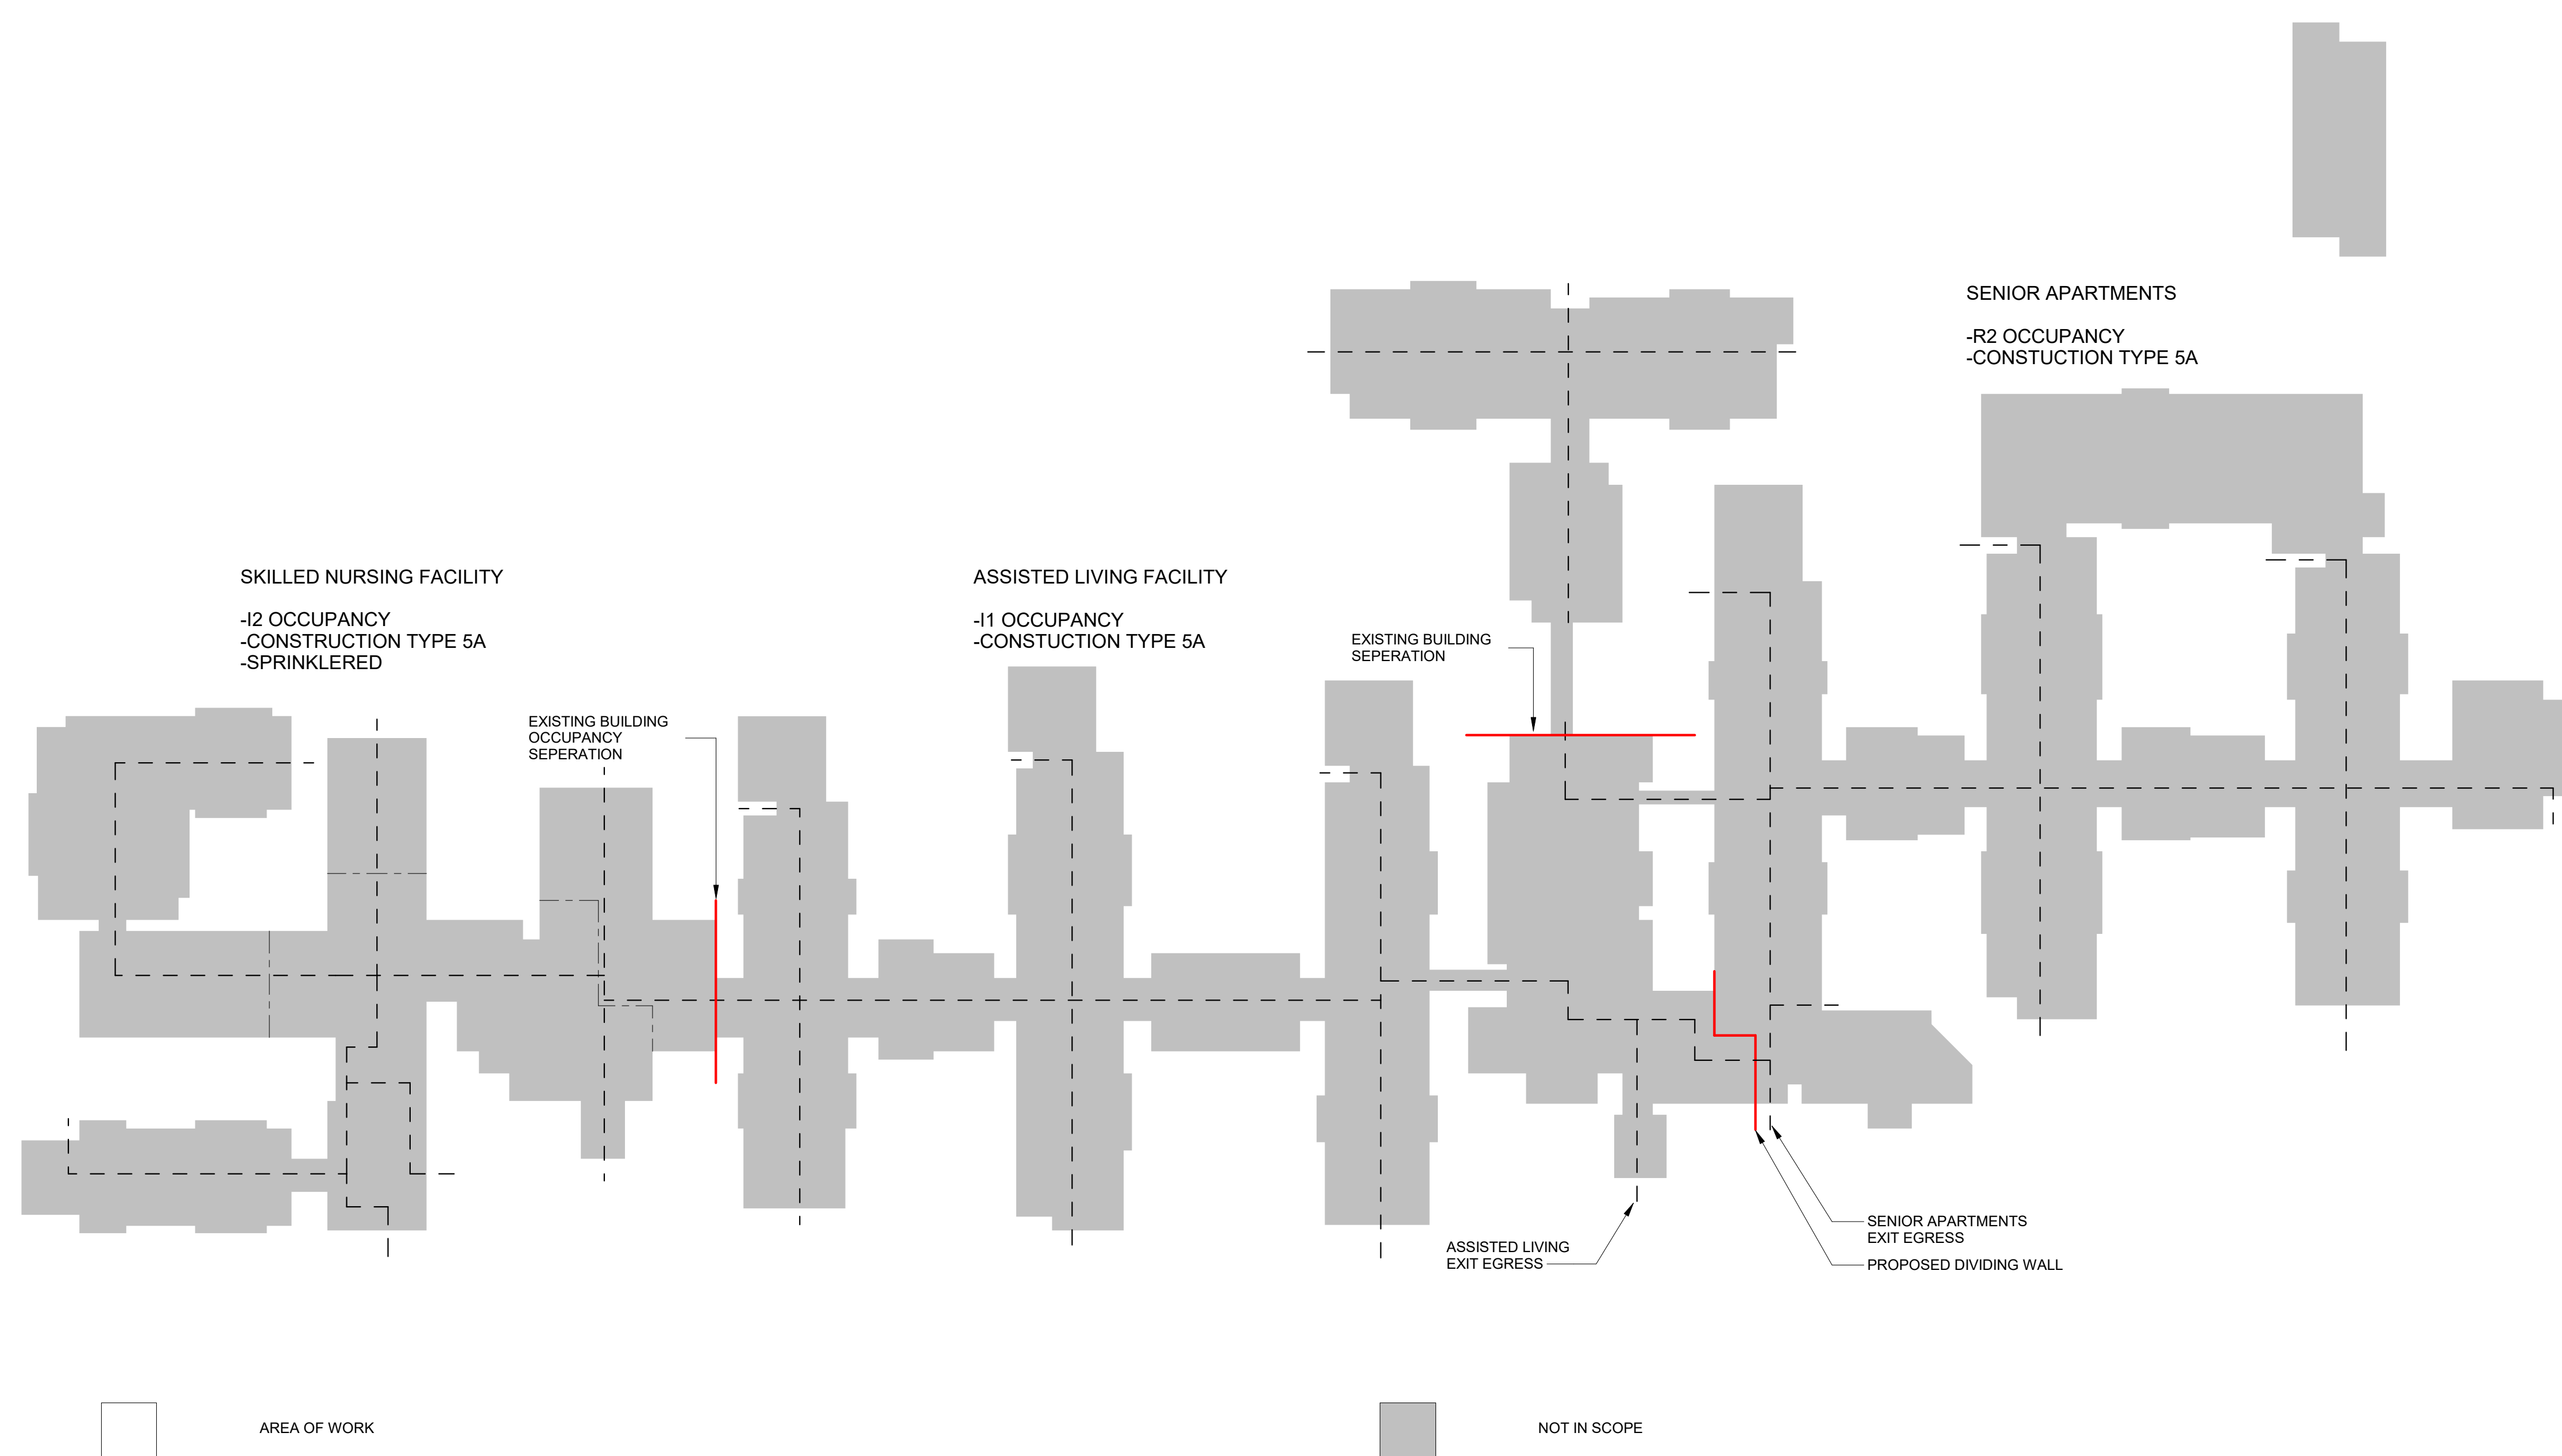
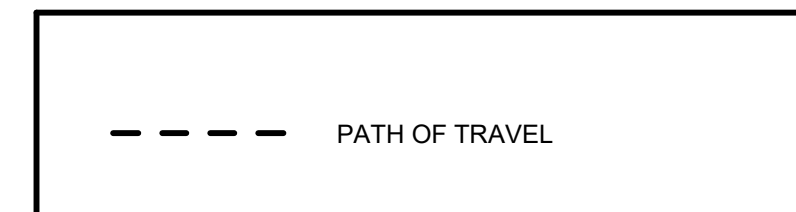
Sheet Title

DOOR TYPES & SCHEDULES

Sheet #

G1-03

CODE PLAN KEY



□ AREA OF WORK

■ NOT IN SCOPE

KEY PLAN
 NTS

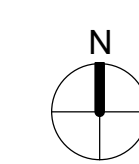
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CODE PLAN

Sheet # **G1-04**



GENERAL DEMOLITION NOTES

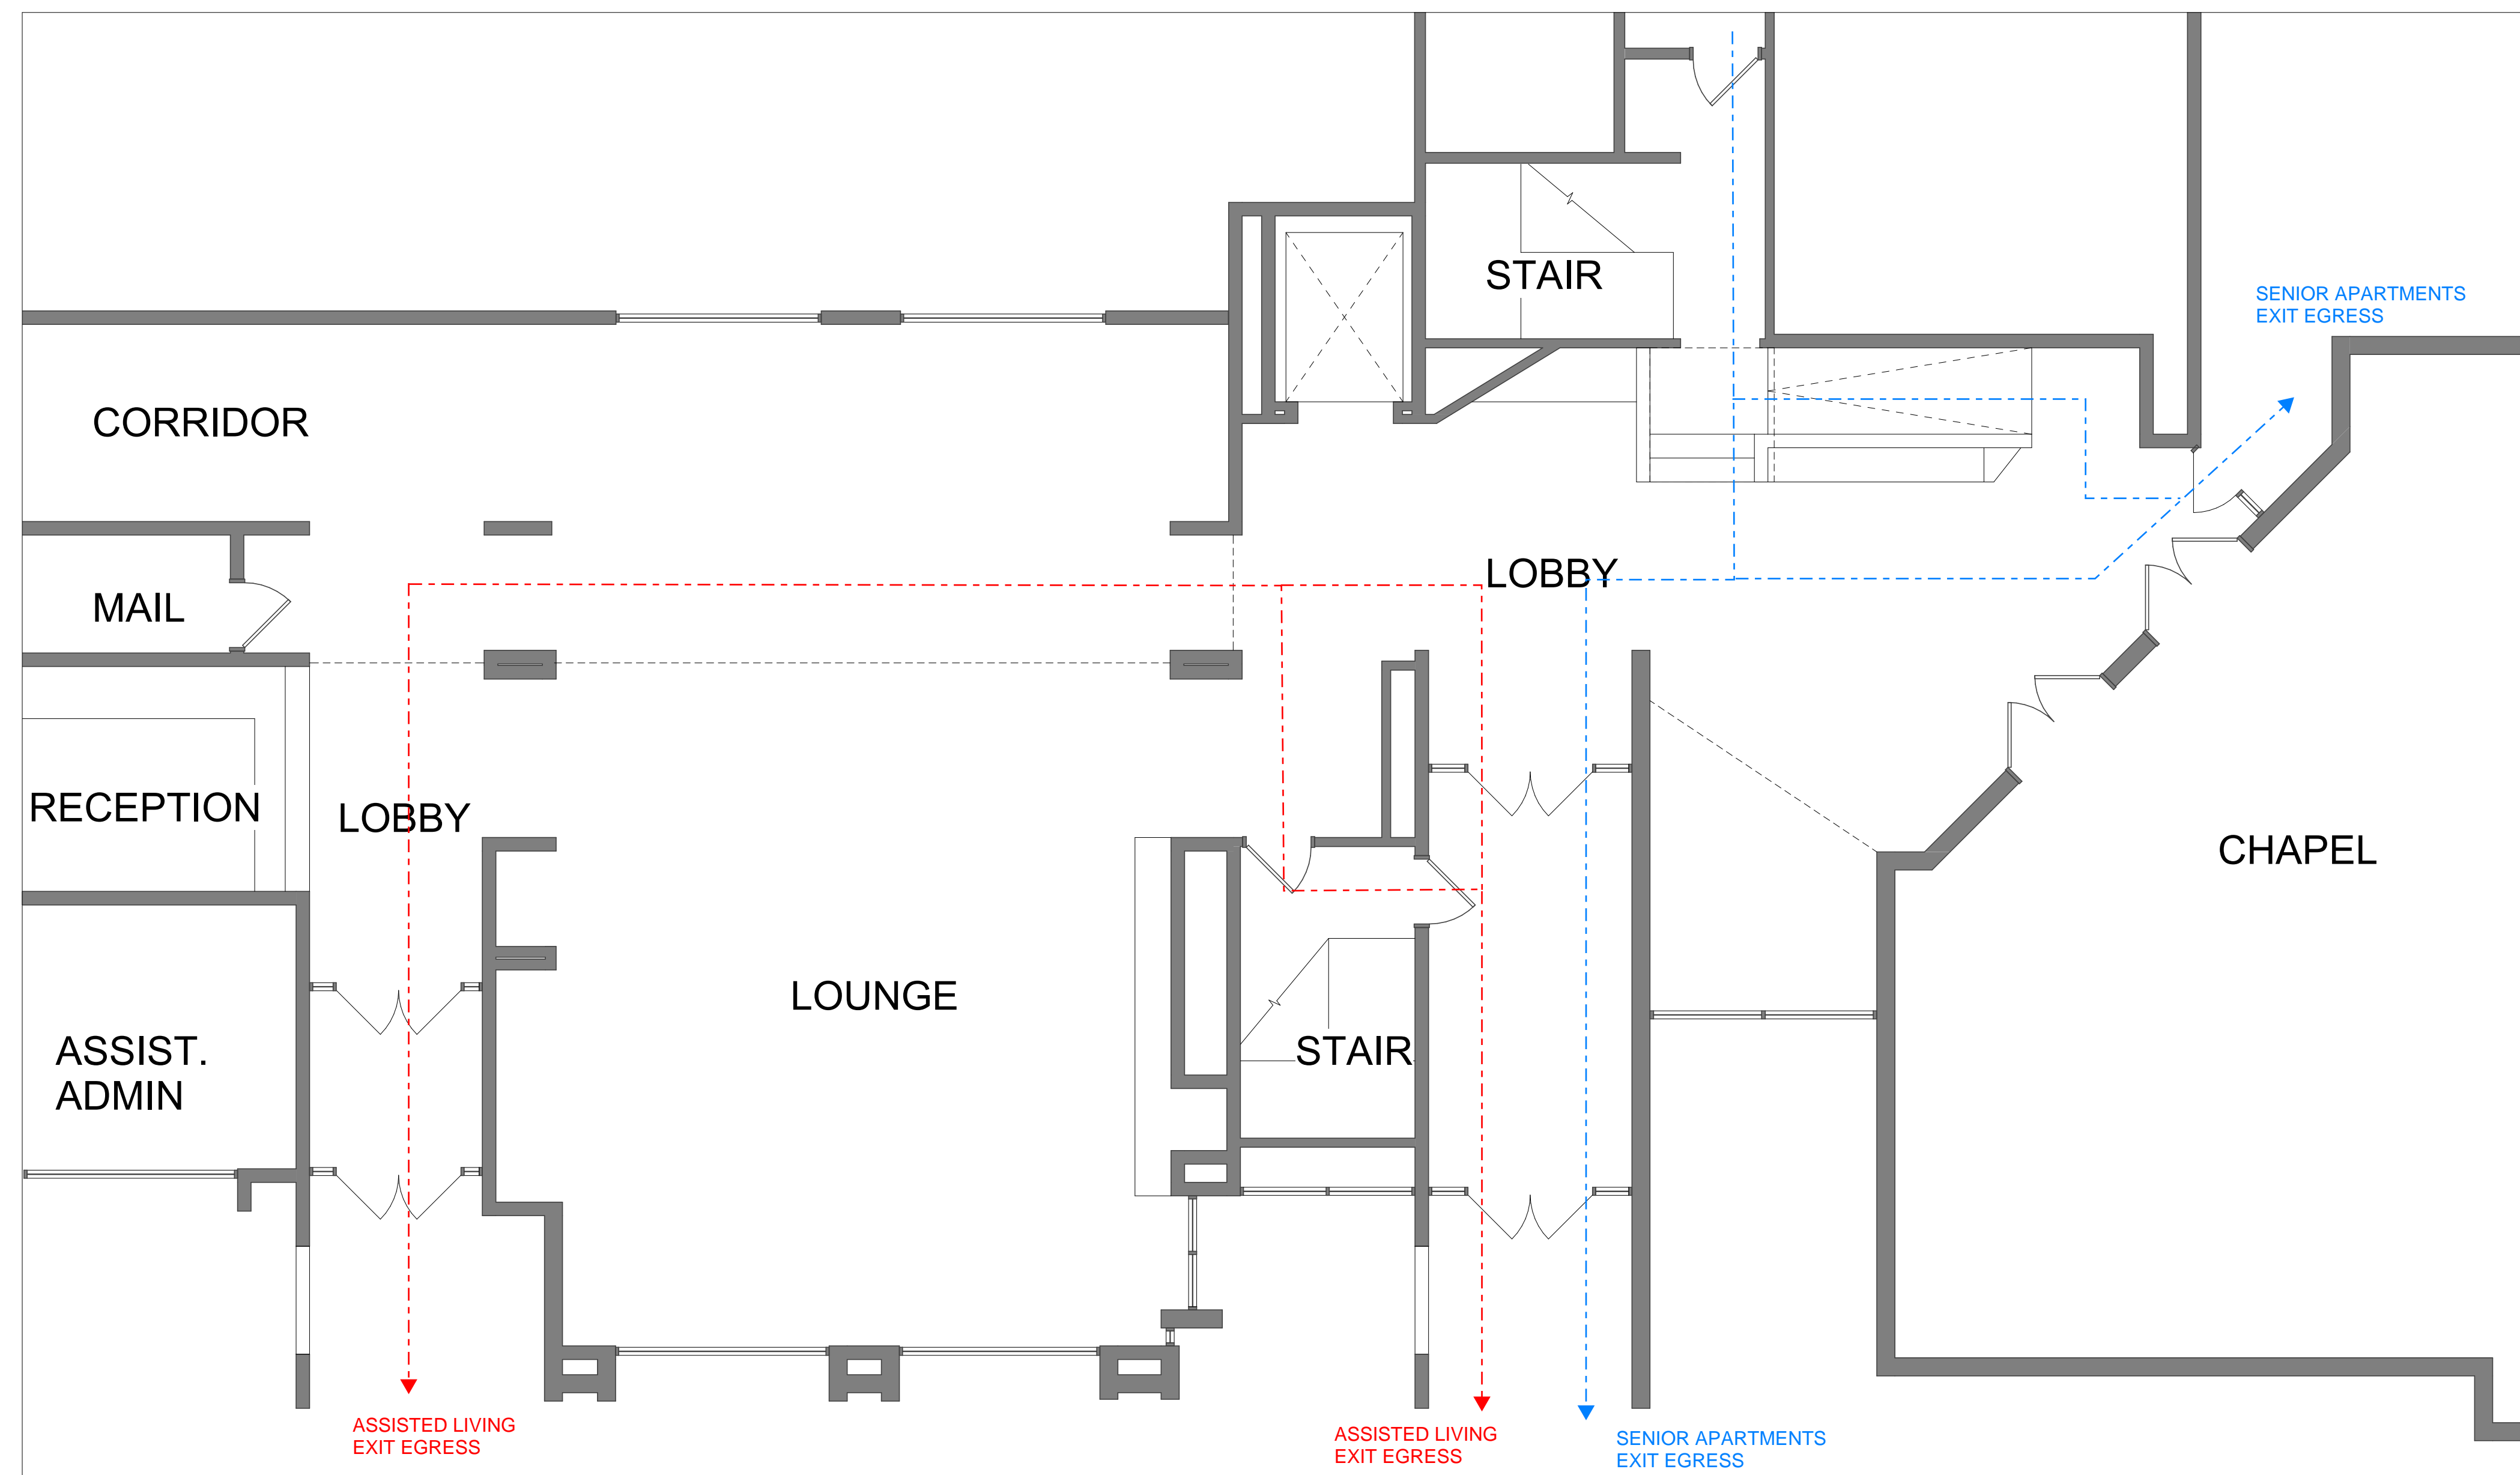
- EXISTING BUILDING PLANS HAVE BEEN SHOWN ACCORDING TO ORIGINAL BUILDING PLANS, FIELD NOTES AND MEASUREMENTS. EXISTING CONDITIONS AND DIMENSIONS SHALL BE FIELD VERIFIED BY CONTRACTORS AND DISCREPANCIES REPORTED TO THE ARCHITECT.
- HEAVY DASHED LINES INDICATE EXISTING WALLS, DOORS, WINDOWS, STAIRS, RAILINGS, CABINETS & FIXTURES TO BE REMOVED.
- EXISTING WALLS, PARTITIONS, FLOOR LINES AND DOORS AND FRAMES THAT REMAIN ARE SHOWN IN CONTINUOUS LINE WEIGHT. THESE AND EXISTING FLOOR AND WALL FINISHES THAT ARE SCHEDULED TO REMAIN SHALL BE PROTECTED FROM DAMAGE DURING DEMOLITION AND CONSTRUCTION. ANY SUCH EXISTING CONDITIONS WHICH ARE DAMAGED OR BECOME UNSTABLE DUE TO OTHER DEMOLITION SHALL BE REPLACED AT NO COST TO OWNER WITH NEW CONSTRUCTION TO MATCH.

————— EXISTING TO REMAIN

- - - - - DEMOLITION ITEMS

- REMOVE ALL UNUSED MECHANICAL, ELECTRICAL, AND PLUMBING FIXTURES AND EQUIPMENT WITHIN THE WORK AREA.
- KEYED NOTES ARE SPECIFIC TO THIS DRAWING.
- REMOVE WALL COVERING & ADHESIVES & PREPARE FOR NEW FINISHES AT ALL LOCATIONS WITHIN THE WORK AREA.

KEY NOTES ◻



1 EXISTING LOBBY FLOOR PLAN
3/16" = 1'-0"

△ Revisions

BUILDING PERMIT
BRIA TRINITY VILLAGE

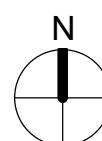
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Sheet Title

DEMO LOBBY FLOOR PLAN



Sheet #

A0-01

GENERAL DEMOLITION NOTES

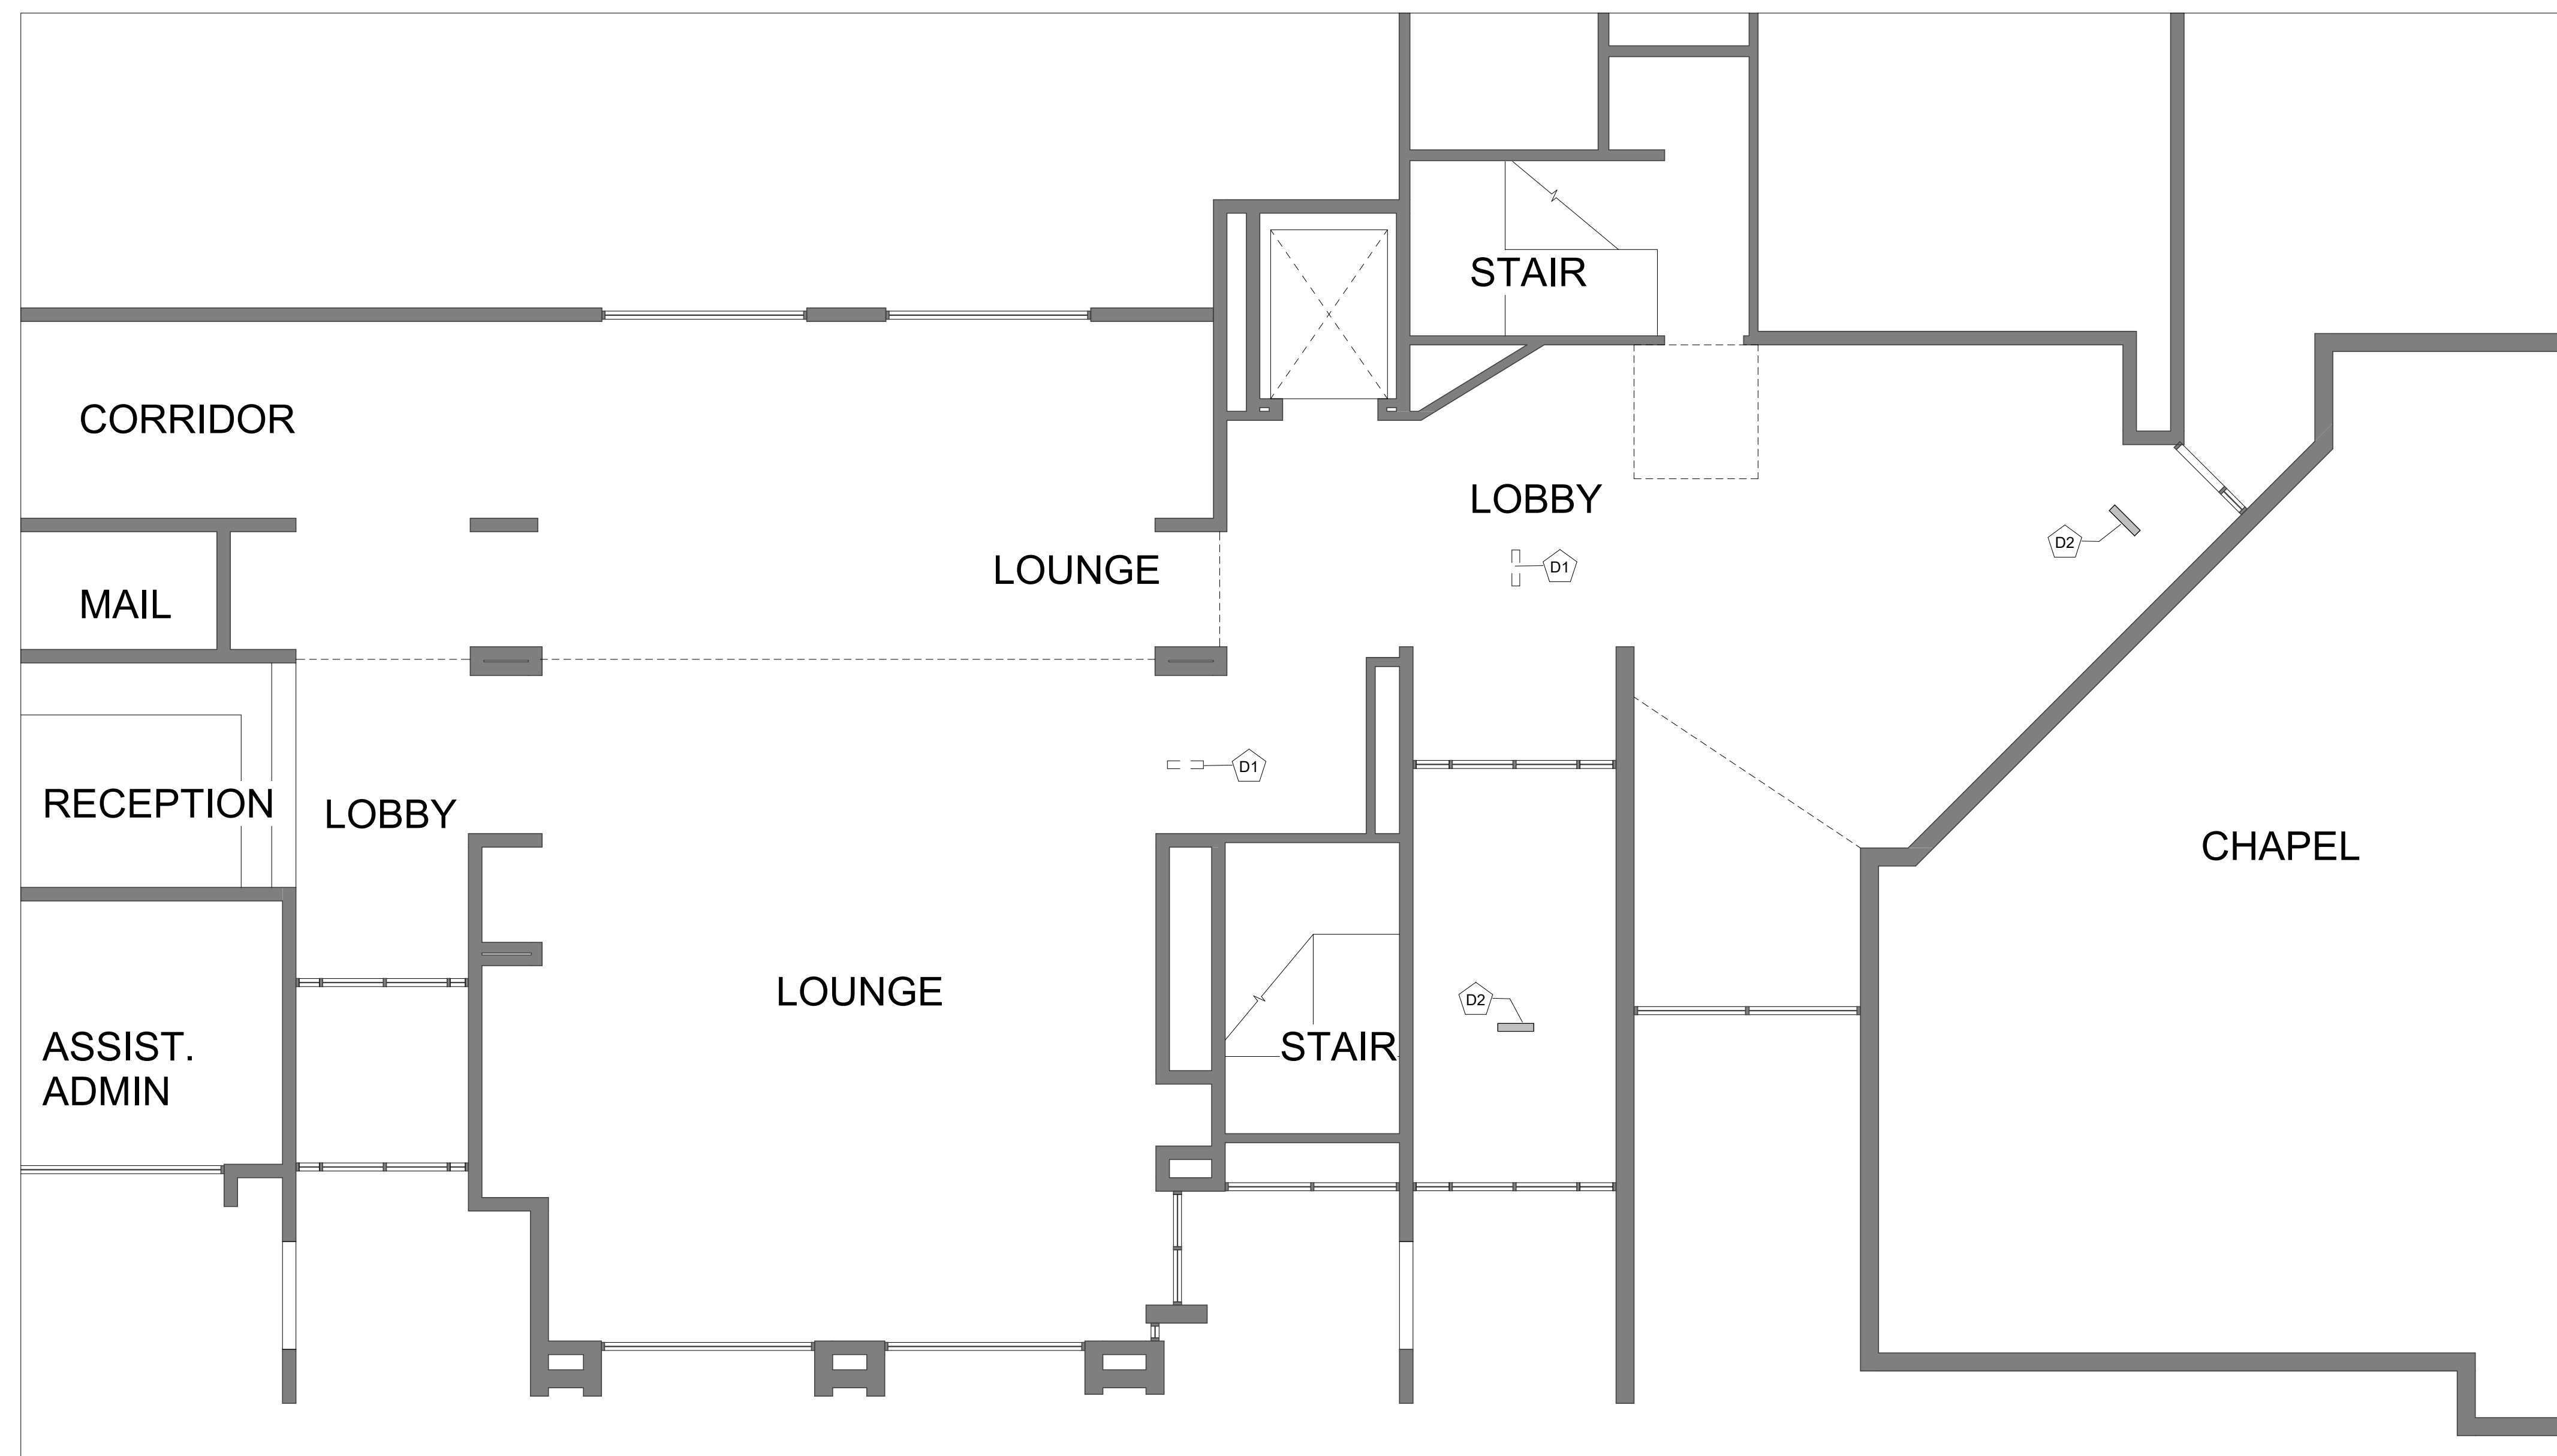
1. EXISTING BUILDING PLANS HAVE BEEN SHOWN ACCORDING TO ORIGINAL BUILDING PLANS, FIELD NOTES AND MEASUREMENTS. EXISTING CONDITIONS AND DIMENSIONS SHALL BE FIELD VERIFIED BY CONTRACTORS AND DISCREPANCIES REPORTED TO THE ARCHITECT.
2. HEAVY DASHED LINES INDICATE EXISTING WALLS, DOORS, WINDOWS, STAIRS, RAILINGS, CABINETS & FIXTURES TO BE REMOVED.
3. EXISTING WALLS, PARTITIONS, FLOOR LINES AND DOORS AND FRAMES THAT REMAIN ARE SHOWN IN CONTINUOUS LINE WEIGHT. THESE AND EXISTING FLOOR AND WALL FINISHES THAT ARE SCHEDULED TO REMAIN SHALL BE PROTECTED FROM DAMAGE DURING DEMOLITION AND CONSTRUCTION. ANY SUCH EXISTING CONDITIONS WHICH ARE DAMAGED OR BECOME UNSTABLE DUE TO OTHER DEMOLITION SHALL BE REPLACED AT NO COST TO OWNER WITH NEW CONSTRUCTION TO MATCH.

————— EXISTING TO REMAIN
 - - - - - DEMOLITION ITEMS


4. REMOVE ALL UNUSED MECHANICAL, ELECTRICAL, AND PLUMBING FIXTURES AND EQUIPMENT WITHIN THE WORK AREA.
5. KEYED NOTES ARE SPECIFIC TO THIS DRAWING.
6. REMOVE WALL COVERING & ADHESIVES & PREPARE FOR NEW FINISHES AT ALL LOCATIONS WITHIN THE WORK AREA.

KEY NOTES 

- D1 REMOVE EXISTING EXIT SIGN, SALVAGE FOR POSSIBLE RELOCATION
 D2 EXISTING EXIT SIGN TO REMAIN



1 DEMO LOBBY FLOOR PLAN
 3/16" = 1'-0"

 Revisions

BUILDING PERMIT
BRIA TRINITY VILLAGE

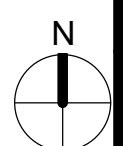
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Sheet Title

REFLECTED CEILING DEMO PLAN



Sheet #

A0-02

GENERAL NOTES: FLOOR PLANS

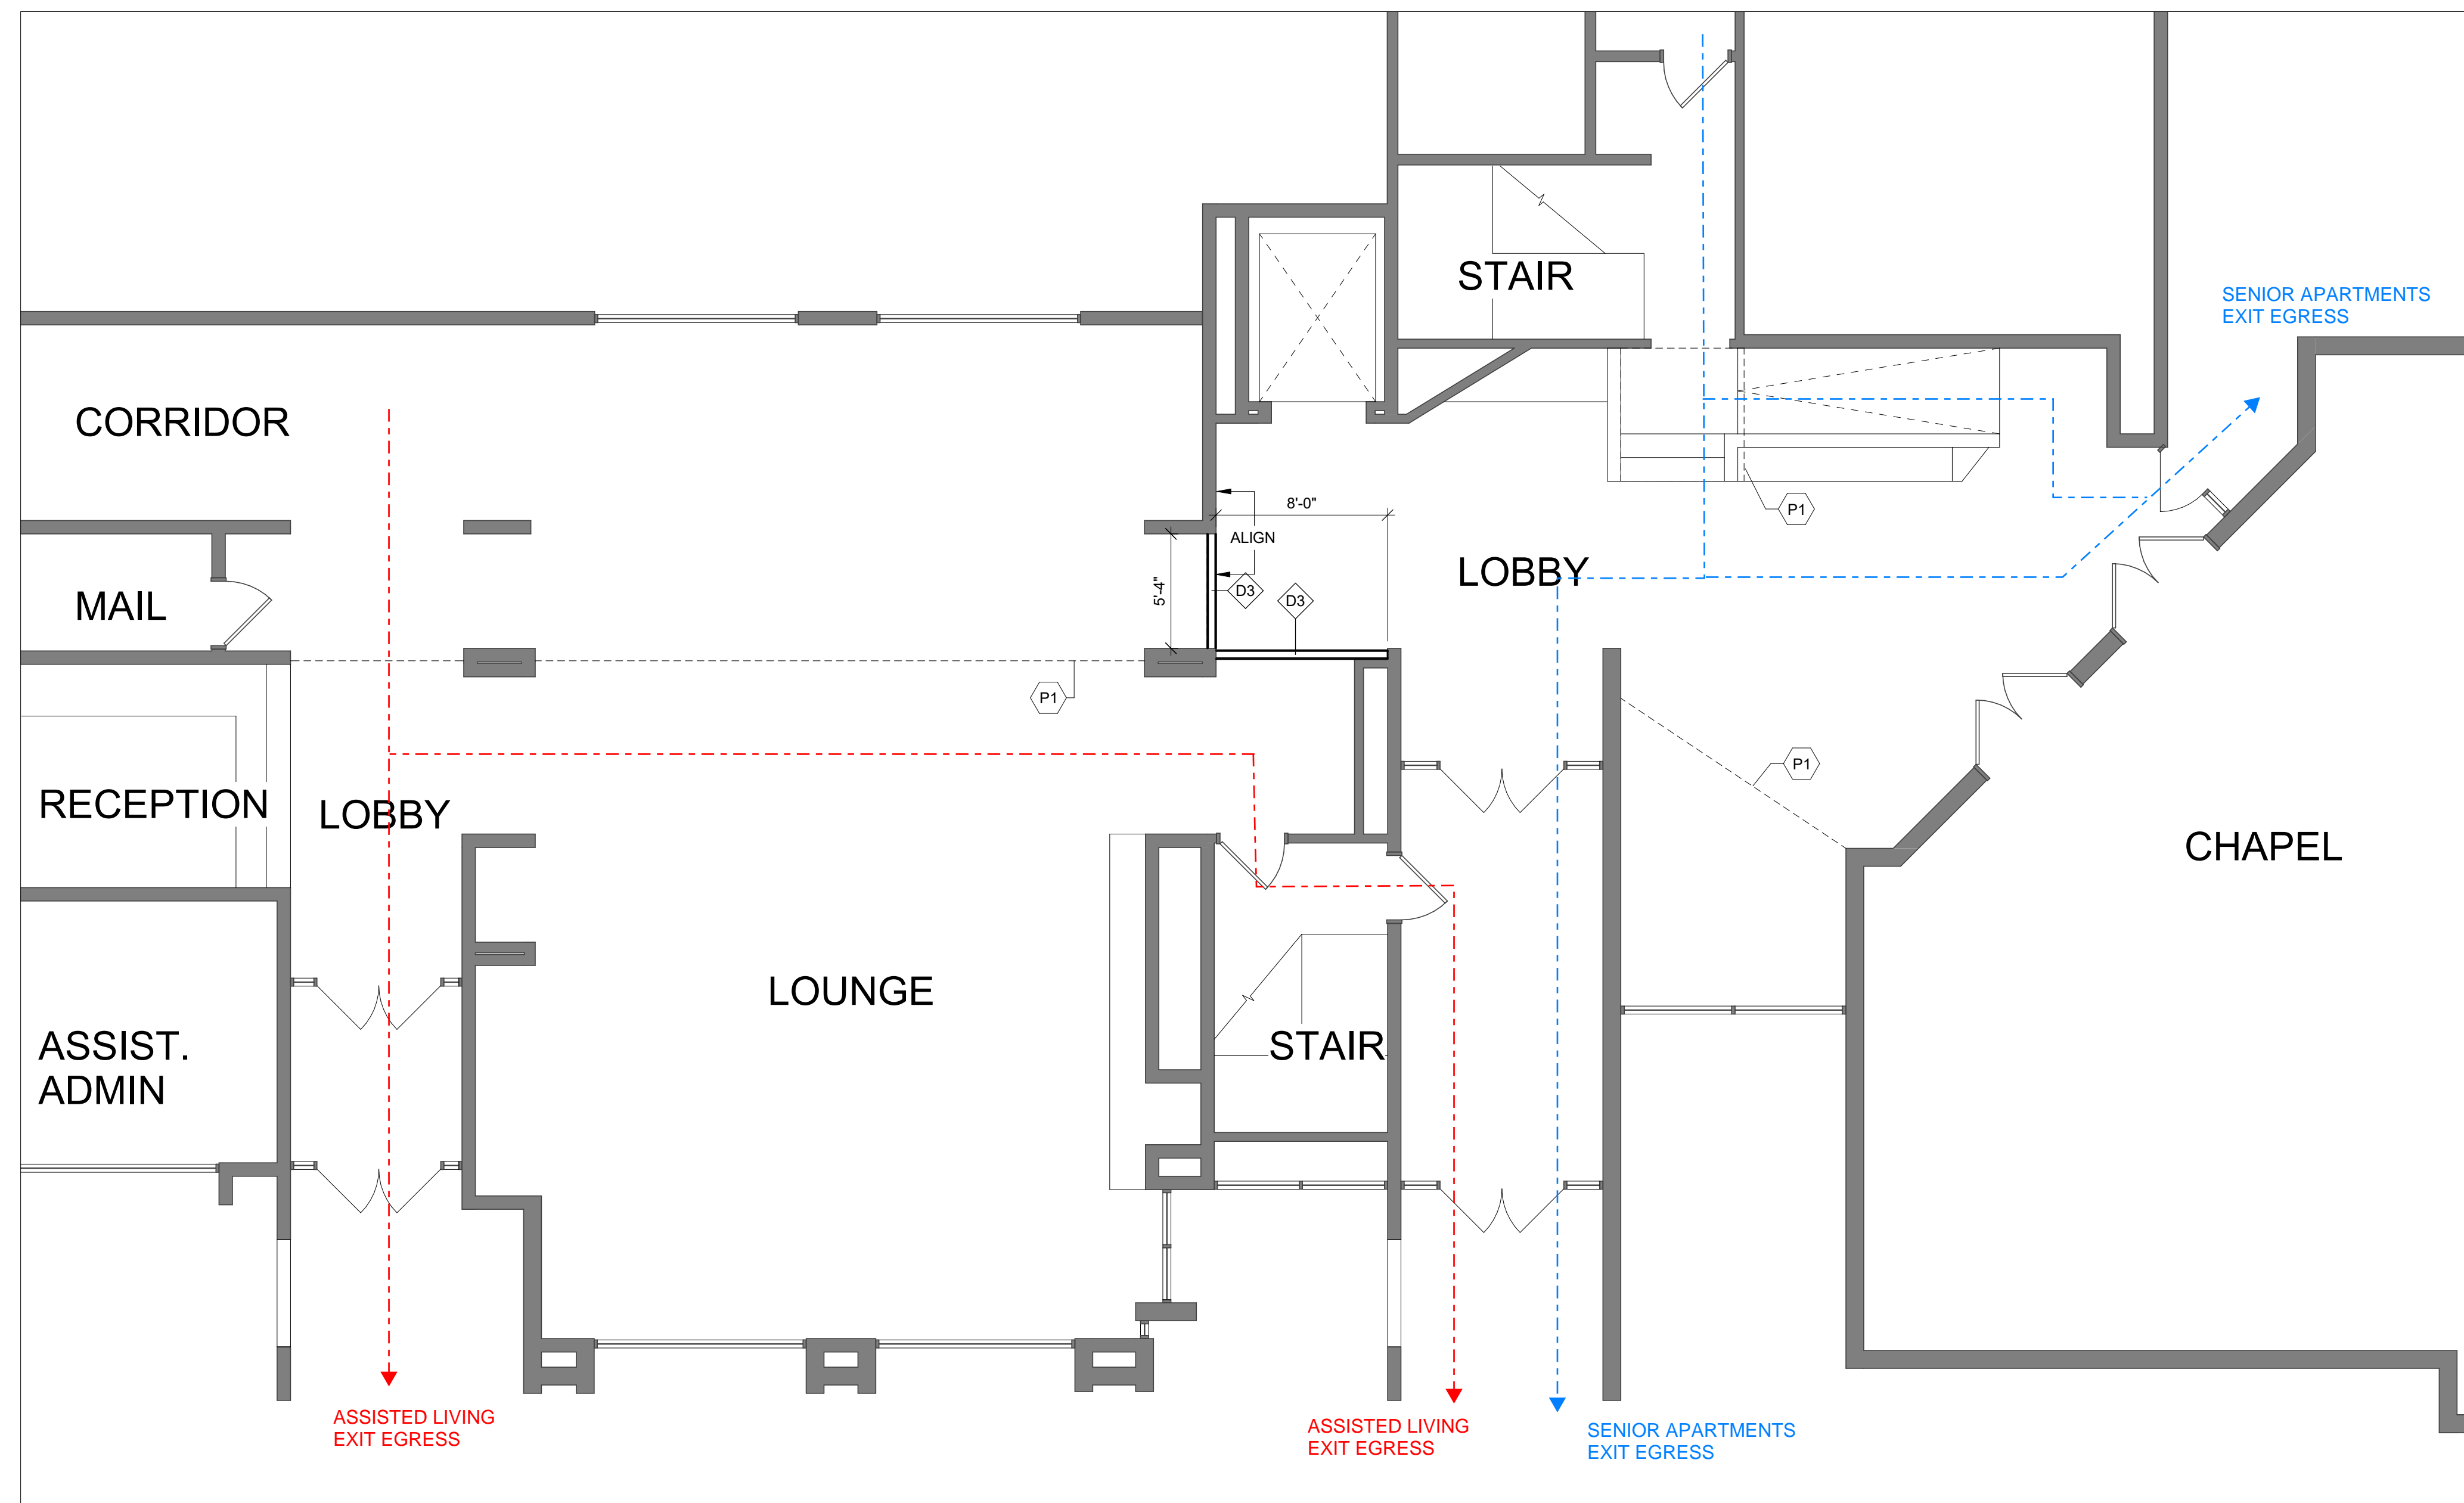
1. ALL INTERIOR PARTITIONS TO BE TYPE D3(E), U.N.O.
2. PROVIDE BLOCKING TO SUPPORT ALL LIGHT FIXTURES, EQUIPMENT, CASEWORK, ETC.
3. REFER TO SCHEMATIC DESIGN NARRATIVE FOR PROJECT MATERIALS/SYSTEMS

KEY NOTES 


P1 EXISTING EDGE OF SOFIT



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1 LOBBY FLOOR PLAN
3/16" = 1'-0"

 Revisions

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BRIA TRINITY
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53223

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Sheet Title

LOBBY FLOOR
PLAN

Sheet #

A1-01

GENERAL NOTES: FLOOR PLANS

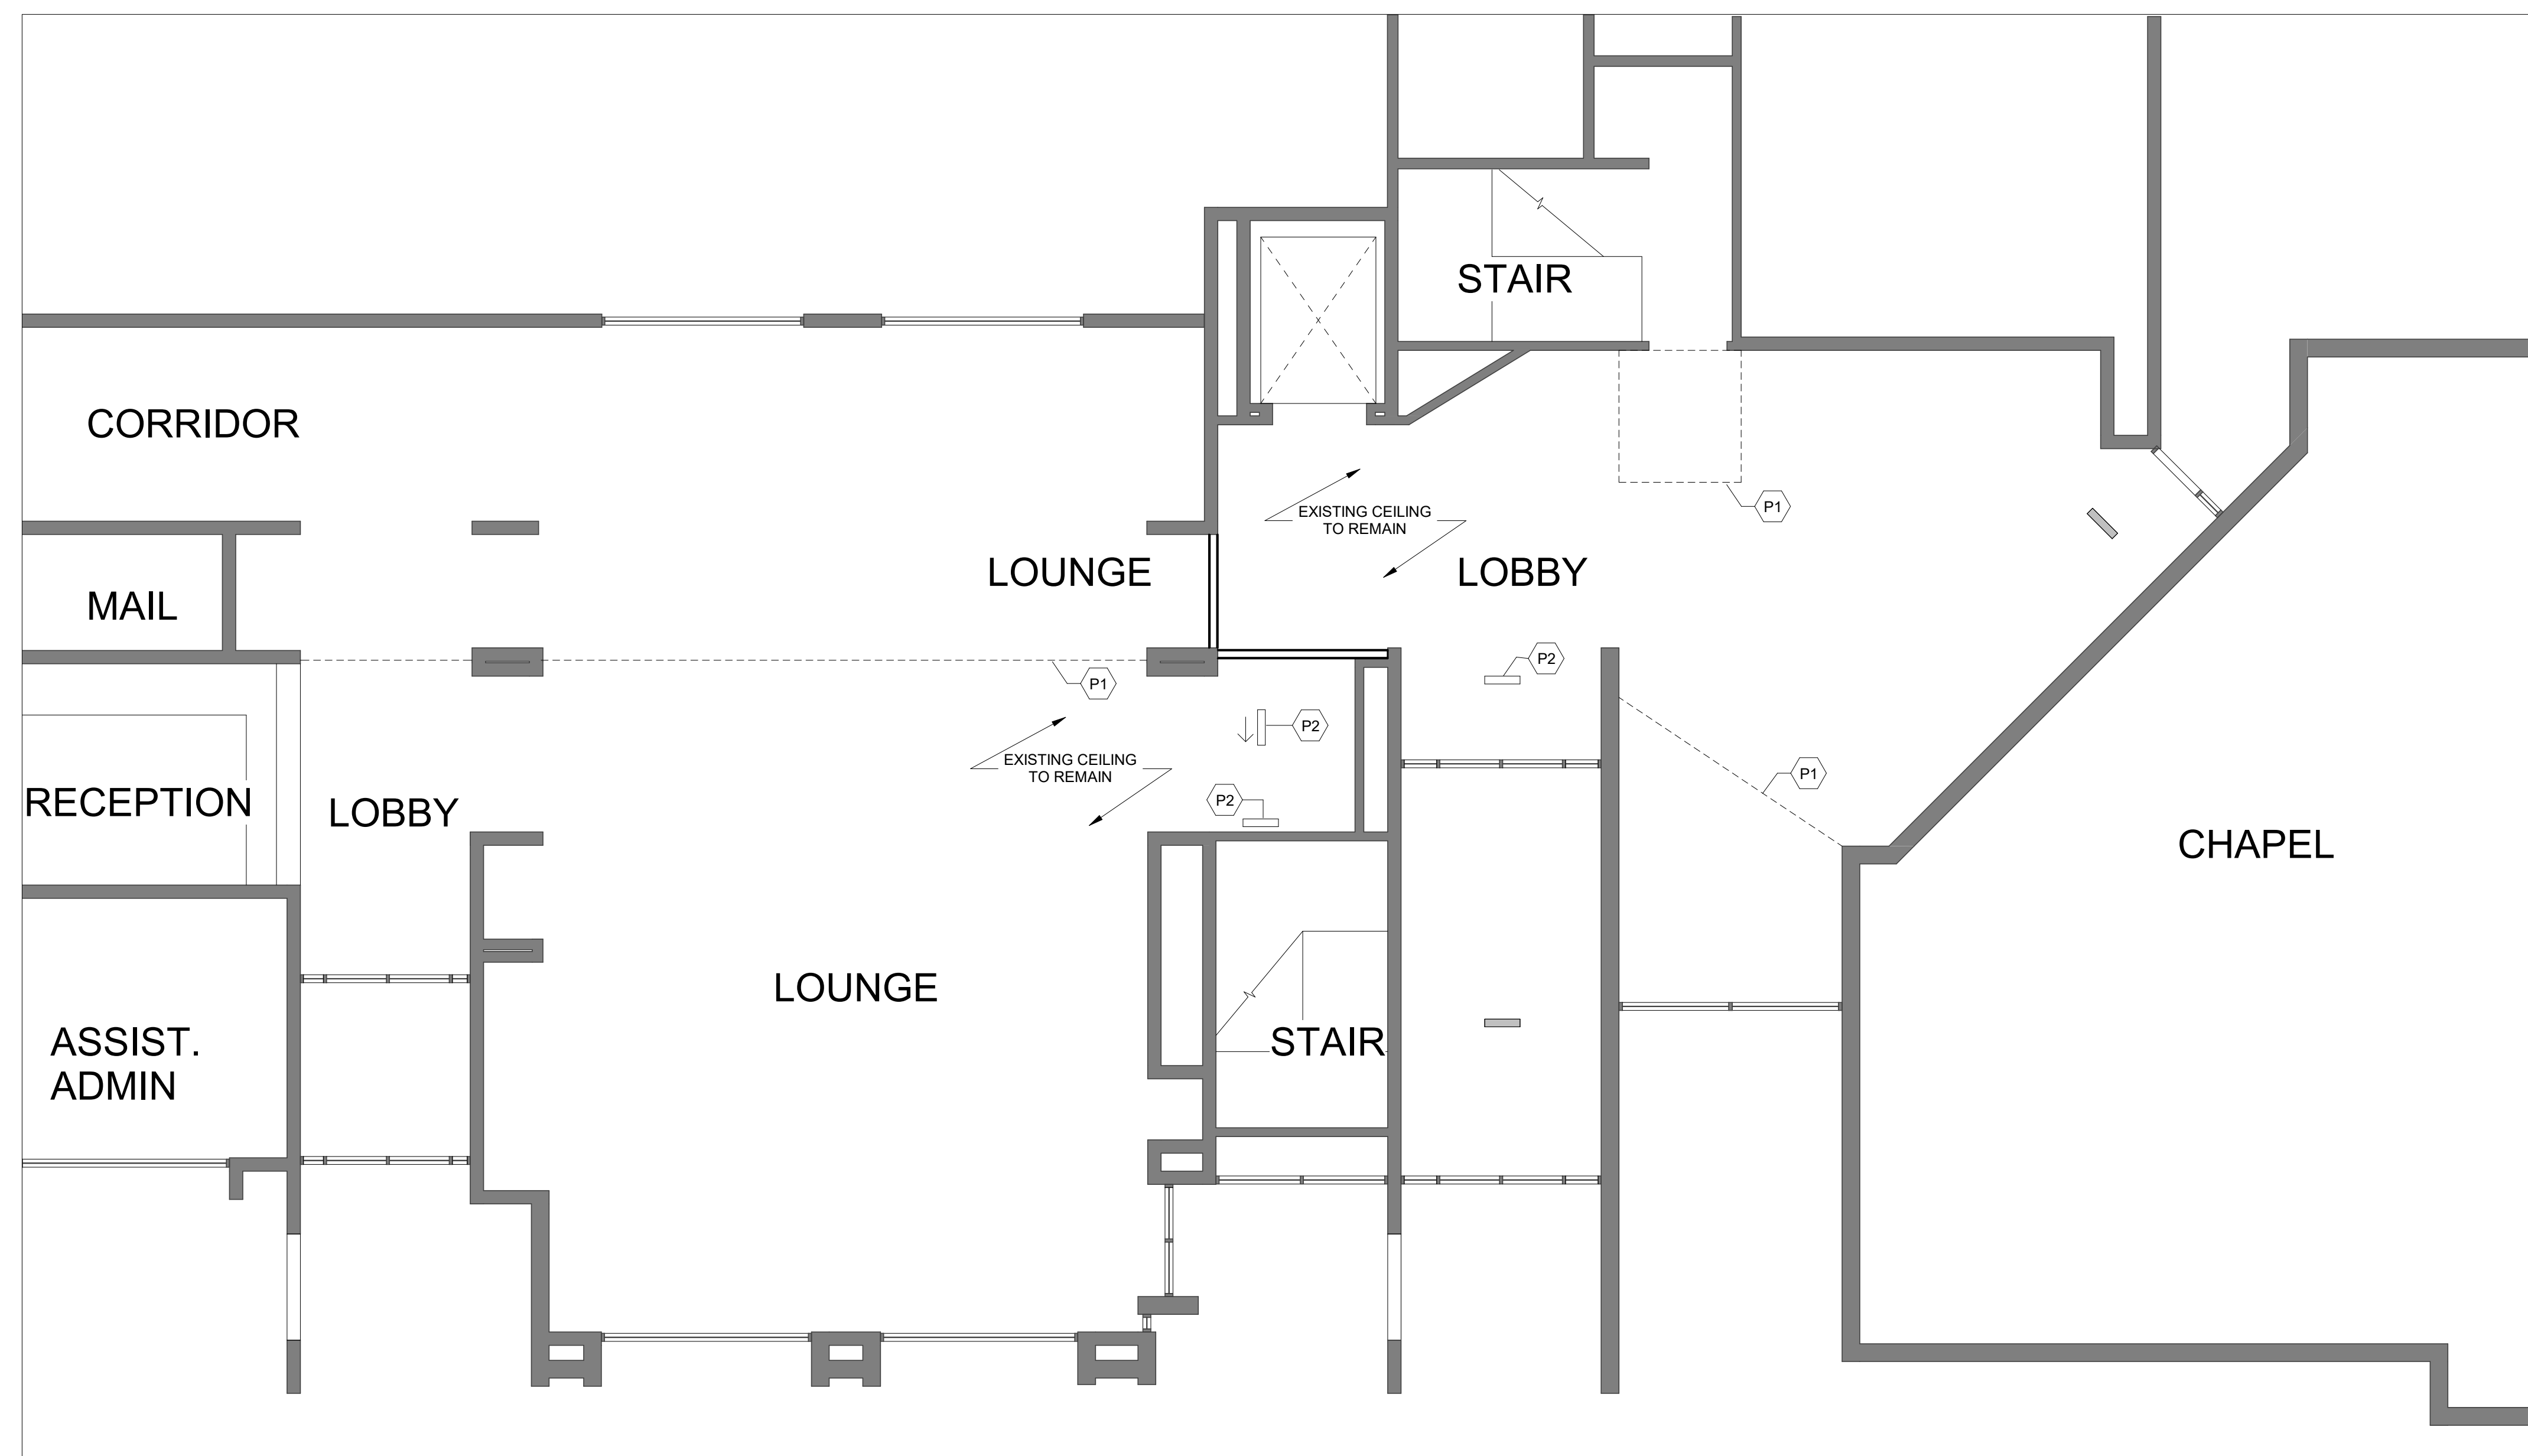
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KEY NOTES 

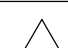
- P1 EXISTING EDGE OF SOFIT
 P2 PROPOSED CEILING MOUNTED EXIT SIGN, DIRECTIONAL ARROW AS SHOWN



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1 LOBBY FLOOR PLAN
 3/16" = 1'-0"

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BRIA TRINITY VILLAGE

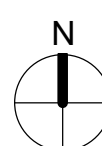
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Sheet Title

REFLECTED CEILING PLAN



Sheet #

A1-02

GENERAL NOTES: FLOOR PLANS

1. ALL INTERIOR PARTITIONS TO BE TYPE D3(E), U.N.O.
2. PROVIDE BLOCKING TO SUPPORT ALL LIGHT FIXTURES, EQUIPMENT, CASEWORK, ETC.
3. REFER TO SCHEMATIC DESIGN NARRATIVE FOR PROJECT MATERIALS/SYSTEMS

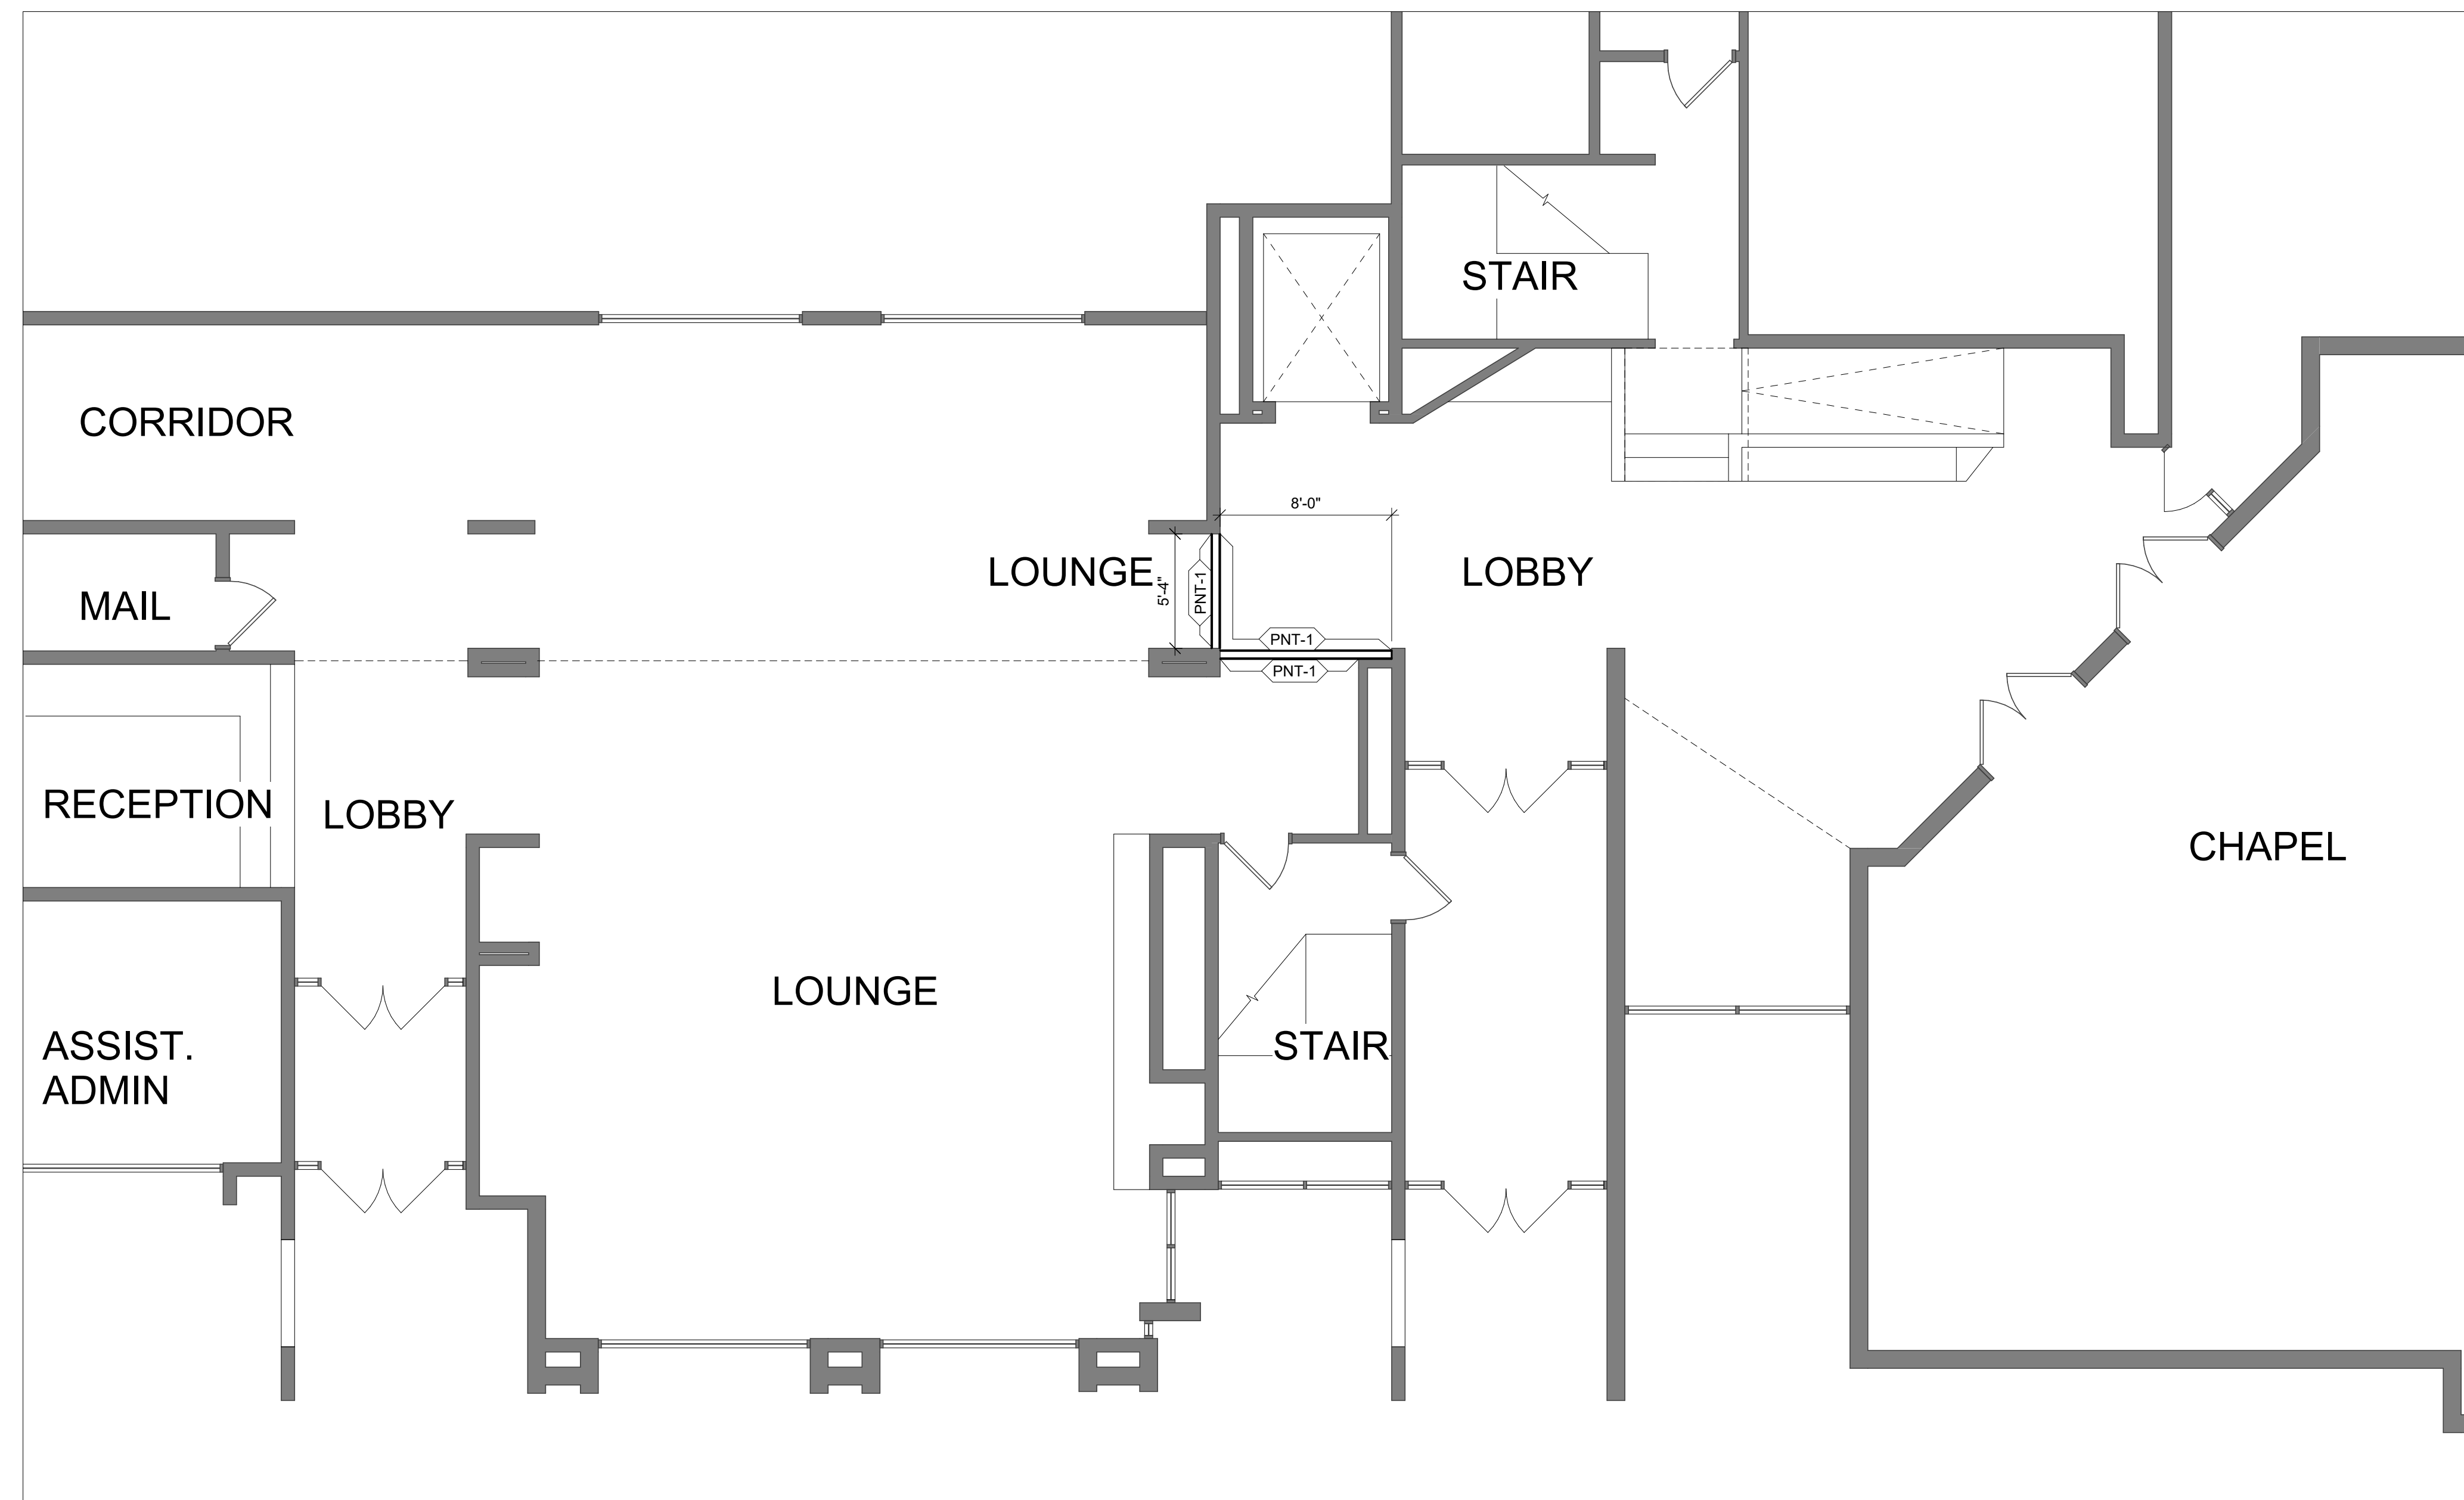


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INTERIOR FINISHES			
REV	TAG	SPEC SECTION	DESCRIPTION
	PNT-1	09 9123	WALL PAINT
	RB-1	09 6513	RESILIENT BASE

FINISH KEY

FINISH
BASE
FLOOR
WALL



1 LOBBY WALL FINISH PLAN
3/16" = 1'-0"

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FINISH PLAN

Sheet #

A9-01

