### COM-ALT-24-00633 CCF 240870



LIVING WITH HISTORY

Property Description of work

### **Certificate of Appropriateness**

Milwaukee Historic Preservation Commission/841 N Broadway/Milwaukee, WI 53202/phone 414-286-5712

802 E. Historic Mitchell StreetMitchell Street HDAll work per attached plans, consistingly primarily of the following 5 components

- 1. Replace existing storefront and single-pane glazing, with new aluminum storefront (midnight bronze) and insulated clear glazing.
- 2. Eliminate multiple entry access points on Historic Mitchell Street, relocate main entry access on west side of building, which accommodates an accessible entrance, reduces user confusion, and provides a clear point of access to the facility.
- 3. Provide new glazed storefront opening on south-east corner- facing South 8th Street- in a pattern of similar size and scale to storefront on Mitchell Street. This replicates other corner buildings in the district with fenestration "turning-the-corner".
- 4. Apply a monolithic coating to exterior surfaces, including fluted concrete masonry. Replace metal roof edge with similar color.
- 5. Introduce a concrete landscape curb element along sidewalk to replace "railroad-tie" planting bed. Infill beds with native & pollinator plantings.

#### Date issued

11/12/2024

Under the provisions of Section 320-21 (11) and (12) of the Milwaukee Code of Ordinances, the Milwaukee Historic Preservation Commission has granted a certificate of appropriateness for the work listed above. The work was found to be consistent with preservation guidelines. The following conditions apply to this certificate of appropriateness:

Paint must be certified by manufacturer for use on exterior masonry and have an appropriate vapor permeability rating. The specific paint product and its relevant manufacturer information must be provided to HPC staff for approval before beginning painting.

All work must be done in a craftsman-like manner. Staff must approve any changes or additions to this certificate before work begins. Work that is not completed in accordance with this certificate may be subject to correction orders or citations. If you require technical assistance, please contact Historic Preservation staff as follows: Phone: (414) 286-5712 E-mail: hpc@milwaukee.gov.

#### Permits and timeline


You are responsible for determining if permits are required and obtaining them prior to commencing work. Consult the Development Center on the web or by telephone for details <u>www.milwaukee.gov/lms</u> (414) 286-8210. If permits are <u>not</u> required, work must be completed within one year of the date this certificate was issued. If permits are required, permits must be obtained within one year of the date this certificate was issued.

#### 3 pages of drawings follow

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City of Milwaukee Preservation Staff







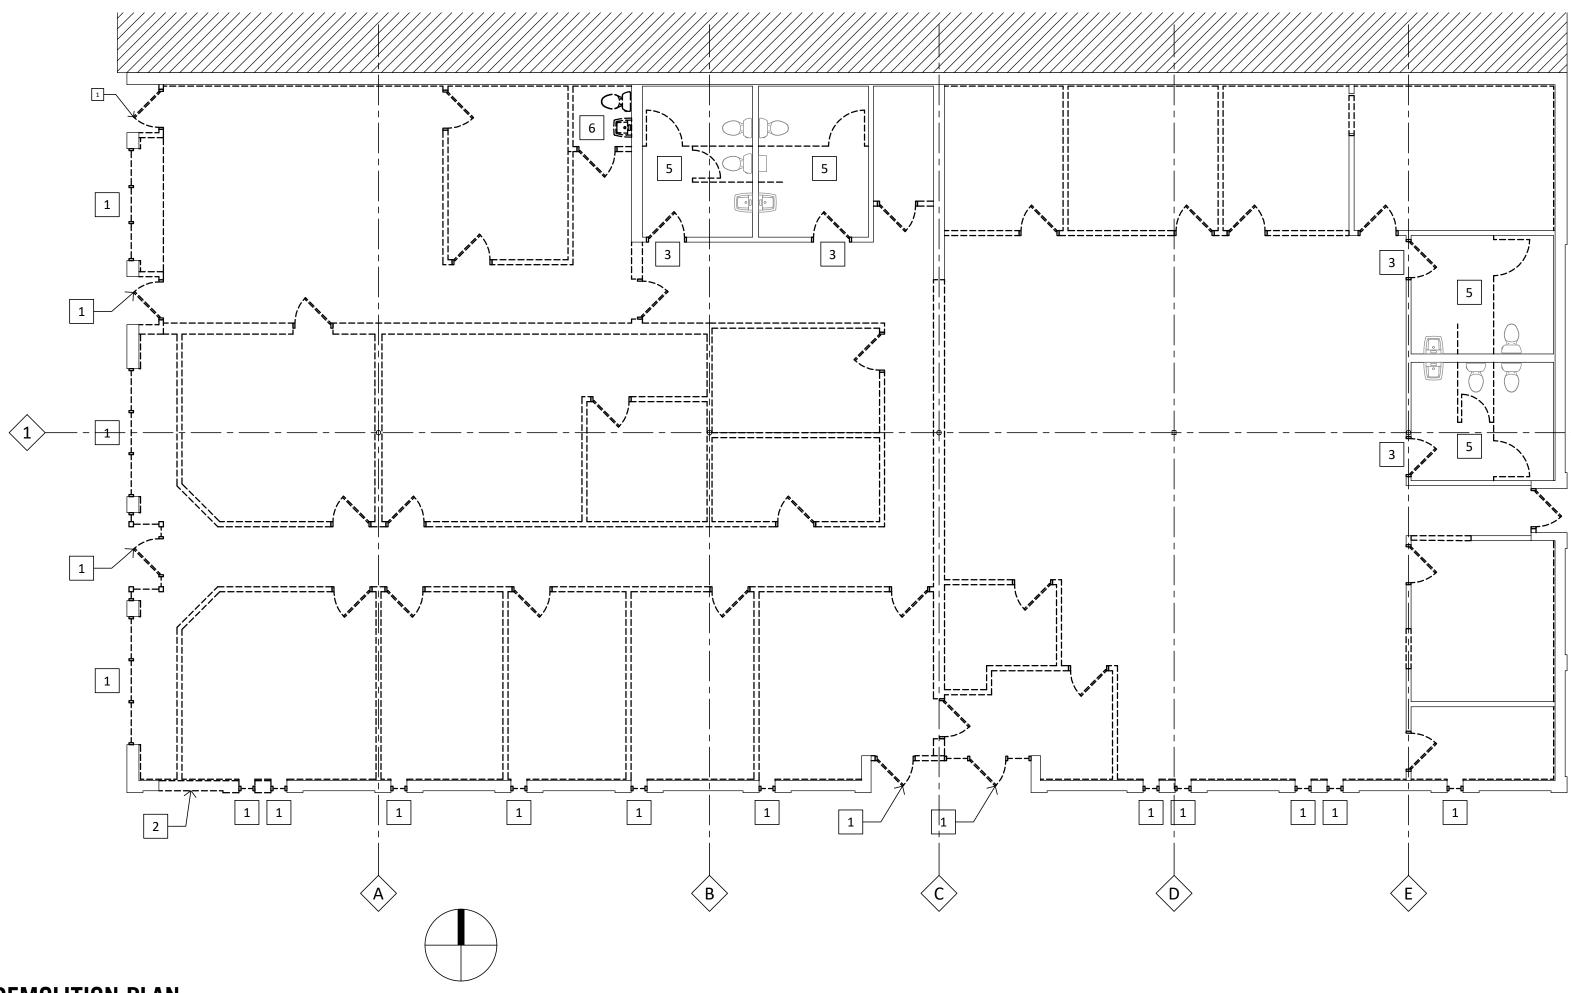

### BUILDING CODE SUMMARY

BUILDING CODES	WISCONSIN BUILDING CODE WISCONSIN ACCESSIBILITY CODE	IBC 2015 - AMENDED ANSI A117.1; 2009
CONSTRUCTION TYPES	TYPE VB	
BUILDING AREA:	7,200 SF ALLOWABLE AREA At = 9,000 SF PEF	R FLOOR.
BUILDING HEIGHT:	ALLOWABLE HEIGHT: 40-FEET.	
OCCUPANCY CLASSIFICATION	BUSINESS GROUP B; NON-SEPARATED	O USES.
DESIGN OCCUPANT LOAD	BUSINESS GROUP: 7,200 SF/ 100 = 72	OCCUPANTS
COMMON PATH OF EGRESS	200-FEET ALLOWED	
ACCESSIBILITY	BUILDING IS FULLY ACCESSIBLE.	
FIRE PROTECTION SYSTEMS	NON-SPRINKLED. FIRE ALARM NOT REQUIRED. FIRE EXTINGUISHERS; TWO PROVIDED CLASS A; LIGHT HAZARD; 75-FEET MA	
EXIT TRAVEL DISTANCE (NS)	200-FEET.	
MIN PLUMBING FIXTURES	WC: THREE REQUIRED; TSIX PROVIDED LAV: TWO REQUIRED; FOUR PROVIDED DF: POTABLE WATER PROVIDED AT RE STAFF BREAK ROOM.	D

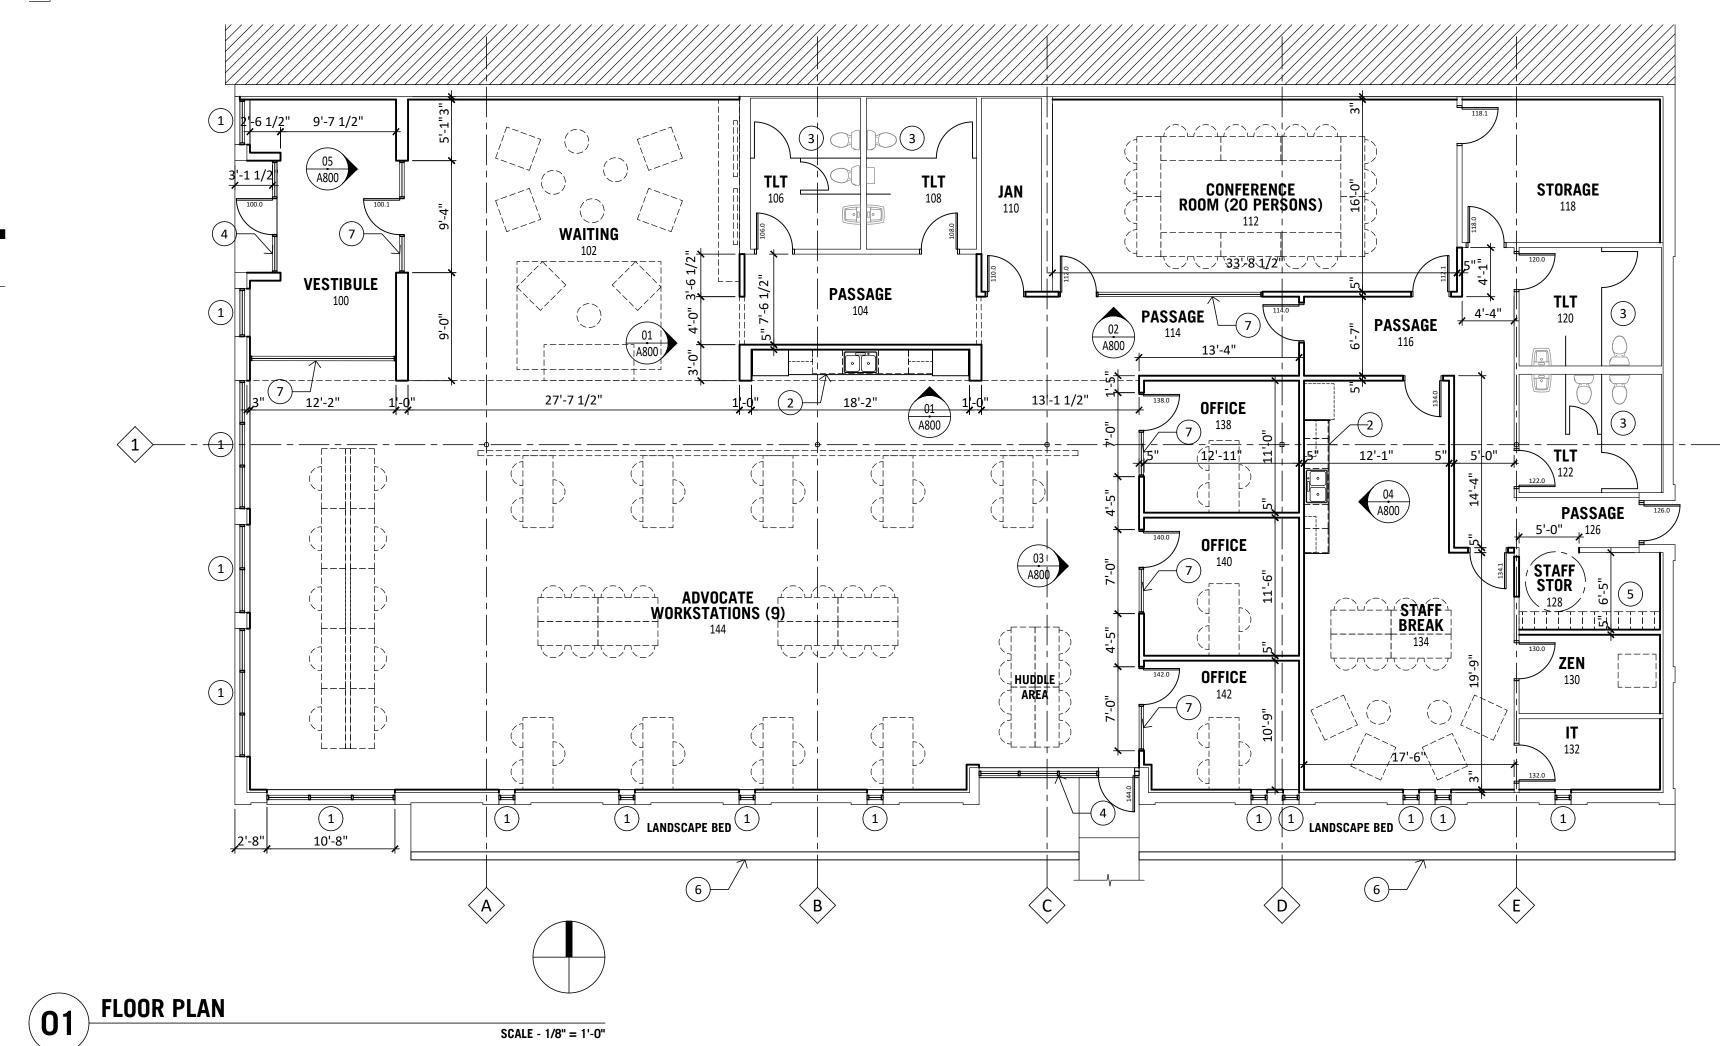

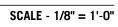

SCALE - 1/8" = 1'-0"

### **DEMOLITION PLAN GENERAL NOTES**

- A. REMOVE ALL EXISTING FLOORING MATERIALS.
- B. REMOVE ALL EXISTING CEILINGS.
- C. REMOVE ALL EXISTING.
- D. REMOVE ALL EXISTING DOORS AND FRAMES SHOWN DASHED WITH EXCEPTION OF EXISTING FRAMES INDICATED TO REMAIN.
- E. REMOVE ALL EXISTING WALLS AND FURRING SHOWN DASHED.

### **DEMOLITION PLAN GENERAL NOTES**

- REMOVE EXISTING STOREFRONT WINDOW OR STOREFRONT ENTRY DOOR.
- 2 REMOVE EXTERIOR WALL.
- 3 REMOVE EXISTING DOOR EXISTING FRAME TO REMAIN.
- 4 REMOVE EXISTING PARTITION / FURRING.
- 5 REMOVE EXISTING TOILET PARTITION.
- 6 REMOVE EXISTING PLUMBING FIXTURES.

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### FLOOR PLAN GENERAL NOTES

- A. FLOOR PLAN DIMENSIONS ARE NOMINAL TAKEN FROM FACE OF WALLS.
- B. FINISHED FLOOR ELEVATION 100'-0" (ARCHITECTURAL).
- C. FURNITURE (SHOWN DASHED) BY OWNER COORDINATE POWER REQUIREMENTS WITH OWNER.

### FLOOR PLAN KEYED NOTES

- (1) NEW STOREFRONT WINDOW AND PRECAST SILL
- (2) PLASTIC LAMINATE CASEWORK.
- (3) METAL TOILET PARTITIONS AND ACCESSORIES.
- (4) NEW STOREFRONT ENTRANCE SYSTEM.
- (5) STAFF LOCKERS VERIFY COUNT WITH OWNER.
- (6) | NEW 18" ABOVE GRADE CONCRETE LANDSCAPE WALL WITH BOARD FORMED TEXTURE.
- (7) INTERIOR ALUMINUM STOREFRONT FRAMING.

### **INTERIOR PARTITION DESCRIPTIONS**

<b>P1</b>	INTERIOR FURRING - STEEL STUDS: 2" RIGID INSULATION WITH 3-5/8 STEEL STUDS AT 16" OC, (1) LAYER 5/8" GYPSUM BOARD. EXTEND FURRING FULL HEIGHT TO DECK ABOVE. EXTEND GYPSUM BOARD FULL HEIGHT TO DECK ABOVE EXCEPT AT CLG-2 EXTEND MIN 4" ABOVE CEILING.
P2>	INTERIOR PARTITION - STEEL STUDS: 3-5/8 STEEL STUDS AT 16" OC, (1) LAYER 5/8" GYPSUM BOARD AT EACH EXPOSED SIDE. PROVIDE SOUND ATTENUATING BLANKET INSULATION. EXTEND PARTITIONS FULL HEIGHT TO DECK ABOVE. EXTEND GYPSUM BOARD FULL HEIGHT TO DECK ABOVE EXCEPT AT CLG-2 EXTEND MIN 4" ABOVE CEILING.
	<ol> <li>INTERIOR PARTITION NOTES:</li> <li>ALL INTERIOR WALLS TO BE (P2) UNLESS OTHERWISE NOTED.</li> <li>ALL INTERIOR FURRING TO BE (P1) UNLESS OTHERWISE NOTED.</li> <li>PROVIDE BLOCKING/BACKING FOR INSTALLATION OF ACCESSIBILITY ACCESSORIES AND WALL MOUNTED ITEMS INDICATED ON THE DRAWINGS INCLUDING AGENCY PROVIDED ITEMS.</li> <li>PROVIDE ACOUSTICAL SEALANT AROUND ALL PENETRATIONS.</li> </ol>

Project Name Hunger Task Force Mitchell Street Offices

(#)

Set Type **Construction Documents** 

Project Number

24004


Sheet Name Demolition Plan and


Floor Plan Sheet Number

09-19-2024

Date



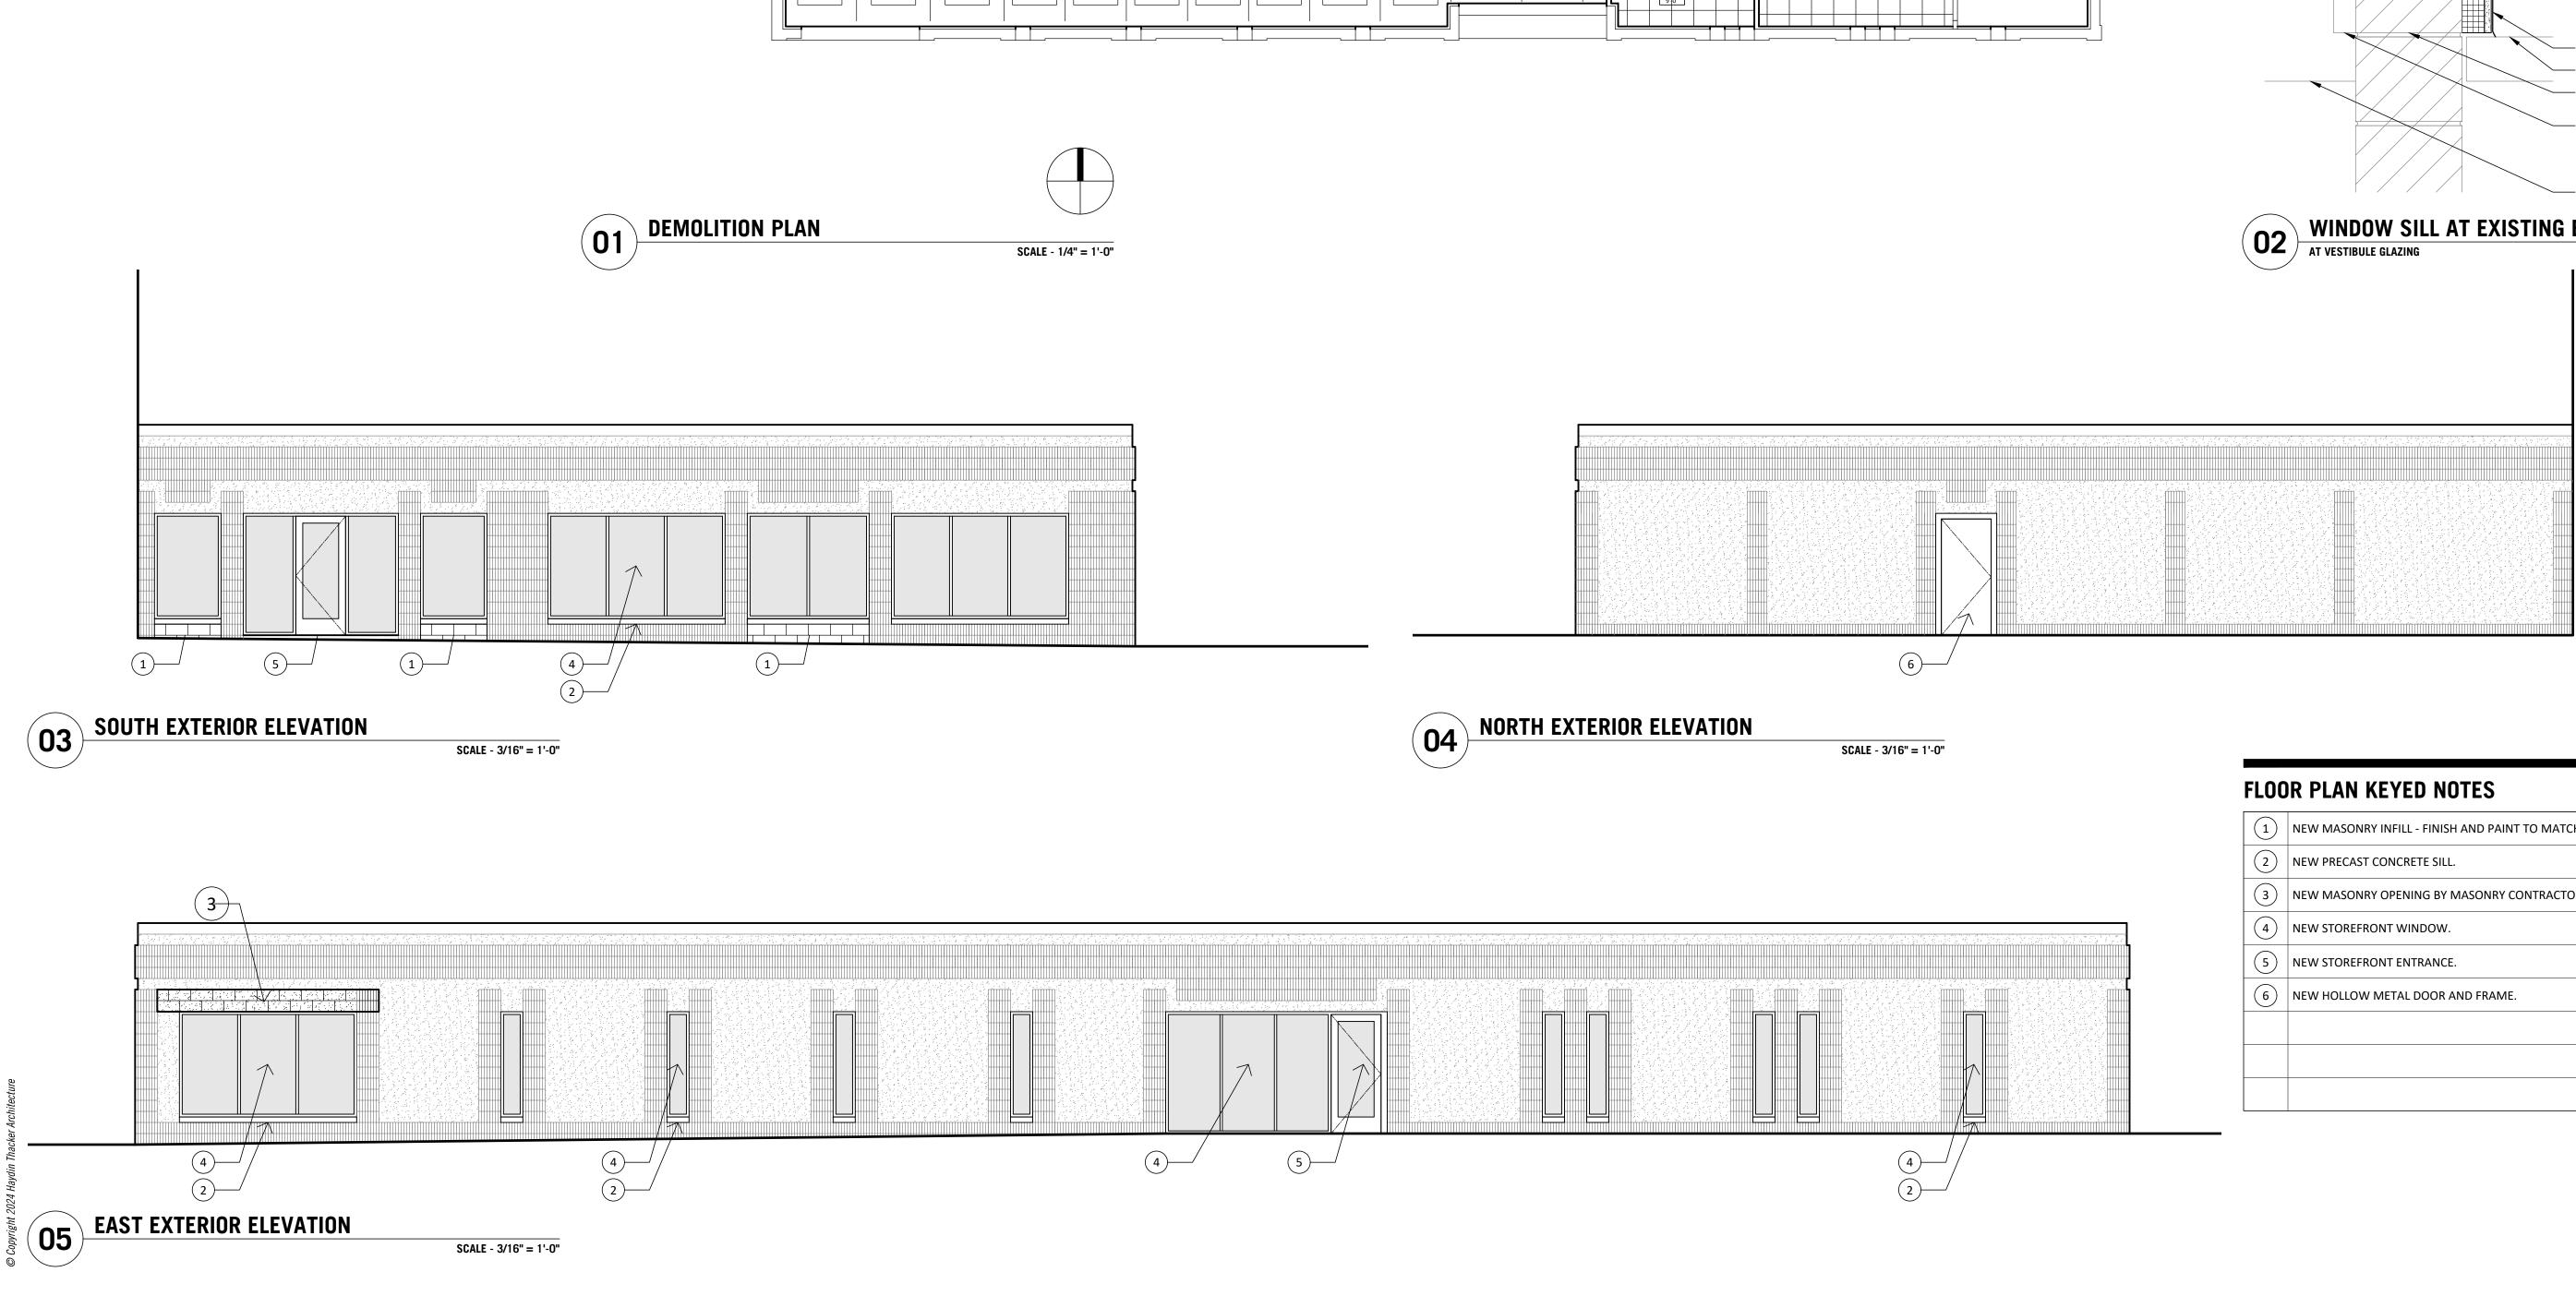

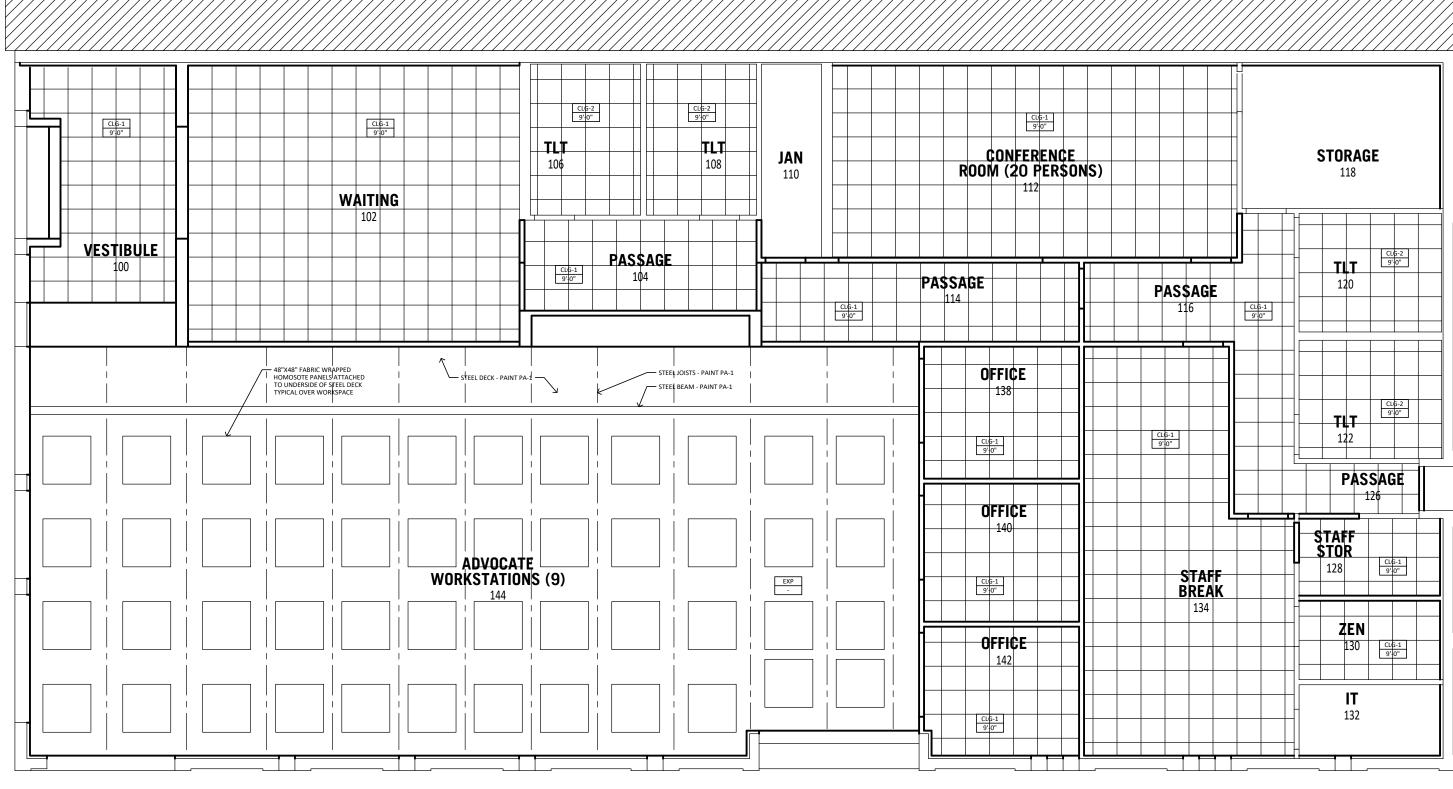


### **REFLECTED CEILING PLAN GENERAL NOTES**

- A. CENTER CEILING TILES IN ROOM.
- B. MINIMUM CEILING TILE DIMENSION AT WALLS AND PERIMETER = 4".

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- ALUMINUM STOREFRONT SYSTEM -BLACK

– BACKER ROD AND SEALANT - PRECAST CONCRETE SILL - GREY - CULTURED MARBLE WINDOW STOOL - CONCRETE MASONRY COURSE
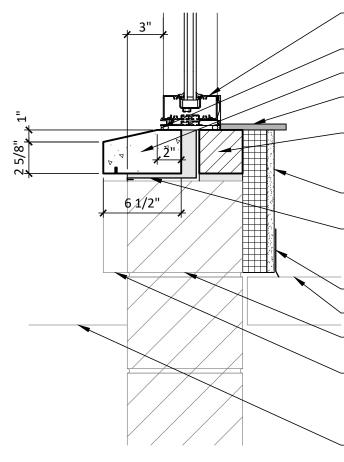
### -{P1}

- STAINLESS STEEL SUB-SILL FLASHING WITH UPTURNED LEG BEHIND SILL AND HEMMED EDGE AT EXTERIOR

— BASE AS SCHEDULED - EXISTING CONCRETE FLOOR - EXISTING CONCRETE MASONRY EXTERIOR WALL - DECORATIVE FLUTES ON EXISTING CONCRETE MASONRY

- GRADE AT EXTERIOR



WINDOW SILL AT EXISTING EXTERIOR WALL

SCALE - 1 1/2" = 1'-0"

FLOC	R PLAN KEYED NOTES (#
1	NEW MASONRY INFILL - FINISH AND PAINT TO MATCH EXISTING.
2	NEW PRECAST CONCRETE SILL.
3	NEW MASONRY OPENING BY MASONRY CONTRACTOR.
4	NEW STOREFRONT WINDOW.
5	NEW STOREFRONT ENTRANCE.
6	NEW HOLLOW METAL DOOR AND FRAME.

Project Name Hunger Task Force Mitchell Street Offices

Set Type **Construction Documents** 

> Project Number 24004


Sheet Name Demolition Plan and Floor Plan Sheet Number

09-19-2024



ROOM NUMBER	ROOM NAME	FLOORS		NORTH WALL		SOUTH WALL		EAST WALL		WEST WALL		CEILING		WINDOW	
		ТҮРЕ	BASE	ТҮРЕ	FINISH	ТҮРЕ	FINSH	ТҮРЕ	FINISH	ТҮРЕ	FINISH	ТҮРЕ			S REMARKS
100	VESTIBULE	CPT-1	RB-1	GYP	PA	GLAZING	-	GLAZING	-	GLAZING		CLG-2			
102	WAITING	CPT-2	RB-1	GYP	PA			GYP	РА	GLAZING		CLG-2			
104	PASSAGE	CPT-2	RB-1	GYP	PA	GYP	РА	GYP	РА	GYP	РА	CLG-1			
106	TLT	EXST	EXST	EXST	EXST	EXST	EXST	EXST	EXST	EXST	EXST	CLG-1			
108	TLT	EXST	EXST	EXST	EXST	EXST	EXST	EXST	EXST	EXST	EXST	CLG-1			
110	JAN	EXST	EXST	EXST	EXST	EXST	EXST	EXST	EXST	EXST	EXST	EXST			
112	CONFERENCE ROOM	CPT-3	RB-1	GYP	PA	GYP	PA	GYP	PA	GYP	РА	CLG-1			
114	PASSAGE	CPT-2	RB-1	GYP	PA	GYP	РА	GYP	PA	GYP	РА	CLG-1			
116	PASSAGE	CPT-2	RB-1	GYP	PA	GYP	PA	GYP	PA	GYP	РА	CLG-1			
118	STORAGE		RB-1	GYP	PA	GYP	PA	GYP	РА	GYP	PA	EXST			
120	TLT	EXST	EXST	EXST	EXST	EXST	EXST	EXST	EXST	EXST	EXST	CLG-1			
122	TLT	EXST	EXST	EXST	EXST	EXST	EXST	EXST	EXST	EXST	EXST	CLG-1			
126	PASSAGE	CPT-2	RB-1	GYP	PA	GYP	PA	GYP	PA	GYP	PA	CLG-1			
128	STAFF STORAGE	CPT-2	RB-1	GYP	PA	GYP	PA	GYP	PA	GYP	PA	CLG-1			
130	ZEN	CPT-2	RB-1	GYP	PA	GYP	PA	GYP	PA	GYP	PA	CLG-1			
132	IT	EXST	EXST	EXST	EXST	EXST	EXST	EXST	EXST	EXST	EXST	EXST			
134	STAFF BREAK	LVP-1	RB-1	GYP	PA	GYP	PA	GYP	PA	GYP	PA	CLG-1		WT-1	
138	OFFICE	CPT-3	RB-1	GYP	PA	GYP	PA	GYP	PA	GYP	PA	CLG-1			
140	OFFICE	CPT-3	RB-1	GYP	PA	GYP	PA	GYP	PA	GYP	PA	CLG-1			
142	OFFICE	CPT-3	RB-1	GYP	PA	GYP	PA	GYP	PA	GYP	PA	CLG-1		WT-1	
144	ADVOCATE WORK	SV-1	RB-1	GYP	PA	GYP	PA	GYP	PA	GYP	PA	EXPOSED	РА	WT-1	
GENERAL N	OTES														
4															

KEYNOTE	DESCRIPTION	
PLAM-1	PLASTIC LAMINATE CASEWORK	FORMICA, 1547-PG NOIR CEDAR, PURE G
PLAM-2	PLASTIC LAMINATE CASEWORK	FORMICA, 1545-PG RAW CEDAR, PURE G
SS-1	SOLID SURFACE COUNTERTOP	CORIAN, COLOR = ARROWROOT.
RB-1	RESILIENT BASE	TARKETT, COVED BASE, 4" PROFILE, 63 B
CLG-1	ACOUSTICAL CEILING TILES (2X2)	ARMSTRONG, CIRRUS, 24 X 24 BEVELED
CLG-2	ACOUSTICAL CEILING TILES (2X2 MOISTURE RESISTANT)	PAINTED GYPSUM BOARD PANELS
CPT-1	CARPET TILE	TBD
CPT-2	CARPET TILE	TBD
CPT-3	CARPET TILE	TBD
PA-1	PAINT (CEILINGS)	SHERWIN WILLIAMS - SW7069 IRON ORE
PA-2	PAINT (PRIMARY INTERIOR)	SHERWIN WILLIAMS - SW 9166 DRIFT OF
PA-3	PAINT (ACCENT INTERIOR)	SHERWIN WILLIAMS - SW 7051 ANALYTI
PA-4	PAINT (ACCENT INTERIOR)	SHERWIN WILLIAMS - SW 6207 RETREAT
PA-5	PAINT (ACCENT INTERIOR)	SHERWIN WILLIAMS - SW7069 IRON ORE
WT-1	MESH ROLLER SHADES	VERIFY MANUFACTURER

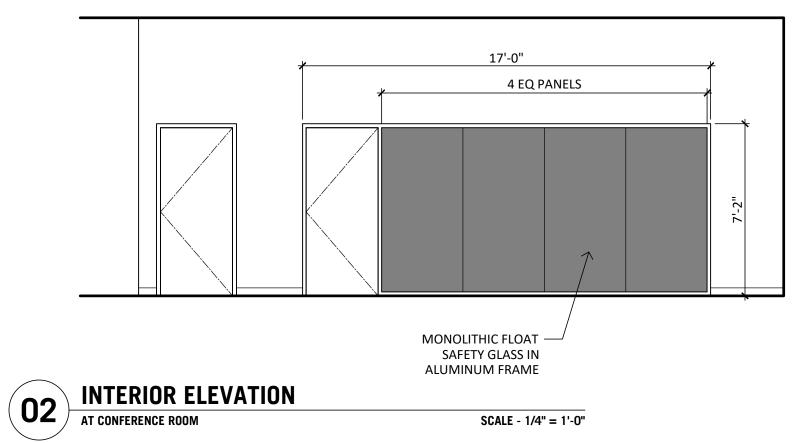

MARK	ROOM	ROOM NAME	DOOR							FR	AME				DEMADING
WARK	NUMBER	ROOMINAME	TYPE	MATL	WIDTH	HEIGHT	FINISH	GLASS	TYPE	MATL	FINISH	GLASS	HARDWARE AND LOCKING	FIRE RATING	REMARKS
L00.0	100	VESTIBULE		ALUM	3'-0"	7'-2"	PREFIN	IG	-	ALUM	PREFIN	IG			FV DOOR HEIGHT
L00.1	100	VESTIBULE		ALUM	3'-0"	7'-2"	PREFIN	MG	-	ALUM	PREFIN	MG			FV DOOR HEIGHT
106.0	106	TLT	FLUSH	WD	3'-0"	7'-0"	PREFIN		EXST	НМ	PA				
108.0	108	TLT	FLUSH	WD	3'-0"	7'-0"	PREFIN		EXST	НМ	PA				
110.0	110	JANITOR	FLUSH	WD	3'-0"	7'-0"	PREFIN			НМ	PA				
112.0	112	CONFERENCE ROOM	FLUSH	WD	3'-0"	7'-0"	PREFIN			ALUM	PREFIN				
112.1	112	CONFERENCE ROOM	FLUSH	WD	3'-0"	7'-0"	PREFIN			НМ	PA				
L14.0	114	PASSAGE	FLUSH	WD	3'-0"	7'-0"	PREFIN			НМ	PA				
L18.0	118	STORAGE	FLUSH	WD	3'-0"	7'-0"	PREFIN		EXST	НМ	PA				
120.0	120	TLT	FLUSH	WD	3'-0"	7'-0"	PREFIN		EXST	НМ	PA				
122.0	122	TLT	FLUSH	WD	3'-0"	7'-0"	PREFIN		EXST	НМ	PA				
126.0	126	PASSAGE	FLUSH	НМ	3'-0"	7'-0"	PREFIN			НМ	PA				
130.0	130	ZEN	FLUSH	НМ	3'-0"	7'-0"	PREFIN			НМ	PA				
132.0	132	IT	FLUSH	НМ	3'-0"	7'-0"	PREFIN			НМ	PA				
L34.0	134	STAFF BREAK	FLUSH	НМ	3'-0"	7'-0"	PREFIN			НМ	PA				
L34.1	134	STAFF BREAK	FLUSH	НМ	3'-0"	7'-0"	PREFIN			НМ	PA				
L38.0	138	OFFICE	FLUSH	WD	3'-0"	7'-0"	PREFIN			ALUM	PREFIN				
L40.0	140	OFFICE	FLUSH	WD	3'-0"	7'-0"	PREFIN			ALUM	PREFIN				
L42.0	142	OFFICE	FLUSH	WD	3'-0"	7'-0"	PREFIN			ALUM	PREFIN				
L44.0	144	ADVOCATE WORKSTATIONS		ALUM	3'-0"	7'-2"	PREFIN	IG	-	ALUM	PREFIN	IG			FV DOOR HEIGHT

GENERAL NOTES

IG = INSULATING GLASS

MG = MONOLITHIC FLOAT GLASS TEMPERED

KEYED REMARKS

BASIS OF DESIGN PRODUCT

E GRAIN TEXTURE.

E GRAIN TEXTURE.

3 BURNT UMBER B.

ED TEGULAR LAY-IN CEILING PANELS.


ORE, FLAT SHEEN.


OF MIST, EG-SHEL SHEEN.

YTICAL GRAY, EG-SHEL SHEEN.

EAT, EG-SHEL SHEEN.


ORE, SEMI-GLOSS SHEEN.

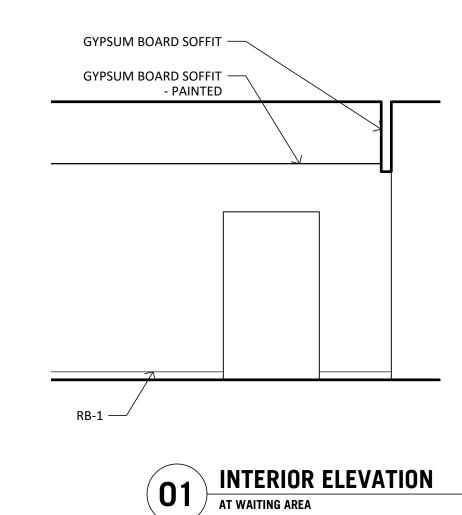

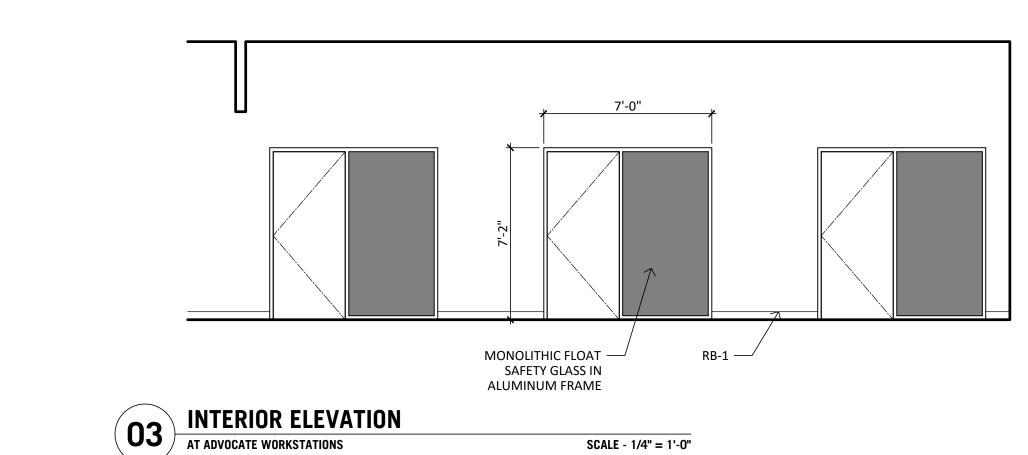


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131 W. Seeboth St., Suite 230 Milwaukee, WI 53204

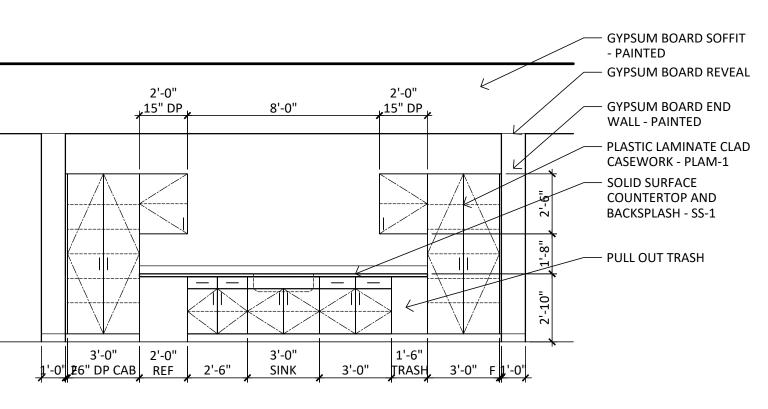

SCALE - 1/4" = 1'-0"



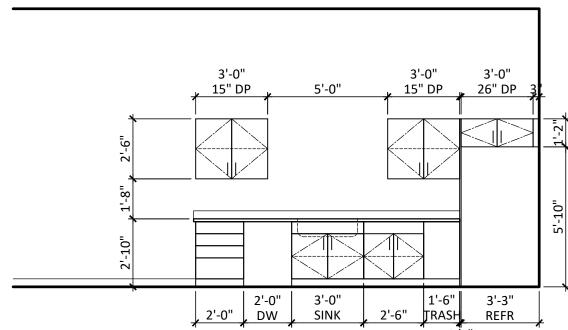



INTERIOR ELEVATION (04) INTERIUK EL AT STAFF BREAKROOM

SCALE - 1/2" = 1'-0"

Project Name Hunger Task Force Mitchell Street Offices

Set Type **Construction Documents** 

Project Number 09-19-2024 24004

Sheet Name Interior Elevations and Schedules

Sheet Number

**A800** 

Date