



Architect Note:

This project involves the replacement of an existing east facing deck that is original to this 1903 historically significant home. Per Historic Preservation Standards, we intend to reconstruct the deck nearly identically to the existing deck in size and materials, with one exception - we intend to increase the usable space of the deck by moving the east wall further east by 4'-0".

We believe that this deck expansion falls within the allowable average setbacks allowed by the RT2 zoning districts, and as the deck floor is less than 3'-0" above grade, it is not included in lot area calculations.

We intend to seek a variance for both the deck wall height and provision of handrails in order to maintain the historic heights and character of the deck.

ZONING ANALYSIS

ZONING DISTRICT

TWO-FAMILY RESIDENTIAL DISTRICT (RT2)

A single family home is a permitted use within the RT-2 district

	Table 295-505-2 PRINCIPAL BUILDING DESIGN STANDARDS									
		Two-family Districts								
		RT1	RT2	RT3	RT4					
	Lot area, minimum (sq. ft.) detached housing	7,200	4,800	3,000	2,400	Project lot area: 11,250sf				
	Lot area, minimum (sq. ft.) attached housing	3,600	3,000	1,800	1,800					
l to	Lot area, maximum (sq. ft.)	none	none	none	none					
	Lot width, minimum (ft.) detached housing	60	40	30	24	Project lot width: 75'-0"				
	Lot width, minimum (ft.) attached housing	30	25	18	18					
	Lot width, maximum (ft.)	none	none	none	none					
	Lot area per dwelling unit, minimum (sq. ft.)	3,600	2,400	1,800	1,200	Project lot area/du: 11,250sf				
	Lot area per roomer or transitional housing client, minimum (sq. ft.)	NA	NA	NA	600					
	Lot coverage, minimum interior lot	none	none	*	*					
ensity	Lot coverage, maximum <i>interior lot</i>	30%	30%	50%	70%	Project lot coverage: 3,403sf/11,250sf = 30%				
Den	Lot coverage, minimum comer lot	none	none	*	*	**Note: Floor of existing front deck is less than 3'-0"				
	Lot coverage, maximum corner lot	40%	40%	60%	85%	above grade. Per table 295-505-3 for Accessory Structure Design Standards, the deck is not included in the lot coverage calculation.				
	Floor area, minimum (sq. ft.) <i>one-story structure</i>	none	none	none	none					
	Floor area, minimum (sq. ft.) <i>split-level or taller</i>	none	none	none	none	The existing deck nor the replacement deck are included in the area used for lot coverage calculation.				
Ŧ	Height, minimum (ft.)	none	none	*	*					
Height	Height, maximum (ft.)	45	45	45	48					

*The requirements of table 295-505-2-i apply in lieu of the minimum lot coverage and minimum height requirements of this table.

**A structure shall meet the minimum height requirements of table 295-505-2-i unless it is adjacent to a lot containing a one-story house, in which case there shall be no minimum height requirement.

	height requirement.									
		Two-family Districts								
		RT1	RT2	RT3	RT4					
0	Front setback, minimum (ft.) (see s. 295-505-2-b)	average	average	average	average					
Primary Frontage	A)	none	none		never more than 20 ft.	**Note: The assumed average setback is found by averaging the setbacks of the adjacent structures. Per 295-505-2 (b), the front setback may be anywhere in the range of the average setback +/- 20% 45'-8" + 29'-10" / (2) = 37'-9" + 20% = 45'-3" to 30'-3" Per table 295-505-3 for Accessory Structure Design Standards, the deck should have the				
	Side street setback, minimum (ft.)	20% of but nev than	er more	10% of lot width but never more than 6 ft.	3					
	Side street setback, maximum (ft.)	none	none	none	15	same front setback as the prinicpal building.				
	North or west side setback, minimum (ft.)	3	3	1.5	1.5	North setback: 3'-0" (verify west setback on survey)				
Setback	South or east side setback, minimum (ft.)	6	6	3.5	3.5	South setback: 18'-0"				
	Combined side setback, minimum (ft.)	12	12	5	5					
l e	Maximum depth of building without side setback adjustment	50	50	75	100					
	Max. no. of stories without side or rear setback adjustment	2	2	3	4					
<u>ب</u>	Rear setback, minimum (ft.) <i>interior lot</i>	25	25	15	15					
etback	Rear setback, minimum (ft.) corner lot	20	20	10	10					
Rear	Dear street eetheels minimum (ft)	average	average	average	average					
	Rear street setback, maximum (ft.)	none	none	none	none					
Mult	Multiple principal residential buildings permitted?		no	no	yes, if in existence on Nov. 22, 2003; otherwise, special use					

CODE ANALYSIS

PER SPS 320-325 UNIFORM DWELLING CODE

SPS 321.04 STAIRWAYS:

- MINIMUM WIDTH = 36" : PROPOSED WIDTH = 6'-1" AND 3'-5"

- MAXIMUM RISER HEIGHT = 8" : **PROPOSED RISER HEIGHT = 6.25"**

- MINIMUM TREAD DEPTH = 9" : **PROPOSED TREAD DEPTH = 13"**

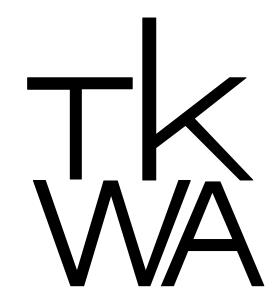
- UNIFORMITY = GREATEST RISER HEIGHT MAY NOT EXCEED SMALLEST RISER HEIGHT BY MORE THAN 3/8"

- HANDRAILS = A FLIGHT OF STAIRS WITH MORE THAN 3 RISERS SHALL BE PROVIDED WITH AT LEAST ONE HANDRAIL

** SEEK VARIANCE TO ALLOW PRIMARY STAIRS (AND NORTH STAIR) TO USE STAIR WING WALLS AS HANDRAIL?

- GUARDS MINIMUM HEIGHT = 36" : PROPOSED HEIGHT = 30"

**SEEK VARIANCE TO ALLOW FOR 30" HISTORIC PORCH WALL HEIGHT TO REMAIN



The Kubala Washatko Architects, Inc W61 N617 Mequon Avenue Cedarburg, WI 53012 p: 262.377.6039 | f: 262.377.2954

PROJECT

Roepsch Residence

Historic Deck Replacement 2239 N Terrace Ave Milwaukee, WI 53202

OWNER

Thomas and Suzanne Roepsch 2239 N Terrace Ave Milwaukee, WI 53202 414.791.4366

CONSTRUCTION MANAGER

ADK

2738 South 13th Street Milwaukee, WI 53215 p: 414.915.0516

STRUCTURAL ENGINEER

SPIRE ENGINEERING, INC. 305 N. Plankinton Ave., Suite 101 Milwaukee, WI 53203 p: 414.278.9200

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November 7, 2023

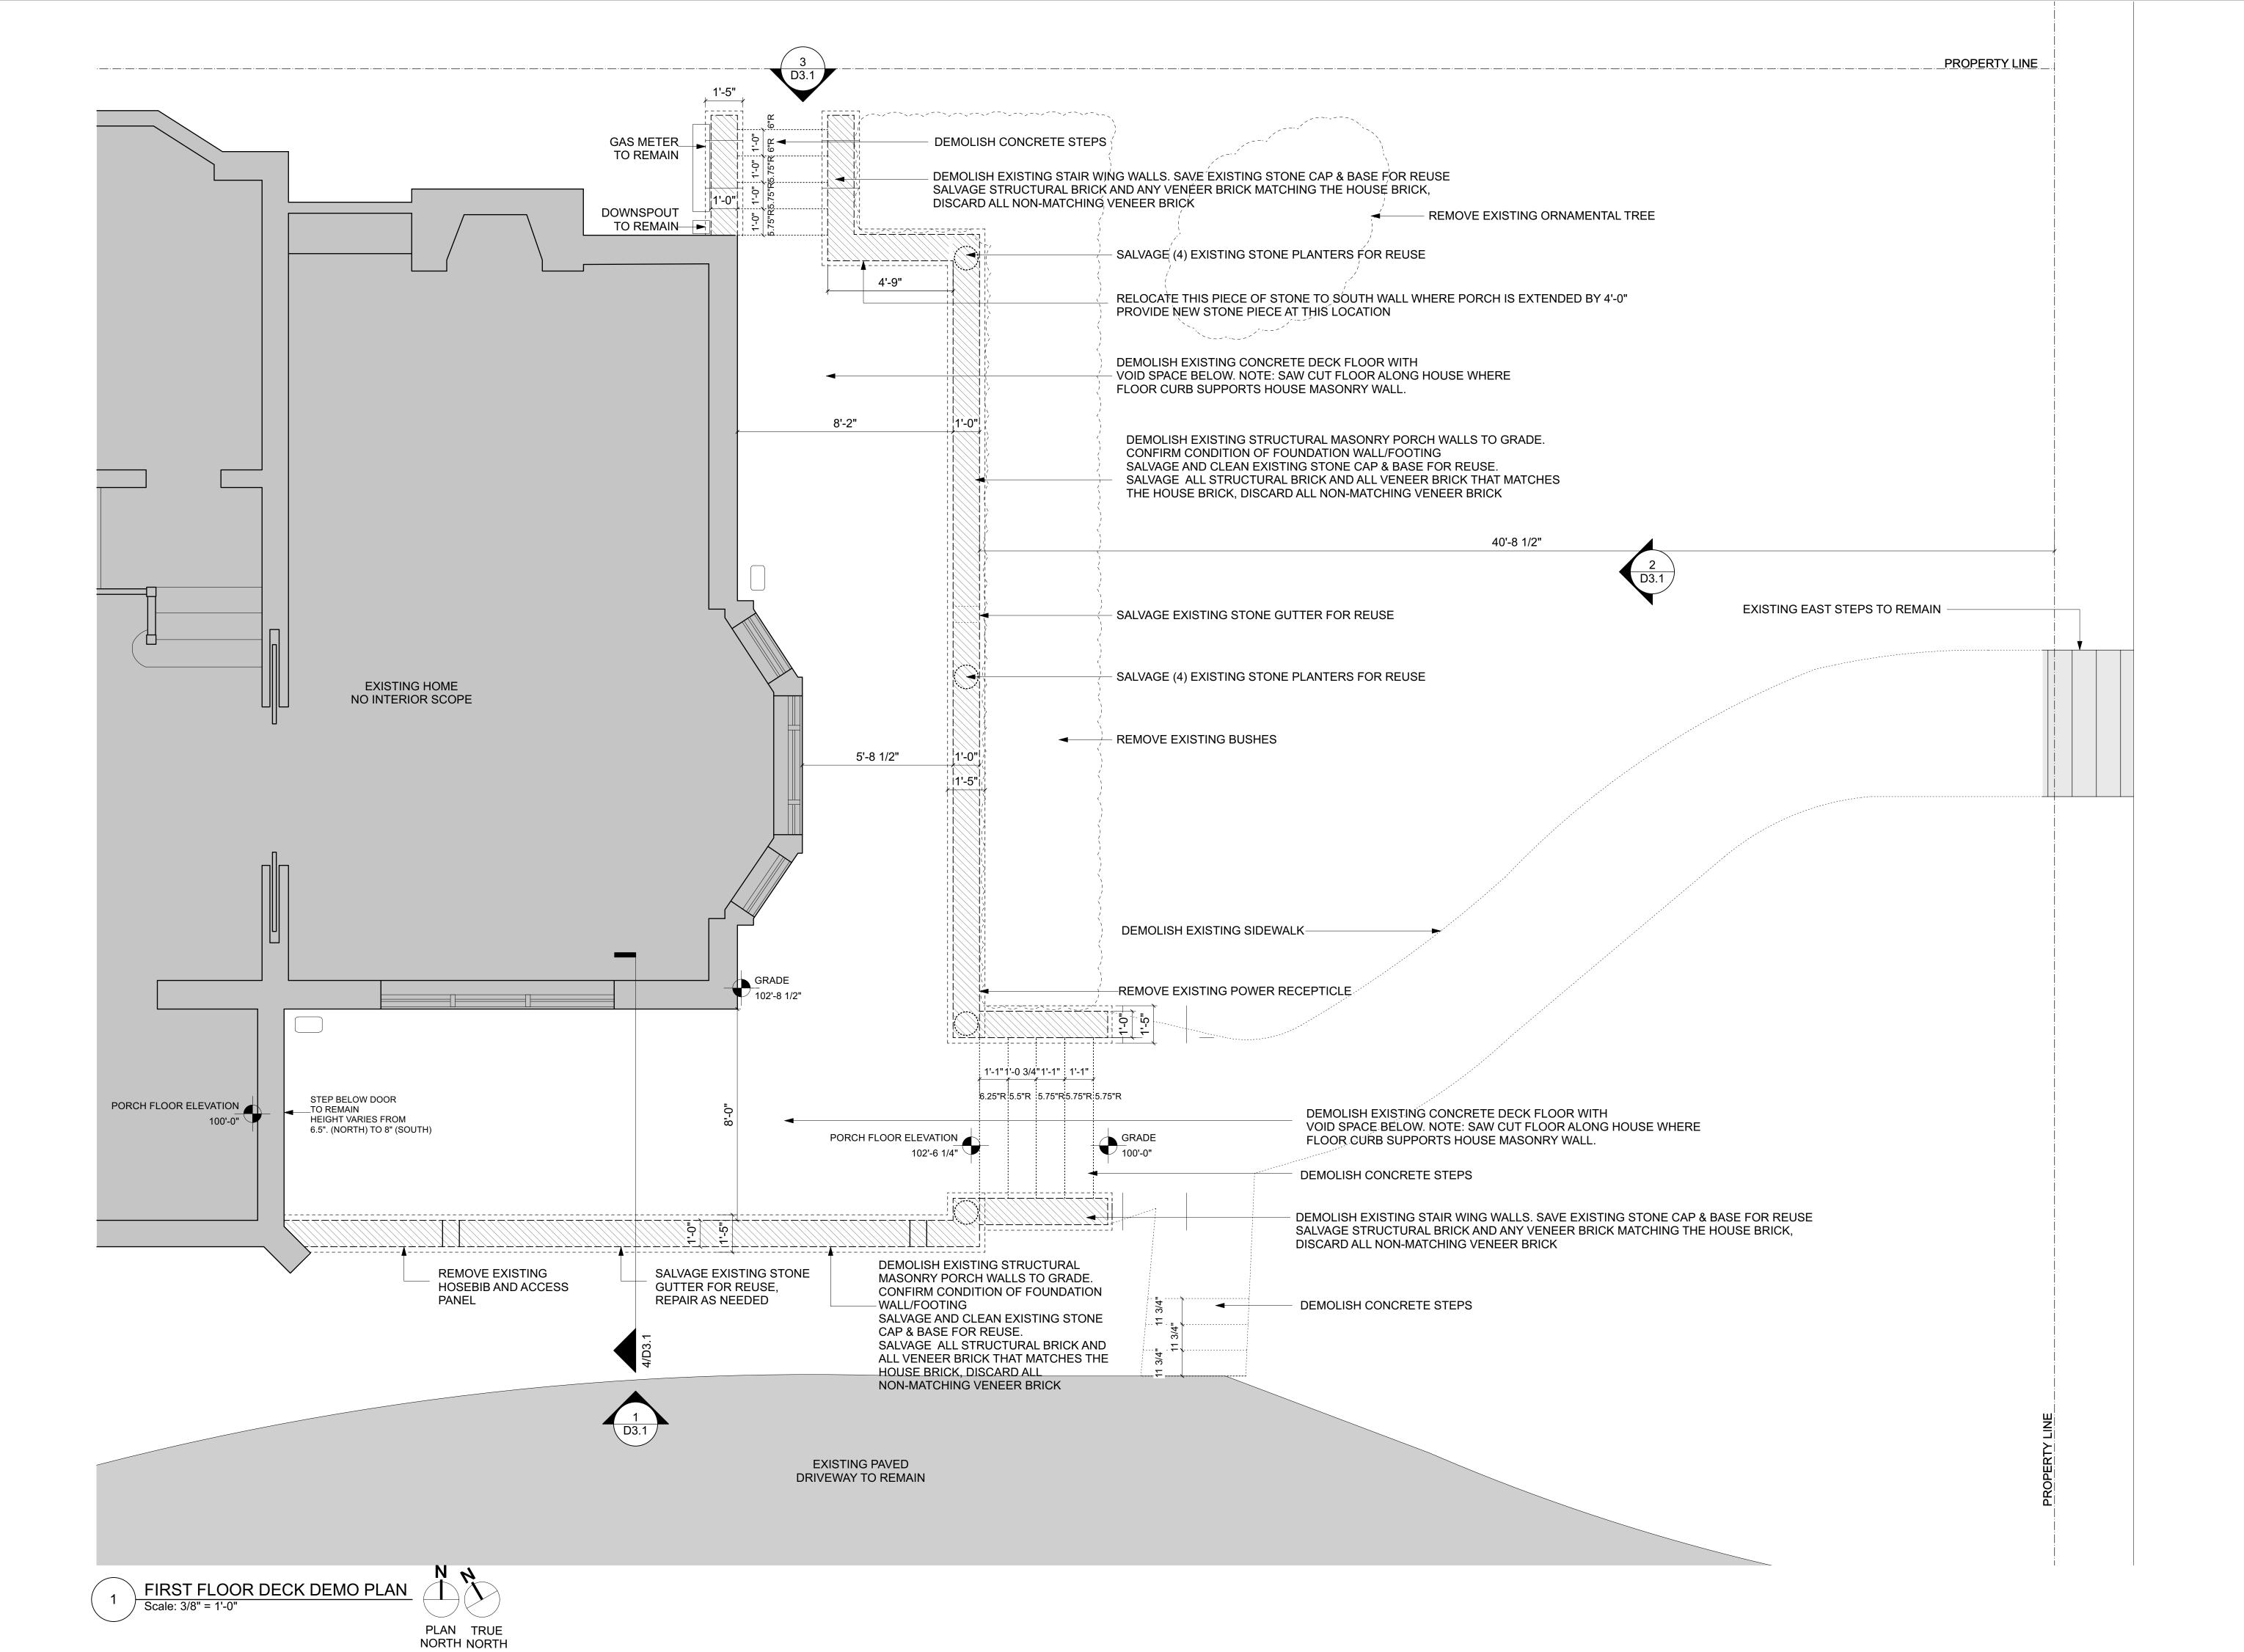
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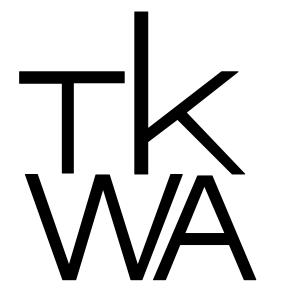
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SHEET TITLE

CODE AND ZONING PLAN

SHEET NUMBER





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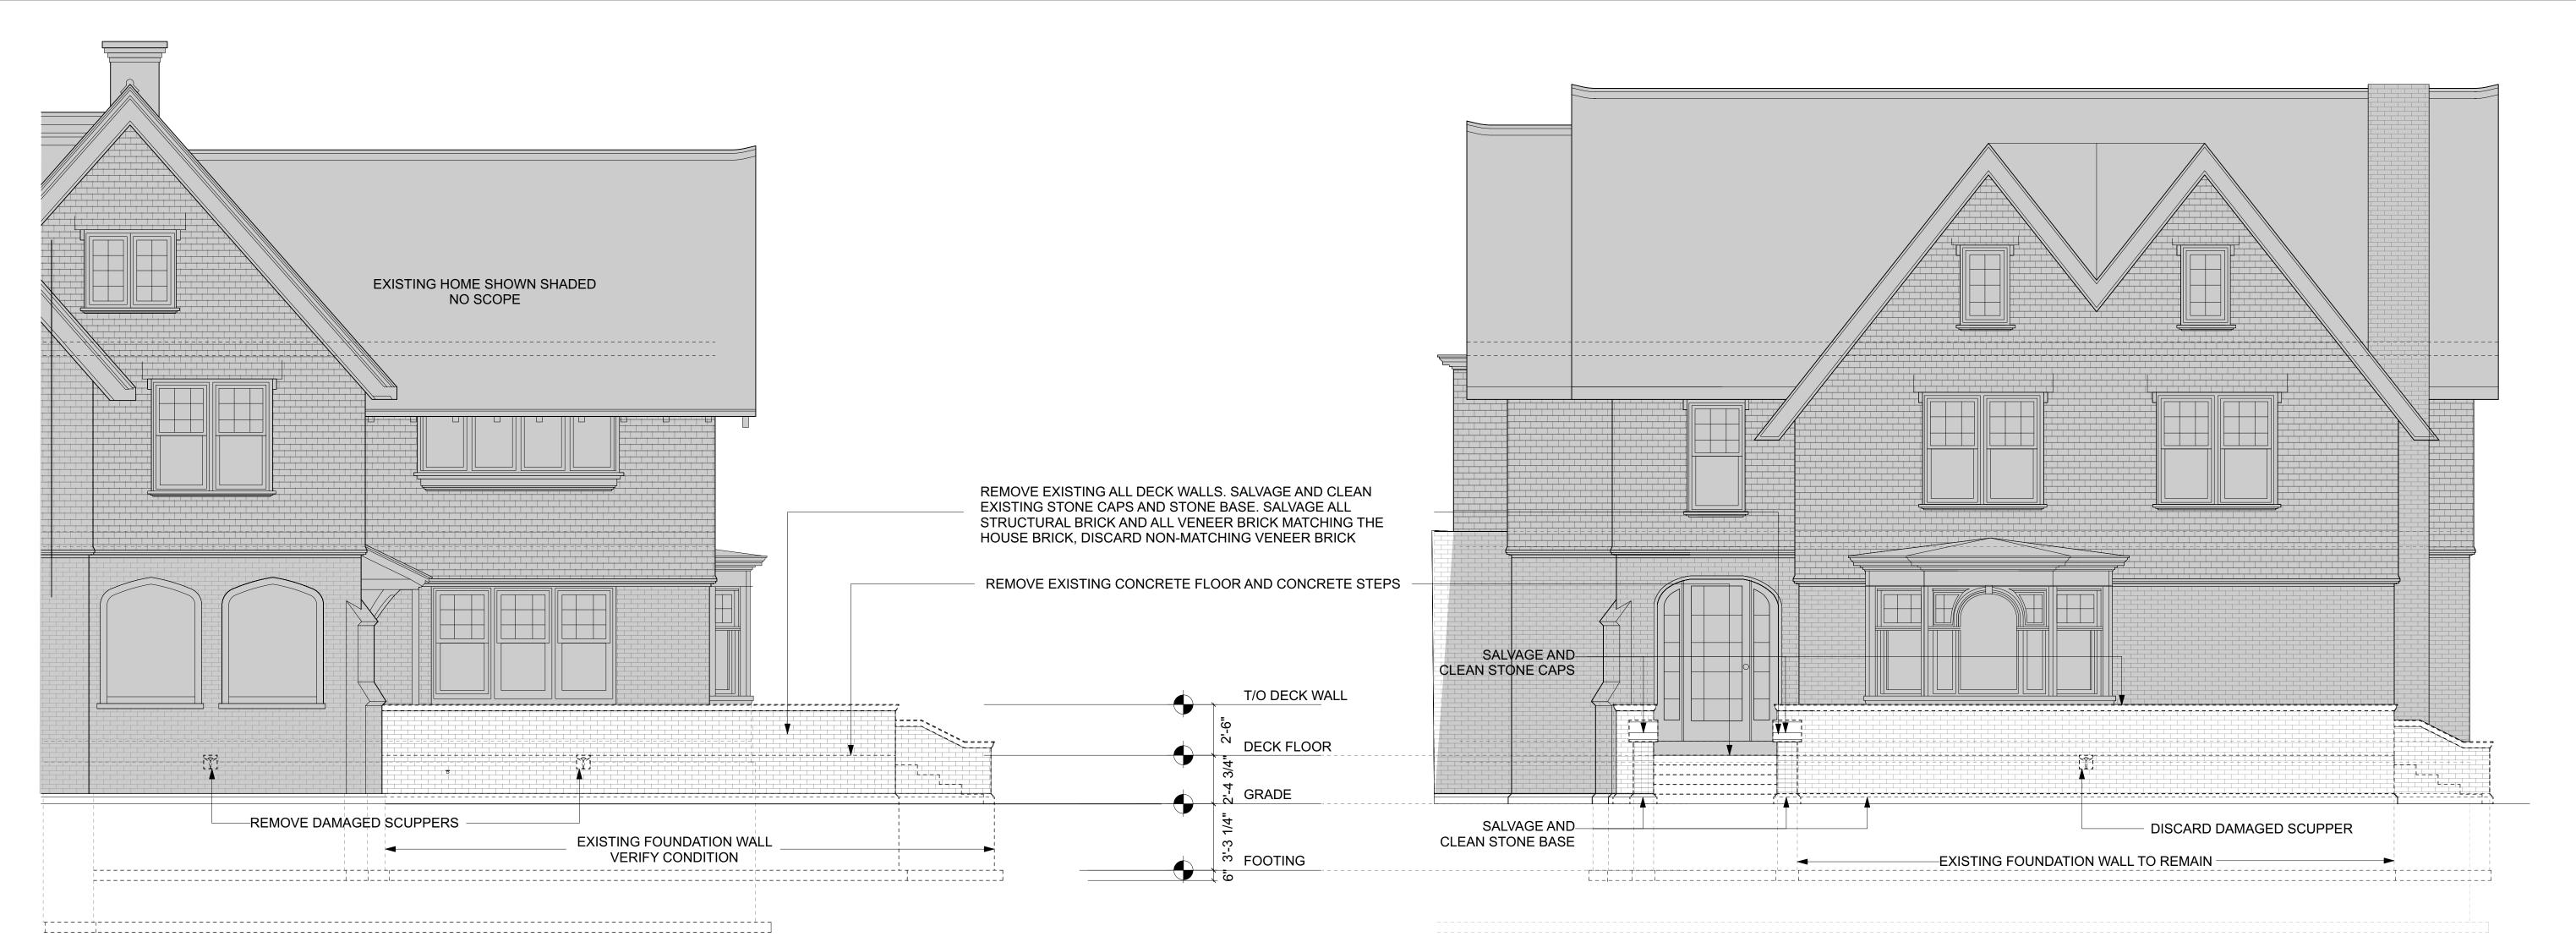
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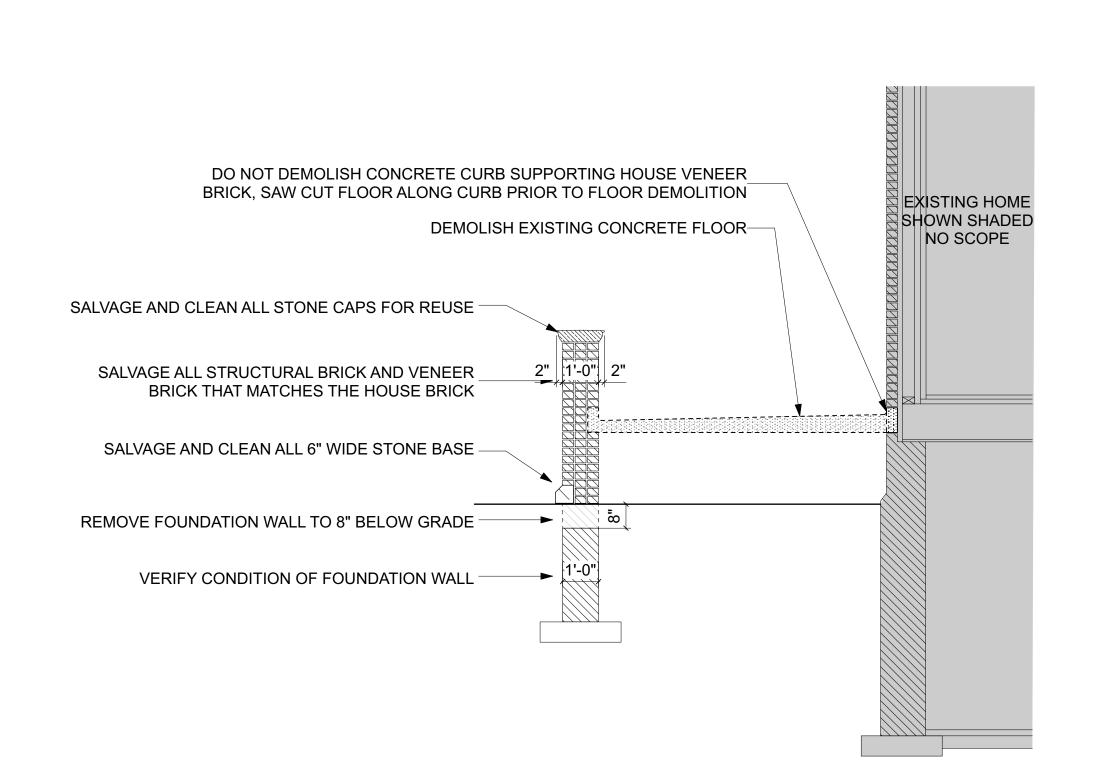
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First Floor Deck Demo Plan

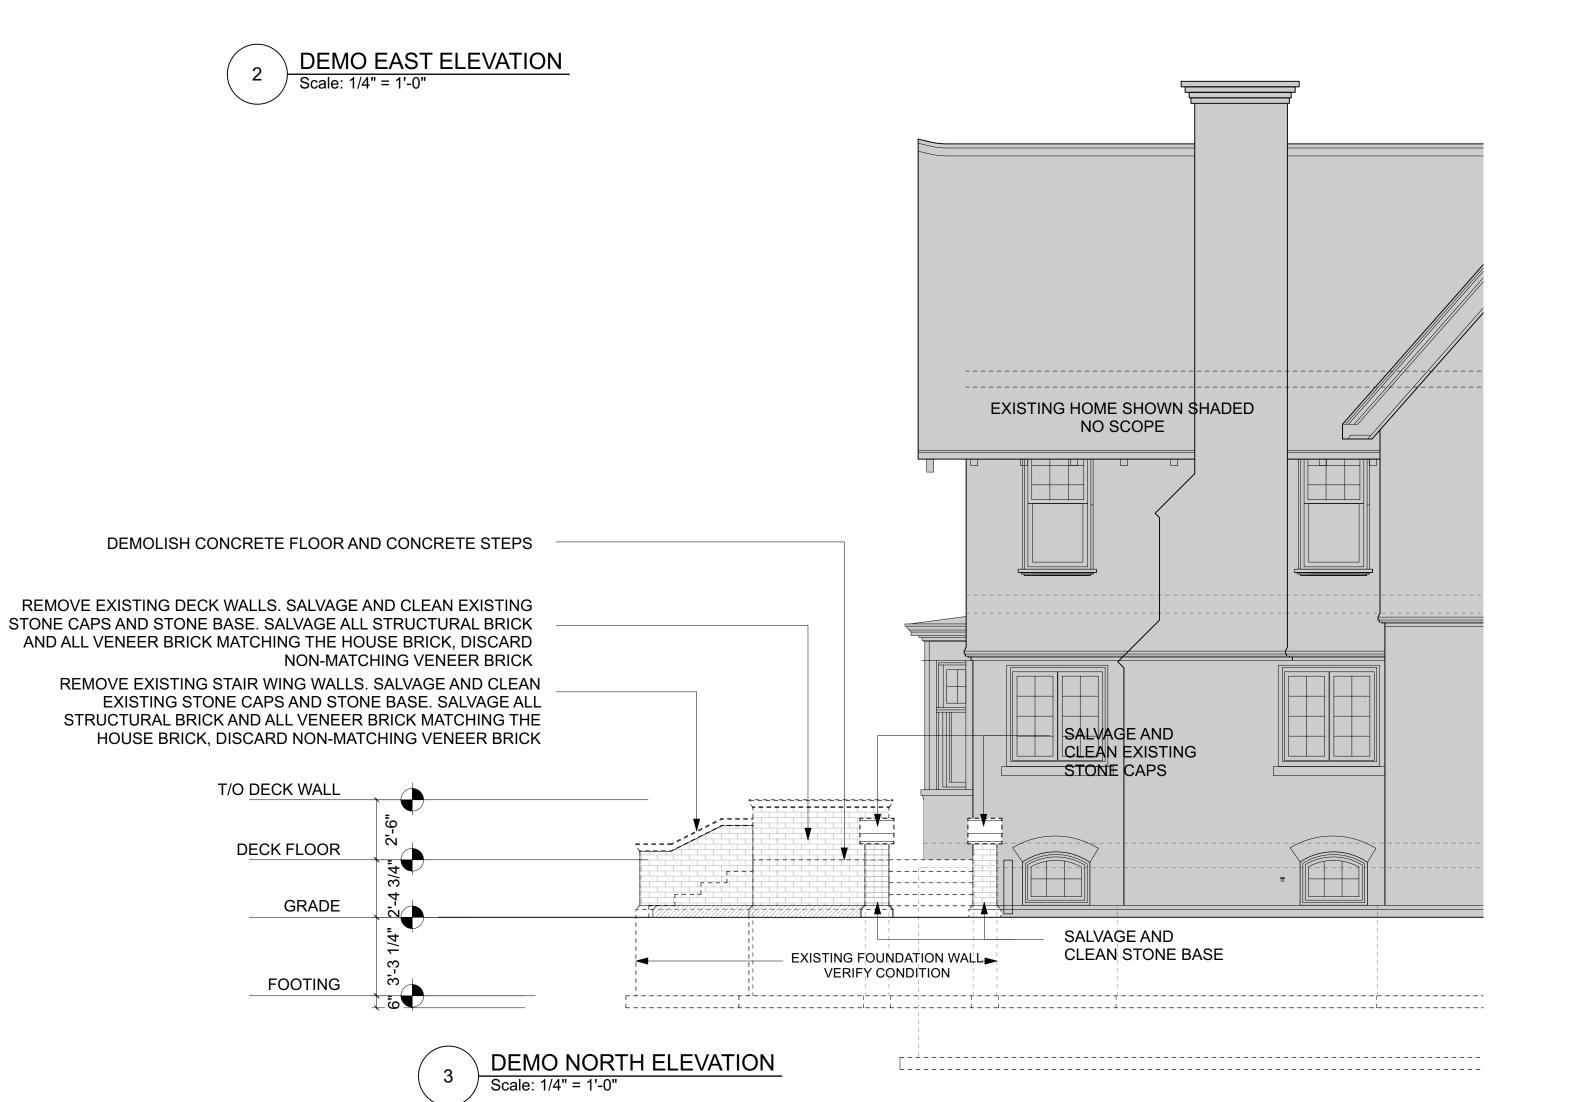
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1 DEMO SOUTH ELEVATION
Scale: 1/4" = 1'-0"



4 DEMOLITION SECTION
Scale: 3/8" = 1'-0"



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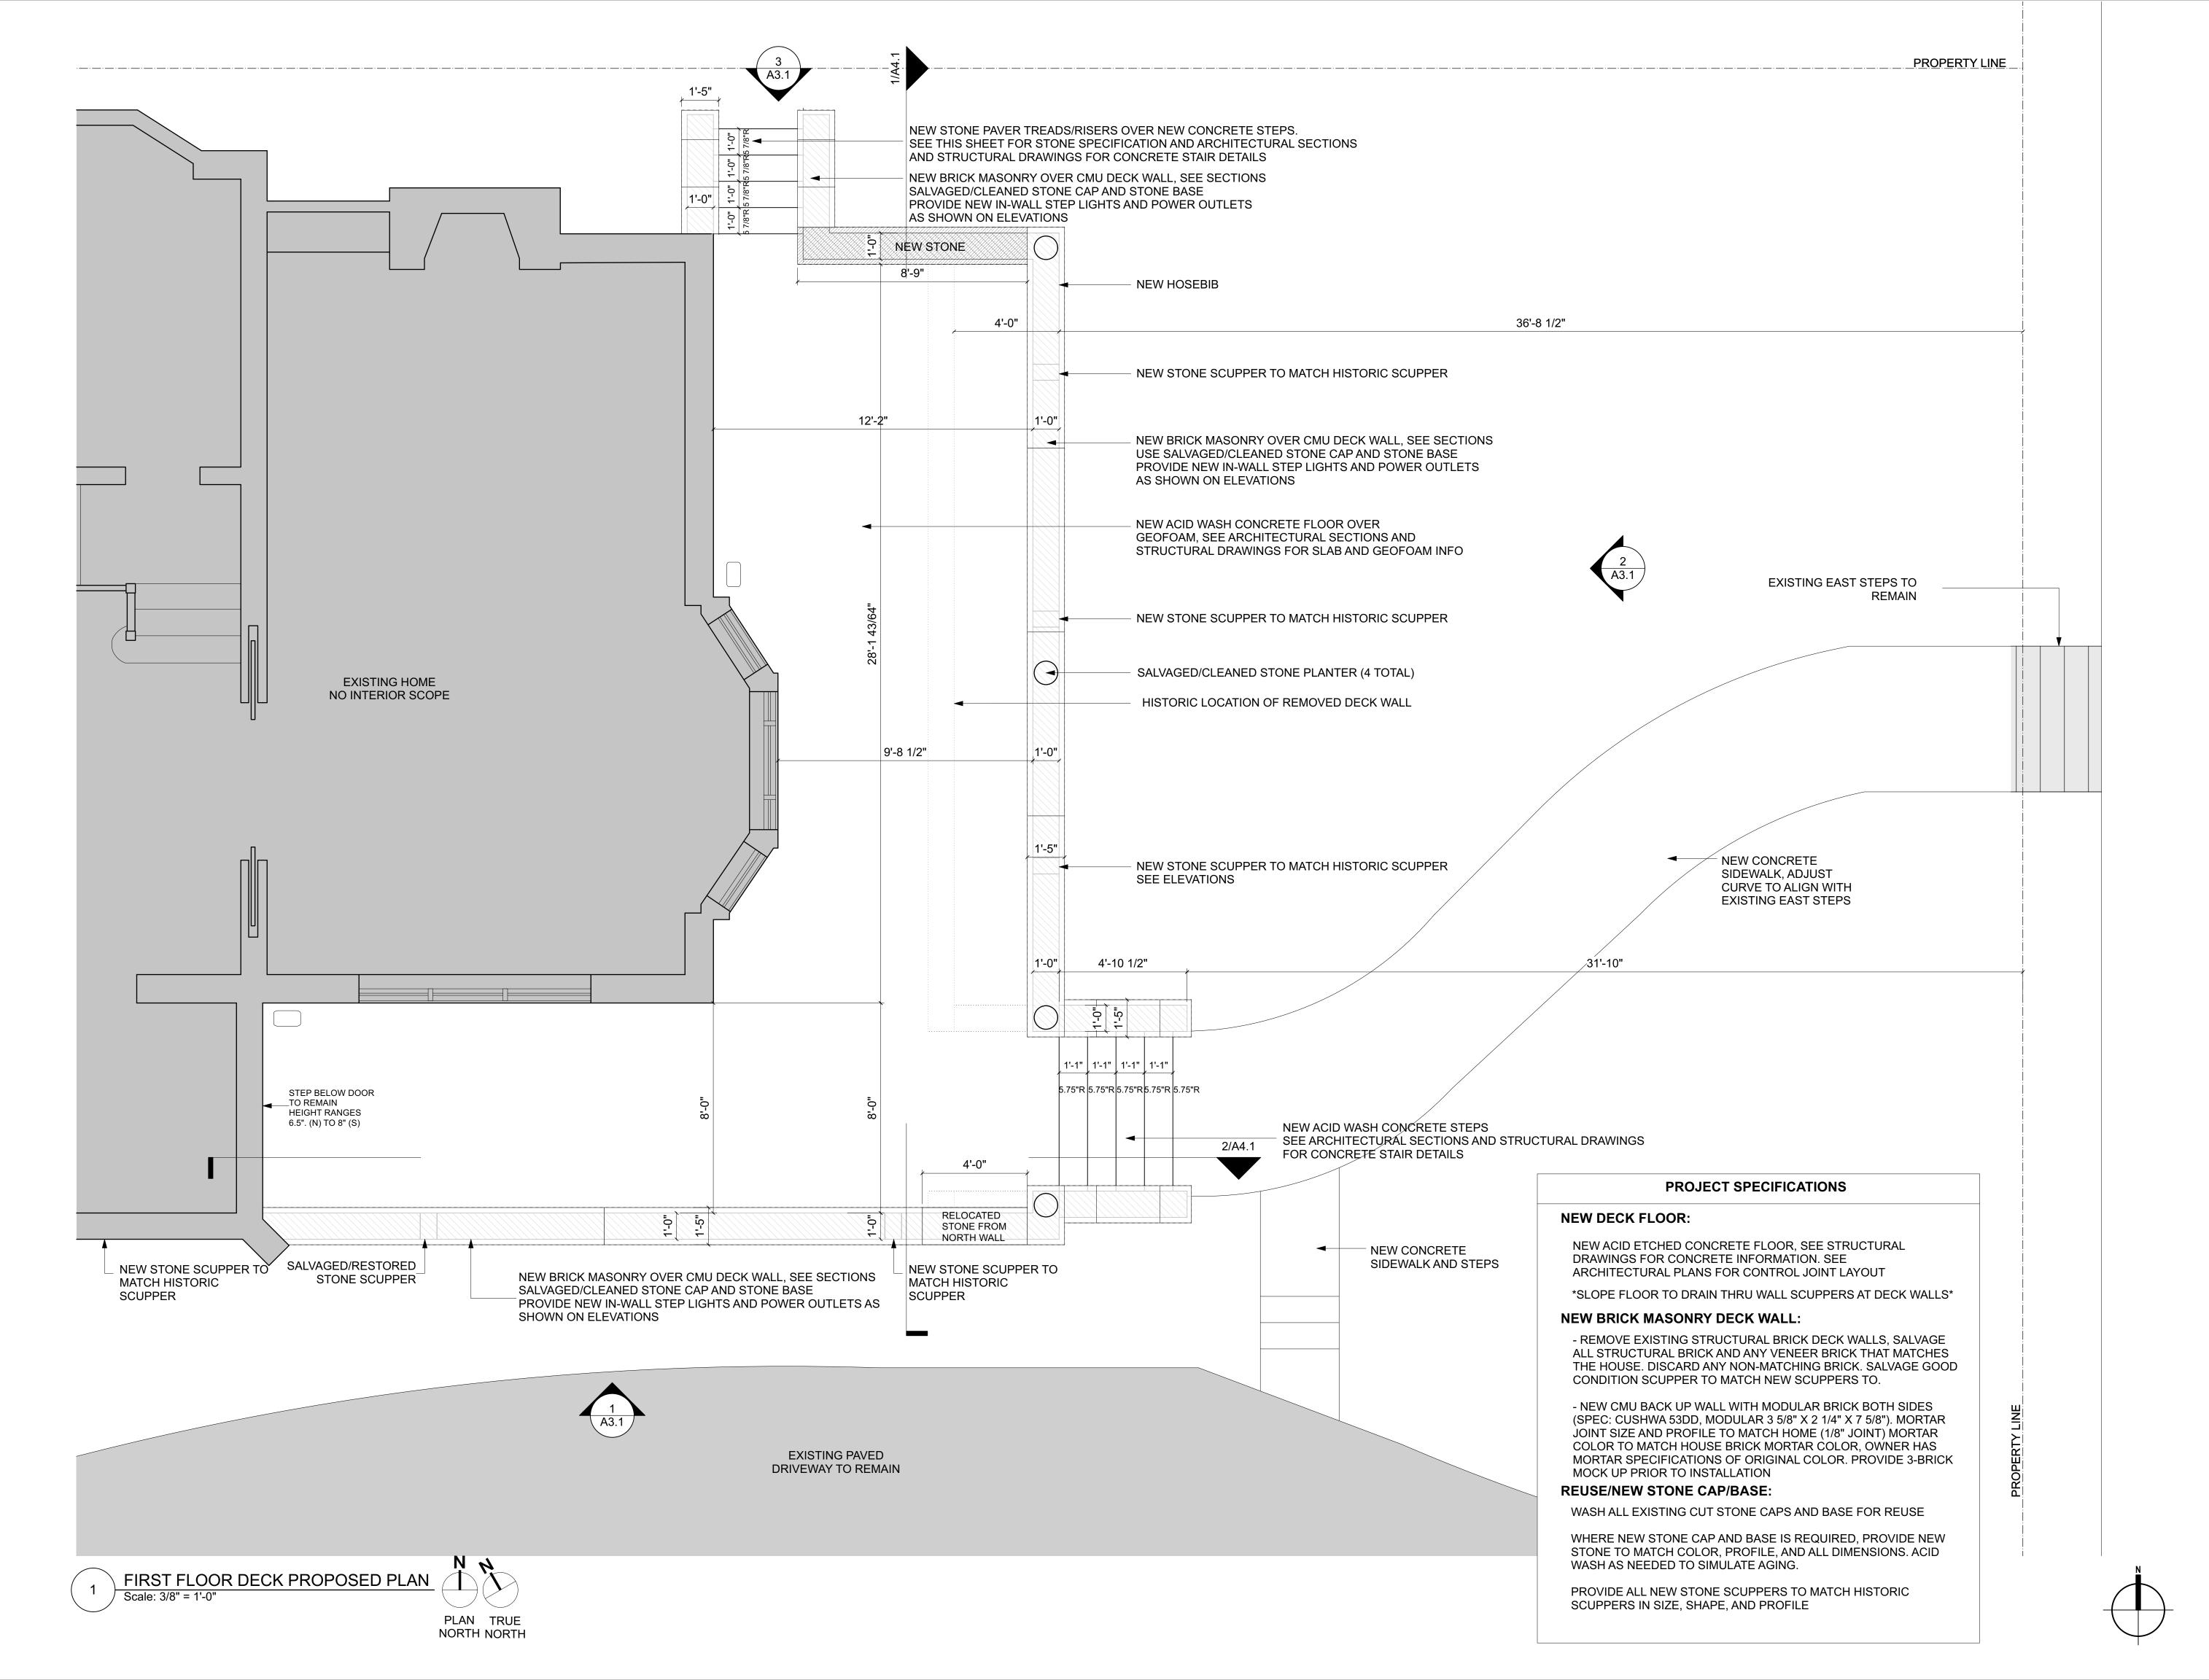
Demolition Elevations

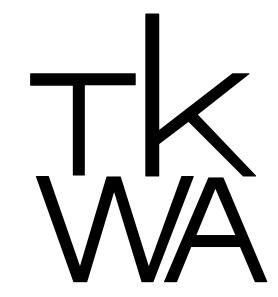
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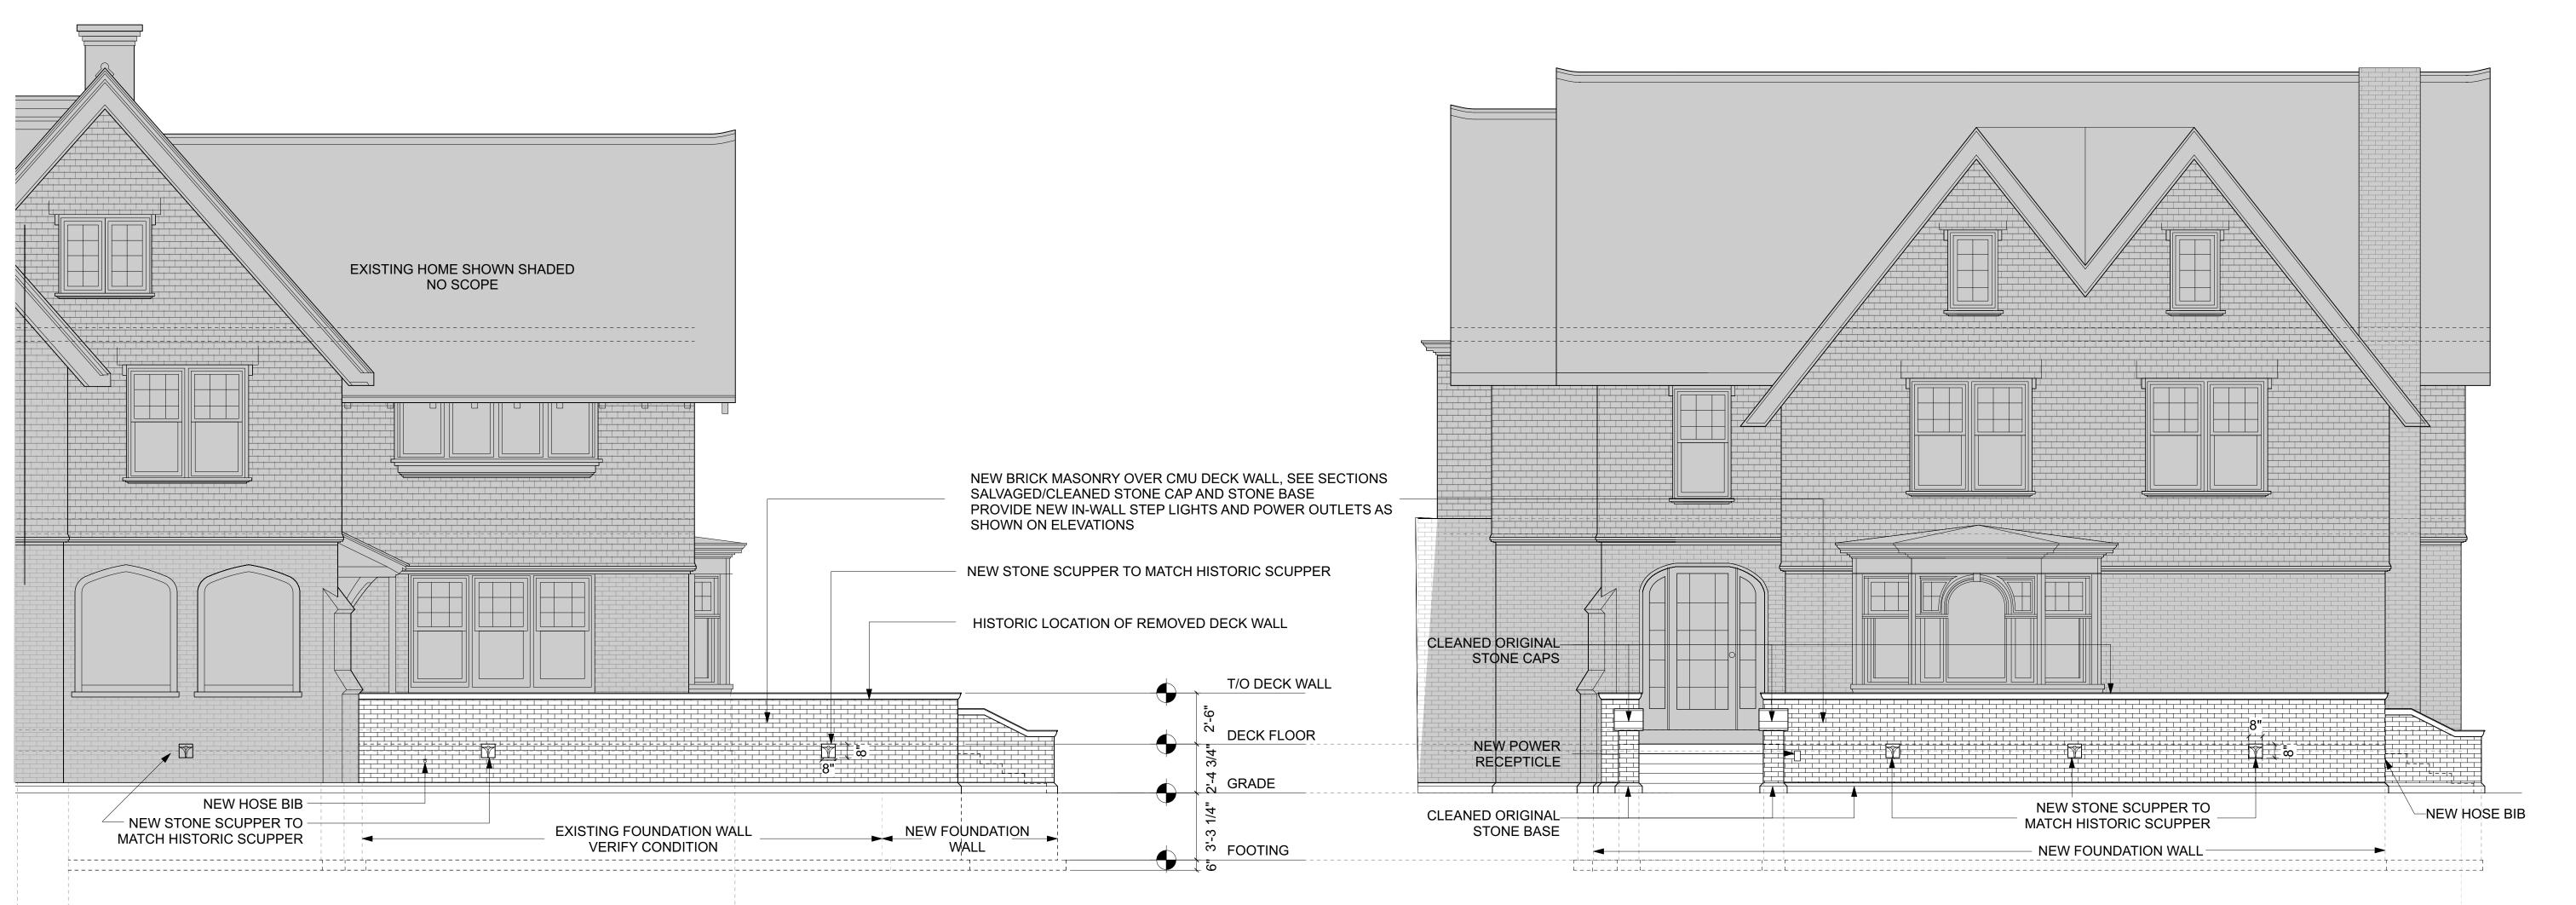
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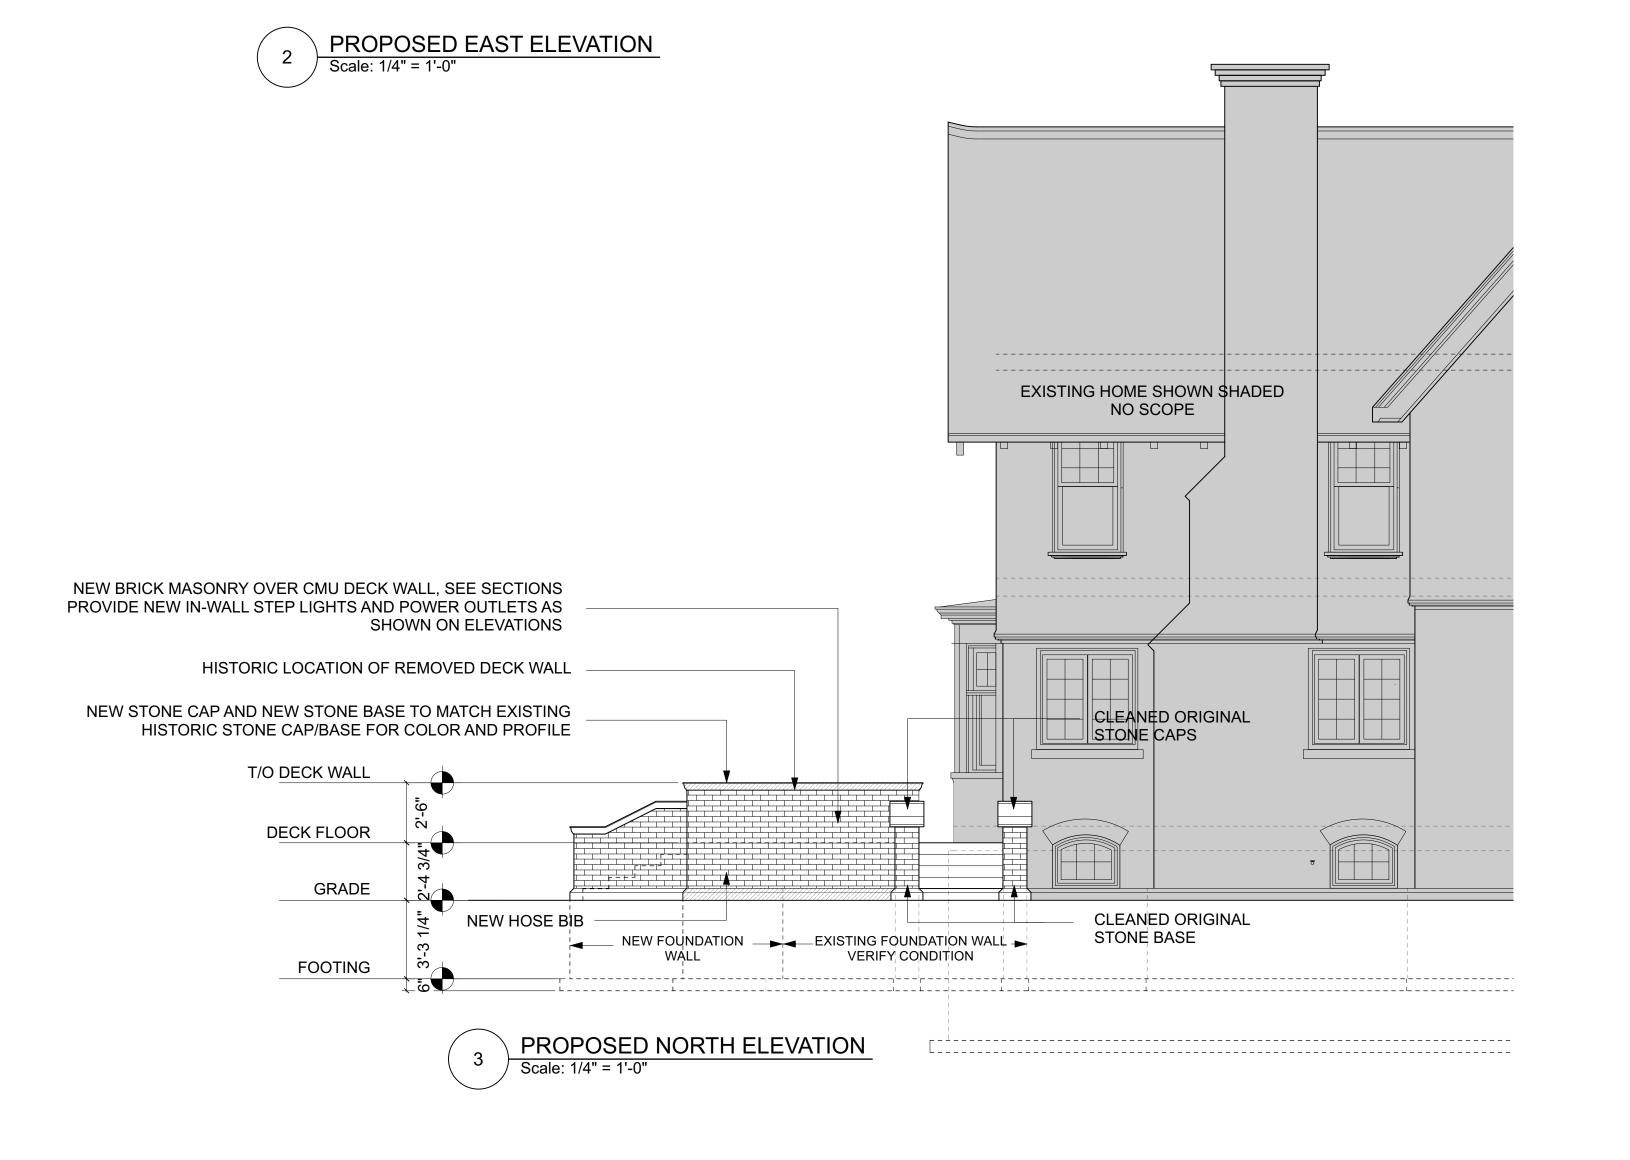
First Floor Proposed Deck Plan

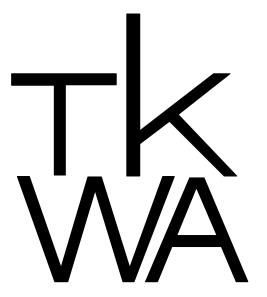
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1 PROPOSED SOUTH ELEVATION
Scale: 1/4" = 1'-0"





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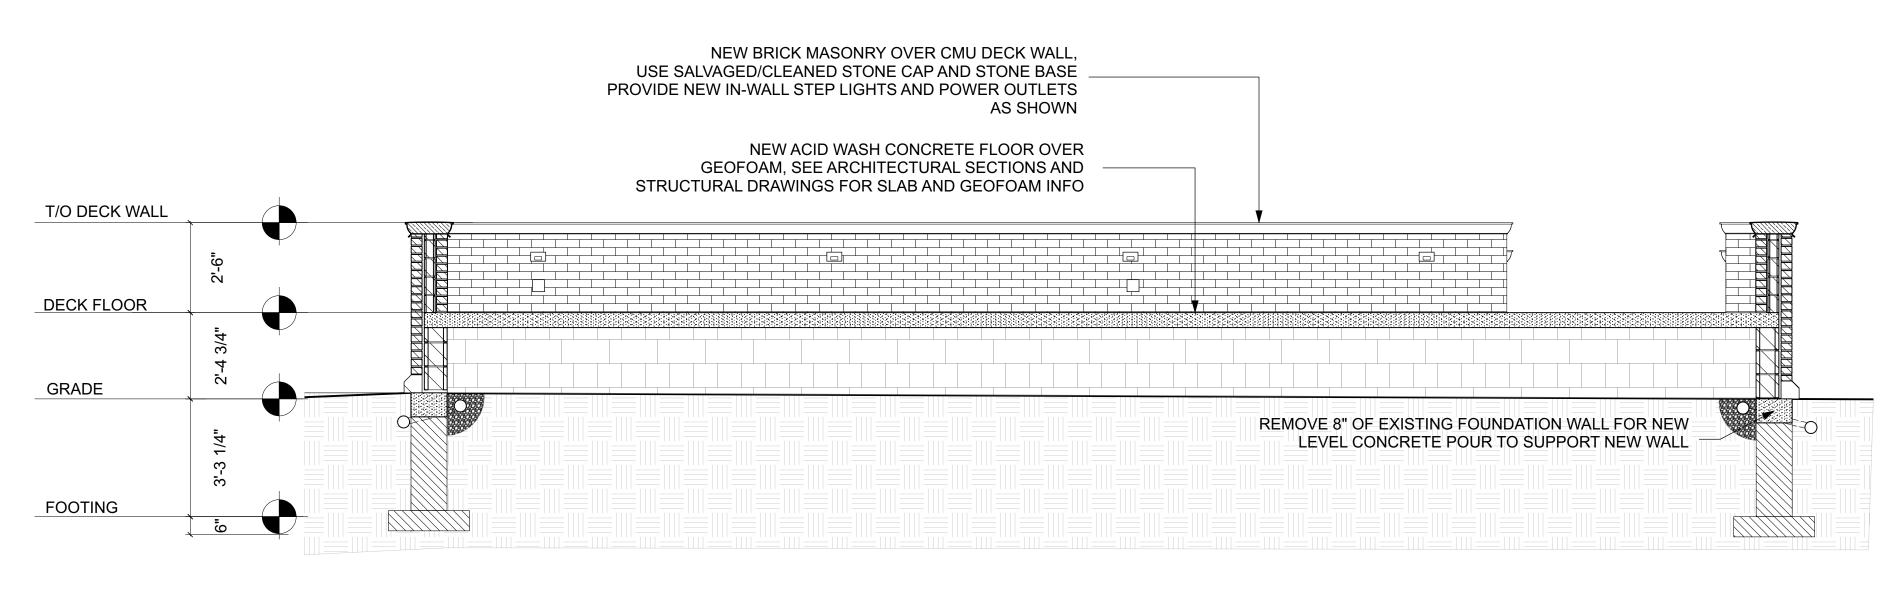
Proposed Elevations

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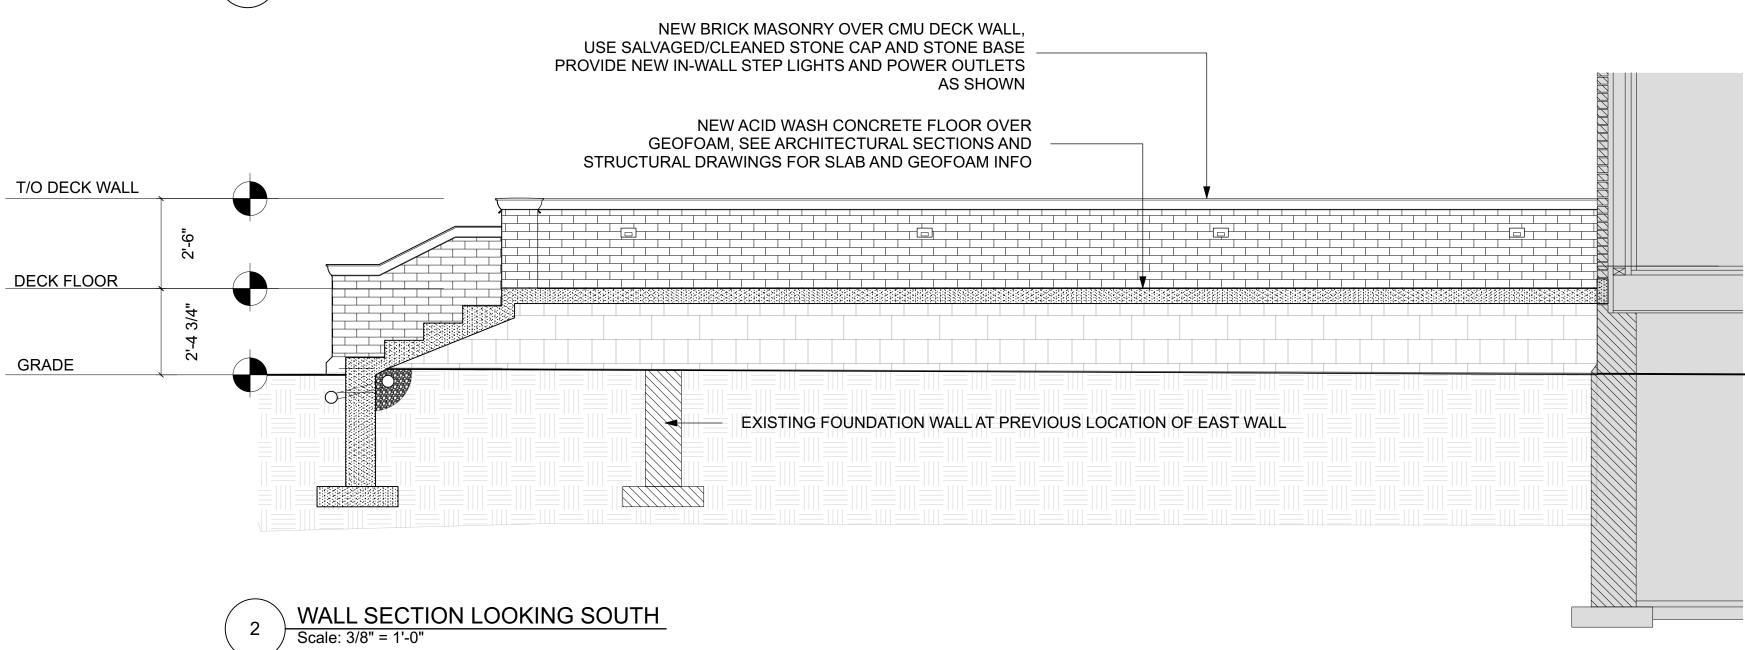
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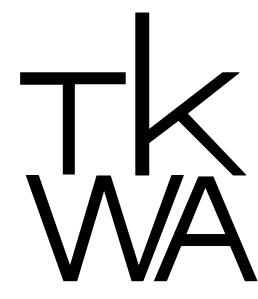
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DECK SECTIONS

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