


A REMODELING PROJECT FOR:

THE MIDWEST BUILDING

1736 N. 2ND STREET
MILWAUKEE, WI 53202

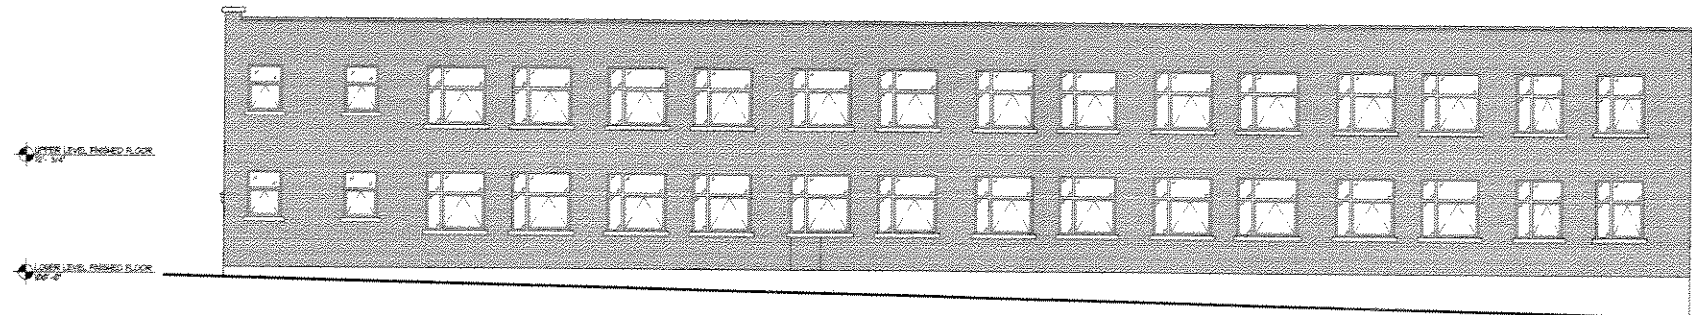

SOUTH ELEVATION
1/8" = 1'-0"

OWNER:

Olson Management Group
1371 N. Palmer St.
Milwaukee, WI 53212
Telephone: (414) 263-4011
Fax: (414) 263-4055

PROJECT LOCATION:

1736 N. 2nd Street
Milwaukee, WI 53202

ARCHITECT:

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Fax: (414) 283-9569
Email: emadisen@execpc.com

STRUCTURAL ENGINEER

Triad Engineering Inc.
329 E. Chicago St.
Milwaukee, WI 53202
Telephone: (414) 291-8840
Fax: (414) 291-8841
Email: www.triadengineering.com

CIVIL ENGINEER

Capital Survey & Engineering, LLC
1430 W. Bluemound Rd.
Suite 11
Wausatona, WI 53226
Telephone: (414) 302-4580
Fax: (414) 302-5905
Email: www.capitalsurvey.com

LIST OF DRAWINGS:

- T1 Title Sheet
- C1 Site Plan
- D1 Demolition Plan
- A1 Upper & Lower Level Floor Plans
- A2 Reflected Ceiling Plans
- A3 Exterior Elevations
- A4 Schedules & Details

CODE INFORMATION

ZONING DESIGNATION: IL3
CLASS OF CONSTRUCTION: OFFICE, TYPE III-B, EXTERIOR MASONRY UNPROTECTED
OCCUPANCY CLASSIFICATION: B, BUSINESS

PROJECT ADDRESS:
1736 N. 2ND ST. MILWAUKEE, WI

BUILDING AREAS:
GROSS AREA (MEASURED TO OUTSIDE OF BUILDING)
GROSS LOWER LEVEL AREA: 6,371 SQ. FT.
GROSS UPPER LEVEL AREA: 6,371 SQ. FT.
TOTAL GROSS AREA: 12,742 SQ. FT.

NET AREA (MEASURED TO INSIDE FACE OF OUTSIDE WALLS)
NET AREA, LOWER: 6,400
NET AREA, UPPER: 6,290
TOTAL NET AREA: 12,690 SQ. FT.

OFFICE AREAS:
OFFICE AREAS, LOWER: 4,815
OFFICE AREAS, UPPER: 5,738
TOTAL OFFICE AREAS: 10,553 SQ. FT.

PARKING REQUIREMENTS:
(GENERAL OFFICE): 1 SPACE FOR EACH 250 SQ. FT. OF THE FIRST 2,000 SQ. FT. OF GROSS FLOOR AREA; ONE FOR EACH 1,000 SQ. FT. OF GROSS FLOOR AREA IN EXCESS OF 2,000 SQ. FT. = 20 SPACES REQUIRED

PARKING PROVIDED:
11 SPACES EAST OF BUILDING, (AS SHOWN ON SITE PLAN); 10 ADDITIONAL SPACES LEASED FROM UNITED WAYS WEST PARKING LOT FOR A TOTAL OF 21 PARKING SPACES.

LIFE SAFETY:
STREETS OF FIRE FIGHTING ACCESS: 4 STREETS
FIRE PROTECTION: OFFICE AREA, NON-SPRINKLERED, SMOKE DETECTORS.

AREAS OF REFUGE: 1003.2.13.1
AS REQUIRED BY CODE, THREE AREAS OF REFUGE ARE PROVIDED IN COMPLIANCE WITH 1003.2.13.1 & 1003.2.13.2

BUILDING CAPACITY:
BUSINESS AREAS, 100 SQ. FT. GROSS PER PERSON (TABLE 1003.2.2.2)
BUSINESS AREA CAPACITY: 132 PERSONS


OCCUPANCY SEPARATION: (PER 1003.2)
BUSINESS/BUSINESS @ HOURS, (NON-SEPARATED USE)

REQUIRED EXIT WIDTH:
02 INCHES PER PERSON PER TABLE 1003.2.3
32 X 02 INCHES PER PERSON = 26.4'
EXIT WIDTH PROVIDED: 34'

MAX. DISTANCE TO EXIT (PER TABLE 1004.2.4)
B OCCUPANCY: 200 FEET FOR AN UNSPRINKLERED BUILDING

REQUIRED INTERIOR FINISH RATING:
VERT. EXITS & EXIT PASSAGES, CLASS B PER TABLE 803.4
ROOMS & ENCLOSED SPACES, CLASS C, PER TABLE 803.4

OFFICE AREAS:
REQUIRED SANITARY FIXTURES (PER TABLE 2902.1)
BUSINESS: WC: 1 PER 80 (BOTH MEN & WOMEN)
LAVS: 1 PER 80 (BOTH MEN & WOMEN)

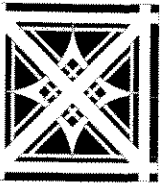

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A REMODELING PROJECT FOR:

THE MIDWEST BUILDING
1736 N. 2ND ST.
MILWAUKEE, WI

sheet title:

TITLE SHEET

revisions:

12/08/05 KMW

date:

07/01/05

drawn by:

KMW

file name:

line 1
line 2
project number:
2004044


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1/8" = 1'-0"

sheet number:

T1

APPROVAL DOCUMENTS

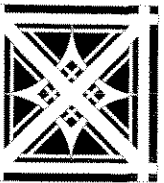

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project title:

A REMODELING PROJECT
FOR:

THE MIDWEST
BUILDING
1736 N. 2ND ST.
MILWAUKEE, WI

sheet title:

SITE PLAN
FOR
PARKING

revisions:

12/08/05 KMW

date:

07/01/05

drawn by:

KMW

file name:

line1

line 2

project number:

2004044


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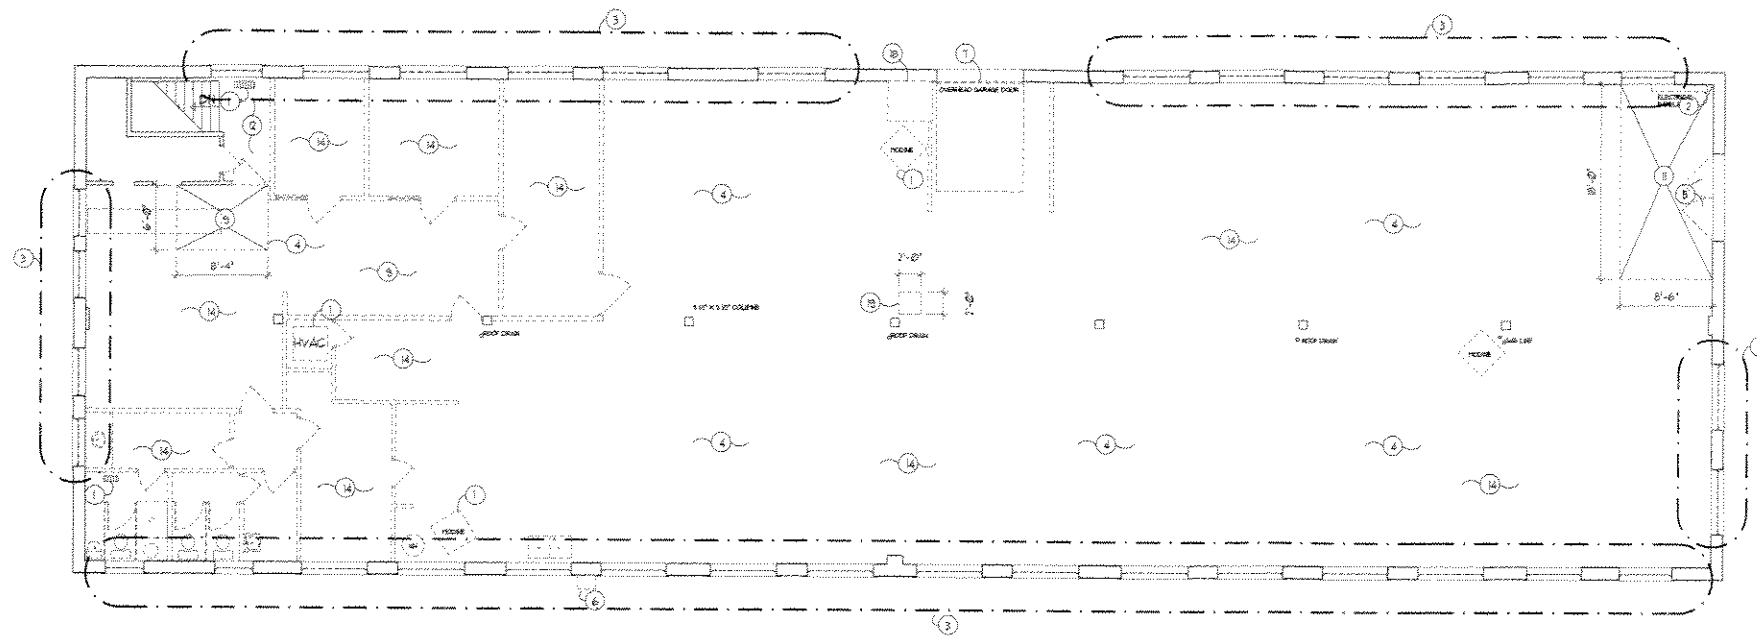
APPROVAL DOCUMENTS



SITE PLAN @ NEW PARKING LOT
1" = 10'-0"
NORTH


| LANDSCAPE NOTES | |
|--|--|
| 1. LANDSCAPE CONTRACTOR TO PROVIDE BLACK PLASTIC EDGERS AT ALL NEW LANDSCAPE AREAS EXCEPT AS NOTED. | 5. LANDSCAPE CONTRACTOR SHALL CONTACT DIGGERS NOTING PRIOR TO ANY DIGGING. |
| 2. LANDSCAPE CONTRACTOR TO PROVIDE A MINIMUM OF 3" BROADCAST BARK FILL TO MATCH EXISTING AT ALL NEW LANDSCAPE AREAS. | 6. ALL PLANT MATERIALS MUST BE GUARANTEED FOR A PERIOD OF ONE YEAR AFTER INSTALLATION. |
| 3. LANDSCAPE CONTRACTOR TO PROVIDE BLACK BEED BARRIER AT ALL NEW LANDSCAPE AREAS. | 7. LANDSCAPE CONTRACTOR SHALL FURNISH AND INSTALL ALL PLANT MATERIAL IN ACCORDANCE WITH THE GUIDELINES OF THE WISCONSIN DEPARTMENT OF NATURAL RESOURCES URBAN FORESTRY DIVISION. |
| 4. LANDSCAPE CONTRACTOR SHALL FURNISH AND INSTALL ALL PLANT MATERIAL IN ACCORDANCE WITH THE GUIDELINES OF THE CITY OF MILWAUKEE DESIGN CODE: 20-485-1.1-C. | |

NORTH 2ND STREET (80')

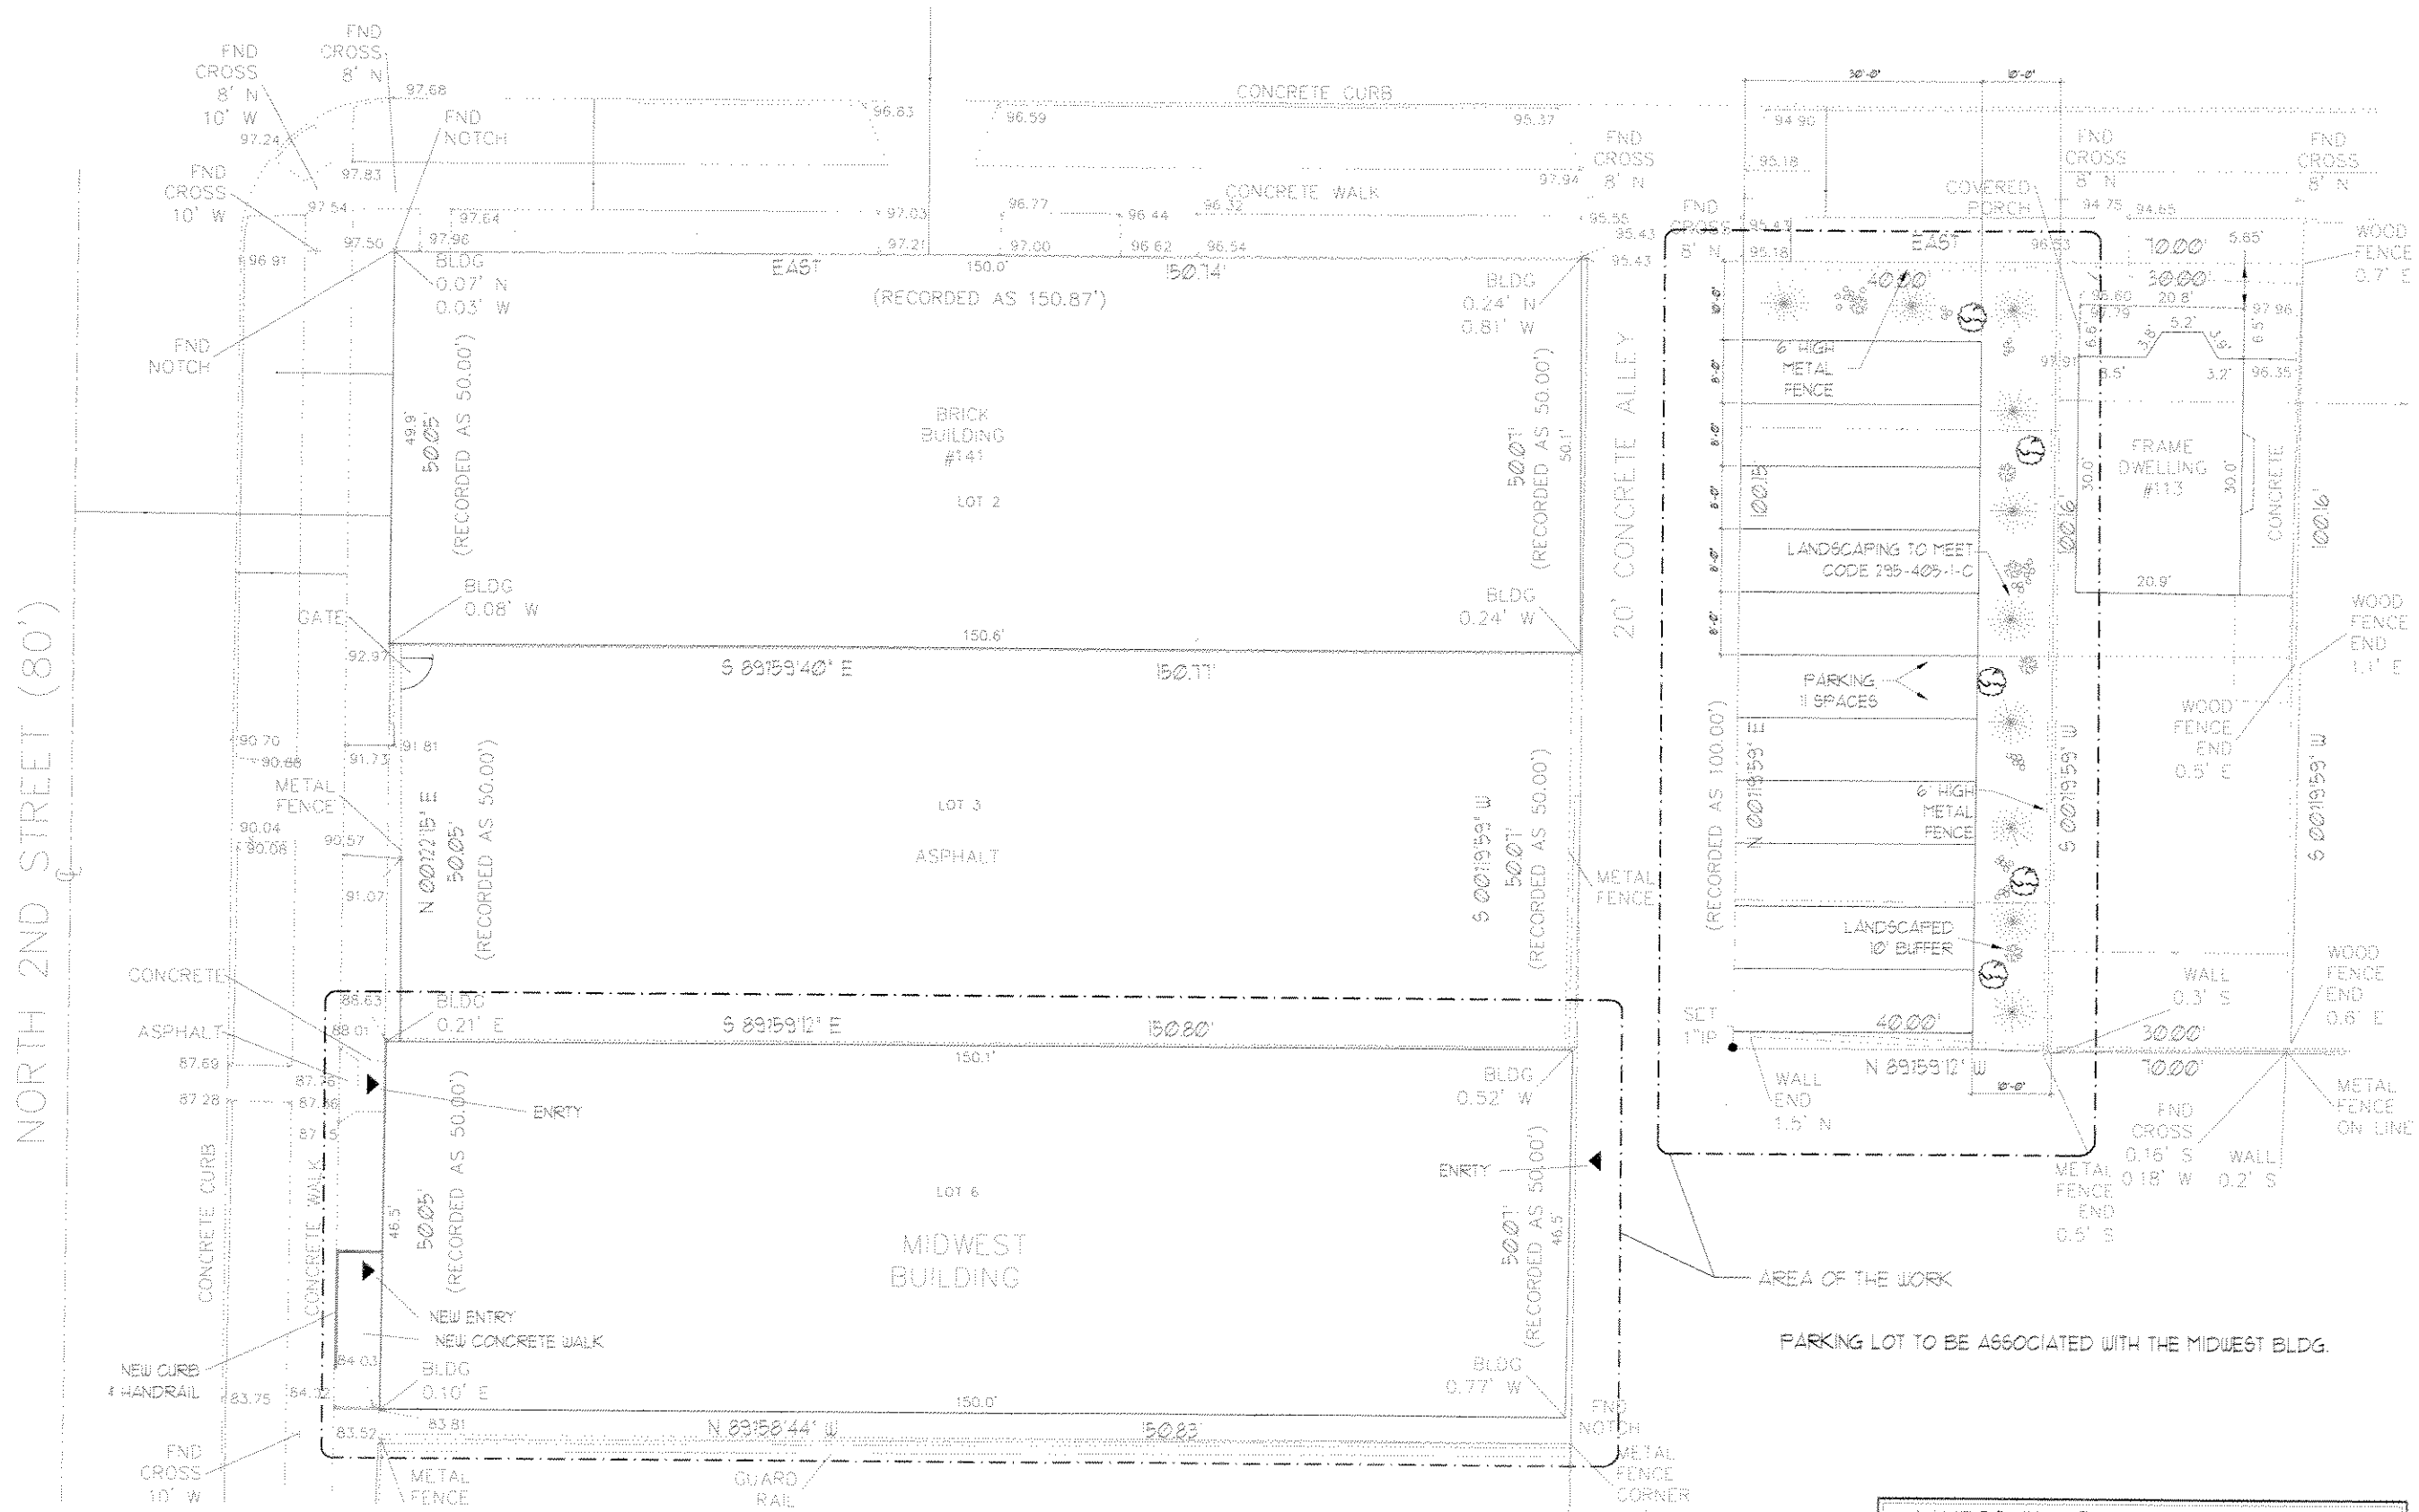

UPPER LEVEL DEMOLITION PLAN

1/8" = 1'-0"

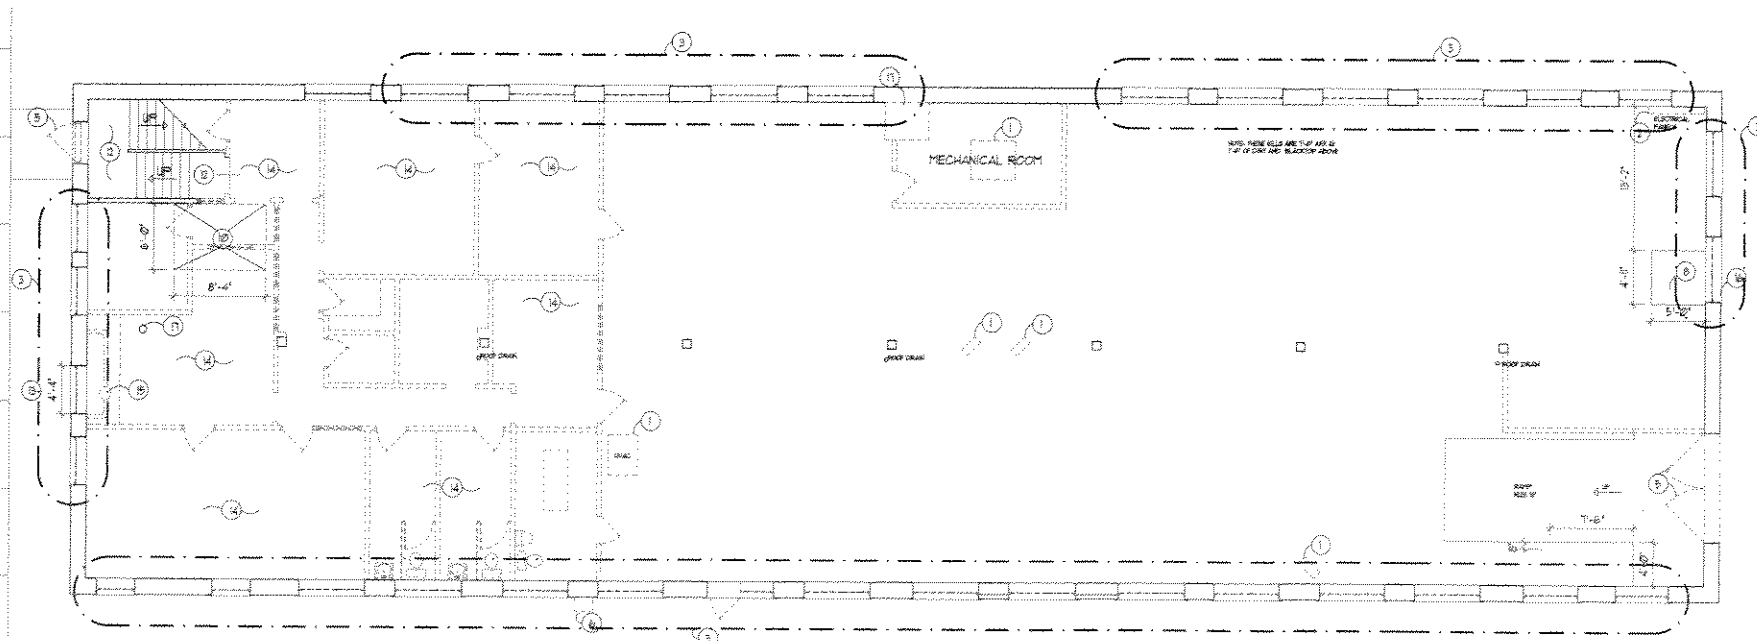

LOWER LEVEL DEMOLITION PLAN

1/8" = 1'-0"



DEMOLITION GENERAL NOTES


1. THESE DRAWINGS WERE PREPARED UTILIZING VISUAL AND FIELD MEASURED VERIFICATION. ARCHITECT ASSUMES NO RESPONSIBILITY FOR THE ACCURACY OF DETAILS OR DESCRIPTION OF EXISTING CONDITIONS.
2. GENERAL CONTRACTOR TO VERIFY ALL EXISTING CONDITIONS AND REPORT ANY DISCREPANCIES TO THE ARCHITECT PRIOR TO BEGINNING DEMOLITION WORK.
3. HVAC CONTRACTOR IS RESPONSIBLE FOR THE REMOVAL, CAPPING AND CODE COMPLIANCE OF ALL HVAC EQUIPMENT AND RELATED SYSTEMS REMOVED DURING DEMOLITION.
4. ELECTRICAL CONTRACTOR IS RESPONSIBLE FOR THE REMOVAL, CAPPING AND CODE COMPLIANCE OF ALL ELECTRICAL FIXTURES AND RELATED WIRING REMOVED DURING DEMOLITION.
5. TELECOMMUNICATIONS CONTRACTOR IS RESPONSIBLE FOR THE REMOVAL, CAPPING AND CODE COMPLIANCE OF ALL TELECOMMUNICATIONS FIXTURES AND RELATED WIRING REMOVED DURING DEMOLITION.
6. THE OWNER HAS THE RIGHT OF FIRST REFUSAL ON ALL ITEMS REMOVED DURING DEMOLITION.
7. PRIOR TO EXCAVATING 4 REMOVING FLOOR 4 ROOF FOR ELEVATOR PIT, VERIFY ELEVATOR MODEL AND SIZE 4 DEPTH OF PIT REQD.
8. GC TO REMOVE ROOF AND ANY ROOF DECKING AS NEEDED FOR REPLACEMENT.

DEMO NOTES - THIS SHEET

1. EXISTING HVAC EQUIPT. TO BE REMOVED COMPLETE.
2. EXISTING ELECTRICAL EQUIPT. TO BE REMOVED.
3. REMOVE EXISTING WINDOWS.
4. REMOVE EXISTING T 4 G FLOORING.
5. EXISTING DOOR TO BE REMOVED.
6. EXISTING DUCT TO BE REMOVED.
7. EXISTING OVERHEAD DOOR TO BE REMOVED.
8. EXISTING CONCRETE TO BE REMOVED, AS REQD. FOR NEW STAIRS 4 LANDING.
9. AREA OF FLOOR 4 ROOF TO BE REMOVED FOR ELEVATOR INSTALLATION.
10. REMOVE EXISTING CONC. SLAB AS REQD. FOR ELEV. PIT INSTALLATION.
11. REMOVE SECTION OF EXISTING FLOOR AS REQD FOR STAIR INSTALLATION.
12. REMOVE SECTION OF EXISTING FLOORING THIS AREA.
13. REMOVE SECTION OF WALL AS REQD. FOR DOOR 4 SIDELIGHT INSTALLATION. SEE EXT. ELEVATIONS.
14. REMOVE EXISTING FINISHED CEILING TILES AS REQUIRED TO EXPOSE STRUCTURE.
15. EXISTING WATER MAIN TO BE RELOCATED.
16. REMOVE SECTION OF WALL AS REQD. FOR DOOR INSTALLATION. SEE EXT. ELEVATIONS.
17. CAP EXISTING CLEANOUT.
18. REMOVE EXISTING CHIMNEY.
19. REMOVE FLOOR FOR DUCT CHASE.

LEGEND

- EXISTING DOOR TO REMAIN
- EXISTING DOOR TO BE REMOVED
- EXISTING WALL TO REMAIN
- EXISTING WALL/FIXTURE TO BE REMOVED, EXCEPT AS NOTED.
- DEMO NOTE

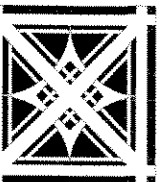

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MILWAUKEE, WI

sheet title:

DEMOLITION
FLOOR
PLANS

revisions:
12/08/05 KMW

date:
07/01/05
drawn by:
KMW

file name:
line 1
line 2
project number:
2004.044


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sheet number:
D1

APPROVAL DOCUMENTS


ROOF NOTES

1. REMOVE & REPLACE ANY DAMAGED T & G ROOF DECKING
2. ROOF CONSTRUCTION SHALL BE 45 MIL EDPM ROOF MEMBRANE OVER TAPERED INSUL OVER 4 MIL VAPOR BARRIER ATTACHED TO ROOF DECK
3. TAPERED INSULATION SHALL BE PITCHED TO ROOF DRAINS AT 1/8" = 1'-0"
4. EVALUATE ROOF DRAINS REPLACE AS NEEDED.

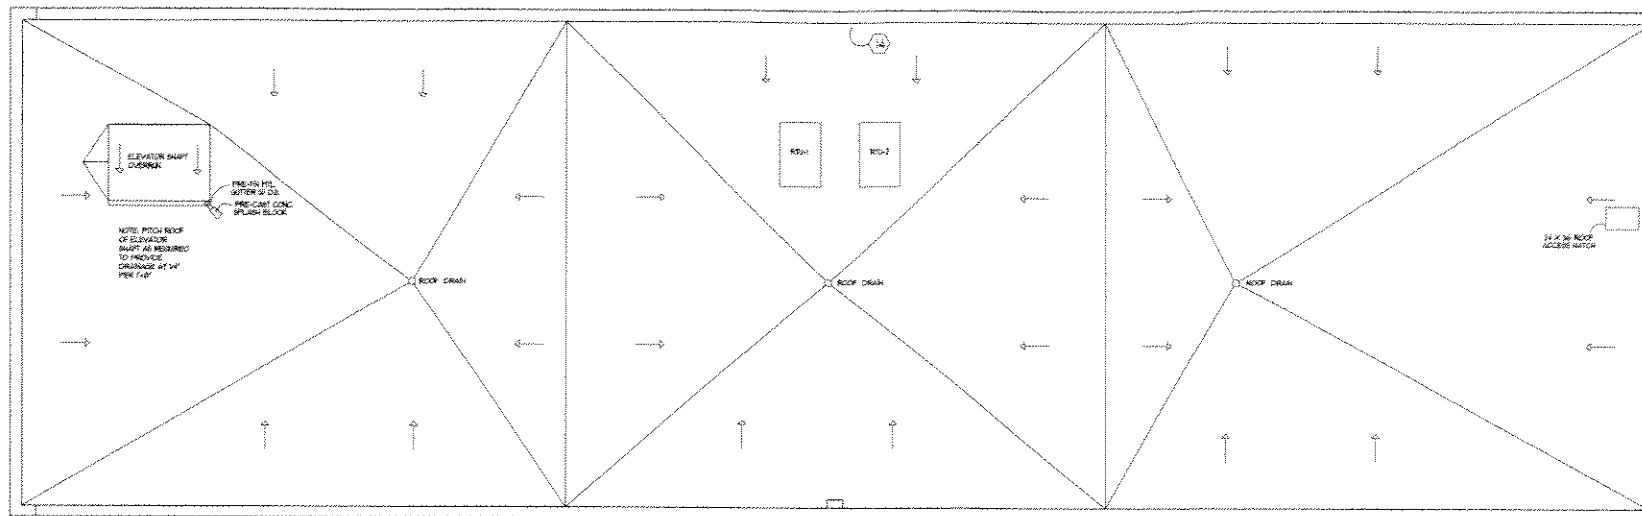


ROOF PLAN

1/8" = 1'-0"

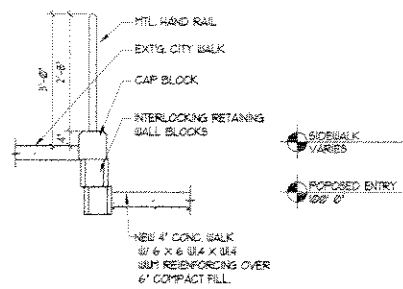


SECTION @ ENTRY

1/2" = 1'-0"

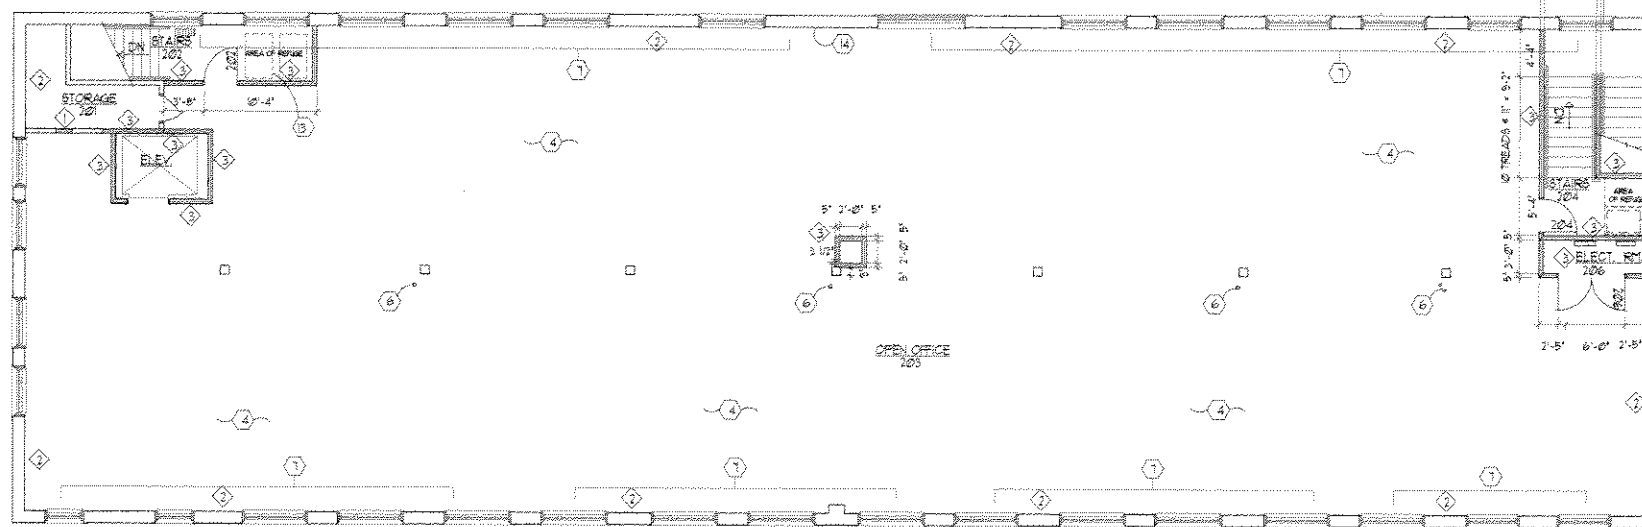

UPPER LEVEL FLOOR PLAN

1/8" = 1'-0"

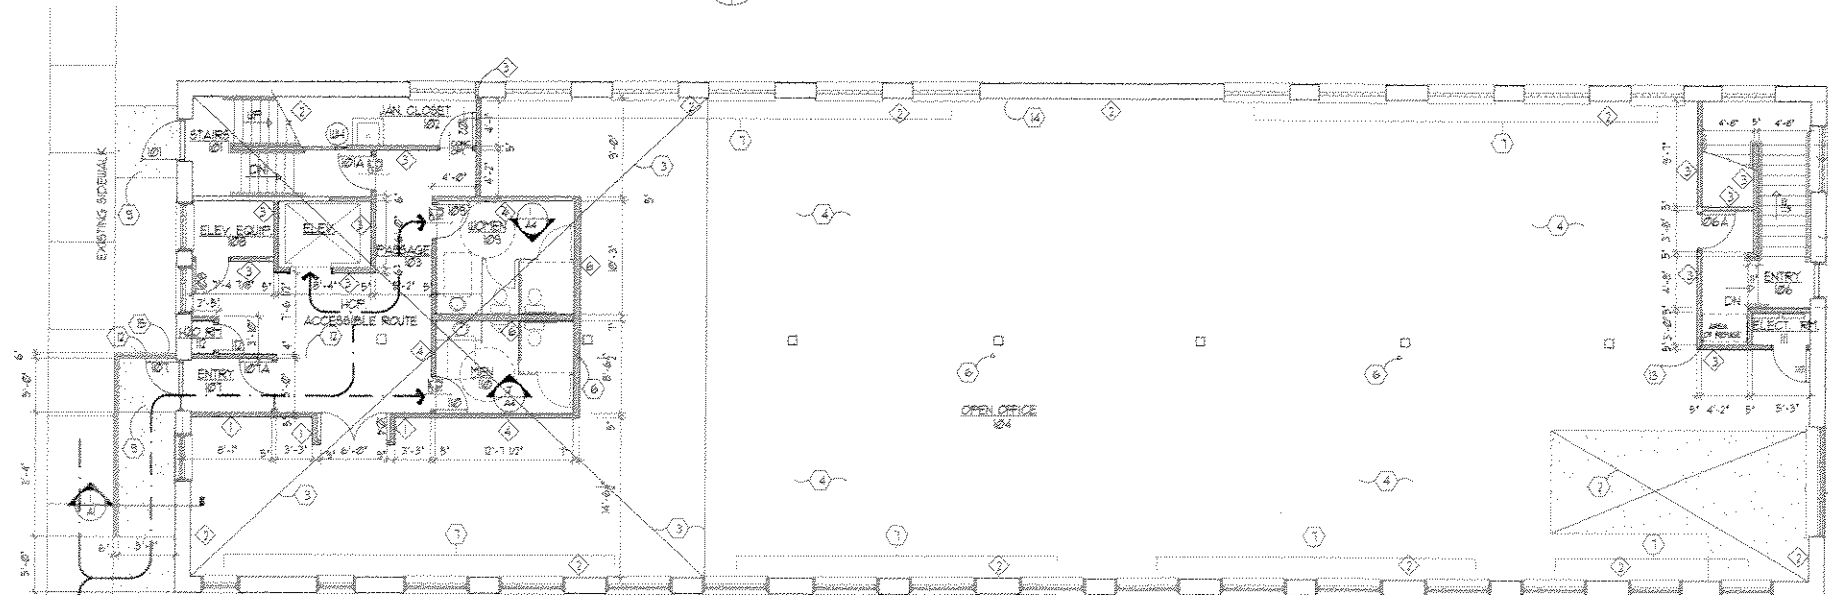

LOWER LEVEL FLOOR PLAN

1/8" = 1'-0"



GENERAL NOTES

1. CONTRACTOR TO VERIFY ALL EXISTING CONDITIONS AND REPORT ANY DISCREPANCIES TO THE ARCHITECT PRIOR TO CONSTRUCTION.
2. NOTIFY OWNER AT LEAST 24 HOURS PRIOR TO ANY PLANNED UTILITY OUTAGES.
3. HVAC CONTRACTOR IS RESPONSIBLE FOR THE DESIGN, INSTALLATION, AND CODE COMPLIANCE OF ALL HVAC EQUIPMENT AND RELATED SYSTEMS.
4. PLUMBING CONTRACTOR IS RESPONSIBLE FOR THE DESIGN, INSTALLATION, AND CODE COMPLIANCE OF ALL PLUMBING EQUIPMENT AND RELATED SYSTEMS.
5. ELECTRICAL CONTRACTOR IS RESPONSIBLE FOR THE DESIGN, INSTALLATION, AND CODE COMPLIANCE OF ALL ELECTRICAL FIXTURES AND RELATED WIRING, AND THE FURNISHING & INSTALLATION OF NEW FACE PLATES ENTIRE PROJECT AREA.
6. THE ELEVATOR SHAFT SIZE IS BASED UPON A SCHINDLER 2800M ELEVATOR. VERIFY SIZE & SUPPORT REQTS. PRIOR TO CONSTRUCTION.
7. NOTE: GC TO VERIFY EXISTING FLOOR LEVELS, TOP FLOOR AS REQUIRED TO PROVIDE LEVEL SURFACE THROUGHOUT.
8. GC TO COORDINATE ELECTRICAL DESIGN WITH TENANTS' OFFICE LAYOUT.

KEYED NOTES - THIS SHEET

1. SEE ELEVATIONS FOR BRICK CHIMNEY AREA
2. INFILL EXISTING CONC. RAFTER: 4" CONCRETE SLAB W/ 1/4" X 1/4" 6X6BAY REIN. OVER 6" COMPACTED GRAVEL FILL.
3. NO CONCRETE TOPPING THIS AREA. PATCH EXISTING SLAB AS REQD. (WHERE NEW PLUMBING IS INSTALLED)
4. TOP EXISTING FLOOR WITH 1-1/2" CONCRETE. WHERE TOPPING MEETS EXISTING FLOOR ON LOWER LEVEL, MATCH HEIGHTS, BASE BID. REGULAR CONCRETE, ALTERNATE BID. COLORED ADDITIVE CONCRETE.
5. FURNISH & INSTALL 4" CONC. SLAB W/ 6X6 @ 18 X 18 W/ 4 BAR REIN. OVER EXISTING SLAB. PITCH AWAY FROM BLDG @ 1/4" FT.
6. EXISTING ROOF DRAIN - PREP, PRIME, & PAINT.
7. FURNISH & INSTALL M-LAM SILLS & APRONS AT NEW WINDOWS, TYP.
8. GC TO SET TOP RIBBER OF NEW STAIR AGAINST S. FACE OF EXISTING WOOD BEAM.
9. FURNISH & INSTALL 4" CONC. SLAB W/ 6X6 @ 18 X 18 W/ 4 BAR REIN. OVER 6" COMPACTED FILL. PITCH AWAY FROM BLDG @ 1/4" FT.
10. 24" X 36" ROOF HATCH W/ ROLL DOWN LADDER.
11. EXISTING ROOF DRAIN INSULATE AS REQD. & BURY IN WALL.
12. MTL HANDRAIL, PRIME & PAINT.
13. GC TO COORDINATE INSTALLATION OF COMMUNICATION SYSTEMS AS NEEDED FOR AREAS OF RESCUE ASSISTANCE.
14. PATCH BRICK AS REQUIRED WHERE CHIMNEY WAS REMOVED.
15. 6" CONC. CURB CHAMFER EDGES 1". TOP OF CURB TO BE SET AT 6" ABOVE EXISTING SIDEWALK.

WALL TYPES


- 1. 5/8" GUS EACH SIDE OF 2X4 WOOD STUDS W/ 3-1/2" FIBERGLASS SOUND INSULATION. EXTEND PARTITION TO STRUCTURE.
- 2. EXTERIOR WALL: SAND BLAST & TUCK WITH MOTAR TO MATCH EXISTING.
- 3. 5/8" GUS EACH SIDE OF 2X4 WOOD STUDS AT 16" O.C. WITH 3-1/2" FIBERGLASS BATT INSULATION. EXTEND PARTITION TO STRUCTURE. ONE HOUR FIRE RATED PARTITION PER UL 1333.
- 4. 5/8" MOISTURE RESISTANT GUS ON TOILET ROOM SIDE & 5/8" GUS ON OPPOSITE SIDE OF 2 X 4 WOOD STUDS AT 16" O.C. W/ 3-1/2" FIBERGLASS BATT SOUND INSULATION. EXTEND PARTITION TO STRUCTURE.
- 5. 5/8" TYPE 'X' MOISTURE RESISTANT GUS ON TOILET ROOM SIDE & 5/8" TYPE 'X' GUS ON OPPOSITE SIDE OF 2 X 4 WOOD STUDS AT 16" O.C. W/ 3-1/2" FIBERGLASS BATT SOUND INSULATION. EXTEND PARTITION TO STRUCTURE. 1 HOUR FIRE RATED PARTITION PER UL 1329.
- 6. 5/8" MOISTURE RESISTANT GUS EACH SIDE OF 2 X 6 WOOD STUDS AT 16" O.C. W/ 3-1/2" FIBERGLASS BATT SOUND INSULATION. EXTEND PARTITION TO STRUCTURE.

LEGEND

- NEW WOOD STUD WALL
- EXISTING WALL TO REMAIN
- EXISTING DOOR TO REMAIN
- NEW DOOR
- WALL TYPE
- KEYED NOTE

ELEVATOR OPERATION

ELEVATOR SHALL BE KEYED TO PREVENT ACCESS TO 2ND FLOOR DURING NON-BUSINESS HOURS.

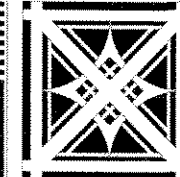

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sheet title:

UPPER & LOWER LEVEL FLOOR PLANS

revisions:

12/08/05 KMW

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07/01/05

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KMW

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line 2

project number:

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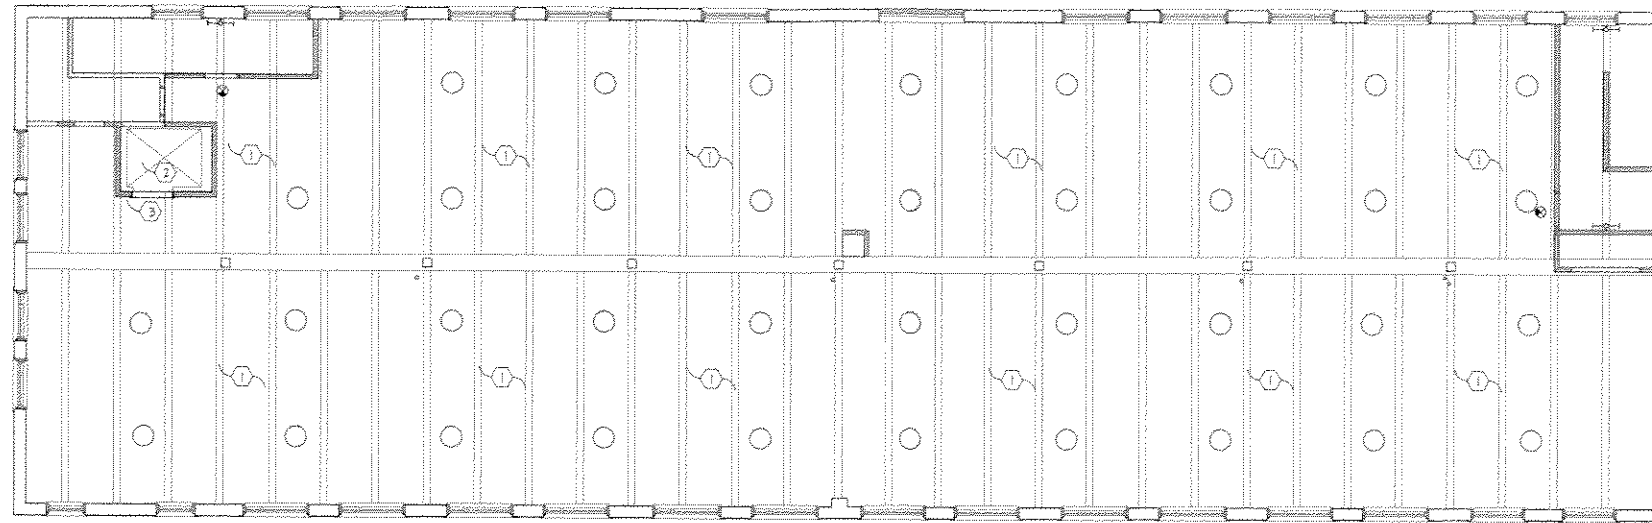
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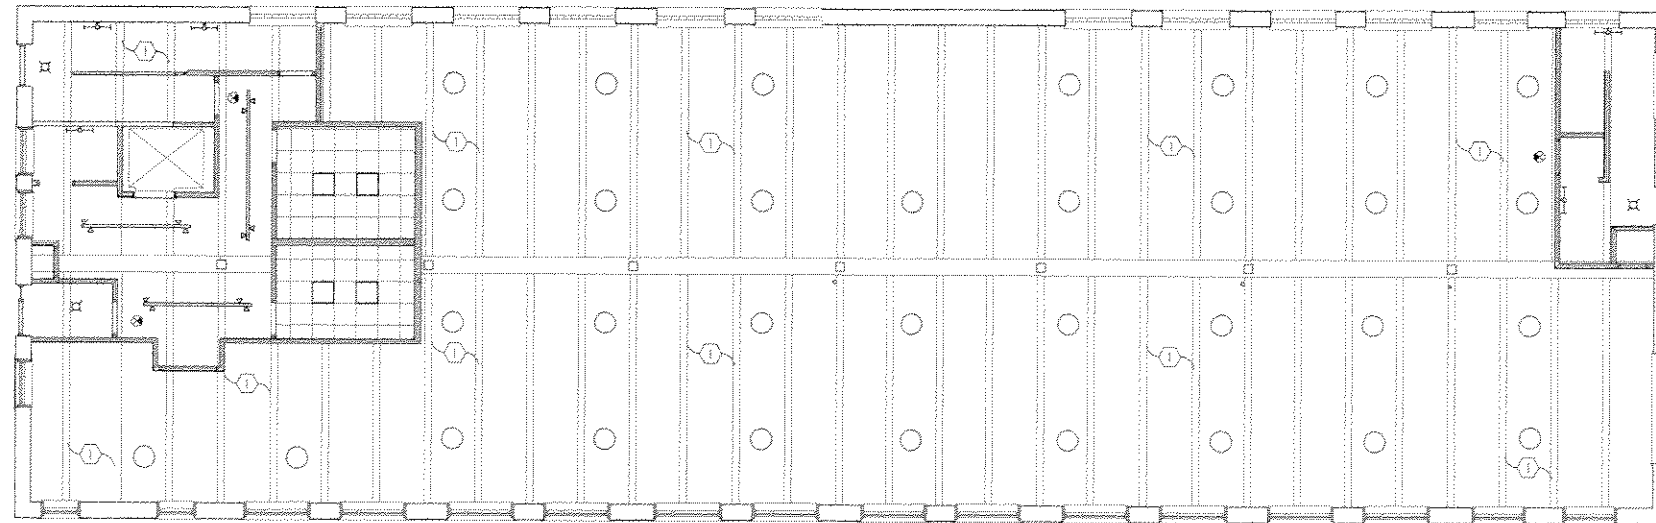
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A1

APPROVAL DOCUMENTS



UPPER LEVEL REFLECTED CEILING PLAN
1/8" = 1'-0"




LOWER LEVEL REFLECTED CEILING PLAN
1/8" = 1'-0"



| LEGEND | |
|--------|-------------------------------------|
| | PENDENT MTD. INDIRECT FLOOR FIXTURE |
| | EXIT SIGN |
| | PENDENT MTD. TRACK LIGHTS |
| | CLG. MOUNTED FIXTURE |
| | 2 X 2 FLOOR FIXTURE |
| | 2 X 4 WALL MOUNTED FLOOR FIXTURE |

| KEYED NOTES | |
|-------------|---|
| ① | GC TO FILL HOLES SAND BLAST EXISTING WOOD COLUMNS, BEAMS & FLOOR STRUCTURE. |
| ② | CAP ELEVATOR SHAFT W/ ROOF TYPE UL-515, 5/8" PLYWOOD OVER 1/2" PLYWOOD ATTACHED TO 2 X 10 @ 16" O.C. W/ 1 X 3 BRIDGING. BOTTOM FACE 1/2" GIBS OVER 4 MIL VAPOR BARRIER ATTACHED TO BOTTOM SIDE OF JOISTS. FILL CAVITIES W/ R-24 FIBERGLASS BATT INSULATION. |
| ③ | MANTAIN 0'-0" CLEARANCE FROM UPPER FLOOR TO UNDERSIDE OF ELEVATOR SHAFT. |

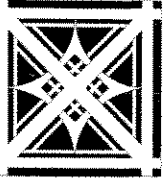

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THE MIDWEST BUILDING
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sheet title:
REFLECTED CEILING PLANS

revisions:
12/08/05 KMW


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07/01/05
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KMW

file name:
line 1
line 2
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2004.044

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1/8" = 1'-0"

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A2

APPROVAL DOCUMENTS

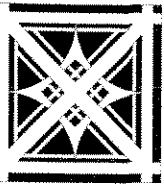

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MILWAUKEE, WI

sheet title:

SCHEDULES
AND
DETAILS

revisions:

12/08/05 KMW

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A4



APPROVAL DOCUMENTS

| ROOM # | ROOM NAME | BASE | FLOOR | WALLS | | | | | CEILING | | REMARKS | |
|--------|-------------------|----------|-------|-------|---|---|---|---|---------|--------|-----------|-------|
| | | | | ALL | N | S | E | U | MATL | HEIGHT | | |
| 101 | STAIRS | 6" WOOD | CONC. | P1 | | | | | | | STRUCT. | |
| 102 | JAN. CLST. | 4" VINYL | CONC. | P1 | | | | | | | STRUCT. | |
| 103 | PASSAGE | 6" WOOD | CONC. | P1 | | | | | | | STRUCT. | |
| 104 | OPEN OFFICE | 6" WOOD | CONC. | P1 | | | | | | | STRUCT. | |
| 105 | NOT USED | | | | | | | | | | | |
| 106 | ENTRY | 6" WOOD | CONC. | P1 | | | | | | | STRUCT. | |
| 107 | VESTIBULE | 6" WOOD | CONC. | P1 | | | | | | | STRUCT. | |
| 108 | ELEV. EQUIPMENT | 4" VINYL | CONC. | P1 | | | | | | | STRUCT. | |
| 109 | WOMEN | 6" TILE | TILE | P2 | | | | | | | SUB. ACC. | 8'-0" |
| 110 | MEN | 6" TILE | TILE | P2 | | | | | | | SUB. ACC. | 8'-0" |
| 111 | ELECTRICAL ROOM | 4" VINYL | CONC. | | | | | | | | STRUCT. | |
| 112 | WATER METER CLST. | 4" VINYL | CONC. | | | | | | | | STRUCT. | |
| 201 | STORAGE | 4" VINYL | CONC. | P1 | | | | | | | STRUCT. | |
| 202 | STAIR | 6" WOOD | CONC. | P1 | | | | | | | STRUCT. | |
| 203 | OPEN OFFICE | 6" WOOD | CONC. | P1 | | | | | | | STRUCT. | |
| 204 | STAIR | 6" WOOD | CONC. | P1 | | | | | | | STRUCT. | |
| 205 | NOT USED | | | | | | | | | | | |
| 206 | ELECTRICAL ROOM | 4" VINYL | CONC. | | | | | | | | STRUCT. | |


P1: PRIMER LATEX FINISH COAT EGG SHELL TEXTURE. COLOR BY OWNER.
P2: PRIMER LATEX FINISH COAT SEMI-GLOSS TEXTURE. COLOR BY OWNER.
R1: CEILING PANELS TO BE 1/2" VINYL FACED GIB.

| DOOR NO. | ROOM NAME | SIZE | DOOR | | FRAME | | | | | | REMARKS | | | |
|----------|-------------------|---------------|------|-------|-------|------|---------------|-------|-----------|------|---------|-------|--|--|
| | | | TYPE | MATL. | HEAD | JAMB | SILL | GLAZ. | GLAZ. NO. | JAMB | | MATL. | | |
| 101 | STAIRS | 3'-0" x 7'-0" | 1 | 1 | PTL. | | | | | | | | | |
| 102A | STAIRS | 3'-0" x 7'-0" | 1 | 2 | WOOD | -- | 45 MIN. WOOD | 3/4" | 3/4" | | | | | |
| 103 | JAN. CLST. | 3'-0" x 7'-0" | 1 | 3 | WOOD | -- | 45 MIN. WOOD | 3/4" | 3/4" | | | | | |
| 104 | OPEN OFFICE | 3'-0" x 7'-0" | 2 | 3 | WOOD | -- | WOOD | 3/4" | 3/4" | | | | | |
| 105 | NOT USED | | | | | | | | | | | | | |
| 106 | ENTRY | 3'-0" x 7'-0" | 1 | 1 | PTL. | -- | 45 MIN. WOOD | 3/4" | 3/4" | | | | | |
| 106A | ENTRY | 3'-0" x 7'-0" | 1 | 1 | PTL. | -- | 45 MIN. WOOD | 3/4" | 3/4" | | | | | |
| 107 | VESTIBULE | 3'-0" x 7'-0" | 1 | 1 | PTL. | -- | 45 MIN. WOOD | 3/4" | 3/4" | | | | | |
| 107A | VESTIBULE | 3'-0" x 7'-0" | 1 | 1 | PTL. | -- | 45 MIN. ALUM. | 3/4" | 3/4" | | | | | |
| 108 | ELEV. EQPT. RM. | 3'-0" x 7'-0" | 1 | 1 | WOOD | -- | 45 MIN. WOOD | 3/4" | 3/4" | | | | | |
| 109 | WOMEN | 3'-0" x 7'-0" | 1 | 3 | WOOD | -- | WOOD | 3/4" | 3/4" | | | | | |
| 110 | MEN | 3'-0" x 7'-0" | 1 | 3 | WOOD | -- | WOOD | 3/4" | 3/4" | | | | | |
| 111 | ELECTRICAL ROOM | 3'-0" x 7'-0" | 1 | 3 | WOOD | -- | WOOD | 3/4" | 3/4" | | | | | |
| 112 | WATER METER CLST. | 3'-0" x 7'-0" | 1 | 1 | WOOD | -- | WOOD | 3/4" | 3/4" | | | | | |
| 202 | STAIRS | 3'-0" x 7'-0" | 1 | 2 | WOOD | -- | 45 MIN. WOOD | 3/4" | 3/4" | | | | | |
| 204 | STAIRS | 3'-0" x 7'-0" | 1 | 3 | WOOD | -- | 45 MIN. WOOD | 3/4" | 3/4" | | | | | |
| 205 | NOT USED | | | | | | | | | | | | | |
| 206 | ELECTRICAL ROOM | 3'-0" x 7'-0" | 2 | 3 | WOOD | -- | WOOD | 3/4" | 3/4" | | | | | |


R1: UNDERCUT DOOR P.
R2: DOOR FRAME WITH ATTACHED 3'-0" SIDE LIGHT.
NOTE: ALL HARDWARE TO BE ADA COMPLIANT.

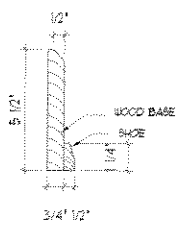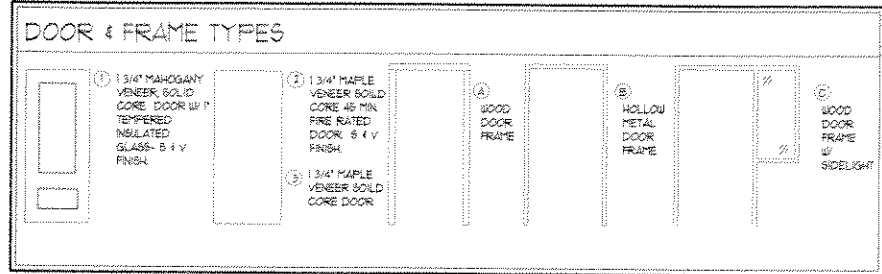


5 WOOD BASE
3/4" x 1'-0"

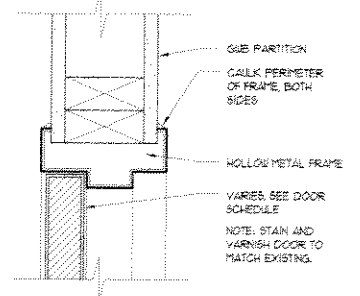


4 HEAD AT HOLLOW METAL DOOR
1/4" x 1'-0"

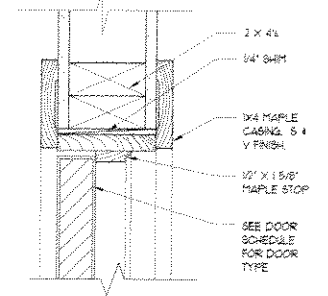

3 HEAD AT WOOD FRAME DOOR
1/4" x 1'-0"

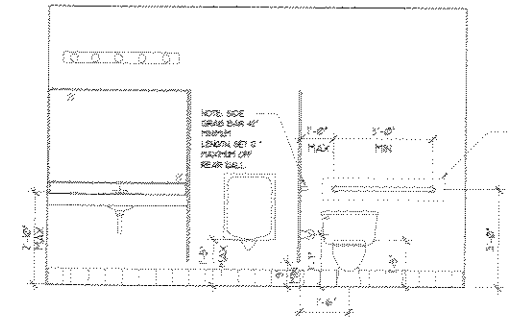

2 ELEVATION AT MEN'S 110
3/8" = 1'-0"

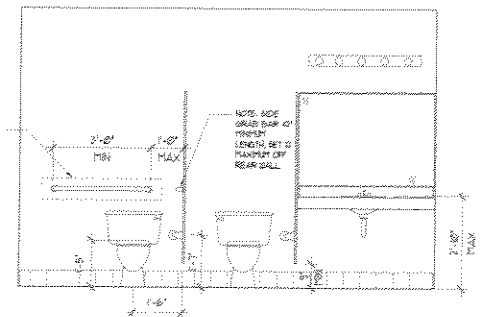

1 ELEVATION AT WOMEN'S 109
3/8" = 1'-0"