

## CERTIFICATE OF APPROPRIATENESS APPLICATION FORM

Incomplete applications will not be processed for Commission review.

Please print legibly.

1139 East Knapp Street							
NAME AND ADDRESS OF C	WNER:						
Name(s): Lynde and Harry Brad	ey Foundation						
Address: 1241 North Franklin P	lace						
City: Milwaukee	State: WI	ZIP 53202					
Email:							
Telephone number (area code	e & number) Daytime:	Evening:					
APPLICANT, AGENT OR CO	NTRACTOR: (if different from ow	vner)					
Name(s): Steve Wellenstein, Al	A Uihlein/Wilson Architects						
Address: 322 E. Michigan Street	Suite 400	2					
City: Milwaukee	State: WI	ZIP Code: 53202					
Email; stevew@ulhlein-wilson.co		S.					
Telephone number (area code	e & number) Daytime: (414) 271-8						
ATTAOLIMENTO							
ATTACHMENTS							
	PROJECTS:						
A. REQUIRED FOR ALL		Photographs of affected areas & all sides of the building (annotated photos recommended					
	ed areas & all sides of the building	(annotated photos recommende					
C Photographs of affect	ed areas & all sides of the building on Drawings (1 full size and 2 redu	•					
Photographs of affects Sketches and Elevation	_	•					
C Photographs of affects C Sketches and Elevation Material and Design S	on Drawings (1 full size and 2 redu	uced to 11" x 17" or 8 1/2" x 11")					
Sketches and Elevation  Material and Design S  NEW CONSTRUCTION	on Drawings (1 full size and 2 redu specifications (see next page)	uced to 11" x 17" or 8 1/2" x 11")					
C Photographs of affects C Sketches and Elevation Material and Design S B. NEW CONSTRUCTION C Floor Plans (1 full size	on Drawings (1 full size and 2 reduspecifications (see next page)  N/DEMOLITION ALSO REQUIRE	eced to 11" x 17" or 8 ½" x 11")					

**PLEASE NOTE:** 

YOUR APPLICATION CANNOT BE PROCESSED UNLESS BOTH PAGES OF THIS FORM ARE PROPERLY COMPLETED.

## 5. DESCRIPTION OF PROJECT:

<u>Describe all existing features</u> that will be affected by proposed work. Please specify the condition of materials, design, and dimensions of each feature (additional pages may be attached)

Existing features affected by proposed work, per elevation:

EAST At the second-floor level of the bnck veneer, a mid-span settling of the structural framing is venfied. The wood sills of the two attic-level dormers are visibly affected. Photos 1, 1a.

NORTH The garden-level entrance will be removed so as to return to the historic window configuration. At the entrance porch the full-glass window will be returned to historic condition. All infill materials at the garden level windows will be removed. Photo 2.

The clapboard and aluminum-framed glazed windows forming the enclosed porch at the first and second-levels will be removed. The site's existing brick retaining wall with its decorative iron-gate will be retained. Photo 3.

WEST The three-floor tower, recessed from the street line, will be reworked into the new addition. The single dormer will be removed and rebuilt into the north facade of the addition. All existing brick will be retained for re-use. Photos 4, 4a, 5 and 5a.

SOUTH The historic Bloodgood Residence shares a party wall with its sister-residence, the Hawley

Photo No.	1 through 7	Drawing No.	na
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B. <u>Describe all proposed work</u>, materials, design, dimensions and construction technique to be employed (additional pages may be attached)

The project involves the exterior restoration of the 4-story building (footprint of approx. 1,900 sq. ft.) and an interior/exterior renovation to include an addition of approx.115 sq. ft. per floor, at all levels. This West-end addition allows an IBC-compliant exit stair and elevator designed to serve all levels. EAST The second-story's structural framework will be replaced, restoring the brick veneer facade to its historic appearance at time of construction (late 1890's). All original brick will be removed, cleaned and re-used.

NORTH The existing garden-level door opening returns to the historic condition of an arched masonry opening for a wood framed, glazed window with mullions. The porch entry door will be refinished and the adjacent window replaced with a window corresponding to the historic condition. The insertion of a glazed curtain wall (65 sq. ft.) extending from the first-floor line to the roof line, transitions the existing facade to the west-end addition. The addition's unglazed brick veneer facade corresponds to the historic brick veneer in color, size and course banding. The renovation provides a semi-enclosed porch and an accessible entry to the enclosed stair and elevator. This porch is composed of eliptical brick

	Photo No. na		Drawing No.	AA001; AA100; A	
6.	SIGNATURE OF APP	LICANT:	2		
	Signature				
	Steve Wellenstein		Octo	ober 20, 2011	
	Print or type name	Date			

This form and all supporting documentation **MUST** arrive by 12:00 noon on the deadline date established to be considered at the next Historic Preservation Commission Meeting. Any information not provided to staff in advance of the meeting will not be considered by the Commission during their deliberation. Please call if you have any questions and staff will assist you.

Hand Deliver or Mail Form to: Historic Preservation Commission City Clerk's Office 200 E. Wells St. Room B-4 Milwaukee, WI

PHONE: (414) 286-5722 FAX: (414) 286-3004 www.milwaukee.gov/hpc

## Existing features affected by proposed work, per elevation:

EAST At the second-floor level of the brick veneer, a mid-span settling of the structural framing is verified. The wood sills of the two attic-level dormers are visibly affected. *Photos 1, 1a.* 

NORTH The garden-level entrance will be removed so as to return to the historic window configuration. At the entrance porch the full-glass window will be returned to historic condition. All infill materials at the garden level windows will be removed. *Photo 2.* The clapboard and aluminum-framed glazed windows forming the enclosed porch at the first and second-levels will be removed. The site's existing brick retaining wall with its decorative iron-gate will be retained. *Photo 3.* 

WEST The three-floor tower, recessed from the street line, will be reworked into the new addition. The single dormer will be removed and rebuilt into the north facade of the addition. All existing brick will be retained for re-use. *Photos 4, 4a, 5 and 5a.* 

SOUTH The historic Bloodgood Residence shares a party wall with its sister-residence, the Hawley House of comparative square footage.

OVERALL The existing wood, double-hung muntin-glazed windows at the garden and first floor levels will be removed and replaced to match historic profiles. Likewise, second and attic-level windows will be removed and replaced. *Photos 6, 6a.* The aluminum combination storm and screens will be removed throughout. The existing roof drainage system of metal gutters and downspouts will be replaced to correspond to historic conditions. *Photo 7.* 

ROOF The existing dimensional shingle system will be replaced to correspond to historic conditions.

## Proposed work:

UWA PN: 11-118

The project involves the exterior restoration of the 4-story building (footprint of approx. 1,900 sq. ft.) and an interior/exterior renovation to include an addition of approx.115 sq. ft. per floor (all levels). This West-end addition allows an IBC-compliant exit stair and elevator designed to serve all levels.

EAST The second-story's structural framework will be replaced, restoring the brick veneer facade to its historic appearance at time of construction (late 1890's). All original brick will be removed, cleaned and re-used.

NORTH The existing garden-level door opening returns to the historic condition of an arched masonry opening for a wood framed, glazed window with mullions. The porch entry door will be refinished and the adjacent window replaced with a window corresponding to the historic condition. The insertion of a glazed curtain wall (65 sq. ft.) extending from the first-floor line to the roof line, transitions the existing facade to the west-end addition. The addition's unglazed brick veneer facade corresponds to the historic brick veneer in color, size and course banding. The renovation provides a semi-enclosed porch and an accessible entry to the enclosed stair and elevator. This porch is composed of eliptical brick arches bearing on brick pilasters to a stone masonry half-wall. The porch half-wall is in direct relation to the first-floor line of the adjacent, original facade. The north facade renovation includes architectural

terra cotta elements and a round window. New cut-stone lintels and stone masonry will match historic conditions.

Windows throughout the building will be of wood frame and sash with profiles and proportions to match historic conditions. Glazing will be with insulated glass. New stone headers and sills will correspond to historic profiles.

WEST The glazed curtain wall is composed of three glazed areas with two areas of 54 sq. ft. and one section of 165 sq. ft. (See Elevations A200)

The roof will be entirely replaced, restoring the building's original splendor of a textural clay tile roof.

All decorative crowning elements (crockets, ridge elements) at the roof line and at the dormers will be restored, replacing all degraded elements. All sheet metal at gutters, downspouts, collectors, valleys, copings, ridge caps and flashings will match existing profiles and stampings. Exposed metal roofing accessories will be zinc-covered copper with paint finish to be determined upon further investigation.


Roof drainage will be restored with specifically restored valleys, ridge caps, eaves, collectors, downspouts with hangers.

OVERALL The veneer brick will be tuckpointed where appropriate.

SITE The Work scope includes the rebuiding of the existing brick retaining wall, with its decorative iron gate. An entry ramp is provided completing the new accessible entrance.

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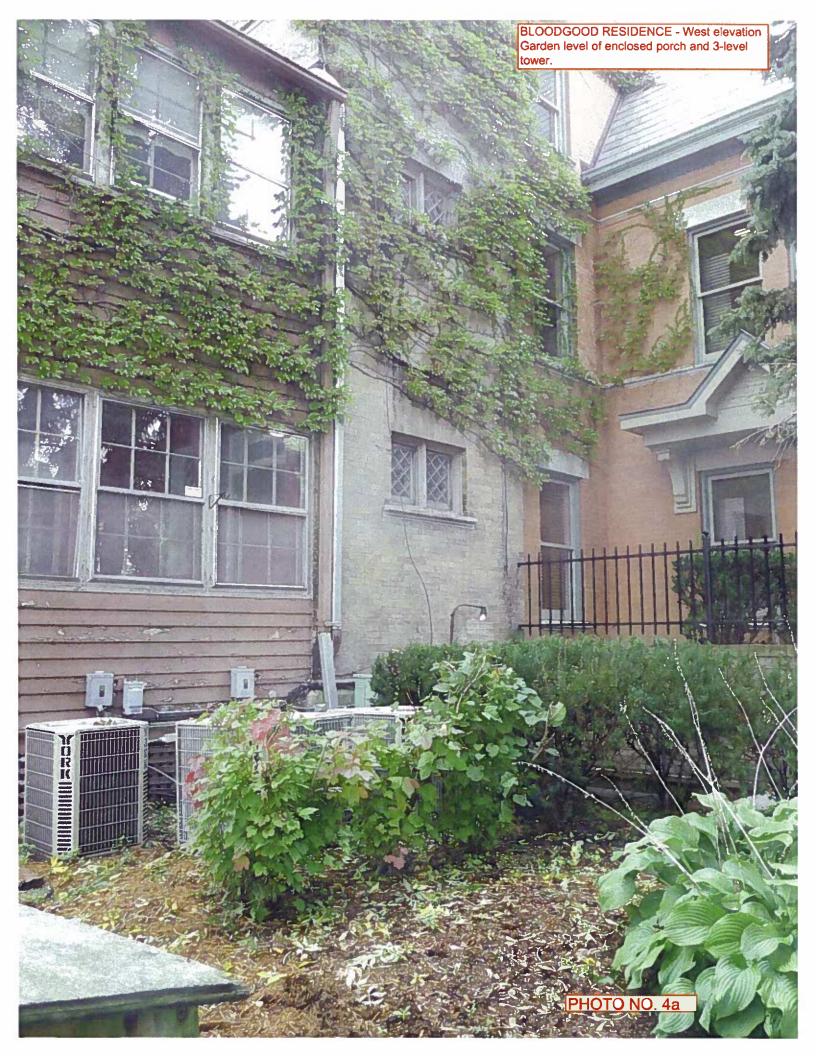





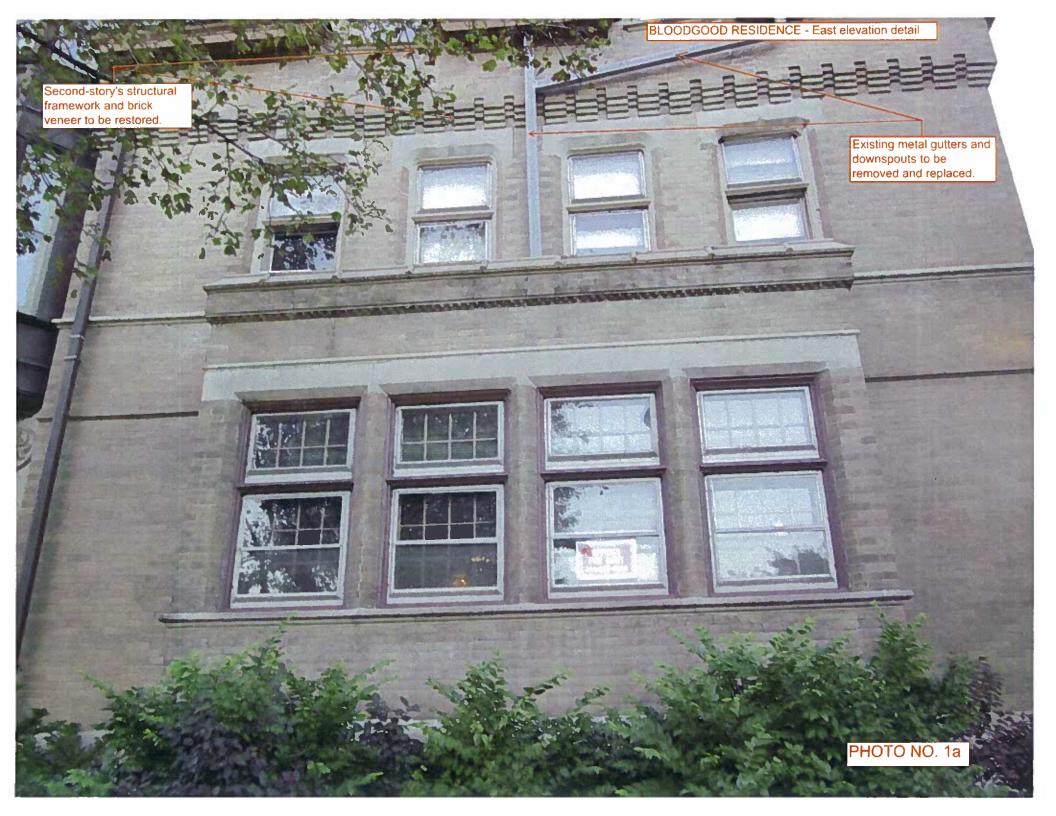









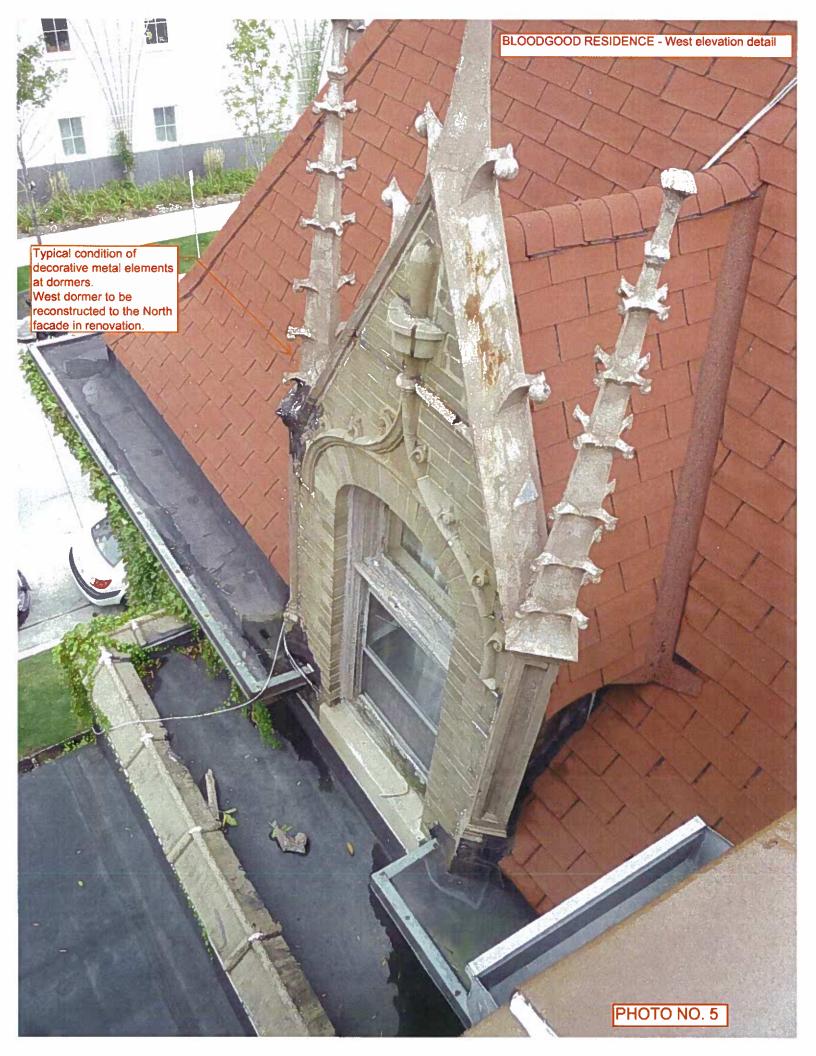


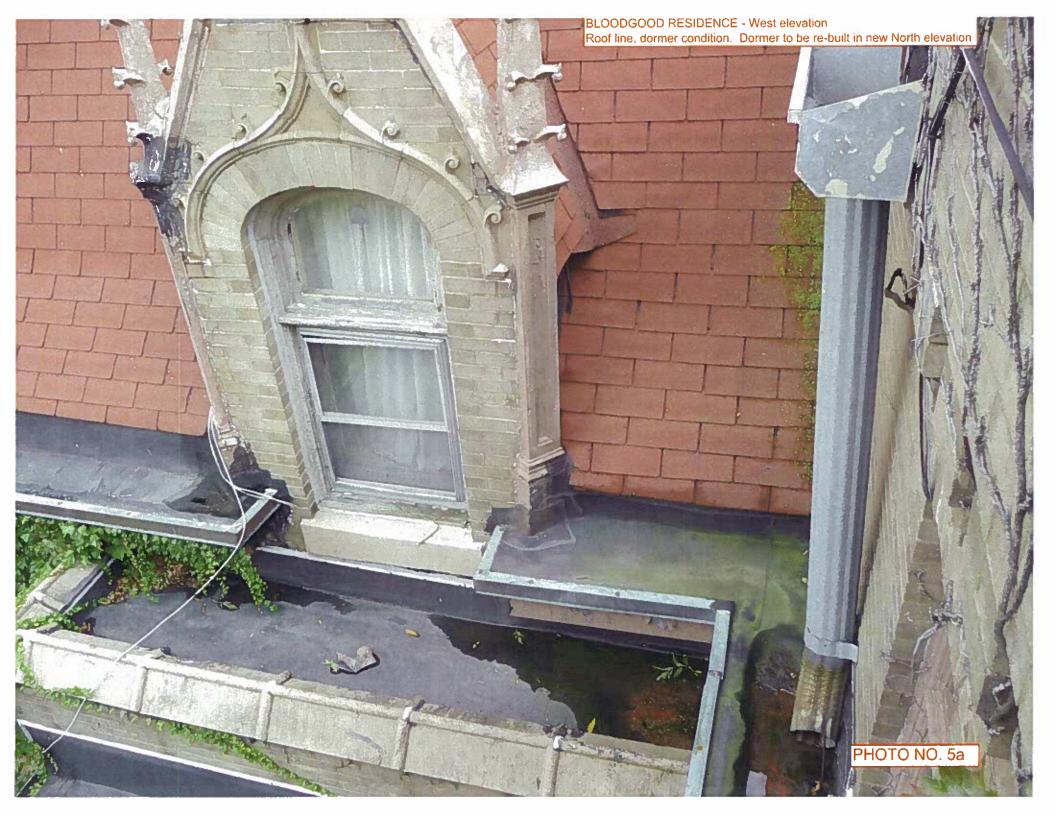

BLOODGOOD RESIDENCE - North elevation
Typical condition of dormer windows and decorative elements PHOTO NO. 6



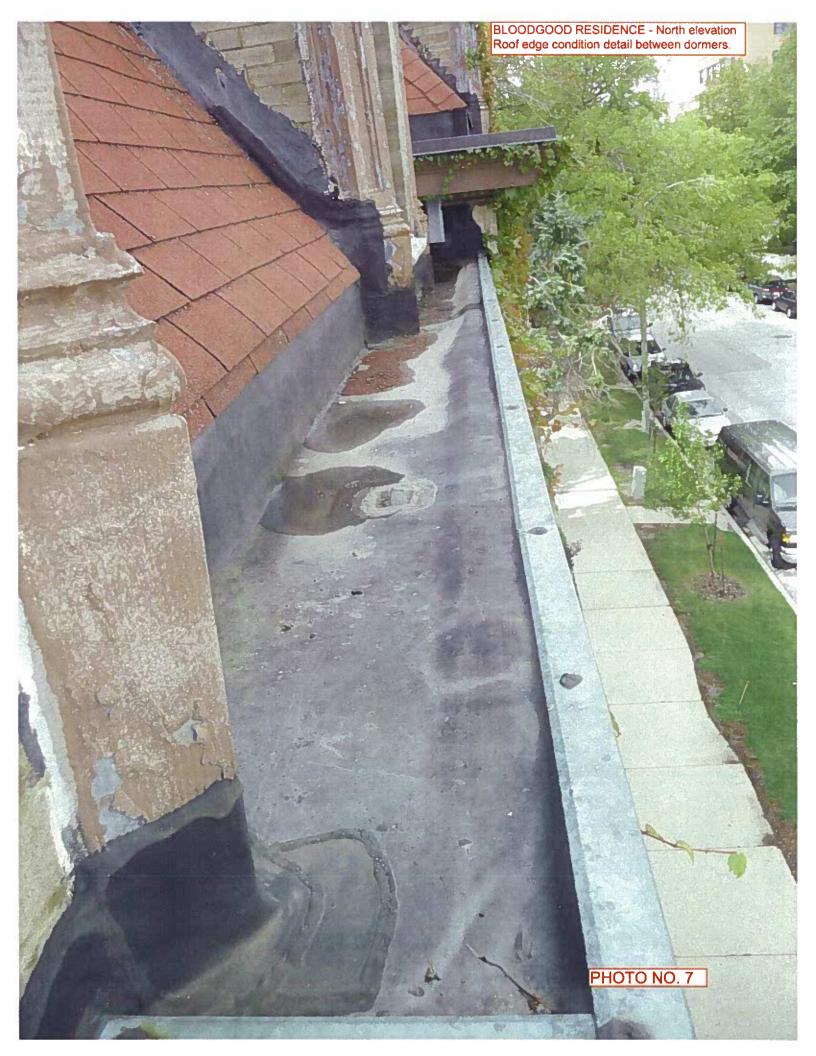

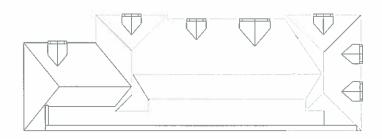





322 East Michigan Street Milwaukee, WI 53202


relephone |414.271.8899 facsimile | 414.271.8942 amail | office@uihlein-wilson.com

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REVISIONS No. Date

Description



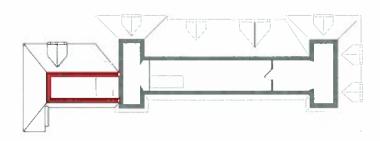

Residence
Renovation
1139 East
Knapp Street


PLANS - ALL LEVELS, ROOF

DATE
October 20, 2011

PROJECT NO.
11-118

SITEET'NO.

AA100

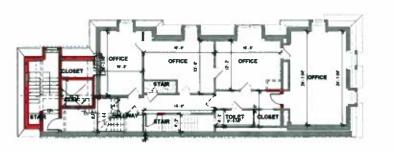

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OPEN OFFICE/CONF

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3 2 Second level - New 146" = 1'-0"

2 1 First Ploor - New 1/8" = 1'-0"

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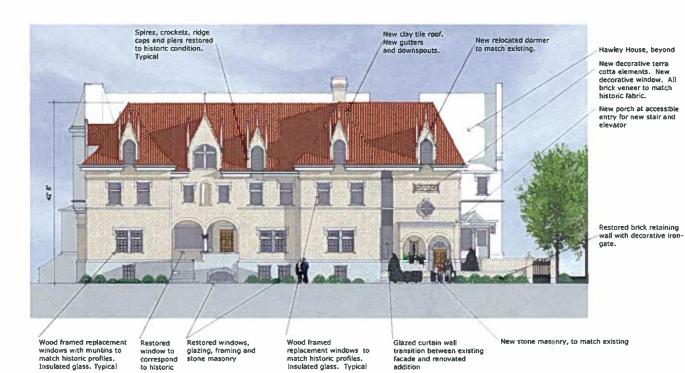
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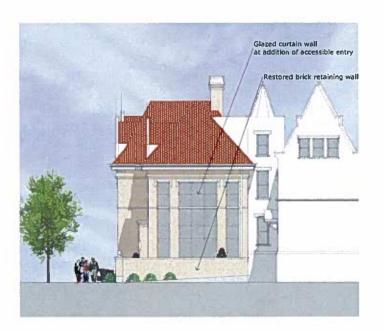
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NORTH






**ARCHITECTS** 

322 Last Michigan Street Milwaukee, WI 53202

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West Elevation Scale: 1/8"=1"+0"



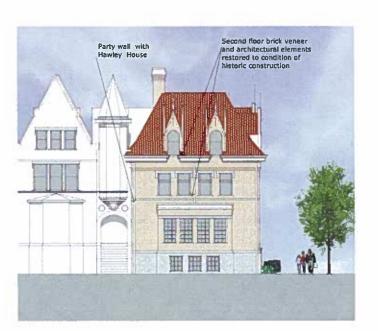

Bloodgood Residence Renovation 1139 East Knapp Street

Elevations

October 20, 2011

PRIMITING 11-118

A200




North Elevation

A200 Scale: 1/8\*={\*-0\*\*

Bast Elevation

A200 Scale: 1/8"=1'-0"

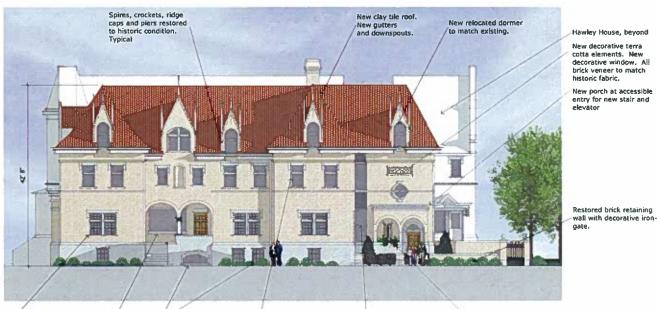

Wood framed replacement windows to match historic profiles. Insulated glass. Typical

Glazed curtain wall transition between existing facade and renovated addition

Hawley House, beyond New decorative terra cotta elements. New decorative window. All brick veneer to match historic fabric. New porch at accessible entry for new stair and elevator

Glazed curtain wall at addition of accessible entry

ARCHITECTS

322 Hast Michigan Street Milwaukee, WI 53202

relephone | 414.251.8894 facsimile | 414.251.8942 email | office/a whiem wisconcorii

Restored window to correspond to historic

Restored windows, glazing, framing and stone masonry

North Elevation

A200 Scale: 1/8"=1/-0"

Wood framed replacement windows with munths to match historic profiles. Insulated glass, Typical







Bloodgood Residence Renovation 1139 East Knapp Street

Elevations

Derober 20, 2011

11-118

A200





522 East Michigan Street Milwaukee, WI 53202

telephone | 414 271 8899 factimile | 414 271.8942 email | office@ublein wilson.com

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Date De

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Bloodgood Residence Renovation 1139 East Knapp Street

PROPOSED SITE PLAN AND ADDITION

October 20, 2011

PROJECT NO

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AA001

