



LEGEND & SYMBOLS

- UTILITY POLE
- SIGN
- TELCO PEDESTAL
- FIRE HYDRANT
- LIGHT STANDARD
- INLET
- CATCH BASIN
- MANHOLE
- TRAFFIC SIGNAL
- ROW MARKER
- IRON PIPE SET
- IRON PIPE FOUND

- BUFFALO BOX
- VALVE BOX
- HORIZONTAL CONTROL POINT
- HANDICAPPED PARKING SPACE
- DECIDUOUS TREE W/SIZE
- CONIFEROUS TREE W/SIZE
- BRUSH
- TREE LINE
- CONTOUR W/ELEVATION
- EXISTING GUARDRAIL
- CHAIN LINK FENCE
- IRON FENCE
- WOOD FENCE
- OVERHEAD WIRES
- LOT LINE
- PROPERTY LINE
- CENTER LINE
- UNDERGROUND ELECTRIC LINE
- UNDERGROUND GAS LINE
- UNDERGROUND TELECOMM. LINE
- UNDERGROUND STORM/SANITARY SEWER LINE
- UNDERGROUND WATER LINE

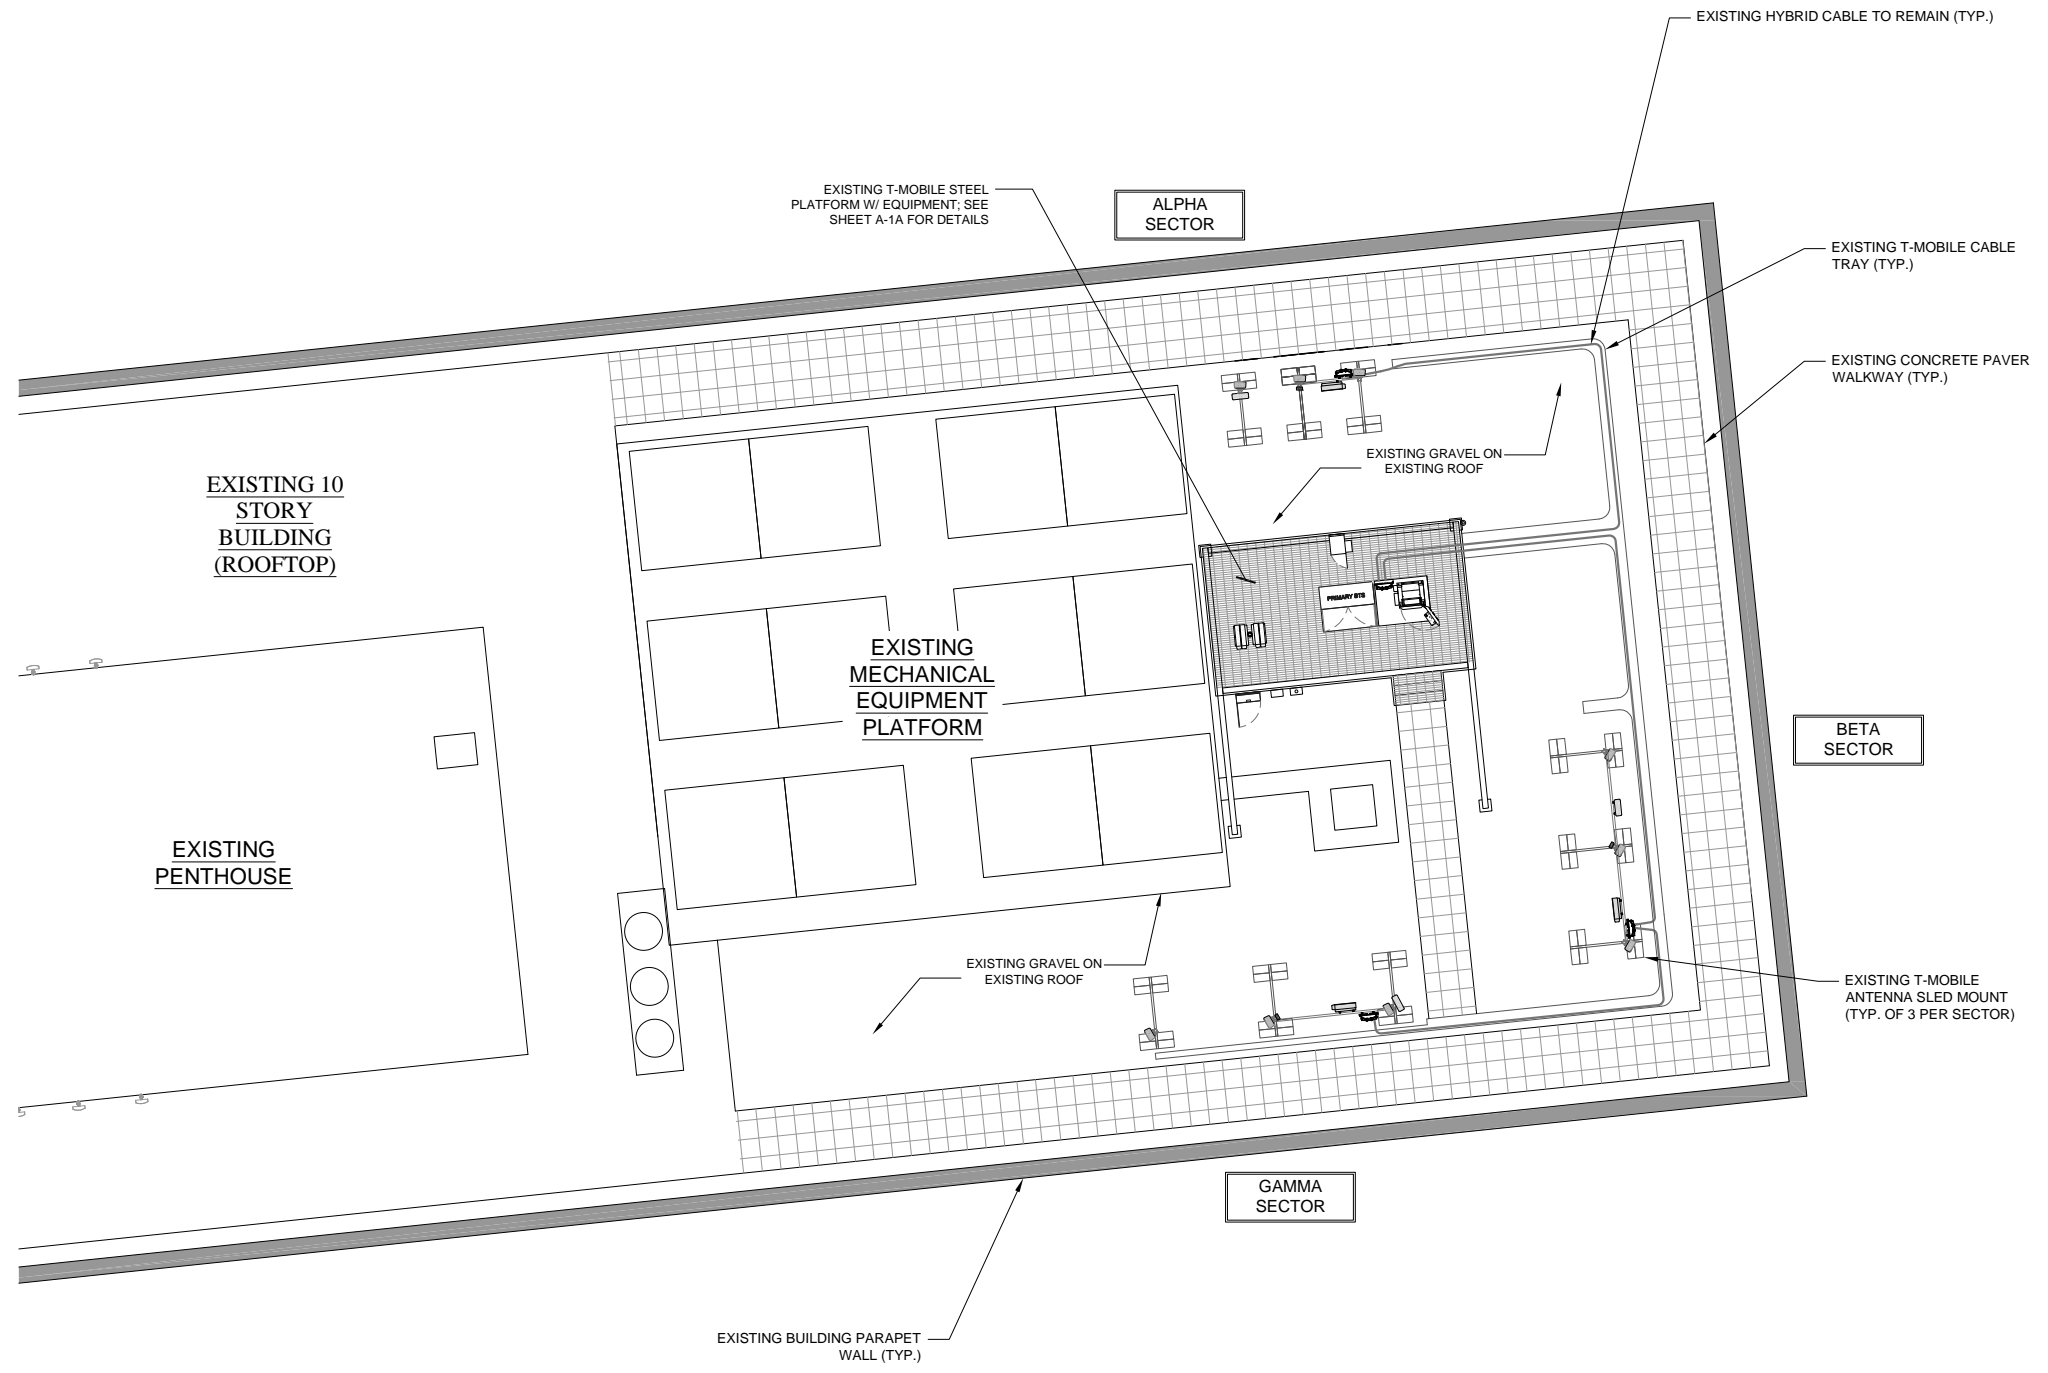

1 ROOF PLAN (PARTIAL)
SCALE: 1/8"=1'-0" (1/8"=2'-0" IF 11X17 SHEET SIZE)

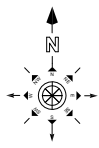

T-Mobile

T-MOBILE
8550 WEST BRYN MAWR AVE.
SUITE 100
CHICAGO, IL 60631
MAIN: (773) 444-5400

CONCORDIA, LTD
A PROFESSIONAL DESIGN FIRM
LICENSE # 3323-011- D.B.A.

CONCORDIA WIRELESS, INC.

361 RANDY ROAD
UNIT 101
CAROL STREAM, IL 60188
MAIN: (847) 981-0801

(C) Concordia 2001-2016, Copyright Notice: These Documents/Drawings Are Produced by and Are Therefore The Intellectual Property of Concordia Group Of Companies. Do Not Copy, Reproduce, Reverse-Engineer or Replicate Any Parts of These Documents In any Manner Without Obtaining Written Consent From The Concordia Group.

DRAWN BY: BG	CHECKED BY: GMS
CHECKED BY: RH	APPROVED BY: GMS

No.	Revision/Issue	Date	Initial
A	LEASE EXHIBIT	03/28/16	BG

ML10001A
ZEIDLER BLDG
841 NORTH BROADWAY
MILWAUKEE, WI 53201

ROOF PLAN

A-1

T-Mobile

T-MOBILE
8550 WEST BRYN MAWR AVE.
SUITE 100
CHICAGO, IL 60631
MAIN: (773) 444-5400

CONCORDIA, LTD
A PROFESSIONAL DESIGN FIRM
LICENSE # 3323-011- D.B.A.
CONCORDIA WIRELESS, INC.
361 RANDY ROAD
UNIT 101
CAROL STREAM, IL 60188
MAIN: (847) 981-0801


(C) Concordia 2001-2016, Copyright Notice:
These Documents/Drawings Are Produced by and
Are Therefore The Intellectual Property of Concordia
Group Of Companies. Do Not Copy, Reproduce,
Reverse-Engineer or Replicate Any Parts of These
Documents in any Manner Without Obtaining Written
Consent From The Concordia Group.

DRAWN BY: BG	CHECKED BY: GMS
CHECKED BY: RH	APPROVED BY: GMS

ML10001A
ZEIDLER BLDG
841 NORTH BROADWAY
MILWAUKEE, WI 53201

EXISTING & PROPOSED
EQUIPMENT LAYOUT


A-1A

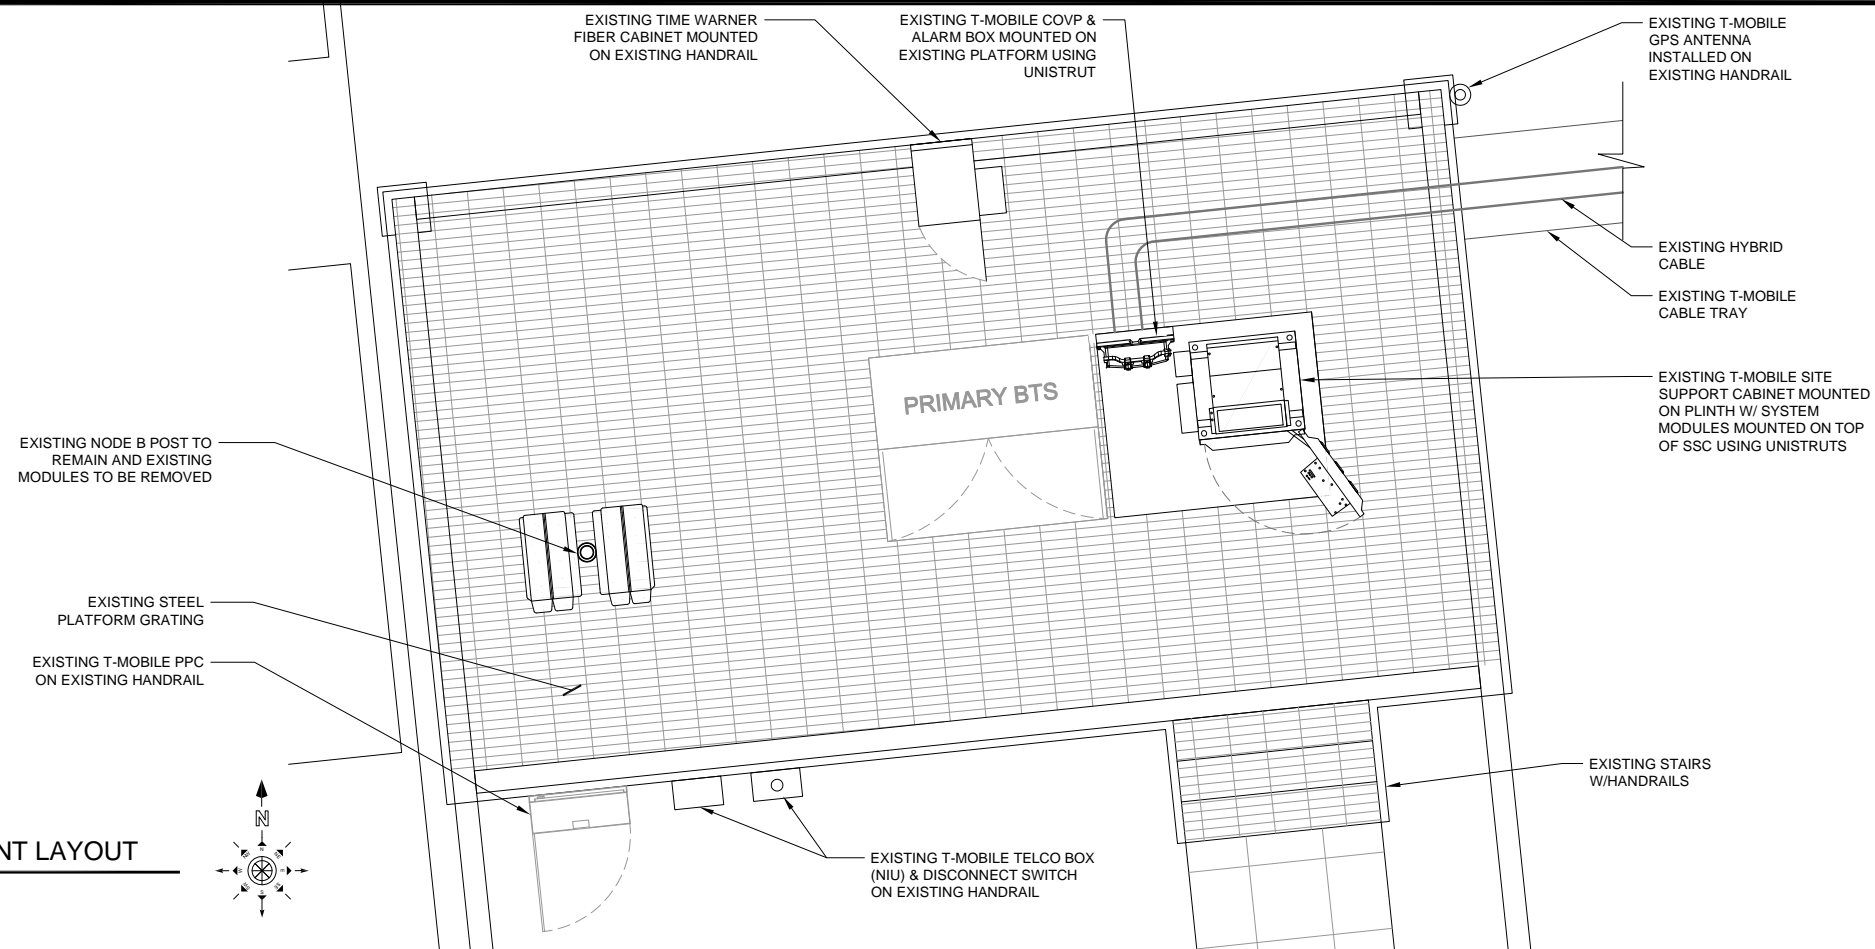

1 ENLARGED EXISTING EQUIPMENT LAYOUT
SCALE: 1/2"=1'-0" (1/2"=2'-0" IF 11 X 17 SHEET SIZE)

IMPORTANT NOTES:

1. EXISTING SSC TO BE UTILIZED BY GC. GC TO SWAP EXISTING 7705 SAR-F TO SAR-M
2. GC TO REUSE EXISTING 10A DC BREAKERS FOR UMTS FSMF & LTE FSMF
3. GC TO REUSE EXISTING 10A DC BREAKERS FOR ESMC-GSM
4. GC TO REPLACE EXISTING 150A COVP DC BREAKER W/ 200A BREAKER
5. GC TO REPLACE EXISTING (2) #2 AWG COVP DC CABLES W/ (8) NEW #4 AWG
6. GC TO REPLACE EXISTING CONDUIT TO 2" CONDUIT FROM COVP TO SSC

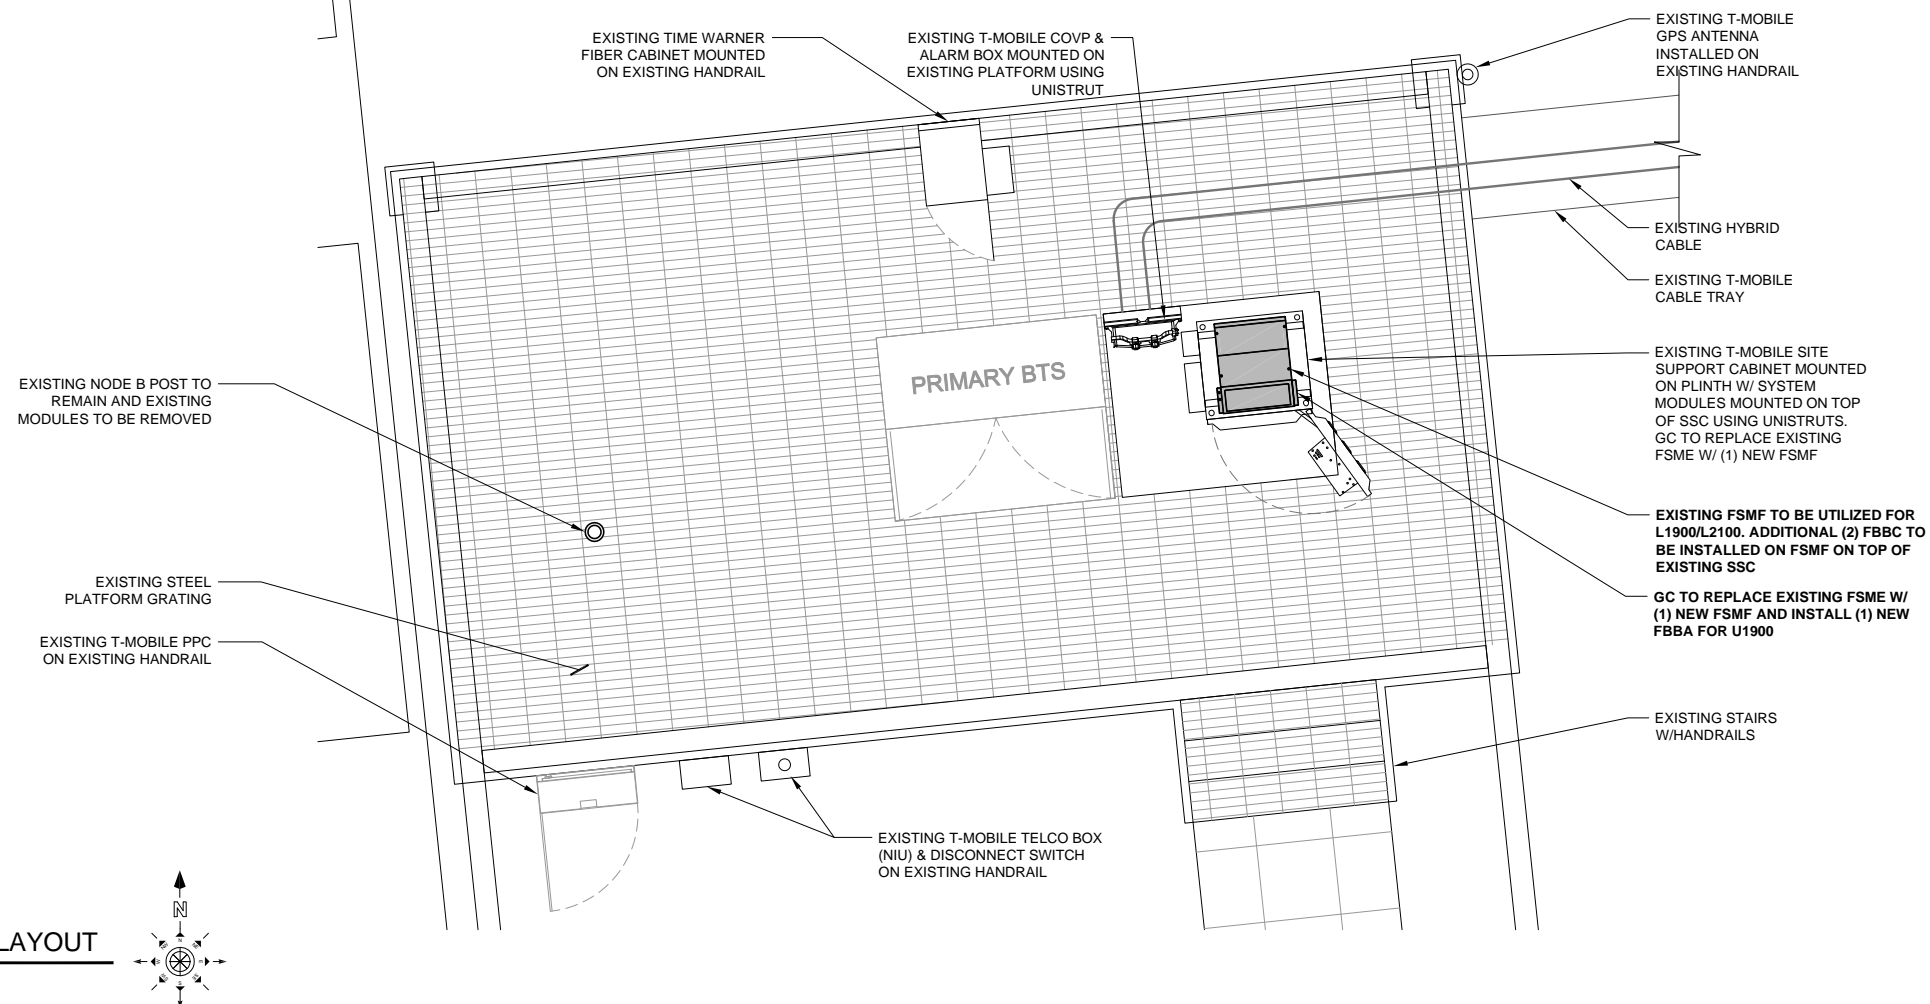

2 ENLARGED PROPOSED EQUIPMENT LAYOUT
SCALE: 1/2"=1'-0" (1/2"=2'-0" IF 11 X 17 SHEET SIZE)

T-Mobile

T-MOBILE
8550 WEST BRYN MAWR AVE.
SUITE 100
CHICAGO, IL 60631
MAIN: (773) 444-5400

CONCORDIA, LTD
A PROFESSIONAL DESIGN FIRM
LICENSE # 3323-011- D.B.A.
CONCORDIA WIRELESS, INC.
361 RANDY ROAD
UNIT 101
CAROL STREAM, IL 60188
MAIN: (847) 981-0801


(C) Concordia 2001-2016, Copyright Notice:
These Documents/Drawings Are Produced by and
Are Therefore The Intellectual Property of Concordia
Group Of Companies. Do Not Copy, Reproduce,
Reverse-Engineer or Replicate Any Parts of These
Documents In any Manner Without Obtaining Written
Consent From The Concordia Group.

DRAWN BY: BG	CHECKED BY: GMS
CHECKED BY: RH	APPROVED BY: GMS


ML10001A
ZEIDLER BLDG
841 NORTH BROADWAY
MILWAUKEE, WI 53201

SITE ELEVATION


A-2

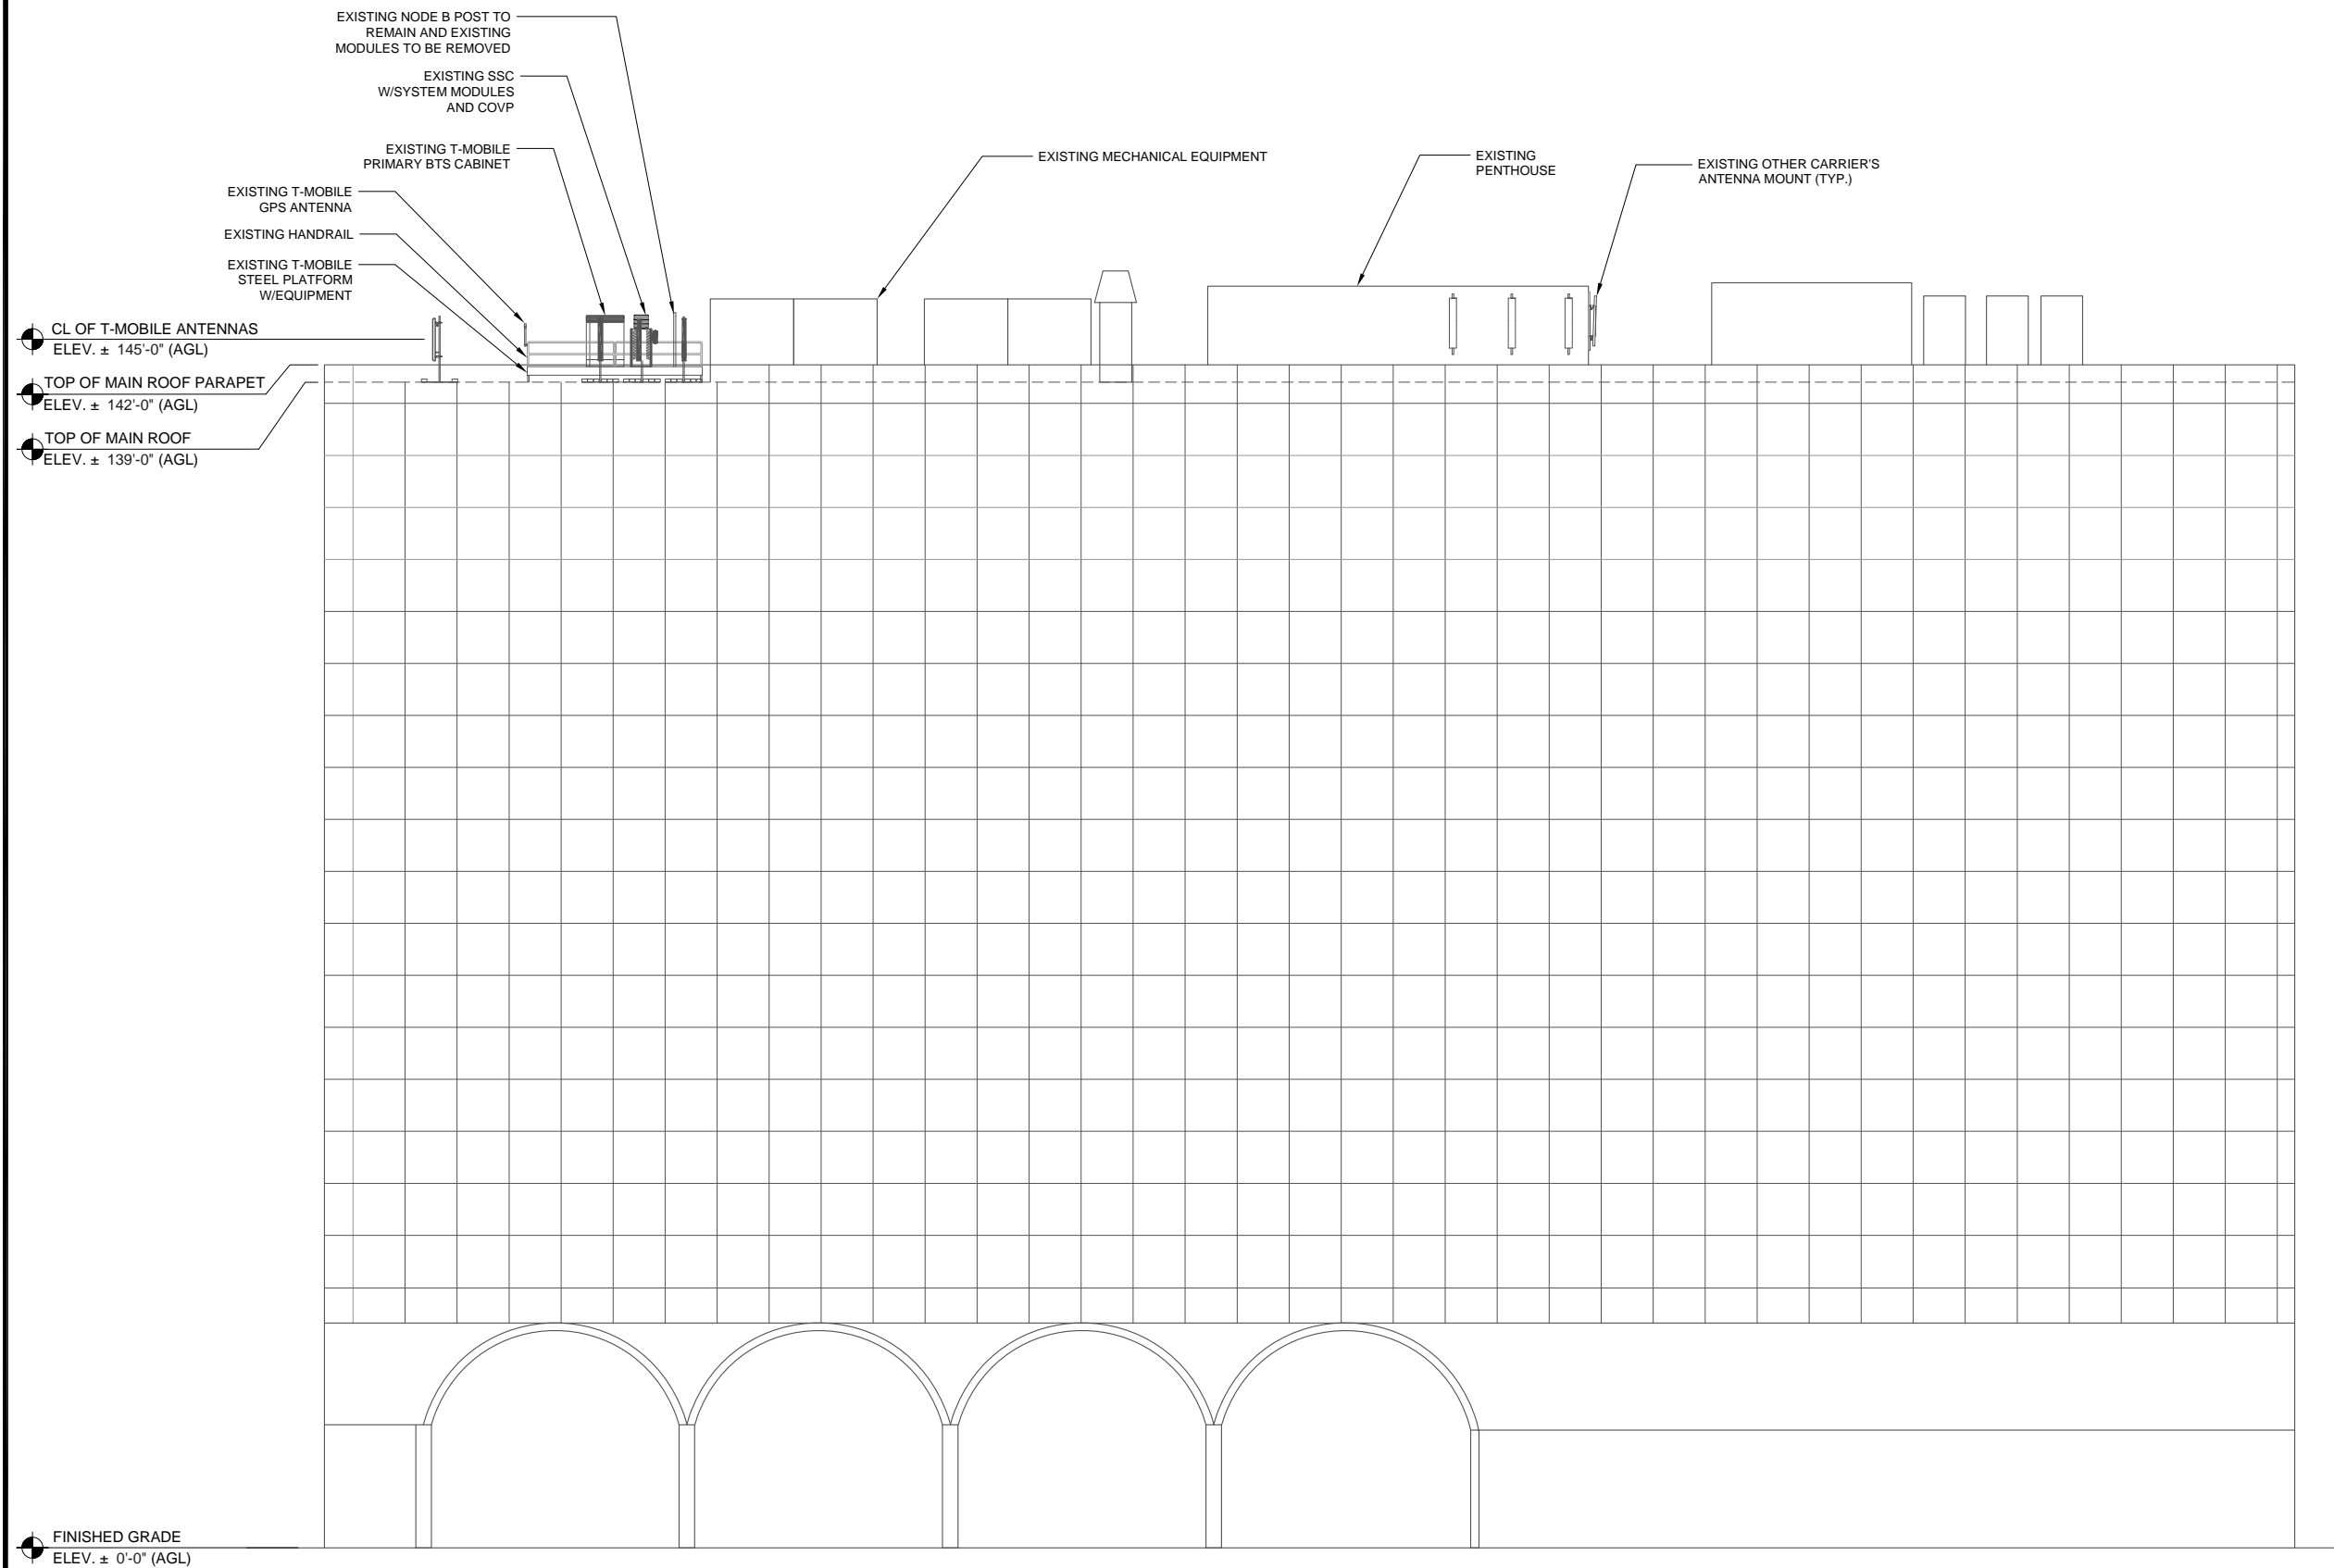


1 SITE ELEVATION
SCALE: 3/32"=1'-0" (3/32"=2'-0" IF 11 X 17 SHEET SIZE)

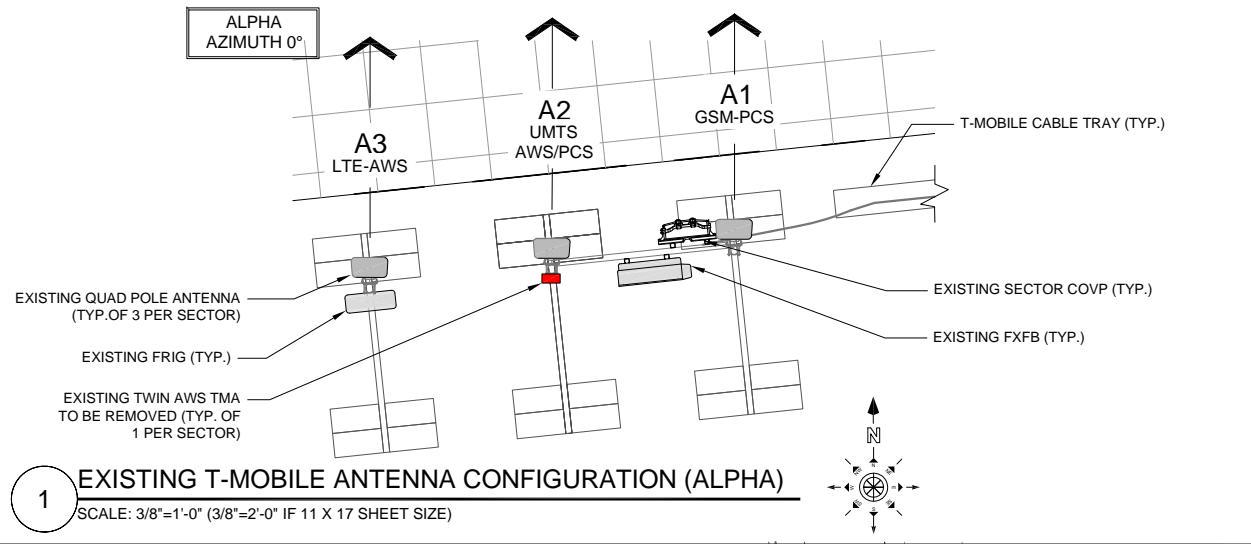


1 EXISTING T-MOBILE ANTENNA CONFIGURATION (ALPHA)
SCALE: 3/8"=1'-0" (3/8"=2'-0" IF 11 X 17 SHEET SIZE)

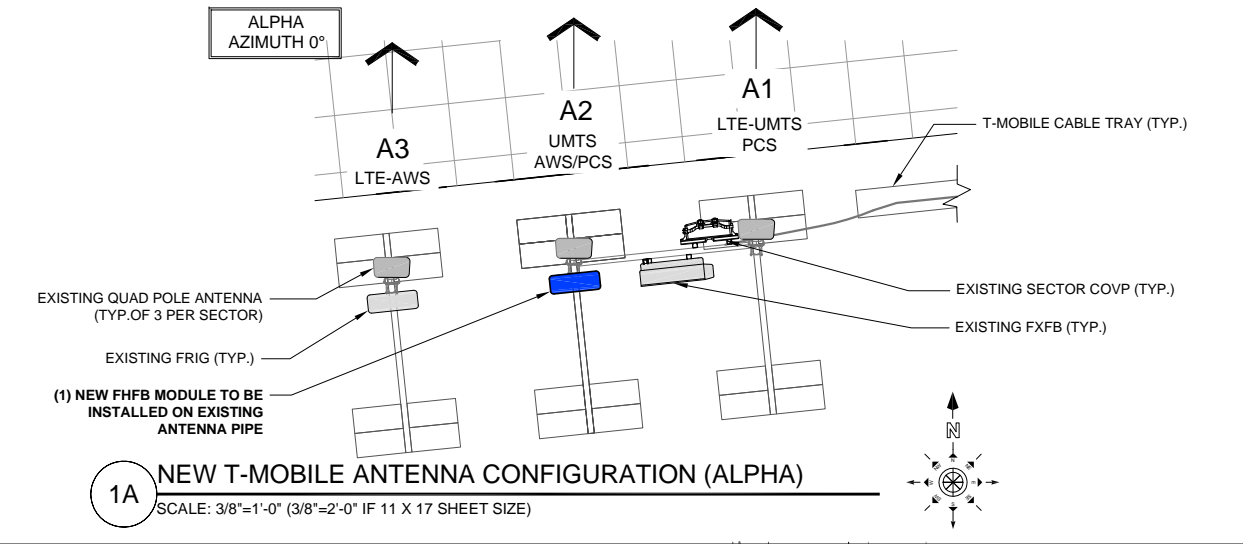


1A NEW T-MOBILE ANTENNA CONFIGURATION (ALPHA)
SCALE: 3/8"=1'-0" (3/8"=2'-0" IF 11 X 17 SHEET SIZE)

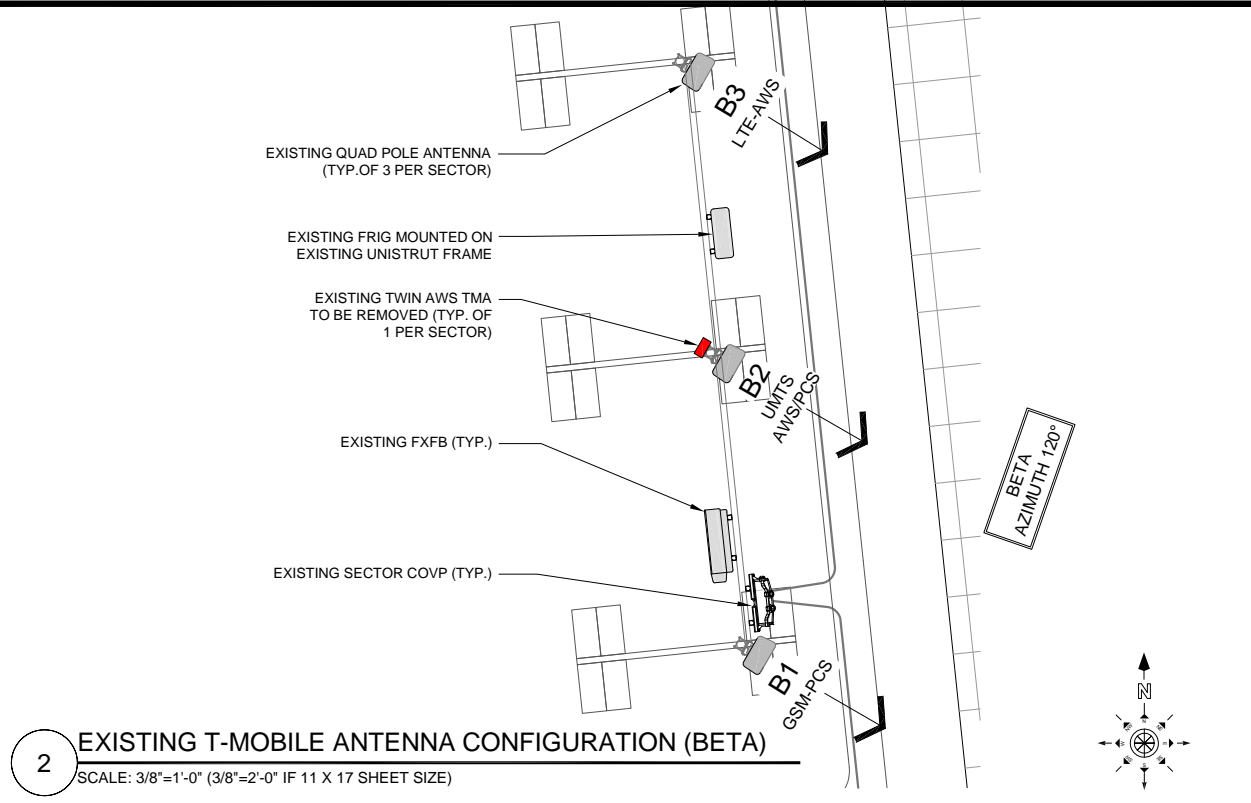


2 EXISTING T-MOBILE ANTENNA CONFIGURATION (BETA)
SCALE: 3/8"=1'-0" (3/8"=2'-0" IF 11 X 17 SHEET SIZE)

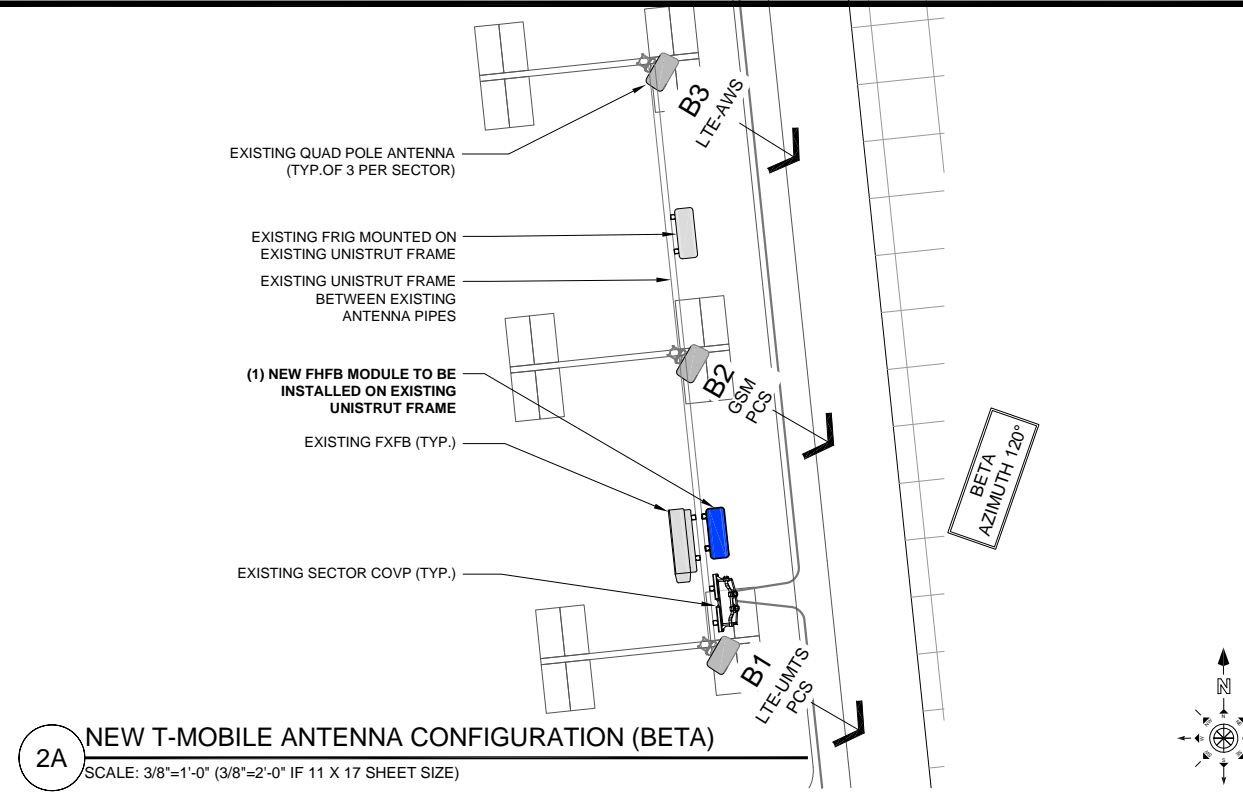

2A NEW T-MOBILE ANTENNA CONFIGURATION (BETA)
SCALE: 3/8"=1'-0" (3/8"=2'-0" IF 11 X 17 SHEET SIZE)

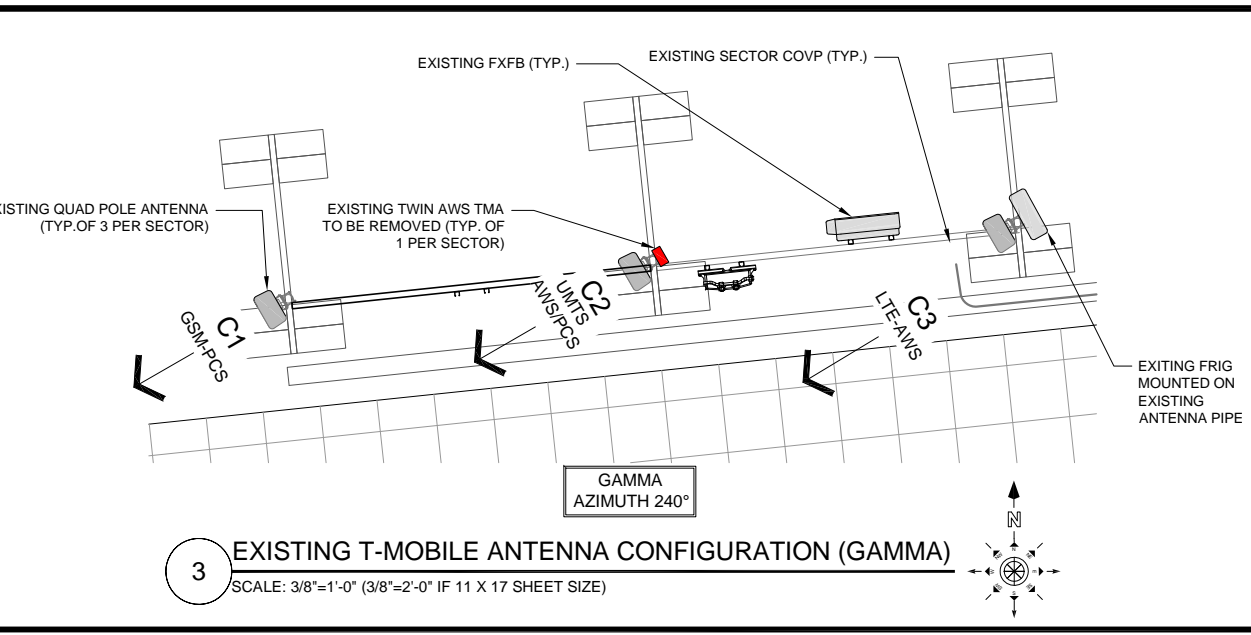

3 EXISTING T-MOBILE ANTENNA CONFIGURATION (GAMMA)
SCALE: 3/8"=1'-0" (3/8"=2'-0" IF 11 X 17 SHEET SIZE)

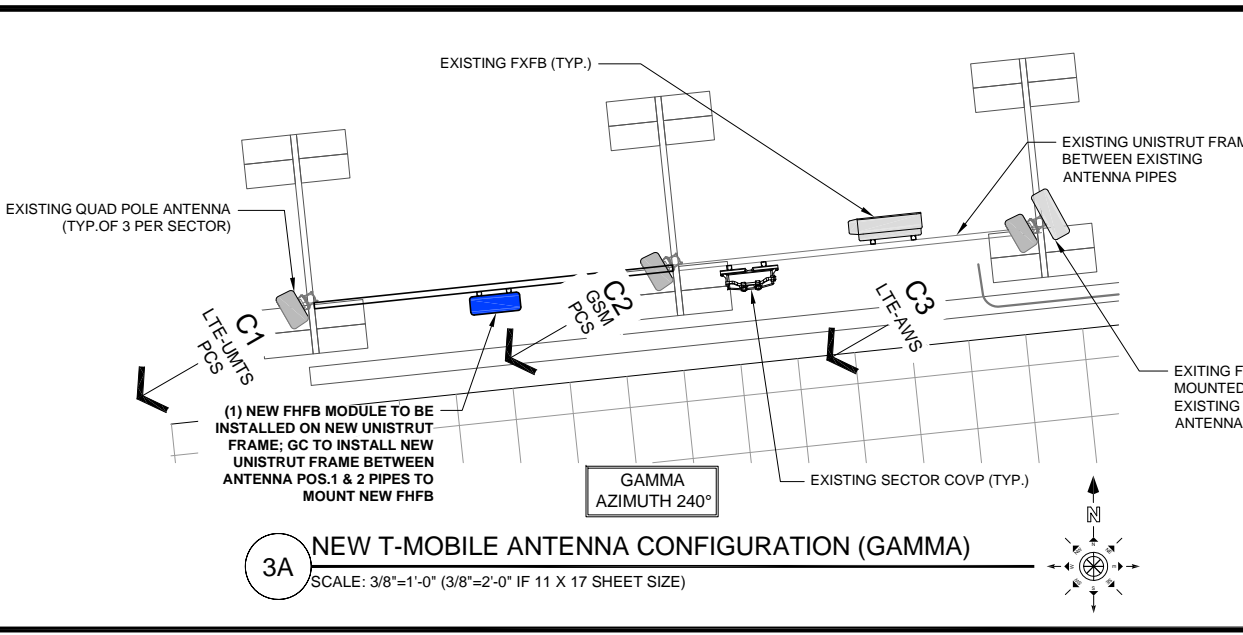

3A NEW T-MOBILE ANTENNA CONFIGURATION (GAMMA)
SCALE: 3/8"=1'-0" (3/8"=2'-0" IF 11 X 17 SHEET SIZE)



T-MOBILE
8550 WEST BRYN MAWR AVE.
SUITE 100
CHICAGO, IL 60631
MAIN: (773) 444-5400

CONCORDIA, LTD.
A PROFESSIONAL DESIGN FIRM
LICENSE # 3323-011-D.B.A.
CONCORDIA WIRELESS, INC.
361 RANDY ROAD
UNIT 101
CAROL STREAM, IL 60188
MAIN: (847) 981-0801

(C) Concordia 2001-2016, Copyright Notice:
These Documents/Drawings Are Produced by and
Are Therefore The Intellectual Property of Concordia
Group Of Companies. Do Not Copy, Reproduce,
Reverse-Engineer or Replicate Any Parts of These
Documents In any Manner Without Obtaining Written
Consent From The Concordia Group.

DRAWN BY: BG	CHECKED BY: GMS
CHECKED BY: RH	APPROVED BY: GMS

ML10001A
ZEIDLER BLDG
841 NORTH BROADWAY
MILWAUKEE, WI 53201

PROPOSED ANTENNA
PLANS

A-2A