

Cedar

"the petitioner must take all measures necessary to control litter, loitering, and loud noise on the premises, including, but not limited to, hiring private personnel if necessary" 604 Wilson Avenue

Menomonie, WI 54751

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September 26, 2014

Department of City Development Planning Administration 809 N. Broadway, 2nd Floor Milwaukee, WI 53202

Planning Commission Members:

I am submitting these documents for your review of the Taco Bell Tenant Build-Out in the End-Cap space of Holt Plaza at 150-160 West Holt Avenue, Milwaukee, WI. This tenant is a Fast Food Restaurant with take-out service which is listed in the Commercial Service Zoning as Limited and in the Development Incentive Zone Guidelines as Approved, and noted that a public hearing is required.

I have reviewed the Submittal Checklist for Projects within a Development Incentive Zone as follows:

- 1. In lieu of a current site survey I am submitting the Site Plan for the previous construction project and an aerial photo courtesy of Google Earth to establish that the conditions are as shown on this plan.
- 2. a., b., c., f., h., and i., See plans attached.
- 2. d., e., and g., These items are not being altered by the new work from their existing conditions.
- 3. Elevations of the existing South and West Facades are attached for review of their alterations and signage. See plan sheet A401.
- 4. Pictures of the Existing Building and Parking area are included.
- 5. See the narration below.

I have reviewed the D.I.Z. Guidelines and had some discussion with staff at the Planning Administration offices. I propose to modify an existing approved structure with limited facade revisions and some site revisions. The front facade signage will incorporate a new prototype for Taco Bell signage that gives a nice streamlined effect. The Planning Administration staff suggested this horizontal slat overlay start above the existing soldier course at the bottom of the existing entry canopy. I have included two South Elevations on plan sheet A401 for your review and comparison.

The renovations to the West parking lot are made to accommodate the drive-up order and window delivery access. I have shown Taco Bell's standard Menu Board and intercom/speaker pedestal at the North end of this area near the existing light pole. The position of the car placing an order will be East-West and the intercom/speaker will face south. Taco Bell has a standard landscape plan for this area and I propose to incorporate this in the island area created by the

drive-up lane. The landscaped island will direct traffic and help alleviate sound. It is located so that it will not block the existing flow of storm water to the curb catch basin. The Planning Administration staff asked about the sound transfer from the drive-up order pedestal. I have attached information from the manufacturer on sound levels for your review and I have the cut sheets of the equipment that will be located in this area. The Planning Administration staff recommended a Board-on-Board screening fence be located at the NW corner of the parking lot and I have added a 6' high fence per the City zoning code. The owner plans on adding a monument sign at the SE corner of this parking lot, and Taco Bell will have the sign modified to fit the local zoning codes.


Thank you for your careful consideration.

Cuto A. liddell

Sincerely,

Rita Liddell

Project Architect

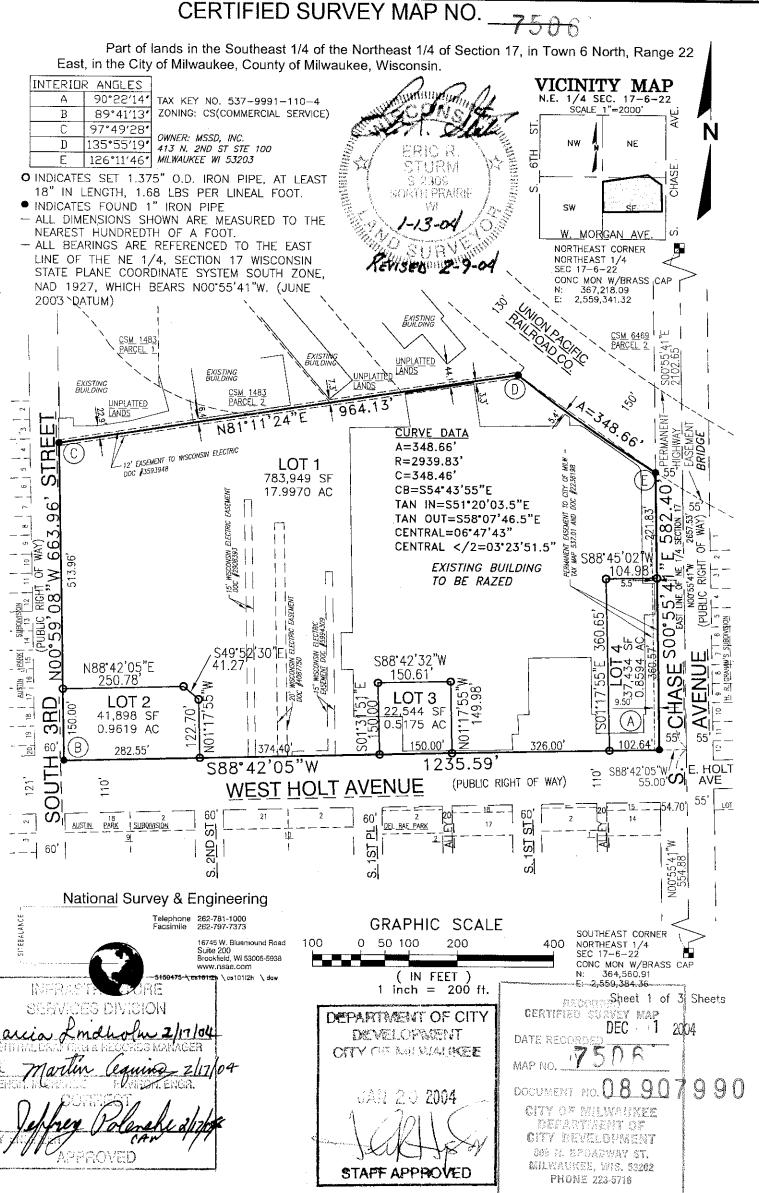

Google Maps
Page 1 of 1



GENERAL PROJECT NOTES


- WE CERTIFY, TO THE BEST OF OUR KNOWLEDGE, INFORMATION AND BELIEF THAT THE DESIGN OF THE PROJECT COMPLIES WITH APPLICABLE PROVISIONS OF THE ADMINISTRATIVE CODES AND STATUTES OF THE STATE OF WISCONSIN AND ACCESSIBILITY STANDARDS.
- THE CONTRACTOR SHALL TAKE ALL PRECAUTIONARY MEASURES TO PROTECT THE PUBLIC AND ADJACENT PROPERTIES FROM DAMAGE THROUGHOUT
- ANY EXISTING UTILITIES TO BE ABANDONED SHALL BE PROPERLY DISCONNECTED, PLUGGED OR CAPPED, AS REQUIRED BY CODE OR LOCAL
- THESE DRAWINGS ARE DIAGRAMMATIC AND SHALL NOT BE SCALED. ADDITIONAL DATA SHALL BE FROM THE ARCHITECT / ENGINEER THROUGH WRITTEN CLARIFICATION ONLY. VERIFY ALL EXISTING CONDITIONS, ELEVATIONS, AND DIMENSIONS BEFORE PROCEEDING WITH ANY PORTION OF ANY WORK.
- NO CHANGES, MODIFICATIONS OR DEVIATIONS SHALL BE MADE FROM THE DRAWINGS OR SPECIFICATIONS WITHOUT FIRST SECURING WRITTEN PERMISSION FROM THE ARCHITECT / ENGINEER.
- WHERE LACK OF INFORMATION, OR ANY DISCREPANCY SHOULD APPEAR IN THE DRAWINGS OR SPECIFICATIONS, REQUEST WRITTEN INTERPRETATION FROM THE ARCHITECT / ENGINEER BEFORE PROCEEDING WITH THAT PORTION OF THE WORK.
- ALL WORK AS OUTLINED IN THESE DOCUMENTS, SHALL STRICTLY CONFORM TO ALL APPLICABLE CODES AND ORDINANCES, IN THE EVENT OF CONFLICTS THE MORE STRINGENT REQUIREMENT SHALL GOVERN AND BE MET.
- THE CONTRACTOR SHALL PAY FOR ALL FEES, PERMITS, LICENSES, ETC., NECESSARY FOR PROPER COMPLETION OF THE WORK.
- THE CONTRACTOR SHALL GUARANTEE ALL WORKMANSHIP AND MATERIALS FOR A PERIOD OF ONE (1) YEAR FROM THE DATE OF SUBSTANTIAL COMPLETION OR AS OTHÈRWISE REQUIRED IN THE SPECIFICATIONS.
- PROVIDE ADEQUATE CONCEALED BLOCKING AND ANCHORING FOR ALL CEILING AND WALL MOUNTED EQUIPMENT, HARDWARE AND ACCESSORIES.
- WHEN A SYSTEM OR ASSEMBLY IS CALLED OUT FOR, ALL NECESSARY PARTS AND MATERIALS REQUIRED FOR A COMPLETE INSTALLATION/SYSTEM SHALL BE INSTALLED ACCORDING TO THE MANUFACTURERS INSTRÚCTIONS.
- . COORDINATE WITH ALL TRADES THE LOCATIONS OF SLEEVES OR OTHER PRESET ACCESSORIES INVOLVING OTHER TRADES.
- DISRUPTED EXISTING CONDITIONS i.e. LANDSCAPING, LIGHTING, PEDESTRIAN AND VEHICLE ACCESS SHALL BE MINIMALLY REPLACED AT THE END OF CONSTRUCTION TO MATCH EXISTING AND ADJACENT CONDITIONS PRIOR TO
- 14. DIMENSIONS ARE SHOWN FROM FACE TO FACE WALL SURFACE AND EDGE OF ROUGH OPENING UNLESS OTHERWISE NOTED.
- 15. THE CONTRACTOR SHALL VISIT THE JOB SITE AND BECOME FAMILIARIZED WITH ALL EXISTING CONDITIONS WHICH MAY AFFECT THE BID. NO ALLOWANCES WILL BE MADE AFTER THE BID FOR EXISTING CONDITIONS OR THE CONTRACTOR'S FAILURE TO VERIFY EXISTING CONDITIONS.
- PROVIDE SIX (6) SETS OF SHOP DRAWINGS FOR ALL EQUIPMENT TO THE ARCHITECT / ENGINEER FOR REVIEW PRIOR TO ORDERING. EQUIPMENT INSTALLED WITHOUT APPROVAL SHALL BE SUBJECT TO REJECTION AND REPLACEMENT AT CONTRACTOR'S EXPENSE.
- 17. THE CONTRACTOR SHALL BE RESPONSIBLE FOR VERIFYING LOCATIONS OF EXISTING UTILITIES, EASEMENTS, PROPERTY BOUNDARIES AND SETBACKS.
- 18. THE CONTRACTOR SHALL BE RESPONSIBLE FOR SCHEDULING AND COORDINATING EXTENSION OF NATURAL GAS, SANITARY SEWER, ELECTRICAL, TV CABLE AND TELEPHONE SERVICE TO THE BUILDING.
- 19. THE CONTRACTOR SHALL BE RESPONSIBLE TO VERIFY THE SOIL BEARING CAPACITY WITH GEOTECHNICAL CONSULTANT.
- 20. THE CONTRACTOR SHALL PROVIDE 6" COMPACTED GRANULAR FILL AT
- 21. ALL DETAILS NOT SHOWN ON THIS PLAN SHALL BE THE RESPONSIBILITY
- 22. THE GENERAL CONTRACTOR IS RESPONSIBLE FOR ALL CUTTING AND

- 1				
	FIN FLR	EXPOSEDEXTERIORFINISHFLOOR	WH VAR VB	WATER HEATERVARIESVAPOR BARRIER
	FLOUR	FLUORESCENT	VCT	- VINYL COMPOSITION TILE
- 1	I FDN	 FOUNDATION 		


TACO BELL TENANT BUILD-OUT

HOLT PLAZA 150-160 WEST HOLT AVENUE MILWAUKEE, WI 53207



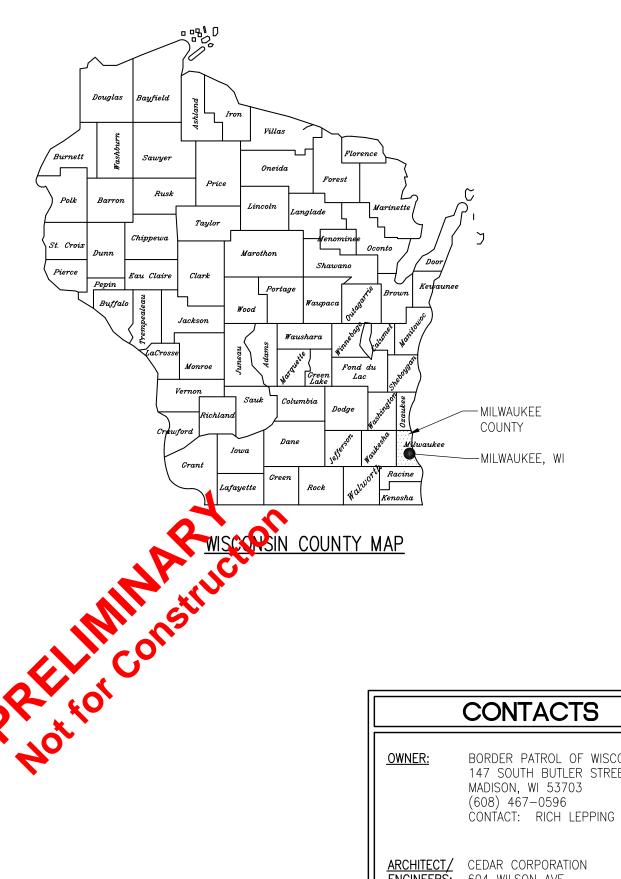





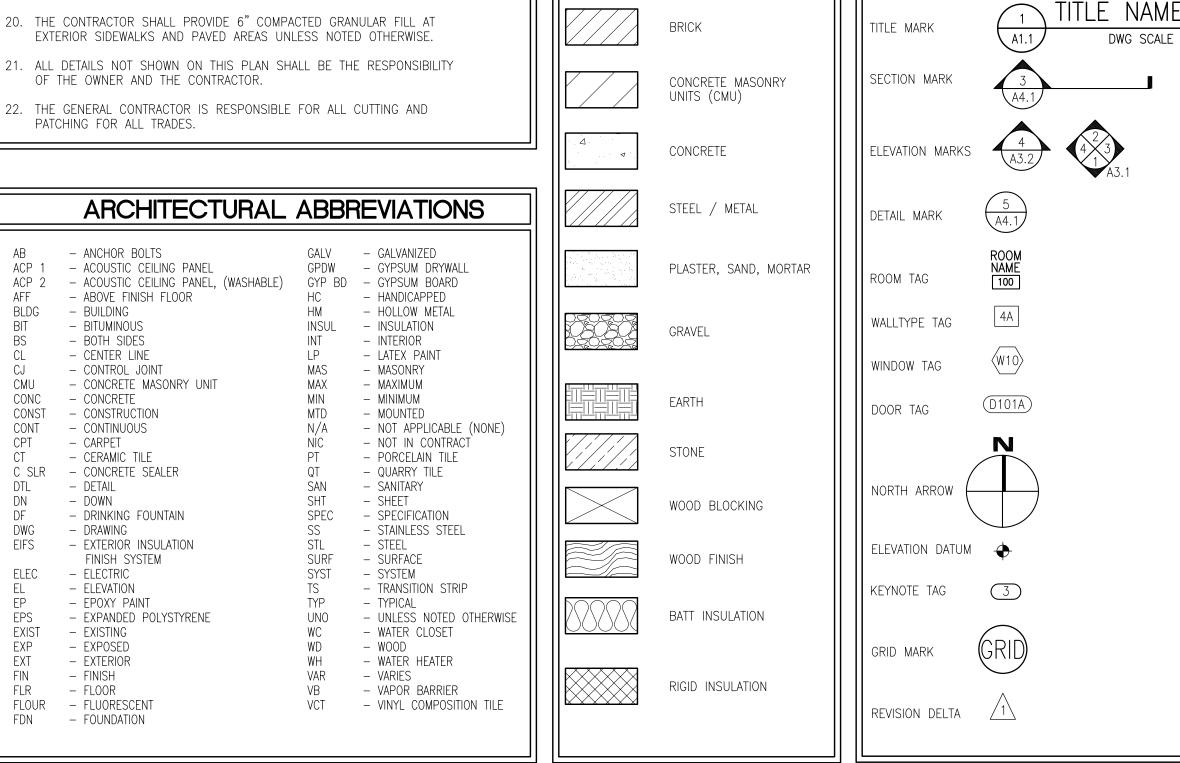


MATERIALS

DRAFTING SYMBOLS

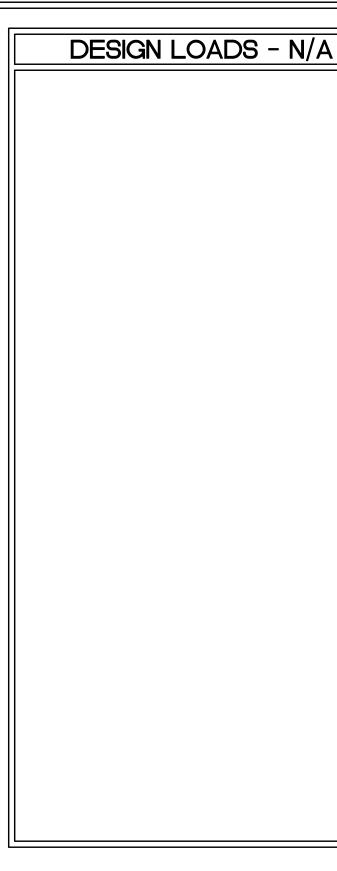

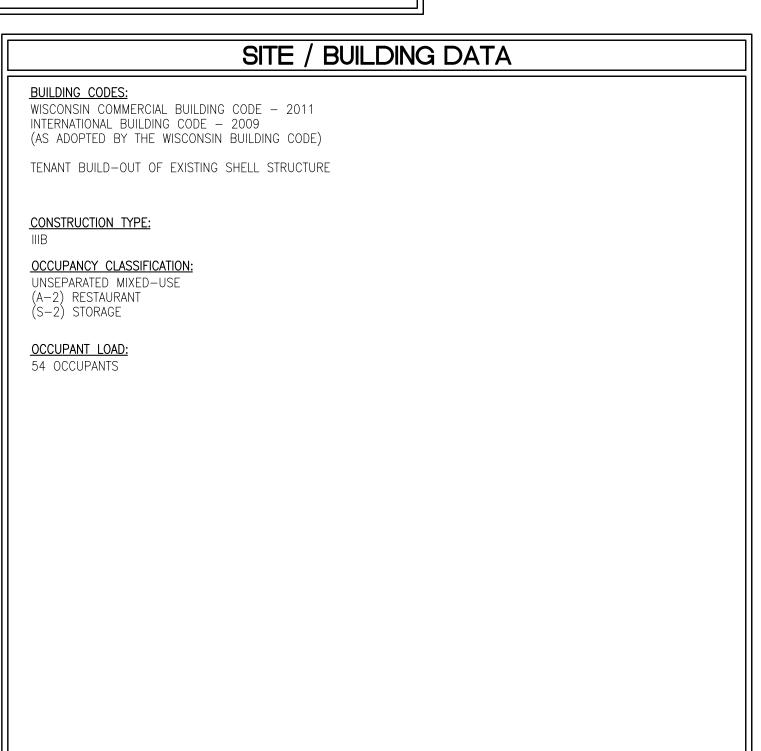

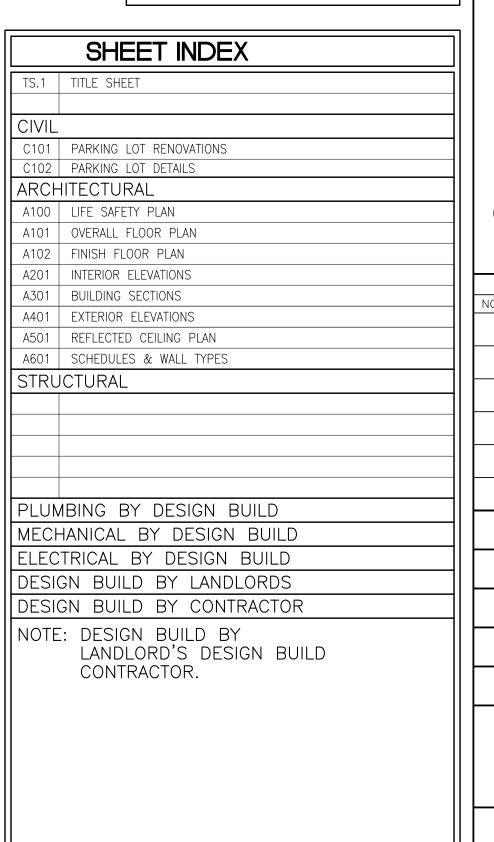




B5541-001

PRELIMINARY

ISSUE DATE

SEPTEMBER 2014

SHEET

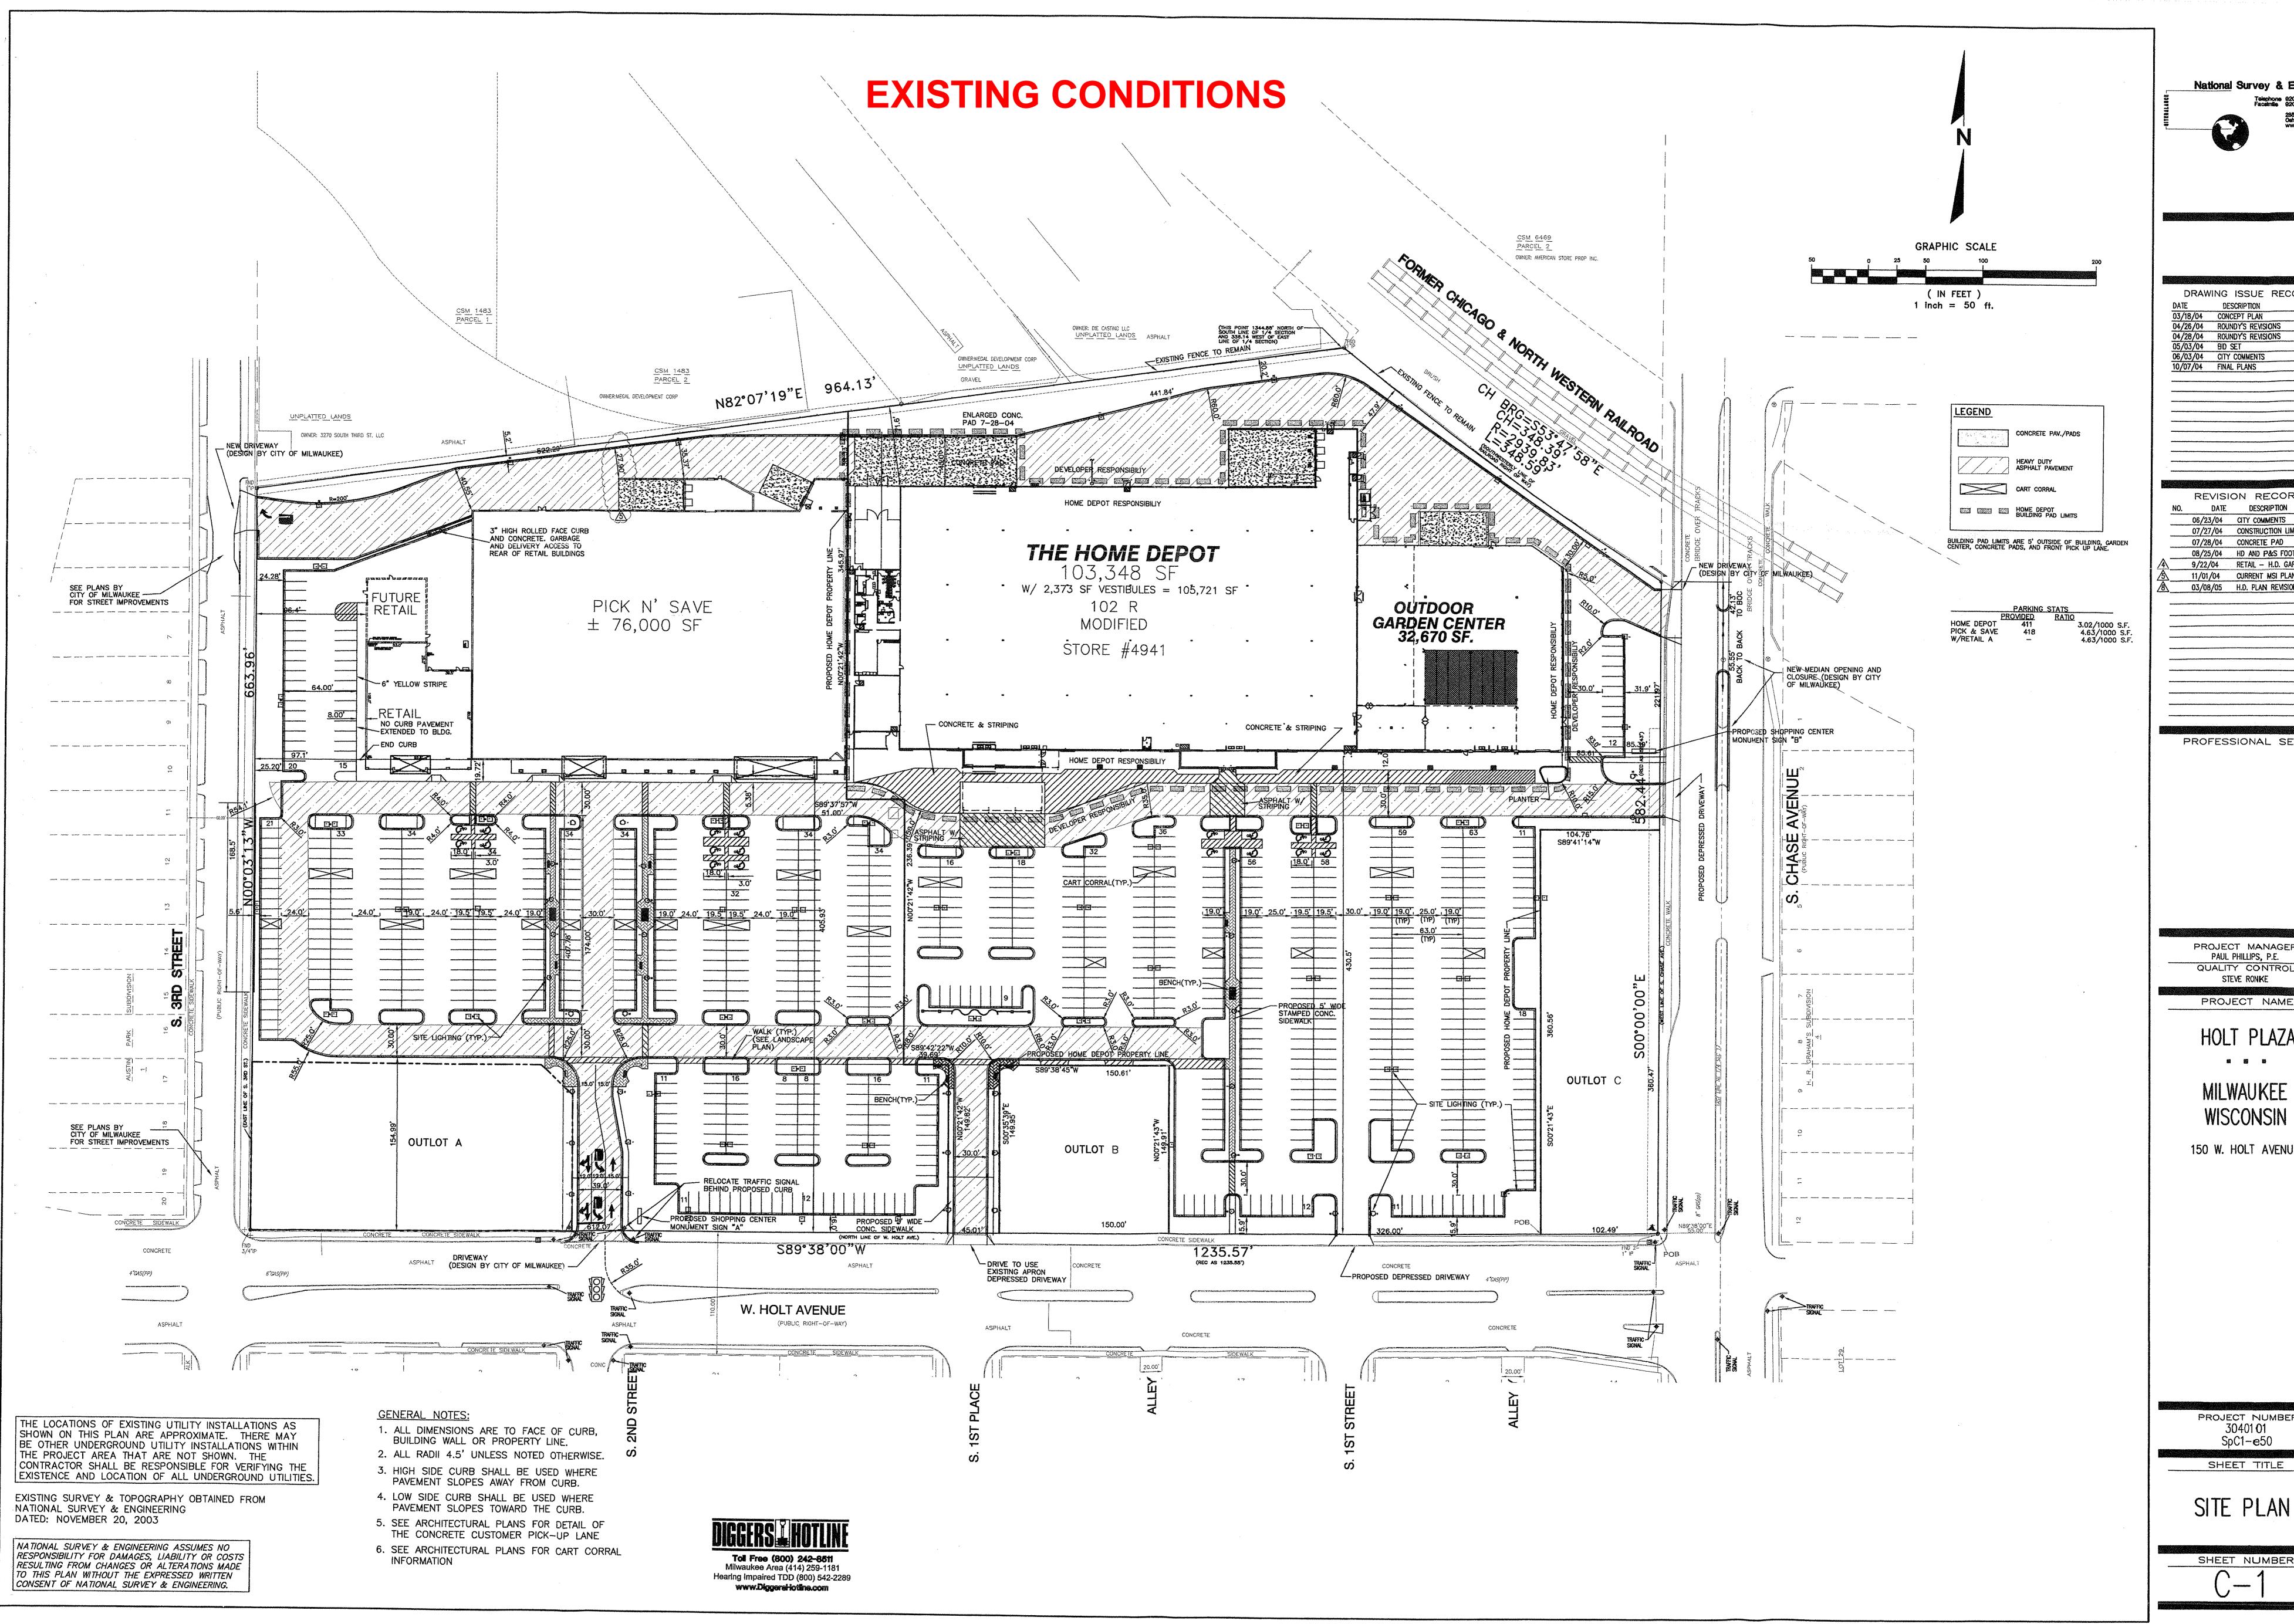

REVISION RECORD

PROFESSIONAL SEAL

PAUL PHILLIPS, P.E. QUALITY CONTROL STEVE RONKE


150 W. HOLT AVENUE


PROJECT NUMBER 30401 01 SpC1-e50

SHEET TITLE

SITE PLAN

SHEET NUMBER

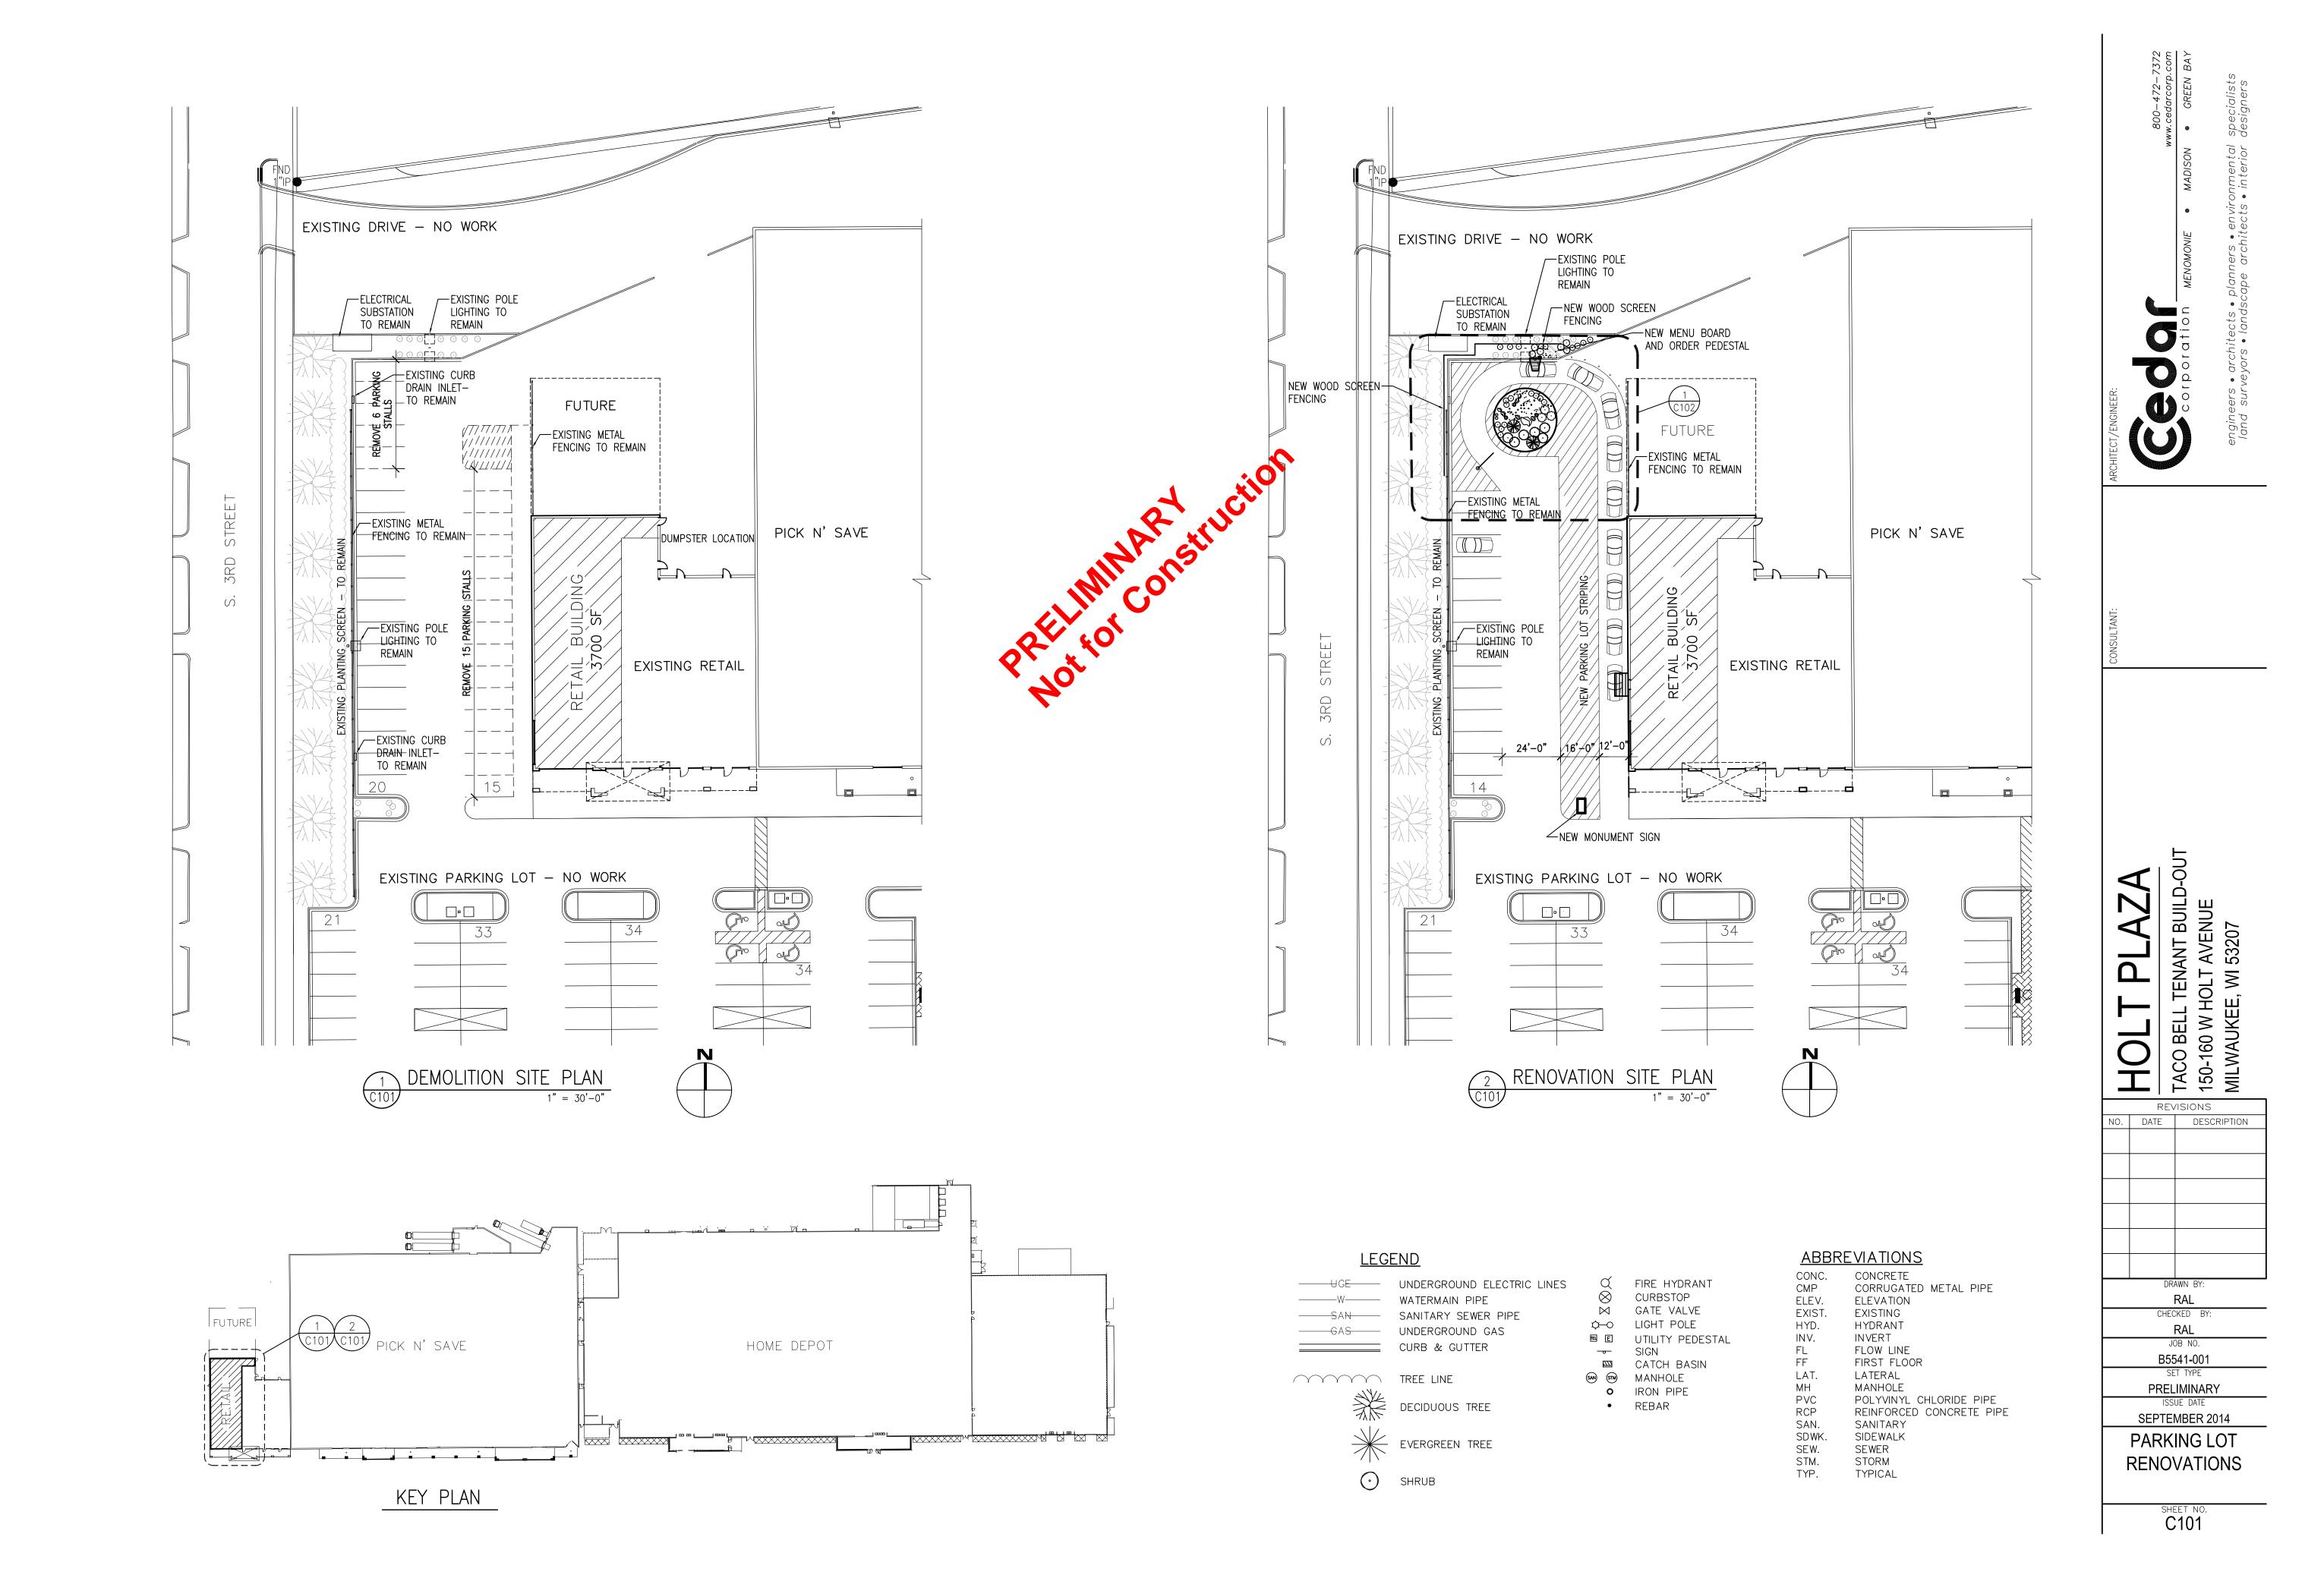

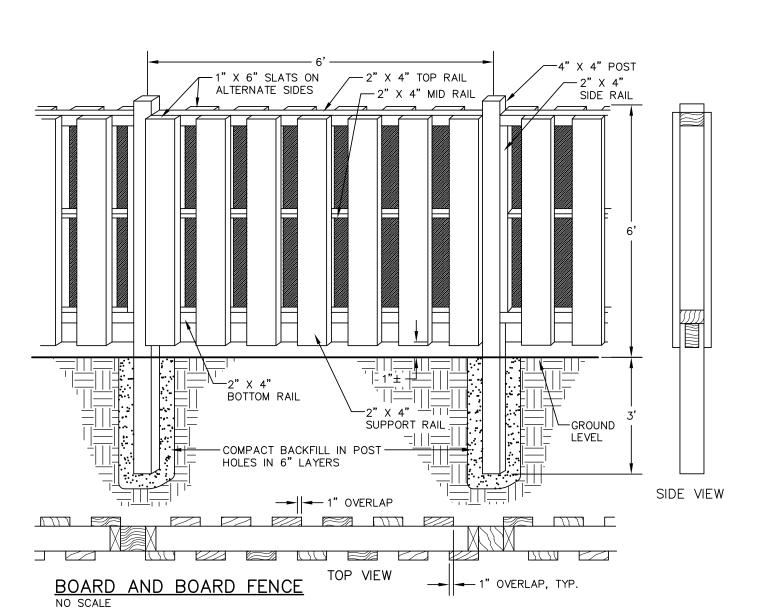

- NOTES:


 * ALL WOOD RAILS & POSTS SHALL BE BROWN IN COLOR, PRESSURE TREATED IN ACCORDANCE WITH AASHTO DESIGNATION M 133.


 * ALL NAILS & FASTENERS SHALL BE HOT-DIP GALVANIZED IN ACCORDANCE WITH WITH ASTM A153 STANDARDS.

 * PROVIDE CONCRETE IN WOOD POST HOLES AT THE BEGINNING, END, AND CORNERS OF EACH WOOD POST RUN.


 * 204 TOTAL LINEAR FEET OF BOARD AND BOARD FENCE.

 * CONTRACTOR SHALL COORDINATE LOCATION OF FENCE W/ OWNER.

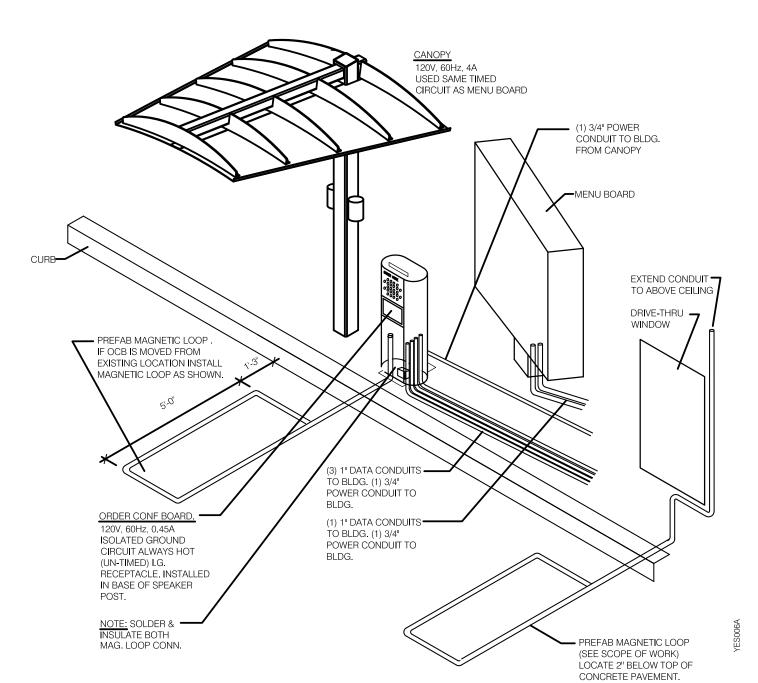

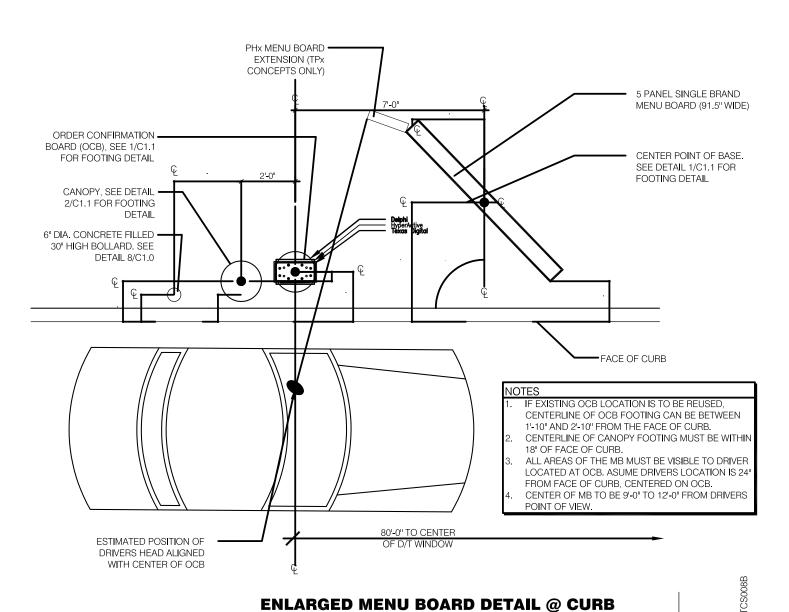

DRIVE-THRU COMMUNICATIONS ISOMETRIC

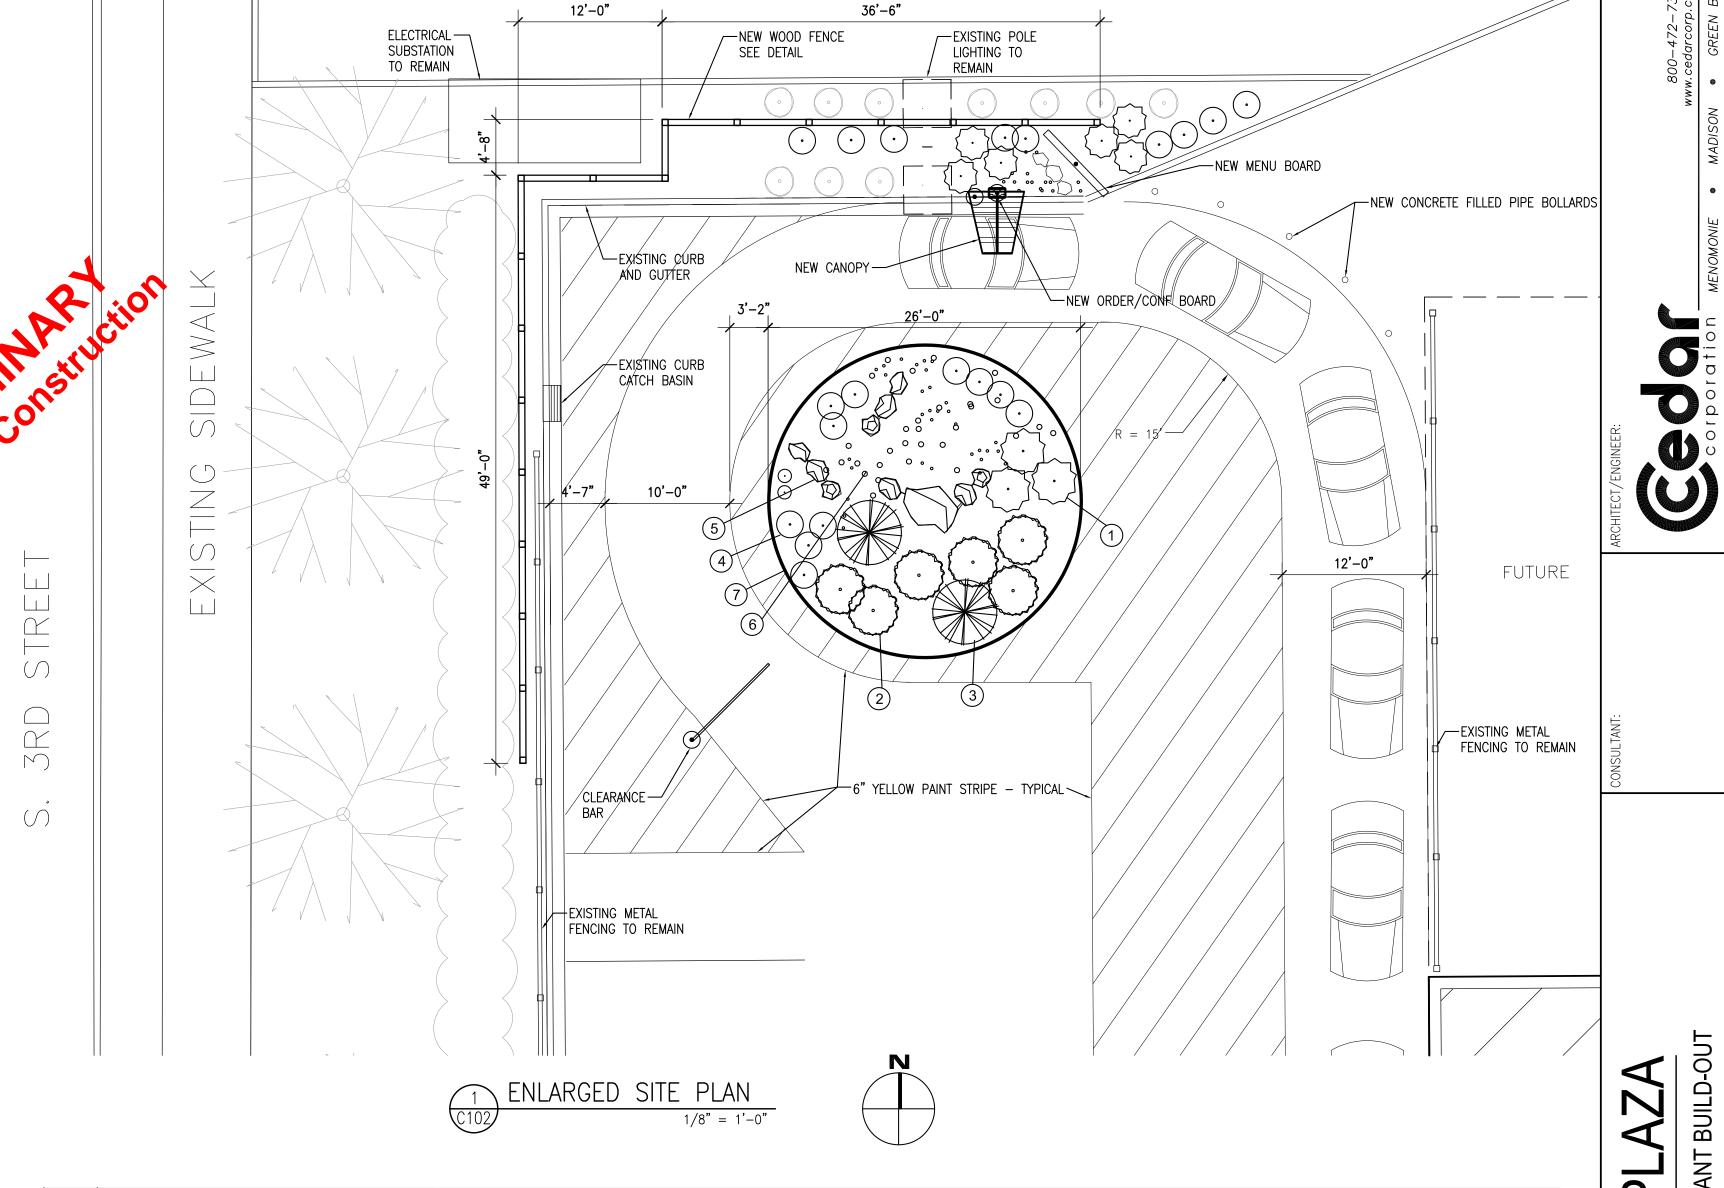



REGION 5 - MIDWEST REG					REGION (6 - NO	RTH				
	MATERIAL	QTY	SIZE	HGT.	SP	MATERIAL	QTY	SIZE	HGT.	ST. SP	
1	BLUE FESCUE FESTUCA GLAUCA	PER PLAN	3 GAL.	12"	12"	BLUE FESCUE FESTUCA GLAUCA	PER PLAN	3 GAL.	12"	12"	
2	JAPANESES BARBERRY BERBERIS THUNBERGII	PER PLAN	3 GAL.	15"	15"	CRANBERRY BUSH VIBURNUM OPULUS	PER PLAN	3 GAL.	15"	" 15"	
3	SOAPWEED YUCCA GLAUCA	PER PLAN	5 GAL.			ADAM'S NEEDLE YUCCA FILAMENTOSA	PER PLAN	5 GAL.			
4	DWARF GOLDEN ARBORVITAL THUJA OCCIDENTALIS 'RHEIN	E PE GOLD' ^{PL}		24"	24"	DWARF GOLDEN ARBORVITAI THUJA OCCIDENTALIS 'RHEIN	E PER Golfd!AN	5 GAL.	24"	24"	
(5)	LIMESTONE BOULDER SAND -GREY - 6" TO 24"	PER PLAN	6"-24"	N/A		LIMESTONE BOULDER SAND -GREY - 6" TO 24"	PER PLAN	6"-24"	N/A	A	
6	GRAVEL MULCH LIMESTONE - 3" AGGREGATE	PER E PLAN	3"	N/A		GRAVEL MULCH LIMESTONE - 3" AGGREGATE	PER E PLAN	3"	N/A		
7	STEEL EDGING	PER PLAN	N/A	3" AFG 6" BFG	N/A	STEEL EDGING	PER PLAN	N/A	3" AFG 6" BFG	$1/N/\Delta$	
MATERIALS LEGEND						LANDSCAPE NOTES					
	(1)	·	• 4 — 7				 GRAVEL MULCH SHALL BE CONTINUOUS TO EDGE OF STEEL BORDER & CONCRETE CURB. ALSO UNDER ALL PLANTS PROVIDE WEED BARRIER UNDER GRAVEL MULCH PROVIDE A INDUSTRY STANDARD DRIP IRRIGATION SYSTEM APPROPRIATE FOR THE SELECTED REGION AND PLANTING TYPES PLANTS SHALL BE PLANTED PER REGIONAL BEST PRACTICES INCLUDING BUT NOT LIMITED TO SUPPORT, DEPTH/WIDTH OF PLANTING HOLE AND SOIL AMMENDEMENTS 				
	(·) (2)	0	5				5.	SEE SHE	EET C1.0	C1.0 AND C1.1 FOR ADDITIONAL TACO BELL SPECIFIC DETAILS INCLUDING THE MENU BOARD, ENTRY PORTALL AND OCB/CANOPY.	
\(\frac{1}{2}\)	3	0	6								

TACO BELL TENANT BUILD-C 150-160 W HOLT AVENUE MILWAUKEE, WI 53207 REVISIONS DATE DESCRIPTION DRAWN BY: RAL CHECKED BY: RAL JOB NO. B5541-001 SET TYPE **PRELIMINARY** ISSUE DATE SEPTEMBER 2014 PARKING LOT

DETAILS

SHEET NO.

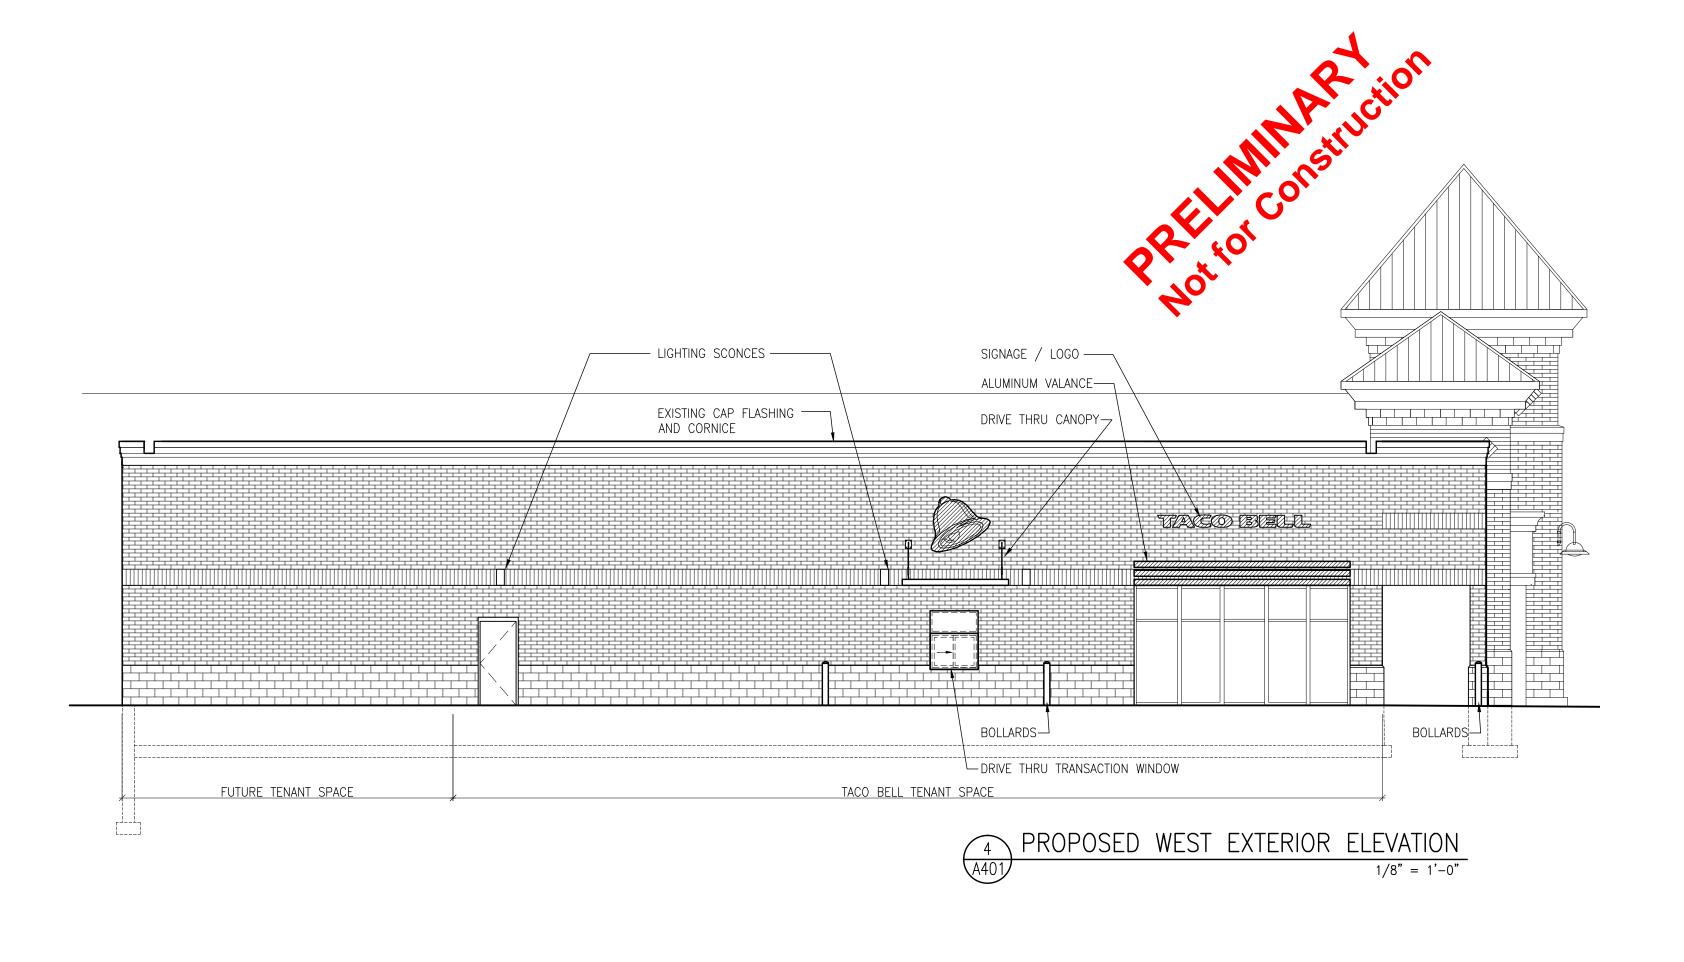

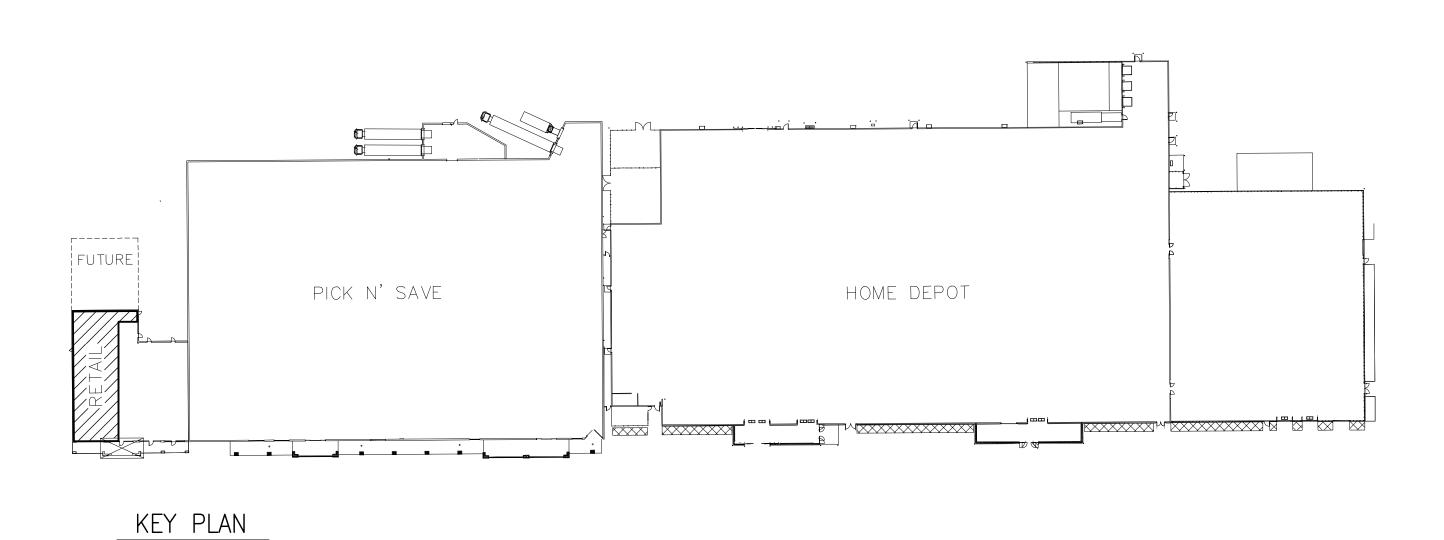










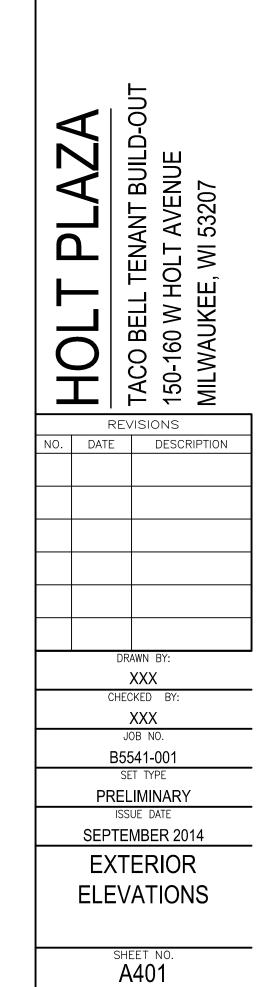


1/8" = 1'-0"








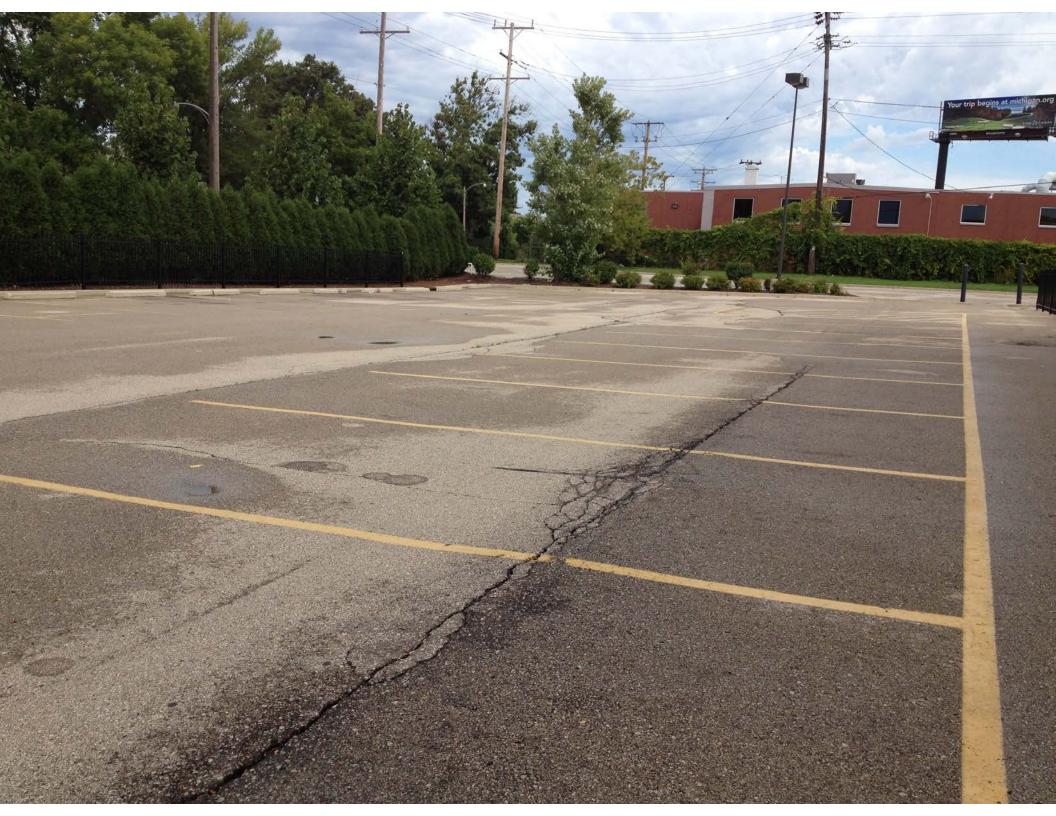




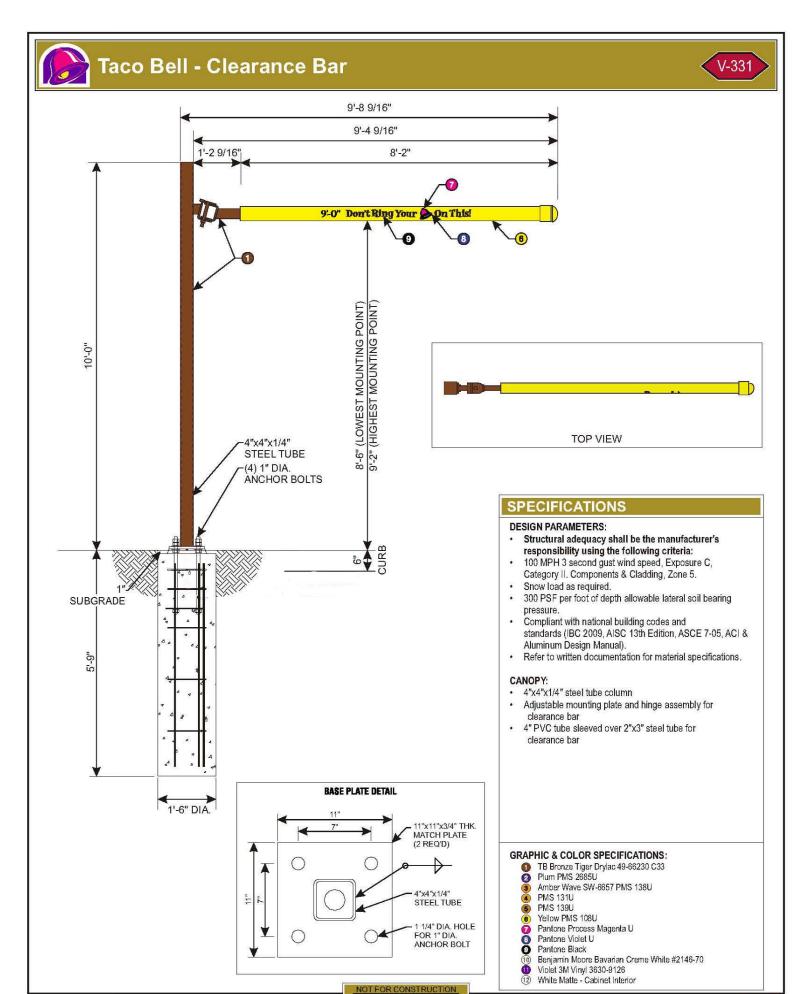

Taco Bell - DT Canopy

6'-3"

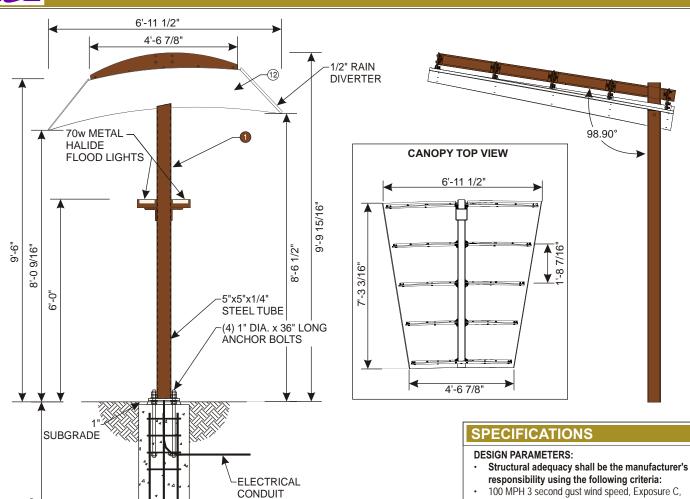

BASE PLATE DETAIL 11"x11"x3/4" THK. STEEL PLATE 5"x5"x1/4" STEEL TUBE 1 1/4" DIA. HOLE FOR 1" DIA. ANCHOR BOLT

- 100 MPH 3 second gust wind speed, Exposure C, Category II. Components & Cladding, Zone 5.
- Snow load as required.
- 300 PSF per foot of depth allowable lateral soil bearing
- Compliant with national building codes and standards (IBC 2009, AISC 13th Edition, ASCE 7-05, ACI & Aluminum Design Manual).
- Refer to written documentation for material specifications.

CANOPY

- 5"x5"x1/4" steel tube column
- 4"x4"x1/4" steel tube horizontal canopy support
- .063 aluminum canopy deck
- · 1/4" steel rib plates rafters

ELECTRICAL SPECIFICATIONS

UL & NEC approval required.


(2) Flood lights - 70W Metal Halide Lamp(s):


Total Load: 1.17 amps/120 volts Circuits(s): (1) 20 amp-120V

GRAPHIC & COLOR SPECIFICATIONS:

- TB Bronze Tiger Drylac 49-66230 C33
- Plum PMS 2685U
- Amber Wave SW-6657 PMS 138U
- PMS 131U
- PMS 139U
- Yellow PMS 108U
- Pantone Process Magenta U
- Pantone Violet U
- Pantone Black
- Benjamin Moore Bavarian Creme White #2146-70
- Violet 3M Vinyl 3630-9126
- White Matte Cabinet Interior



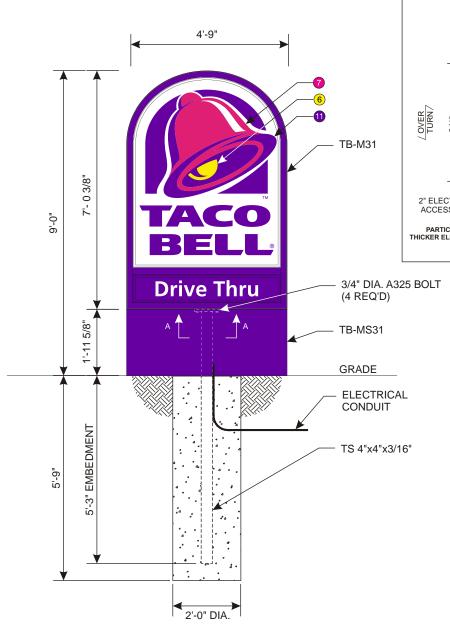

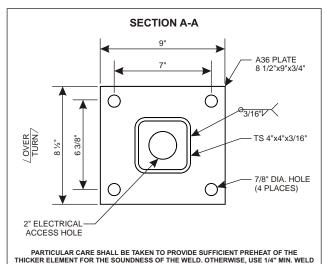

SPECIFICATIONS

DESIGN PARAMETERS

- Structural adequacy shall be the manufacturer's responsibility using the following criteria:
- 100 MPH 3 second gust wind speed, Exposure C, Category II.
- 300 PSF per foot of depth allowable lateral soil bearing
- Compliant with national building codes and standards (IBC 2009, AISC 13th Edition, ASCE 7-05, ACI & Aluminum Design Manual).
- Refer to written documentation for material specifications.

DIRECTIONAL:

- Extruded aluminum frame, 10" deep with 1 1/2" retainers
- Aluminum painted fillers
- .125 pan-formed and embossed SG polycarbonate face with retention strips
- Approximate weight: 325 lbs.

ELECTRICAL SPECIFICATIONS

UL & NEC approval required.

(4) F48T12DSGN50/HO Lamp(s): (2) F42T12DSGN50/HO

(2) F36T12DSGN50/HO

(2) 4-lamp electronic ballast (1.7 amps each) Ballast(s)

Total Load: 3.4 amps Circuits(s): (1) 20 amp-120V

GRAPHIC & COLOR SPECIFICATIONS:

- TB Bronze Tiger Drylac 49-66230 C33
- Plum PMS 2685U
- Amber Wave SW-6657 PMS 138U
- PMS 131U
- PMS 139U
- Yellow PMS 108U Pantone Process Magenta U
- Pantone Violet U
- Pantone Black
- Benjamin Moore Bavarian Creme White #2146-70
- Violet 3M Vinyl 3630-9126
- White Matte Cabinet Interior

Memo

Re: Drive-Thru Sound Pressure Levels From the Menu Board or Speaker Post

The sound pressure levels from the menu board or speaker post are as follows:

- 1. Sound pressure level (SPL) contours (A weighted) were measured on a typical HME SPP2 speaker post. The test condition was for pink noise set to 84 dBA at 1 foot in front of the speaker. All measurements were conducted outside with the speaker post placed 8 feet from a non-absorbing building wall and at an oblique angle to the wall. These measurements should not be construed to guarantee performance with any particular speaker post in any particular environment. They are typical results obtained under the conditions described above.
- 2. The SPL levels are presented for different distances from the speaker post:

Distance from the Speaker (Feet)	SPL (dBA)
1 foot	84 dBA
2 feet	78 dBA
4 feet	72 dBA
8 feet	66 dBA
16 feet	60 dBA
32 feet	54 dBA

3. The above levels are based on factory recommended operating levels, which are preset for HME components and represent the optimum level for drive-thru operations in the majority of the installations.

Also, HME incorporates automatic volume control (AVC) into many of our Systems. AVC will adjust the outbound volume based on the outdoor, ambient noise level. When ambient noise levels naturally decrease at night, AVC will reduce the outbound volume on the system. See below for example:

Distance from Outside Speaker	Decibel Level of standard system with 45 dB of outside noise <u>without</u> AVC	Decibel level of standard system with 45 dB of outside noise with AVC active
1 foot	84 dBA	60 dBA
2 feet	78 dBA	54 dBA
4 feet	72 dBA	48 dBA
8 feet	66 dBA	42 dBA
16 feet	60 dBA	36 dBA

If there are any further questions regarding this issue please contact HME customer service at 1-800-848-4468.

Thank you for your interest in HME's products.